

MASON RIDGE ENTRANCE MONUMENT PLANS

LOCATED IN
HARNETT COUNTY, NORTH CAROLINA
ESP PROJECT # 24-01007

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SHEET NO.	SHEET NAME	ORIGINAL DATE	REVISION DATE
cov	COVER	9/10/2024	12/31/2024
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H2.0	ENTRANCE MONUMENT CONCEPTUAL ELEVATION	9/10/2024	-
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S-1	STRUCTURAL PLANS	9/10/2024	-
S-2	STRUCTURAL PLANS	9/10/2024	-



ILLUSTRATIVE ELEVATION (NTS)



FAX: (919) 677-1252
CONTACT: EMILY ROTHROCK, PLA

DEVELOPER: D.R. HORTON
ADDRESS: 2000 AERIAL CENTER PKWY
SUITE 110A
MORRISVILLE, NC 27560
PHONE: (919) 460-2999
CONTACT: ROBERT STUART

REVIEW AGENCY: HARNETT COUNTY PLANNING DEPARTMENT
ADDRESS: 420 MCKINNEY PKWY

(919) 678-1070

ESP ASSOCIATES, INC.

MORRISVILLE, NC 27560

LILLINGTON. NC 27546

910 893-7525

2200 GATEWAY CENTRE BLVD.

LANDSCAPE ARCHITECT:


ADDRESS:

PHONE:



COVER CONSTRUCTION DOCUMENTS

PROJECT INFORMATION
PROJECT NUMBER: MS
DESIGNED BY: MS
DRAWN BY: BA
PROJECT NUMBER: 24-01007
ORIGINAL DATE: 09/10/2024
SHEET:
COV

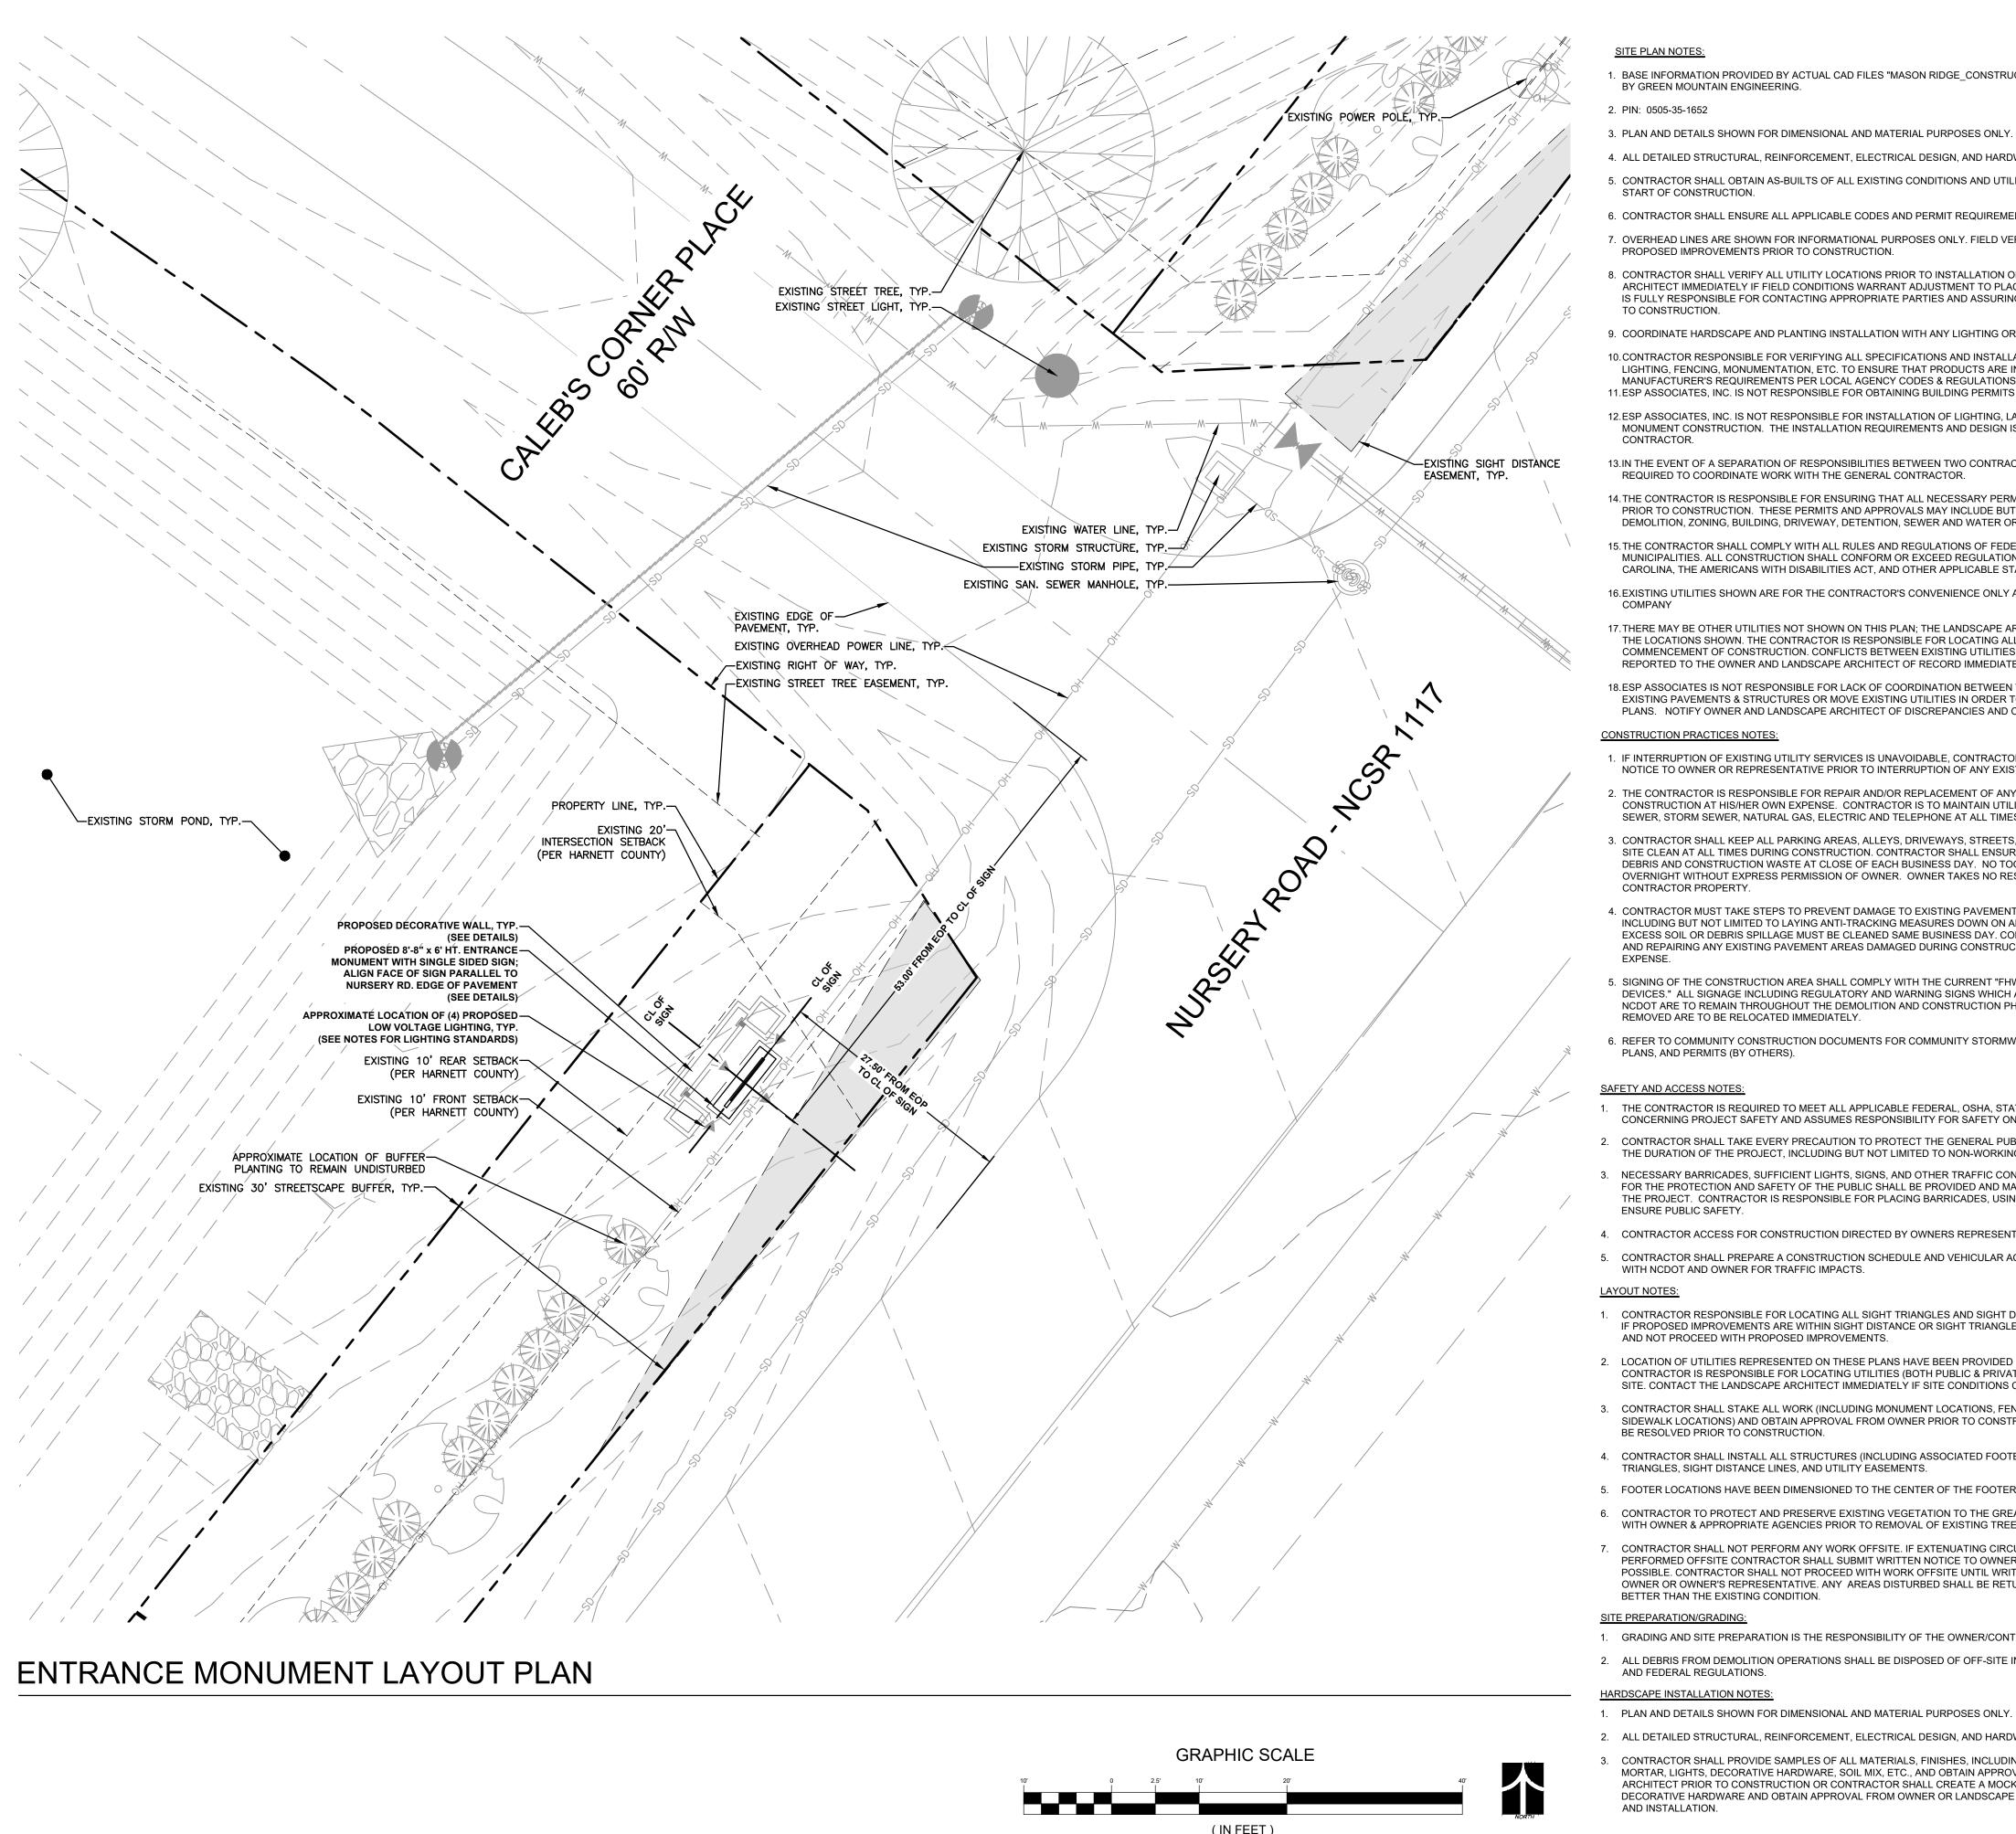

- . BASE INFORMATION PROVIDED BY ACTUAL CAD FILES "MASON RIDGE_CONSTRUCTION CAD FILE" DATED 7/19/2024 PROVIDED BY GREEN MOUNTAIN ENGINEERING.
- 2. PIN: 0505-35-1652
- 3. PLAN AND DETAILS SHOWN FOR DIMENSIONAL AND MATERIAL PURPOSES ONLY.
- 4. ALL DETAILED STRUCTURAL, REINFORCEMENT, ELECTRICAL DESIGN, AND HARDWARE BY OTHERS.
- 5. CONTRACTOR SHALL OBTAIN AS-BUILTS OF ALL EXISTING CONDITIONS AND UTILITIES AND VERIFY LAYOUT IN FIELD PRIOR TO START OF CONSTRUCTION.
- 6. CONTRACTOR SHALL ENSURE ALL APPLICABLE CODES AND PERMIT REQUIREMENTS ARE MET.
- 7. OVERHEAD LINES ARE SHOWN FOR INFORMATIONAL PURPOSES ONLY. FIELD VERIFY POWER POLE LOCATIONS WITH PROPOSED IMPROVEMENTS PRIOR TO CONSTRUCTION.
- 8. CONTRACTOR SHALL VERIFY ALL UTILITY LOCATIONS PRIOR TO INSTALLATION OF IMPROVEMENTS AND NOTIFY LANDSCAPE ARCHITECT IMMEDIATELY IF FIELD CONDITIONS WARRANT ADJUSTMENT TO PLACEMENT OF IMPROVEMENTS. CONTRACTOR IS FULLY RESPONSIBLE FOR CONTACTING APPROPRIATE PARTIES AND ASSURING THAT ALL UTILITIES ARE LOCATED PRIOR
- 9. COORDINATE HARDSCAPE AND PLANTING INSTALLATION WITH ANY LIGHTING OR IRRIGATION INSTALLATION.
- 10. CONTRACTOR RESPONSIBLE FOR VERIFYING ALL SPECIFICATIONS AND INSTALLATION REQUIREMENTS OF IRRIGATION, LIGHTING, FENCING, MONUMENTATION, ETC. TO ENSURE THAT PRODUCTS ARE INSTALLED PROPERLY AND PER MANUFACTURER'S REQUIREMENTS PER LOCAL AGENCY CODES & REGULATIONS.
- 12.ESP ASSOCIATES, INC. IS NOT RESPONSIBLE FOR INSTALLATION OF LIGHTING, LANDSCAPING, FENCING, IRRIGATION, OR
- MONUMENT CONSTRUCTION. THE INSTALLATION REQUIREMENTS AND DESIGN IS THE RESPONSIBILITY OF THE
- 13.IN THE EVENT OF A SEPARATION OF RESPONSIBILITIES BETWEEN TWO CONTRACTORS, LANDSCAPE CONTRACTOR IS REQUIRED TO COORDINATE WORK WITH THE GENERAL CONTRACTOR.
- 14. THE CONTRACTOR IS RESPONSIBLE FOR ENSURING THAT ALL NECESSARY PERMITS AND APPROVALS HAVE BEEN OBTAINED PRIOR TO CONSTRUCTION. THESE PERMITS AND APPROVALS MAY INCLUDE BUT ARE NOT LIMITED TO GRADING, DEMOLITION, ZONING, BUILDING, DRIVEWAY, DETENTION, SEWER AND WATER OR ANY OTHERS NOT SPECIFICALLY LISTED.
- 15.THE CONTRACTOR SHALL COMPLY WITH ALL RULES AND REGULATIONS OF FEDERAL, STATE, COUNTY, AND LOCAL MUNICIPALITIES. ALL CONSTRUCTION SHALL CONFORM OR EXCEED REGULATIONS OF WAKE COUNTY, THE STATE OF NORTH CAROLINA, THE AMERICANS WITH DISABILITIES ACT, AND OTHER APPLICABLE STANDARDS AND GOVERNING AUTHORITIES.
- 16.EXISTING UTILITIES SHOWN ARE FOR THE CONTRACTOR'S CONVENIENCE ONLY AND ARE BASED ON PLANS BY THE NAU
- 17. THERE MAY BE OTHER UTILITIES NOT SHOWN ON THIS PLAN; THE LANDSCAPE ARCHITECT ASSUMES NO RESPONSIBILITY FOR THE LOCATIONS SHOWN. THE CONTRACTOR IS RESPONSIBLE FOR LOCATING ALL EXISTING UTILITIES PRIOR TO COMMENCEMENT OF CONSTRUCTION. CONFLICTS BETWEEN EXISTING UTILITIES AND PROPOSED IMPROVEMENTS SHALL BE REPORTED TO THE OWNER AND LANDSCAPE ARCHITECT OF RECORD IMMEDIATELY.
- 18.ESP ASSOCIATES IS NOT RESPONSIBLE FOR LACK OF COORDINATION BETWEEN TRADES RESULTING IN THE NEED TO DEMO EXISTING PAVEMENTS & STRUCTURES OR MOVE EXISTING UTILITIES IN ORDER TO BUILD IMPROVEMENTS SHOWN ON THESE PLANS. NOTIFY OWNER AND LANDSCAPE ARCHITECT OF DISCREPANCIES AND CONFLICTS BEFORE WORK BEGINS.

CONSTRUCTION PRACTICES NOTES:

- 1. IF INTERRUPTION OF EXISTING UTILITY SERVICES IS UNAVOIDABLE, CONTRACTOR SHALL PROVIDE MINIMUM OF 48 HOUR NOTICE TO OWNER OR REPRESENTATIVE PRIOR TO INTERRUPTION OF ANY EXISTING UTILITY SERVICE.
- 2. THE CONTRACTOR IS RESPONSIBLE FOR REPAIR AND/OR REPLACEMENT OF ANY UTILITIES DAMAGED DURING CONSTRUCTION AT HIS/HER OWN EXPENSE. CONTRACTOR IS TO MAINTAIN UTILITY SERVICES INCLUDING: WATER, SANITARY SEWER, STORM SEWER, NATURAL GAS, ELECTRIC AND TELEPHONE AT ALL TIMES DURING CONSTRUCTION.
- 3. CONTRACTOR SHALL KEEP ALL PARKING AREAS, ALLEYS, DRIVEWAYS, STREETS, ETC. ADJACENT TO THE CONSTRUCTION SITE CLEAN AT ALL TIMES DURING CONSTRUCTION. CONTRACTOR SHALL ENSURE WORK AREA IS CLEAN AND CLEAR OF ALL DEBRIS AND CONSTRUCTION WASTE AT CLOSE OF EACH BUSINESS DAY. NO TOOLS OR EQUIPMENT ARE TO BE LEFT OVERNIGHT WITHOUT EXPRESS PERMISSION OF OWNER. OWNER TAKES NO RESPONSIBILITY FOR LOSS OR DAMAGE TO CONTRACTOR PROPERTY.
- 4. CONTRACTOR MUST TAKE STEPS TO PREVENT DAMAGE TO EXISTING PAVEMENT OR EXCESSIVE TRACKING OF SOIL, INCLUDING BUT NOT LIMITED TO LAYING ANTI-TRACKING MEASURES DOWN ON ALL ACTIVE DRIVES AND WORK AREAS. ANY EXCESS SOIL OR DEBRIS SPILLAGE MUST BE CLEANED SAME BUSINESS DAY. CONTRACTOR RESPONSIBLE FOR REPLACING AND REPAIRING ANY EXISTING PAVEMENT AREAS DAMAGED DURING CONSTRUCTION ACTIVITY AT CONTRACTOR'S OWN
- 5. SIGNING OF THE CONSTRUCTION AREA SHALL COMPLY WITH THE CURRENT "FHWA MANUAL ON UNIFORM TRAFFIC CONTROL DEVICES." ALL SIGNAGE INCLUDING REGULATORY AND WARNING SIGNS WHICH ARE OWNED AND MAINTAINED BY THE NCDOT ARE TO REMAIN THROUGHOUT THE DEMOLITION AND CONSTRUCTION PHASES. ALL SIGNS WHICH NEED TO BE REMOVED ARE TO BE RELOCATED IMMEDIATELY.
- 6. REFER TO COMMUNITY CONSTRUCTION DOCUMENTS FOR COMMUNITY STORMWATER & EROSION CONTROL MEASURES, PLANS, AND PERMITS (BY OTHERS).

- 1. THE CONTRACTOR IS REQUIRED TO MEET ALL APPLICABLE FEDERAL, OSHA, STATE AND LOCAL REGULATIONS CONCERNING PROJECT SAFETY AND ASSUMES RESPONSIBILITY FOR SAFETY ON THE PROJECT.
- CONTRACTOR SHALL TAKE EVERY PRECAUTION TO PROTECT THE GENERAL PUBLIC FROM CONSTRUCTION AREAS FOR THE DURATION OF THE PROJECT, INCLUDING BUT NOT LIMITED TO NON-WORKING HOURS.
- NECESSARY BARRICADES, SUFFICIENT LIGHTS, SIGNS, AND OTHER TRAFFIC CONTROL METHODS AS MAY BE NECESSARY FOR THE PROTECTION AND SAFETY OF THE PUBLIC SHALL BE PROVIDED AND MAINTAINED THROUGHOUT THE LIFE OF THE PROJECT. CONTRACTOR IS RESPONSIBLE FOR PLACING BARRICADES, USING FLAG MEN, ETC. AS NECESSARY TO
- 4. CONTRACTOR ACCESS FOR CONSTRUCTION DIRECTED BY OWNERS REPRESENTATIVE.
- 5. CONTRACTOR SHALL PREPARE A CONSTRUCTION SCHEDULE AND VEHICULAR ACCESS SCHEDULE AND COORDINATE WITH NCDOT AND OWNER FOR TRAFFIC IMPACTS.

- 1. CONTRACTOR RESPONSIBLE FOR LOCATING ALL SIGHT TRIANGLES AND SIGHT DISTANCE LINES PRIOR TO INSTALLATION. IF PROPOSED IMPROVEMENTS ARE WITHIN SIGHT DISTANCE OR SIGHT TRIANGLES CONTRACTOR SHALL NOTIFY OWNER AND NOT PROCEED WITH PROPOSED IMPROVEMENTS.
- 2. LOCATION OF UTILITIES REPRESENTED ON THESE PLANS HAVE BEEN PROVIDED FOR INFORMATION PURPOSES CONTRACTOR IS RESPONSIBLE FOR LOCATING UTILITIES (BOTH PUBLIC & PRIVATE) PRIOR TO START OF WORK ON THIS SITE. CONTACT THE LANDSCAPE ARCHITECT IMMEDIATELY IF SITE CONDITIONS CHANGE.
- 3. CONTRACTOR SHALL STAKE ALL WORK (INCLUDING MONUMENT LOCATIONS, FENCE LOCATIONS, PLANT LOCATIONS, AND SIDEWALK LOCATIONS) AND OBTAIN APPROVAL FROM OWNER PRIOR TO CONSTRUCTION. ANY DISCREPANCIES SHALL BE RESOLVED PRIOR TO CONSTRUCTION.
- 4. CONTRACTOR SHALL INSTALL ALL STRUCTURES (INCLUDING ASSOCIATED FOOTERS) AND PLANTINGS OUTSIDE OF SIGHT TRIANGLES, SIGHT DISTANCE LINES, AND UTILITY EASEMENTS.
- 5. FOOTER LOCATIONS HAVE BEEN DIMENSIONED TO THE CENTER OF THE FOOTER.
- 6. CONTRACTOR TO PROTECT AND PRESERVE EXISTING VEGETATION TO THE GREATEST EXTENT POSSIBLE. COORDINATE WITH OWNER & APPROPRIATE AGENCIES PRIOR TO REMOVAL OF EXISTING TREES/VEGETATION.
- 7. CONTRACTOR SHALL NOT PERFORM ANY WORK OFFSITE. IF EXTENUATING CIRCUMSTANCES REQUIRE WORK TO BE PERFORMED OFFSITE CONTRACTOR SHALL SUBMIT WRITTEN NOTICE TO OWNER'S REPRESENTATIVE AS SOON AS POSSIBLE. CONTRACTOR SHALL NOT PROCEED WITH WORK OFFSITE UNTIL WRITTEN APPROVAL IS OBTAINED FROM OWNER OR OWNER'S REPRESENTATIVE. ANY AREAS DISTURBED SHALL BE RETURNED TO A CONDITION EQUAL TO OR BETTER THAN THE EXISTING CONDITION.

SITE PREPARATION/GRADING:

- 1. GRADING AND SITE PREPARATION IS THE RESPONSIBILITY OF THE OWNER/CONTRACTOR.
- 2. ALL DEBRIS FROM DEMOLITION OPERATIONS SHALL BE DISPOSED OF OFF-SITE IN ACCORDANCE WITH LOCAL, STATE, AND FEDERAL REGULATIONS.

1 INCH = 10 FT.

- 1. PLAN AND DETAILS SHOWN FOR DIMENSIONAL AND MATERIAL PURPOSES ONLY.
- 2. ALL DETAILED STRUCTURAL, REINFORCEMENT, ELECTRICAL DESIGN, AND HARDWARE BY OTHERS.
- CONTRACTOR SHALL PROVIDE SAMPLES OF ALL MATERIALS, FINISHES, INCLUDING STONE VENEER, SIGN FACE, GROUT, MORTAR, LIGHTS, DECORATIVE HARDWARE, SOIL MIX, ETC., AND OBTAIN APPROVAL FROM OWNER AND LANDSCAPE ARCHITECT PRIOR TO CONSTRUCTION OR CONTRACTOR SHALL CREATE A MOCK-UP OF WALL, CAP, AND TRIM WITH DECORATIVE HARDWARE AND OBTAIN APPROVAL FROM OWNER OR LANDSCAPE ARCHITECT PRIOR TO FABRICATION

LIGHTING STANDARDS

- COORDINATE ALL LIGHTING. CONDUITS AND ELECTRICAL COMPONENTS WITH ELECTRICIAN LICENSED TO DO WORK IN NORTH CAROLINA PRIOR TO INSTALLATION OF FOOTINGS AND OTHER LANDSCAPE
- LIGHTING DESIGN IS TO BE COMPLETE BY OTHERS. LIGHT FIXTURE SHOWN ON SITE PLANS IS FOR DESIGN INTENT ONLY.
- CONTRACTOR RESPONSIBLE FOR INSTALLING UPLIGHTING. SEE LOW VOLTAGE LIGHTING ON SITE LAYOUT AND PLANTING PLANS FOR APPROXIMATE LOCATION.
- 4. UPLIGHTING TO BE FX LUMINAIRE LOW-VOLTAGE LED UPLIGHT MODEL PB-3LED-FB WARM 2,700K LAMP OR OWNER APPROVED EQUIVALENT.
- SIGN SCONCE LIGHTING TO BE POSSINI EURO ACKERLY 14" TEXTURED BLACK OUTDOOR LANTERN WALL LIGHT.
- 6. LIGHTING TO BE INSTALLED PER MANUFACTURER'S SPECIFICATIONS AND REQUIREMENTS WHICH MAY INCLUDE THE FOLLOWING:
 - LIGHT FIXTURES TO CONTAIN HIGH OUTPUT LED BULBS. LIGHTING SYSTEM TO INCLUDE PHOTOCELL FOR AUTOMATIC
- DUSK-TO-DAWN OPERATION AND TRANSFORMER. FIXTURE IS BLACK FINISH.
- FIXTURE TO INCLUDE LIGHT, BASE ASSEMBLY AND GROUND STAKE.
- WIRING TO BE INSTALLED PER MANUFACTURER'S RECOMMENDATION.
- LIGHT OUTPUT TO BE 6 WATTS. WATTAGE SUBJECT TO CHANGE PER FINAL DESIGN.
- PROVIDE APPROVED CONNECTIONS TO EXISTING ELECTRICAL SYSTEM AS IS REQUIRED FOR THE PROPER OPERATION OF THE
- AUTOMATIC CONTROL SYSTEM
- ALL ELECTRICAL WORK SHALL BE INSTALLED IN CONFORMANCE WITH NATIONAL, STATE, AND LOCAL ELECTRICAL CODES.
- THE ENTIRE SYSTEM SHALL FULLY COMPLY WITH LOCAL, STATE, AND NATIONAL REGULATIONS, ORDINANCES, AND ESTABLISHED LOCAL CODES APPLICABLE HERETO. IT IS THE CONTRACTOR'S
- MATERIALS USED IN THE SYSTEM SHALL BE NEW AND WITHOUT FLAWS OR DEFECTS OF ANY TYPE.

RESPONSIBILITY TO ESTABLISH COMPLIANCE.

- CONTRACTORS SHALL PROVIDE A CERTIFICATE OF WARRANTY FOR ONE YEAR FROM THE DATE OF FINAL ACCEPTANCE OF THE SYSTEM AND SHALL APPLY FOR ANY WARRANTIES IN THE OWNER'S NAME AND TURN PAPERWORK OVER TO THE OWNER UPON SUBMITTAL.
- NECESSARY BUILDING PERMITS RELATED TO THE CONSTRUCTION OF THE MONUMENTS AND THEIR LIGHTING SYSTEMS.

CONTRACTOR RESPONSIBLE FOR OBTAINING ANY AND ALL

CONTRACTOR SHALL OBTAIN ALL NECESSARY PERMITS PRIOR TO CONSTRUCTION AND COMMENCEMENT OF WORK.

LIGHTING INFORMATION:

VENDOR: FX LUMINAIRE CONTACT: LANCE ROSSELL

PHONE: 919-214-4818 LANCE.ROSSELL@HUNTERINDUSTRIES.COM

- 1. STONE VENEER TO BE APPROVED PER OWNER BEFORE START OF INSTALLATION.
- 2. ALL CAPS SHALL BE INSTALLED TO PROMOTE POSITIVE DRAINAGE
- 3. ALL SIGN LOCATIONS TO BE STAKED AND REVIEWED BY OWNER AND CONTRACTOR TO CONFIRM PROPER VERTICAL MONUMENT / SIGN PANEL LOCATION PRIOR TO
- 4. SAMPLES OF ALL MATERIALS SHALL BE SUBMITTED TO OWNER FOR APPROVAL.


ONUME

RD

PROJECT INFORMATION PROJECT MANAGER: PROJECT NUMBER:

S

H1.0

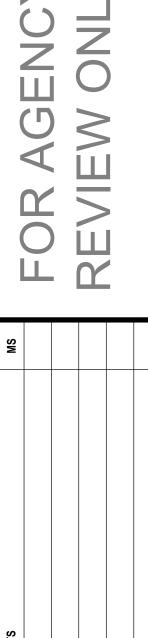

CONCEPTUAL ELEVATION
MASON RIDGE - ENTRANCE MONUMENT
CONSTRUCTION DOCUMENTS
HARNETT COUNTY, NC


Sign Panel Corrosion-Resistant Sign Panel, Aluminum; Matte Black



Sign Letters Caset/Acrylic **Channel Letters** Pure White



Sign Base Cap Concrete Base Cap; Keystone Cool Grey Tones

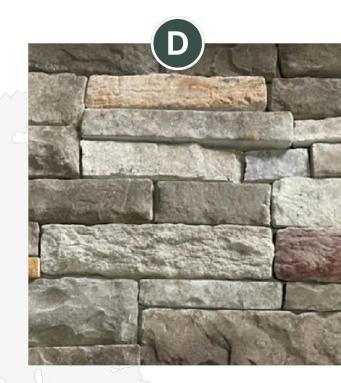


Masonry Sign Base Mucina Stone Saranda Ledgestone




Column Sconce Possini Euro 14" Lantern Finish: Black

Entrance Monument Sign 6' H x 8.33' L 50 sf



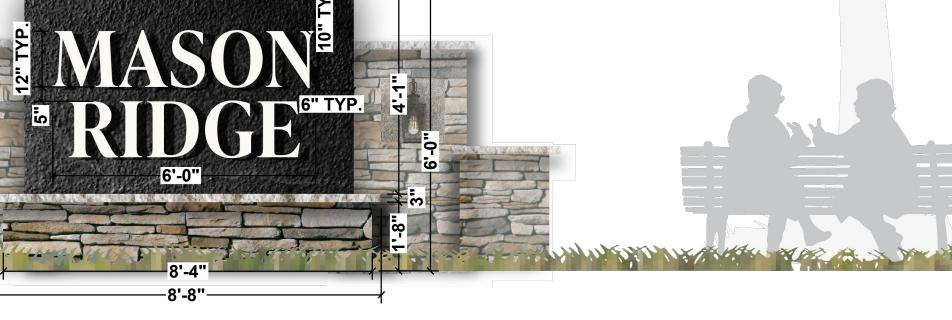

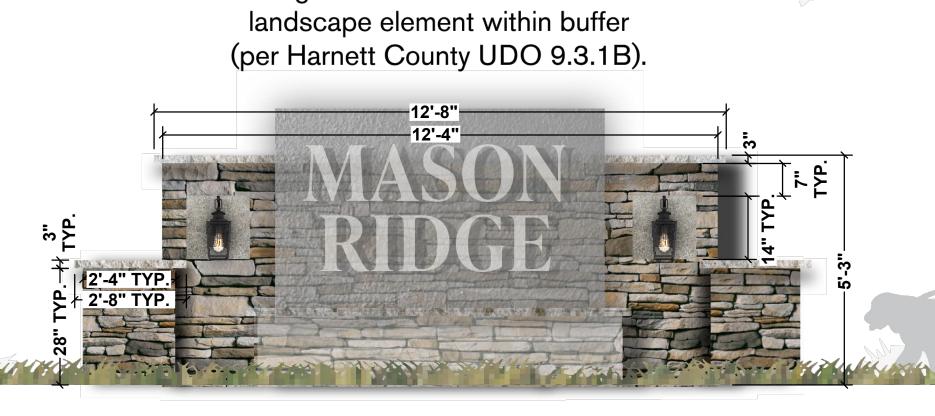

Decorative Wall & Columns

5.25' H x 16.55' L

87 sf

+ elements are freestanding and separate


from sign structure. To be included as


FRONT ELEVATION

SCALE: NTS

SEE DETAIL SHEET H2.1 & H2.2 FOR ADDITIONAL DIMENSIONS


H2.0

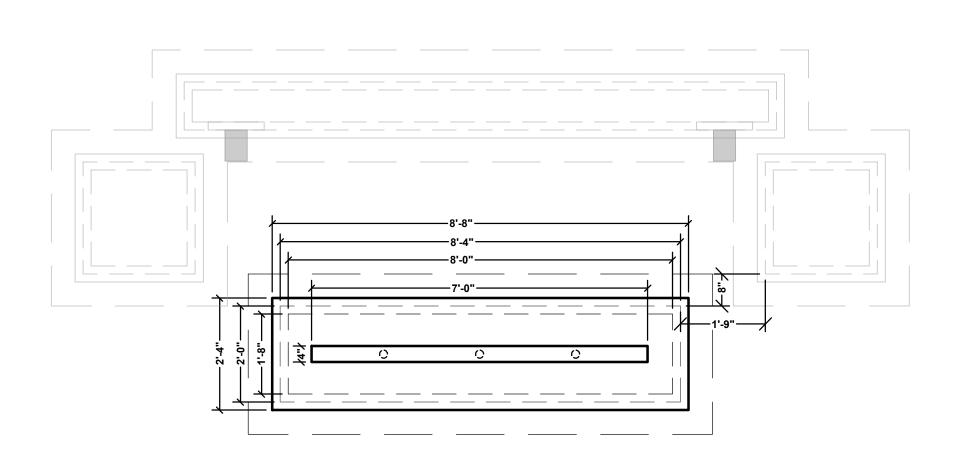


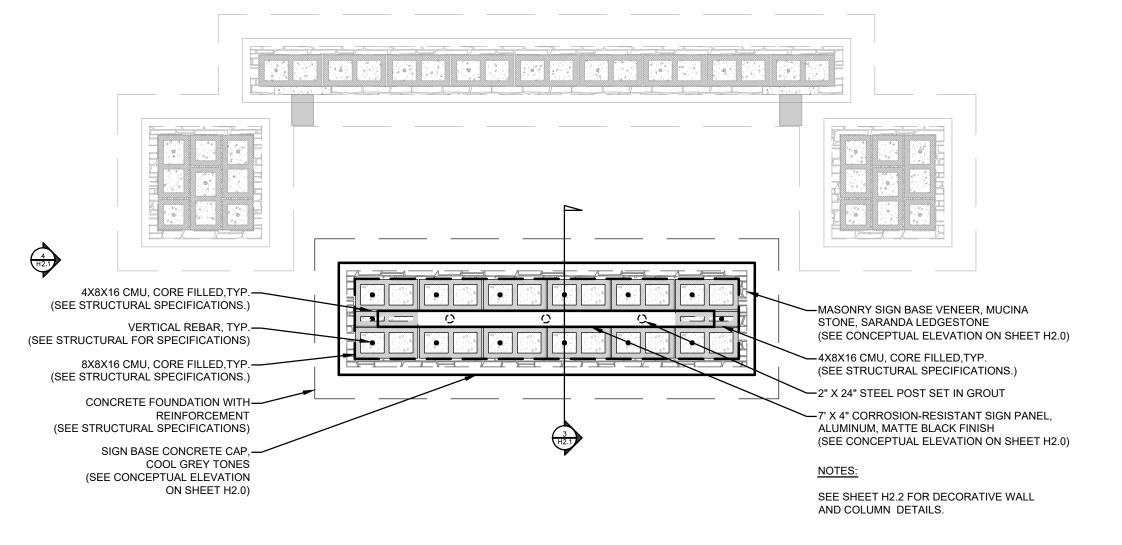

DIMENSIONAL LAYOUT

SCALE: 1/2" = 1'

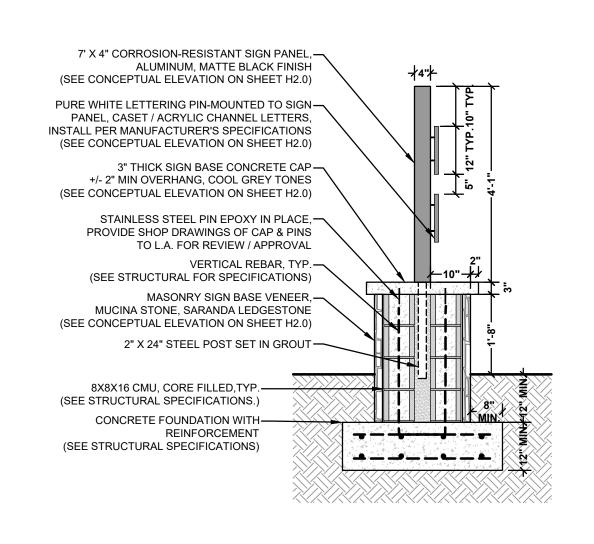

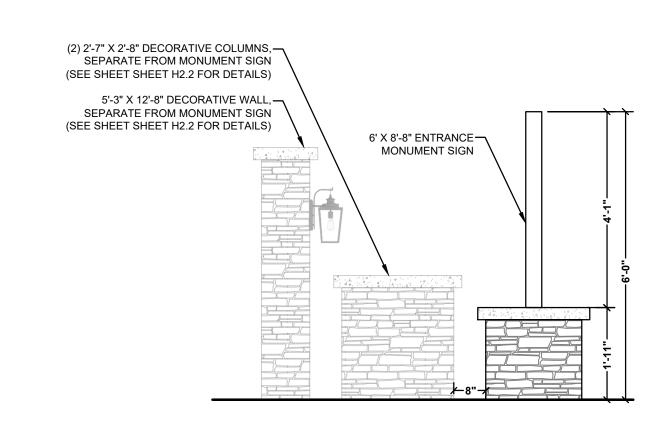


MONUMENT SIGN SECTION 3 SCALE: 1/2" = 1'

MONUMENT SIGN ELEVATION SCALE: 1/2" = 1'

MASON RIDGE - ENTRANCE MONUMENT
CONSTRUCTION DOCUMENTS
HORTON **ENTRANCE MONUMENT DETAILS**

PROJECT INFORMATION DESIGNED BY: DRAWN BY: PROJECT NUMBER: ORIGINAL DATE:

H2.1

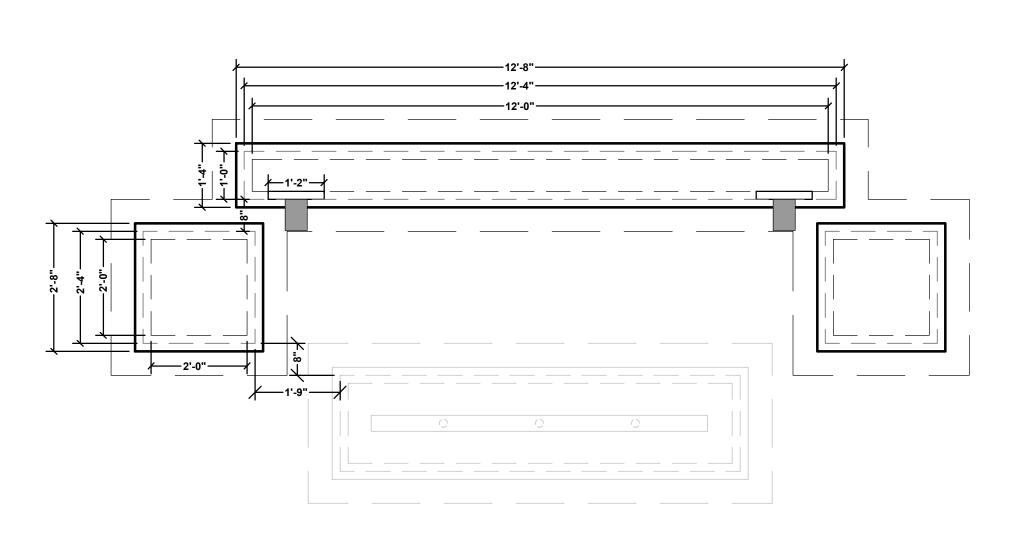


KEYSTONE, COOL GREY TONES-(SEE CONCEPTUAL ELEVATION ON SHEET H2.0) COLUMN SCONCE, POSSINI EURO 14"-LANTERN, BLACK FINISH
(SEE CONCEPTUAL ELEVATION ON SHEET H2.0) 8X8X16 CMU, CORE FILLED, TYP.-(SEE STRUCTURAL SPECIFICATIONS.) VERTICAL REBAR, TYP (SEE STRUCTURAL SPECIFICATIONS.) CONCRETE CAP, COOL GREY TONES-(SEE CONCEPTUAL ELEVATION ON MASONRY SIGN BASE VENEER, MUCINA -STONE, SARANDA LEDGESTONE (SEE CONCEPTUAL ELEVATION ON SHEET H2.0) SEE SHEET H2.1 FOR ENTRANCE MONUMENT SIGN DETAILS.

DIMENSIONAL LAYOUT


SCALE: 1/2" = 1'

WALL / COLUMN PLAN

SCALE: 1/2" = 1'

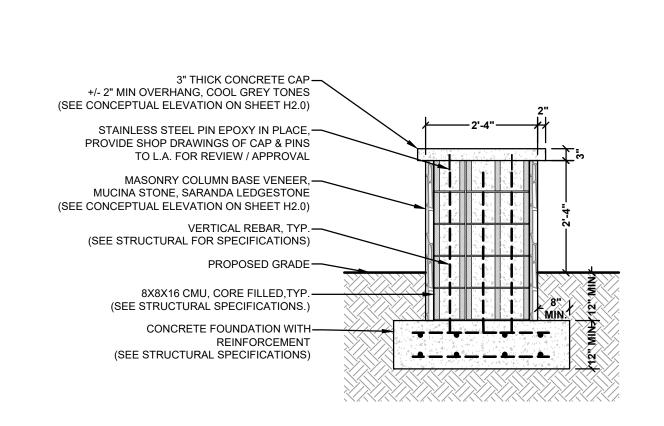

3" THICK CONCRETE CAP— +/- 2" MIN OVERHANG, COOL GREY TONES (SEE CONCEPTUAL ELEVATION ON SHEET H2.0) STAINLESS STEEL PIN EPOXY IN PLACE,-PROVIDE SHOP DRAWINGS OF CAP & PINS TO L.A. FOR REVIEW / APPROVAL 2" THICK CONCRETE KEYSTONE, COOL GREY TONES-(SEE CONCEPTUAL ELEVATION ON SHEET H2.0) COLUMN SCONCE, POSSINI EURO 14"-LANTERN, BLACK FINISH (SEE CONCEPTUAL ELEVATION ON SHEET H2.0) MASONRY SIGN BASE VENEER, MUCINA-STONE, SARANDA LEDGESTONE (SEE CONCEPTUAL ELEVATION ON SHEET H2.0) CONDUIT TO LIGHT FIXTURE. -CONCEAL WIRING AND CONDUIT. (SEE 'LIGHTING STANDARD NOTES') VERTICAL REBAR, TYP.-(SEE STRUCTURAL FOR SPECIFICATIONS) 8X8X16 CMU, CORE FILLED, TYP.-(SEE STRUCTURAL SPECIFICATIONS.) CONCRETE FOUNDATION WITH REINFORCEMENT (SEE STRUCTURAL SPECIFICATIONS)

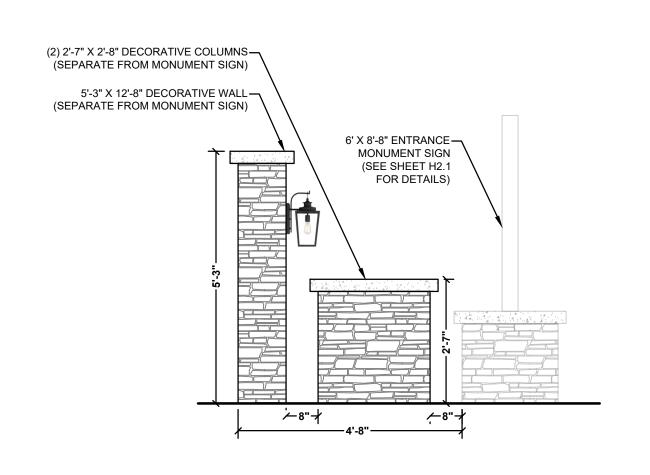

COLUMN: SECTION

WALL: SECTION

SCALE: 1/2" = 1'


WALL / COLUMN ELEVATION SCALE: 1/2" = 1'

DECORATIVE MASONRY DETAILS

MASON RIDGE - ENTRANCE MONUMENT
CONSTRUCTION DOCUMENTS
HORTON

PROJECT INFORMATION DESIGNED BY: DRAWN BY: PROJECT NUMBER: ORIGINAL DATE:

H2.2

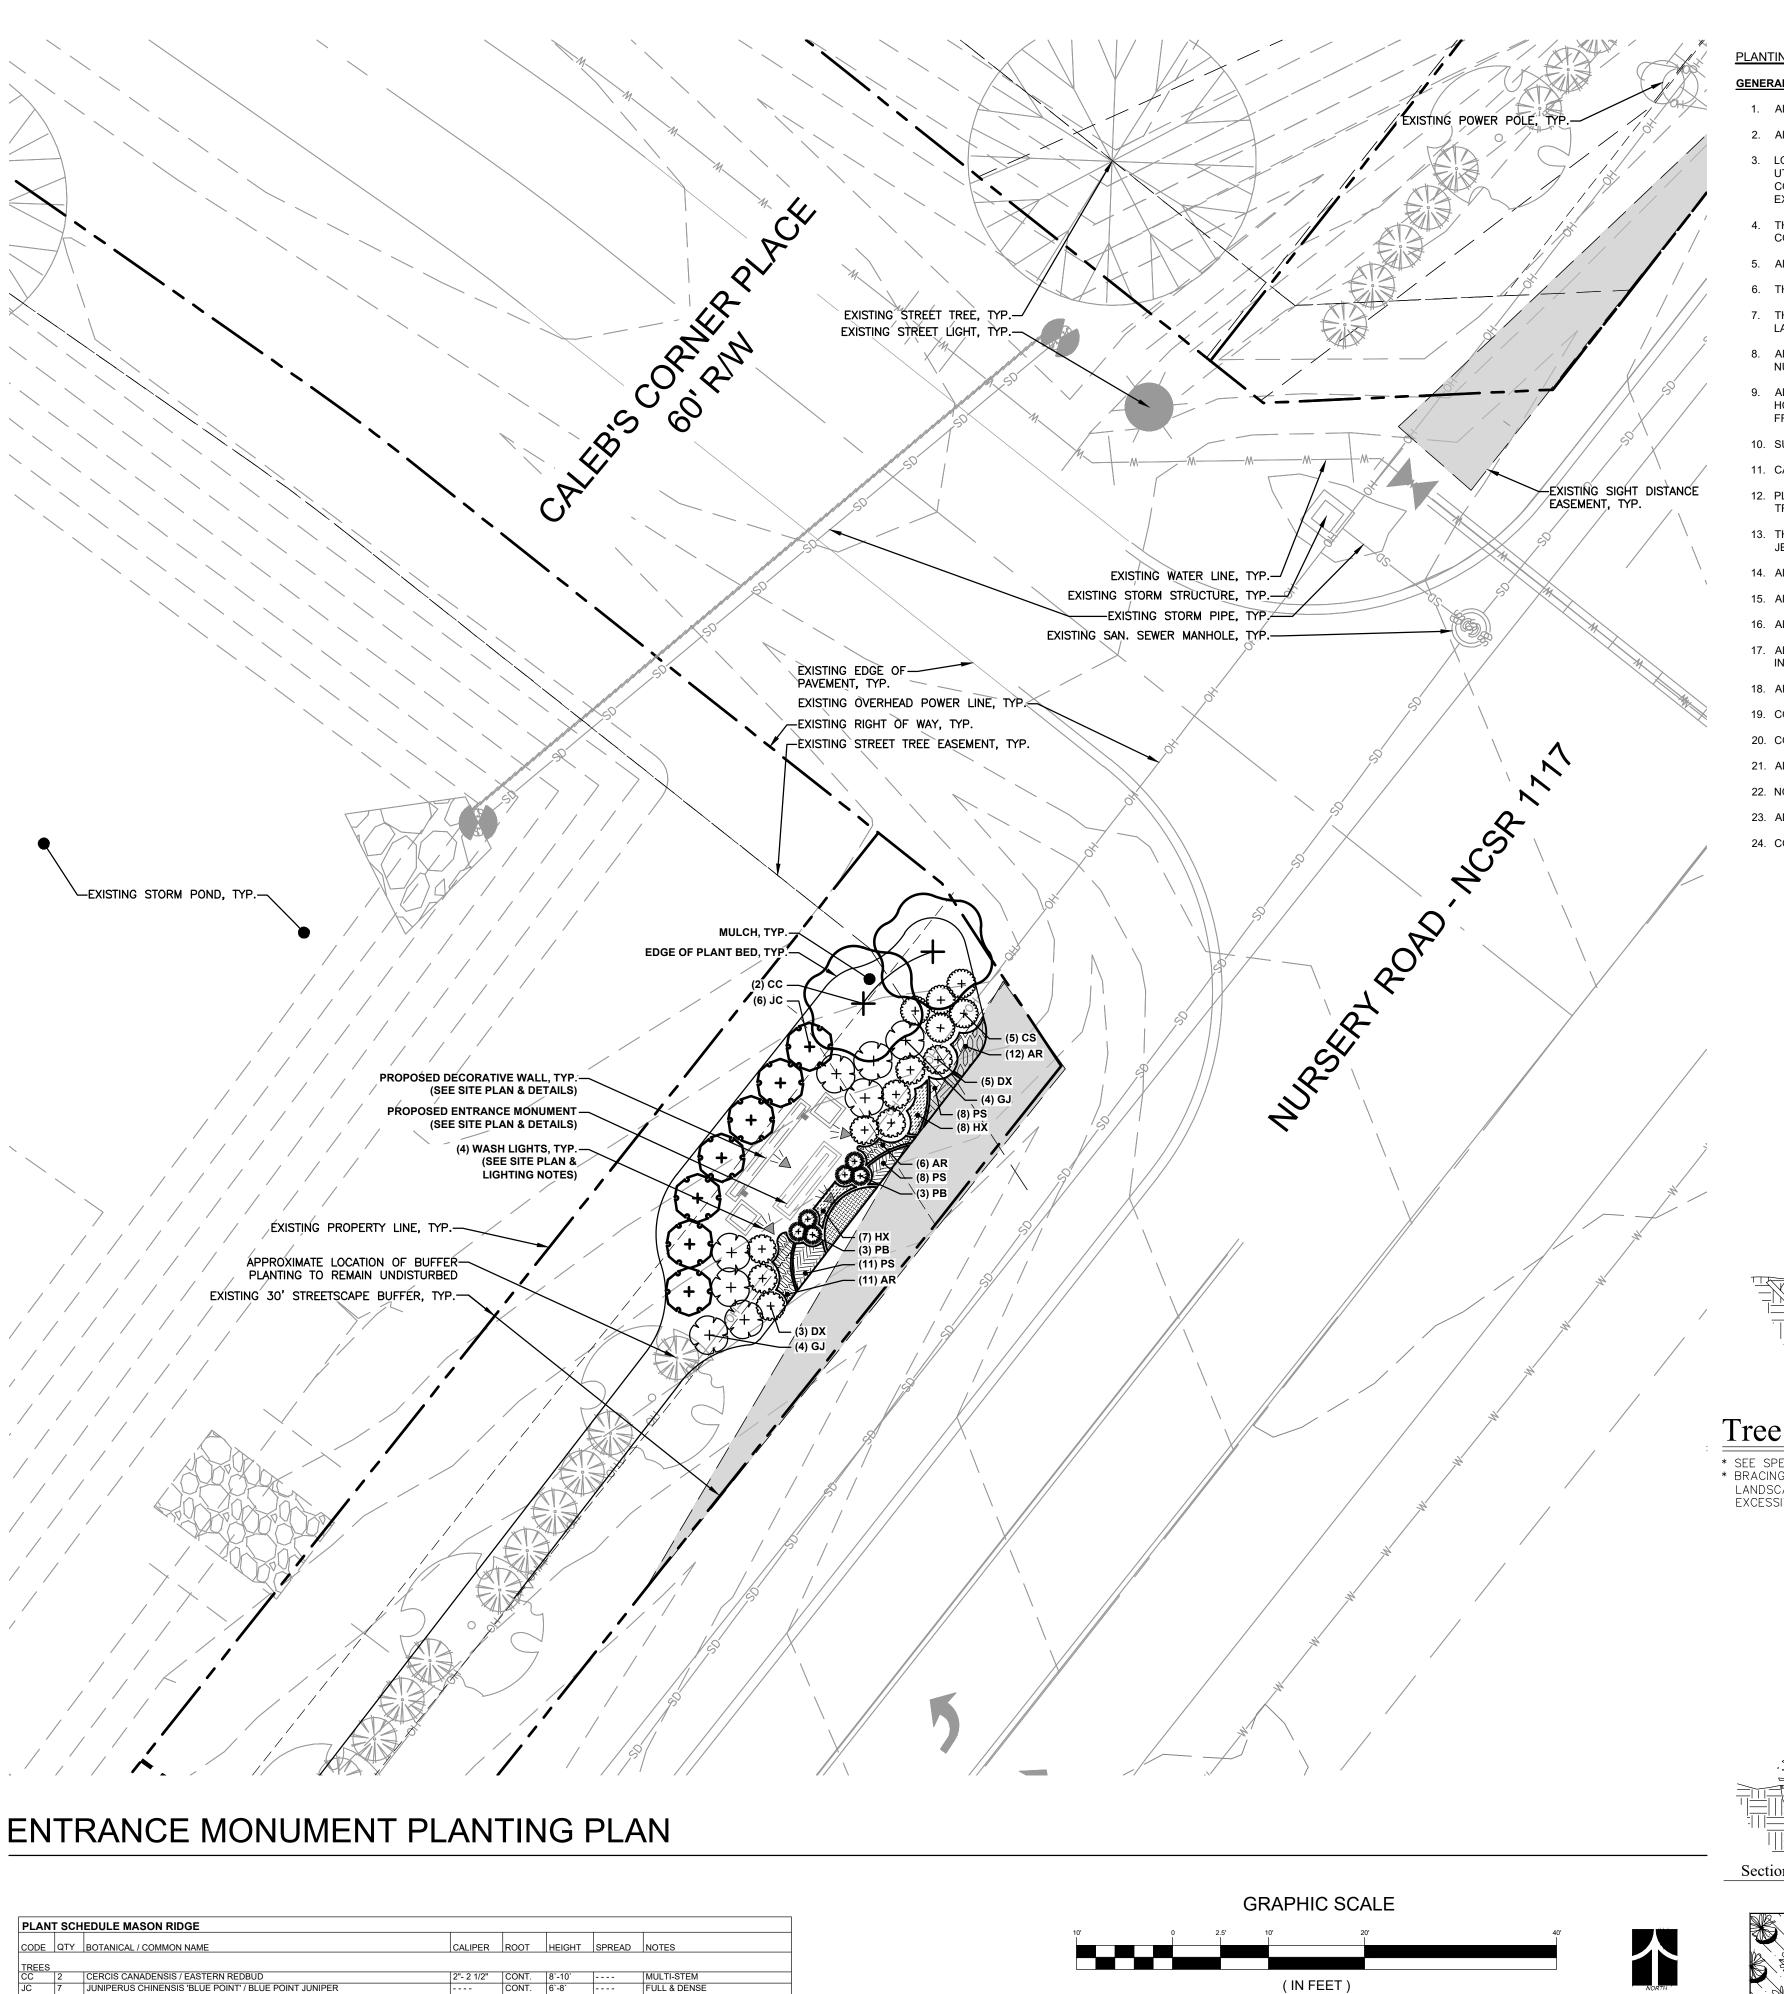

CODE QTY BOTANICAL / COMMON NAME

CODE QTY BOTANICAL / COMMON NAME

GROUND COVERS
AR | 29 | AJUGA REPTANS / CARPET BUGLE

DISTYLIUM X 'PIIDIST-V' / FIRST EDITIONS® CINNAMON GIRL® DISTYLIUM
GARDENIA JASMINOIDES 'FROSTPROOF' / FROSTPROOF GARDENIA


HX 15 HEMEROCALLIS X 'SUNDAY GLOVES' / SUNDAY GLOVES DAYLILY
PS 27 PHLOX SUBULATA 'AMAZING GRACE' / AMAZING GRACE CREEPING PHLOX


PENNISETUM ALOPECUROIDES 'LITTLE BUNNY' / LITTLE BUNNY FOUNTAIN GRASS

PLANTING NOTES:

GENERAL NOTES:

- 1. ALL MATERIALS AND METHODS OF CONSTRUCTION SHALL BE IN ACCORDANCE WITH THE HARNETT COUNTY AND THE STATE OF NORTH CAROLINA STANDARDS AND SPECIFICATIONS.
- 2. ALL LANDSCAPE WORK SHALL BE PROVIDED BY OR UNDER THE SUPERVISION OF A LICENSED NC LANDSCAPE CONTRACTOR.
- 3. LOCATIONS OF EXISTING UTILITY LINES SHOWN ON PLANS ARE BASED UPON BEST AVAILABLE INFORMATION AND CONSIDERED APPROXIMATE. THE CONTRACTOR SHALL BE RESPONSIBLE FOR LOCATING ALL UNDERGROUND UTILITIES IN AND ADJACENT TO THE WORK AREAS PRIOR TO THE BEGINNING OF WORK. ALL UTILITY LINES SHALL BE PROTECTED DURING THE CONSTRUCTION TO AVOID DAMAGE. HAND EXCAVATE, AS REQUIRED. THE CONTRACTOR SHALL BE RESPONSIBLE FOR REPAIRING ANY AND ALL UTILITIES, STRUCTURES, SITE APPURTENANCES, ETC. DAMAGED DURING CONSTRUCTION OR INSTALLATION OF PLANT MATERIAL AT CONTRACTOR'S
- 4. THE LOCATION OF ALL EXISTING UTILITIES SHALL BE CONFIRMED PRIOR TO BEGINNING CONSTRUCTION. CALL "NC ONE-CALL", 1-800-632-4949. THE OWNER SHALL BE NOTIFIED OF ANY DISCREPANCIES BETWEEN FIELD CONDITIONS AND THOSE SHOWN ON THE PLAN.
- 5. ALL DIMENSIONS AND ELEVATIONS SHALL BE VERIFIED IN THE FIELD PRIOR TO CONSTRUCTION. ANY DISCREPANCIES SHALL BE BROUGHT TO THE ATTENTION OF THE LANDSCAPE ARCHITECT.
- 6. THE LANDSCAPE CONTRACTOR SHALL FURNISH AND INSTALL ALL PLANT MATERIALS, LABOR AND OTHER MATERIALS NECESSARY TO COMPLETE THE WORK AS SHOWN ON THE PLANS AND DETAILS.
- 7. THE CONTRACTOR SHALL BE RESPONSIBLE FOR VERIFYING ALL QUANTITIES SHOWN IN THE PLANT SCHEDULE AND MATCH QUANTITIES ON THE PLANS PRIOR TO PRICING WORK. SHOULD DISCREPANCIES OCCUR, THE LANDSCAPE ARCHITECT SHALL BE NOTIFIED PRIOR TO BIDDING.
- 8. ALL PLANT MATERIAL SHALL MEET MINIMUM SIZE STANDARDS, INCLUDING THE MINIMUM HEIGHT, WIDTH, ROOT BALL SIZE AND NUMBER OF BRANCHES, SET FORTH IN THE LATEST EDITION OF THE "AMERICAN STANDARD FOR NURSERY STOCK" PUBLISHED BY THE AMERICAN ASSOCIATION OF NURSERYMEN (AAN) FOR THE TYPE OF TREE OR SHRUB AT THE TIME OF INSTALLATION.
- ALL PLANTS SHALL BE NURSERY GROWN UNDER THE SAME CLIMATE CONDITIONS AS THE LOCATION OF THE PROJECT FOR AT LEAST TWO YEARS BEFORE PLANTING. ALL PLANTS SHALL BE IN ACCORDANCE WITH GOOD HORTICULTURAL PRACTICES, HEALTHY, VIGOROUS, AND FREE OF INSECTS, EGGS, LARVAE, DISEASES AND DEFECTS SUCH AS KNOTS, SUN-SCALD, INJURIES, ABRASIONS OR DISFIGUREMENT. PLANT MATERIAL COLLECTED FROM NATURALIZED AREAS SHALL BE REJECTED.
- 10. SUBSTITUTIONS IN PLANT SPECIES OR SIZE SHALL NOT BE PERMITTED EXCEPT WITH THE WRITTEN APPROVAL OF THE LANDSCAPE ARCHITECT.
- 11. CALIPER, HEIGHT AND WIDTH SPECIFICATIONS INDICATED ON THE PLANT SCHEDULE SHALL TAKE PRECEDENCE OVER CONTAINER SIZE.
- 12. PLANT SIZES SHOWN IN THE PLANT SCHEDULE ARE THE MINIMUM SIZES BEFORE PRUNING. ANY NECESSARY PRUNING APPROVED BY LANDSCAPE ARCHITECT SHALL BE PERFORMED AT THE TIME OF PLANTING IF NEEDED.
 TREES AND SHRUBS OF LARGER SIZE MAY BE INSTALLED IF SIZES OF THE ROOTS OR BALLS ARE INCREASED PROPORTIONATELY.
- 13. THE CONTRACTOR IS RESPONSIBLE FOR INSTALLING PLANTS TO MEET THE MINIMUM SIZE AND SPACING FOR CODE COMPLIANCE. FAILURE TO INSTALL THE PLANT MATERIAL PER THE PLAN AND PLANT SCHEDULE MAY JEOPARDIZE ISSUANCE OF FINAL CERTIFICATE OF OCCUPANCY. CONTRACTOR SHALL BE RESPONSIBLE FOR SCHEDULING INSPECTIONS OF PLANT MATERIAL.
- 14. ALL SHADE/CANOPY/STREET TREES SHALL BE GRADE 'A' SPECIMENS WITH A STRAIGHT MAIN LEADER AND FULL HEAD.
- 15. ALL TREES OF THE SAME VARIETY SHALL MATCH IN SHAPE AND SIZE WHEN INSTALLED AS GROUPS, ROWS OR STREET TREES.
- 16. ALL PLANTS SHALL BE BALLED AND BURLAPPED OR CONTAINER GROWN AS INDICATED IN THE PLANT SCHEDULE.
- 17. ALL PLANTS SHALL BE SUBJECT TO THE APPROVAL OF THE LANDSCAPE ARCHITECT BEFORE, DURING AND AFTER INSTALLATION FOR COMPLIANCE WITH REQUIREMENTS FOR NAME, VARIETY, SIZE, QUALITY AND INSTALLATION.
- 18. AREAS DAMAGED BY ACTIVITIES OF THE LANDSCAPE CONTRACTOR SHALL BE RESEEDED/REPLANTED AND REPAIRED AT NO ADDITIONAL COST TO THE OWNER.
- 19. CONTRACTOR SHALL PROVIDE TREES PROTECTION FENCING PER THE PLANS AND TREE PROTECTION FENCE DETAIL TO PROTECT ANY EXISTING TREES, SHRUBBERY AND PLANTING BEDS IN THE PLANTING AREA.
- 20. CONTRACTOR SHALL OBTAIN AUTHORIZATION PRIOR TO ANY CHANGES OF PLANT LOCATIONS DUE TO UTILITIES OR OTHER CONFLICTS.
- 21. ALL STRUCTURES, WALLS, PIERS AND PLANT BED LOCATIONS SHALL BE FIELD STAKED BY THE CONTRACTOR AND LOCATION APPROVED BY THE OWNER PRIOR TO CONSTRUCTION/ INSTALLATION.
- 22. NO WORK SHALL BE PERFORMED IN THE PUBLIC RIGHT-OF-WAY UNLESS ALL REQUIRED PERMITS ARE OBTAINED.
- 23. ALL EQUIPMENT AND TOOLS SHALL BE PLACED SO AS NOT TO INTERFERE OR HINDER PEDESTRIAN OR VEHICULAR TRAFFIC FLOW.
- 24. CONTRACTOR TO FIELD VERIFY BUFFER PLANTING PRIOR TO PLANTING INSTALLATION. ANY DISCREPANCIES SHALL BE BROUGHT TO THE ATTENTION OF THE LANDSCAPE ARCHITECT.

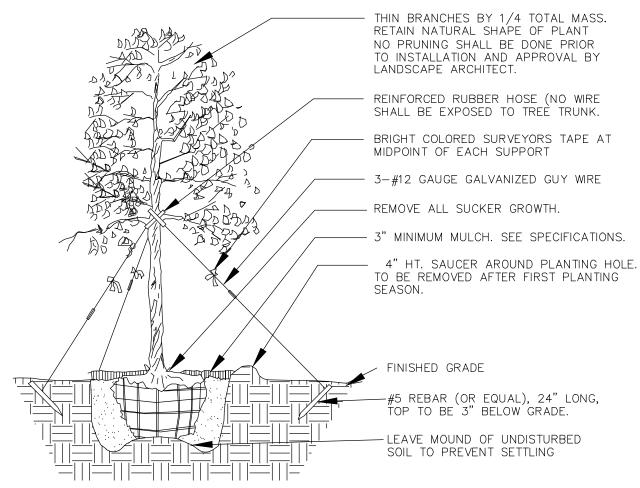

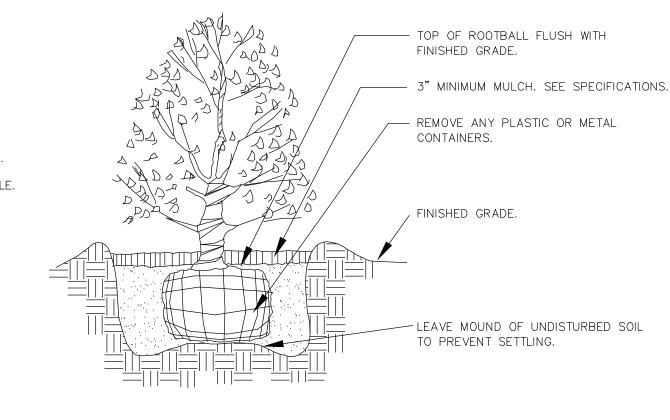

Tree Planting

* SEE SPECIFICATIONS FOR BACKFILL MIXTURE AND FERTILIZATION


* BRACING — SPECIAL SITE CONDITIONS MAY REQUIRE MODIFICATION TO BRACING TECHINQUE.


LANDSCAPE CONTRACTOR WILL ADEQUATELY BRACE (OR WIRE) ALL TREES TO PREVENT

EXCESSIVE MOVEMENT & MAINTAIN A VERTICAL POSITION.

Shrub Planting

* SEE SPECIFICATIONS FOR BACKFILL MIXTURE AND FERTILIZATION.

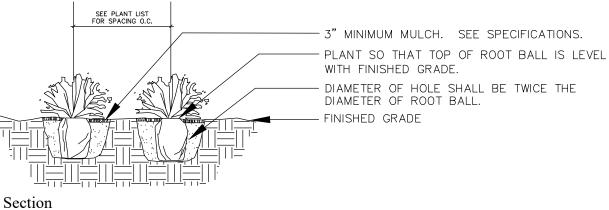

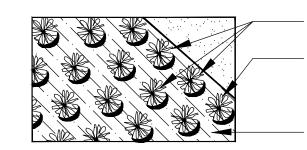

ALTERNATE SPACING OF PLANTS TO ASSURE PROPER COVERAGE OF GROUNDCOVER.
 CUTTINGS: THOROUGHLY WORK IN 2" OF BACKFILL MIXTURE TO A MINIMUM DEPTH OF 4". LOOSELY TILL ENTIRE PLANT BED.

— 3" MINIMUM MULCH. SEE SPECIFICATIONS.

Groundcover Planting

1 INCH = 10 FT.

 * SEE SPECIFICATIONS FOR BACKFILL MIXTURE AND FERTILIZATION.


PLANTING PLAN

MASON RIDGE - ENTRANCE MONUMENT

CONSTRUCTION DOCUMENTS

PROJECT INFORMATION			
PROJECT MANAGER:	MS		
DESIGNED BY:	AL		
DRAWN BY:	BA		
PROJECT NUMBER:	24-01007		
ORIGINAL DATE:	09/10/2024		

L1.0

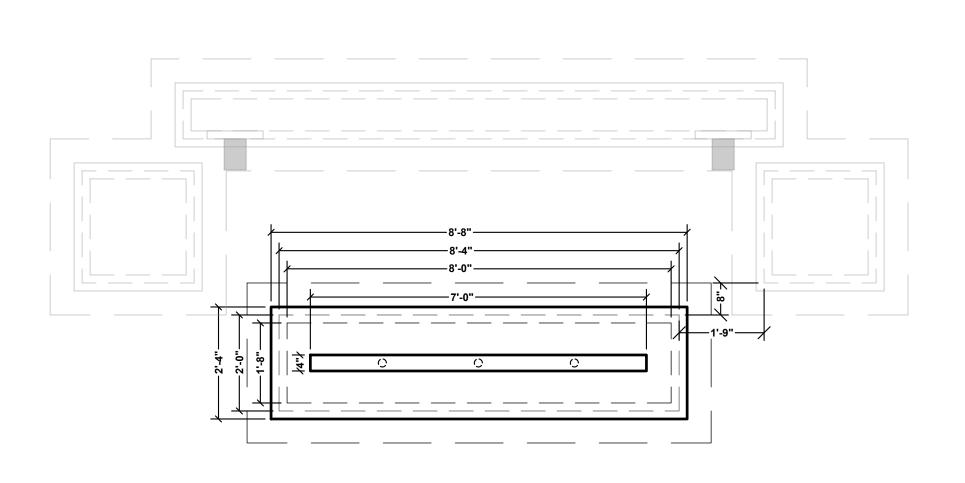



4X8X16 CMU, CORE FILLED, TYP. -MASONRY SIGN BASE VENEER, MUCINA STONE, SARANDA LEDGESTONE #4 VERTICAL REBAR AT 16" O.C. AND EACH CORNER, (SEE CONCEPTUAL ELEVATION ON SHEET H2.0) EMBED IN FOOTING WITH STANDARD HOOK -4X8X16 CMU, CORE FILLED, TYP. 8X8X16 CMU, CORE FILLED, TYP.--2" X 24" STEEL POST SET IN GROUT 12" THICK CONC. FOOTING WITH 12" MIN. PROJECTION, __ INSTALL #4 REBAR AT 8" O.C.E.W. WITH 3" MIN. COVER -7' X 4" CORROSION-RESISTANT SIGN PANEL, ALUMINUM, MATTE BLACK FINISH (SEE CONCEPTUAL ELEVATION ON SHEET H2.0) SIGN BASE CONCRETE CAP,— COOL GREY TONES (SEE CONCEPTUAL ELEVATION ON SHEET H2.0) SEE SHEET H2.2 FOR DECORATIVE WALL AND COLUMN DETAILS.

DIMENSIONAL LAYOUT

SCALE: 1/2" = 1'

SIGN PLAN

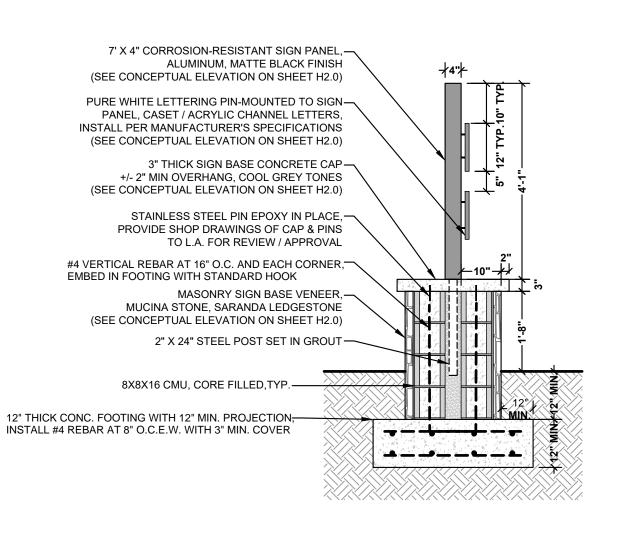

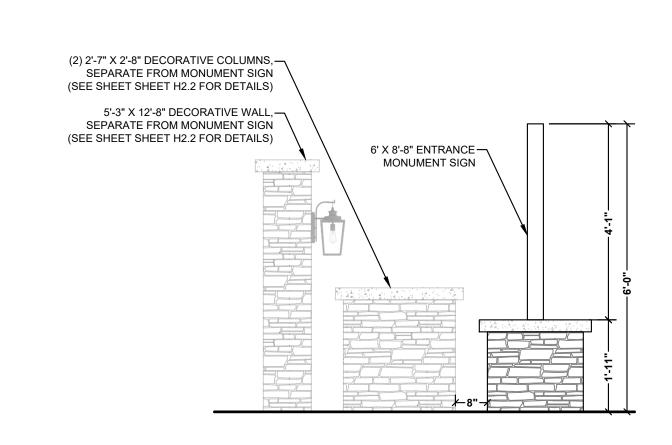

MONUMENT SIGN SECTION SCALE: 1/2" = 1'

MONUMENT SIGN ELEVATION SCALE: 1/2" = 1'

CONCRETE GENERAL NOTES:

EXCEPT WHERE OTHERWISE NOTED, FOR ALL CONCRETE, THE PROPORTIONS OF CEMENT, AGGREGATE, AND WATER TO ATTAIN REQUIRED PLASTICITY AND COMPRESSIVE STRENGTH SHALL BE IN ACCORDANCE WITH ACI 318 CODE. CONCRETE SHALL BE 2,500 PSI IN 28 DAYS FOR FOOTINGS

<u>GENERAL NOTES</u>


1) All rebar splices shall be a minimum of 2'-0" unless otherwise noted.

2) Shallow foundations are designed for an assumed soil bearing capacity of 2,000 psf. The contractor is responsible for notifying the Engineer of Record if any soils are found to be unsuitable for this bearing capacity. The contractor is responsible for obtaining soil testing to ensure that the bearing capacity of the soil meets or exceeds this value. All fill is to be compacted to 95% density as measured by the Standard Proctor Test (ASTM D-1557).

3) All footing excavations shall be neat, straight, and level in the proper elevations to receive the concrete. Excessive variations in the dimensions of footings or slabs will not be permitted. Reinforcing steel and mesh shall be accurately placed and supported to maintain their position during the concrete pouring. Edge forms shall be used for concrete that will be exposed.

4). Masonry construction shall comply with the provisions of ACI 530. Mortar shall comply with ASTM C270. Minimum corrosion protection of joint reinforcement and anchor ties shall comply with ASTM A641, Class 3.



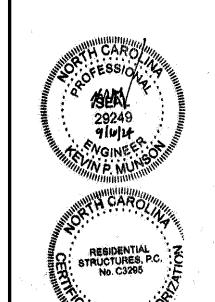


RESIDENTIAL STRUCTURES, RC. 3410 N. Davidson St. Charlotte, N.C. 28205 Seal For Structures Quily

DETAILS

ENTRANCE MONUMENT

MASON RIDGE - ENTRANCE MONUMENT
CONSTRUCTION DOCUMENTS
HORTON

DESCRIPTION DESIGNER:

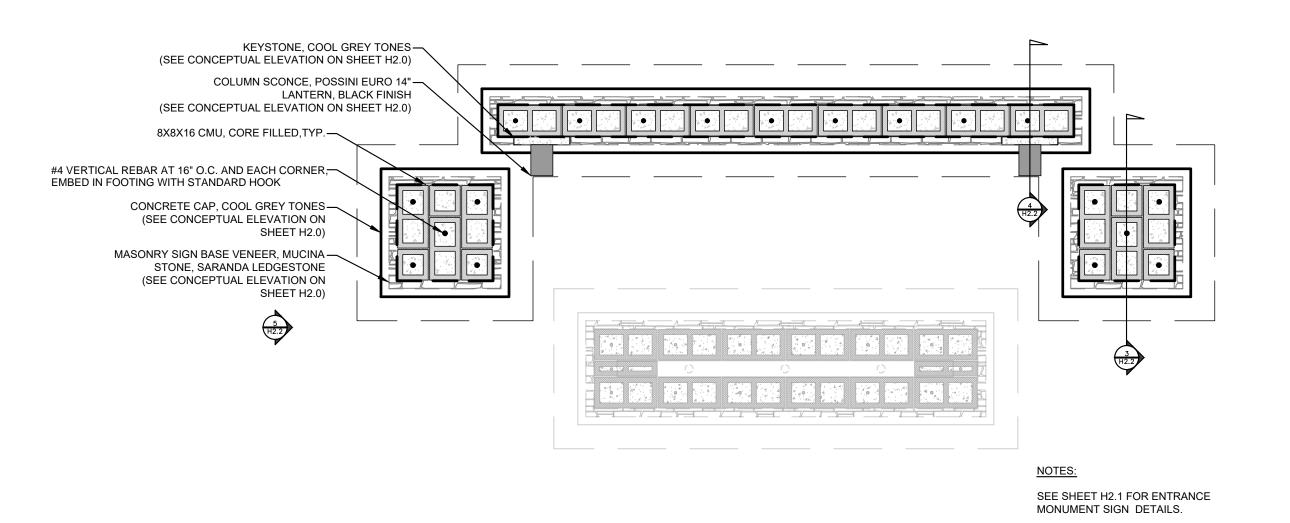


DIMENSIONAL LAYOUT


SCALE: 1/2" = 1'

WALL / COLUMN PLAN

SCALE: 1/2" = 1'

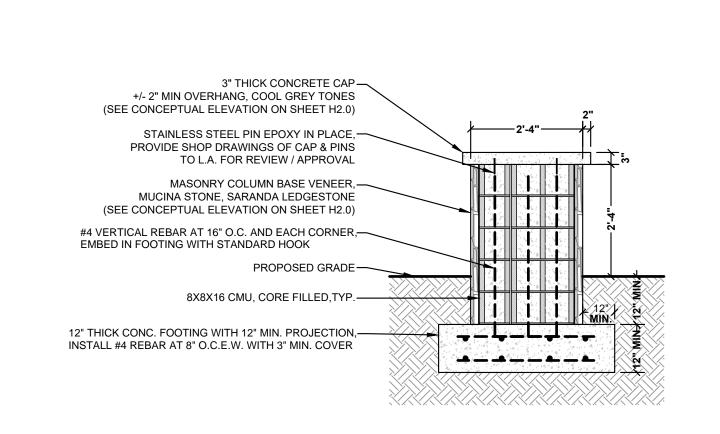

+/- 2" MIN OVERHANG, COOL GREY TONES (SEE CONCEPTUAL ELEVATION ON SHEET H2.0) STAINLESS STEEL PIN EPOXY IN PLACE,— PROVIDE SHOP DRAWINGS OF CAP & PINS TO L.A. FOR REVIEW / APPROVAL 2" THICK CONCRETE KEYSTONE, COOL GREY TONES— (SEE CONCEPTUAL ELEVATION ON SHEET H2.0) COLUMN SCONCE, POSSINI EURO 14"-LANTERN, BLACK FINISH (SEE CONCEPTUAL ELEVATION ON SHEET H2.0) MASONRY SIGN BASE VENEER, MUCINA -STONE, SARANDA LEDGESTONE (SEE CONCEPTUAL ELEVATION ON SHEET H2.0) CONDUIT TO LIGHT FIXTURE. -CONCEAL WIRING AND CONDUIT. (SEE 'LIGHTING STANDARD NOTES') #4 VERTICAL REBAR AT 16" O.C. AND EACH CORNER, EMBED IN FOOTING WITH STANDARD HOOK PROPOSED GRADE— 8X8X16 CMU, CORE FILLED, TYP 12" THICK CONC. FOOTING WITH 12" MIN. PROJECTION,— INSTALL #4 REBAR AT 8" O.C.E.W. WITH 3" MIN. COVER

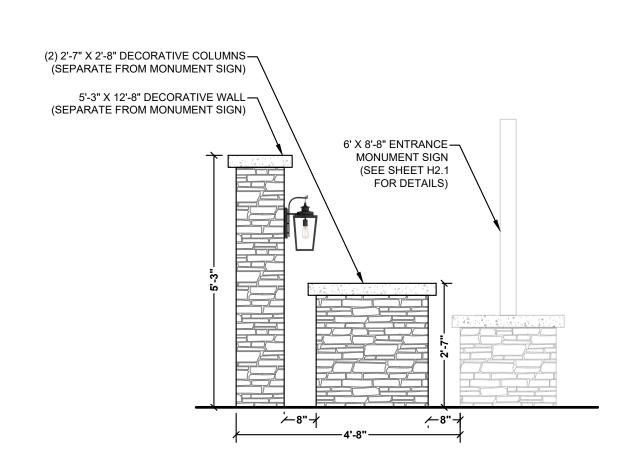

3 COLUMN: SECTION

SCALE: 1/2" = 1'

WALL: SECTION

SCALE: 1/2" = 1'

WALL / COLUMN ELEVATION

SCALE: 1/2" = 1'

CONCRETE GENERAL NOTES:

EXCEPT WHERE OTHERWISE NOTED, FOR ALL CONCRETE, THE PROPORTIONS OF CEMENT, AGGREGATE, AND WATER TO ATTAIN REQUIRED PLASTICITY AND COMPRESSIVE STRENGTH SHALL BE IN ACCORDANCE WITH ACI 318 CODE. CONCRETE SHALL BE 2,500 PSI IN 28 DAYS FOR FOOTINGS

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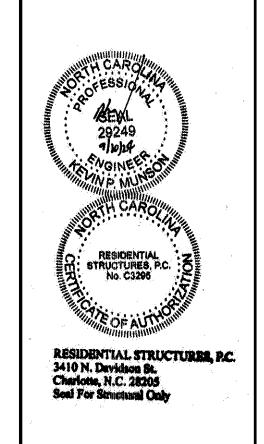
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ENGINEERING & DESIGN A

Residential Structures, P.C. Engineering and Design Charlotte: 704-332-5460 Charleston: 843-406-7174 Myrtle Beach/Florence: 704-301-9521



DECORATIVE MASONRY DETAILS

MASON RIDGE - ENTRANCE MONUMENT

CONSTRUCTION DOCUMENTS

HARNETT COUNTY,

REV. DATE DESCRIPTION
DESIGNER:

SCALE:

PATE:

S_2