




1608 NC 24-87 Cameron, NC March 03, 2019



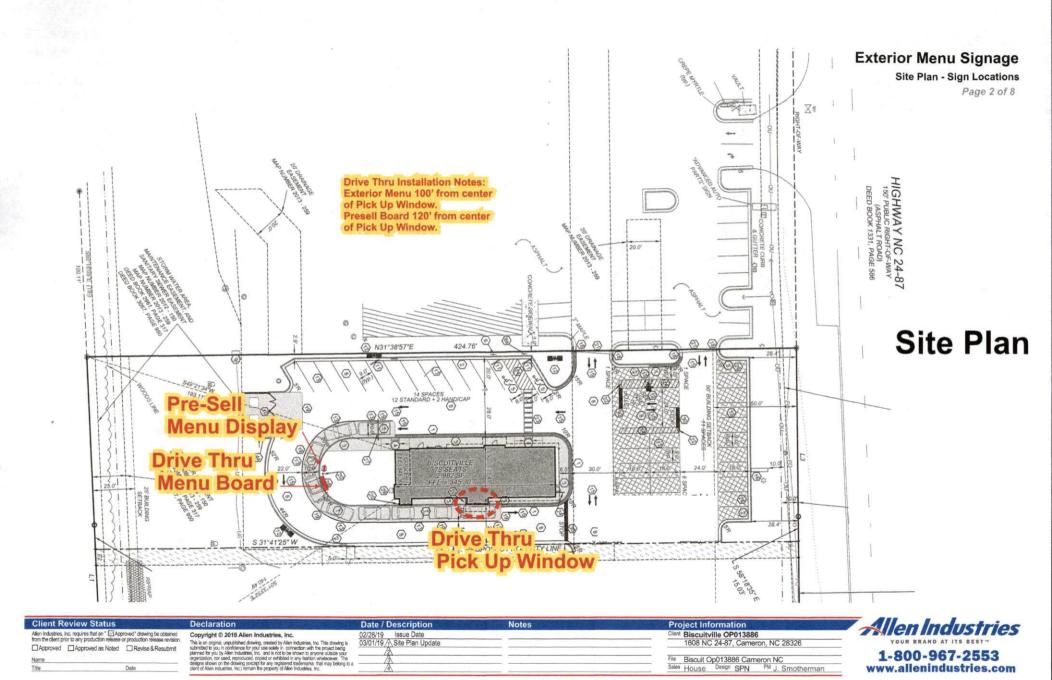


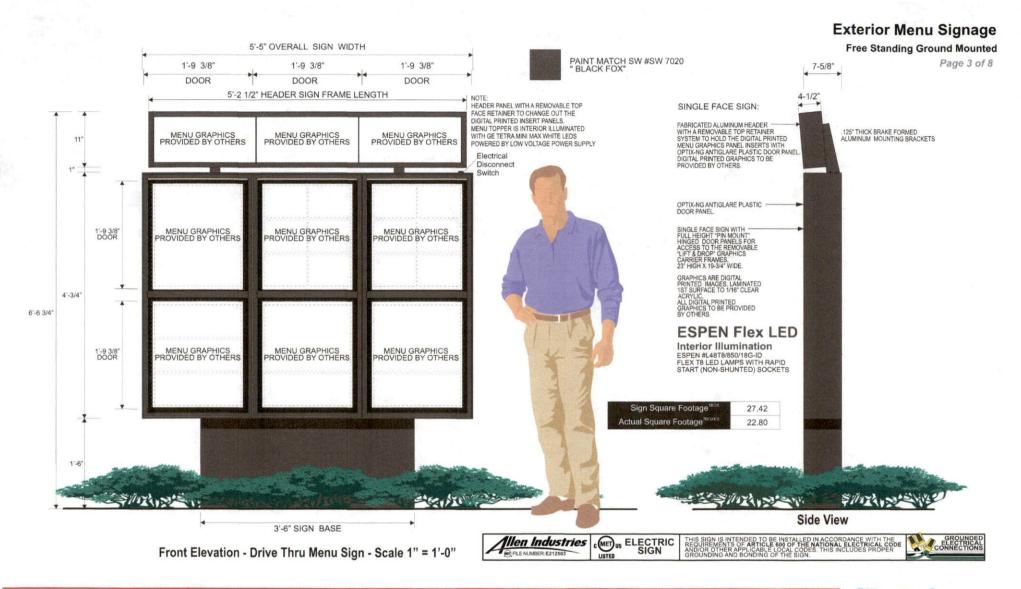


		Notes	Project Information	
Alen industries, inc. requires that an "Ell-Approved" drawing be obtained from the client prior to any production relesses or production relesses relesses. The same release re	Allen Industries, Inc. This drawing is 03/01/19 A Site Plan Update		Cilent Biscuitville OP013886 1608 NC 24-87, Cameron, NC 28326	Allen Industries YOUR BRAND AT ITS BEST
Name place of the page of the	to be shown to anyone outside your stand in any fashion whatsonver. The discreti redermake that may be shown to a stereof redermake that may be shown to a		File Biscuit Op013886 Cameron NC Sales House Design SPN PM J. Smotherman	1-800-967-2553 www.allenindustries.com

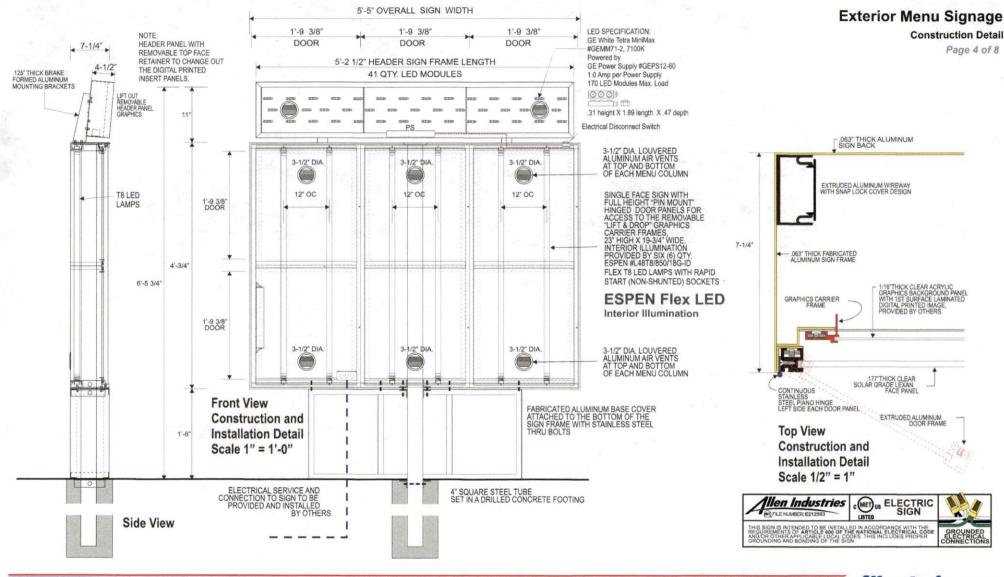

Allen Industries Client Review Status Declaration Date / Description Notes **Project Information** Allen Industries, Inc. requires that an " Approved" drawing be obtained from the client prior to any production release or production release revision Copyright © 2018 Allen Industries, Inc. Biscuitville OP013886 Issue Date Copyright w 2x or views in museus way, in the same origin, put his same origin, putphished drawing or used by Alein Industries. Inc. This drawing is submated to your out-office with or your one safety in connection with the project being under the project being originated in a connection, and a project being originated in any settion of without on the drawing (second for any teglisted stademarks that may belong to ident of Alein Industries, Inc.) remain the property of Alein Industries, Inc.) remain the property of Alein Industries, Inc.) remain the property of Alein Industries, Inc.) remain the group of Alein Industries, Inc. Tenta the group of Alein Industries and Industrie 1608 NC 24-87, Cameron, NC 28326 Site Plan Undate □ Approved □ Approved as Noted □ Revise & Resubmit 1-800-967-2553 File Biscuit Op013886 Cameron NC
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1'-6"0

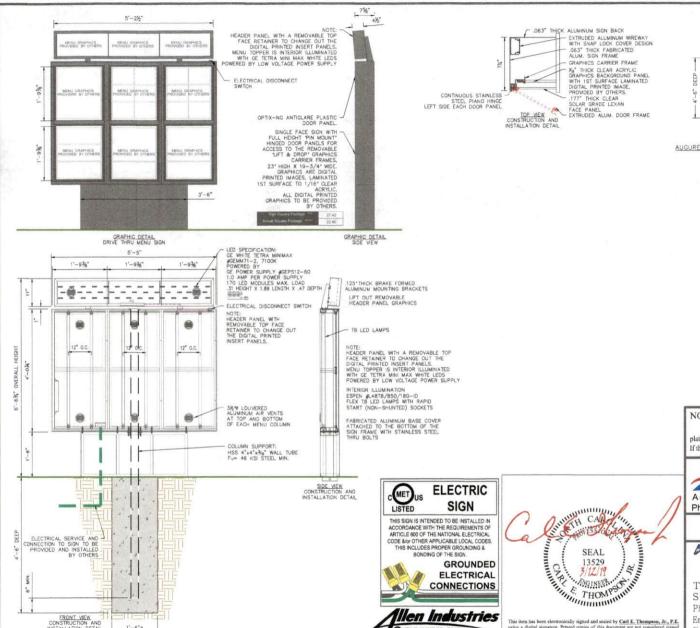

GENERAL NOTES:

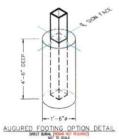- All design, detailing, fabricating and construction shall conform to
- the following codes and specifications:
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 The International Building Code (2015 Edition).
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 Specification for the Design, Fabrication and Erection of Structural
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- Aluminum Association Aluminum Design Manual (2005 Edition).
- Concrete shall be t'c=2,500 P.S.I. @ 28 days Compressive Strength, STD WT (150 P.C.F.)
- Reinforcing Steel shall be ASTM A-615 Grade 60, (#mounts).

surfaces deposited against the ground except as noted.

- All reinforcing steel shall be free from mud, oil, rust or coatings that would reduce or destroy band. It used to both shall reinforcing the shall be free from mud, oil, rust or coatings that would reduce or destroy band. All reinforcing bots shall go 30 diameters mismum, except as noted. Minimum contrate cover on tes, stimps and main bars shall be 3/4 inch for side, well and surfaces not exposed to weather or in contact with ground: 3 inches for unformed
- Structural Material Specifications:
 a. Aluminum shapes shall be extruded from 5061-16 alloy.
 Weiding filler alloy shall be 4043.
 b. Structural Steel and Plates shall be A-38
- W-Shape beams shall be ASTM A-992 (Fy=50 ksi) Minimum
- Structural tubing shall be ASTM A-500, Grade B, (F₂=46 ksi)
 Structural piping shall be ASTM A-52, Grade B, Tipe E or S, (F₂=35 ksi), ASTM A572 Grade 42 (F-42 kg) or ASTM 4572 Grade 50 (F-50 kg).
- Ancher Bolts (if required) shall be ASTM F-1554 Grade 36, unless otherwise noted.
- High strength bolts (<u>Frequired</u>) for connections shall be ASTM A-325, unless otherwise noted.
- Welding electrodes shall comply with AWS D1.1-(Current Edition), E70XX. (All waiting to be done by welder certified for specified weld type.)
- Design Wind Speed, V_{ULY}= 120 MPH (ASCE 7-10) Equivalent Wind Load, P_{ASC}= 20.2 PSF **6** 6:-6 3/4* above the ground (3 See Wind Gusts.) Exposure © Risk Category II I_P=1.0 G=8.85
- Soil Bearing Capacity Requirements:
 a. Minimum Allowable Vertical Bearing Capacity shall be 1,550 P.S.F.
 Minimum Lateral Bearing Capacity shall be
 (150 FF * 2)=350 P.S.F. per foot of depth.
 (Times two increase per NBCS C
- Contractor shall verify all dimensions and conditions in the field before erection and notify the Engineer of any discrepancies.

This drawing is for permit procurement purposes only. T.E.S. is responsible for column support, base plate, anchor bolt & foundation design only. All other components are the responsibility of the sign manufacturer. If the existing wall is questionable or subst&ard, the installer shall notify the engineer immediately.

Address: 6434 Burnt Poplar Road, Greensboro, NC 27409 Phone: (888) 294-2007 www.allenindustries.com

> Biscuitville | Menu Board 4'-03/4" x 5'-5" @ 6'-53/4" O.A.H. Location: Biscuitville, 1608 NC 24-87, Cameron, NC 28326



Phone: (423)781-7336 Fax: (423)781-7337 Website:tesengrs.com Email:engineering@tesengrs.com P.O. Box 1500, Englewood, TN 37329

DRAWN BY: D.P. Ward DATE: March 12, 2019 ALLEN P.O.# 180733 1/2"=1'-0" SCALE PROJ.# 032419 DWG.# EB-8194 1 OF

This item has been electronically signed and sealed by Carl E. Thompson, Jr., P.E. using a digital signature. Printed copies of this document are not considered signed and sealed and the signature must be verified on any electronic copies.

ELECTRICAL


CONNECTIONS

llen Industries

FILE NUMBER: E212503

Exterior Menu Signage

Sign Construction

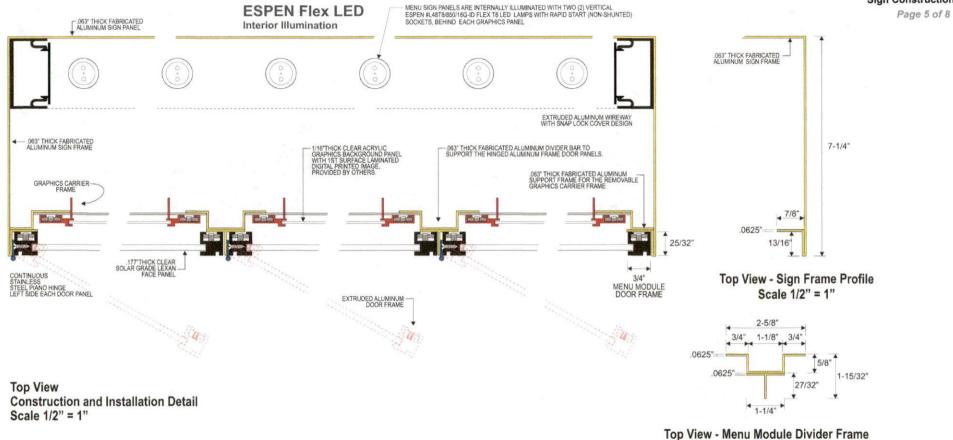





Scale 1/2" = 1"




Client Review Status	Declaration	Date / Description	Notes	Project Information	Allen Industries
Allen Industries, Inc. requires that an " Approved" drawing be obtained from the client prior to any production release or production release revision.	Copyright © 2018 Allen Industries, Inc.	02/28/19 Issue Date		Client Biscuitville OP013886	
□ Approved □ Approved as Noted □ Revise & Resubmit	This is an original, unpublished drawing, created by Allen Industries, Inc. This drawing is submitted to you in confidence for your use solely in connection with the project being	03/01/19 Site Plan Update		1608 NC 24-87, Cameron, NC 28326	YOUR BRAND AT ITS BEST
Name	planned for you by Allen Industries, Inc. and is not to be shown to anyone outside your organization, nor used, reproduced, copied or exhibited in any feshion whatsoever. The	<u></u>		File Biscuit Op013886 Cameron NC	1-800-967-2553
Title Date	designs shown on the drawing (except for any registered trademarks, that may belong to a client of Alian Industries, Inc.) remain the property of Alian Industries, Inc.	A		Sales House Design SPN PM J. Smotherman	www.allenindustries.com

Exterior Menu Signage


THIS SIGN IS INTENDED TO BE INSTALLED IN ACCORDANCE WITH THE REQUIREMENTS OF ARTICLE 600 OF THE NATIONAL ELECTRICAL CODE AND/OR OTHER APPLICABLE LOCAL CODES. THIS INCLUDES PROPER GROUNDING ON THE SIGN.


Pre-Sale Board

Page 6 of 8

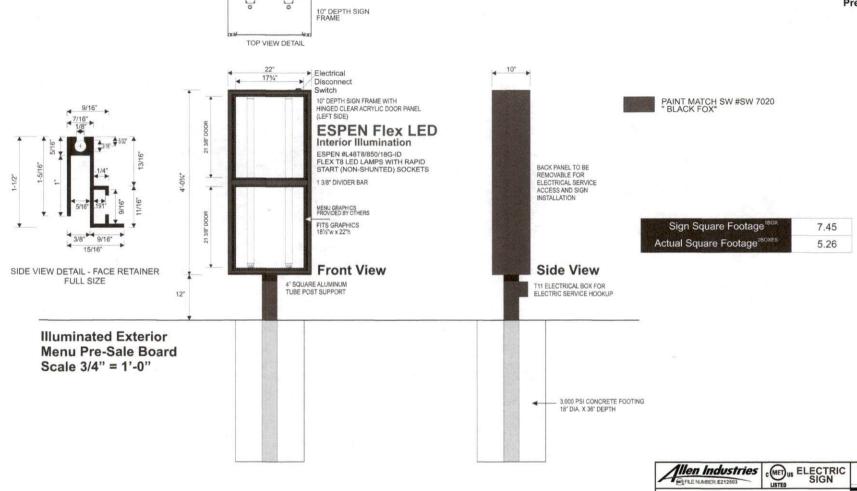

Client Review Status	Declaration	Date / Description	Notes	Project Information	Allen Industries
Allen Industries, Inc. requires that an " Approved" dr from the client prior to any production release or product	awing be obtained from release revision. Copyright © 2018 Allen Industries, Inc. This is an original, unpublished drawing, preeded by Allen Industries, Inc.	02/28/19 Issue Date This drawing is 03/01/19 /↑ Site Plan Update		Client Biscuitville OP013886 1608 NC 24-87, Cameron, NC 28326	YOUR BRAND AT ITS BEST
□ Approved □ Approved as Noted □ Re	vise & Resubmit submitted to you in confidence for your use solely in connection with the planned for you by Allen Industries. Inc. and is not to be shown to anyon	project being		1000 110 24 07, 041101011, 110 20020	1-800-967-2553
Name Title Date	organization, nor used, reproduced, copied or exhibited in any fashion w designs shown on the drawing (except for any registered trademarks the glass of Allian Industrials in premark the property of Allian Industrials in	at may belong to a		File Biscuit Op013886 Cameron NC Sales House Design SPN PM I Smotherman	T-000-907-2999

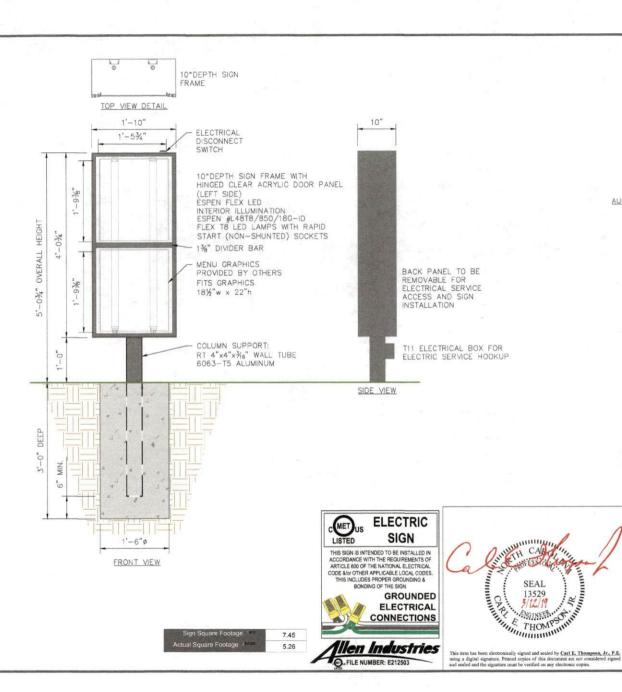

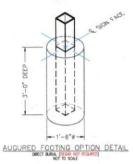

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 All reinforcing bars shall lap 30 diameters minimum, except as noted.
 Minimum controls over as tee, altings and main bars shall be 3/4 inch for slab, wall and surfaces not exposed to weather or in contact with ground; 3 inches for unformed surfaces deposited against the ground except as noted.
- Structural Material Specifications: ructural Material Specifications: Aluminum shopes shall be extruded from 6061–16 alloy. Weiding filler alloy shall be 4043, be A-36 Structural Steel and Plates shall be A-36 W-Shope become shall be ASNA-992 ($\Gamma_{P}-950$ ks) Minimum Structural tubing shall be ASNA-950, Grade 8, ($\Gamma_{P}=46$ ks)

- Structural piping shall be ASTM A-S3. Grade B. Type E or S. (Fy=35 km). ASTM ASTR Grade 42 (Fy-42 km) or ASTM A572 Grade 50 (Fy-50 km), (see drawing for individual member specifications
- Anchor Bolts (if required) shall be ASTM F-1554 Grade 36, unless otherwise noted.
- High strength bolts (Frequired) for connections shall be ASTM A-325, unless otherwise noted.
- Welding electrodes shall comply with AWS D1.1-(Current Edition), E70XX. (All welding to be done by welder cartified for specified weld type.)
- Design Wind Speed, $V_{\rm IA,T^{\rm SS}}$ 12D MPH (ASCE 7-10) Equivalent Wind Load, $P_{\rm ASD^{\rm SS}}$ 21.3 PSF Φ 5 -0 3/4" above the ground (3 Sec Wind Gusts.) Exposure Ω Risk Category II $I_{\rm P}$ =1.0 G=0.85
- Soil Bearing Capacity Requirements:
 a. Minimum Allowable Vettod Bearing Capacity shall be 1,500 P.S.F.
 Minimum Lateral Bearing Capacity shall be
 (150 \$\foatim{Y}\$ * 2)=300 P.S.F. per foot of depth.
 (Times two increase per NSBC Section 1806.3.4)
- Contractor shall verify all dimensions and conditions in the field before erection and notify the Engineer of any discrepancies.

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DRAWN BY: D. P. Ward DATE: March 12, 2019 ALLEN P.O.# 180733 SCALE 3/4"=1'-0" PROJ.# 032519 DWG.# EB-8195 1 OF 1