



North Carolina Onsite Wastewater Contractor Inspector Certification Board
Authorized Onsite Wastewater Evaluator Permit Option for Non-Engineered Systems
Notice of Intent (NOI) to Construct

☒ New ☐ Expansion ☐ Repair ☐ Relocation ☐ Relocation of Repair Area

Owner or Legal Representative Information:

Name: RiverWILD Homes

Mailing address: 114 W Main St City: Clayton State: NC Zip: 27520

Phone: 919-373-6048 Email: kelley@staywild.com

Authorized Onsite Wastewater Evaluator Information:

Name: Trent Bostic Certification #: 10056E

Mailing address: 1225 Crescent Drive, Ste 250 City: Cary State: NC Zip: 27518

Phone: 919-367-6322 Email: tbostic@agriwaste.com

Site Location Information:

Site address: 113 Beebalm Run, Dunn, NC 28334

Tax parcel identification number or subdivision lot, block number of property: 1509-12-3044

Alton Fields, Lot - 21 County: Harnett

System Information:

Wastewater System Type: IIIb

Daily Design Flow: 480

Saprolite System: ☐ Yes ☒ No Subsurface Operator Required: ☐ Yes ☒ No

Water Supply Type: ☐ Private Well ☒ Public Water Supply ☐ Spring ☐ Other: _____

Facility Type:

☒ Residential 4 # Bedrooms 8 Maximum # of Occupants

☐ Business Type of Business and Basis for Flow: _____

☐ Public Assembly Type of Public Assembly and Basis for Flow: _____

Required Attachments:

☒ Plat or Site Plan

☒ Evaluation of Soil and Site Features by Licensed Soil Scientist

Attest: On this the 31 day of OCT, 2025 by signature below I hereby attest that the information required to be included with this NOI to Construct is accurate and complete to the best of my knowledge. Furthermore, I hereby attest that I have adhered to the laws and rules governing onsite wastewater systems in the state of North Carolina. This NOI shall expire on 31 day of OCT, 2028.


Signature of Authorized Onsite Wastewater Evaluator: Trent Bostic

Signature of Owner or Legal Representative: _____

Disclosure: The owner may apply for a building permit for the project upon submitting a complete NOI to Construct and the fee required (if any) to the local health department. An onsite wastewater system authorized by an authorized onsite wastewater evaluator shall be transferable to a new owner with the consent of the authorized onsite wastewater evaluator.


Local Health Department Receipt Acknowledgement:

Signature of Local Health Department Representative: _____ Date: _____

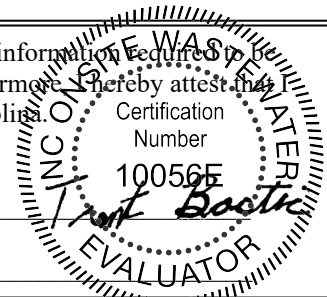



Agri-Waste Technology, Inc.
1225 Crescent Green, Suite 250, Cary NC 27518
agriwaste.com | 919.859.0669

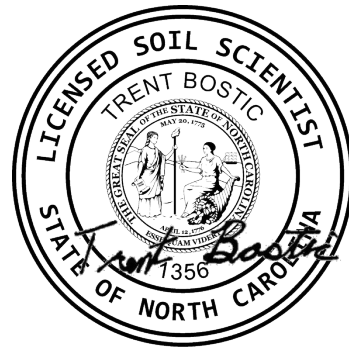

**Soil Suitability for Domestic Sewage Treatment and Disposal Systems
113 Beebalm Run, Dunn, NC 28334
(PIN: 1509-12-3044; Harnett County)**

PREPARED FOR: RiverWILD Homes, c/o Kelley Judd

PREPARED BY: Trent Bostic, Senior Soil Scientist

DATE: October 31, 2025

Soil suitability for domestic sewage treatment and disposal systems was evaluated on May 1, 2025, for the property located at the Alton Fields subdivision. Trent Bostic of Agri-Waste Technology, Inc. (AWT) conducted the soil evaluation. This evaluation was done to facilitate permitting for a septic system. This report and attached documents were prepared to meet the requirements for an Authorized On-Site Wastewater Evaluator to meet G.S. 130A-336.2

A drawing of the site plan, septic layout, and boring locations is included in Attachment 1. Profile descriptions for each boring are included in Attachment 2. Additional documentation about the property is included in Attachment 3.

Site Conditions

The total property area is approximately 0.58 acres. The property is wooded. The drawing in Attachment 1 details the property boundaries, house location, boring locations, and layout of drain field trenches (Completed by AWT).

Soil Suitability for Domestic Sewage Treatment and Disposal Systems

Multiple soil borings/pits were assessed on the property. Soil borings/pits were examined to determine soil suitability for on-site sewage disposal systems in accordance with 15A NCAC 18E: Wastewater Treatment and Dispersal Systems. These borings/pits were advanced with a hand auger and excavator. All soil borings/pits shown are provisionally suitable for a conventional style trench. The proposed LTAR (Long Term Acceptance Rate) by AWT is 0.375 GPD/ft². The soils on this property are group III soils within the distribution and treatment zone as used to define the LTAR. The maximum trench bottom should not exceed 24".

Field Layout & System Design

A septic layout was performed to demonstrate available space (.0508). The layout in Attachment 1 indicates there is available space for a four-bedroom primary and repair system utilizing a 50% reduction product. With an LTAR of 0.375 GPD/ft², 214 linear feet of trench is necessary to support a four-bedroom home initial and 214 linear feet of trench is required for the repair system. The attached drawing proves that 418+ linear feet of trench can be installed with the proposed home location on the property.

Any disturbances or grading done in the usable soils area may change the potential of using the area designated for a drain field and can result in a revoked permit.

We appreciate the opportunity to assist you in this matter. Please contact us with any questions, concerns, or comments.

Sincerely,

Trent Bostic, AOWE

A handwritten signature in black ink that reads "Trent Bostic". The signature is written in a cursive, slightly slanted style.

SOIL & SITE EVALUATION for ON-SITE WASTEWATER SYSTEMS

Evaluation Date	5/1/2025	Site Location	113 Beebalm Run	County	Harnett
PIN/Parcel	1509-12-3044	Property Size (acres)	0.58	Property Recorded	Yes
Proposed Facility	SFR	Bedrooms	4	Wastewater Strength	Domestic
Water Supply	Municipal	Design Flow (.0400)	480	Evaluation Method	Auger

Profile #	.0502 Landscape Position Slope %	Horizon Depth (in)	Soil Morphology		Other Factors					.0509 Profile Class LTAR	.0502(d) Slope Corrected Depth
			.0503 Struct ure Textur e	.0503 Consistence Mineralogy	.0504 Soil Wetness Color	.0505 Soil Depth (in)	.0506 Saprolite	.0507 Restrictive Horizon			
1	2%	Ap 0-9	LS	NS, NP, Vfr	10YR 5/2	36	Suitable	Suitable	0.375	36	
		E 9-15	LS	NS, NP, Vfr	10YR 6/4						
		Bt	SCL	SS, SP, Fi	10YR 5/6						
		System Type						Conventional			
2	2%	Ap 0-9	LS	NS, NP, Vfr	10YR 5/2	36	Suitable	Suitable	0.375	36	
		E 9-15	LS	NS, NP, Vfr	10YR 6/4						
		Bt	SCL	SS, SP, Fi	10YR 5/6						
		System Type						Conventional			
3	2%	Ap 0-9	LS	NS, NP, Vfr	10YR 5/2	36	Suitable	Suitable	0.375	36	
		E 9-15	LS	NS, NP, Vfr	10YR 6/4						
		Bt	SCL	SS, SP, Fi	10YR 5/6						
		System Type						Conventional			
4	2%	Ap 0-9	LS	NS, NP, Vfr	10YR 5/2	36	Suitable	Suitable	0.375	36	
		E 9-15	LS	NS, NP, Vfr	10YR 6/4						
		Bt	SCL	SS, SP, Fi	10YR 5/6						
		System Type						Conventional			

Evaluated by:	TB
---------------	----

Site Classification	Suitable	
Primary LTAR	0.375	Repair LTAR 0.375
Primary Trench Depth	24	Repair Trench Depth 24

SOIL & SITE EVALUATION for ON-SITE WASTEWATER SYSTEMS

LEGEND

Soil Group	Soil Texture	Conventional LTAR	Anaerobic Dip LTAR	Aerobic Drip LTAR (TS-II)	Mineralogy & Consistence		Structure
					Moist	Wet	
I	S (Sand)	0.8-1.2	0.4-0.6	0.8-1.5			SG (Single grain)
	LS (Loamy Sand)				Lo (Loose)	NS (Non Sticky)	M (Massive)
II	SL (Sandy Loam)	0.6-0.8	0.3-0.4	0.6-0.8	VFR (Very Friable)	SS (Slightly Sticky)	GR (Granular)
	L (Loam)				FR (Friable)	S (Sticky)	SBK (Subangular Blocky)
III	SiL (Silt Loam)	0.3-0.6	0.15-0.3	0.2-0.6	FI (Firm)	VS (Very Sticky)	ABK (Angular Blocky)
	SCL (Sandy Clay Loam)				VFI (Very Firm)	NP (Non Plastic)	PR (Prismatic)
	CL (Clay Loam)				EFI (Extremely Firm)	SP (Slightly Plastic)	
	SiCL (Silty Clay Loam)					P (Plastic)	PL (Platy)
IV	SC (Sandy Clay)	0.1-0.4	0.05-1.5	0.05-0.2		VP (Very Plastic)	
	SiC (Silty Clay)				SEXP (Slightly Expansive)		
	C (Clay)				EXP (Expansive)		



CERTIFICATE OF LIABILITY INSURANCE

DATE (MM/DD/YYYY)

1/20/2025

THIS CERTIFICATE IS ISSUED AS A MATTER OF INFORMATION ONLY AND CONFERS NO RIGHTS UPON THE CERTIFICATE HOLDER. THIS CERTIFICATE DOES NOT AFFIRMATIVELY OR NEGATIVELY AMEND, EXTEND OR ALTER THE COVERAGE AFFORDED BY THE POLICIES BELOW. THIS CERTIFICATE OF INSURANCE DOES NOT CONSTITUTE A CONTRACT BETWEEN THE ISSUING INSURER(S), AUTHORIZED REPRESENTATIVE OR PRODUCER, AND THE CERTIFICATE HOLDER.

IMPORTANT: If the certificate holder is an **ADDITIONAL INSURED**, the policy(ies) must have **ADDITIONAL INSURED** provisions or be endorsed. If **SUBROGATION** IS **WAIVED**, subject to the terms and conditions of the policy, certain policies may require an endorsement. A statement on this certificate does not confer rights to the certificate holder in lieu of such endorsement(s).

PRODUCER Hartsfield & Nash Agency, Inc. 10405 Ligon Mill Rd., Ste H Wake Forest NC 27587	CONTACT NAME: Connie Garkalns PHONE (A/C, No, Ext): 984-235-4273 FAX (A/C, No): 919-556-8758 E-MAIL ADDRESS: connie@hartsfield-nash.com
INSURED Agri-Waste Technology Inc 501 N. Salem St Ste 203 Apex NC 27502	INSURER(S) AFFORDING COVERAGE NAIC # INSURER A: Selective Insurance Company of 39926 INSURER B: Accident Fund 10166 INSURER C: Evanston Insurance Company 35378 INSURER D: INSURER E: INSURER F:

License#: 1000009111
AGRITC-01**COVERAGES****CERTIFICATE NUMBER:** 1304989694**REVISION NUMBER:**

THIS IS TO CERTIFY THAT THE POLICIES OF INSURANCE LISTED BELOW HAVE BEEN ISSUED TO THE INSURED NAMED ABOVE FOR THE POLICY PERIOD INDICATED. NOTWITHSTANDING ANY REQUIREMENT, TERM OR CONDITION OF ANY CONTRACT OR OTHER DOCUMENT WITH RESPECT TO WHICH THIS CERTIFICATE MAY BE ISSUED OR MAY PERTAIN, THE INSURANCE AFFORDED BY THE POLICIES DESCRIBED HEREIN IS SUBJECT TO ALL THE TERMS, EXCLUSIONS AND CONDITIONS OF SUCH POLICIES. LIMITS SHOWN MAY HAVE BEEN REDUCED BY PAID CLAIMS.

INSR LTR	TYPE OF INSURANCE	ADDL INSD	SUBR WVD	POLICY NUMBER	POLICY EFF (MM/DD/YYYY)	POLICY EXP (MM/DD/YYYY)	LIMITS
A	<input checked="" type="checkbox"/> COMMERCIAL GENERAL LIABILITY <input type="checkbox"/> CLAIMS-MADE <input checked="" type="checkbox"/> OCCUR GEN'L AGGREGATE LIMIT APPLIES PER: <input type="checkbox"/> POLICY <input checked="" type="checkbox"/> PRO-JECT <input type="checkbox"/> LOC OTHER:			S 2253659	1/18/2025	1/18/2026	EACH OCCURRENCE \$2,000,000 DAMAGE TO RENTED PREMISES (Ea occurrence) \$300,000 MED EXP (Any one person) \$10,000 PERSONAL & ADV INJURY \$2,000,000 GENERAL AGGREGATE \$4,000,000 PRODUCTS - COMP/OP AGG \$4,000,000 \$
A	<input checked="" type="checkbox"/> AUTOMOBILE LIABILITY <input checked="" type="checkbox"/> ANY AUTO <input type="checkbox"/> OWNED AUTOS ONLY <input type="checkbox"/> SCHEDULED AUTOS <input checked="" type="checkbox"/> HIRED AUTOS ONLY <input checked="" type="checkbox"/> NON-OWNED AUTOS ONLY			S 2253659	1/18/2025	1/18/2026	COMBINED SINGLE LIMIT (Ea accident) \$1,000,000 BODILY INJURY (Per person) \$ BODILY INJURY (Per accident) \$ PROPERTY DAMAGE (Per accident) \$ \$
A	<input checked="" type="checkbox"/> UMBRELLA LIAB <input checked="" type="checkbox"/> OCCUR <input type="checkbox"/> EXCESS LIAB <input type="checkbox"/> CLAIMS-MADE DED RETENTION \$			S 2253659	1/18/2025	1/18/2026	EACH OCCURRENCE \$2,000,000 AGGREGATE \$2,000,000 \$
B	WORKERS COMPENSATION AND EMPLOYERS' LIABILITY ANY PROPRIETOR/PARTNER/EXECUTIVE OFFICER/MEMBER EXCLUDED? (Mandatory in NH) If yes, describe under DESCRIPTION OF OPERATIONS below	Y/N N	N/A	100003072	1/18/2025	1/18/2026	<input checked="" type="checkbox"/> PER STATUTE <input type="checkbox"/> OTH-ER E.L. EACH ACCIDENT \$1,000,000 E.L. DISEASE - EA EMPLOYEE \$1,000,000 E.L. DISEASE - POLICY LIMIT \$1,000,000
C	Prof & Pollution Liability Leased & Rented			MKLV3ENV104794 S 2253659	8/22/2024 1/18/2025	8/22/2025 1/18/2026	Each Claim 5,000,000 Equipment 25,000

DESCRIPTION OF OPERATIONS / LOCATIONS / VEHICLES (ACORD 101, Additional Remarks Schedule, may be attached if more space is required)

CERTIFICATE HOLDER**CANCELLATION**Artisan Custom Homes
21016 Catawba Avenue
Cornelius NC 28031
USA

SHOULD ANY OF THE ABOVE DESCRIBED POLICIES BE CANCELLED BEFORE THE EXPIRATION DATE THEREOF, NOTICE WILL BE DELIVERED IN ACCORDANCE WITH THE POLICY PROVISIONS.

AUTHORIZED REPRESENTATIVE

Connie Garkalns

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NORTH CAROLINA, HARNETT COUNTY
I, Mickey R. Bennett, PLS do certify that this plat was drawn under
my supervision (deed description recorded in Book (see ref.)
Page (see ref.) last that boundaries not surveyed are clearly
indicated as drawn from information found in Book (see ref.) Page
(see ref.) that the ratio of precision as calculated is 1:10,000.
Witness my original signature, registration number and seal this
28th day of April, 2025 A.D.

Mickey R. Bennett PLS


MICKEY R. BENNETT
L - 1514




I, MICKEY R. BENNETT, PLS, CERTIFY
That this survey is of and existing parcel
or parcels of land or one or more existing
statements and does not create a new street
or change an existing street.

20

NORTH FREE NC GRID NAD 83 2011

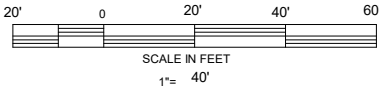

VERBENA POINT 50' PUBLIC R/W

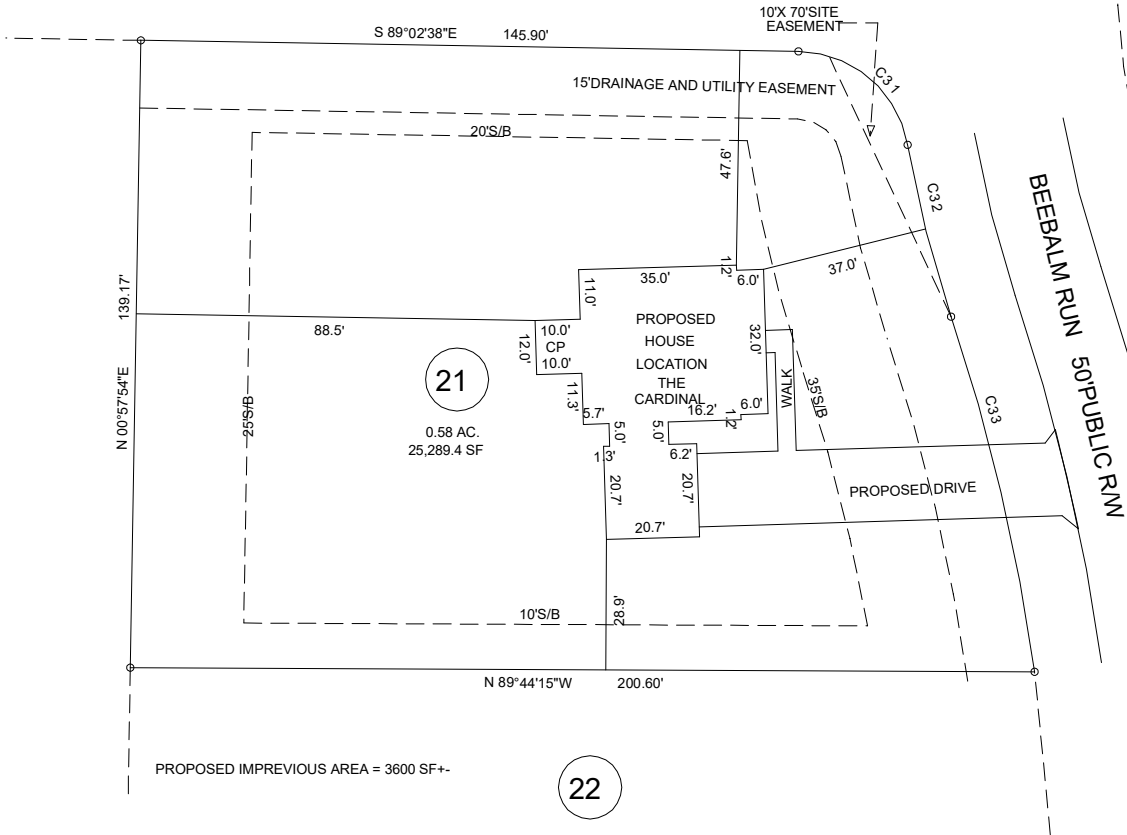

CURVE	RADIUS	LENGTH	CHORD	CH. BEARING
C31	25.00'	34.57'	31.88'	S 49°25'33"E
C32	258.00'	39.37'	39.33'	S 14°10'50"E
C33	436.29'	81.03'	80.91'	S 13°13'54"E

FEMA FLOOD HAZARD STATEMENT
ALL PROPERTY SHOWN ON THIS PLAT
IS LOCATED WITHIN THE FEMA (ZONE X)
MINIMAL FLOOD RISK AS SHOWN ON
FIRM NUMBER 3720150900J
EFFECTIVE DATE 10/3/2006.

MINIMUM BUILDING SETBACKS

RA-30
FRONT --- 35' FROM R/W
REAR --- 25'
SIDE --- 10'
CORNER LOT SIDE - 20'
MAXIMUM HEIGHT - 35'


MAXIMUM IMPREVIOUS AREA PER LOT - 5000 SF

DEED REFERENCE DEED BOOK 4231, PAGE 1889
MAP REFERENCE PLAT BOOK 2025, PAGE 176

DISCLAIMER
ALL INFORMATION SHOWN ON THIS MAP WAS TAKEN FROM
RECORDED DEEDS, PLATS AND OTHER PUBLIC INFORMATION.
BENNETT SURVEYS HAS NOT PERFORMED ANY SURVEY IN
PREPARING THIS PLAT AS OF DATE SHOWN.

OWNER: GREGORY INC.
62 E MCIVERY STREET
ANGIER, NC
27501-5891

NO FIELD SURVEY WAS PERFORMED IN .
PREPARING THIS PLAT
PROPOSED PLOT PLAN
BEEBLUM RUN, DUNN, NC 28334

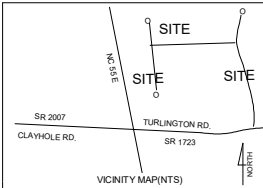

ALTTON FIELDS SUBDIVISION.

LOT - 21

GROVE TOWNSHIP		HARNETT COUNTY	
STATE: NORTH CAROLINA		DATE: APRIL 28, 2025	
ZONE RA-30	PIN 1509-12-3044.000	PID 071509 0037 31	

BENNETT SURVEYS F-1304

1662 CLARK ROAD LILLINGTON, NC 27546 910-893-5252

SCALE: 1"= 40'			DRAWING NO.
	DRAWN BY:	MRB	
CHECKED BY:			25149

AOWE - AF21

Project Location	113 Beebalm Run Dunn, NC 27334 Harnett County PIN: 1509-12-3044
Project Owner	RiverWILD Homes 114 W Main St Clayton, NC 27520 919-373-6048 kelley@staywild.com
Project Consultant	Trent Bostic, AOWE (919) 367-6322 tbostic@agriwaste.com
	Agri-Waste Technology, Inc. 1225 Crescent Green, Suite 250 Cary, NC 27518 (919) 859-0669 (919) 233-1970 Fax
System Overview	Single Family Residence Four (4) Bedrooms, 480GPD Pressure Manifold Horizontal T&J Panel



VICINITY MAP

Sheet Index

Sheet 1	Cover Sheet
Sheet 2	Property Layout
Sheet 3	Primary Drainfield
Sheet 4	Repair Drainfield
Sheet 5	Detail Sheet
Sheet 6	Detail Sheet

AWT
Engineers and Soil Scientists
Agri-Waste Technology, Inc.
1225 Crescent Green, Suite 250
Cary, North Carolina 27518
919-859-0669
www.agriwaste.com

RiverWILD Homes
AOWE - AF21

Project Location:
113 Beebalm Run
Dunn, NC 27334
Harnett County
PIN: 1509-12-3044

Project Owner:
RiverWILD Homes
114 W Main St
Clayton, NC 27520
919-373-6048
kelley@staywild.com

NC ONSITE WASTEWATER
EVALUATOR SEAL



Trent Bostic
EVALUATOR

REV.	ISSUED DATE	DESCRIPTION

SHEET TITLE
Cover Sheet


DRAWN BY: T. Bostic
CREATED ON: 10/27/2025
REVISED BY: ####
REVISED ON: ####
RELEASED BY: ####
RELEASED ON: ####
DRAWING NUMBER
WW-1



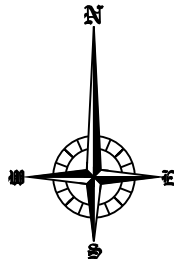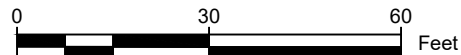

VERBENA POINT 50'PUBLIC R/W

20

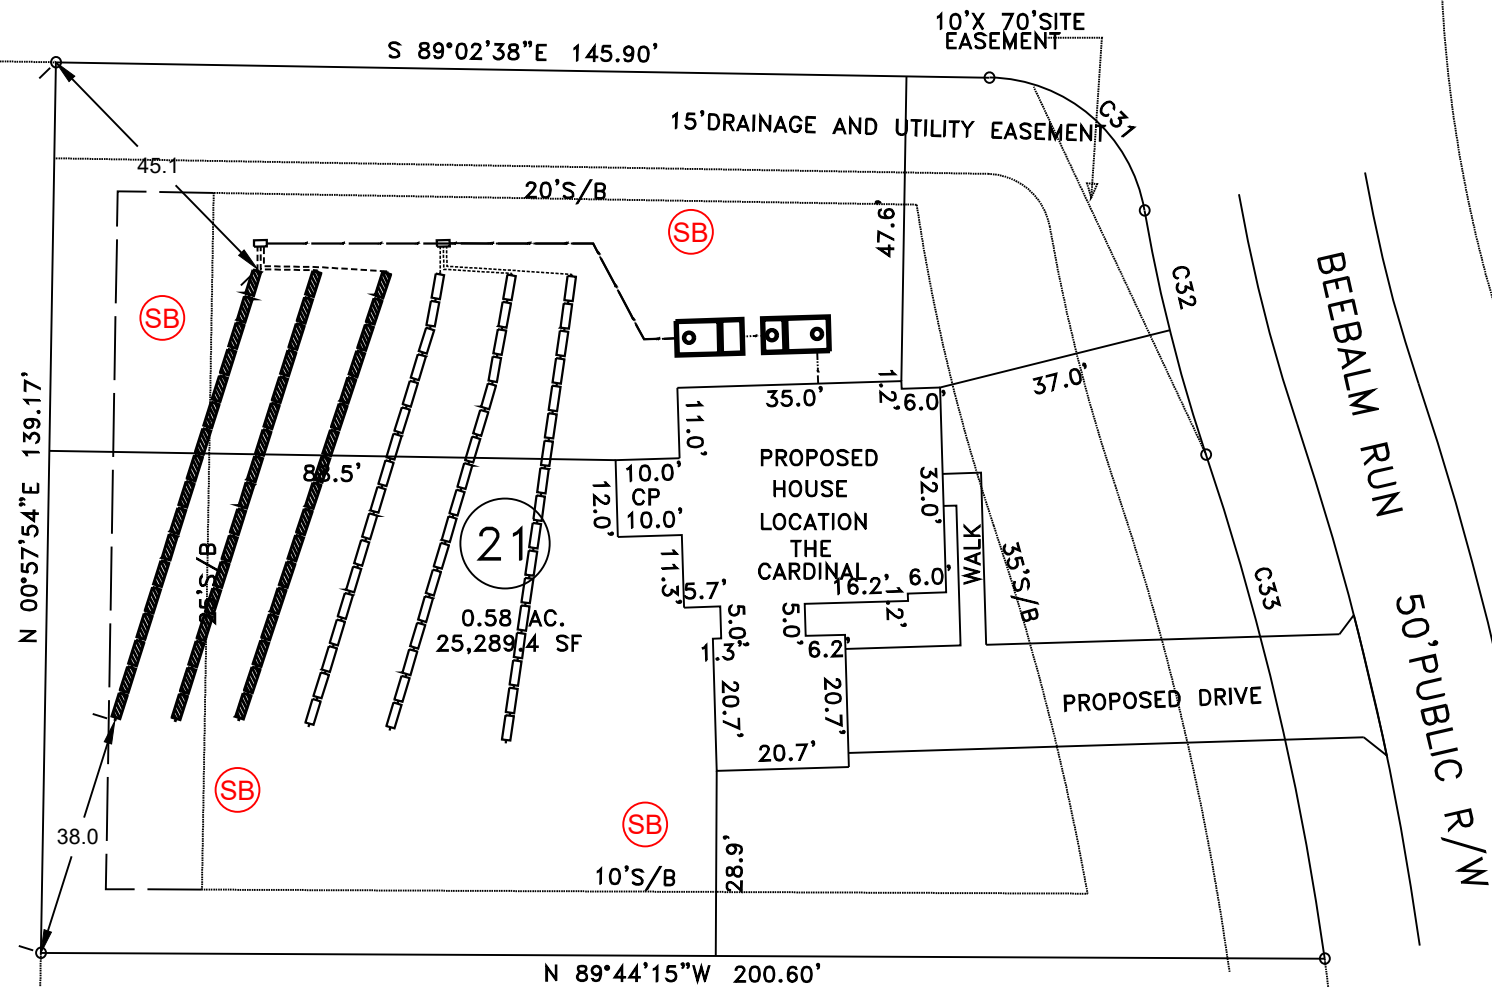

22



REV.	ISSUED DATE	DESCRIPTION
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SHEET TITLE

Property Layout


DRAWN BY: T. Bostic	CREATED ON: 10/27/2025
REVISED BY: ####	REVISED ON: ####
RELEASED BY: ####	RELEASED ON: ####

DRAWING NUMBER

WW-2

General Drainfield Notes:


1. Clear all trees less than 8" in diameter (measured at a height 3' from soil surface) from the drainfield.
2. Vegetation that will re-grow from a cut stump shall be stumped or pulled from the ground. Stumps shall not be pushed over.
3. Drainfield area shall be cleared of all leaves, pine straw, debris, etc. The accumulated material shall be removed from the drainfield.
4. In clayey soils, sides of trenches shall be raked and limed per manufacturer's instructions.
5. Supply lines shall be installed with a minimum of 18" cover.
6. The trenches shall be backfilled appropriately so that no low areas are present.
7. Apply lime over the drainfield area as needed. Seed fine fescue over the drainfield at the rate recommended by the seed manufacturer. Hand rake the seed into the soil surface. Straw the seeded area at the rate of 1.5-2 bales per 1000 sq. ft.

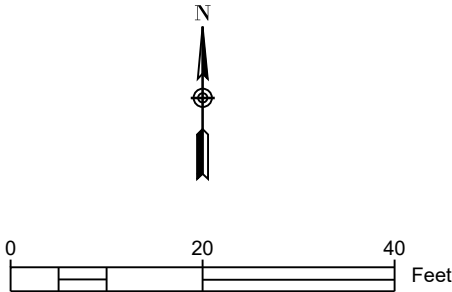

DRAINFIELD INFO. - Primary						
Proposed Type of System/Distribution: Pump to Pressure Manifold using PPBPS, Horizontal						
Line No.	Flag Color	Line Length (ft)	Tap	Flow (gpm)	Flow/Foot (gpm/ft)	Line L.T.A.R.
1	red	73.7	1/2in SCH 40	7.11	0.096	0.724
2	white	73.7	1/2in SCH 40	7.11	0.096	0.724
3	blue	73.7	1/2in SCH 40	7.11	0.096	0.724
Total		221	Total	21.33	Avg.	0.72

Note: Line lengths are calculated in 4'4" increments to reflect use of PPBPS product.

Note:
Primary distribution is pressure manifold utilizing horizontal T&J Panel.

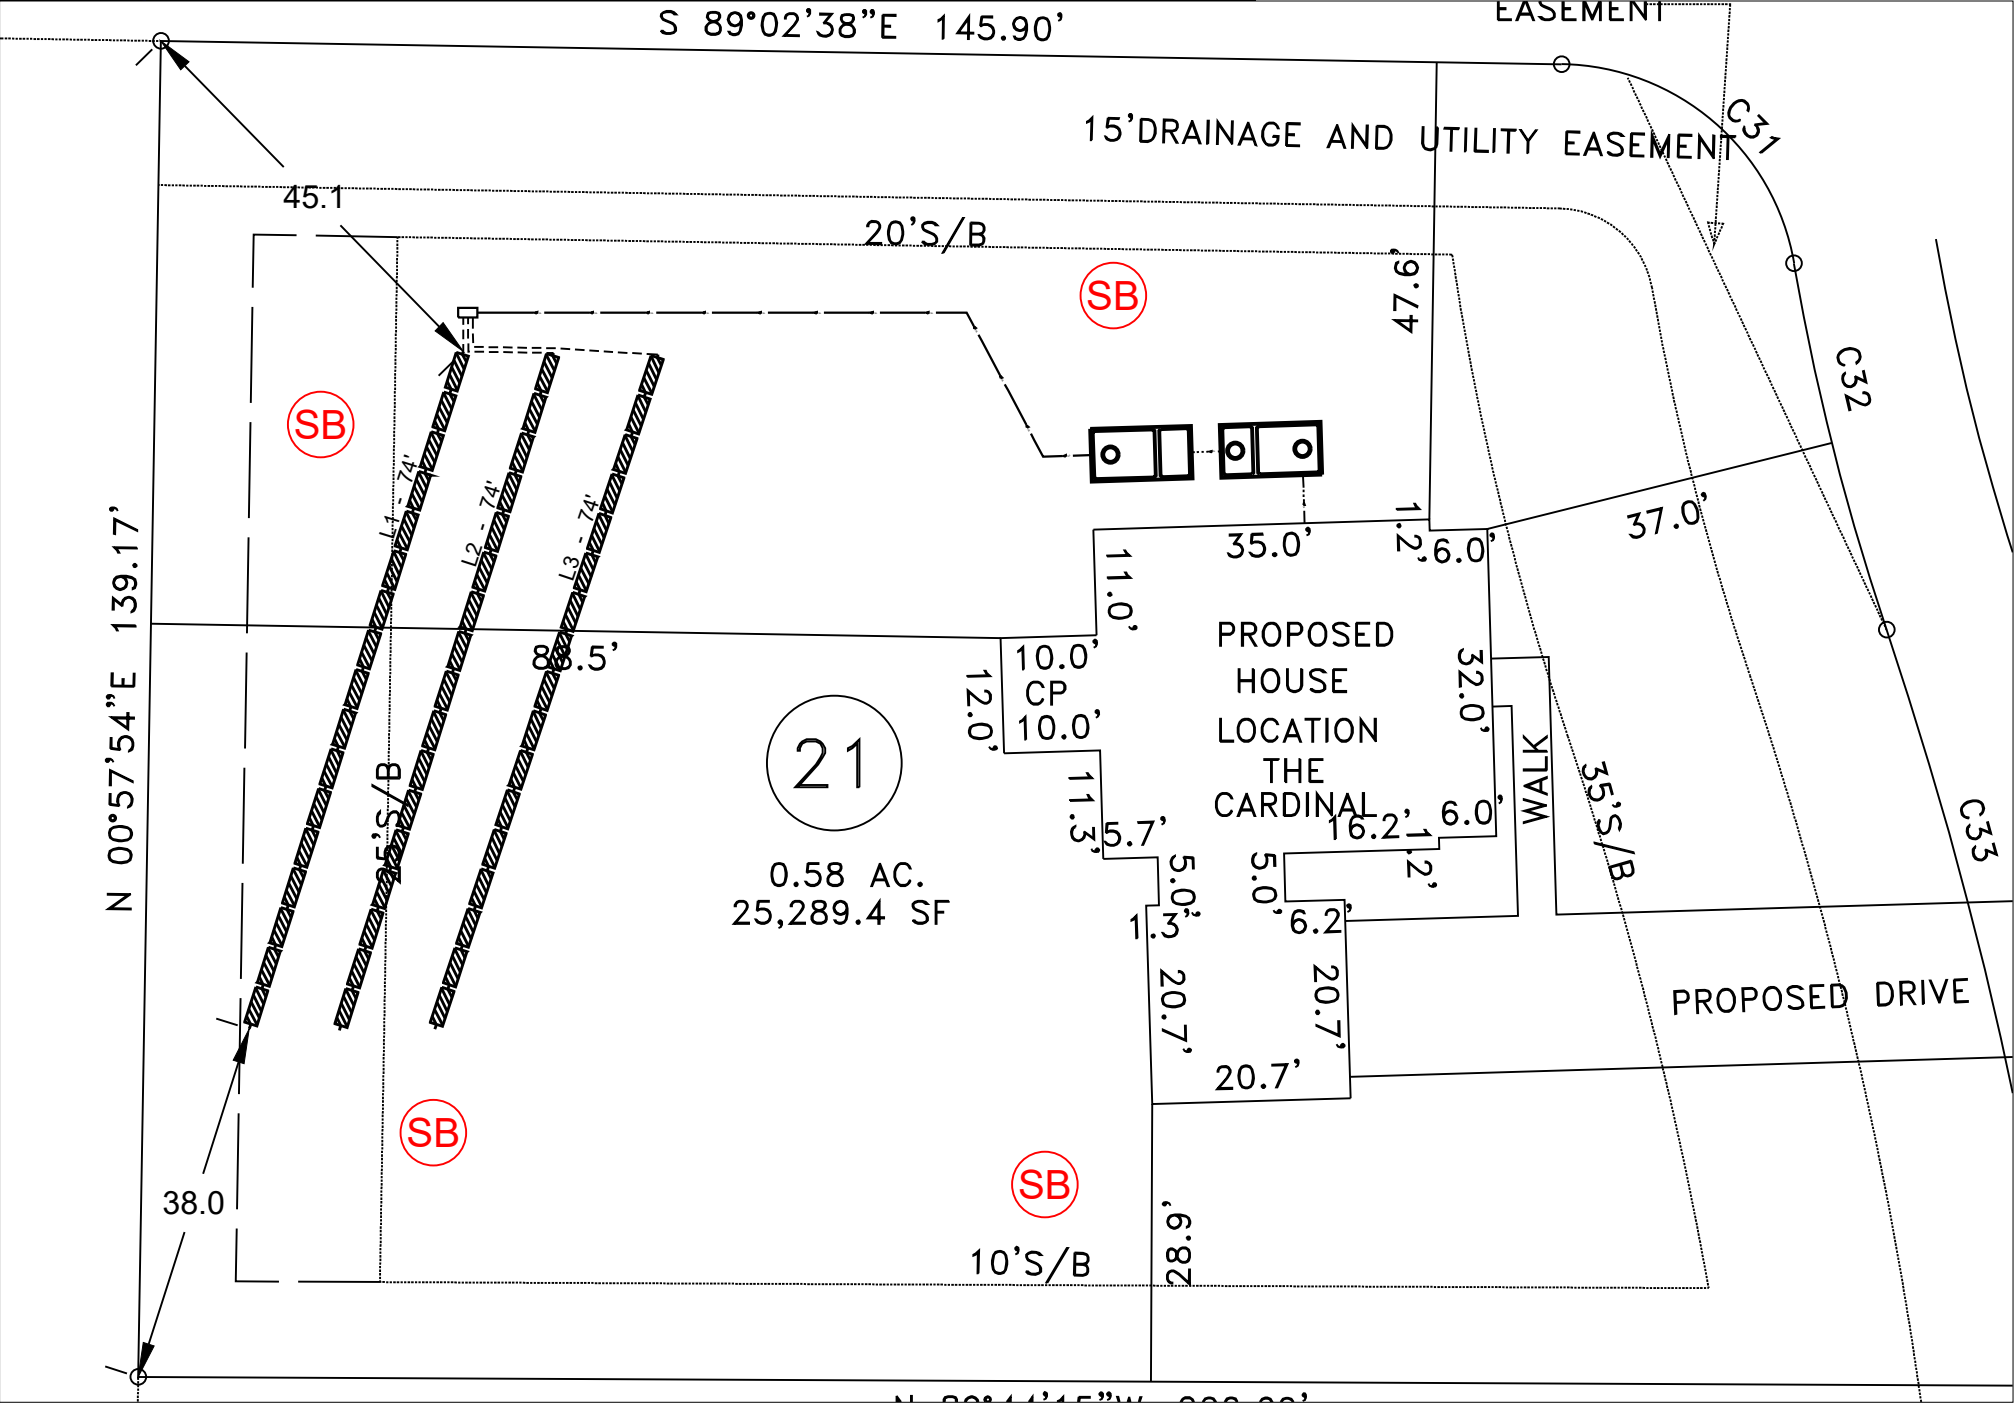

1 Primary Drainfield
SOURCE: Agri-Waste Technology, Inc.



REV.	ISSUED DATE	DESCRIPTION
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SHEET TITLE


Primary Drainfield

DRAWN BY: T. Bostic	CREATED ON: 10/27/2025
REVISED BY: ####	REVISED ON: ####
RELEASED BY: ####	RELEASED ON: ####

DRAWING NUMBER
WW-3


General Drainfield Notes:

1. Clear all trees less than 8" in diameter (measured at a height 3' from soil surface) from the drainfield.
2. Vegetation that will re-grow from a cut stump shall be stumped or pulled from the ground. Stumps shall not be pushed over.
3. Drainfield area shall be cleared of all leaves, pine straw, debris, etc. The accumulated material shall be removed from the drainfield.
4. In clayey soils, sides of trenches shall be raked and limed per manufacturer's instructions.
5. Supply lines shall be installed with a minimum of 18" cover.
6. The trenches shall be backfilled appropriately so that no low areas are present.
7. Apply lime over the drainfield area as needed. Seed fine fescue over the drainfield at the rate recommended by the seed manufacturer. Hand rake the seed into the soil surface. Straw the seeded area at the rate of 1.5-2 bales per 1000 sq. ft.

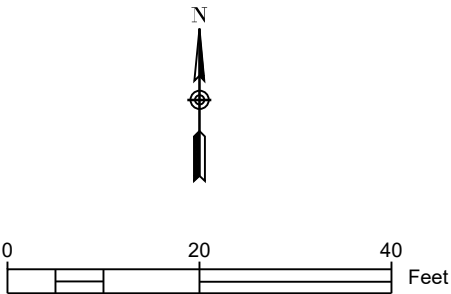


DRAINFIELD INFO. - Repair						
Proposed Type of System/Distribution:		Pump to Pressure Manifold using PPBPS, Horizontal				
Line No.	Flag Color	Line Length (ft.)		Flow (gpm)	Flow/Foot (gpm/ft)	Line L.T.A.R.
4	yellow	73.7	1/2in SCH 40	7.11	0.096	0.724
5	purple	73.7	1/2in SCH 40	7.11	0.096	0.724
6	red	73.7	1/2in SCH 40	7.11	0.096	0.724
	Total	221	Total	21.33	Avg.	0.72
Note: Line lengths are calculated in 4'4" increments to reflect use of PPBPS product.						

Note:
Repair distribution is pressure manifold utilizing an accepted trench product.

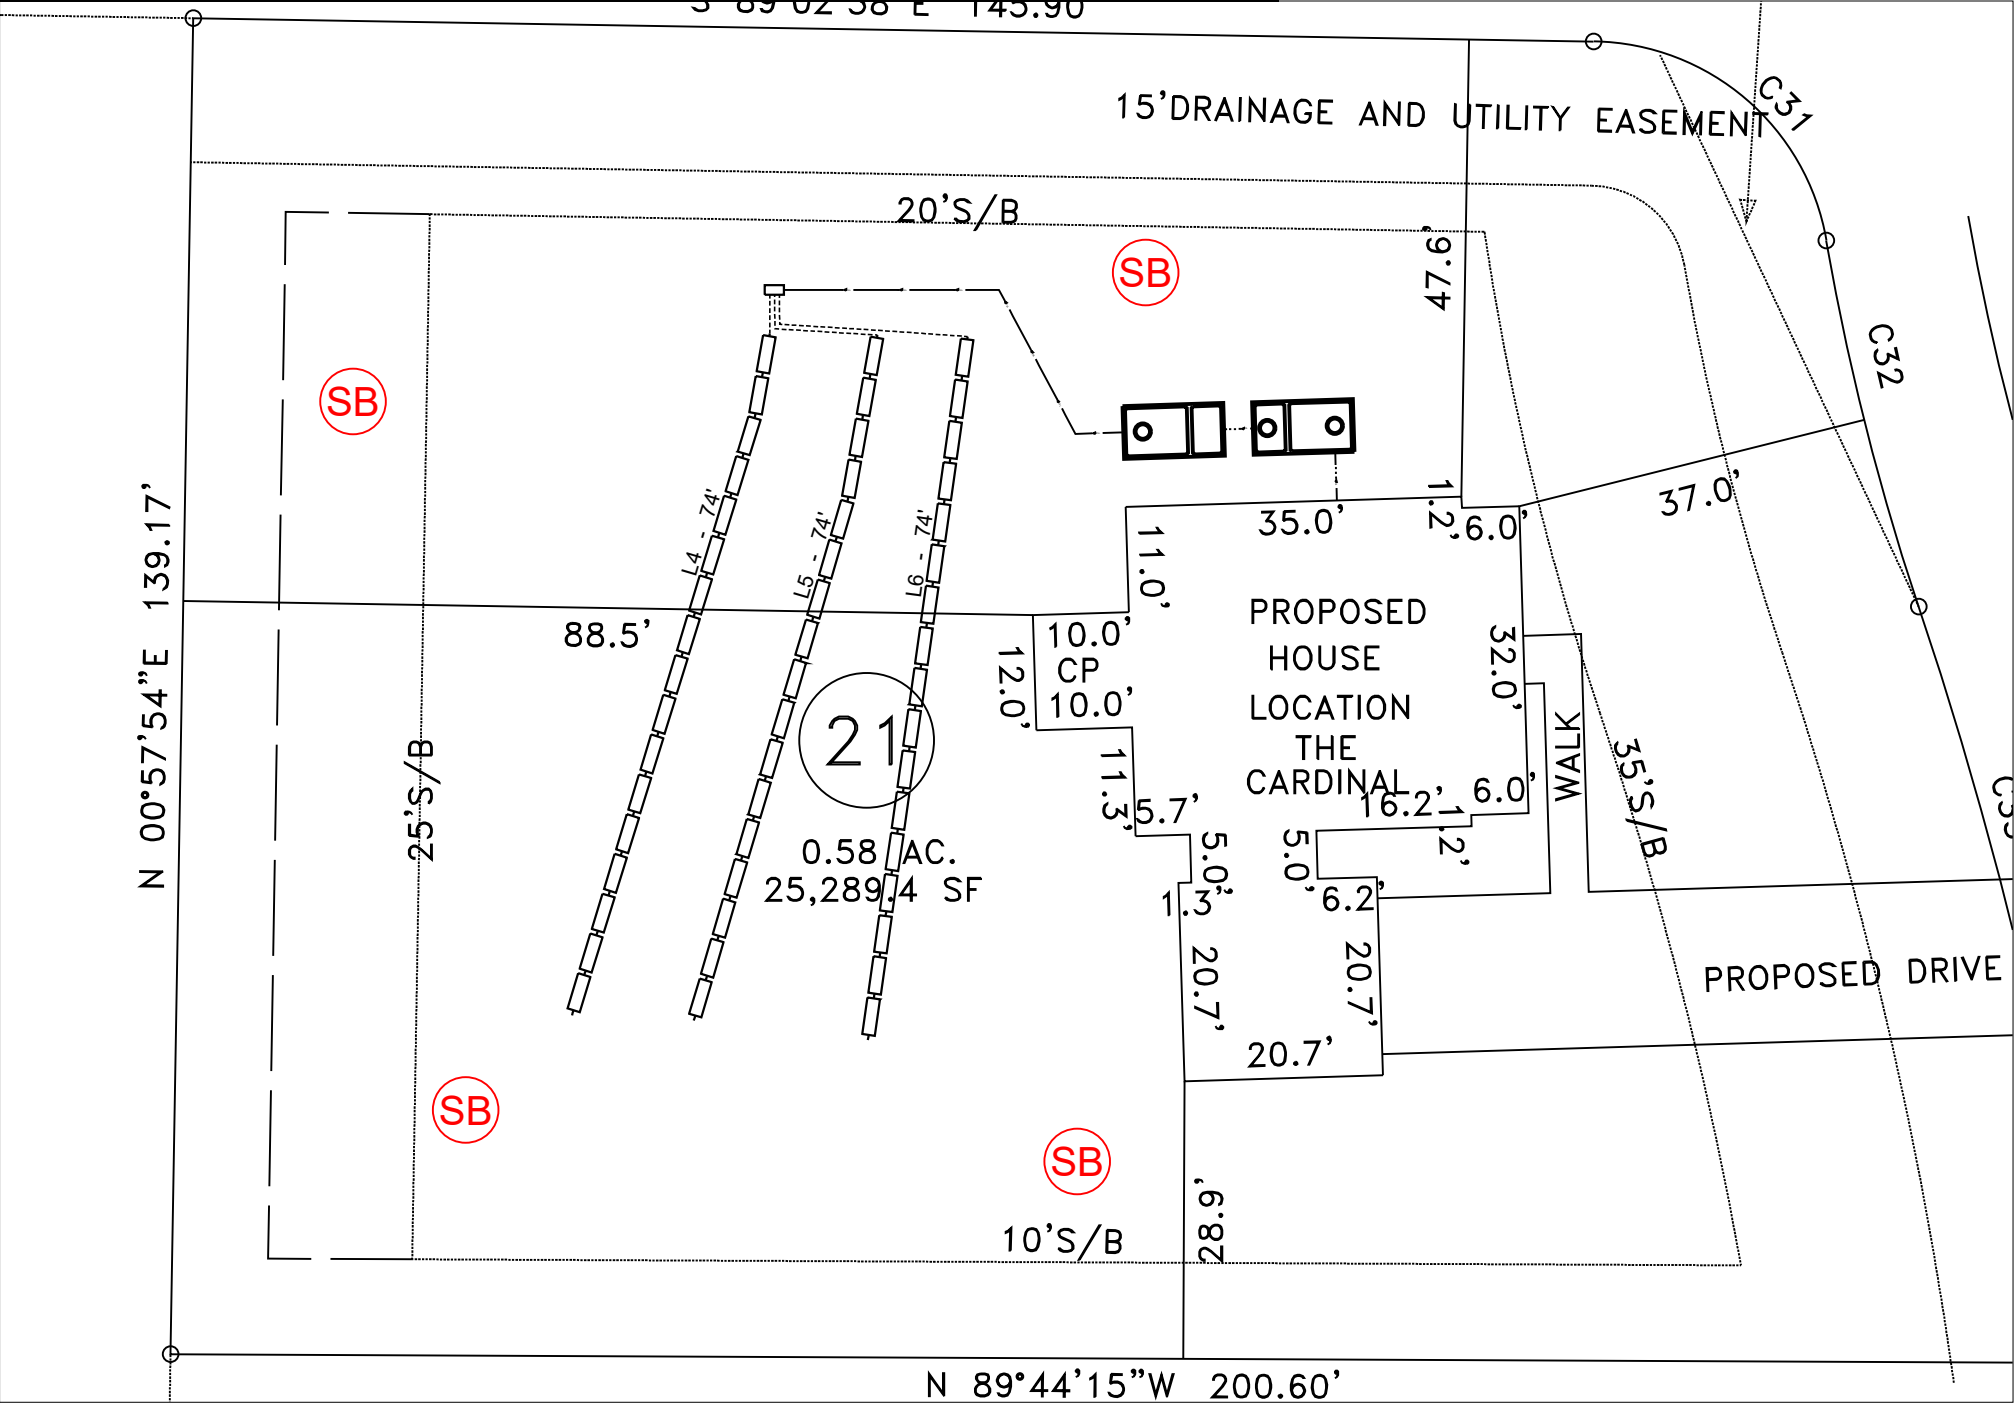

1 Repair Drainfield
SOURCE: Agri-Waste Technology, Inc.

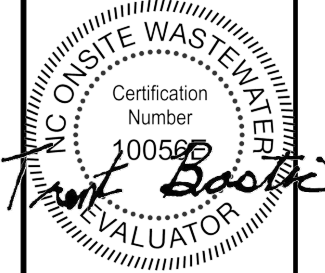


REV.	ISSUED DATE	DESCRIPTION


SHEET TITLE
Repair Drainfield

DRAWN BY: T. Bostic	CREATED ON: 10/27/2025
REVISED BY: ####	REVISED ON: ####
RELEASED BY: ####	RELEASED ON: ####


DRAWING NUMBER
WW-4

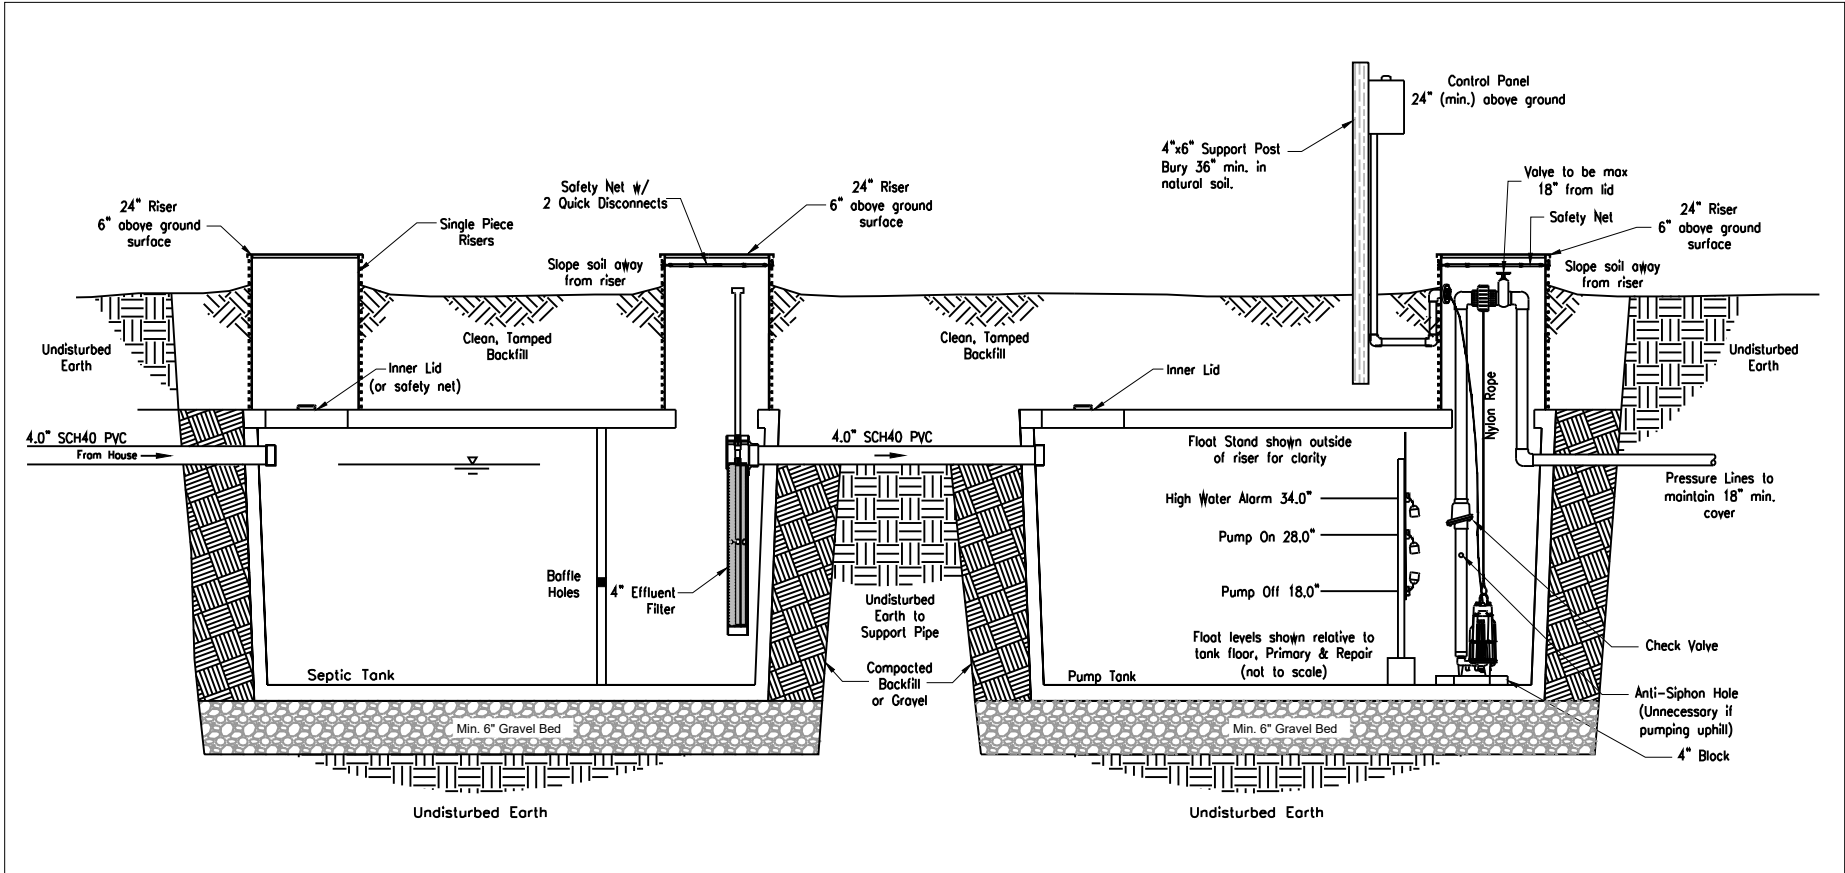


1 SYSTEM PROFILE VIEW
WW-6 N.T.S.

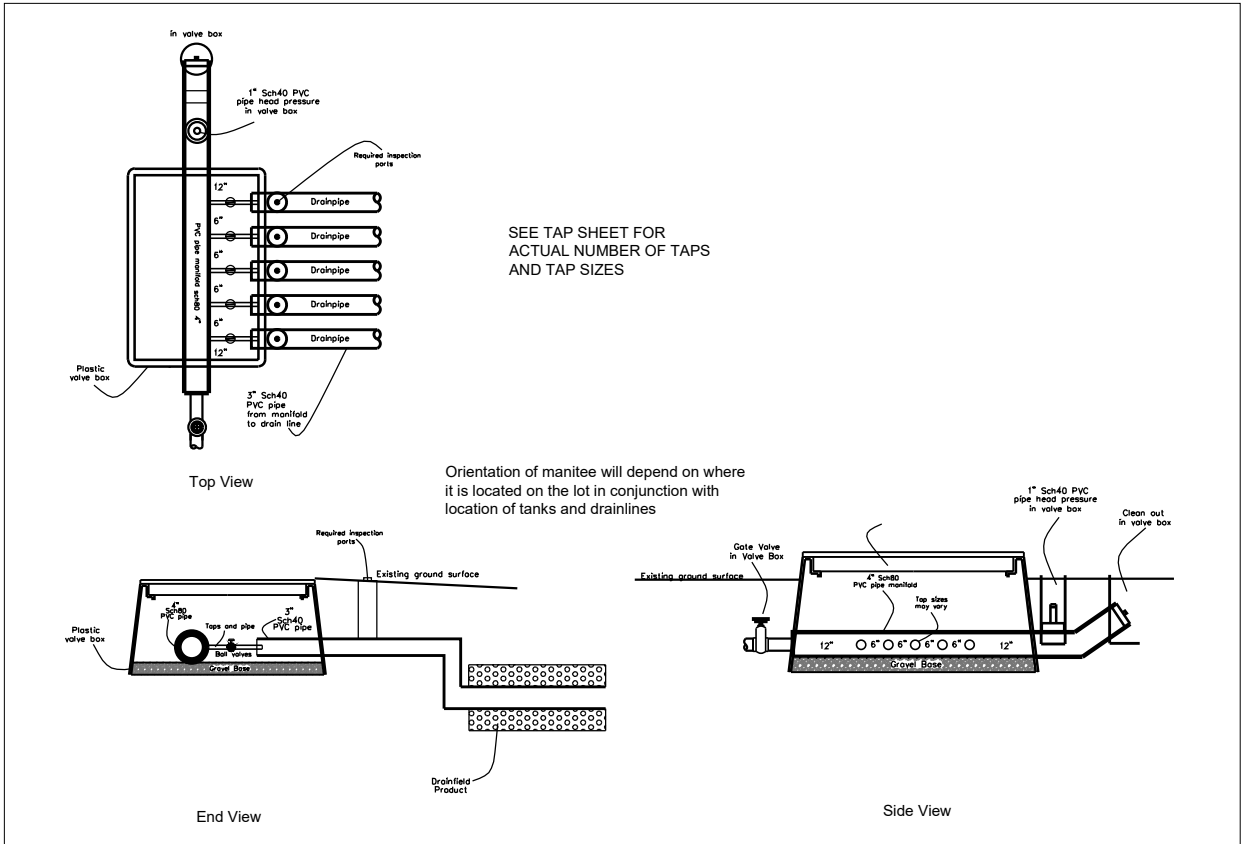

4 PRESSURE MANIFOLD INSTALLATION (Manitee) - For Illustration Only
WW-6 N.T.S. SOURCE: AWT

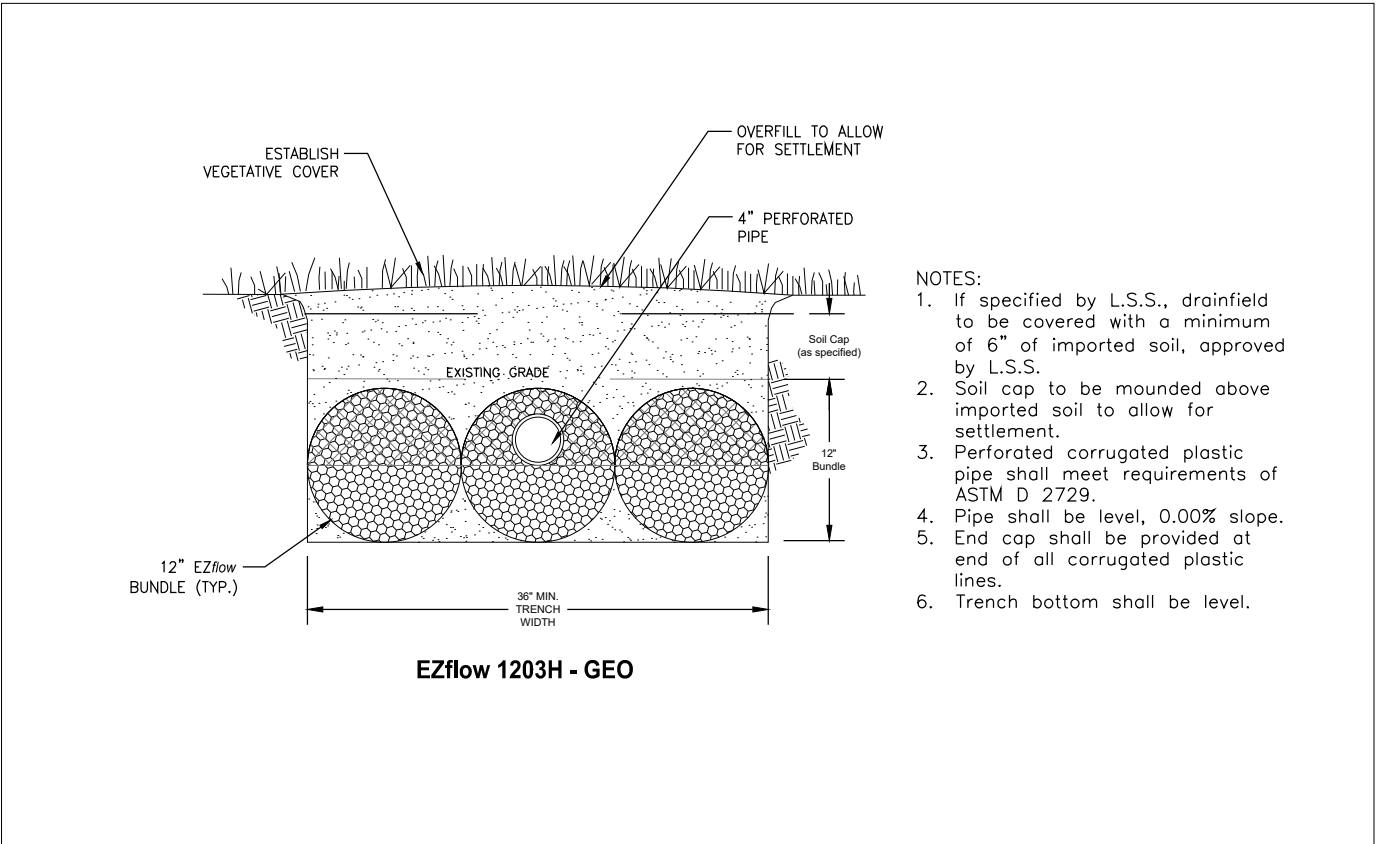

2 TRENCH X-SECTION (Typical)
WW-6 N.T.S. Source: AWT

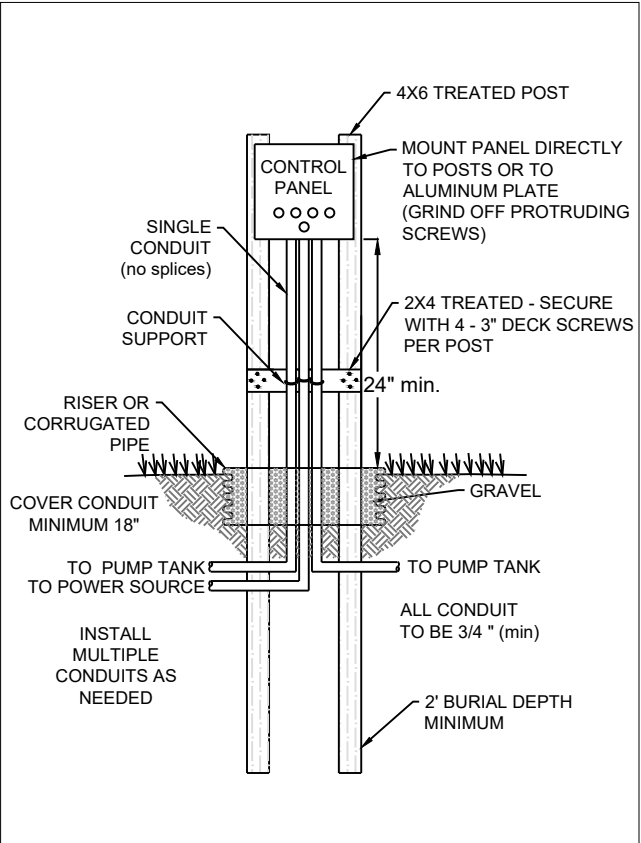

6 CONTROL PANEL SUPPORT
WW-6 N.T.S. SOURCE: AWT



REV.	ISSUED DATE	DESCRIPTION
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SHEET TITLE
Detail Sheet 2

DRAWN BY: T. Bostic	CREATED ON: 10/27/2025
REVISED BY: ####	REVISED ON: ####
RELEASED BY: ####	RELEASED ON: ####

DRAWING NUMBER
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