#### CYPRESS COVE **ABBREVIATIONS** A A PRESSURE TREATED WD H.R. HALF ROUN HWD HARDWOOD (FL ILLO. N LIEU OF ISUL NSULATED(TION INT NTERIOR ITC N THE CLEAR KIT KITCHEN R&M RANGE W/MICROWAY LIV LIVING LTL LINTEL LVR LOUVER MAX MAXIMUM DRY DRYER MACHINE TEMP TEMPERED (GLASS MISC MISCELLANE MULL MULLION(ED U.N.O. UNLLGG OTHERWISE EXTERIOR 0A OVERALL F.F. FINISH FLOOR (LINE OBS OBSCURE (GLA O.H. OVERHANI OPNG OPENING WH WATER HEATER FLR FLOOR(ING FP FIREPLACE OPT OPTIONAL WIC WALK-IN CLOSE FURRED(ING) PEDESTAL (SINK) FUR W/W/O WITH or WITHOU ROHND FAIL TERPROOF(ING) CIRCUIT INTERRU

# **GENERAL NOTES**

### 1 - GENERAL BUILDING & DESIGN REQUIREMENTS

1) THE ATTACHED PLANS & SPECIFICATIONS ARE THE SOLE PROPERTY OF TRI POINTE HOMES ANY UNAUTHORIZED USE OF THESE PLANS WITHOUT PRIOR WRITTEN CONSENT OF TRI POINTE HOMES IS STRICTLY

2) TRI POINTE HOMES DESIGNS & BUILDS HOUSING AS SET FORTH BY THE FORMAT AND PROVISIONS OF TH INTERNATIONAL RESIDENTIAL CODE (IRC), AND THE NATIONAL ELECTRIC CODE (NEC). ANY NON-CONFORMING DOCUMENTS DISCOVERED BY THE CONTRACTOR OR HIS AGENTS SHALL BE CALLED TO THE IMMEDIATE ATTENTION OF TRI POINTE HOMES BY CALLING (469)329-0470.

). THESE PLANS ARE SUBJECT TO MODIFICATIONS TO MEET CODE REQUIREMENTS AND/OR TO FACILITATE MECHANICAL/ ELECTRICAL/ PLUMBING INSTALLATION AND/ OR TO IMPLEMENT DESIGN IMPROVEMENTS. ANY

INTENTION TO MODIFY THESE PLANS MUST BE APPROVED IN WRITING BY TRI POINTE HOMES
4) CONTRACTOR SHALL BE RESPONSIBLE FOR VERIFYING ALL DIMENSIONS AFFECTING CONTRACTOR'S PRODUCTS, INSTALLATIONS, OR FABRICATIONS IN THE FIELD PRIOR TO EXPEDITING THE CONSTRUCTION OF SUCH WORK. FIELD VERIFY ALL DIMENSIONS — DO NOT SCALE DRAWINGS! CONTRACTOR IS RESPONSIBLE FOR SURVEYING THE PROJECT AND BECOMING FAMILIAR WITH THE EXISTING CONDITIONS AND SCOPE OF WORK INCLUDING BUT NOT LIMITED TO SITE AND SOIL BEARING CONDITIONS.
5) ERRORS AND OMISSIONS WHICH MAY OCCUR IN THE CONTRACT DOCUMENTS SHALL BE BROUGHT TO THE

ATTENTION OF THE ARCHITECT, IN WRITING, AND WRITTEN INSTRUCTION SHALL BE OBTAINED PRIOR TO PROCEEDING WITH CONSTRUCTION. THE CONTRACTOR SHALL BE HELD RESPONSIBLE FOR ANY ERRORS, DISCREPANCIES, OR OMISSIONS FOR WHICH THE CONTRACTOR FAILED TO NOTIFY THE ARCHITECT PRIOR TO

### 2 - SITE CONSTRUCTION

) BACK FILL SHALL BE FREE FROM VEGETATION AND CONSTRUCTION DEBRIS

) BACK FILL SHALL BE PLACED IN LIFTS AND COMPACTED IN SUCH A MANNER AS BACKFILL TO NOT DAM. THE FOUNDATION WALLS OR ANY WATERPROOFING/ DAMPPROOFING MATERIALS.

### 3 - CONCRETE

1) SLOPE ON GARAGE SLAB SHALL BE 1/8" PER FOOT TOWARDS VEHICLE DOOR. SLOPE ON PORCH AND

### 4 - MASONRY

ALL EXTERIOR BRICK MUST MEET ASTM C-216 FOR "SW" CONDITIONS

2) MASONRY VENEER SHALL BE ATTACHED TO SUPPORTING WALLS w/ CORRUGATED METAL TIES IN ACCORDANCE WITH R703.7.4.1 - I.R.C. OR LOCAL CODE REQUIREMENTS

) WEEPHOLES SHALL BE PROVIDED ALONG THE OUTSIDE WYTHE OF EXTERIOR MASONRY WALLS AT 33" O.C. MAX, SHALL BE A MIN. OF 3/16" IN DIAMETER, AND LOCATED IMMEDIATELY ABOVE THE FLASHING PER 18703.7.6 – LR.C.

### 5 - METALS

### 6 - WOOD AND PLASTICS

### 7 - THERMAL & MOISTURE PROTECTION

) Fire stopping and/ or draft stopping shall meet the requirements of IRC R602.8. 2) Attic ventilation shall be provided at 1/300 th of the Area of the Space ventilated. Cross VENTILATION WITH HALF OF THE VENTILATED AREA SHALL BE PROVIDED BY ROOF VENTS AND THE OTHER HALF BY SOFFIT VENTS. VENTS SHALL BE PLACED SO AS TO NOT ALLOW INFILTRATION OF RAIN OR SNOW. S) PROVIDE APPROVED TILE BACKER DRYWALL FOR ALL SHOWER AND BATH SPACE ) PROVIDE ATTIC VENTILATION PER IRC-R806.1

### 8 - DOORS AND WINDOWS

- ) REVIEW ALL WINDOW HDR HEIGHTS PER PLATE HT. AND VERIFY W/ ELEVATIONS AND CORNICE DETAILS TEMPERED GLASS SHALL BE USED IN HAZARDOUS AREAS AS DESCRIBED IN SECTION R308.4 - LR.C.
- FRONT DOOR WIDTH PER IRC-R311.3
- GARAGE DOOR PER IRC-R309.1

FMERGENCY EGRESS SHALL MEET REQUIREMENTS OF SECTION R310 - LR C 2018 - SLEEPING ROOMS HALL HAVE AT LEAST ONE EGRESS OPENING OF NOT LESS THAN 5.7 SF AND A CLEAR OPENING OF NOT IFSS THAN 20" WIDE X 24" HIGH AND SHALL NOT BE MORE THAN 44" ABOVE THE FLOOR

### 15 - MECHANICALS

WOOD BUILT CHIMNEYS AND FIREPLACES SHALL BE INSTALLED PER MANUFACTURER'S INSTRUCTIONS AND RE SUBJECT TO MECHANICAL INSPECTION PER IRC SECTION R1002.1 ) EXTERIOR AIR INTAKE FOR COMBUSTION AIR PER IRC SECTION AS REQUIRED BY LOCAL MUNICIPALITY

### 16 - ELECTRICAL

ALL FLECTRICAL INSTALLATION SHALL MEET THE REQUIREMENTS OF THE NATIONAL ELECTRIC CODE (NEC). MATERIAL AND EQUIPMENT SHALL BEAR THE LABEL OF APPROVAL OF THE UNDERWRITERS ABORATORIES, INC.

) ELECTRICAL CONTRACTOR SHALL VERIFY SPACE REQUIRED FOR METER INSTALLATION BEFORE ONSTRUCTION AND SHALL NOTIFY GENERAL CONTRACTOR OF ANY DISCREPANCIES.

VERIFY LOCATION OF ALL RECEPTACLES FOR APPLIANCES WITH MANUFACTURER SPECIFICATIONS. GROUND FAULT INTERRUPTS SHALL BE LOCATED PER THE NEC

ALL SWITCHES SHALL BE INSTALLED AT 3'-6" ABOVE FINISHED FLOOR TO CENTERLINE OF SWITCH VLESS NOTED OTHERWISE

) ALL CONVENIENCE OUTLETS SHALL BE INSTALLED W/ CENTERLINE OF OUTLET LOCATED 1'-3" ABOVE FÍNISHED ELOOR UNLESS NOTED OTHERWISE

ALL CONVENIENCE OUTLETS WITH SWITCHES TO BE SWITCH AT TOP ONLY.

ALL EXTERIOR WALL BRACKET FIXTURES SHALL BE INSTALLED AS NOTED ON PLANS.

APPROVED SMOKE DETECTORS SHALL BE LOCATED ON EVERY STORY OF THE DWELLING UNIT AS PER IRC ECTION R317 (SEE SHEET B1.1 FOR LOCATIONS). WHERE MORE THAN ONE DETECTOR IS REQUIRED THEY SHALL BE INTERCONNECTED. POWER SOURCE SHALL BE BUILDING POWER w/ BATTERY BACKUP. )) CONDUCTORS SHALL BE OF COPPER.

### GENERAL FRAMING SPECS AND CONSTRUCTION NOTES STAIRS:

1) THE MAXIMUM RISER HEIGHT SHALL BE 7 3/4 INCHES AND THE MINIMUM TREAD DEPTH SHALL BE 10 CHES IN ACCORDANCE WITH SECTION I.R.C.

HANDRAILS HAVING MINIMUM AND MAXIMUM HEIGHTS OF 34 INCHES AND 38 INCHES SHALL BE OVIDED ON AT LEAST. ONE SIDE OF STAIRWAYS IN ACCORDANCE WITH SECTION R315.1 — I.R.C HANDRAIL AND BALUSTRADE (WHERE PRESENT) SHALL BE CONSTRUCTED. ACCORDING TO IRC. ALL REQUIRED HAND RAILS SHALL BE CONTINUOUS THE FULL LENGTH OF THE STAIRS W/ 2 OR MORE SERS FROM A POINT ABOVE THE THE TOP RISER OF A FLIGHT TO A POINT ABOVE THE LÓWEST RISER OF THE FLIGHT. ENDS SHALL BE RETURNED OR SHALL TERMINATE AT NEWEL POSTS OR SAFETY TERMINALS. ANDRAILS ADJACENT TO A WALL SHALL HAVE A SPACE OF NOT LESS THAN 1.5" BETWEEN THE WALL

### WALLS:

) ALL DIMENSIONS ARE FROM FACE OF STUD TO FACE OF STUD. ALL STUDS ARE 3 1/2" UNLESS NOTED. ALL DIMENSIONS PRESENTED HERE ARE FRAME DIMENSIONS ONLY.

I SEPARATION BETWEEN THE RESIDENCE AND THE GARAGE SHALL BE MAINTAINED BY INSTALLATION OF  $rac{1}{2}"$ GYPSUM BOARD ON ALL COMMON WALLS. 2-STORY HOMES REQUIRE 5/8" TYPE X GYPSUM BOARD AT CARAGE CEILINGS WHERE HABITABLE ROOMS ARE PRESENT ABOVE.

### FLOORS:

STRUCTURAL FLOOR MEMBERS SHALL NOT BE CUT, BORED, OR NOTCHED IN EXCESS OF THE LIMITATIONS ECIFIED IN IRC

) THE ENDS OF EACH JOIST, BEAM, OR GIRDER SHALL HAVE NOT LESS THAN 1.5 INCHES OF BEARING ON WOOD OR METAL AND NOT LESS THAN 3 INCHES ON MASONRY OR CONCRETE OR AS OTHERWISE SPECIFIED

) ALL DIMENSIONAL FLOOR JOISTS TO BE PER ENGINEER STRUCTURAL PLANS.

### FRAMING:

ALL FRAMING DIMENSIONS TO FACE OF MEMBER. ALL BEARING HEADERS TO BE PER ENGINEERING PLANS.

FIRE STOPPING AND / OR DRAFT STOPPING SHALL MEET THE REQUIREMENTS OF IRC R602.8.

### **ROOF**

HIP AND VALLEY RAFTERS SHALL BE SUPPORTED AT RIDGE DOWN TO BEARING PARTITION, CUT ENDS OF RAFTERS SHALL BE FULLY SUPPORTED WALL AND RIDGE

REQUIRED VENTILATION AREAS CALCULATED AT 1/300 RATIO

# SQUARE FOOTAGE

Elevation "B"

(Slab S.F.)	
Slab Area	Sq. Ft.
FIRST FLOOR	1767
2 BAY GARAGE	428
PORCH	172
COVERED OUTDOOR LIVING	153
Total Slab Area	2520

(Outside of Frame	S.F.)
A/C Area	Sq. Ft.
FIRST FLOOR	1767
Total A/C Area	1767
Non-A/C Area	Sq. Ft.
2 BAY GARAGE	428
PORCH	172
COVERED OUTDOOR LIVING	153
Total Non-A/C Area	753

(Inside of Frame S.F.)		
/C Area	Sq. Ft.	
IRST FLOOR	1718	
otal A/C Area	1718	

	OPTIONS	
LOFT		+569

**LOT 373** 5920-04 **CYPRESS COVE ELEVATION B RIGHT-HAND GARAGE** 

UNDER 9.000 FT<sup>2</sup> -FIRE-RATED WALL REQUIRED AT **GARAGE SIDE &** NON-GARAGE SIDE

BUILDING CODE COMPLIANCE

CONSTRUCTION PLANS DESIGNED TO MEET OR EXCEED MINIMUM CODE REQUIREMENTS OF 2018 LR (

LECTRICAL PLANS DESIGNED TO MEET OR EXCEED MINIMUM

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	SHEET LEGEND
SHEET NO.	TYPE OF SHEET/LAYOUT
"G0.01"	COVER SHEET & GEN. NOTES
"G0.11"	REVISIONS & SYMBOLS
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"A1.10B"	FIRST FLOOR PLAN - ELEVATION 'B'
"01.A10"	FLOOR PLAN OPTIONS
"01.A20"	2ND FLOOR PLAN OPTION
"A2.01B"	EXTERIOR ELEVATIONS — 'B'
"A2.02B"	EXTERIOR ELEVATIONS - 'B'
"A2.03B"	EXTERIOR ELEVATIONS OPTION — 'B'
"A2.04B"	EXTERIOR ELEVATIONS OPTION — 'B'
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"E1.11B"	1ST FLR. ELECTRICAL PLAN UPGRADE OPTIONS — ELEVATION 'B'
"01.E10"	1ST FLR. ELECTRICAL PLAN OPTIONS
"01.E20"	2ND FLR. ELECTRICAL PLAN OPTION
"01.E11"	1ST FLR. ELECTRICAL PLAN UPGRADE OPTIONS
"01.E21"	2ND FLR. ELECTRICAL PLAN UPGRADE OPTION
"D1.0"	DETAILS
"D2.0"	GRAB BAR PARTIAL PLANS
L	1

### **SELECTED OPTIONS**

STANDARD PRIMARY SHOWER W/ OPT. TILE WALLS & TILE FLOOR PAN

\*OPT. BATH 2 SHOWER ILO TUB W/ TILE WALLS

\*OPT. BEDROOM 3 ILO FLEX SPACE

\*OPT. SCREENED COVERED OUTDOOR LIVING

\*OPT. STAINED MAHOGANY FRONT DOOR

\*OPT. FIRE-RATED GARAGE SIDE \*OPT. FIRE-RATED NON-GARAGE SIDE

#### SYMBOLS PLYWOOD ELEVATION KEY OR SECTION KEY TUB/SHOWER INSULATING SHEATHING CENTERI INF BATT INSULATION CEILING TRANSITION LINE LAVATOR' RIGID HOSE BIB (FREEZE PROOF) 6 DBL SINK GAS LINE STUB CONCRETE TOWEL BAR SAND OR GRAVEL LAUNDRY SINK PAPER HOLDER STONE TOWEL RING 2x FRAME PEDESTAL SINK SHOWER HEAD BRICK VENEER WATER CLOSET

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SHOWER CONTROLS

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ALTIS @ SHE SUBDIVISION: ADDRESS: LOT: 373

10-13-24 Issue Date: ACC

5920-04

CYPRESS COVE

G0.01

STONE VENEER

	REVISION INDEX		
REL. #	DESCRIPTION	DATE	DRAWN BY
5920-04	NEW PLAN	10/13/2024	ACC
	ADDED ATTIC PULL-DOWN, REVISED ROD/SHELF IN PRIMARY WIC, ADDED OPTIONS — SCREENED COVERED OUTDOOR LIVING, GOURMET KITCHEN KITCHEN, ZERO ENTRY SHOWER AT PRIMARY BATH, ADDED TRIM SURROUNDING VENTS AT VARIOUS ELEVATIONS, REVISED BENCH DETAIL, ADDED OPT. LAUINDRY, CABINETS, ADDED (2) 4—LED LIGHTS IN GARAGE, REVISED ELECT LIGHTING AND SWITCHES IN PRIMARY BATH, ADDED DISHWASHER ACCESSIBLE DISCONNECT SWITCH AND COUNTER-TOP AIR SWITCH FOR DISPOSAL NOTES	01/19/2025	ACC
	ADDED SHOWER NICHE NOTE, ADDED CURB TO SHOWERS, REVISED INT/EXT FIREPLACE DEPTHS, REVISED OPENING HEADER HEIGHTS THROUGHOUT, REVISED BEAR EXTERIOR DOOR TO 3, REVISED DROP ZONE AREA, ADDED DOOR HEIGHTS TO MAIN FLOOR NOTES, ADDED ZERO ENTRY SHOWER DETAIL, REMOVED PRIMARY BATH 2 OPTION, ADDED OUTDOOR LIVING PATIO OPTION, ADDED PARTIAL SHOWER NICHE DETAIL, ADDED COURMET KITCHEN INTERIOR, REVISED ELECTRICAL / ELECTRICAL OPTION AT GREAT ROOM AND PRIMARY BATH.	04/22/2025	ACC
	ADDED TYPICAL CLOSET ROD AND SHELF DETAILS, ADDED SHOWER NICHE DETAILS, REVISED PANTRY SHELVES TO 4, REMOVED KITCHEN ISLAND "TOP SIZE" NOTE, ADDED TOWEL HOOK IN PRIMARY BATH, ADDED GABLE WINDOW DIMENSIONS, REVISED TYPICAL BENCH DETAIL, ADDED VARIOUS ELECTRICAL NOTES, ADDED SWITCHES TO OPTIONAL ELECTRICAL SHEETS,	07/31/2025	ACC
	ADDED OPTIONAL BEAMS IN PRIMARY SUITE, ADDED OPTIONAL GRAB BARS IN ALL BATHS, REVISED TOWEL BAR AND HOLDER HEIGHTS	09/06/2025	ACC

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FUQUAY-VARINA, NC 27526
LOT: 373
BLOCK:


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CYPRESS COVE

G0.11



UNDER 9,000 FT<sup>2</sup> -FIRE-RATED WALL REQUIRED AT GARAGE SIDE & NON-GARAGE SIDE

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HOMES
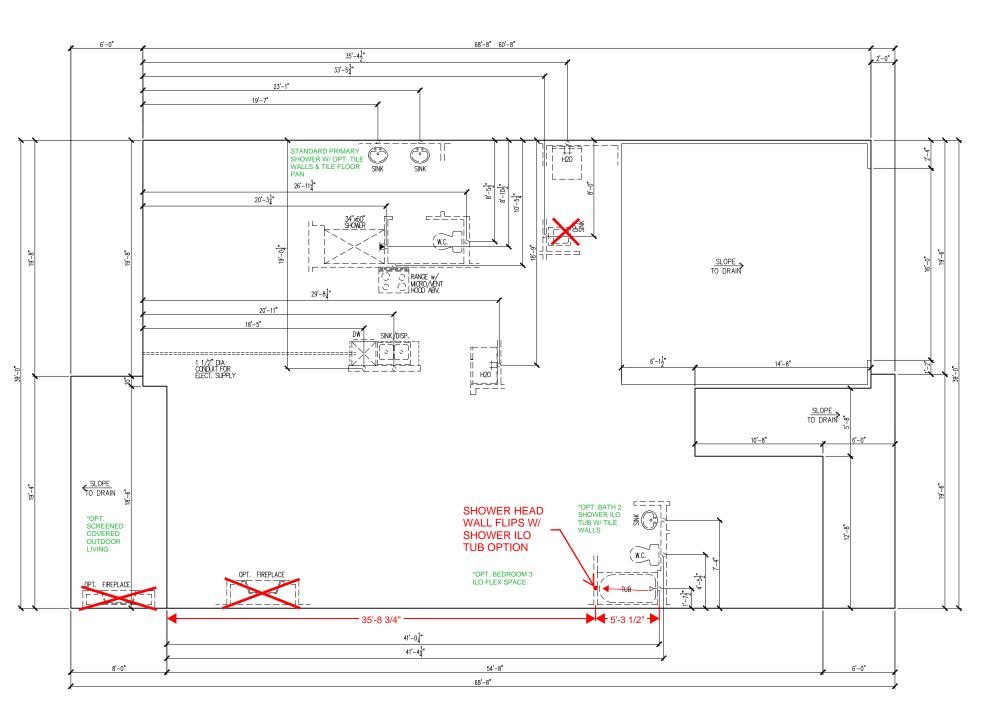
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N PLAN

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CYPRESS COVE

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SELECTED OPTIONS

STANDARD PRIMARY SHOWER W/ OPT. TILE WALLS & TILE FLOOR PAN

\*OPT. BATH 2 SHOWER ILO TUB W/ TILE WALLS

\*OPT. BEDROOM 3 ILO FLEX SPACE

\*OPT. SCREENED COVERED OUTDOOR LIVING


\*OPT. STAINED MAHOGANY FRONT DOOR

\*OPT. FIRE-RATED GARAGE SIDE \*OPT. FIRE-RATED NON-GARAGE SIDE


LOT 373 5920-04 CYPRESS COVE

ELEVATION B RIGHT-HAND GARAGE

S COVE

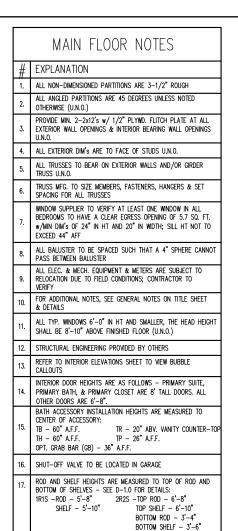

UNDER 9,000 FT<sup>2</sup> -FIRE-RATED WALL REQUIRED AT GARAGE SIDE & NON-GARAGE SIDE

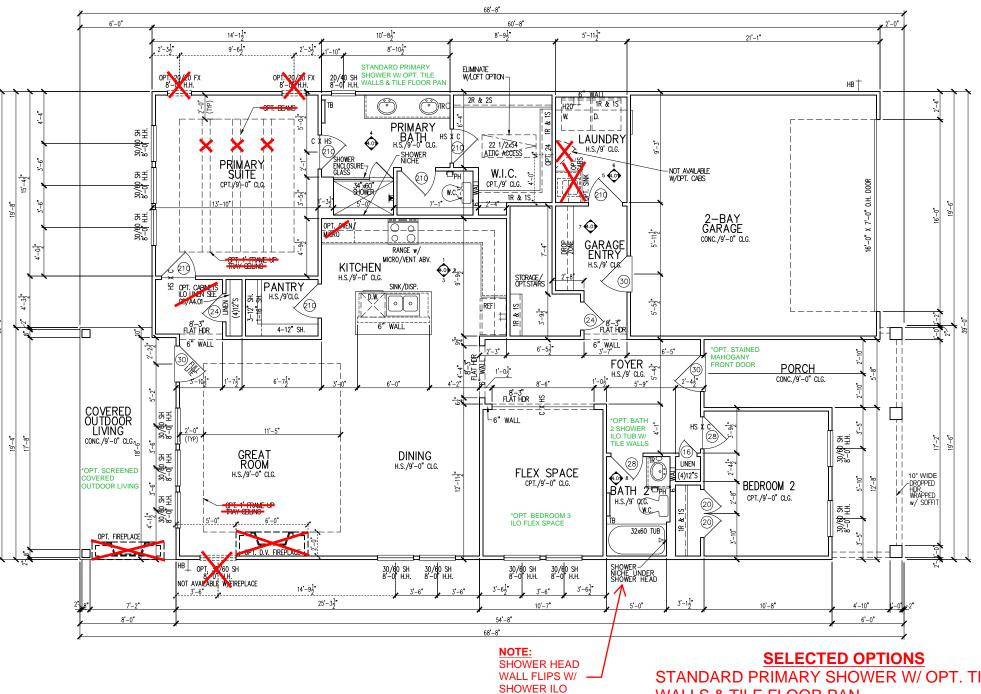

**TUB OPTION** 

**LOT 373** 5920-04 **CYPRESS COVE ELEVATION B RIGHT-HAND GARAGE** 

STANDARD PRIMARY SHOWER W/ OPT. TILE WALLS & TILE FLOOR PAN

\*OPT. BATH 2 SHOWER ILO TUB W/ TILE WALLS

\*OPT. BEDROOM 3 ILO FLEX SPACE

\*OPT. SCREENED COVERED OUTDOOR LIVING \*OPT. STAINED MAHOGANY FRONT DOOR

\*OPT. FIRE-RATED GARAGE SIDE

\*OPT. FIRE-RATED NON-GARAGE SIDE

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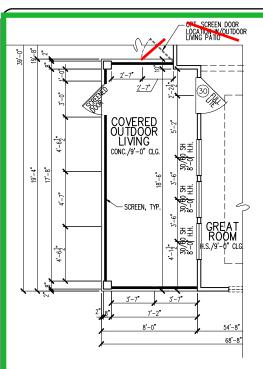
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# OPT. SCREENED COVERED OUTDOOR LIVING PARTIAL FLOOR PLAN

### MAIN FLOOR NOTES

# EXPLANATION

ALL NON-DIMENSIONED PARTITIONS ARE 3-1/2" ROUGH

OTHERWISE (U.N.O.)

PROVIDE MIN. 2-2x12's w/ 1/2" PLYWD. FLITCH PLATE AT ALL EXTERIOR WALL OPENINGS & INTERIOR BEARING WALL OPENINGS

ALL EXTERIOR DIM'S ARE TO FACE OF STUDS U.N.O.

ALL TRUSSES TO BEAR ON EXTERIOR WALLS AND/OR GIRDER TRUSS U.N.O.

TRUSS MFG. TO SIZE MEMBERS, FASTENERS, HANGERS & SET SPACING FOR ALL TRUSSES

WINDOW SUPPLIER TO VERIFY AT LEAST ONE WINDOW IN ALL BEDROOMS TO HAVE A CLEAR EGRESS OPENING OF 5.7 SQ. FT.  $\mbox{\ensuremath{\text{w/MIN}}}$  DIM's OF 24" IN HT AND 20" IN WIDTH; SILL HT NOT TO

ALL BALUSTER TO BE SPACED SUCH THAT A 4" SPHERE CANNO PASS BETWEEN BALUSTER

ALL ELEC. & MECH. EQUIPMENT & METERS ARE SUBJECT TO RELOCATION DUE TO FIELD CONDITIONS; CONTRACTOR TO VERIFY

FOR ADDITIONAL NOTES, SEE GENERAL NOTES ON TITLE SHEET & DETAILS

ALL TYP. WINDOWS 6'-0" IN HT AND SMALLER, THE HEAD HEIGHT SHALL BE 8'-10" ABOVE FINISHED FLOOR (U.N.O.)

STRUCTURAL ENGINEERING PROVIDED BY OTHERS

REFER TO INTERIOR ELEVATIONS SHEET TO VIEW BUBBLE CALLOUTS

INTERIOR DOOR HEIGHTS ARE AS FOLLOWS - PRIMARY SUITE, PRIMARY BATH, & PRIMARY CLOSET ARE 8' TALL DOORS. ALL OTHER DOORS ARE 6'-8".

BATH ACCESSORY INSTALLATION HEIGHTS ARE MEASURED TO CENTER OF ACCESSORY:


TB - 60" A.F.F. TH - 60" A F.F.

TP - 26" A.F.F. OPT. GRAB BAR (GB) - 36" A.F.F.

SHUT-OFF VALVE TO BE LOCATED IN GARAGE

ROD AND SHELF HEIGHTS ARE MEASURED TO TOP OF ROD AND BOTTOM OF SHELVES — SEE D-1.0 FOR DETAILS: 2R2S -TOP ROD - 6'-8" SHELF - 5'-10" TOP SHELF - 6'-10"

BOTTOM ROD - 3'-4" BOTTOM SHELF - 3'-6"

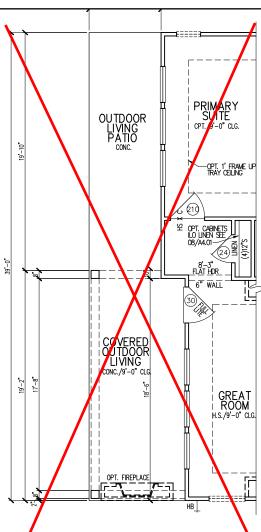

OPT. OUTDOOR LIVING PATIO PARTIAL FLOOR PLAN

COOKTOP w/

VENT ABV.

SINK/DISP

6" WALL


**OPT/GOURMET 2** 

KITCHEN - PARTIAL

PARTIAL FLOOR PLAN


FULL DEPTH CABINET OVER FRIDGE

KITCHEN

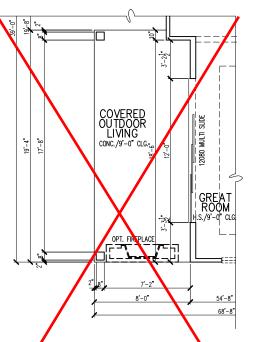


OP7. 12080 MULTI SLIDE DOOR AT GREAT ROOM PARTIAL FLOOR PLAN




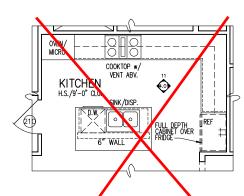


OPT/ GOURMET 1 KITCHEN - PARTIAL PARTIAL FLOOR PLAN

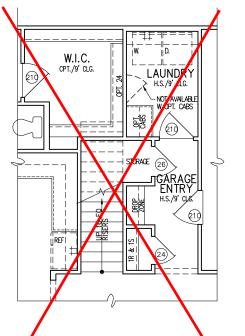


OP/ SECOND FLOOR STAIR PARTIAL FLOOR PLAN

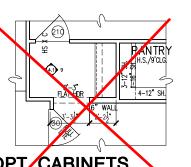

OPT CABINETS
ILO LINEN CLOSET
PARTIAL FLOOR PLAN

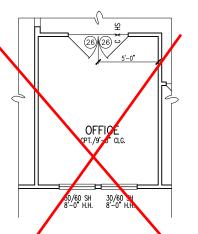


OPT. OFFICE ILO FLEX SPACE PARTIAL FLOOR PLAN

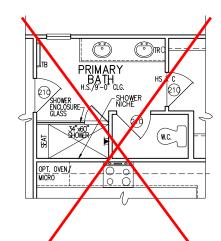

OPT. PRIMARY BATH 1 PARTIAL FLOOR PLAN



OPT DOOR FROM PRIM. W.I.C TO LAUNDRY PARTIAL FLOOR PLAN

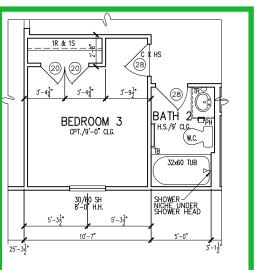

OPT. BEDROOM 3 ILO FLEX SPACE PARTIAL FLOOR PLAN

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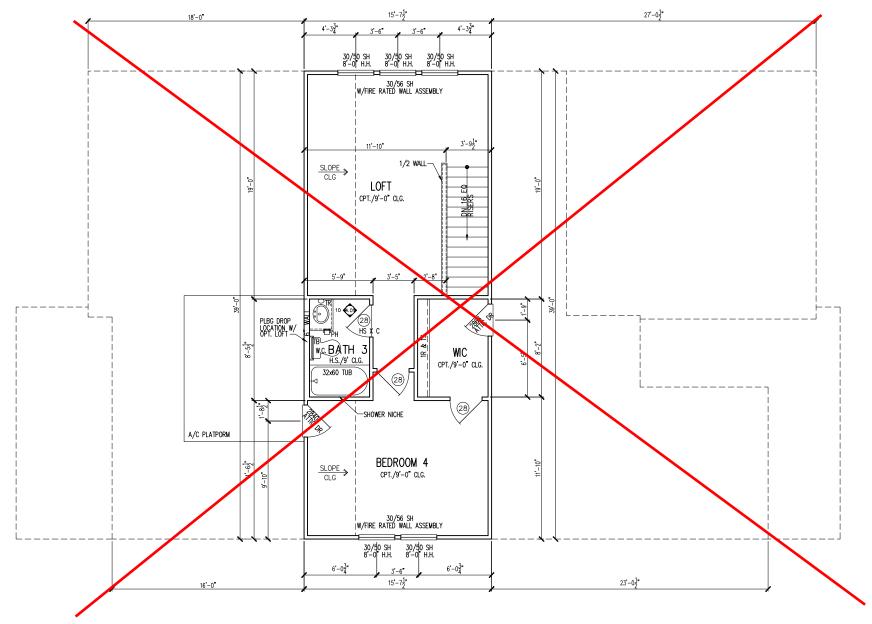
5920-04

CYPRESS COVE

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### MAIN FLOOR NOTES EXPLANATION ALL NON-DIMENSIONED PARTITIONS ARE 3-1/2" ROUGH ALL ANGLED PARTITIONS ARE 45 DEGREES UNLESS NOTED OTHERWISE (U.N.O.) PROVIDE MIN. 2-2x12's w/ 1/2" PLYWD. FLITCH PLATE AT ALL EXTERIOR WALL OPENINGS & INTERIOR BEARING WALL OPENINGS 4. ALL EXTERIOR DIM'S ARE TO FACE OF STUDS U.N.O. ALL TRUSSES TO BEAR ON EXTERIOR WALLS AND/OR GIRDER TRUSS U.N.O. TRUSS MFG. TO SIZE MEMBERS, FASTENERS, HANGERS & SET SPACING FOR ALL TRUSSES WINDOW SUPPLIER TO VERIFY AT LEAST ONE WINDOW IN ALL BEDROOMS TO HAVE A CLEAR EGRESS OPENING OF 5.7 SQ. FT. w/MIN DIM's OF 24" IN HT AND 20" IN WIDTH; SILL HT NOT TO ALL BALUSTER TO BE SPACED SUCH THAT A 4" SPHERE CANNOT PASS BETWEEN BALUSTER ALL ELEC. & MECH. EQUIPMENT & METERS ARE SUBJECT TO RELOCATION DUE TO FIELD CONDITIONS; CONTRACTOR TO FOR ADDITIONAL NOTES, SEE GENERAL NOTES ON TITLE SHEET ALL TYP. WINDOWS 6'-0" IN HT AND SMALLER, THE HEAD HEIGHT 12. STRUCTURAL ENGINEERING PROVIDED BY OTHERS REFER TO INTERIOR ELEVATIONS SHEET TO VIEW BUBBLE CALLOUTS INTERIOR DOOR HEIGHTS ARE AS FOLLOWS - PRIMARY SUITE, PRIMARY BATH, & PRIMARY CLOSET ARE 8' TALL DOORS. ALL OTHER DOORS ARE 6'-8". BATH ACCESSORY INSTALLATION HEIGHTS ARE MEASURED TO CENTER OF ACCESSORY: TR - 20" ABV. VANITY COUNTER-TO TP - 26" A.F.F. TH - 60" A.F.F. OPT. GRAB BAR (GB) - 36" A.F.F. SHUT-OFF VALVE TO BE LOCATED IN GARAGE ROD AND SHELF HEIGHTS ARE MEASURED TO TOP OF ROD AND BOTTOM OF SHELVES - SEE D-1.0 FOR DETAILS: 1R1S -R0D - 5'-8" SHELF - 5'-10" 2R2S -TOP ROD - 6'-8" " TOP SHELF - 6'-10"

UNDER 9,000 FT<sup>2</sup> FIRE-RATED WALL
REQUIRED AT GARAGE
SIDE & NON-GARAGE SIDE



OPT. SECOND FLOOR PLAN PARTIAL FLOOR PLAN 1/8"=1"-0" SELECTED OPTIONS

STANDARD PRIMARY SHOWER W/ OPT. TILE WALLS & TILE FLOOR PAN

\*OPT. BATH 2 SHOWER ILO TUB W/ TILE WALLS

\*OPT. BEDROOM 3 ILO FLEX SPACE

\*OPT. SCREENED COVERED OUTDOOR LIVING

\*OPT. STAINED MAHOGANY FRONT DOOR

\*OPT. FIRE-RATED GARAGE SIDE

\*OPT. FIRE-RATED NON-GARAGE SIDE

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HOMES

HOMES

Business Operations 5440 Wade Park Blvd Suite 400 Raleigh, NC 27607

NN - OPTION

FLOOR

2ND

SUBDIVISION: ALTIS @ SEREN ADDRESS:42 SHADY CREEK WA FUQUAY-VARINA, NC LOT:373 BLOCK:

Issue Date: 10-13-24
Drawn By: ACC


5920-04


CYPRESS COVE


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LOT 373
5920-04
CYPRESS COVE
ELEVATION B
RIGHT-HAND GARAGE

BOTTOM SHELF - 3'-6"



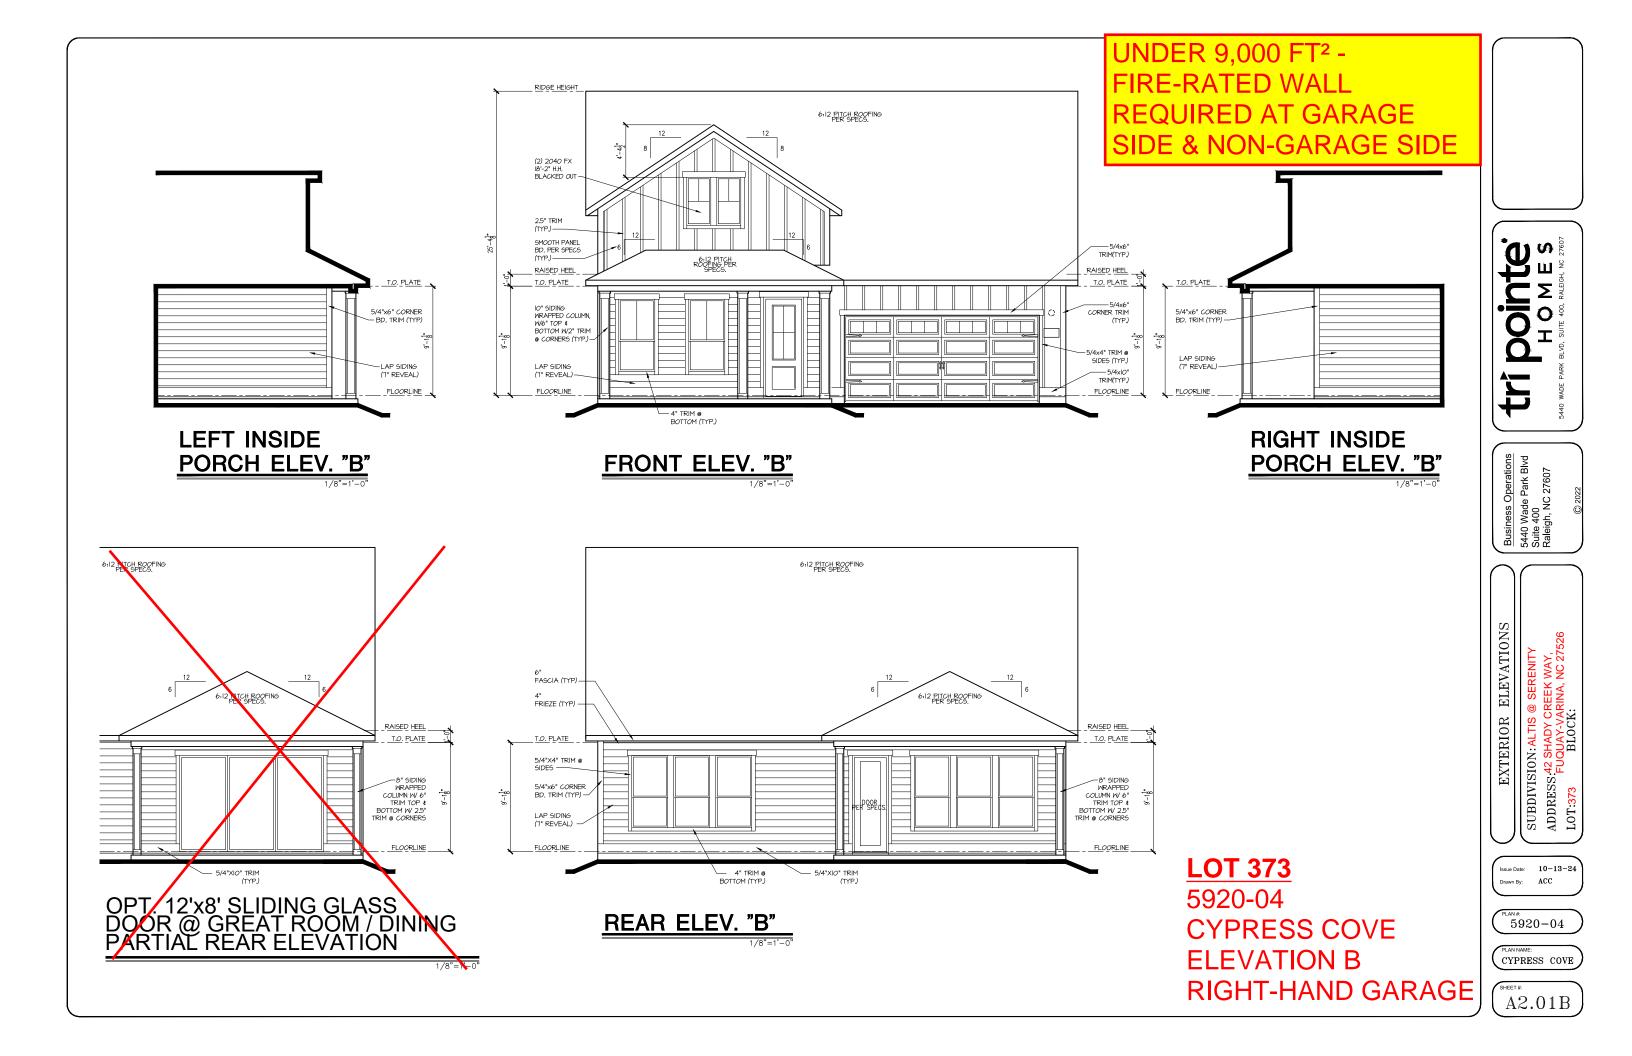

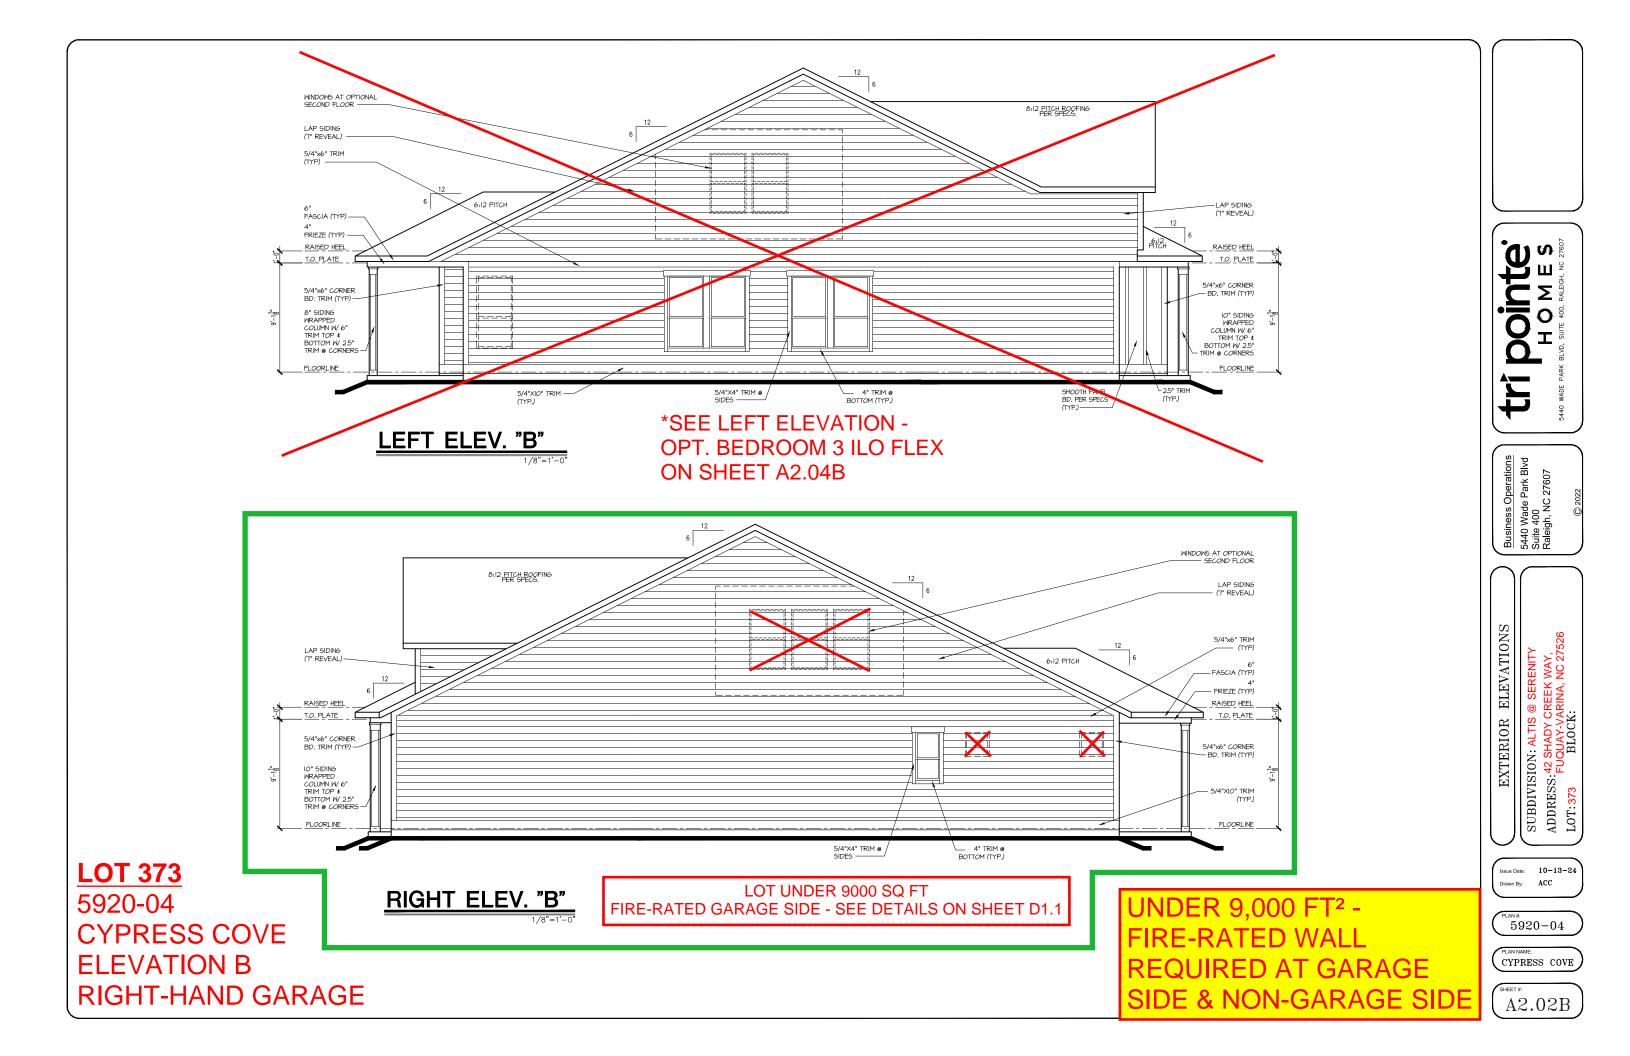

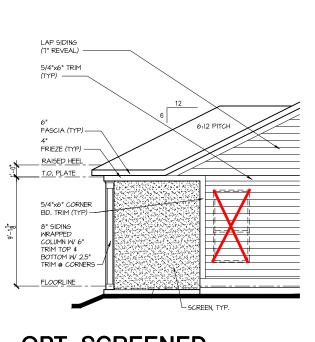OPT. SCREENED COVERED OUTDOOR LIVING PARTIAL LEFT ELEVATION

6:12 PITCH - FASCIA (TYP) – FRIEZE (TYP) RAISED HEEL T.O. PLATE 5/4"x6" CORNER (TYP.)

OPT. SCREENED COVERED OUTDOOR LIVING PARTIAL RIGHT ELEVATION

6:12 PITCH ROOFING PER SPECS. 6:12 PITCH ROOFING PER SPECS. RAISED HEEL T.O. PLATE 8" SIDING WRAPPED COLUMN W 6" TRIM TOP & BOTTOM W 2.5" TRIM @ CORNERS SCREEN, TYP.

OPT. SCREENED COVERED OUTDOOR LIVING PARTIAL REAR ELEVATION

UNDER 9,000 FT<sup>2</sup> -REQUIRED AT GARAGE SIDE & NON-GARAGE SIDE Dointe HOMES RR BLYD. SUITE 400, RALEIGH, NC 22607 4

Business Operations 5440 Wade Park Blvd Suite 400 Raleigh, NC 27607

OPTION EXTERIOR ELEVATIONS SUBDIVISION: ALTIS @ SERE
ADDRESS: 42 SHADY CREEK W
FUQUAY-VARINA, N
LOT: 373 BLOCK:

Issue Date: 10-13-24

ACC

5920-04


CYPRESS COVE

A2.03B

**LOT 373** 5920-04

**CYPRESS COVE ELEVATION B** 

**RIGHT-HAND GARAGE** 

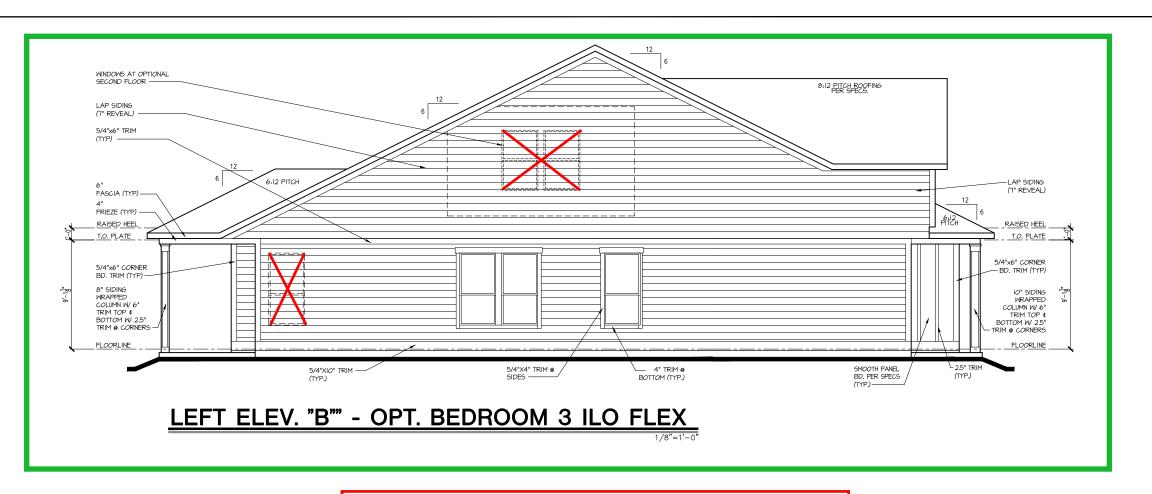

LOT UNDER 9000 SQ FT FIRE-RATED NON-GARAGE SIDE - SEE DETAILS ON SHEET D1.1

**LOT 373** 5920-04 **CYPRESS COVE ELEVATION B RIGHT-HAND GARAGE** 

UNDER 9,000 FT<sup>2</sup> -REQUIRED AT GARAGE SIDE & NON-GARAGE SIDE Dointe HOMES KRUD. SUITE 400, RALEGH, NG 27807 4

Business Operations 5440 Wade Park Blvd Suite 400 Raleigh, NC 27607


EXTERIOR ELEVATIONS OPTION SUBDIVISION: ALTIS @ SERENITY
ADDRESS: 42 SHADY CREEK WAY,
FUQUAY-VARINA, NC 27526
LOT: 373 BLOCK:

10-13-24 Issue Date: ACC

5920-04

CYPRESS COVE

A2.04B

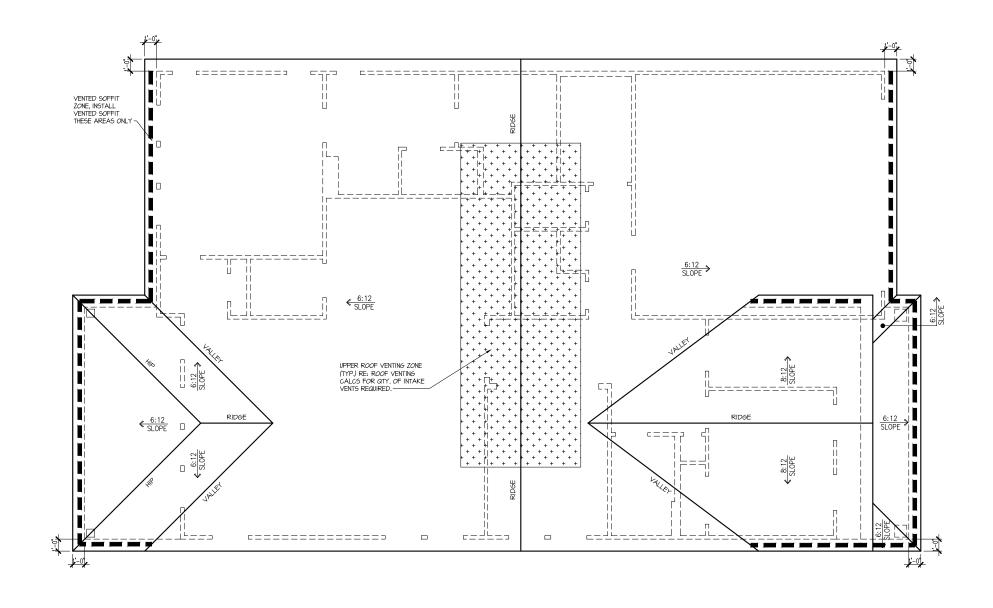

Attic Venting Calculations Elev. "B"			
ROOF INFORMATION	BASE		
TOTAL SF ROOF AREA	2740		
AVAILABLE L.F. ROOF SOFFIT	115		
AVAILABLE L.F. ROOF RIDGE	61		
VENT TYPES	QTY VENTS REQ'D		
LOWER VENTS CONTINUOUS SOFFIT VENTING @ 5 SI/LF	132 LF		
UPPER VENTS SLANT 150 VENTS @ 150 SI/VENT	4		
UPPER VENTS 4' RIDGE VENTS @ 72 SI/VENT	9		

NOTE: QTY OF UPPER VENTS SHOWN COVERS 100% OF UPPER VENTING. NO MIXING OF VENT TYPES FOR UPPER VENTING IS FIGURED FOR IN THIS TABLE.

ROOF PLAN 'B'

LOT 373
5920-04
CYPRESS COVE
ELEVATION B
RIGHT-HAND GARAGE

UNDER 9,000 FT<sup>2</sup> -FIRE-RATED WALL REQUIRED AT GARAGE SIDE & NON-GARAGE SIDE tri pointe.
H O M E S
5440 WADE PARK BLVD, SUITE 400, RALEIGH, NG 27807

Business Operations 5440 Wade Park Blvd Suite 400 Raleigh, NC 27607

SUBDIVISION: ALTIS @ SERENITY
ADDRESS:42 SHADY CREEK WAY,
FUQUAY-VARINA, NC 27526
LOT:373 BLOCK:

Issue Date: 10-13-24
Drawn By: ACC

5920-04

CYPRESS COVE

(A3.01B)



POINTE AD MES

Business Operations 5440 Wade Park Blvd Suite 400 Raleigh, NC 27607

SUBDIVISION: ALTIS @ SERENITY
ADDRESS:42 SHADY CREEK WAY,
FUQUAY-VARINA, NC 27526
LOT:373 BLOCK:

Issue Date: 10-13-24 Drawn By: ACC

5920-04

CYPRESS COVE

A4.01


ELECTRICAL I SCHEDU	FIXTURE LE
DESCRIPTION	SYMBOL
110V OUTLET	ф
220V OUTLET	<b>\$</b> 220
1/2 HOT OUTLET	
GFI OUTLET	% GFI
WP GFI OUTLET	₩P/GFI
GARAGE DOOR OPENER OUTLET	Ø GDO
SECURITY SYSTEM	♦ SEC SYS
DISHWASHER	●DW
JUNCTION BOX	Ū
CEILING MOUNTED LIGHT	<b>-</b>
CEILING FAN w/ LIGHT KIT	PROVIDE BRACING
RECESSED CEILING LIGHT	Ø
RECESSED WATER PROOF LIGHT	⊠ WP
WALL MOUNTED LIGHT	04
WALL MOUNTED PUSH BUTTON	<b>å</b> PB
TWO WAY SWITCH	\$
THREE WAY SWITCH	<b>"</b> \$
FOUR WAY SWITCH	₩
DIMMER SWITCH	\$□
EXHAUST VENTS	<b>S</b> VENT TO EXT
LOW VOLTAGE PANEL	
PHONE OUTLET	●PH
TV OUTLET	<b>⊕</b> TV
DATA & RG6 COMBO BOX	
SMOKE DETECTOR	(ý)
CARBON MONOXIDE SMOKE DETECTOR COMBO	⊚ CM/SD
DOOR CHIMES	CHIMES
ELECTRICAL PANEL	₽ EP
SURFACE MOUNT LED	+
EXTERIOR WALL MOUNT UPLIGHT	88
SOFFIT MOUNT FLOOD LIGHT	₩
UNDER COUNTER LIGHTING	-cc- UCL
SMURF TUBE	

# **ELECTRICAL NOTES:**

- PROVIDE AND INSTALL LOCALLY CERTIFIED SMOKE AND CARBON MONOXIDE DETECTORS REQUIRED BY NATIONAL FIRE PROTECTION ASSOCIATION (NFPA) AND MEETING THE REQUIREMENTS OF ALL GOVERNING CODES PROVIDE AND INSTALL GROUND FAULT CIRCUIT—INTERRUPTERS (GFI) AS REQUIRED BY NATIONAL ELECTRIC CODE (NEC) AND MEETING THE REQUIREMENTS OF ALL GOVERNING CODES. ELECTRICAL CONTRACTOR TO PROVIDE ELECTRICAL CONTRACTOR TO PROVIDE REQUIRED DIRECT HOOK—UPS/CUTOFFS.
- REQUIRED DIRECT HOOK-UPS/CUTOFFS.
- REQUIRED DIRECT HOOK—UPS/CUTOFFS.
  HVAC CONTRACTOR TO VERIFY THERMOSTAT
  LOCATIONS.
  ALL ELECTRICAL AND MECHANICAL EQUIPMENT
  (I.E. FURNACES, A/C UNITS, ELECTRICAL PANELS,
  SANITARY SUMP PITS, DRAIN TILE SUMP, AND

WATER HEATERS) ARE SUBJECT TO RELOCATION
DUE TO FIELD CONDITIONS.
ELECTRICAL DEVICES: ABOVE FINISHED FLOOR:
SWITCHES OVER COUNTER
WALL OUTLETS OVER COUNTER
+42" TO BOTTOM OF HORIZONTAL OUTLET(TYP. @ COUNTER)
REMAINING SWITCHES
WALL OUTLETS
BATH VANITY BRACKET OUTLET 1,2 (1" ABOVE TOP OF VANITY)
WATER SOFTENER AND SUMP OUTLETS 48" TO CL
EXTERIOR GFI OUTLETS
GARAGE GFI (ABOVE GARAGE FLOOR) 48" TO CL
FRONT DOOR COACH LIGHT
GARAGE DOOR COACH LIGHT, (ABOVE GARAGE FLOOR)
THERMOSTAT
DOORBELL CHIMES
DOORBELL BUTTON DR .HANDLE
KITCHEN HOOD FAN "WHIP"
KITCHEN WALL HUNG MICROWAVE OUTLET 72" TO CL
KITCHEN DISHWASHER RECEPTACLE UNDER SINK
KITCHEN RANGE
KITCHEN REFRIGERATOR
WASHER/DRYER OUTLET
CL = CENTER LINE

- CL = CENTER LINE 1 = FIELD VERIFY 2 = MASTER BATH STANDARD 30" HIGH VANITY TO BE RAISED 4"

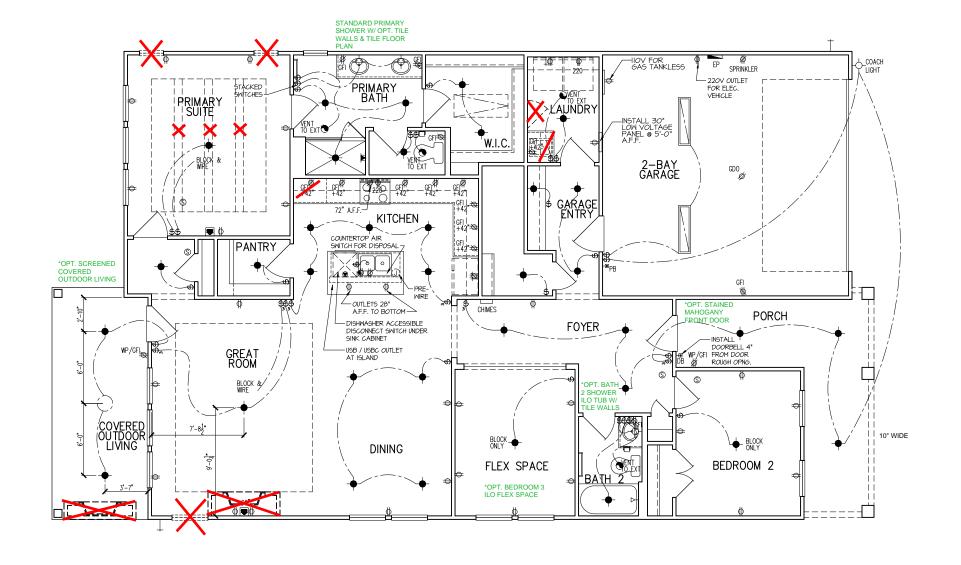

**LOT 373** 5920-04 **CYPRESS COVE ELEVATION B RIGHT-HAND GARAGE** 

SIDE & NON-GARAGE SIDE

Doint B S HOME & は

Business Operations 5440 Wade Park Blvd Suite 400 Raleigh, NC 27607

ELECTRICAL PLAN

SUBDIVISION: ALTIS @ S ADDRESS: 42 SHADY CREE FUQUAY-VARIN LOT: 373 BLOCK:

FLOOR

1st

10-13-24 Issue Date: ACC

5920-04

CYPRESS COVE

E1.10B

ELECTRICAL I SCHEDU	FIXTURE
DESCRIPTION	SYMBOL
110V OUTLET	ф
220V OUTLET	<b>⊕</b> 220
1/2 HOT OUTLET  GFI OUTLET	₩ GFI
WP GFI OUTLET	% WP/GFI
GARAGE DOOR OPENER	
OUTLET	Ø GDO
SECURITY SYSTEM	∯ SEC SYS
DISHWASHER	<b>⊕</b> DW
JUNCTION BOX	Ũ
CEILING MOUNTED LIGHT	· <del>\</del>
CEILING FAN w/ LIGHT KIT	PROVIDE BRACING
RECESSED CEILING LIGHT	R
RECESSED WATER PROOF LIGHT	™ Mb
WALL MOUNTED LIGHT	9
WALL MOUNTED PUSH BUTTON	<b>d</b> PB
TWO WAY SWITCH	\$
THREE WAY SWITCH	*\$
FOUR WAY SWITCH	*\$
DIMMER SWITCH	\$ <sup>DIM</sup>
EXHAUST VENTS	SVENT TO EXT
LOW VOLTAGE PANEL	
PHONE OUTLET	<b>⊜</b> PH
TV OUTLET	<b>⊚</b> TV
DATA & RG6 COMBO BOX	
SMOKE DETECTOR	<u>(S</u> )
CARBON MONOXIDE SMOKE DETECTOR COMBO	⊚ CM/SD
DOOR CHIMES	CHIMES
ELECTRICAL PANEL	EP.
SURFACE MOUNT LED	•
EXTERIOR WALL MOUNT UPLIGHT	88
SOFFIT MOUNT FLOOD LIGHT	445
UNDER COUNTER LIGHTING	eco- UCL
SMURF TUBE	

# **ELECTRICAL NOTES:**

- 1. PROVIDE AND INSTALL LOCALLY CERTIFIED SMOKE AND CARBON MONOXIDE DETECTORS REQUIRED BY NATIONAL FIRE PROTECTION ASSOCIATION (NFPA) AND MEETING THE REQUIREMENTS OF ALL GOVERNING CODES 2. PROVIDE AND INSTALL GROUND FAULT (IRCUIT-INTERRUPTERS (GFI) AS REQUIRED BY NATIONAL ELECTRIC CODE (NEC) AND MEETING THE REQUIREMENTS OF ALL GOVERNING CODES.


  3. ELECTRICAL CONTRACTOR TO PROVIDE REQUIRED DIRECT HOOK—UPS/CUTOFFS.

  4. HVAC CONTRACTOR TO VERIFY THERMOSTAT LOCATIONS.

  ALL ELECTRICAL AND MECHANICAL EQUIPMENT (I.E. FURNACES, A/C UNITS, ELECTRICAL PANELS, SANITARY SUMP PITS, DRAIN TILE SUMP, AND WATER HEATERS) ARE SUBJECT TO RELOCATION

WATER HEATERS) ARE SUBJECT TO RELOCATION DUE TO FIELD CONDITIONS.	
ELECTRICAL DEVICES: ABOVE FINISHED FLOOR:	
SWITCHES OVER COUNTER	
WALL OUTLETS OVER COUNTER	
+42" TO BOTTOM OF HORIZONTAL OUTLET(TYP. @ COUNTER)	
REMAINING SWITCHES	
WALL OUTLETS	
BATH VANITY BRACKET OUTLET 1,2 (1" ABOVE TOP OF VANITY)	
WATER SOFTENER AND SUMP OUTLETS 48" TO CL	
EXTERIOR GFI OUTLETS	
GARAGE GFI (ABOVE GARAGE FLOOR) 48" TO CL	
FRONT DOOR COACH LIGHT	
GARAGE DOOR COACH LIGHT, (ABOVE GARAGE FLOOR)84".TO CL	
THERMOSTAT	
DOORBELL CHIMES	
DOORBELL BUTTON	-
KITCHEN HOOD FAN "WHIP"	
KITCHEN WALL HUNG MICROWAVE OUTLET 72" TO CL	
KITCHEN DISHWASHER RECEPTACLE JNDER SINI	K
KITCHEN RANGE	
KITCHEN REFRIGERATOR	
WASHER/DRYER OUTLET	
CL = CENTED LINE	

CL = CENTER LINE
1 = FIELD VERIFY
2 = MASTER BATH STANDARD 30" HICH
VANITY TO BE RAISED 4"

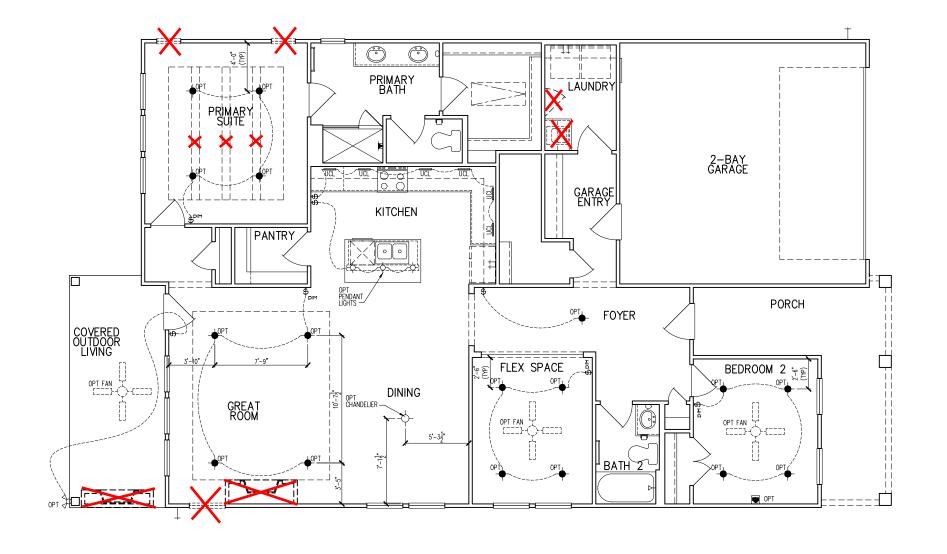

CHECK BOO FOR SELECTED ELECTRICAL OPTIONS

**LOT 373** 5920-04 **CYPRESS COVE ELEVATION B RIGHT-HAND GARAGE** 

SIDE & NON-GARAGE SIDE

**Dointe**HOMES

RELYD, SUITE 400, RALEIGH, NC 27607

Business Operations 5440 Wade Park Blvd Suite 400 Raleigh, NC 27607

OPITONS


1st FLOOR ELEC. PLAN SUBDIVISION: ALTIS @ SERE
ADDRESS:42 SHADY CREEK W
FUQUAY-VARINA, N
LOT:373 BLOCK:

10-13-24 Issue Date: ACC

5920-04

CYPRESS COVE

E1.11B

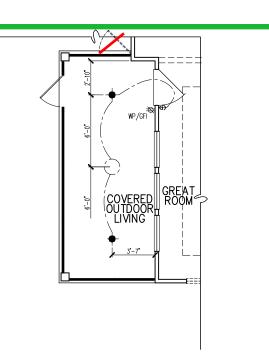

OPT. SCREENED COVERED OUTDOOR LIVING

PARTIAL ELECTRICAL PLAN


ELECTRICAL FIXTURE SCHEDULE

**CHECK BOO** FOR SELECTED **ELECTRICAL** 


OPT. OUTDOOR LIVING PATIO PARTIAL ELECTRICAL PLAN

# **OPTIONS** DESCRIPTION SYMBOL

DESCRIPTION	3 INDOL	
110V OUTLET	ф	
220V OUTLET	<b>Ф</b> 220	
1/2 HOT OUTLET	♦	
GFI OUTLET	<b>V</b> \$ GFI	!
WP GFI OUTLET	₩P/GFI	
GARAGE DOOR OPENER OUTLET	Ø GDO	
SECURITY SYSTEM	Ø SEC SYS	
DISHWASHER	<b>⊕</b> DW	
JUNCTION BOX	0	
CEILING MOUNTED LIGHT	<b></b>	ELECTRICAL MOTEO
CEILING FAN w/ LIGHT KIT	BRAZINE	ELECTRICAL NOTES:  1. PROVIDE AND INSTALL LOCALLY CERTIFIED SMOKE AND CARBON MOKINDE DETECTIORS AS REQUIRED BY NATIONAL FIRE PROTECTION
RECESSED CEILING LIGHT	Ø	ASSOCIATION (NFPA) AND MEETING THE
RECESSED WATER PROOF LIGHT	) <b>⊠</b> (WP	REQUIREMENTS OF ALL GOVERNING CODES 2 PROVIDE AND INSTALL CROLING FALLET
WALL MOUNTED LIGHT	Ŷ	CIRCUIT-INTERRUPTERS (GFI) AS REQUIRED BY NATIONAL ELECTRIC CODE (NEC) AND MEETING
WALL MOUNTED PUSH BUTTON	á PB	THE REQUIREMENTS OF ALL GOVERNING CODES.  3. ELECTRICAL CONTRACTOR TO PROVIDE
TWO WAY SWITCH	\$	REQUIRED DIRECT HOOK-UPS/CUTOFFS.
THREE WAY SWITCH	3\$	HVAC CONTRACTOR TO VERIFY THERMOSTAT LOCATIONS.
FOUR WAY SWITCH	<b>*</b> \$	<ol> <li>ALL ELECTRICAL AND MECHANICAL EQUIPMENT (I.E. FURNACES, A/C UNITS, ELECTRICAL PANELS,</li> </ol>
DIMMER SWITCH	\$ <sup>DIM</sup>	SANITARY SUMP PITS, DRAIN TILE SUMP, AND
EXHAUST VENTS	<b>S</b> VENT TO EXT	WATER HEATERS) ARE SUBJECT TO RELOCATION DUE TO FIELD CONDITIONS.
LOW VOLTAGE PANEL	<b>□</b> ₽□	ELECTRICAL DEVICES: ABOVE FINISHED FLOOR:
PHONE OUTLET	<b>⊕</b> PH	SWITCHES OVER COUNTER
TV OUTLET	⊛TV	WALL OUTLETS OVER COUNTER
DATA & RG6 COMBO BOX		REMAINING SWITCHES
SMOKE DETECTOR	S	WALL OUTLETS
CARBON MONOXIDE SMOKE DETECTOR COMBO	⊚ CM/SD	BATH VANITY BRACKET OUTLET
DOOR CHIMES	CHIMES	WATER SOFTENER AND SUMP OUTLETS 48" TO CL EXTERIOR GFI OUTLETS
ELECTRICAL PANEL	EP	GARAGE GFI (ABOVE GARAGE FLOOR) 48" TO CL
SURFACE MOUNT LED	-	FRONT DOOR COACH LIGHT
EXTERIOR WALL MOUNT UPLIGHT	X.	GARAGE DOOR COACH LIGHT, (ABOVE GARAGE FLOOR)84°.TO CL
SOFFIT MOUNT FLOOD LIGHT	44	THERMOSTAT
UNDER COUNTER LIGHTING	-==-UCL	
SMURF TUBE		DOORBELL BUTTON. LEVEL W/ KITCHEN HOOD FAN "WHIP"
		KITCHEN WALL HING MICROWAVE OUTLET. 72 TO CL KITCHEN DISHMASHER RECEPTACLE. LIADERS SINK KITCHEN RANGE. 24* TO. CL. KITCHEN RETRIGERATOR. 46* TO CL WISHER/DEPKER OUTLET. 46* TO CL CL = CENTER LINE 1 = FELDL WERFY
		2 = MASTER BATH STANDARD 30" HIGH VANITY TO BE RAISED 4"

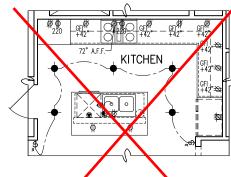

OPT. GOURMET 2 KITCHEN - PARTIAL ELECTRICAL PLAN

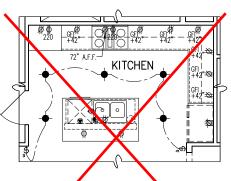


COVERED OUTDOOR LIVING

GREAT ROOM

PRIMARY SUJTE


OUTDOOR LIVING PATIO

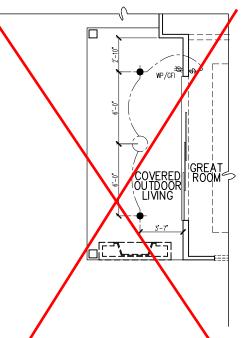


OPT. 12080 MULTI SLIDE DOOR AT GREAT ROOM PARTIAL ELECTRICAL PLAN




OPT. SHOWER ILO TUB AT BATH 2 - PARTIAL ELECTRICAL PLAN

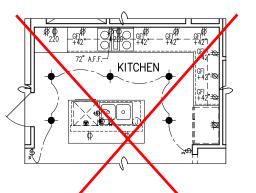

OPT. GOURMET 1 ELECTRICAL PLAN

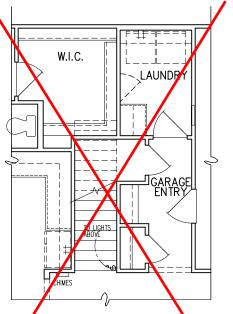

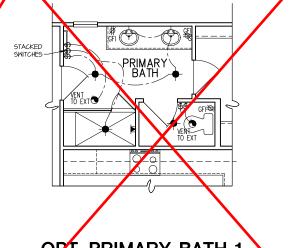


OPT. PRIMARY BATH 1
PARTIAL ELECTRICAL PLAN

OPT. SECOND FLOOR STAIR PARTIAL ELECTRICAL PLAN




OPT CABINETS NO LINEN CABINETS -PARTIAL ELECT. PLAN

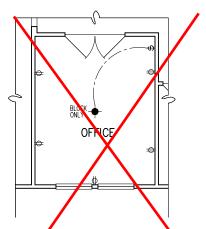

OPT OFFICE ILO FLEX SPACE - PARTIAL EVECTRICAL PLAN



OPT. DOOR FROM PRIM. W.I.C TO LAUNDRY PARTIAL ELECT. PLAN

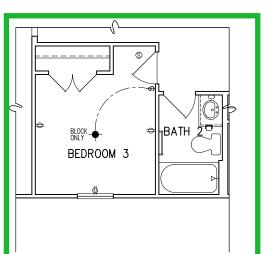

OPT. BEDROOM 3 ILO FLEX SPACE - PARTIAL ELECTRICAL PLAN

**Dointe**HOMES 4

Business Operations 5440 Wade Park Blvd Suite 400 Raleigh, NC 27607

OPTIONS SUBDIVISION: ALTIS @ PLAN ELEC.

ADDRESS: 42 FU LOT: 373 10-13-24 Issue Date: ACC

5920-04

CYPRESS COVE

01.E10

	1	
ELECTRICAL FIXTURE SCHEDULE		
DESCRIPTION	SYMBOL	
110V OUTLET	ф	
220V OUTLET	© 220	
1/2 HOT OUTLET	•	
GFI OUTLET	₩ GFI	
WP GFI OUTLET	₩P/GFI	
GARAGE DOOR OPENER OUTLET	Ø GDO	
SECURITY SYSTEM	♦ SEC SYS	
DISHWASHER	<b>⊕</b> DW	
JUNCTION BOX	0	
CEILING MOUNTED LIGHT	<b>-</b>	
CEILING FAN w/ LIGHT KIT	BROVIDE	
RECESSED CEILING LIGHT	Ø	
RECESSED WATER PROOF LIGHT	⊠WP	
WALL MOUNTED LIGHT	Q	
WALL MOUNTED PUSH BUTTON	₫ PB	
TWO WAY SWITCH	\$	
THREE WAY SWITCH	³\$	
FOUR WAY SWITCH	<b>4</b> \$	
DIMMER SWITCH	\$ <sup>DIM</sup>	
EXHAUST VENTS	<b>S</b> VENT TO EXT	
LOW VOLTAGE PANEL		
PHONE OUTLET	<b>●</b> PH	
TV OUTLET	<b>⊚</b> TV	
DATA & RG6 COMBO BOX		
SMOKE DETECTOR	<u>(S</u> )	
CARBON MONOXIDE SMOKE DETECTOR COMBO	⊚ CM/SD	
DOOR CHIMES	CHIMES	
ELECTRICAL PANEL	£.	
SURFACE MOUNT LED	-	
EXTERIOR WALL MOUNT UPLIGHT	8	
SOFFIT MOUNT FLOOD LIGHT	443	
UNDER COUNTER LIGHTING	-co- UCL	
SMURF TUBE		


# **ELECTRICAL NOTES:**

- 1. PROVIDE AND INSTALL LOCALLY CERTIFIED SMOKE AND CARBON MONOXIDE DETECTORS AS REQUIRED BY NATIONAL FIRE PROTECTION ASSOCIATION (NFPA) AND MEETING THE REQUIREMENTS OF ALL GOVERNING CODES
  2. PROVIDE AND INSTALL GROUND FAULT (IRCUIT—INTERRUPTERS (GF) AS REQUIRED BY NATIONAL ELECTRIC CODE (NEC) AND MEETING THE REQUIREMENTS OF ALL COVERNING CODES.
  3. ELECTRICAL CONTRACTOR TO PROVIDE REQUIRED DIRECT HOOK—UPS/CUTOFFS.
  4. HYAC CONTRACTOR TO VERIFY THERMOSTAT LOCATIONS.
  5. ALL ELECTRICAL AND MECHANICAL EQUIPMENT (I.E. FURNACES, A/C UNITS, ELECTRICAL PANELS, SANITARY SUMP PITS, DEAN TILE SUMP, AND WATER HEATERS) ARE SUBJECT TO RELOCATION

SANITART SUMP PITS, DRAIN TILE SUMP, AND
WATER HEATERS) ARE SUBJECT TO RELOCATION
DUE TO FIELD CONDITIONS.
ELECTRICAL DEVICES: ABOVE FINISHED FLOOR:
SWITCHES OVER COUNTER
WALL OUTLETS OVER COUNTER
+42" TO BOTTOM OF HORIZONTAL OUTLET(TYP. @ COUNTER)
REMAINING SWITCHES
WALL OUTLETS
BATH VANITY BRACKET OUTLET
WATER SOFTENER AND SUMP OUTLETS 48" TO CL
EXTERIOR GFI OUTLETS
GARAGE GFI (ABOVE GARAGE FLOOR) 48" TO CL
FRONT DOOR COACH LIGHT
GARAGE DOOR COACH LIGHT, (ABOVE GARAGE FLOOR) 84". TO CL
THERMOSTAT
DOORBELL CHIMES
DOORBELL BUTTON DR. HANDLE
KITCHEN HOOD FAN "WHIP"
KITCHEN WALL HUNG MICROWAVE OUTLET 72" TO CL
KITCHEN DISHWASHER RECEPTACLE JUNDER SINI
KITCHEN RANGE
KITCHEN REFRIGERATOR
WASHER/DRYER OUTLET

- CL = CENTER LINE 1 = FIELD VERIFY 2 = MASTER BATH STANDARD 30" HIGH VANITY TO BE RAISED 4"

**LOT 373** 5920-04 **CYPRESS COVE ELEVATION B RIGHT-HAND GARAGE** 

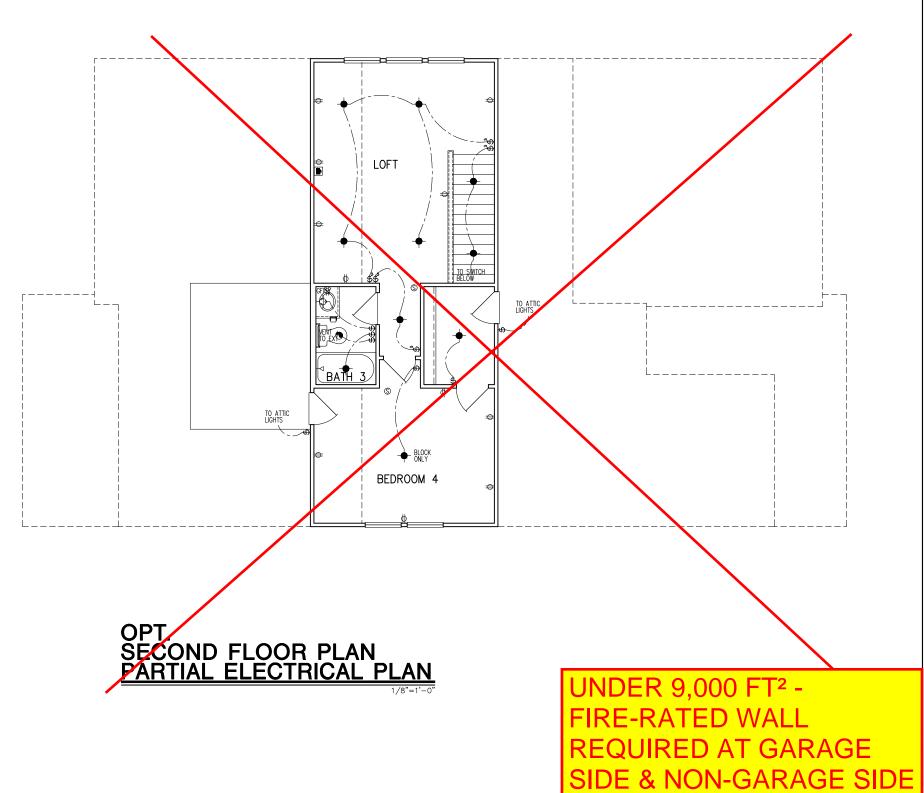

Dointe HOMES RR BLD. SUITE 400, RALEIGH, NC 27607 は

Business Operations 5440 Wade Park Blvd Suite 400 Raleigh, NC 27607

OPTION

FLR ELEC. PLAN


SUBDIVISION: ALTIS @ SERE
ADDRESS:42 SHADY CREEK W
FUQUAY-VARINA, N
LOT:373 BLOCK: 2nd

10-13-24 Drawn By: ACC

5920-04


CYPRESS COVE


01.E20

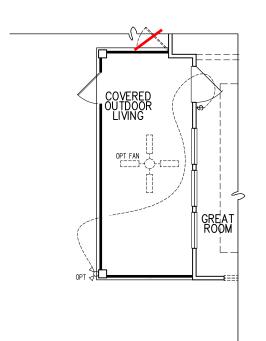

OPT. SCREENED COVERED OUTDOOR LIVING PARTIAL ELECTRICAL PLAN


LOT 373 5920-04 CYPRESS COVE ELEVATION B RIGHT-HAND GARAGE

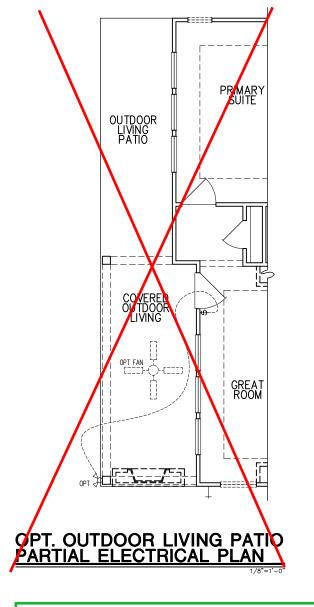

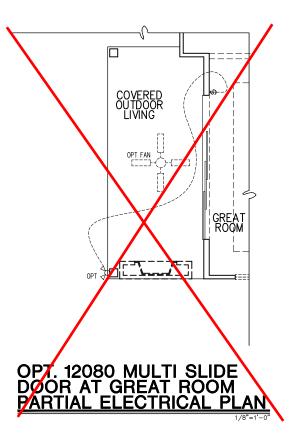


UNDER 9,000 FT<sup>2</sup> FIRE-RATED WALL
REQUIRED AT GARAGE
SIDE & NON-GARAGE SIDE




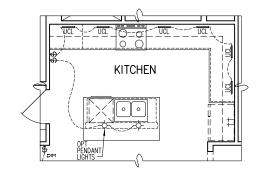


OPT. 2-PACK PENDANTS AT KITCHEN - PARTIAL ELECTRICAL PLAN

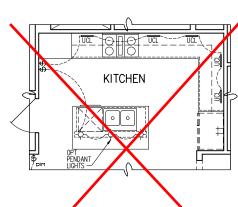


OPT. GOURMET 2 KITCHEN - PARTIAL ELECTRICAL PLAN

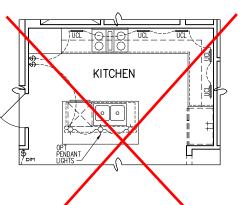

OPT. GOURMET 1 KITCHEN - PARTIAL ELECTRICAL PLAN

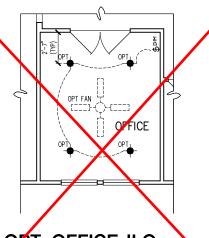

OPT. OFFICE ILO FLEX SPACE - PARTIAL ELECTRICAL PLAN

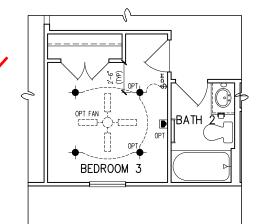

OPT. BEDROOM 3 ILO FLEX SPACE - PARTIAL ELECTRICAL PLAN Tribointe HOMES HOMES S40 WADE PARK BLYD, SUITE 400, RALEIGH, NC 27607

Business Operations 5440 Wade Park Blvd Suite 400 Raleigh, NC 27607


SUBDIVISION: ALTIS @ SERENITY
ADDRESS: 42 SHADY CREEK WAY,
FUQUAY-VARINA, NC 27526
LOT: 373
BLOCK:

Issue Date: 10-13-24
Drawn By: ACC

FLAN#: 5920-04


CYPRESS COVE


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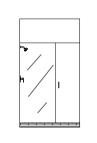


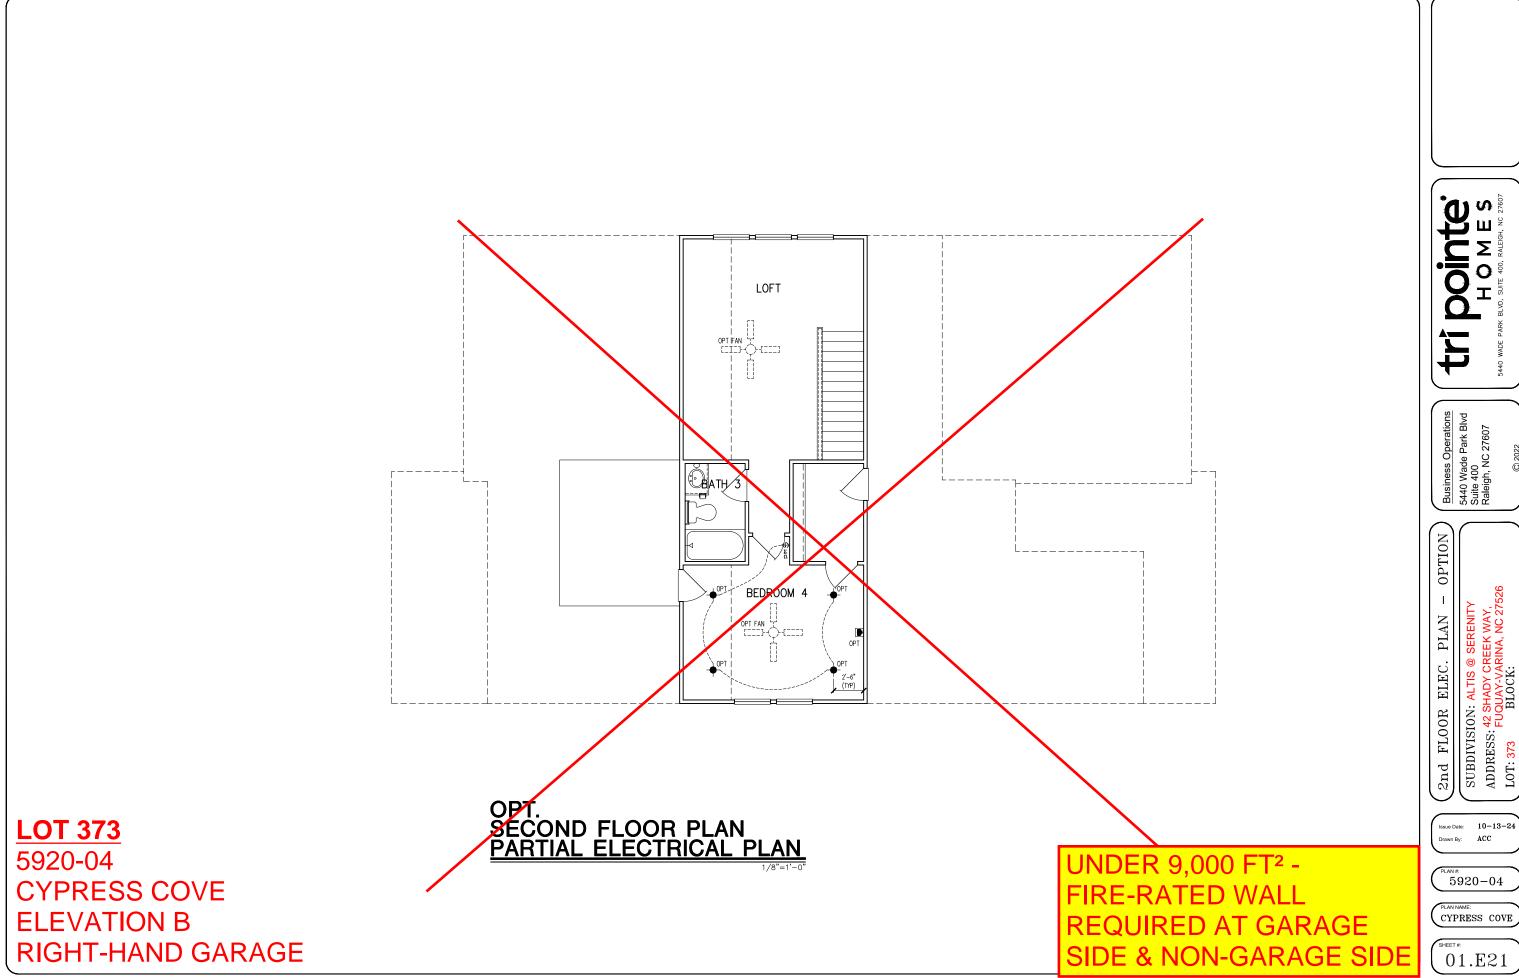
tri pointe Homes 540 WADE PARK BLYD, SUITE 400, RALEIGH, NG 27607


CYPRESS COVE



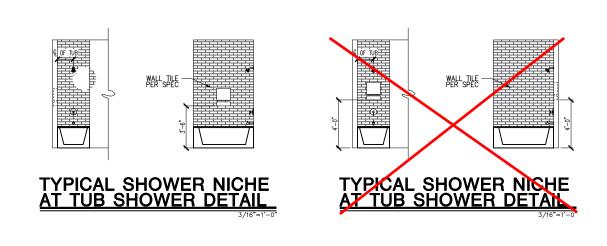

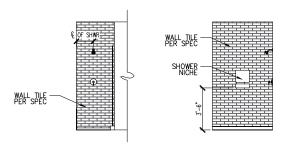


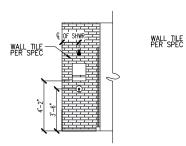


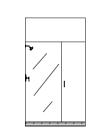

TYPICAL SHOWER NICHE AT SHOWER DETAIL


TYPICAL SHOWER NICHE AT SHOWER DETAIL

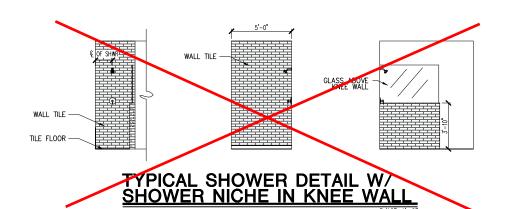

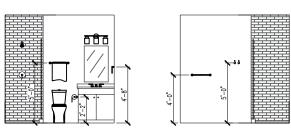

TYPICAL HEIGHTS FOR BATH FIXTURES DETAIL

LOT 373 5920-04 CYPRESS COVE ELEVATION B RIGHT-HAND GARAGE

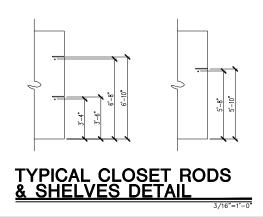

UNDER 9,000 FT<sup>2</sup> -FIRE-RATED WALL REQUIRED AT GARAGE SIDE & NON-GARAGE SIDE tri pointe.
HOMES

S440 WADE PARK BLVD, SUITE 400, RALEIGH, NG 27607

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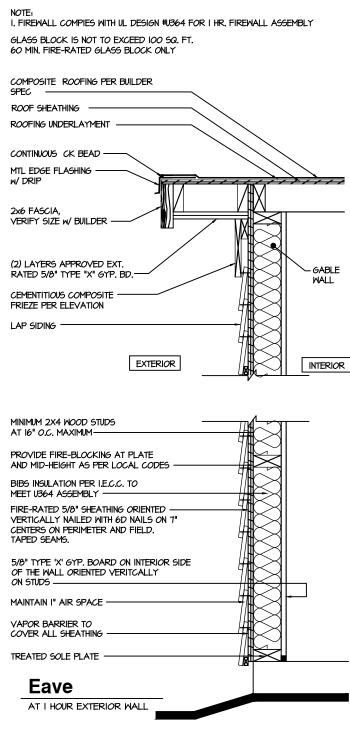
SUBDIVISION: ALTIS @ SERENITY
ADDRESS: 42 SHADY CREEK WAY,
FUQUAY-VARINA, NC 27526

Issue Date: 10-13-24
Drawn By: ACC

5920-04

CYPRESS COVE

D1.0



√1 Hour Wall (2) AT EXTERIOR WALL **CYPRESS COVE** 

**LOT 373** 


5920-04


**ELEVATION B** 

**RIGHT-HAND GARAGE** 

I HOUR FIRE-RESISTIVE CONSTRUCTION

I. FIREWALL COMPIES WITH UL DESIGN #J364 FOR I HR. FIREWALL ASSEMBLY GLASS BLOCK IS NOT TO EXCEED 100 SQ. FT. 60 MIN. FIRE-RATED GLASS BLOCK ONLY

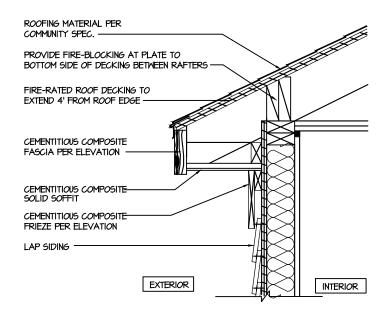

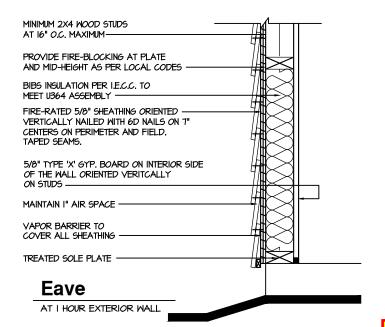

1 Hour Wall AT EXTERIOR WALL

I HOUR FIRE-RESISTIVE CONSTRUCTION (PROPERTY LINE)

**GARAGE SIDE &** NON-GARAGE SIDE **Dointe**HOMES

Business Operations 5440 Wade Park Blvd Suite 400 Raleigh, NC 27607

SERENITY ALTIS @ SERE) STREAMSIDE

DETAILS

SUBDIVISION: ADDRESS: LOT: 328

Issue Date: 10-13-24 ACC

5920 - 04

CYPRESS COVE

D1.1

### GENERAL STRUCTURAL NOTES

### FLOOR FRAMING

- I IOISTS/TRUSSES SHALL BE DESIGNED BY MANUE TO MEET OR EXCEED L/480 LIVE LOAD DEFLECTION CRITERIA. (EXCLUDES STONE/MARBLE OR WET BED CONSTRUCTED FLOORS - CONTACT M&K FOR EXCLUDED FLOOR DESIGNS)
- PER THE GUIDELINES OF THE TILE COUNCIL OF NORTH AMERICA (TCNA HANDBOOK), IT SHALL BE THE FLOOR FINISH INSTALLER'S RESPONSIBILITY TO VERIEY THAT THE FINISHES TO BE INSTALLED. MATCH THE DESIGN CRITERIA NOTED ABOVE (UNDER "DESIGN
- FLOOR SYSTEMS & SHEATHING HAVE BEEN DESIGNED TO SUPPORT ADDITIONAL DEAD LOAD FROM CERAMIC TILE (EXCLUDING MARBLE OR STONE). HOWEVER, IT SHALL BE THE FLOOR FINISH INSTALLER'S RESPONSIBILITY TO PROVIDE PROPER UNDERLAYMENT, UNCOUPLING MEMBRANE AND MORTAR/GROUT PER THE ASSEMBLY DESIGNATIONS IN THE TONA HANDBOOK (TILE COUNCIL OF NORTH AMERICA).
- AT I-JOIST FLOORS, PROVIDE I I/8" MIN. OSB RIM BOARD.
- METAL HANGERS SHALL BE SPECIFIED BY MANUFACTURER, U.N.O.
- I-JOIST/TRUSS SHOP DWGS, SHALL BE SUBMITTED TO ARCH, & ENG.
   FOR REVIEW AND APPROVAL PRIOR TO FABRICATION OR DELIVERY
- FLOOR SHEATHING SHALL BE 23/32" A.P.A. RATED 'STURD-I-FLOOR' 24" O.C. EXPOSURE I (OR APPROVED EQUAL) WITH TONGUE AND GROOVE EDGES. FASTEN TO FRAMING MEMBERS W GLUE AND
- 2 1 x 0.131" NAILS @ 6"o.c. @ PANEL EDGES & @ 12"o.c. FIELD
- · 2 3 × 0.120 NAILS @ 4" O.C. @ PANEL EDGES \$ @ 8" O.C. FIELD. - 2 3 × 0.113 NAILS @ 3" O.C. @ PANEL EDGES & @ 6" O.C. IN FIELD

## ROOF FRAMING

- ROOF SHEATHING SHALL BE 7/16" A.P.A. RATED SHEATHING 24/16 EXPOSURE I (OR APPROVED EQUAL). FASTEN TO FRAMING MEMBERS
- W 2 5" x 0.131" NAILS @ 6"0.c. @ PANEL EDGES € @ 12" O.C. FIELD.
- · w/ 2 🖁 × 0.120" NAILS @ 4"o.c. @ PANEL EDGES \$ @ 8" O.C. FIELD. - w/ 2 3 × 0.113" NAILS @ 3"o.c. @ PANEL EDGES & @ 6" O.C. FIELD.
- WITHIN 48" OF ALL ROOF EDGES, RIDGES, & HIPS FASTEN ROOF. SHEATHING FIELDS PER EDGE NAILING SPEC.
- FASTEN EACH ROOF TRUSS TO TOP PLATE W/ SIMPSON H2.5T CLIP (OR APPROVED EQUAL) @ ALL BEARING POINTS. PROVIDE (2) H2.5T CLIPS AT 2-PLY GIRDER TRUSSES, (3) H2.5T CLIPS AT 3-PLY GIRDER TRUSSES & ROOF BEAMS - AT ALL BEARING POINTS.
- METAL HANGERS SHALL BE SPECIFIED BY THE MANUFACTURER, U.N.O.
- ROOF TRUSS SHOP DWGS SHALL BE SUBMITTED TO ARCH & ENG FOR REVIEW AND APPROVAL PRIOR TO FABRICATION OR DELIVERY
- ERECT AND INSTALL ROOF TRUSSES PER WTCA & TPI'S BCSI I "GUIDE TO GOOD PRACTICE FOR HANDLING, INSTALLING & BRACING
- OF METAL PLATE CONNECTED WOOD TRUSSES." SUPPORT SHORT SPAN ROOF TRUSSES W/2x4 LEDGER FASTENED TO

FRAMING w/(2) 3" x 0.120" NAILS @ 16" O.C. (UP TO 7' SPAN).

### CONNECTION SPECIFICATIONS (TYP. U.N.O.)

DESCRIPTION OF BLDG. ELEMENT	3"x0.131" NAILS	3"x0.120" NAIL5
JOIST TO SOLE PLATE	(3) TOENAILS	(3) TOENAILS*
SOLE PL. TO JOIST/RIM OR BLK'G	NAILS @ 4" o.c.	NAILS @ 4" o.c.
STUD TO PLATE	(4) TOENAILS/ (3)END NAILS	(4) TOENAILS/ (4)END NAILS*
RIM TO TOP PLATE	TOENAILS @ 6" o.c.	TOENAILS @ 4" o.c.*
BLK'G. BTWN. JOISTS TO TOP PL.	(3) TOENAILS EA. END	(3) TOENAILS EA. END*
DOUBLE STUD	NAILS @ 16" o.c.	NAILS @ 16" o.c.
DOUBLE TOP PLATE	NAILS ❷ 12" o.c.	NAILS @ 8" o.c.
DOUBLE TOP PLATE LAP SPLICE	(12) NAILS IN LAPPED AREA	(15) NAILS IN LAPPED AREA
	(24" MIN.)	(24" MIN.)
TOP PLATE LAP @ CORNERS & INTERSECTING WALLS	(3) NAILS	(3) NAILS
RAFTER/TRUSS TO TOP PLATE	(4) TOENAILS +	(4) TOENAILS +
	(I) SIMPSON H2.5T	(I) SIMPSON H2.5T
GAB. END TRUSS TO DBL. TOP PL.	TOENAILS @ 8" o.c.	TOENAILS @ 6" o.c.
R.T. w/ HEEL HT. 9 1/4" TO 12"	2xIO BLK EVERY 3RD BAY FASTENED TO DBL. TOP PLATE w/ TOENAILS @ 6" O.C.	2XIO BLK EVERY 3RD BAY FASTENED TO DBL. TOP PLATE W/ TOENAILS @ 4" O.C.
R.T. w/ HEEL HT. 12" TO 16"	2XI2 BLK EVERY 3RD BAY FASTENED TO DBL. TOP PLATE w/ TOENAILS @ 6" O.C.	2xI2 BLK EVERY 3RD BAY FASTENED TO DBL. TOP PLATE W/ TOENAILS @ 4" O.C.
R.T. w/ HEEL HT. UP TO 24"	LAP WALL SHTG. W/ DBL. TOP PL. & INSTALL ON TRUSS VERT FASTEN W/ NAILS @ 6" O.C.	LAP WALL SHTG. W/ DBL. TOP PL. \$ INGTALL ON TRUGS VERT FASTEN W/ NAILS @ 6" O.C.*
R.T. w/ HEEL HT. 24" TO 48"	LAP WALL SHTG. W/ DBL. TOP PL. & INSTALL ON TRUGS VERT FASTEN W/ NAILS @ 6" O.C. PROVIDE 2x BLK @ EA. BAY AT TOP OF HEEL	LAP WALL SHTG. W/ DBL. TOP PL. & INSTALL ON TRUSS VERT FASTEN W/ NAILS @ 6" O.C. PROVIDE 2x BLK @ EA. BAY AT TOP OF HEEL*
WALL TO FOUNDATION	WALL SHTG. LAP W/ SILL PL. & FASTENED PER SHEAR WALL FASTENING SPEC.	

# 2½"x0.113 IS AN ACCEPTABLE ALTERNATIVE TO A 3"x0.120", SAME SPACING OR NUMBER OF NAILS. DNLY ACCEPTABLE WHERE \* ARE SHOWN)

### GENERAL STRUCTURAL NOTES

### DESIGN LOADING

- DESIGN IS BASED ON 2018 NORTH CAROLINA STATE BUILDING CODE: RESIDENTIAL CODE.
- WOOD FRAME ENGINEERING IS BASED ON NDS, "NATIONAL DESIGN SPECIFICATION FOR WOOD CONSTRUCTION" - LATEST EDITION.

DESIGN LOADS ROOF

SNOW = 15 PSF (12 PSF GROUND SNOW, TRUSSES) LIVE = 20 PSF (REDUCIBLE BASED ON ROOF PITCH) DEAD = 7 PSF T.C., IO PSF B.C. LOAD DURATION FACTOR = 1.25

FLOOR LIVE = 40 PSF (30 PSF @ SLEEPING AREAS) DEAD = 10 PSF (I-JOISTS), 15 PSF (FLOOR TRUSSES)

ADD'L IO PSE @ CERAMIC TILE IN KITCHEN

BUNROOMS, BATHS, FOYER, LAUND. & MUDRMS

2,000 PSF ASSUMED ALLOWABLE BEARING PRESSURE (TO BE VERIFIED BY BUILDER)

115 MPH, EXPOSURE B

### GENERAL FRAMING

- ALL TYP, NAIL FASTENER REQUIREMENTS ARE NOTED IN STANDARD CONNECTIONS TABLE (IRC TABLE R602.3(I)) OR ON PLANS. ALL NAILS SPECIFIED ARE MIN DIAMETER AND LENGTH REQUIRED FOR CONNECTION. ALL HANGER NAILS SHALL BE INSTALLED PER MANUFACTURER'S REQUIREMENTS FOR MAX CHARTED CAPACITY NOTE: HANGERS USE COMMON NAIL DIAMETERS NOT TYPICAL FRAMING GUN NAILS.
- EXT & INT BEARING WALLS SHALL BE 2x4 OR 2x6 (AS SHOWN ON PLANS) @ 16" O.C. SPF/SP #2 GRADE LUMBER, OR BETTER, U.N.O.. WALLS OVER 12' TALL SHALL BE PER PLAN.
- ALL INTERIOR BEARING WALLS ARE ASSUMED TO BE SHEATHED W/ GYP WALL BOARD (ONE SIDE MIN.) OR PROVIDE MID HT. BLOCKING.
- ALL HEADERS, BEAMS & OTHER STRUCTURAL MEMBERS SHALL BE SPRUCE-PINE-FIR #2 (SPE) OR SOUTHERN PINE #2 (SP) LUMBER, OR BETTER, SUPPORT ALL HEADERS/ BEAMS W/ (1)2x JACK STUD & (1)2x KING STUD MINIMUM
- THE NUMBER OF STUDS SPECIFIED AT A SUPPORT INDICATES THE NUMBER OF JACK STUDS REQUIRED, U.N.O.,
- ALL NON-BEARING INTERIOR STUD WALLS SHALL BE CONSTRUCTED WITH 2x 'STUD' GRADE MEMBERS SPACED @ 24" O.C. (MAX., U.N.O.) . HEADERS IN NON-LOAD BEARING WALLS SHALL BE: (I)2x4/6 FLAT @ OPENINGS UP TO 4', (2)2x4/6 FLAT UP TO 8'.
- ALL FRAMING LUMBER SHALL BE DRIED TO 15% MC (KD-15)
- ENGINEERED LUMBER BEAMS TO MEET OR EXCEED THE FOLLOWING: • 'LVL' - Fb=2600 psi; Fv=285 psi; E=2.0x10^6 psi
- ENGINEERED LUMBER POSTS TO MEET OR EXCEED THE FOLLOWING 'LVL' - Fb=2400 psi; Fcll=2500 psi; E=1.8xl0^6 psi
- FOR 2 & 3 PLY BEAMS OF EQUAL 134" MAX, WIDTH, FASTEN PLIES TOGETHER WITH 3 ROWS OF 3"X0.120" NAILS @ 8" O/C OR 2 ROWS K"x3K" SIMPSON SDS SCREWS (OR 3K" TRUSSI OK SCREWS) @ 16" GREATER. APPLY EASTENING AT BOTH FACES FOR 3-PLY CONDITION. LOCATE TOP & BOTTOM NAILS/SCREWS 2" FROM EDGE. SOLID 31/5" OR 51/4" BEAMS ARE ACCEPTABLE, USE 2 ROWS OF NAILS FOR 2x6 € 2x8 MEMBERS.
- FOR 4 PLY BEAMS OF EQUAL 13/4" MAX. WIDTH, FASTEN PLIES TOGETHER WITH 3 ROWS OF 1/2 x6" SIMPSON SDS SCREWS (OR 6 3/4" TRUSSLOK SCREWS) @ 16" O/C. USE A MINIMUM OF 4 ROWS FOR BEAM DEPTHS OF 14" OR GREATER, APPLY FASTENING AT BOTH FACES (ONE SIDE ONLY FOR TRUSSLOK SCREWS). LOCATE TOP AN BOTTOM SCREWS 2" FROM EDGE. A SOLID 7" BEAM IS ACCEPTABLE
- PROVIDE SOLID BLOCKING IN FLOOR SYSTEM UNDER ALL POSTS CONTINUOUS TO FND./BEARING. BLOCKING TO MATCH POST ABOVE.
- ALL EXTERIOR 4x4 WOOD POSTS SHALL HAVE SIMPSON BCS2-2/4 CAP & ABW44 BASE, U.N.O.
- CORROSION NOTES
- BUILDER RESPONSIBLE TO DETERMINE CORROSION-RESISTANCE REQUIREMENTS AND COMPATIBILITY OF HARDWARE FASTENERS AND CONNECTORS FOR ENVIRONMENTAL EXPOSURE AND IN CONTACT W PRESERVATIVE-TREATED WOOD OF ACTUAL FINAL CONDITIONS AND SOURCED MATERIALS. CONTACT LUMBER & HARDWARE SUPPLIERS TO COORD.

### GENERAL STRUCTURAL NOTES

### **FOUNDATION**

- DESIGN IS BASED ON 2018 NORTH CAROLINA STATE BUILDING CODE:
- FOOTING DESIGN 2,000 PSF ALLOWABLE SOIL BEARING
- FASTEN 2x4/6 SILL PLATES TO CONC FND WITH A MINIMUM OF 2
- ANCHORS PER PLATE 12" MAX FROM PLATE ENDS UTILIZING: • I/2" DIA. ANCHOR BOLTS @ 6'-0" O.C,7" MIN. EMBEDMENT
- I/2" DIA. x 6" LONG SIMPSON TITEN HD @ 6'-0" O.C. • SIMPSON MASA ANCHOR STRAPS @ 6'-0" O.C. (CONCRETE)
- ALL LUMBER EXPOSED TO WEATHER OR IN CONTACT W/ PERIMETER FOUNDATION SHALL BE PRESERVATIVE TREATED SOUTHERN PINE #2.
- BUILDER TO VERIEY CORROSION-RESISTANCE COMPATIBILITY OF HARDWARE & FASTENERS IN CONTACT W/ PRESERVATIVE-TREATED WOOD, CONTACT LUMBER & HARDWARE SUPPLIERS TO COORD.
- FOOTINGS SHALL BE PLAIN CONCRETE, U.N.O
- CONCRETE DESIGN BASED ON ACL 318, CONCRETE SHALL ATTAIN THE FOLLOWING MIN. COMPRESSIVE STRENGTHS IN 28 DAYS, U.N.O. f'c = 3,000 psi: ...... FOOTINGS & INTERIOR SLABS ON GRADE 3,500 psi: ...... GARAGE & EXTERIOR SLABS ON GRADE fu = 60.000 psi
- ALL CONCRETE EXPOSED TO THE WEATHER SHALL NOT HAVE LESS THAN 5% OR MORE THAN 7% AIR ENTRAINMENT
- ALL FOOTINGS SHALL BEAR BELOW FROST LINE (TYP.) OR 12" MIN I REGIONS WHERE CODE FROST DEPTH IS NOT APPLICABLE. CONSULT SOILS REPORT OR BUILDING DEPT. FOR MINIMUM DEPTH BELOW GRADE
- FOOTINGS AND SLABS ON GRADE SHALL BEAR ON VIRGIN SOIL OR
- PROVIDE CONTROL JOINTS AT ALL INSIDE CORNERS OF SLAB EDGES, AND OTHER LOCATIONS WHERE SLAB CRACKS ARE LIKELY
- JOINTS SHALL BE LOCATED @ 10'-0" O.C. (RECOMMENDED) OR 15'-0" O.C. (MAXIMUM)
- JOINT GRID PATTERN SHALL BE AS CLOSE TO SQUARES AS POSSIBLE (I:I RATIO), WITH A MAXIMUM OF I:I.5 RATIO
- CONTROL JOINTS SHALL <u>NOT</u> BE INSTALLED IN STRUCTURAL
- DIMENSIONS BY OTHERS, BUILDER TO VERIFY.

### HOLD-DOWN SCHEDULE

SYMBOL	SPECIFICATION
► HD-I	SIMPSON CSI6 STRAP TIE W/ 14" END LENG
► HD-2	SIMPSON MSTC66 STRAP TIE W 24" END LENG
<b>▶</b> HD-3	SIMPSON HTT4 HOLD-DOWN *
► HD-4	SIMPSON HDU5-SDS2.5 HOLD-DOWN *
HD-5	SIMPSON STHDI4RJ HOLD-DOWN *

UTILIZE SIMPSON "SET-36" EPOXY SYSTEM TO FASTEN %" DIA. THREADED ROD INTO CONCRETE FOUNDATION. PROVIDE 12" MIN. EMBEDMENT INTO CONCRETE. INSTALL PER MANUE, RECOMMENDATIONS, DO NOT LOCATE ANCHORS WITHIN I 3/4" OF EDGE OF FOUNDATION

### MEANS & METHODS NOTES

THE STRUCTURE IS DESIGNED TO BE SELF SUPPORTING AND STABLE AFTER THE BUILDING IS FINISHED AND ALL PLAN, DETAIL, AND NOTE SPECIFICATIONS HAVE BEEN COMPLETED. IT IS THE CONTRACTOR'S SOLE RESPONSIBILITY TO DETERMINE THE ERECTION PROCEDURES AND SEQUENCE TO COMPONENTS DURING CONSTRUCTION. THIS INCLUDES BUT IS NOT LIMITED TO, THE ADDITION OF NECESSARY SHORING, SHEETING, TEMPORARY BRACING, GUYS, AND TIE-DOWNS. CONTRACTOR SHALL BE RESPONSIBLE FOR ALL SHORING AND BRACING REQUIRED TO STABILIZE AND PROTECT EXISTING AND ADJACENT STRUCTURES AND SYSTEMS DURING COURSE OF DEMOLITION AND CONSTRUCTION

STRUCTURAL DESIGN AND SPECIFICATIONS ASSUME THAT ALL SUPPORTING AND NON-SUPPORTING ELEMENTS IN CONTACT WITH FLOOR FRAMING ARE LEVEL, INCLUDING, BUT NOT LIMITED TO: FOUNDATIONS SLABS ON GRADE, BEAMS, WALLS, AND NON-BEARING ELEMENTS. IT IS THE CONTRACTOR'S RESPONSIBILITY TO VERIEY LEVELNESS AND MAKE ADJUSTMENTS AS NECESSARY, INCLUDING CONSIDERATION OF THOSE AREAS THAT MAY BE WITHIN CONTRACTUAL, INDUSTRY OR WARRANTY TOLERANCES.

### VENEER LINTEL SCHEDULE

SPAN (MAX)	HEIGHT OF VENEER ABOVE LINTEL	STEEL ANGLE SIZE
3'-0"	20 FT. MAX	L3"x3"x¼"
	3 FT. MAX	L3"x3"x/4"
6'-0"	I2 FT. MAX	L4"x3"x/4"
	20 FT. MAX	L5"x3½"x¾6"
8'-0"	3 FT. MAX	L4"x4"x¼" *
8-0	I2 FT. MAX	L5"x3½"x¾6"
	I6 FT. MAX	L6"x3½"x¾"
9'-6"	I2 FT. MAX	L6"x3½"x¾6"
16'-0"	2 FT. MAX	L7"x4"x½" **
	2 ET MAY	Q!U/!UK! **

- ALLIMITES.

  \$404L SIPPORT 2 %\* 3 ½" YEBEER W 40 PAI MAXIMM MEIGHT.

  (IG SHALL HAVE 4" MIN. BEARING

  IG SHALL HAVE 9" MIN. BEARING

  IG SHALL HAVE 9" MIN. BEARING

  IG SHALL BOT BE FASTIBED BACK TO MODO HEADER IN MALL 446" oz. W ½" DIA. x 3 ½"

  LONG LAG SCREPK IN 2" LONG YERTICALLY SLOTTED HOLES.

  MAX. YEBEER IN APPLIES TO ANY FORTION OF PERIOK OVER THE OPENING.

  ALL INITIES SHALL BE LONG IES VERTICAL.

  MAY BEC OT IN THE PELLO TO BE 3½" MIDE OVER THE BEARING LIGHTH ONLY. THIS

  SET STIPLOTIES. AND FOR ANY LIMITEL CONDITION NOT ENCOMPASSED BY THE

  ROW GER SHAPETERS.

FOR QUEEN VENEER USE L4x3%". FOR 3½" VENEER ONLY, SEE PLAN FOR VENEER SUPPORT IF VENEER < 3½" THICK.

# ADDITIONAL NOTES FOR TRUSS \$

I-JOIST MANUFACTURER

ROOF TRUSS, FLOOR TRUSS AND ENGINEERED JOISTS SHALL BE DESIGNED TO MEET THE DEFLECTION CRITERIA BELOW, UNLESS NOTED OTHERWISE ON PLAN. MULHERN & KULP CANNOT BE HELD RESPONSIBLE FOR ANY STRUCTURAL ISSUES
RELATED TO ANY BUILDING COMPONENT IF COMPONENT SHOP DRAWINGS ARE NOT SUBMITTED TO M&K FOR REVIEW PRIOR TO FABRICATION, DELIVERY, OR INSTALLATION.

TRUSSES/JOISTS SHALL BE DESIGNED SO THAT DIFFERENTIAL DEFLECTION BETWEEN ADJACENT PARALLEL TRUSSES/JOISTS OR GIRDER TRUSSES/FLUS BEAMS DO NOT EXCEED THE FOLLOWING: A ROOF TRUSSES.

I/4" DEAD LOAD

B. FLOOR TRUSSES, ATTIC TRUSSES, & I-JOISTS:

ABSOLUTE DEAD LOAD DEFECTION OF FLOOR TRUSSES/ATTIC TRUSSES WHEN ADJACENT TO FLOOR FRAMING BY OTHERS SHALL BE LIMITED TO 3/16". (NO DIFFERENTIAL DEFLECTION

### FLOOR JOIST NOTES

- SPECIFIED ON PLAN FLOOR JOISTS SERIES & SPACING IS PER THE FLOOR JOIST MANUF.
- SPACING SHALL NOT EXCEED 19.2" O.C. (MAX.) LOCATION OF TILE: SPACING SHALL NOT
- EXCEED 16" O.C. (MAX.)

### LATERAL/WALL BRACING & WALL SHEATHING SPECIFICATIONS

THIS MODEL HAS BEEN DESIGNED TO RESIST LATERAL FORCES RESULTING FROM:

# 5 MPH WIND IN 2018 NCSBC:RO

(115 MPH WIND SPEED IN ASCE 7-10 WIND MAP, PER IRC R301.2.1.1) EXP. B, RISK CAT. 2 & SEISMIC CAT. A/B.

THE DESIGN WAS COMPLETED PER 2015 IBC (SECTION 1609) & ASCE 7-10, AS PERMITTED BY R301.1.3 OF THE 2018 NGSBG:RG, ACCORDINGLY THIS MODEL, AS DOCUMENTED AND DETAILED HEREWITHIN, IS ADEQUATE TO RESIST THE CODE REQUIRED LATERAL FORCES.

DESIGN WIND UPLIFT LOADS HAVE BEEN CALCULATED UTILIZING ASCE 7-10 (ACCEPTED ENGINEERING PRACTICE) AS ALLOWED PER 2018 NCSBC:RC SECTION R802.II.I.I. THIS MODEL HAS BEEN DETAILED WHERE REQUIRED & ENGINEERED TO RESIST THE WIND UPLIFT LOAD PATH PER SECTIONS R602.3.54 R802.II.

### EXT. WALL SHEATHING SPECIFICATION

- 7/16" OSB OR 15/32" PLYWOOD: FASTEN SHEATHING W/ 2 🖁 "XO.II3 NAIL5 @ 6" O.C. AT EDGES & @ 12" O.C. IN THE PANEL FIELD. (TYP, U.N.O.)
- ALL SHEATHING PANELS SHALL BE ORIENTED VERTICALLY (LONG DIRECTION PARALLEL TO STUDS) AND INSTALLED FULL HEIGHT OF SHEAR WALL - OR 2x HORIZONTAL BLOCKING SHALL BE PROVIDED TO SUPPORT ALL UNSUPPORTED PANEL EDGES & EDGE
- ALL EXT. WALLS SHALL BE CONTINUOUSLY SHEATHED AND ARE CONSIDERED SHEAR WALLS.
- ALT. STAPLE CONNECTION SPEC: 1 3/4" 16 GA STAPLES (1/6" CROWN) @ 3" O.C. AT EDGES & @ 6" O.C IN FIELD.

### 3" O.C. EDGE NAILING

 AT DESIGNATED AREAS - FASTEN PANEL EDGES OF WOOD STRUCTURAL WALL SHEATHING TO FRAMING W 2 🖁 × 0.113" NAILS @ 3" O.C. AND 12" O.C. IN THE PANEL FIELD NO STAPLE ALTERNATIVE AVAILABLE AT THIS SPEC. ALL SHEATHING PANELS SHALL BE ORIENTED VERTICALLY (LONG DIRECTION PARALLEL TO STUD) AND INSTALLED FULL HEIGHT OF SHEAR WALL - OR - 2x HORIZONTAL BLOCKING SHALL BE PROVIDED TO SUPPORT UNSUPPORTED PANEL EDGES AND 3" O.C. EDGE FASTENING.

### TYP. UNIT SEPARATION WALL SHEATHING SPECIFICATION

•1/2" OR 5/8" GYPSUM WALL BOARD: FASTEN GWB SHEATHING TO FRAMING W/ 1 \$"x0.086" COOLER NAILS OR I 1/4" DRYWALL SCREWS @ 7" O.C. " PANEL EDGES & PANEL FIELD (INCLUDING T&B PLATES

- SEE CONNECTION SPECIFICATIONS CHART FOR STANDARD SHEAR TRANSFER DETAILING. IF ADDITIONAL CAPACITY IS REQUIRED BY DESIGN. T WILL BE SPECIFICALLY NOTED ON PLAN.
- DESIGN ASSUMES 16" O.C MAX. STUD SPACING, U.N.O.
- ALL STRUCTURAL PANELS ARE TO BE DIRECTLY APPLIED TO STUD FRAMING.
- FASTEN TOGETHER END STUDS OF WALL PANELS SHEATHED W/ OSB OR PLYWOOD W/ 3" x 0.120" NAILS @ 4" O.C. (THRU ONE SIDE ONLY)

INDICATES EXTENT OF INT. OSB SHEARWALL, BLOCKED PANEL EDGES. AND/OR 3" O.C. EDGE NAILING

INDICATES HOLDOWN

MULHERN+KULP RESIDENTIAL STRUCTURAL ENGINERING



lulhern+Kulp project numbe 243-2403

SMI ssue date: 11-07-24

REVISIONS

05-16-25 Per updated af JPP

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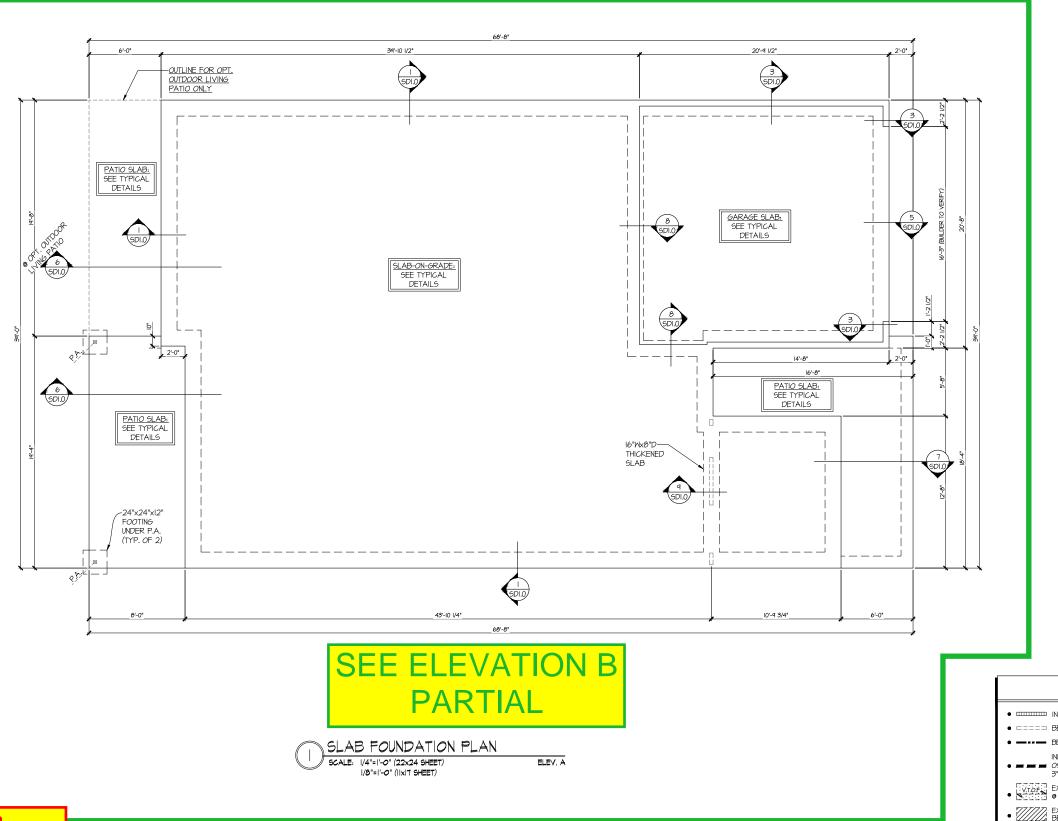
NOTE GENERAL

SERENITY MASTER SET RALEIGH, NC 5920-04

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JNDER 9.000 FT<sup>2</sup> -GARAGE SIDE & **NON-GARAGE SIDE** 

**Lot 373** 5920-04 Cypress Cove Elevation B Right-Hand Garage



UNDER 9,000 FT<sup>2</sup> -**GARAGE SIDE & NON-GARAGE SIDE** 

<u>Lot 373</u> 5920-04 Cypress Cove Elevation B Right-Hand Garage

### LEGEND

- INTERIOR BEARING WALL
- □□□□□ BEARING WALL ABOVE (B.W.A.)
- BEAM / HEADER
- INDICATES EXTENT OF INT.

  OSB SHEARWALL AND/OR 3" O.C. EDGE NAILING

- ► INDICATES HOLDOWN
- INDICATES POST ABOVE. PROVIDE SOLID BLOCKING UNDER POST OR JAMB ABOVE.

REFER TO SO.O FOR TYPICAL STRUCTURAL NOTES & SCHEDULES

MULHERN+KULP RESIDENTIAL STRUCTURAL ENGINERING



Mulhern+Kulp project number: 243-24030

SMK SMN issue date: 11-07-24

REVISIONS:


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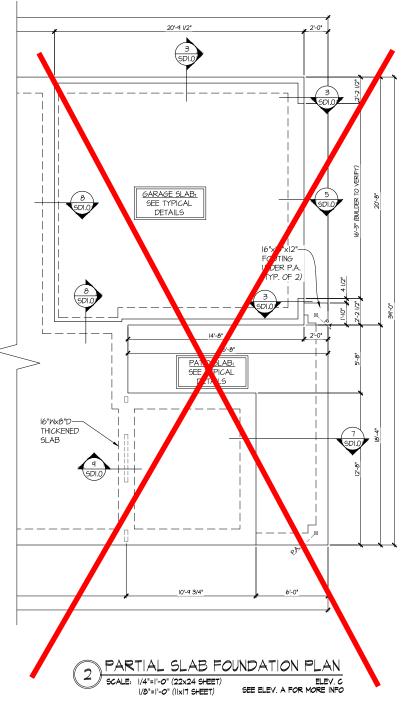
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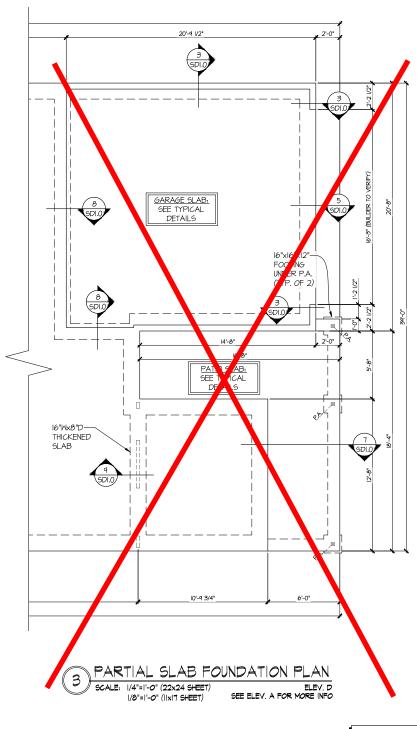
FOUNDATION PLAN 5920-04 MODEI

SERENITY MASTER SET RALEIGH, NC

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REFER TO SO.O FOR

TYPICAL STRUCTURAL NOTES

# SCHEDULES
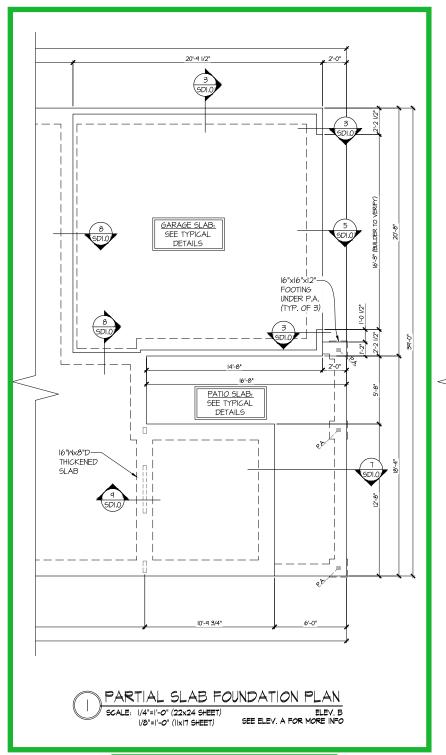
# **ELEVATION B**

**GARAGE SIDE & NON-GARAGE SIDE** 

Lot 373 5920-04 Cypress Cove Elevation B Right-Hand Garage

### LEGEND

- INTERIOR BEARING WALL
- □===□ BEARING WALL ABOVE (B.W.A.)
- BEAM / HEADER
- INDICATES EXTENT OF INT ■ 05B SHEARWALL AND/OR 3" O.C. EDGE NAILING
- EXTENT OF VALLEY TRUSS OVERFRAMING
- EXTENT OF FLOOR SYSTEM TO BE DESIGNED FOR TILE
- NDICATES HOLDOWN
- JL METAL HANGER
- | INDICATES POST ABOVE. PROVIDE SOLID BLOCKING UNDER POST OR JAMB ABOVE.

FOUNDATION PLAN 5920-04 MODEI

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MULHERN+KULP

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NC LICENSE # C-3925

Mulhern+Kulp project number:

issue date:

REVISIONS:

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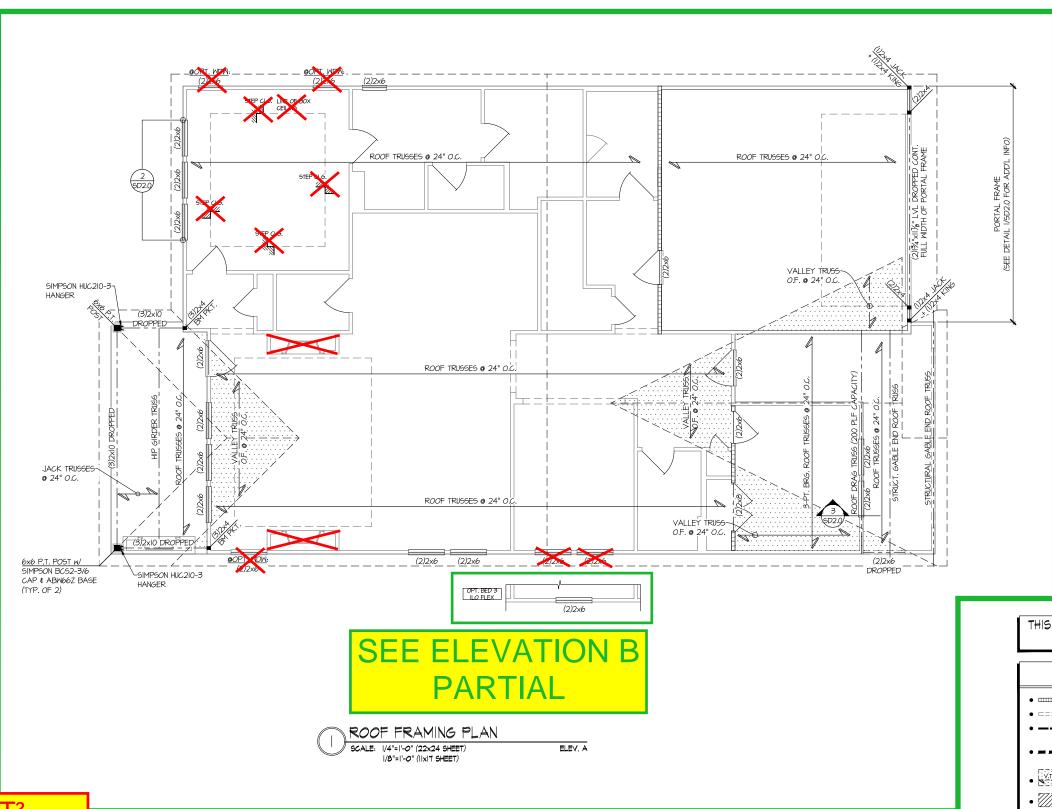
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JPP

11-07-24

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**Lot 373** 5920-04 Cypress Cove **Elevation B** Right-Hand Garage

THIS LEVEL HAS BEEN DESIGNED FOR 9'-1" PLATE HEIGHT

### LEGEND

- INTERIOR BEARING WALL
- □===□ BEARING WALL ABOVE (B.W.A.)
- INDICATES EXTENT OF INT.

  OSB SHEARWALL AND/OR 3" O.C. EDGE NAILING

- ► INDICATES HOLDOWN
- \* INDICATES POST ABOVE. PROVIDE SOLID

REFER TO SO.O FOR TYPICAL STRUCTURAL NOTES & SCHEDULES

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243-24030

SMN issue date: 11-07-24

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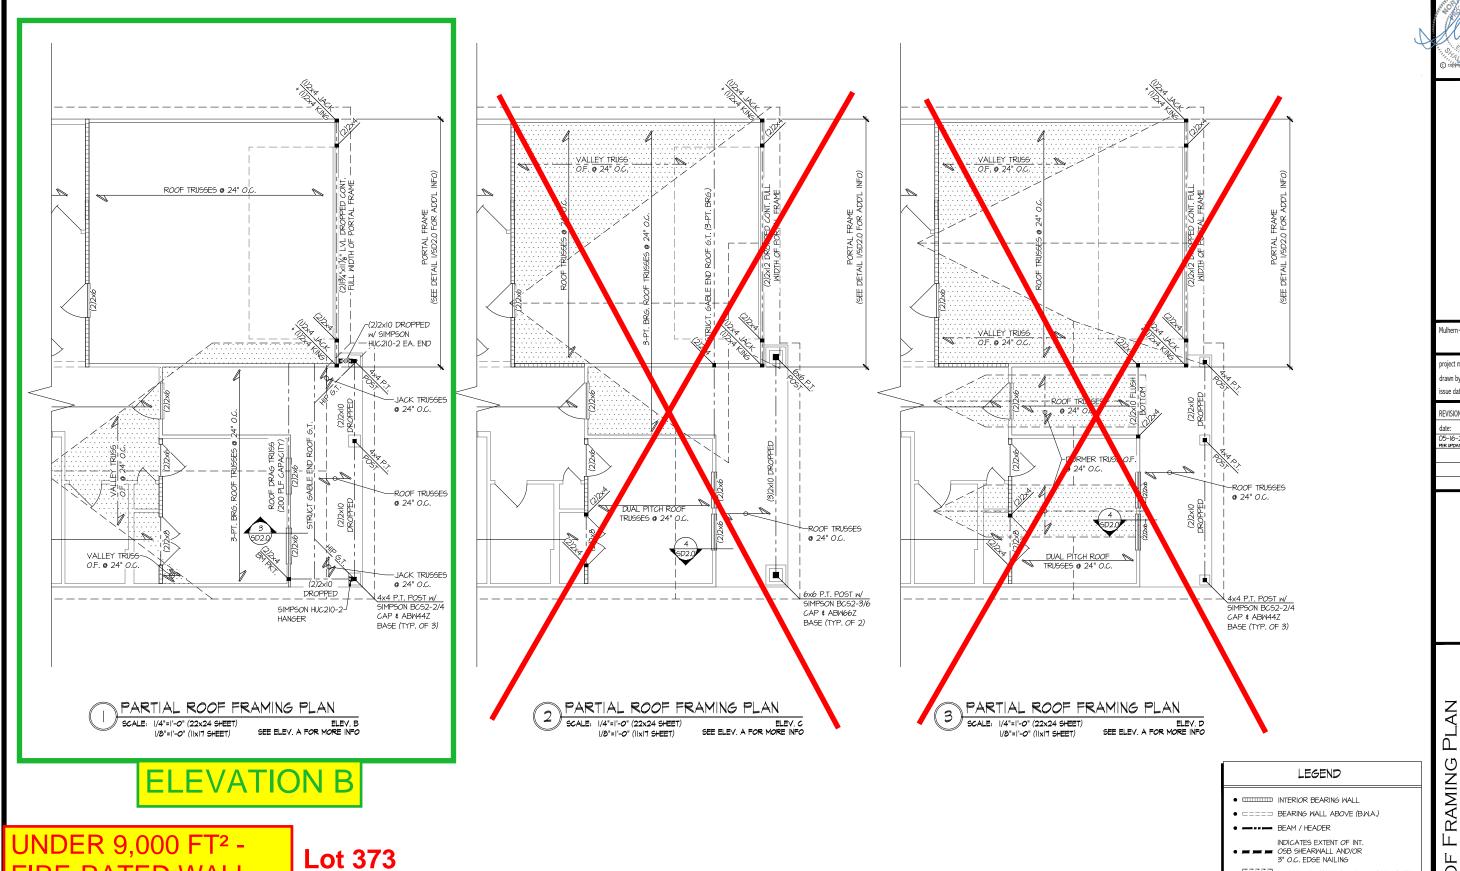
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ROOF FRAMING PLAN 5920-04 MODEI

SERENITY MASTER SET RALEIGH, NC

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Lot 373 5920-04 Cypress Cove **Elevation B** Right-Hand Garage

THIS LEVEL HAS BEEN DESIGNED FOR 9'-1" PLATE HEIGHT

REFER TO SO.O FOR TYPICAL STRUCTURAL NOTES # SCHEDULES

- EXTENT OF VALLEY TRUSS OVERFRAMING
- EXTENT OF FLOOR SYSTEM TO BE DESIGNED FOR TILE
- NDICATES HOLDOWN
- JL METAL HANGER
- | INDICATES POST ABOVE. PROVIDE SOLID BLOCKING UNDER POST OR JAMB ABOVE

MULHERN+KULP RESIDENTIAL STRUCTURAL ENGINERING



243-24030

SMK SMN ssue date: 11-07-24

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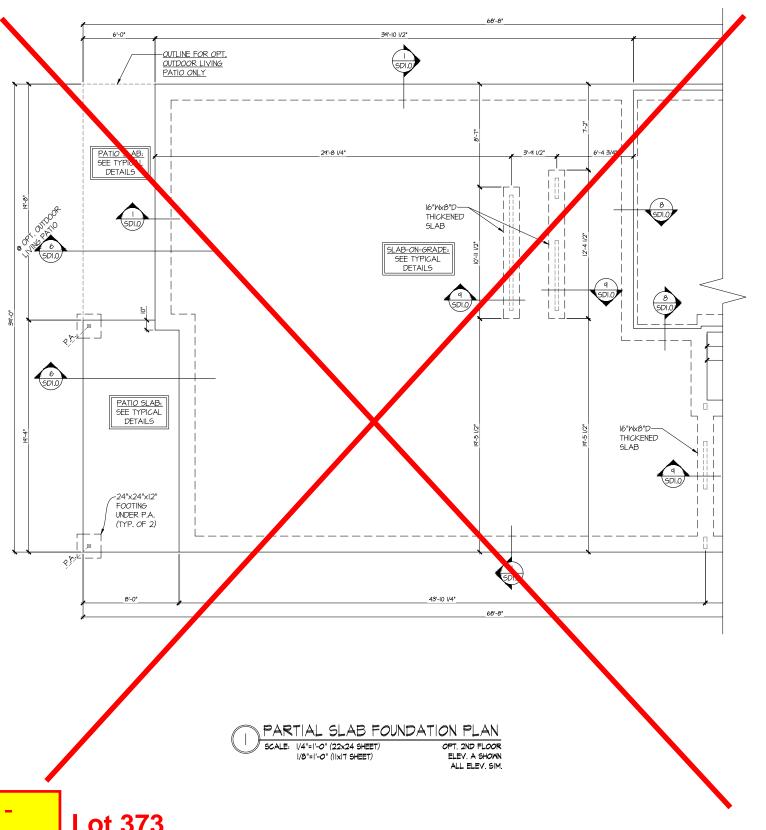
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ROOF FRAMING PLAN 5920-04 MODEI

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SERENITY MASTER SET RALEIGH, NC



<u>Lot 373</u> 5920-04 Cypress Cove Elevation B Right-Hand Garage

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NC License # C-3925



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REVISIONS:

date: 05-16-25 per updated arc JPP

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- ==== BEARING WALL ABOVE (B.W.A.)
- BEAM / HEADER

- INDICATES POST ABOVE. PROVIDE SOLID

REFER TO SO.O FOR TYPICAL STRUCTURAL NOTES & SCHEDULES

LEGEND

• IIIII INTERIOR BEARING WALL

INDICATES EXTENT OF INT.

OSB SHEARWALL AND/OR
3" O.C. EDGE NAILING

EXTENT OF VALLEY TRUSS OVERFRAMING

► INDICATES HOLDOWN


BLOCKING UNDER POST OR JAMB ABOVE.

STRUCTURAL OPTIONS

**S3.0** 

5920-04 MODEI

SERENITY MASTER SET RALEIGH, NC

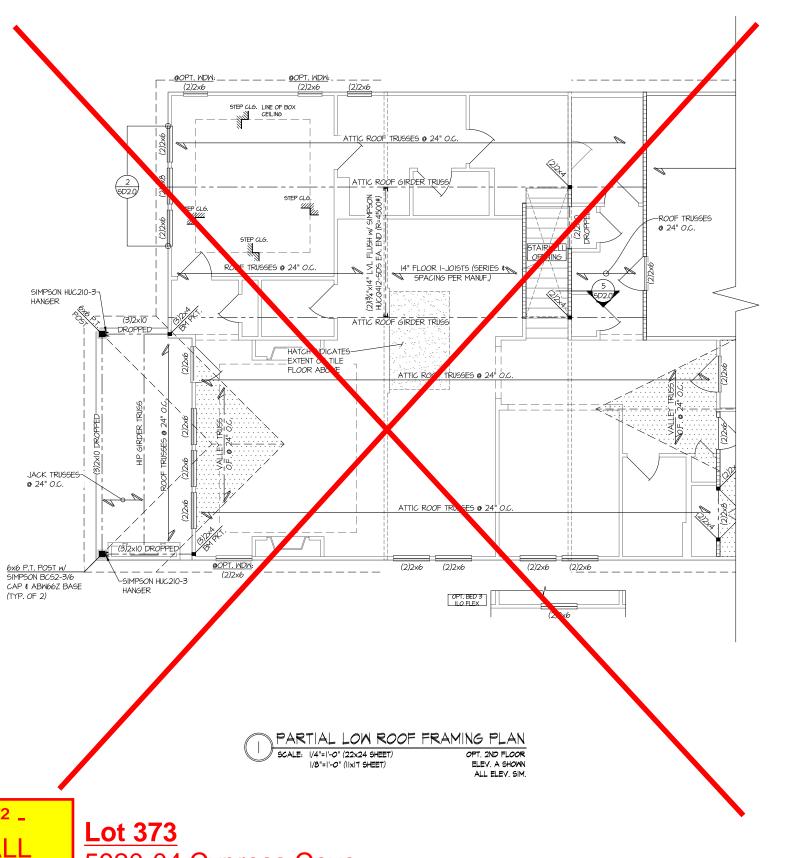

FIRE-RATED WALL
REQUIRED AT
GARAGE SIDE &
NON-GARAGE SIDE

Lot 373
5920-04 Cypress Cove
Elevation B
Right-Hand Garage

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Mulhern+Kulp project number: 243-24030

project mgr: SMM drawn by: SMM issue date: 1 1-07-24

REVISIONS:

date: initial:
05-16-25 JPP
PER UPDATED ARCH

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THIS LEVEL HAS BEEN DESIGNED FOR 9'-I" PLATE HEIGHT

### LEGEND

- INTERIOR BEARING WALL
- □==== BEARING WALL ABOVE (B.W.A.)
- BEAM / HEADE
- INDICATES EXTENT OF INT.

  OSB SHEARWALL AND/OR
  O.C. EDGE NAILING
- EXTENT OF VALLEY TRUSS OVERFRAMING
   24" O.C. (MAX.)
- 777777, EXTENT OF FLOOR SYSTEM
- ► INDICATES HOLDOWN
- METAL HANGER
- INDICATES POST ABOVE. PROVIDE SOLID BLOCKING UNDER POST OR JAMB ABOVE.


REFER TO SO.O FOR
TYPICAL STRUCTURAL NOTES
\$ SCHEDULES

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STRUCTURAL OPTIONS 5920-04 MODEL

5920–04 Serenty Master set Raleigh, nc

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**GARAGE SIDE &** 

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9,78-77-6074 - mailtonical com

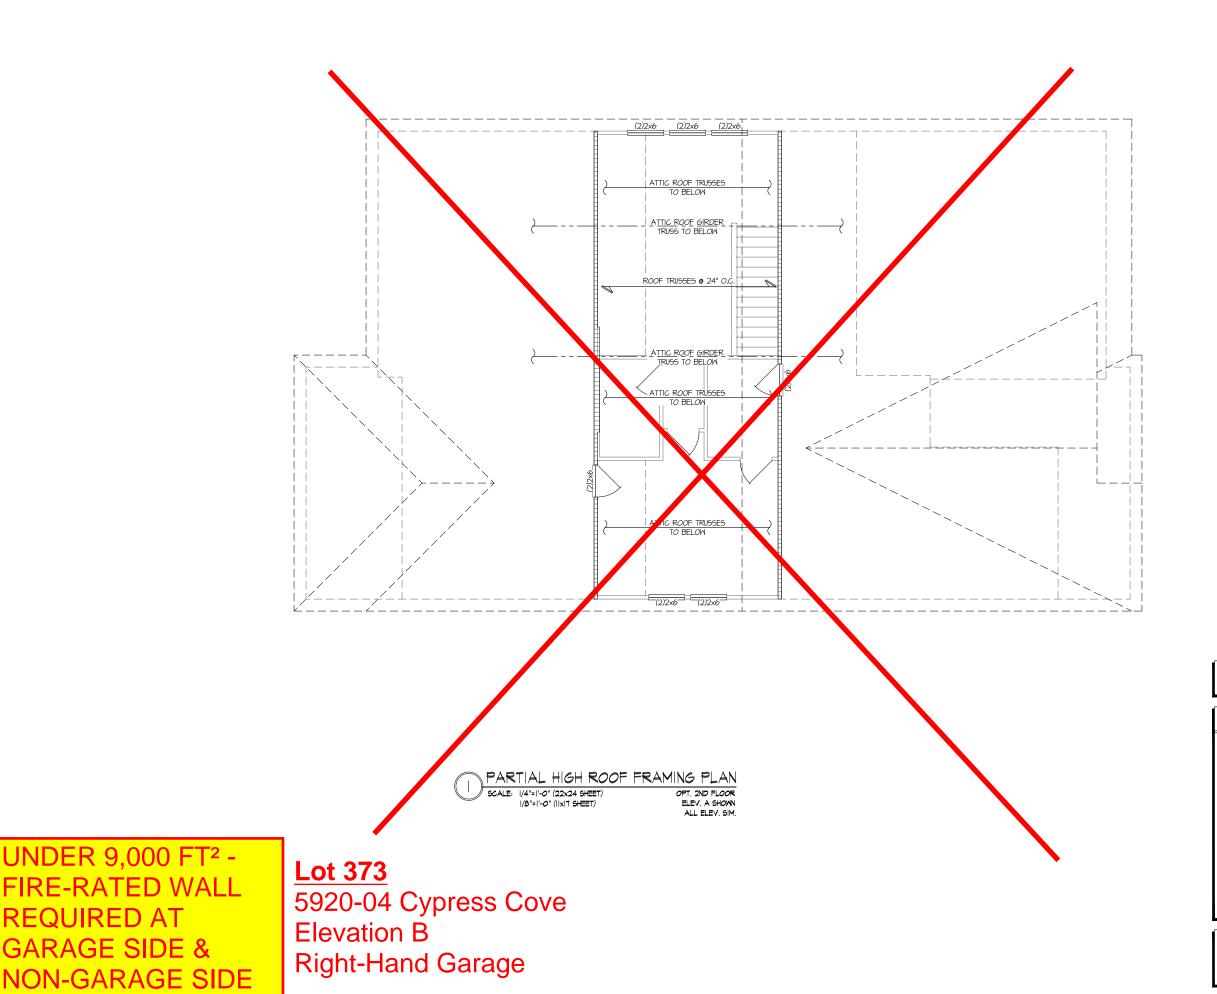NC License # C-3825



243-24030

SMK SMM issue date: 11-07-24

REVISIONS:

date: 05-16-25 PER UPDATED ARCH JPP

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THIS LEVEL HAS BEEN DESIGNED FOR 9'-1" PLATE HEIGHT

### LEGEND

- INTERIOR BEARING WALL
- □===□ BEARING WALL ABOVE (B.W.A.)
- INDICATES EXTENT OF INT.

  OSB SHEARWALL AND/OR
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- ► INDICATES HOLDOWN
- INDICATES POST ABOVE. PROVIDE SOLID BLOCKING UNDER POST OR JAMB ABOVE.


REFER TO SO.O FOR TYPICAL STRUCTURAL NOTES & SCHEDULES


STRUCTURAL OPTIONS

**S3.2** 

5920-04 MODEI

SERENITY MASTER SET RALEIGH, NC

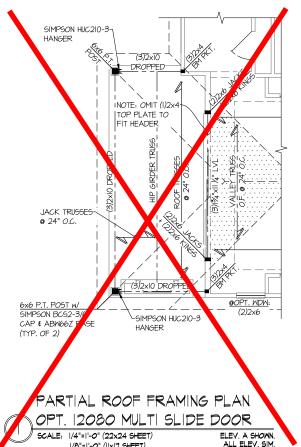

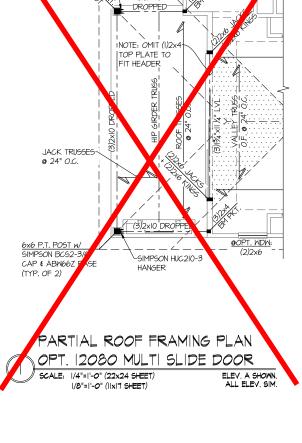

<u>Lot 373</u> 5920-04 Cypress Cove Elevation B Right-Hand Garage

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NC. Licence # C-3925



Mulhern+Kulp project number: 243-24030

SMK SMN issue date: 11-07-24

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# LEGEND

- IIIIII INTERIOR BEARING WALL
- □□□□□ BEARING WALL ABOVE (B.W.A.)
- BEAM / HEADER
- INDICATES EXTENT OF INT.

  OSB SHEARWALL AND/OR
  3" O.C. EDGE NAILING
- EXTENT OF VALLEY TRUSS OVERFRAMING


  24" O.C. (MAX.)
- ► INDICATES HOLDOWN
- INDICATES POST ABOVE. PROVIDE SOLID BLOCKING UNDER POST OR JAMB ABOVE.

REFER TO SO.O FOR TYPICAL STRUCTURAL NOTES & SCHEDULES

STRUCTURAL OPTIONS 5920-04 MODEI

SERENITY MASTER SET RALEIGH, NC

**S3.3** 

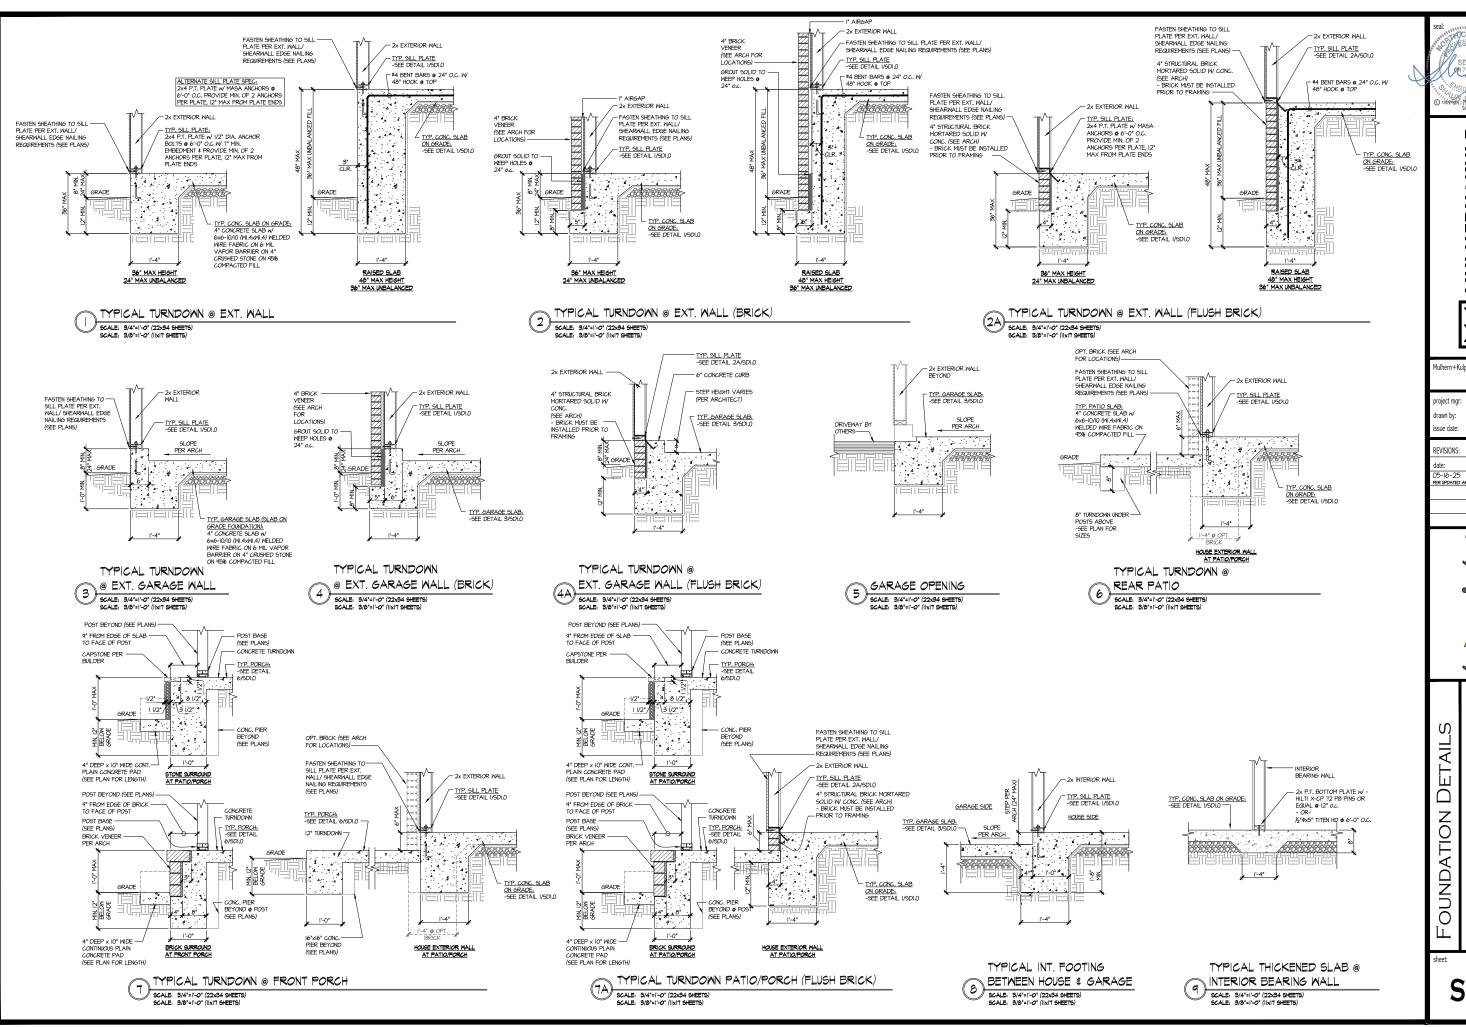

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lulhern+Kulp project number 243-2403 SMK SMN

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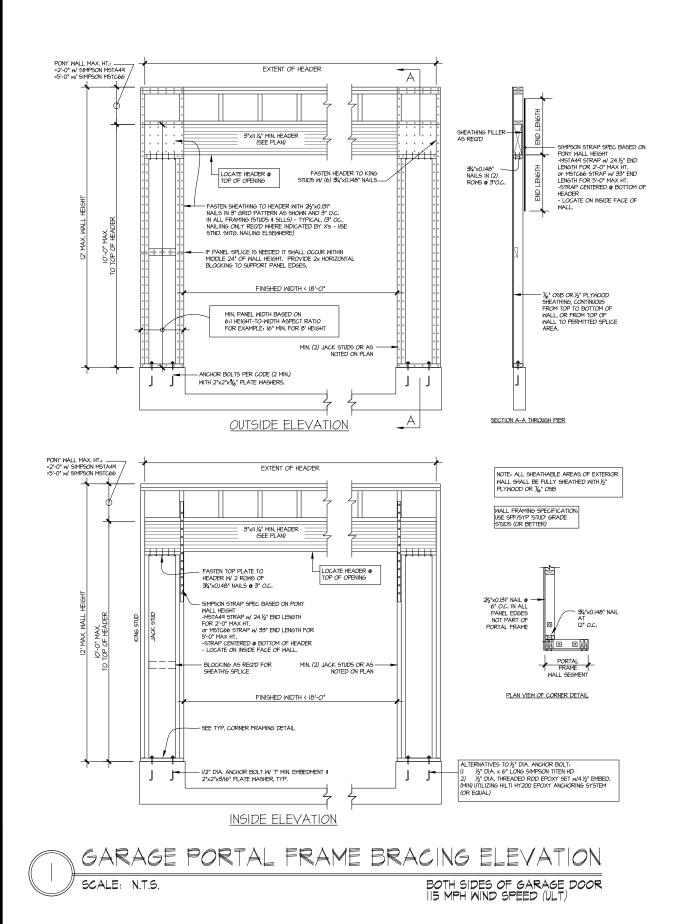
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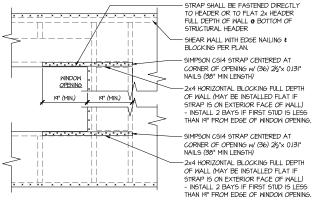
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SERENITY MASTER SET RALEIGH, NC 5920-


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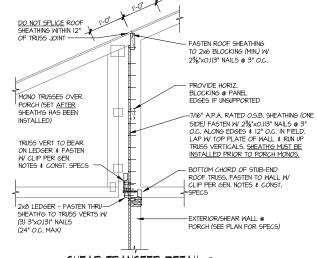


- STRAPS MAY BE INSTALLED ON EXTERIOR OR INTERIOR FACE OF WALL WHEN INSTALLED ON THE EXTERIOR FACE OF THE WALL, STRAPS TO BE INSTALLED ON EXTERIOR FACE OF SHTG. ( MAY BE MOVED 1/2" FROM EDGE TO ALLOW FOR WINDOW NAILING
  REQUIRED ONLY @ OPENINGS WHERE SPECIFIED ON PLAN


# TYPICAL EXT. WALL & INT. SHEARWALL OPENING ELEVATION SCALE: NTS



DRAG TRUSS DETAIL 3 DRAG TR

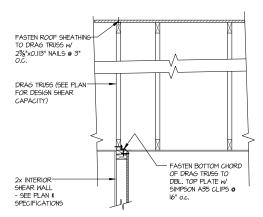

SHEAR TRANSFER DETAIL @ BREAK IN TRUSSES OVER SHEAR WALL SCALE: 3/4"=1'-0" - 22x34 3/8"=1'-0" - 11x17

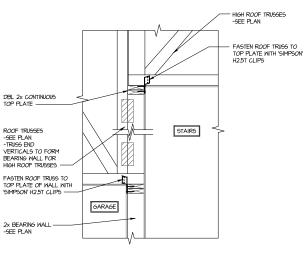

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Aulhern+Kulp project number 243-24030


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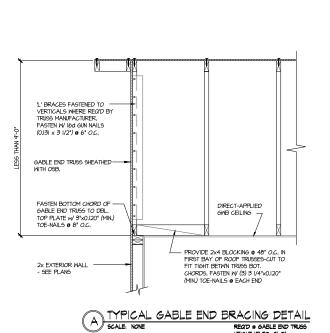
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Ŋ DETAIL MODE FRAMING SERENITY MASTER SET RALEIGH, NC 5920-04


**SD2.0** 





BRACE GABLE END TRUSSES PER ABOVE DETAIL WHEN GABLE HEIGHT IS LESS THAN 9"-0". "L" BRACES REQUIRED WHERE NOTED BY TRUSS MANUFACTURER.

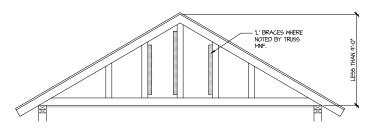REQ'D @ GABLE END TRUSS HEIGHT UP TO 9'-0'

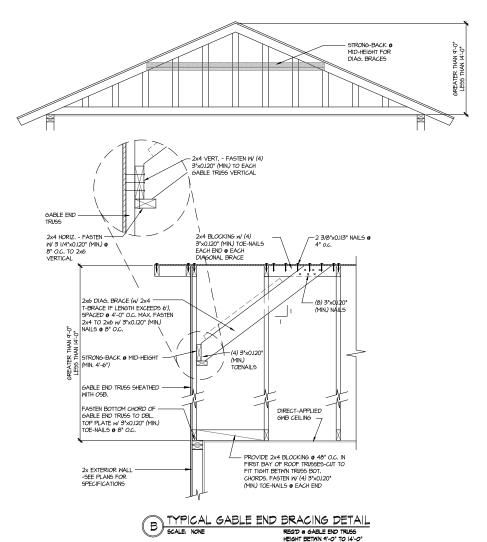

BRACE GABLE END TRUSSES PER ABOVE DETAIL WHEN GABLE HEIGHT EXCEEDS 9'-0'. "L' BRACES NOT REQUIRED.

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NC Licence # C-38.25

Mulhern+Kulp project number: 243-24030

SMK SMM drawn by: issue date: 11-07-24

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FRAMING DETAILS 5920-04 MODEL SERENITY MASTER SET RALEIGH, NC

**SD2.1**