



North Carolina Onsite Wastewater Contractor Inspector Certification Board
 Authorized Onsite Wastewater Evaluator Permit Option for Non-Engineered Systems
 Notice of Intent (NOI) to Construct

New Expansion Repair Relocation Relocation of Repair Area

Owner or Legal Representative Information:
 Name: RiverWILD Homes
 Mailing address: 114 W Main St City: Clayton State: NC Zip: 27520
 Phone: 919-373-6048 Email: kelley@staywild.com

Authorized Onsite Wastewater Evaluator Information:
 Name: Trent Bostic Certification #: 10056E
 Mailing address: 1225 Crescent Drive, Ste 250 City: Cary State: NC Zip: 27518
 Phone: 919-367-6322 Email: tbostic@agriwaste.com

Site Location Information:
 Site address: 98 Beebalm Run, Dunn, NC 28334
 Tax parcel identification number or subdivision lot, block number of property: 1509-11-6927
Alton Fields, Lot - 3 County: Harnett

System Information:
 Wastewater System Type: IIb
 Daily Design Flow: 480
 Saprolite System: Yes No Subsurface Operator Required: Yes No
 Water Supply Type: Private Well Public Water Supply Spring Other: _____


Facility Type:
 Residential 4 # Bedrooms 8 Maximum # of Occupants _____
 Business Type of Business and Basis for Flow: _____
 Public Assembly Type of Public Assembly and Basis for Flow: _____

Required Attachments:
 Plat or Site Plan
 Evaluation of Soil and Site Features by Licensed Soil Scientist

Attest: On this the 29 day of OCT, 2025 by signature below I hereby attest that the information required to be included with this NOI to Construct is accurate and complete to the best of my knowledge. Furthermore, I hereby attest that I have adhered to the laws and rules governing onsite wastewater systems in the state of North Carolina.
 This NOI shall expire on 29 day of OCT, 2028.

Signature of Authorized Onsite Wastewater Evaluator: Trent Bostic

Signature of Owner or Legal Representative: _____

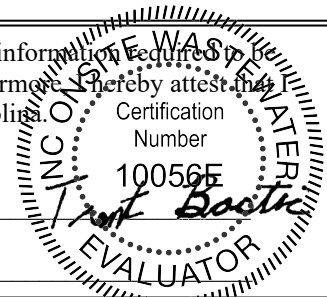


Disclosure: The owner may apply for a building permit for the project upon submitting a complete NOI to Construct and the fee required (if any) to the local health department. An onsite wastewater system authorized by an authorized onsite wastewater evaluator shall be transferable to a new owner with the consent of the authorized onsite wastewater evaluator.

Local Health Department Receipt Acknowledgement:
 Signature of Local Health Department Representative: _____ Date: _____



Agri-Waste Technology, Inc.
1225 Crescent Green, Suite 250, Cary NC 27518
agriwaste.com | 919.859.0669

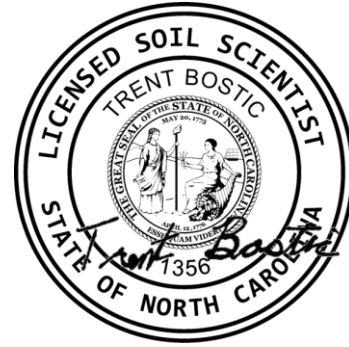

**Soil Suitability for Domestic Sewage Treatment and Disposal Systems
98 Beebalm Run, Dunn, NC 28334
(PIN: 1509-11-6927; Harnett County)**

PREPARED FOR: RiverWILD Homes, c/o Kelley Judd

PREPARED BY: Trent Bostic, Senior Soil Scientist

DATE: October 29, 2025

Soil suitability for domestic sewage treatment and disposal systems was evaluated on May 1, 2025, for the property located at the Alton Fields subdivision. Trent Bostic of Agri-Waste Technology, Inc. (AWT) conducted the soil evaluation. This evaluation was done to facilitate permitting for a septic system. This report and attached documents were prepared to meet the requirements for an Authorized On-Site Wastewater Evaluator to meet G.S. 130A-336.2

A drawing of the site plan, septic layout, and boring locations is included in Attachment 1. Profile descriptions for each boring are included in Attachment 2. Additional documentation about the property is included in Attachment 3.

Site Conditions

The total property area is approximately 0.58 acres. The property is wooded. The drawing in Attachment 1 details the property boundaries, house location, boring locations, and layout of drain field trenches (Completed by AWT).

Soil Suitability for Domestic Sewage Treatment and Disposal Systems

Multiple soil borings/pits were assessed on the property. Soil borings/pits were examined to determine soil suitability for on-site sewage disposal systems in accordance with 15A NCAC 18E: Wastewater Treatment and Dispersal Systems. These borings/pits were advanced with a hand auger and excavator. All soil borings/pits shown are provisionally suitable for a conventional style trench. The proposed LTAR (Long Term Acceptance Rate) by AWT is 0.4 GPD/ft². The soils on this property are group III soils within the distribution and treatment zone as used to define the LTAR. The maximum trench bottom should not exceed 18”.

Field Layout & System Design


A septic layout was performed to demonstrate available space (.0508). The layout in Attachment 1 indicates there is available space for a four-bedroom primary and repair system utilizing a 25% reduction product. With an LTAR of 0.4 GPD/ft², 300 linear feet of trench is necessary to support a four-bedroom home primary and 300 linear feet of trench is required for the repair system. The attached drawing proves that 600+ linear feet of trench can be installed with the proposed home location on the property.

Any disturbances or grading done in the usable soils area may change the potential of using the area designated for a drain field and can result in a revoked permit.

We appreciate the opportunity to assist you in this matter. Please contact us with any questions, concerns, or comments.

Sincerely,

Trent Bostic, AOWE

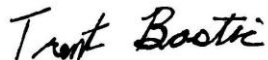



Agri-Waste Technology, Inc.
501 N Salem Street, Suite 203, Apex, NC 27502
agriwaste.com | 919.859.0669

SOIL & SITE EVALUATION for ON-SITE WASTEWATER SYSTEMS

| | | | | | |
|-------------------|--------------|-----------------------|----------------|---------------------|----------|
| Evaluation Date | 5/1/2025 | Site Location | 98 Beebalm Run | County | Harnett |
| PIN/Parcel | 1509-11-6927 | Property Size (acres) | 0.58 | Property Recorded | Yes |
| Proposed Facility | SFR | Bedrooms | 4 | Wastewater Strength | Domestic |
| Water Supply | Municipal | Design Flow (.0400) | 480 | Evaluation Method | Auger |

| Profile # | .0502 Landscape Position Slope % | Horizon Depth (in) | Soil Morphology | | Other Factors | | | | | .0509 Profile Class LTAR | .0502(d) Slope Corrected Depth |
|--------------------|---|-----------------------|-------------------------------|------------------------------------|-----------------------------------|-----------------------------|--------------------|---------------------------------|-------------|-----------------------------------|---|
| | | | .0503 Structure Texture | .0503 Consistence Mineralogy | .0504 Soil Wetness Color | .0505 Soil Depth (in) | .0506 Saprolite | .0507 Restrictive Horizon | System Type | | |
| 1 | 4% | Ap 0-9 | LS | NS, NP, Vfr | 10YR 5/2 | 32 | Suitable | Suitable | 0.375 | 18 | |
| | | E 9-15 | LS | NS, NP, Vfr | 10YR 6/4 | | | | | | |
| | | Bt | SCL | SS, SP, Fi | 10YR 5/6 | | | | | | |
| System Type | | | | | | | | Conventional | | | |

| | | | | | | | | | | |
|--------------------|----|--------|-----|-------------|----------|----|----------|---------------------|-------|----|
| 2 | 4% | Ap 0-9 | LS | NS, NP, Vfr | 10YR 5/2 | 32 | Suitable | Suitable | 0.375 | 18 |
| | | E 9-15 | LS | NS, NP, Vfr | 10YR 6/4 | | | | | |
| | | Bt | SCL | SS, SP, Fi | 10YR 5/6 | | | | | |
| System Type | | | | | | | | Conventional | | |

| | | | | | | | | | | |
|--------------------|----|--------|-----|-------------|----------|----|----------|---------------------|-------|----|
| 3 | 4% | Ap 0-9 | LS | NS, NP, Vfr | 10YR 5/2 | 32 | Suitable | Suitable | 0.375 | 18 |
| | | E 9-15 | LS | NS, NP, Vfr | 10YR 6/4 | | | | | |
| | | Bt | SCL | SS, SP, Fi | 10YR 5/6 | | | | | |
| System Type | | | | | | | | Conventional | | |

| | | | | | | | | | | |
|--------------------|----|--------|-----|-------------|----------|----|----------|---------------------|-------|----|
| 4 | 4% | Ap 0-9 | LS | NS, NP, Vfr | 10YR 5/2 | 32 | Suitable | Suitable | 0.375 | 18 |
| | | E 9-15 | LS | NS, NP, Vfr | 10YR 6/4 | | | | | |
| | | Bt | SCL | SS, SP, Fi | 10YR 5/6 | | | | | |
| System Type | | | | | | | | Conventional | | |

Evlauted by: TB

| | | | |
|-----------------------------|----------|----------------------------|-----|
| Site Classification | Suitable | | |
| Primary LTAR | 0.4 | Repair LTAR | 0.4 |
| Primary Trench Depth | 18 | Repair Trench Depth | 18 |



Agri-Waste Technology, Inc.
 501 N Salem Street, Suite 203, Apex, NC 27502
 agriwaste.com | 919.859.0669

SOIL & SITE EVALUATION for ON-SITE WASTEWATER SYSTEMS

LEGEND

| Soil Group | Soil Texture | Conventional LTAR | Anaerobic Dip LTAR | Aerobic Drip LTAR (TS-II) | Mineralogy & Consistence | | Structure |
|------------|------------------------|-------------------|--------------------|---------------------------|--------------------------|-----------------------|-------------------------|
| | | | | | Moist | Wet | |
| I | S (Sand) | 0.8-1.2 | 0.4-0.6 | 0.8-1.5 | Moist | Wet | SG (Single grain) |
| | Lo (Loose) | | | | NS (Non Sticky) | M (Massive) | |
| II | LS (Loamy Sand) | 0.6-0.8 | 0.3-0.4 | 0.6-0.8 | VFR (Very Friable) | SS (Slightly Sticky) | GR (Granular) |
| | SL (Sandy Loam) | | | | FR (Friable) | S (Sticky) | SBK (Subangular Blocky) |
| III | L (Loam) | 0.3-0.6 | 0.15-0.3 | 0.2-0.6 | FI (Firm) | VS (Very Sticky) | ABK (Angular Blocky) |
| | SiL (Silt Loam) | | | | VFI (Very Firm) | NP (Non Plastic) | PR (Prismatic) |
| IV | SCL (Sandy Clay Loam) | 0.1-0.4 | 0.05-1.5 | 0.05-0.2 | EFI (Extremely Firm) | SP (Slightly Plastic) | P (Plastic) |
| | CL (Clay Loam) | | | | VP (Very Plastic) | PL (Platy) | |
| | SiCL (Silty Clay Loam) | | | | | | |
| | SC (Sandy Clay) | | | | | | |
| | SiC (Silty Clay) | | | | SEXP (Slighty Expansive) | | |
| | C (Clay) | | | | EXP (Expansive) | | |



CERTIFICATE OF LIABILITY INSURANCE

DATE (MM/DD/YYYY)

1/20/2025

THIS CERTIFICATE IS ISSUED AS A MATTER OF INFORMATION ONLY AND CONFERS NO RIGHTS UPON THE CERTIFICATE HOLDER. THIS CERTIFICATE DOES NOT AFFIRMATIVELY OR NEGATIVELY AMEND, EXTEND OR ALTER THE COVERAGE AFFORDED BY THE POLICIES BELOW. THIS CERTIFICATE OF INSURANCE DOES NOT CONSTITUTE A CONTRACT BETWEEN THE ISSUING INSURER(S), AUTHORIZED REPRESENTATIVE OR PRODUCER, AND THE CERTIFICATE HOLDER.

IMPORTANT: If the certificate holder is an ADDITIONAL INSURED, the policy(ies) must have ADDITIONAL INSURED provisions or be endorsed. If SUBROGATION IS WAIVED, subject to the terms and conditions of the policy, certain policies may require an endorsement. A statement on this certificate does not confer rights to the certificate holder in lieu of such endorsement(s).

| | | |
|--|---|------------------------------------|
| PRODUCER Hartsfield & Nash Agency, Inc. 10405 Ligon Mill Rd., Ste H Wake Forest NC 27587 | CONTACT NAME: Connie Garkalns PHONE (A/C No. Ext): 984-235-4273 E-MAIL ADDRESS: connie@hartsfield-nash.com | FAX (A/C, No): 919-556-8758 |
| | INSURER(S) AFFORDING COVERAGE | |
| License#: 1000009111 AGRITEC-01 | INSURER A: Selective Insurance Company of | NAIC # 39926 |
| INSURED Agri-Waste Technology Inc 501 N. Salem St Ste 203 Apex NC 27502 | INSURER B: Accident Fund | 10166 |
| | INSURER C: Evanston Insurance Company | 35378 |
| | INSURER D: | |
| | INSURER E: | |
| | INSURER F: | |


COVERAGES **CERTIFICATE NUMBER:** 1304989694 **REVISION NUMBER:**

THIS IS TO CERTIFY THAT THE POLICIES OF INSURANCE LISTED BELOW HAVE BEEN ISSUED TO THE INSURED NAMED ABOVE FOR THE POLICY PERIOD INDICATED. NOTWITHSTANDING ANY REQUIREMENT, TERM OR CONDITION OF ANY CONTRACT OR OTHER DOCUMENT WITH RESPECT TO WHICH THIS CERTIFICATE MAY BE ISSUED OR MAY PERTAIN, THE INSURANCE AFFORDED BY THE POLICIES DESCRIBED HEREIN IS SUBJECT TO ALL THE TERMS, EXCLUSIONS AND CONDITIONS OF SUCH POLICIES. LIMITS SHOWN MAY HAVE BEEN REDUCED BY PAID CLAIMS.

| INSR LTR | TYPE OF INSURANCE | ADDL INSD | SUBR WVD | POLICY NUMBER | POLICY EFF (MM/DD/YYYY) | POLICY EXP (MM/DD/YYYY) | LIMITS |
|----------|--|-----------|----------|-----------------------------|-------------------------|-------------------------|---|
| A | <input checked="" type="checkbox"/> COMMERCIAL GENERAL LIABILITY <input type="checkbox"/> CLAIMS-MADE <input checked="" type="checkbox"/> OCCUR GEN'L AGGREGATE LIMIT APPLIES PER: <input type="checkbox"/> POLICY <input checked="" type="checkbox"/> PRO-JECT <input type="checkbox"/> LOC <input type="checkbox"/> OTHER: | | | S 2253659 | 1/18/2025 | 1/18/2026 | EACH OCCURRENCE \$2,000,000 DAMAGE TO RENTED PREMISES (Ea occurrence) \$300,000 MED EXP (Any one person) \$10,000 PERSONAL & ADV INJURY \$2,000,000 GENERAL AGGREGATE \$4,000,000 PRODUCTS - COMP/OP AGG \$4,000,000 \$ |
| A | AUTOMOBILE LIABILITY <input checked="" type="checkbox"/> ANY AUTO <input type="checkbox"/> OWNED AUTOS ONLY <input type="checkbox"/> SCHEDULED AUTOS <input checked="" type="checkbox"/> HIRED AUTOS ONLY <input checked="" type="checkbox"/> NON-OWNED AUTOS ONLY | | | S 2253659 | 1/18/2025 | 1/18/2026 | COMBINED SINGLE LIMIT (Ea accident) \$1,000,000 BODILY INJURY (Per person) \$ BODILY INJURY (Per accident) \$ PROPERTY DAMAGE (Per accident) \$ \$ |
| A | <input checked="" type="checkbox"/> UMBRELLA LIAB <input checked="" type="checkbox"/> OCCUR <input type="checkbox"/> EXCESS LIAB <input type="checkbox"/> CLAIMS-MADE DED RETENTION \$ | | | S 2253659 | 1/18/2025 | 1/18/2026 | EACH OCCURRENCE \$2,000,000 AGGREGATE \$2,000,000 \$ |
| B | WORKERS COMPENSATION AND EMPLOYERS' LIABILITY ANY PROPRIETOR/PARTNER/EXECUTIVE OFFICER/MEMBER EXCLUDED? (Mandatory in NH) If yes, describe under DESCRIPTION OF OPERATIONS below | Y/N N | N/A | 100003072 | 1/18/2025 | 1/18/2026 | <input checked="" type="checkbox"/> PER STATUTE <input type="checkbox"/> OTHER E.L. EACH ACCIDENT \$1,000,000 E.L. DISEASE - EA EMPLOYEE \$1,000,000 E.L. DISEASE - POLICY LIMIT \$1,000,000 |
| C A | Prof & Pollution Liability Leased & Rented | | | MKLV3ENV104794 S 2253659 | 8/22/2024 1/18/2025 | 8/22/2025 1/18/2026 | Each Claim \$5,000,000 Equipment 25,000 |

DESCRIPTION OF OPERATIONS / LOCATIONS / VEHICLES (ACORD 101, Additional Remarks Schedule, may be attached if more space is required)

CERTIFICATE HOLDER **CANCELLATION**

| | |
|---|---|
| Artisan Custom Homes 21016 Catawba Avenue Cornelius NC 28031 USA | SHOULD ANY OF THE ABOVE DESCRIBED POLICIES BE CANCELLED BEFORE THE EXPIRATION DATE THEREOF, NOTICE WILL BE DELIVERED IN ACCORDANCE WITH THE POLICY PROVISIONS. AUTHORIZED REPRESENTATIVE  |
|---|---|

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NORTH CAROLINA, HARNETT COUNTY
 I, Mickey R. Bennett, PLS do certify that this plat was drawn under
 my supervision (see description recorded in Book (see ref.) Page
 (see ref.) that boundaries not surveyed are clearly
 indicated as drawn from information found in Book (see ref.) Page
 (see ref.) that the ratio of precision as calculated is 1:10000.
 Witness my original signature, registration number and seal this
 22nd day of April, 2025 A.D.

Mickey R. Bennett PLS

MICKEY R. BENNETT
 L-1514





I, MICKEY R. BENNETT, PLS, CERTIFY
 that this survey is of and existing parcel
 or parcels of land or one or more existing
 easements and does not create a new street
 or change an existing street.

4

3

2

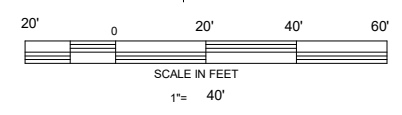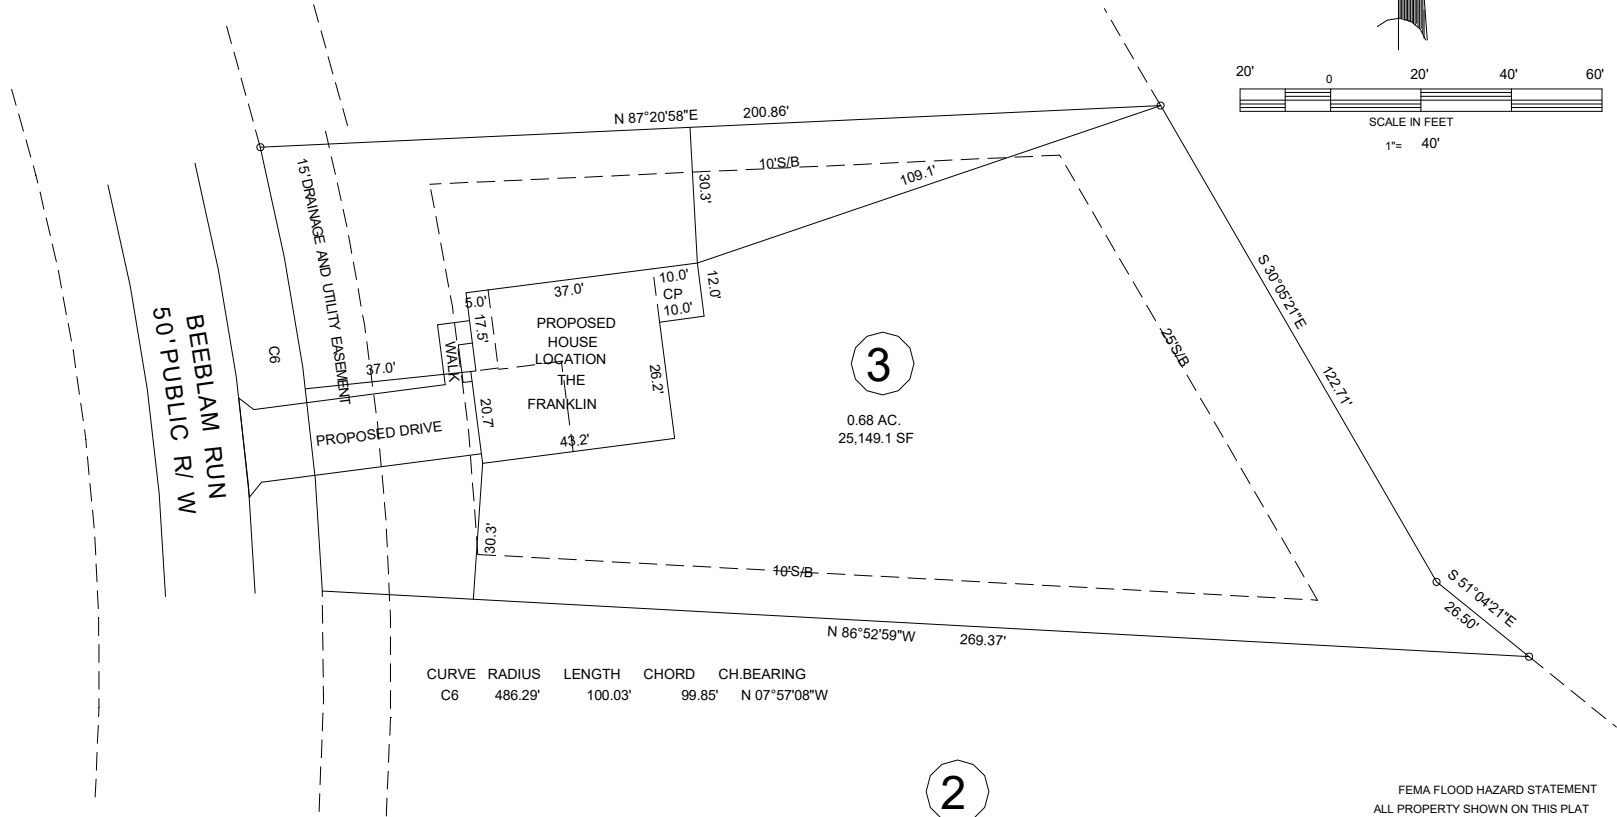

| CURVE | RADIUS | LENGTH | CHORD | CH. BEARING |
|-------|---------|---------|--------|---------------|
| C6 | 486.29' | 100.03' | 99.85' | N 07°57'08\"W |

PROPOSED IMPREVIOUS AREA = 2800 SF+-

MINIMUM BUILDING SETBACKS
 RA-30
 FRONT --- 35' FROM R/W
 REAR --- 25'
 SIDE --- 10'
 CORNER LOT SIDE - 20'
 MAXIMUM HEIGHT - 35'
 MAXIMUM IMPREVIOUS AREA PER LOT - 5000 SF


DEED REFERENCE DEED BOOK 4231, PAGE 1889
 MAP REFERENCE PLAT BOOK 2025, PAGE 176

DISCLAIMER
 ALL INFORMATION SHOWN ON THIS MAP WAS TAKEN FROM
 RECORDED DEEDS, PLATS AND OTHER PUBLIC INFORMATION.
 BENNETT SURVEYS HAS NOT PERFORMED ANY SURVEY IN
 PREPARING THIS PLAT AS OF DATE SHOWN.

OWNER: GREGORY INC.
 62 E MCIVRY STREET
 ANGIER, NC
 27501-5891

NO FIELD SURVEY WAS PERFORMED IN .
 PREPARING THIS PLAT
 PROPOSED PLOT PLAN
 98 BEEBALM RUN, DUNN, NC 28334

FEMA FLOOD HAZARD STATEMENT
 ALL PROPERTY SHOWN ON THIS PLAT
 IS LOCATED WITHIN THE FEMA (ZONE X)
 MINIMAL FLOOD RISK AS SHOWN ON
 FIRM NUMBER 3720150900J
 EFFECTIVE DATE 10/3/2006.

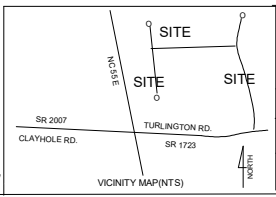

| | | | |
|--------------------------------------|----------------------|------------------------|-------------------|
| ALTON FIELDS SUBDIVISION. LOT - 3 | | BENNETT SURVEYS F-1304 | |
| GROVE TOWNSHIP | | LILLINGTON, NC 27546 | |
| HARNETT COUNTY | | 910-893-5252 | |
| STATE: NORTH CAROLINA | DATE: APRIL 22, 2025 | SCALE: 1"= 40' | DRAWN BY: MRB |
| ZONE RA-30 | PIN 1509-11-6927.000 | PID 071509 0037 13 | CHECKED BY: |
| | | | DRAWING NO. 25141 |

AOWE - AF3

| | |
|--------------------|--|
| Project Location | 98 Beebalm Run Dunn, NC 27334 Harnett County PIN: 1509-11-6927 |
| Project Owner | RiverWILD Homes 114 W Main St Clayton, NC 27520 919-373-6048 kelley@staywild.com |
| Project Consultant | Trent Bostic, AOWE (919) 367-6322 tbostic@agriwaste.com Agri-Waste Technology, Inc. 1225 Crescent Green, Suite 250 Cary, NC 27518 (919) 859-0669 (919) 233-1970 Fax |
| System Overview | Single Family Residence Four (4) Bedrooms, 480GPD Gravity, Parallel Distribution Accepted/Innovative Trench Product |



VICINITY MAP

Sheet Index

| | |
|---------|--------------------|
| Sheet 1 | Cover Sheet |
| Sheet 2 | Property Layout |
| Sheet 3 | Primary Drainfield |
| Sheet 4 | Detail Sheet |

AWT
Engineers and Soil Scientists
Agri-Waste Technology, Inc.
1225 Crescent Green, Suite 250
Cary, North Carolina 27518
919-859-0669
www.agriwaste.com

RiverWILD Homes
AOWE - AF3

Project Location:
98 Beebalm Run
Dunn, NC 27334
Harnett County
PIN: 1509-11-6927

Project Owner:
RiverWILD Homes
114 W Main St
Clayton, NC 27520
919-373-6048
kelley@staywild.com

NC ONSITE WASTEWATER
EVALUATOR SEAL



| REV. | ISSUED DATE | DESCRIPTION |
|------|-------------|-------------|
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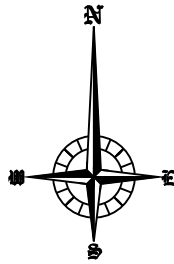
SHEET TITLE
Cover Sheet

| | |
|------------------------|---------------------------|
| DRAWN BY: T. Bostic | CREATED ON: 10/27/2025 |
| REVISED BY: #### | REVISED ON: #### |
| RELEASED BY: #### | RELEASED ON: #### |


DRAWING NUMBER

WW-1





4

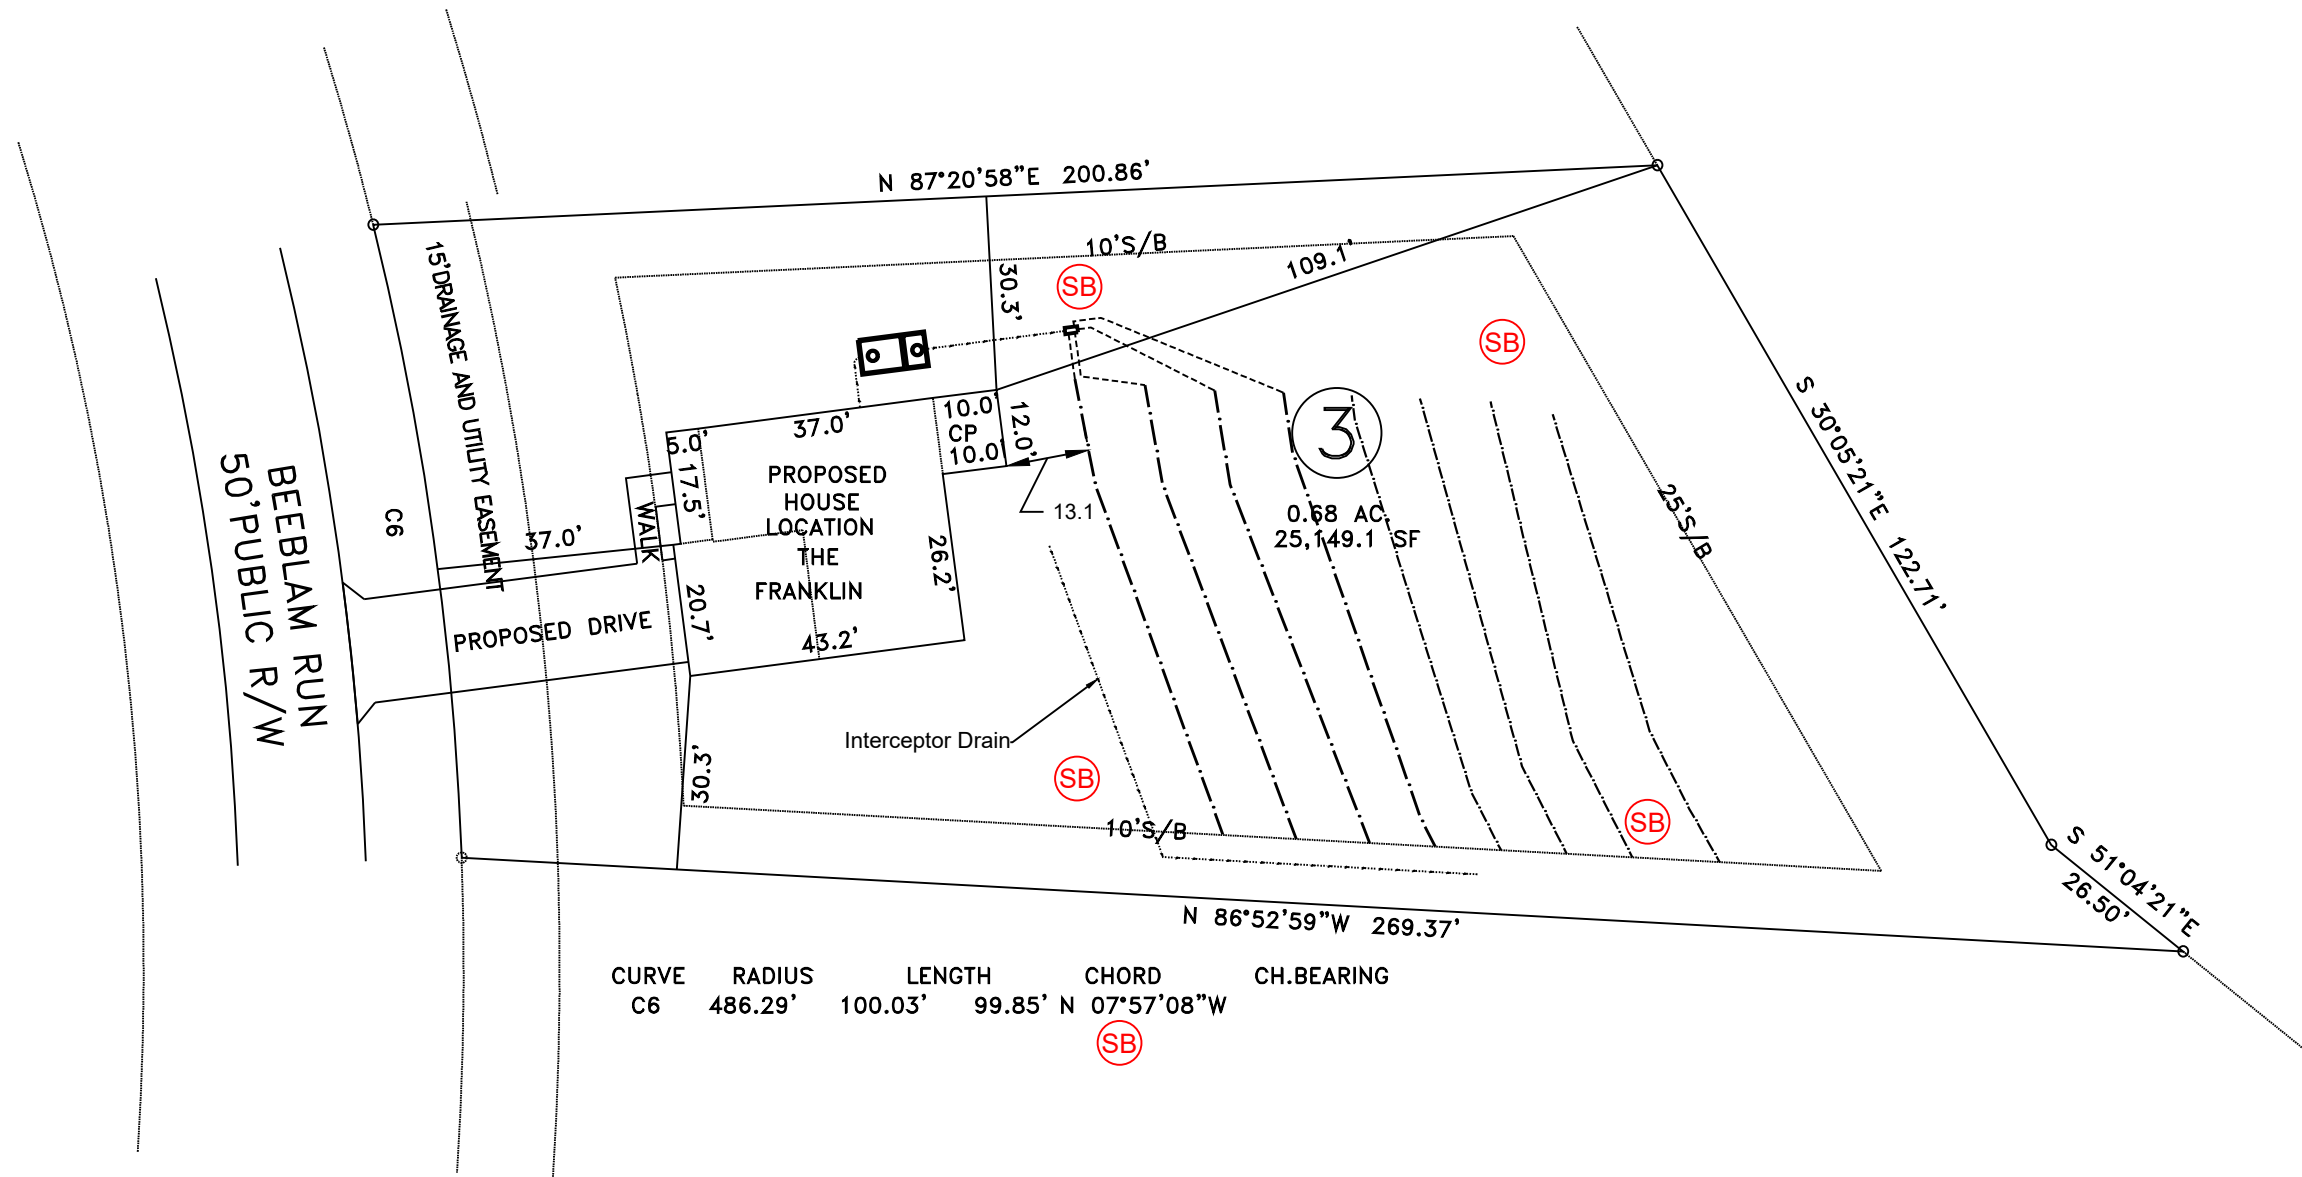

| CURVE | RADIUS | LENGTH | CHORD | CH.BEARING |
|-------|---------|---------|--------|--------------|
| C6 | 486.29' | 100.03' | 99.85' | N 07°57'08"W |

(SB)



Engineers and Soil Scientists

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1225 Crescent Green, Suite 250
Cary, North Carolina 27518
919-859-0669
www.agriwaste.com

RiverWILD Homes
AOWE - AF3

Project Location:
98 Beebalm Run
Dunn, NC 27334
Harnett County
PIN: 1509-11-6927

Project Owner:
RiverWILD Homes
114 W Main St
Clayton, NC 27520
919-373-6048
kelley@staywild.com

NC ONSITE WASTEWATER
EVALUATOR SEAL



| REV. | ISSUED DATE | DESCRIPTION |
|------|-------------|-------------|
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SHEET TITLE

Property Layout

| | |
|------------------------|---------------------------|
| DRAWN BY: T. Bostic | CREATED ON: 10/27/2025 |
| REVISED BY: #### | REVISED ON: #### |
| RELEASED BY: #### | RELEASED ON: #### |



DRAWING NUMBER

WW-2

General Drainfield Notes:

1. Clear all trees less than 8" in diameter (measured at a height 3' from soil surface) from the drainfield.
2. Vegetation that will re-grow from a cut stump shall be stumped or pulled from the ground. Stumps shall not be pushed over.
3. Drainfield area shall be cleared of all leaves, pine straw, debris, etc. The accumulated material shall be removed from the drainfield.
4. In clayey soils, sides of trenches shall be raked and limed per manufacturer's instructions.
5. Supply lines shall be installed with a minimum of 18" cover.
6. The trenches shall be backfilled appropriately so that no low areas are present.
7. Apply lime over the drainfield area as needed. Seed fine fescue over the drainfield at the rate
8. recommended by the seed manufacturer. Hand rake the seed into the soil surface. Straw the seeded area at the rate of 1.5-2 bales per 1000 sq. ft.

Note:
 Primary distribution is parallel w/ D-box. Primary is Infiltrator EZ Flow.

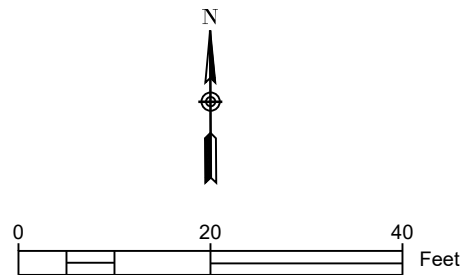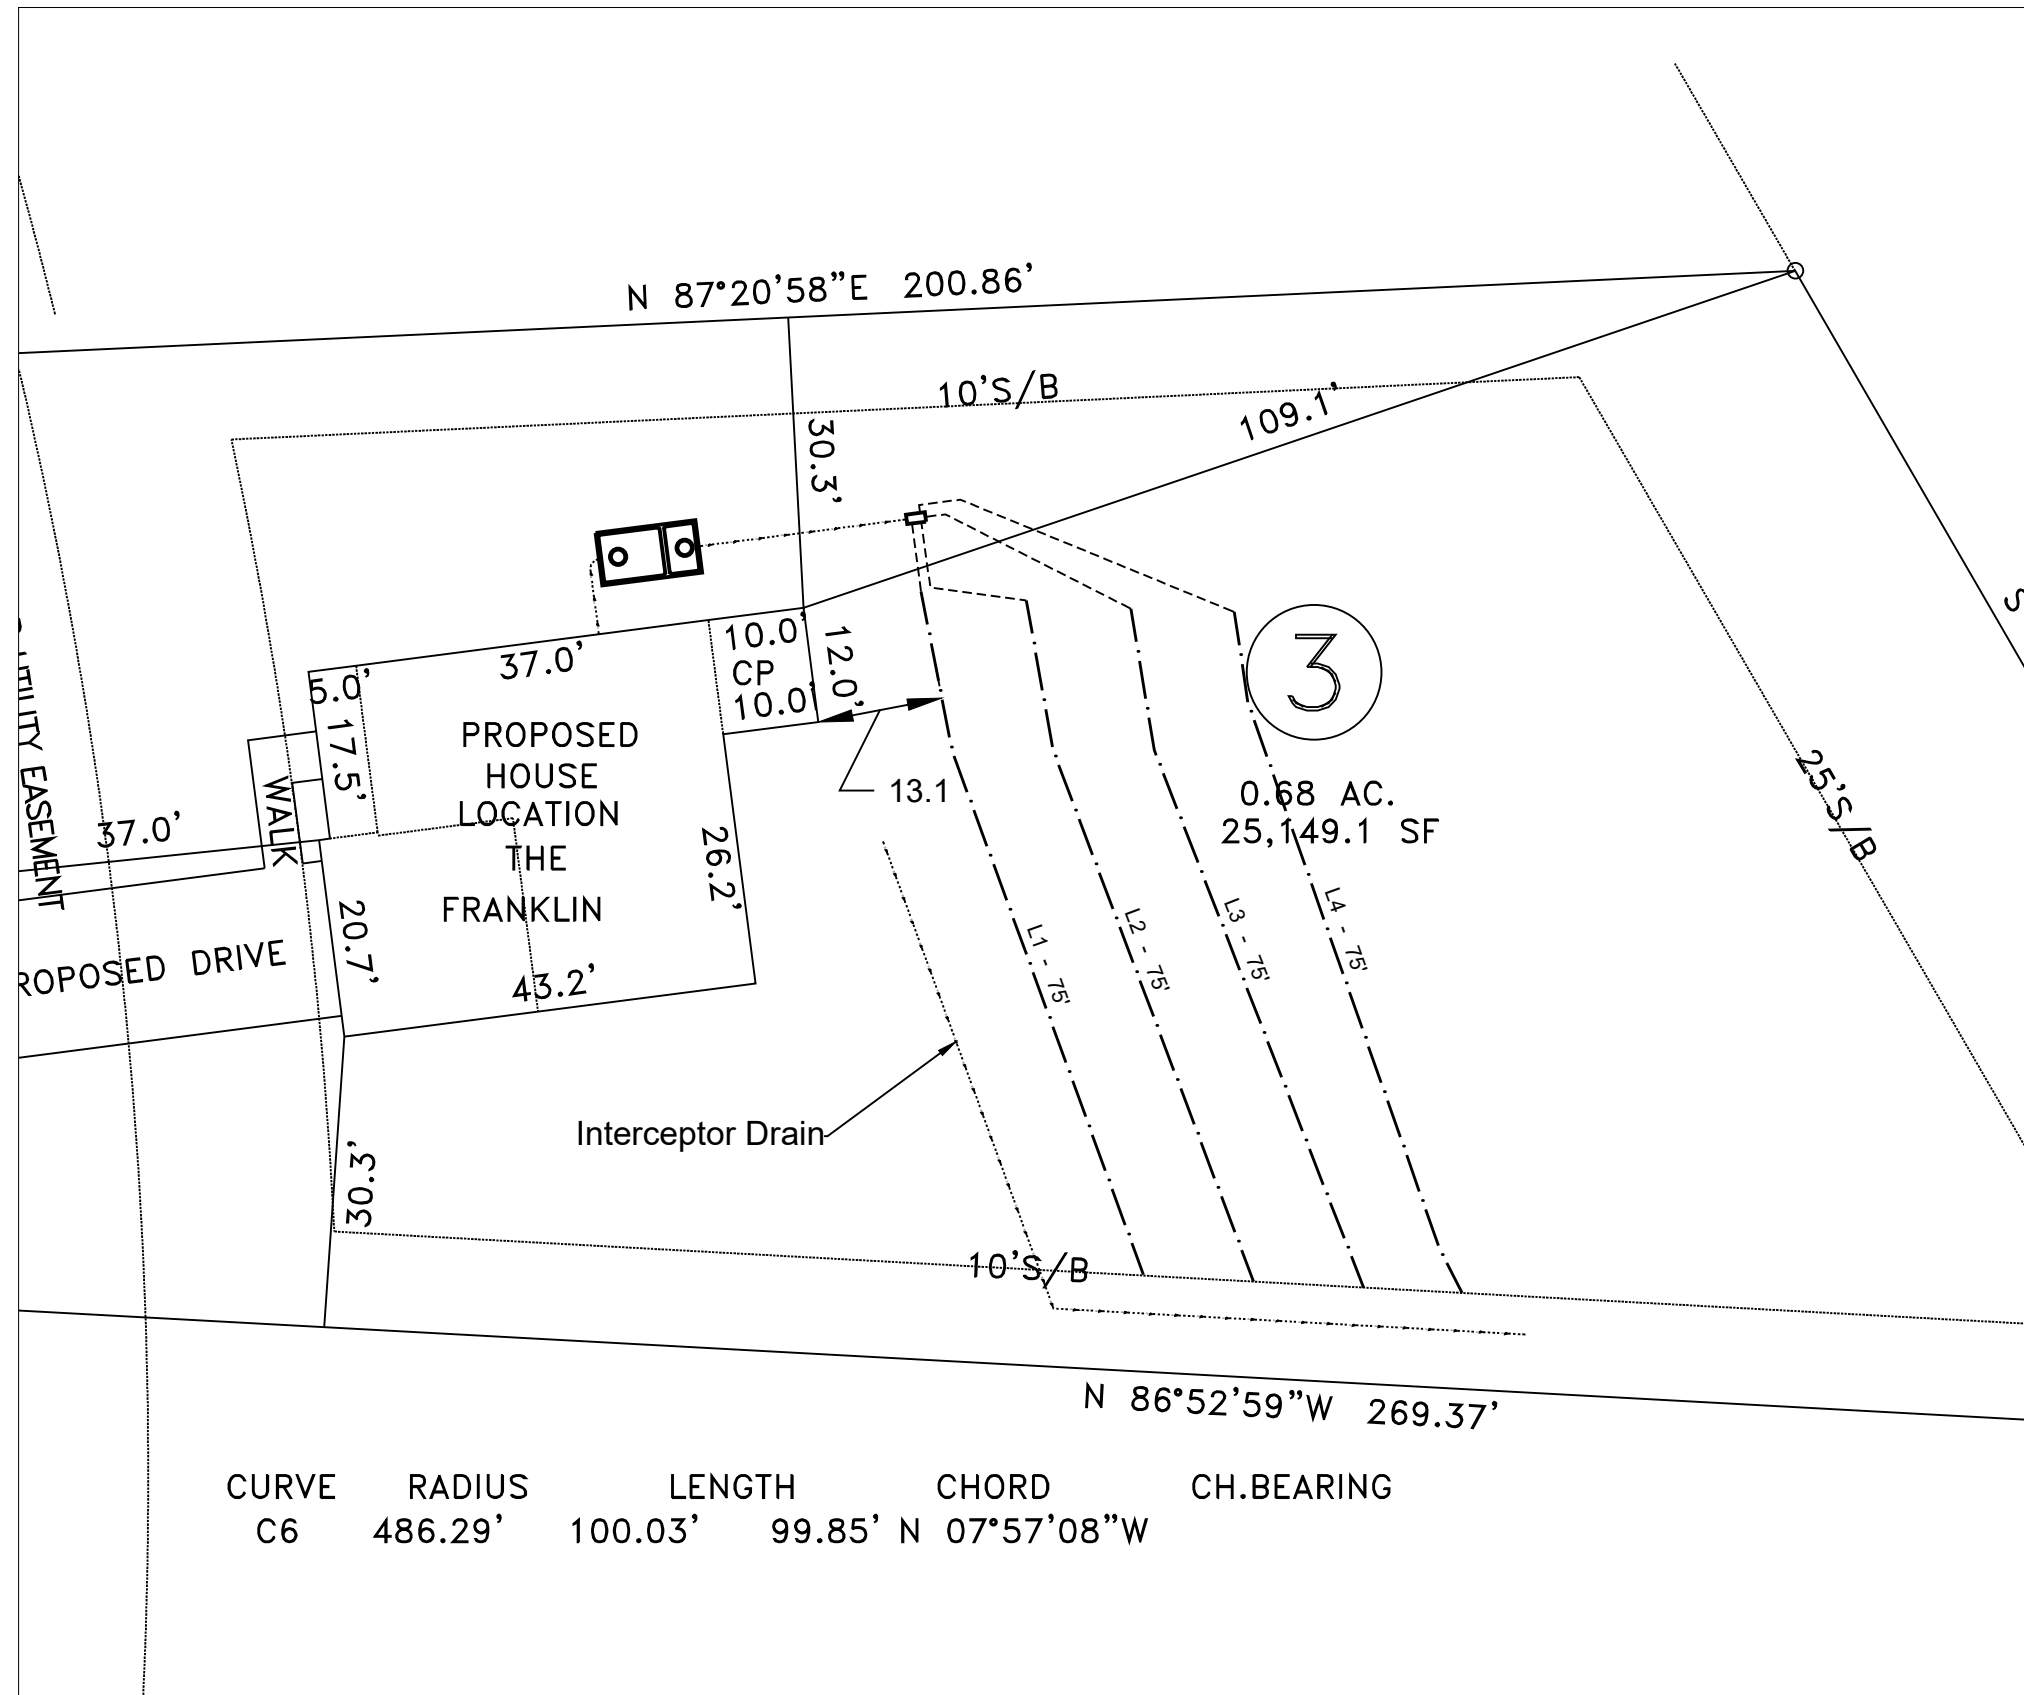

1 System Layout

SOURCE: Agri-Waste Technology, Inc.



Agri-Waste Technology, Inc.
 1225 Crescent Green, Suite 250
 Cary, NC 27518
 919-859-0669
 www.agriwaste.com

RiverWILD Homes
 AOWE - AF3

Project Location:
 98 Beebalm Run
 Dunn, NC 27334
 Harnett County
 PIN: 1509-11-6927

Project Owner:
 RiverWILD Homes
 114 W Main St
 Clayton, NC 27520
 919-373-6048
 kelley@staywild.com

NC ONSITE WASTEWATER
 EVALUATOR SEAL





REV. ISSUED DATE DESCRIPTION

SHEET TITLE
 Primary Layout

| | |
|------------------------|---------------------------|
| DRAWN BY: T. Bostic | CREATED ON: 10/27/2025 |
| REVISED BY: #### | REVISED ON: #### |
| RELEASED BY: #### | RELEASED ON: #### |

DRAWING NUMBER


WW-3

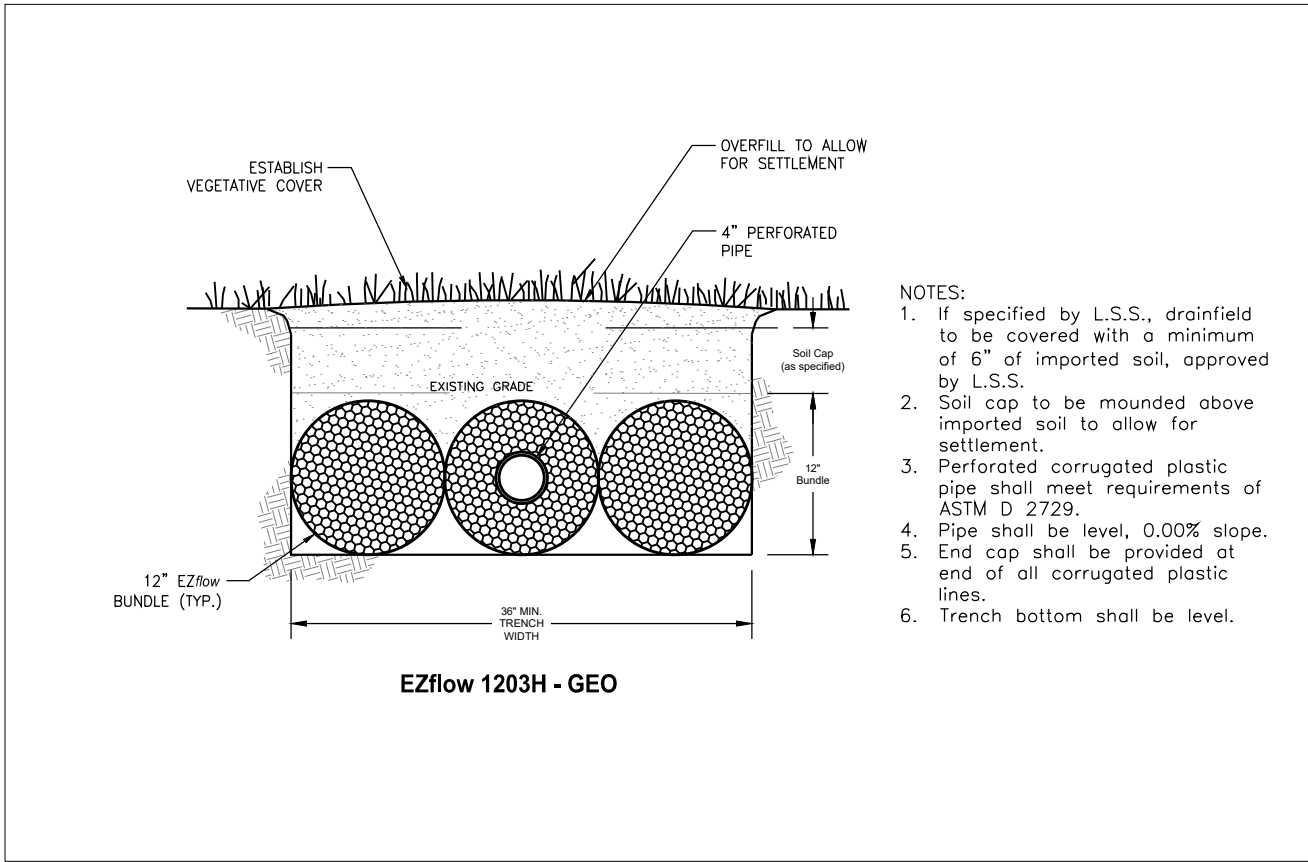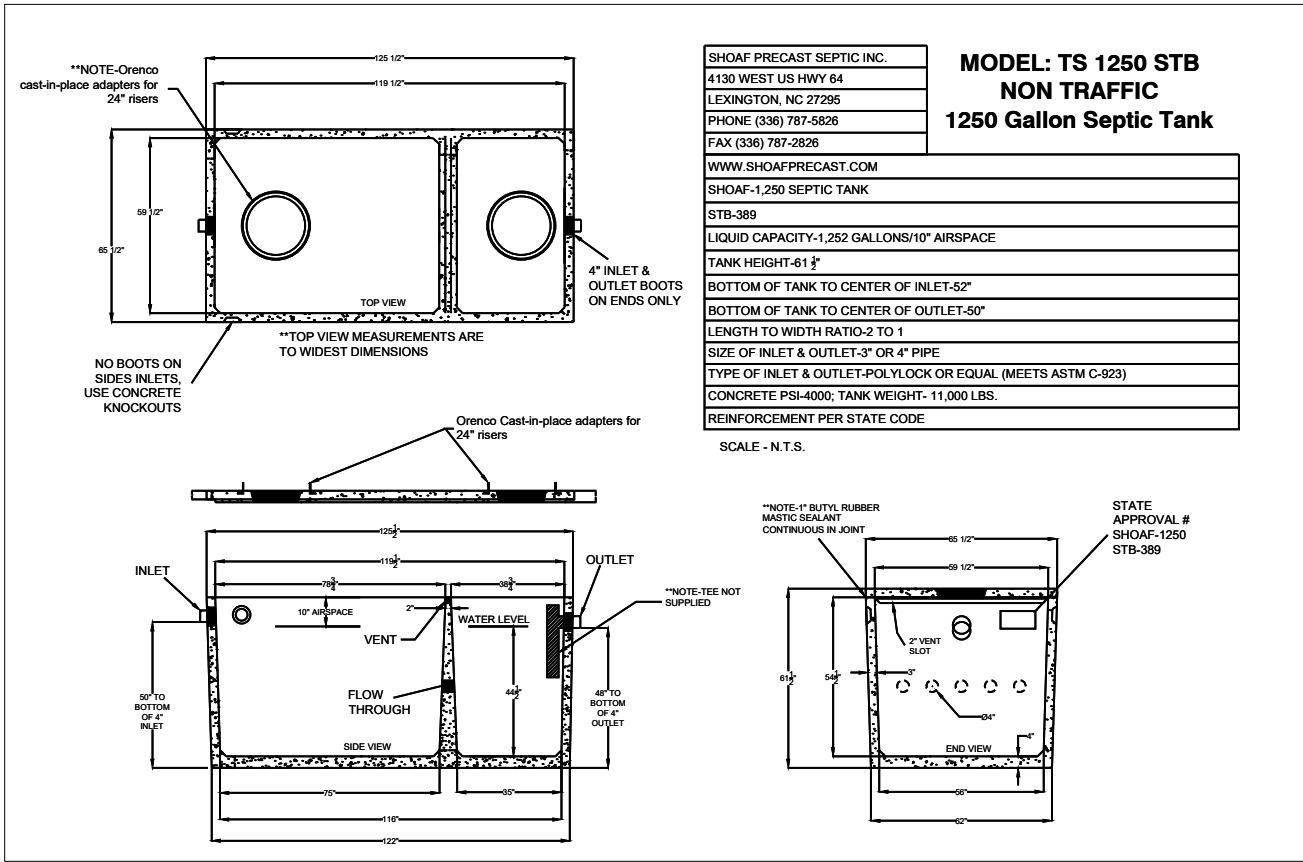

- NOTES:
1. If specified by L.S.S., drainfield to be covered with a minimum of 6" of imported soil, approved by L.S.S.
 2. Soil cap to be mounded above imported soil to allow for settlement.
 3. Perforated corrugated plastic pipe shall meet requirements of ASTM D 2729.
 4. Pipe shall be level, 0.00% slope.
 5. End cap shall be provided at end of all corrugated plastic lines.
 6. Trench bottom shall be level.

1 **Septic Tank**
 WW-4 SOURCE: Shoaf Precast Septic, Inc.

2 **EZ Flow - Trench Cross-Section (Typical)**
 WW-4 INFILTRATOR Water Technologies, LLC

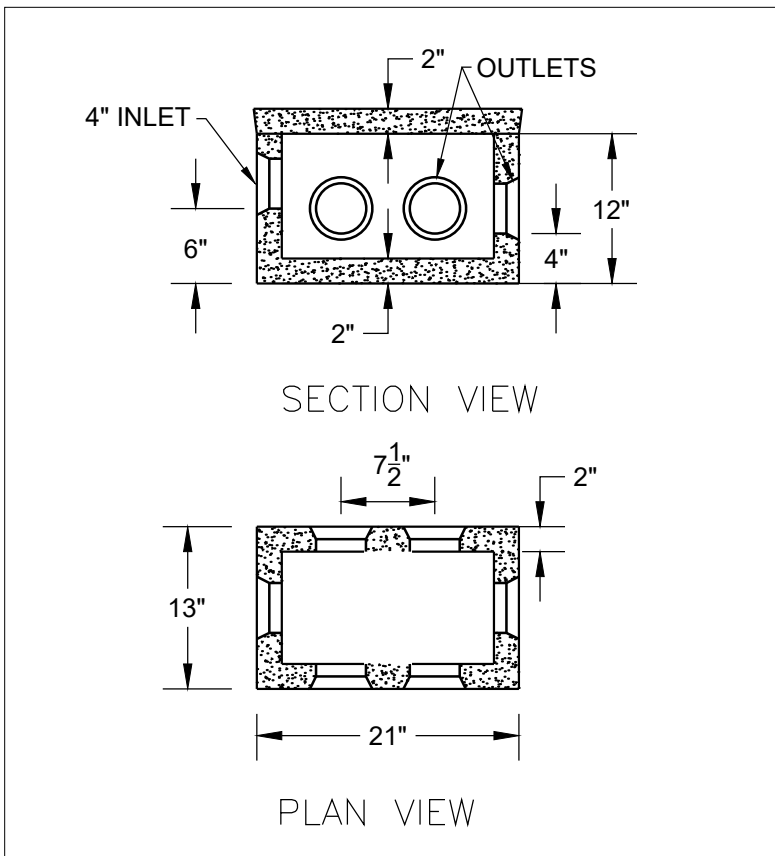

3 **Distribution Box**
 WW-4

- NOTES**
1. Installation to follow all NC DHHS and Harnett County applicable rules and regulations.
 2. AWT to perform construction inspections and final system certification.
 3. Septic Tank to have approved effluent filter.
 4. Contractor to abide by all safety regulations during system installation.
 5. Contractor shall backfill around all access areas such that storm water is shed away from potential entry points.
 6. Invert elevations of all components to be verified in field by contractor to insure proper operation.
 7. All system piping to be SCH40 PVC (except where noted).
 8. All gravity elbows to be long radius or long sweeping type elbows.
 9. Actual installation and placement of treatment system to be overseen by Contractor.
 10. Tank hole to be compacted with tamping machine.
 11. Contractor to seed and/or mulch disturbed areas to coincide

- with existing landscape. Area shall not be left with uncovered soil.
12. All risers to have cast-in-place tank adapters and be single-piece riser. Risers to extend 6" above soil surface and be designed to prevent surface water inflow.
13. Backfill around tank(s) shall be gravel or tank hole shall be over-excavated a minimum of 2' in all directions to allow for mechanical tamping of backfill.
14. All penetrations to be sealed.
15. Contractor to adjust tank placement to meet site constraints.

RiverWILD Homes
 AOWE - AF3
 Project Location:
 98 Beebalm Run
 Dunn, NC 27334
 Harnett County
 PIN: 1509-11-6927
 Project Owner:
 RiverWILD Homes
 114 W Main St
 Clayton, NC 27520
 919-373-6048
 kelley@staywild.com

NC ONSITE WASTEWATER
 EVALUATOR SEAL



| REV. | ISSUED DATE | DESCRIPTION |
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SHEET TITLE
 Detail Sheet

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|------------------------|---------------------------|
| DRAWN BY: T. Bostic | CREATED ON: 10/27/2025 |
| REVISED BY: #### | REVISED ON: #### |
| RELEASED BY: #### | RELEASED ON: #### |

DRAWING NUMBER
WW-4