

Guilford French Country

Trademark Series

Lot: 60 | Duncans Creek 492 Beacon Hill Road Lillington, NC 27546

| | 1ST FLOOR AREA | | BUILDING CODES | | OPTIONS | | SHEET INDEX |
|------------------|----------------|------------|----------------------------------|--|------------------------------|--------|---|
| | | ODES | BUILDING C | SELECTION | OPTION SET | Number | Name |
| | | | | 4 2x 42 Shower & Shower Seat | Owner's Bath Shower | G-100 | Cover Sheet |
| | | | | Add Cafe Room | Cafe Room | G-110 | General Notes & Specifications Instance |
| | | | | Additional 28/ 68 Door | Entry Hall Opening (Level 2) | A-100 | Foundation Plan |
| ESCE | | | | Additional Window | Cafe Windows | A-110 | First Floor Plan |
| | | | | Bed 3 to Bath 2 | Bed 3 to Bath 2 | A-120 | Second Floor Plan |
| | | | | Connected Laundry Door to Owner 's Suite | Laundry Room Access | A-200 | Roof Plan |
| | | | | Covered Patio | Rear Addition | A-310 | Elevations - Front and Back |
| | | | | Crawlspace | ~Foundation Type | A-320 | Elevations - Left and Right |
| | | | | French Country | Elevation | E-110 | First Floor Electrical Plan |
| 2 1 EV.# | | | BUILDING INFO | French Country A | Second Floor Plan | E-120 | Second Floor Electrical Plan |
| | | | | Gas Range | Kitchen Range | P-100 | Perspectives |
| | | | | Gourmet Kitchen | Kitchen Type | | |
| | | | CONDITIONED AREA | Messy Kitchen & Pocket Office | Bedroom 2 Optionals | | |
| | | 2523 SF | TOTAL CONDITIONED AREA | Messy Kitchen Sink | Messy Kitchen Sink | | |
| | | 1663 SF | TOTAL CONDITIONED AREA - Level 1 | Messy Kitchen Window | Messy Kitchen Window | | |
| l y e | | 860 SF | TOTAL CONDITIONED AREA - Level 2 | Pocket Door | Messy Kitchen Door | | |
| 5 | | | | Rear Fireplace | Living Room Fireplace | | |
| Suc | 2ND FLOOR AREA | | | Smart Door Delivery Center | Smart Door Delivery Center | | |
| | ı <u>1</u> | | UNCONDITIONED AREA | | | | |
| at O | | 675 SF | TOTAL UNCONDITIONED AREA | | | | |
| 7 | | 394 SF | Garage Area | | | | |
| <u>'</u> Ui ic | | 193 SF | Covered Patio Area | | | | |
| nch Cc | | 27 SF | Front Porch Area | | | | |
| ford Fre | | | TOTAL AREA | | | | |
| Gui. | | TOTAL AREA | TYPE | | | | |
| <u> </u> | | 2523 SF | TOTAL CONDITIONED AREA | | | | |
| | | 675 SF | TOTAL UNCONDITIONED AREA | | | | |
| | | 3198 SF | TOTAL UNDER ROOF | | | | |
| 1 | | | | | | | |
| | | | | | | | |
| G | | | | | | | |

MONIC.

New Home Inc 1611 Jones Franklin, Raleigh, NC, 27606

(c) 2025 New Home Inc

GENERAL NOTES AND SPECIFICATIONS:

1 GENERAL DATA

PROJECT DESCRIPTION:

THIS PROJECT IS FOR THE CONSTRUCTION OF A NEW SINGLE-FAMILY RESIDENCE, AND ASSOCIATED SITE WORK.

TYPICAL NOTES:

ALL WORK TO BE COORDINATED AND SCHEDULED BY THE OWNER.

ALL WORK, INCLUDING PLUMBING, HVAC AND ELECTRICAL WORK NOT DETAILED HEREIN, SHALL COMPLY WITH APPLICABLE STATE AND LOCAL BUILDING CODES AND THE BUILDING STANDARDS REFERENCED THEREIN.

ALL WORK SHALL CONFORM TO THE HIGHEST LEVELS OF THE APPROPRIATE INDUSTRY STANDARDS FOR CUSTOM WORK.

ALL ITEMS SPECIFIED HEREIN ARE TO BE USED WITHOUT SUBSTITUTION. IF THESE NOTES CONFLICT WITH THE OWNERS SCOPE OF WORK DOCUMENTS, THE NOTES HEREIN SHALL GOVERN AND TAKE PRECEDENT.

THE STRUCTURE IS DESIGNED TO BE SELF-SUPPORTING AND STABLE AFTER THE BUILDING IS FULLY COMPLETE. IT IS SOLELY THE CONTRACTORS RESPONSIBILITY TO ENSURE THE SAFETY OF THE BUILDING AND ITS COMPONENT PARTS DURING ERECTION. THIS INCLUDES THE ADDITION OF TEMPORARY BRACING THAT MAY BE REQUIRED.

IT IS SOLELY THE CONTRACTOR'S RESPONSIBILITY TO FOLLOW ALL APPLICABLE SAFETY CODES AND REGULATIONS DURING ALL PHASES OF CONSTRUCTION.

PLAN DIMENSIONS ARE TO FACE OF ROUGH FRAMING OR MASONRY UNLESS NOTED OTHERWISE. DIMENSIONS TO EXTERIOR WALLS INCLUDE 7/16" OSB WALL SHEATHING WITH WATER-RESISTIVE BARRIER, ROUNDED TO THE NEAREST 1/4".

FINISH FLOOR ELEVATION @ FIRST FLOOR LEVEL IS SET AT 0'-0". SEE SITE PLAN FOR ACTUAL FIRST FLOOR ELEVATION @ EACH BUILDING.

ALL @ INTERIOR PARTITIONS SHALL BE 2x4 STUDS @ 16" O.C. WITH 1/2" DRYWALL EACH SIDE. PLAN DIMENSION IS ASSUMED TO BE 3 1/2" UNLESS NOTED OTHERWISE. PROVIDE SOLID LUMBER BLOCKING FOR ALL WALL MOUNTED ITEMS.

SUBSTRATE (BACKER) FOR TILE IN SHOWERS/TUBS SHALL BE FIBER-CEMENT OR SIMILAR PER APPLICABLE CODE.

ALL INTERIOR COLORS AND FINISHES, NOT SPECIFIED HEREIN, TO BE SELECTED BY THE OWNER.

CONTRACTOR OR EXCAVATOR MUST CONTACT THE APPROPRIATE UTILITIES PROTECTION SERVICE AT LEAST 48 HOURS BUT NO MORE THAN 10 WORKING DAYS BEFORE BEGINNING ANY DIGGING PROJECT.

SOILS BEARING PRESSURE AS INDICATED ON THE STRUCTURAL ENGINEERING PLANS BY OTHER.

3 CONCRETE

REFER TO STRUCTURAL ENGINEERING PLANS BY OTHER.

SEE OWNER SCOPE OF WORK DOCUMENTS FOR ADDITIONAL REQUIREMENTS.

4 MASONRY

STONE /ENEER IF USED) TO BE MANUFACTURED STONE - REFER TO OWNERS SCOPE OF WORK DOCUMENT FOR MATERIAL SELECTION AND COLORS.

BRICK ACCENTS (IF USED) TO BE FULL SIZE UNITS, CUT TO THICKNESS OR SHAPE REQUIRED FOR THE SPECIFIC USE. REFER TO THE OWNERS SCOPE OF WORK DOCUMENT FOR MATERIAL SELECTION AND COLORS.

5 METALS

REFER TO STRUCTURAL ENGINEERING PLANS BY OTHER.

6 WOOD & PLASTICS

PROVIDE SOLID BLOCKING FOR ALL WALL MOUNTED ITEMS INCLUDING:

CABINETS & SHELVES

CLOSET RODS

• MIRRORS AND BATH ACCESSORIES

FRAMING LUMBER IN CONTACT WITH CONCRETE OR MASONRY OR EXPOSED TO THE EXTERIOR SHALL BE PRESERVATIVE PRESSURE TREATED. ANY WOOD, INCLUDING EXTERIOR SHEATHING. WITHIN 6" OF FINISHED GRADE SHALL BE PRESERVATIVE-PRESSURE TREATED.

ANY WOOD, INCLUDING EXTERIOR WALL SHEATHING, LESS THAN 2" VERTICALLY FROM CONCRETE STEPS, PORCH SLABS, PATIO SLABS AND SIMILAR HARD HORIZONTAL SURFACES SHALL BE PRESERVATIVE PRESSURE TREATED.

PROTECTION OF WOOD AND WOOD-BASED PRODUCTS AGAINST DECAY AS REQUIRED BY R317. PROTECTION AGAINST TERMITES AS REQUIRED BY R318.

FIRE BLOCKING TO COMPLY WITH R302.11.

REFER TO STRUCTURAL ENGINEERING PLANS BY OTHER.

CABINETS AND COUNTERTOPS

REFER TO OWNERS SCOPE OF WORK DOCUMENTS FOR CABINET, COUNTERTOP AND HARDWARE

INTERIOR TRIM

OF REFER TO OWNERS SCOPE OF WORK DOCUMENTS FOR REQUIRED INTERIOR TRIM PROFILES.

7 THERMAL & MOISTURE PROTECTION

WATER BARRIER THE WATER BARRIER SYSTEM IS AN INTEGRAL PART OF THE WALL SHEATHING

THERMAL INSULATION

• INSULATION TO HAVE THE FOLLOWING MINIMUM R-VALUES:

• EXTERIOR WALLS R=15 MIN.

• SLOPED CEILINGS (WITH ATTIC SPACE) R=38 OR R=30 WHEREVER THE FULL HEIGHT OF UNCOMPRESSED R=38 INSULATION EXTENDS OVER THE WALL TOP PLATE AT THE EAVES. • SLOPED CEILINGS (WITHOUT ATTIC SPACE) R=38 MIN., OR R=30 MIN. WHERE THERE IS NOT SUFFICIENT SPACE FOR REQ'D INSULATION.

• FLAT CEILINGS (WITH ATTIC SPACE) R=38 OR R=30 WHEREVER THE FULL HEIGHT OF UNCOMPRESSED R=38 INSULATION EXTENDS OVER THE WALL TOP PLATE AT THE EAVES.

• REFER TO OWNERS SCOPE OF WORK DOCUMENTS FOR INSULATION TYPES AND ADDITIONAL REQUIREMENTS.

ARCHITECTURAL SHINGLE ROOFING - SHINGLE ROOFING SHALL BE DIMENSIONAL ASPHALT TYPE WITH DIMENSION FEATURES. SEE OWNERS SCOPE OF WORK DOCUMENTS FOR MANUFACTURER, STYLE, COLOR AND ADDITIONAL REQUIREMENTS FOR INSTALLATION AND ACCESSORIES. • SHINGLES SHALL BE TESTED IN ACCORDANCE WITH AST D 7185.

• SHINGLES SHALL MEET THE CLASSIFICATION REQUIREMENTS FOR THE APPROPRIATE MAXIMUM BASIC WIND SPEED:

MAXIMUM BASIC WIND SPEED CLASSIFICATION REQUIREMENT • REFER TO STRUCTURAL ENGINEERING PLANS BY OTHER.

 ROOFING SHALL BE INSTALLED OVER ONE LAYER OF ASPHALT IMPREGNATED 15# ROOFING FELT. 2 LAYERS FOR ROOF PITCHES 2:12 - 4:12.

VALLEY LININGS TO BE INSTALLED PER R905.2.8.2

GUTTERS TO BE MINIMUM 5" ALUMINUM OGEE STYLE WITH 4" CORRUGATED RECTANGULAR ALUMINUM DOWNSPOUTS AT LOCATIONS AS INDICATED ON THE DRAWINGS.

DOWNSPOUTS TO BE CONNECTED TO UNDERGROUND STORM PIPING AND ROUTED TO DISCHARGE LOCATIONS AS SPECIFIED BY THE GENERAL CONTRACTOR. 12" WIDE (2" THICKNESS) RIGID FOAM LOCATED AT TOP OF FOOTER, SLOPING AWAY FROM THE UNIT TO PREVENT CONCRETE OVERFLOW AND ALLOW PIPE TO TIGHTLY FIT TO STEM WALL.

UNDERGROUND DRAINPIPES TO BE PROVIDED AT ALL COURTYARD SLAB CUTOUT LANDSCAPE AREAS TO PREVENT POOLING WATER.

LAP SIDING - REFER TO OWNERS SCOPE OF WORK DOCUMENTS FOR MATERIAL, MANUFACTURER. STYLE, COLOR AND OTHER REQUIREMENTS.

EXTERIOR TRIM & SOFFITS - REFER TO OWNERS SCOPE OF WORK DOCUMENTS FOR MATERIAL, MANUFACTURER, STYLE, COLOR AND OTHER REQUIREMENTS.

PROVIDE EXTERIOR TRIM OF SIZES INDICATED ON THE DRAWINGS.

8 DOORS & WINDOWS

EXTERIOR PATIO DOORS AND SLIDING PATIO DOORS - REFER TO OWNERS SCOPE OF WORK DOCUMENTS FOR MANUFACTURER. STYLE COLOR AND HARDWARE SELECTIONS. SIZES AS INDICATED ON THE DRAWINGS

• ALL DOORS TO HAVE LOW-E GLASS SAFETY GLAZING.

INTERIOR DOORS - REFER TO OWNERS SCOPE OF WORK DOCUMENTS FOR DOOR TYPE, STYLE AND HARDWARE SELECTIONS.

SIZES AS INDICATED ON THE DRAWINGS.

WINDOWS - REFER TO OWNERS SCOPE OF WORK DOCUMENTS FOR WINDOW MANUFACTURER, STYLE, COLOR AND HARDWARE SELECTIONS.

SIZES AS INDICATED ON THE DRAWINGS.

• ALL WINDOWS TO HAVE LOW-E INSULATING GLASS

• WINDOW MANUFACTURER SHALL PROVIDE TEMPERED GLASS AS REQUIRED BY R308.4 AT ALL HAZARDOUS LOCATIONS.

• WINDOW FALL PROTECTION AS REQUIRED BY R312.2.

• WRITTEN INSTALLATION INSTRUCTIONS SHALL BE PROVIDED BY THE WINDOW MANUFACTURER FOR EACH WINDOW - SEE FULL INSTRUCTIONS FOR ALL ADDITIONAL REQUIREMENTS.

 ALL BEDROOM WINDOWS TO MEET EMERGENCY RESCUE OPENING CODE REQUIREMENTS. • WINDOW TRIM TO BE OFFSET MIN. 1/4" WHERE WINDOW MEETS TRIM FOR CAULKING. COORDINATE

WITH WINDOW SELECTION, PAD OUT THE TRIM IF NEEDED. • TRIM MATERIAL PER OWNERS SCOPE OF WORK DOCUMENTS. SIZES AS INDICATED ON THE DRAWINGS.

• SEE CURRENT BUILDING CODE FOR ALL ADDITIONAL REQUIREMENTS.

9 FINISHES

DRYWALL WALLS AND CEILINGS- REFER TO OWNERS SCOPE OF WORK DOCUMENTS FOR REQUIRED DRYWALL FINISHES.

• PROVIDE TYPE-X GYPSUM PANELS AT LOCATIONS INDICATED ON THE DRAWINGS FOR FIRE-RATED ASSEMBLIES.

• ALL BATHROOMS TO HAVE MOISTURE-RESISTANT, PAPERLESS GYPSUM. • PROVIDE 1/2" TILE BACKER BOARD IN LIEU OF DRYWALL AT ALL WALL LOCATIONS REQUIRING A TILE FINISH.

INTERIOR FINISHES - REFER TO OWNERS SCOPE OF WORK DOCUMENTS FOR ALL INTERIOR FLOOR, WALL AND CEILING FINISHES.

10 SPECIALTIES

BATH ACCESSORIES - REFER TO OWNERS SCOPE OF WORK DOCUMENTS FOR REQUIRED BATH

FIREPLACE - REFER TO OWNERS SCOPE OF WORK DOCUMENTS FOR FIREPLACE REQUIREMENT AND SELECTIONS.

CLOSET ROODS AND SHELVING - REFER TO OWNERS SCOPE OF WORK DOCUMENTS FOR REQUIREMENTS AND SELECTIONS.

11 EQUIPMENT

APPLIANCES - REFER TO OWNERS SCOPE OF WORK DOCUMENTS FOR APPLIANCE SELECTIONS.

12 FURNISHINGS SECTION NOT USED

13 SPECIAL CONSTRUCTION **SECTION NOT USED**

14 CONVEYING SYSTEMS

SECTION NOT USED

22 PLUMBING REFER TO PLUMBING PLANS BY OTHERS.

REFER TO HVAC PLANS BY OTHERS.

26 ELECTRICAL REFER TO ELECTRICAL PLANS BY OTHERS.



New Home Inc 1611 Jones Franklin, Raleigh, NC, 27606

| DATE | | | | | | | | | |
|-------------|---|---|---|---|---|---|---|---|---|
| DESCRIPTION | | | | | | | | | |
| REV.# | 1 | 2 | 3 | - | 4 | 5 | 9 | 2 | 0 |
| | | ~ | | | | | | | |

Specifications and eneral ot

ပ်

JJ/DREW

RIGHT ISSUE DATE: JJ/DREW

(c) 2025 New Home Inc

GENERAL FLOOR PLAN NOTES:

General Floor Plan Notes shall apply unless noted otherwise on plan.

1. Wall Heights: Typically 9'-1 1/2" at first floor and second floor, and 9'-1 1/2" at attics U.N.O. All walls are constructed using a double top plate. Splices at Double Top Plate do not need to occur at Vertical Studs but must be at least 24" apart from Joint in other Top Plate layer. Special wall heights are noted on plans where they occur.

2. Wall Thickness is typically 3 1/2". 2x6 frame shall be used at walls that back up to plumbing fixtures. Walls greater than 10' high shall be framed with 2x6 framing or greater and will be noted as a special condition where it occurs on plan.

3. Typical header height shall be 7'-8" AFF at First Floor, and 7'-4" AFF at Second Floor U.N.O.

4. Jacks: Openings up to 3'-4" wide shall have (1) 2x4 jack stud SPF on each side. Openings greater than 3'-4" wide shall have (2) 2x4 jack studs SPF on each

5. Soffits, Coffered Ceilings, Trey Ceilings and other significant ceiling plan elements are shown on the floor plans and are denoted as single dashed lines. Unless specifically call out as included, Kitchens include soffits over wall cabinetry.

6. Door & Window Frames, where occurring near corners, shall be a minimum of 4 1/2" from corner. Except for walk-in closets with doors near a corner, doors at closets shall be centered on closet.

7. Windows: Shall have at least (1) window in each sleeping room, that meets egress. Shall be provided with tempered glass at hazardous glazing areas. False windows shall be installed with obscure

8. Closets for clothing or coat storage shall be equipped with 1 rod/shelf. Closets for linen shall have 4 open equal shelves. Closets for pantries shall have 4 equal wood shelves, painted.


9. Stair treads shall be a min of 9" deep, risers shall be a maximum of 8 1/4", unless noted otherwise, per the current North Carolina Residential Code.

10. Handrails and Guards at stairs shall be 34" above the finished surface of the ramp surface of the stair. Handrails at landings and overlooks of multilevel spaces shall be 36" above finished floor. Guards (pickets or balusters) shall be spaced with no more than 4" between guards.

11. Attic Access shall be provided at all attic area with a height greater than 30". Minimum clear attic access shall be 20" x 30". Pull down stairs and access doors in knee walls meeting minimum criteria are also acceptable.

12. Garage Door to Living Space shall be 2'-8" x 6'-8" minimum size and shall be 20 minute fire rated and

13. Garage Walls, as a minimum, shall be separated from living space by installing 1/2" gypsum board on the garage side of the wall. With habitable space above, the inside of all garage walls require 1/2" GWB supporting 5/8" type X GWB on ceiling.

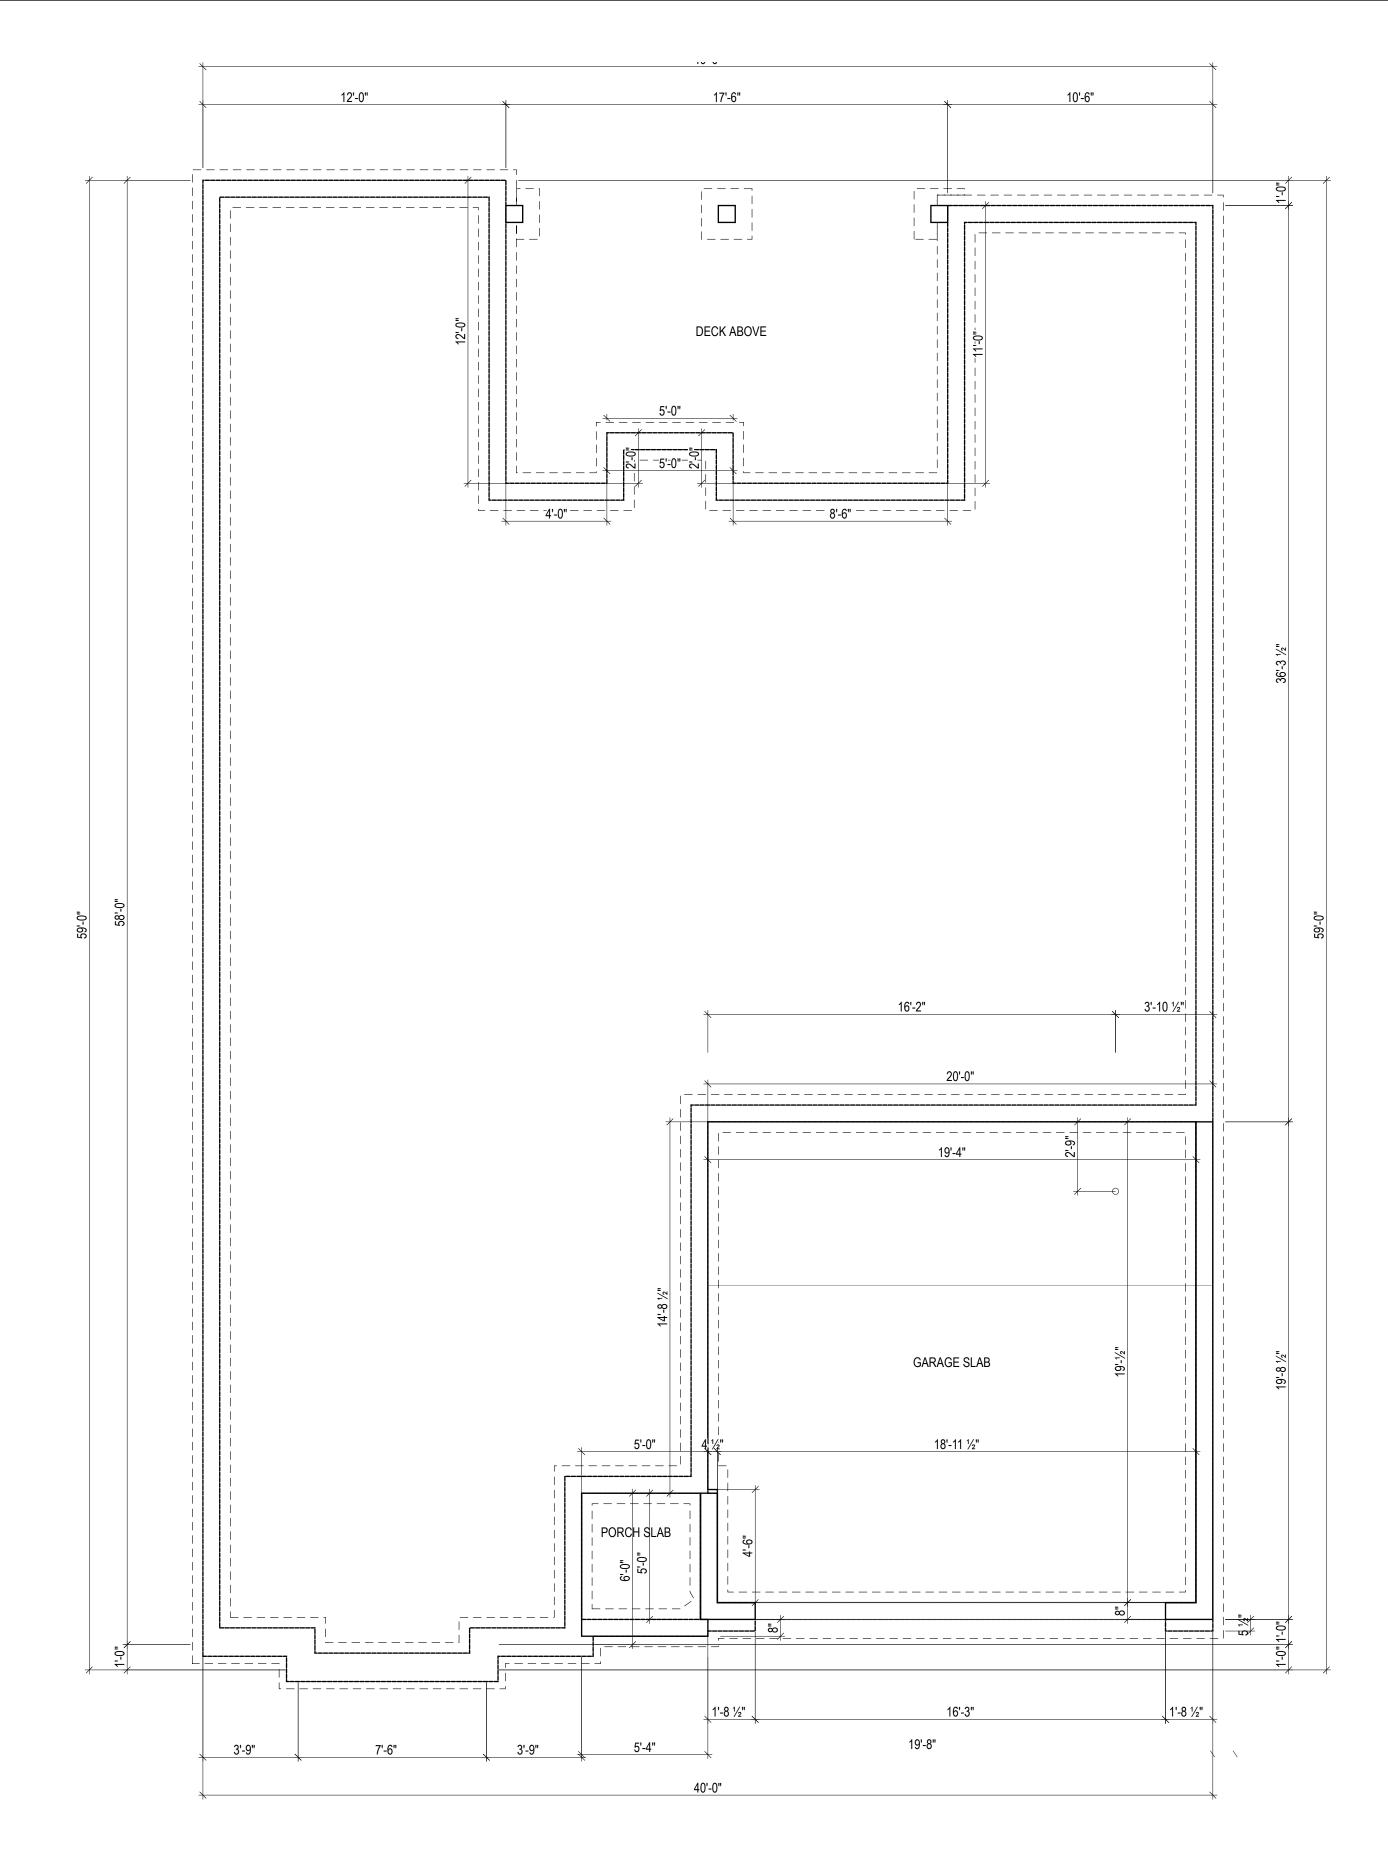

FOUNDATION PLAN - Crawlspace 1/4" = 1'-0" (WHEN PRINTED ON 22x34) 1/8" = 1'-0" (WHEN PRINTED ON 11x17)

(c) 2025 New Home Inc

| HOME MOHC |
|--------------|
| New Home Inc |

1611 Jones Franklin, Raleigh, NC, 27606

Lot 60: Guilford French Country at Duncans Creek FOUNDATION PLAN

JJ/DREW

RIGHT

11/11/1111

GENERAL FLOOR PLAN NOTES:

General Floor Plan Notes shall apply unless noted otherwise on plan.

1. Wall Heights: Typically 9'-1 1/2" at first floor and second floor, and 9'-1 1/2" at attics U.N.O. All walls are constructed using a double top plate. Splices at Double Top Plate do not need to occur at Vertical Studs but must be at least 24" apart from Joint in other Top Plate layer. Special wall heights are noted on plans where they occur.

2. Wall Thickness is typically 3 1/2". 2x6 frame shall be used at walls that back up to plumbing fixtures. Walls greater than 10' high shall be framed with 2x6 framing or greater and will be noted as a special condition where it occurs on plan.

3. Typical header height shall be 7'-8" AFF at First Floor, and 7'-4" AFF at Second Floor U.N.O.

4. Jacks: Openings up to 3'-4" wide shall have (1) 2x4 jack stud SPF on each side. Openings greater than 3'-4" wide shall have (2) 2x4 jack studs SPF on each

5. Soffits, Coffered Ceilings, Trey Ceilings and other significant ceiling plan elements are shown on the floor plans and are denoted as single dashed lines. Unless specifically call out as included, Kitchens include soffits over wall cabinetry.

6. Door & Window Frames, where occurring near corners, shall be a minimum of 4 1/2" from corner. Except for walk-in closets with doors near a corner, doors at closets shall be centered on closet.

7. Windows: Shall have at least (1) window in each sleeping room, that meets egress. Shall be provided with tempered glass at hazardous glazing areas. False windows shall be installed with obscure glazing.

8. Closets for clothing or coat storage shall be equipped with 1 rod/shelf. Closets for linen shall have 4 open equal shelves. Closets for pantries shall have 4 equal wood shelves, painted.


9. Stair treads shall be a min of 9" deep, risers shall be a maximum of 8 1/4", unless noted otherwise, per the current North Carolina Residential Code.

10. Handrails and Guards at stairs shall be 34" above the finished surface of the ramp surface of the stair. Handrails at landings and overlooks of multilevel spaces shall be 36" above finished floor. Guards (pickets or balusters) shall be spaced with no more than 4" between guards.

11. Attic Access shall be provided at all attic area with a height greater than 30". Minimum clear attic access shall be 20" x 30". Pull down stairs and access doors in knee walls meeting minimum criteria are also acceptable.

12. Garage Door to Living Space shall be 2'-8" x 6'-8" minimum size and shall be 20 minute fire rated and

13. Garage Walls, as a minimum, shall be separated from living space by installing 1/2" gypsum board on the garage side of the wall. With habitable space above, the inside of all garage walls require 1/2" GWB supporting 5/8" type X GWB on ceiling.

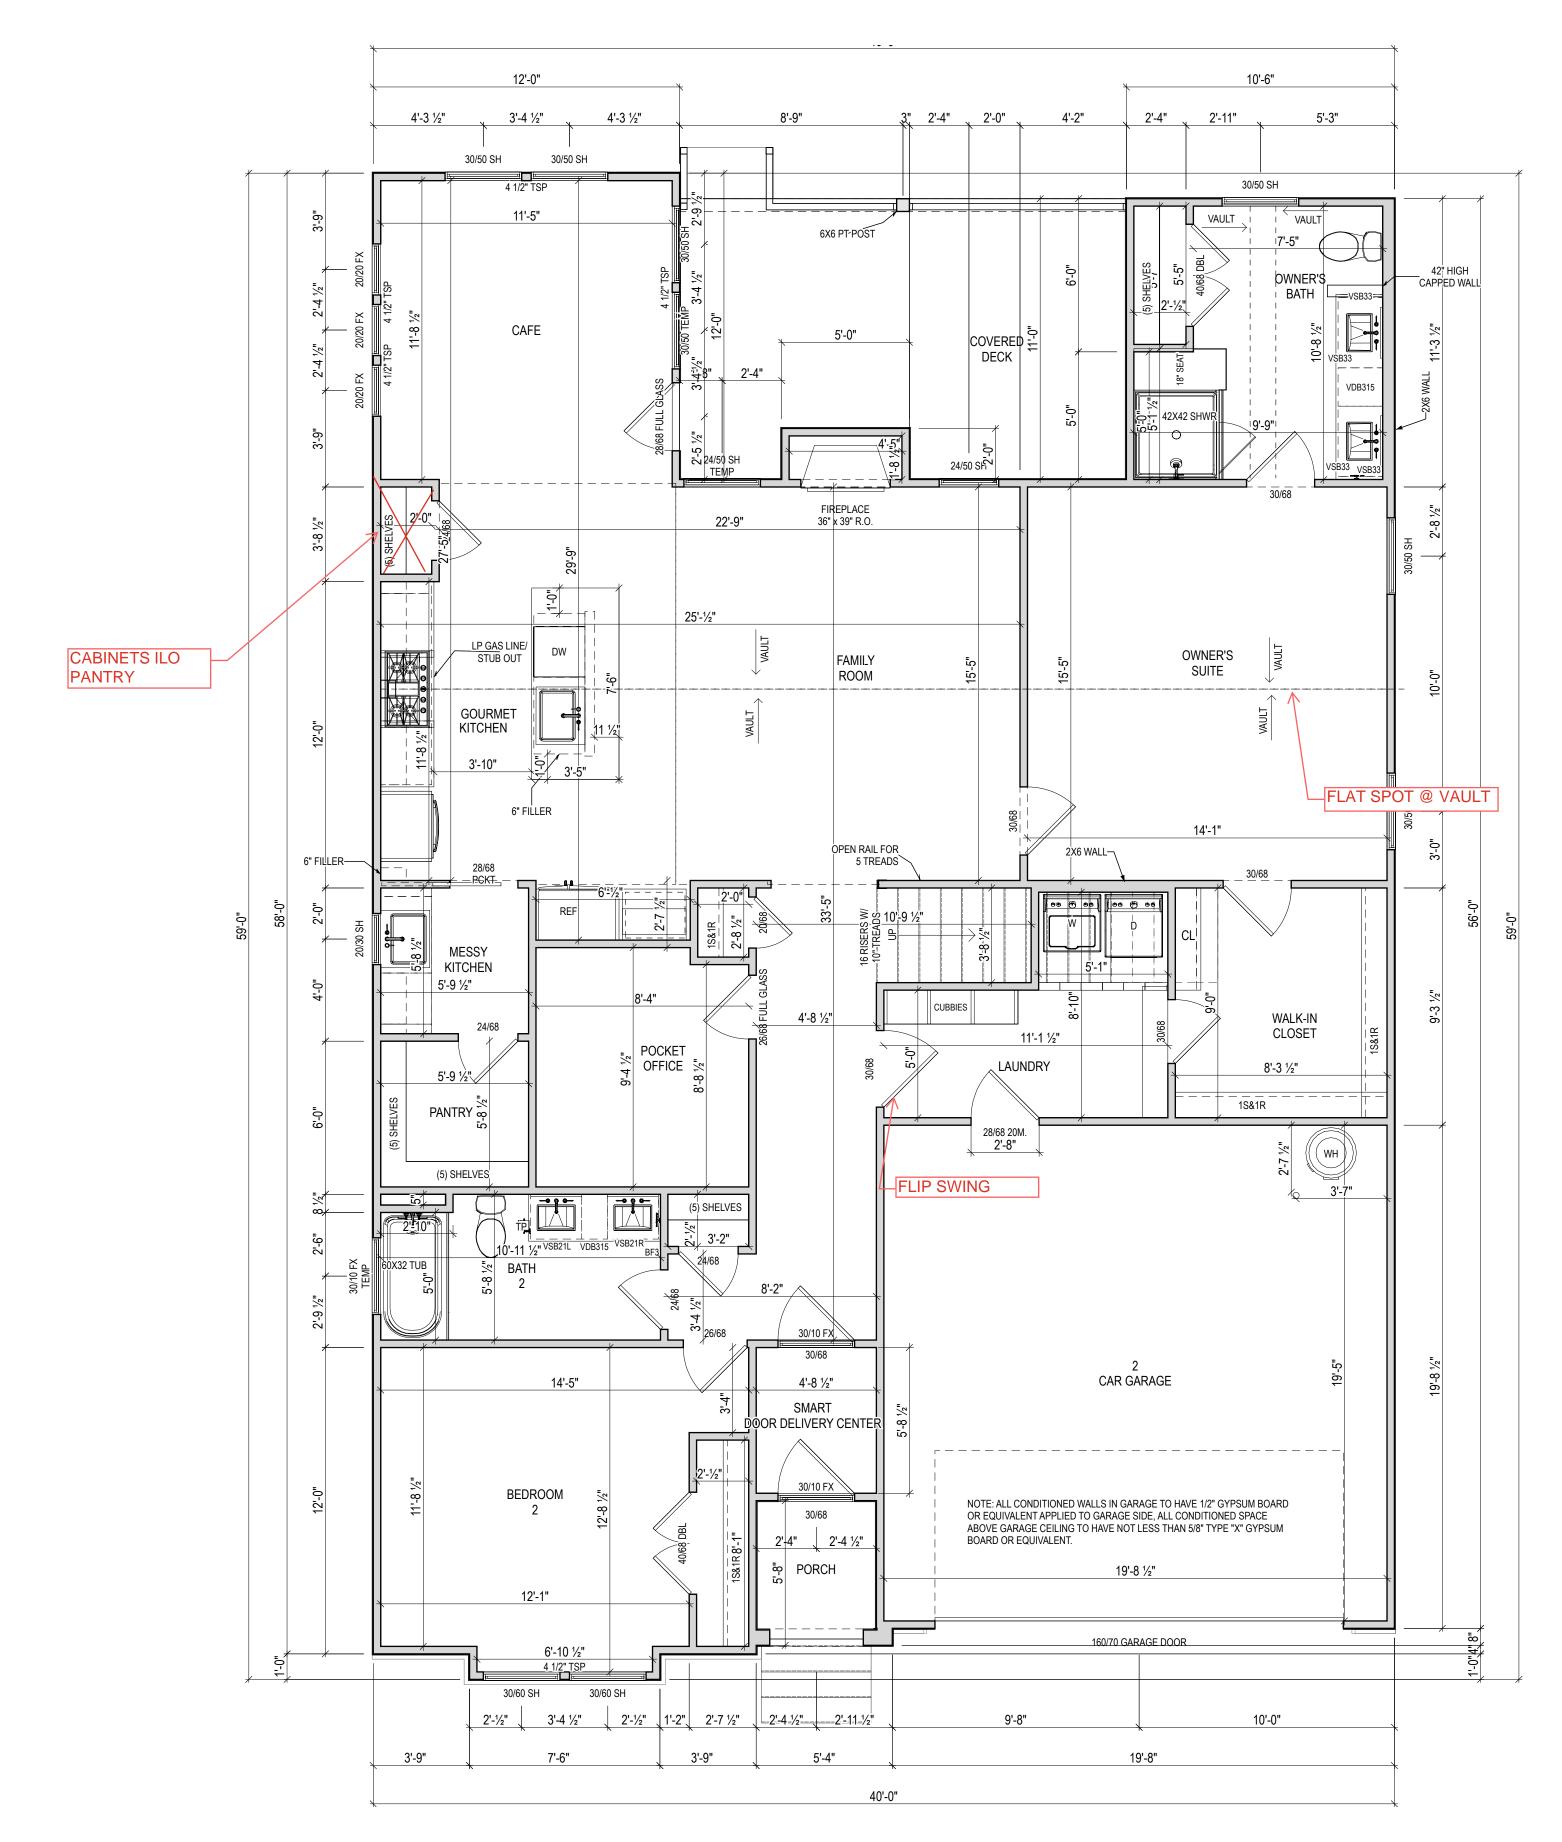

First Floor Plan

1/4" = 1'-0" (WHEN PRINTED ON 22x34) 1/8" = 1'-0" (WHEN PRINTED ON 11x17)

RIGHT

11/11/1111

New Home Inc

1611 Jones Franklin,


Raleigh, NC, 27606

Lot 60: Guilford French Country at Duncans

GENERAL FLOOR PLAN NOTES:

General Floor Plan Notes shall apply unless noted otherwise on plan.

- 1. Wall Heights: Typically 9'-1 1/2" at first floor and second floor, and 9'-1 1/2" at attics U.N.O. All walls are constructed using a double top plate. Splices at Double Top Plate do not need to occur at Vertical Studs but must be at least 24" apart from Joint in other Top Plate layer. Special wall heights are noted on plans where they occur.
- 2. Wall Thickness is typically 3 1/2". 2x6 frame shall be used at walls that back up to plumbing fixtures. Walls greater than 10' high shall be framed with 2x6 framing or greater and will be noted as a special condition where it occurs on plan.
- 3. Typical header height shall be 7'-8" AFF at First Floor, and 7'-4" AFF at Second Floor U.N.O.
- 4. Jacks: Openings up to 3'-4" wide shall have (1) 2x4 jack stud SPF on each side. Openings greater than 3'-4" wide shall have (2) 2x4 jack studs SPF on each
- Soffits, Coffered Ceilings, Trey Ceilings and other significant ceiling plan elements are shown on the floor plans and are denoted as single dashed lines. Unless specifically call out as included, Kitchens include soffits over wall cabinetry.
- 6. Door & Window Frames, where occurring near corners, shall be a minimum of 4 1/2" from corner. Except for walk-in closets with doors near a corner, doors at closets shall be centered on closet.
- 7. Windows: Shall have at least (1) window in each sleeping room, that meets egress. Shall be provided with tempered glass at hazardous glazing areas. False windows shall be installed with obscure glazing.
- 8. Closets for clothing or coat storage shall be equipped with 1 rod/shelf. Closets for linen shall have 4 open equal shelves. Closets for pantries shall have 4 equal wood shelves, painted.
- 9. Stair treads shall be a min of 9" deep, risers shall be a maximum of 8 1/4", unless noted otherwise, per the current North Carolina Residential Code.
- 10. Handrails and Guards at stairs shall be 34" above the finished surface of the ramp surface of the stair. Handrails at landings and overlooks of multilevel spaces shall be 36" above finished floor. Guards (pickets or balusters) shall be spaced with no more than 4" between guards.
- 11. Attic Access shall be provided at all attic area with a height greater than 30". Minimum clear attic access shall be 20" x 30". Pull down stairs and access doors in knee walls meeting minimum criteria are also acceptable.
- 12. Garage Door to Living Space shall be 2'-8" x 6'-8" minimum size and shall be 20 minute fire rated and weather sealed.
- 13. Garage Walls, as a minimum, shall be separated from living space by installing 1/2" gypsum board on the garage side of the wall. With habitable space above, the inside of all garage walls require 1/2" GWB supporting 5/8" type X GWB on ceiling.

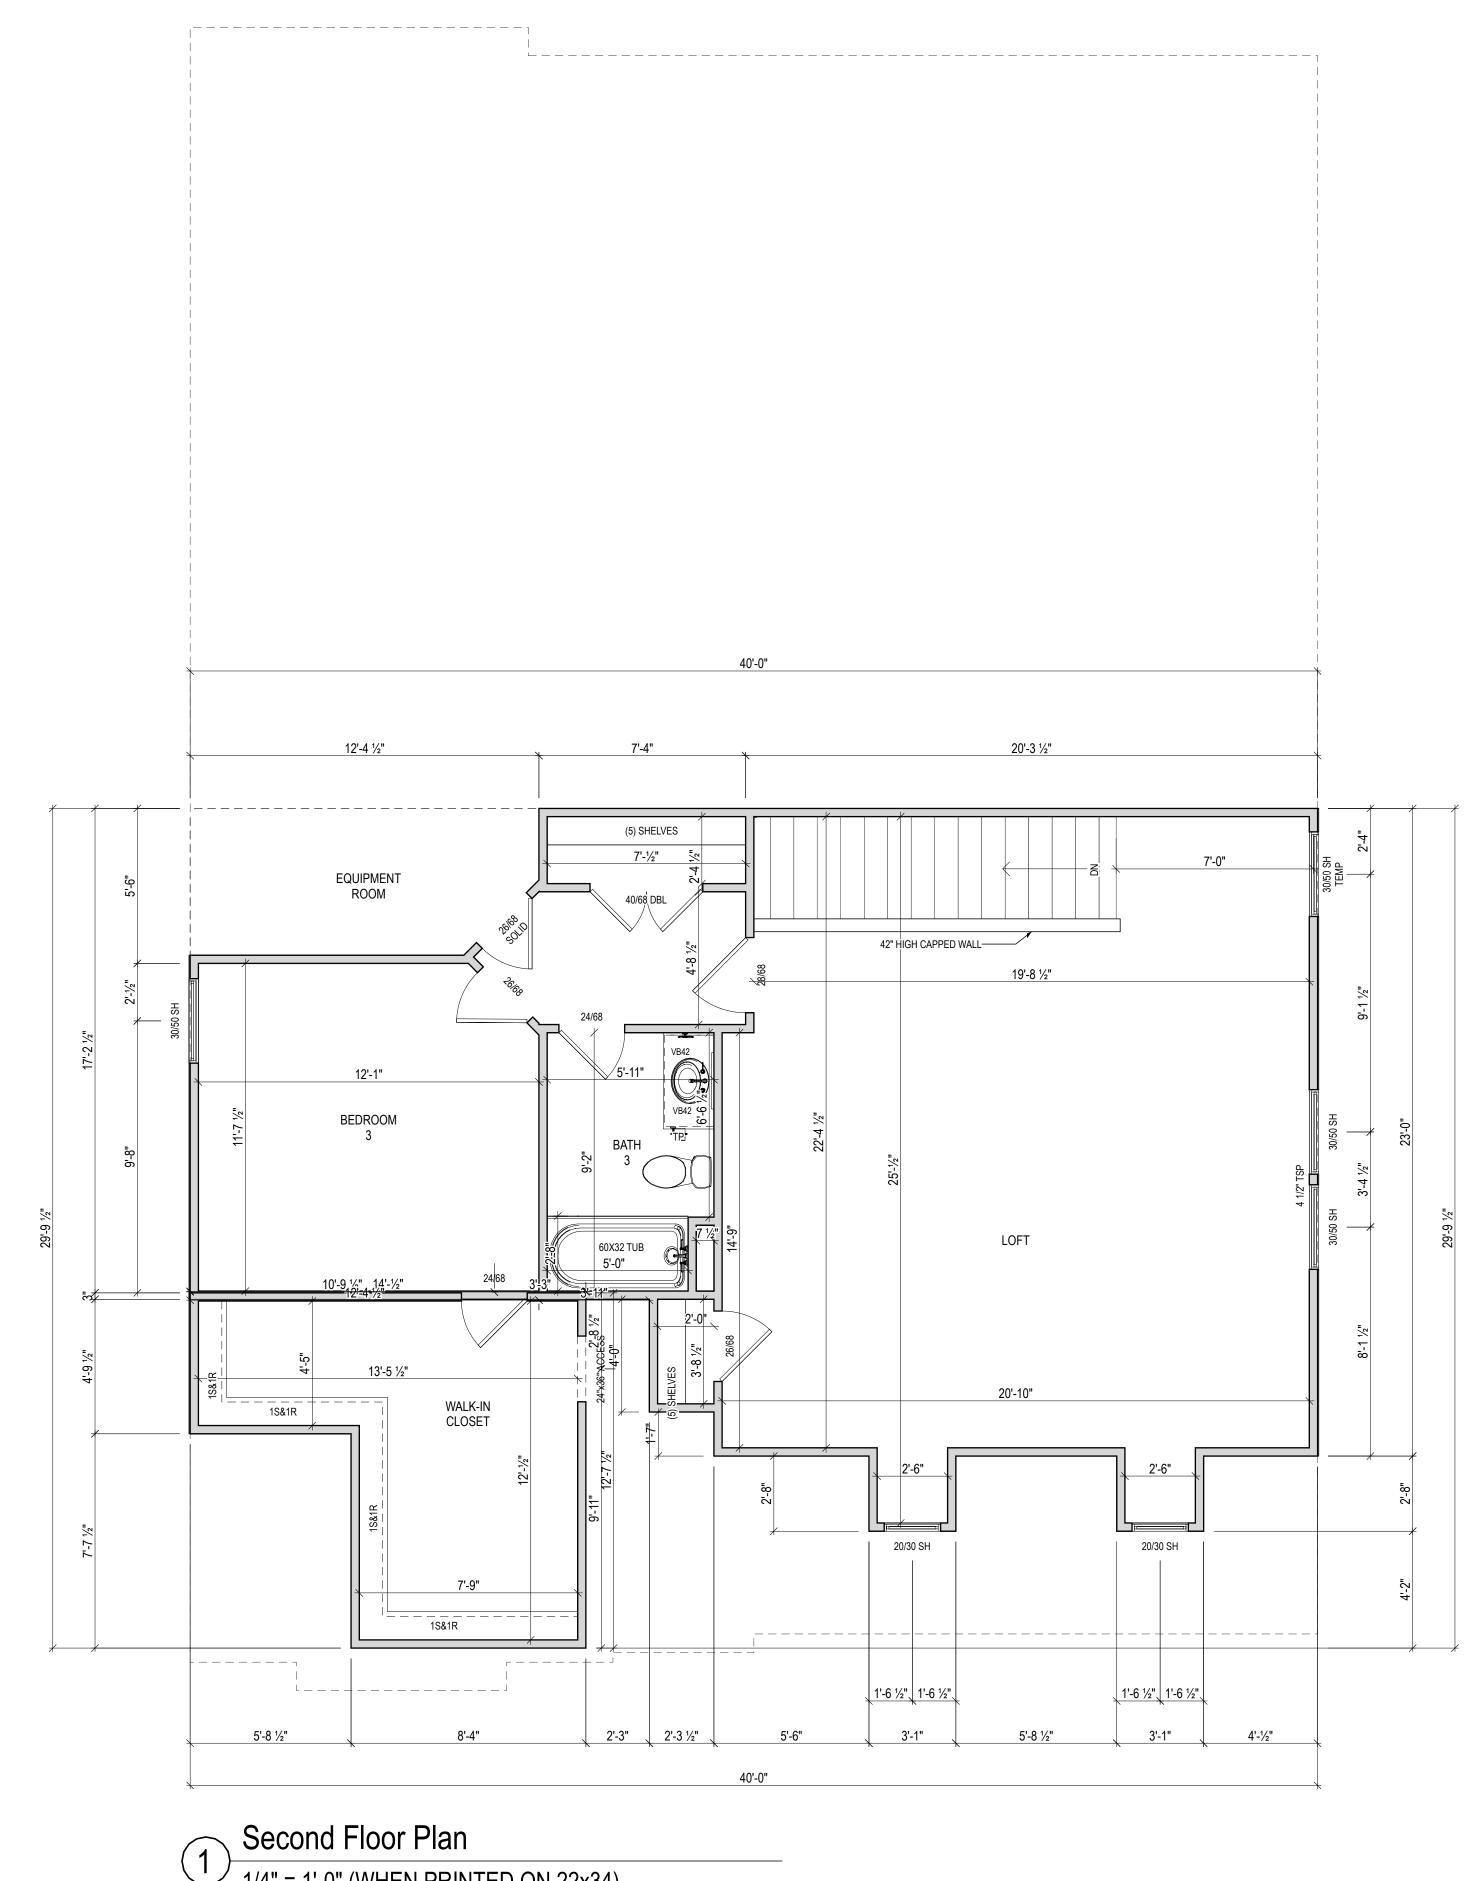

1/4" = 1'-0" (WHEN PRINTED ON 22x34) 1/8" = 1'-0" (WHEN PRINTED ON 11x17) MONIC.

New Home Inc

1611 Jones Franklin, Raleigh, NC, 27606

Lot 60: Guilford French Country at Duncans Second Floor Plan

DRAWN BY:

JJ/DREW

HANDING:
RIGHT
ISSUE DATE:

11/11/1111 SHEET

A-120

GENERAL ROOF PLAN NOTES:

1. ALL ROOF OVERHANGS TO BE 1'-0" UNLESS NOTED OTHERWISE


2. ALL TRAY CEILING TRAY HEIGHTS TO BE 12" UNLESS NOTED OTHERWISE

3. THESE PLANS ARE NOT TO BE SCALED FOR CONSTRUCTION PURPOSES.

4. IT IS THE CONTRACTOR'S RESPONSIBILITY TO VERIFY THE ACCURACY OF ALL DETAILS AND

DIMENSIONS.

5. 8'×16' ATTIC STORAGE
PLATFORM - PROVIDE 3/4" APA
RATED PLYWOOD SUB-FLOORING OR
OSB SHEATHING RATED FOR 20#/SF
ON BOTTOM CHORD OF TRUSSES.
TRUSS MANUFACTURER TO
ACCOUNT FOR ADDITIONAL LOADS

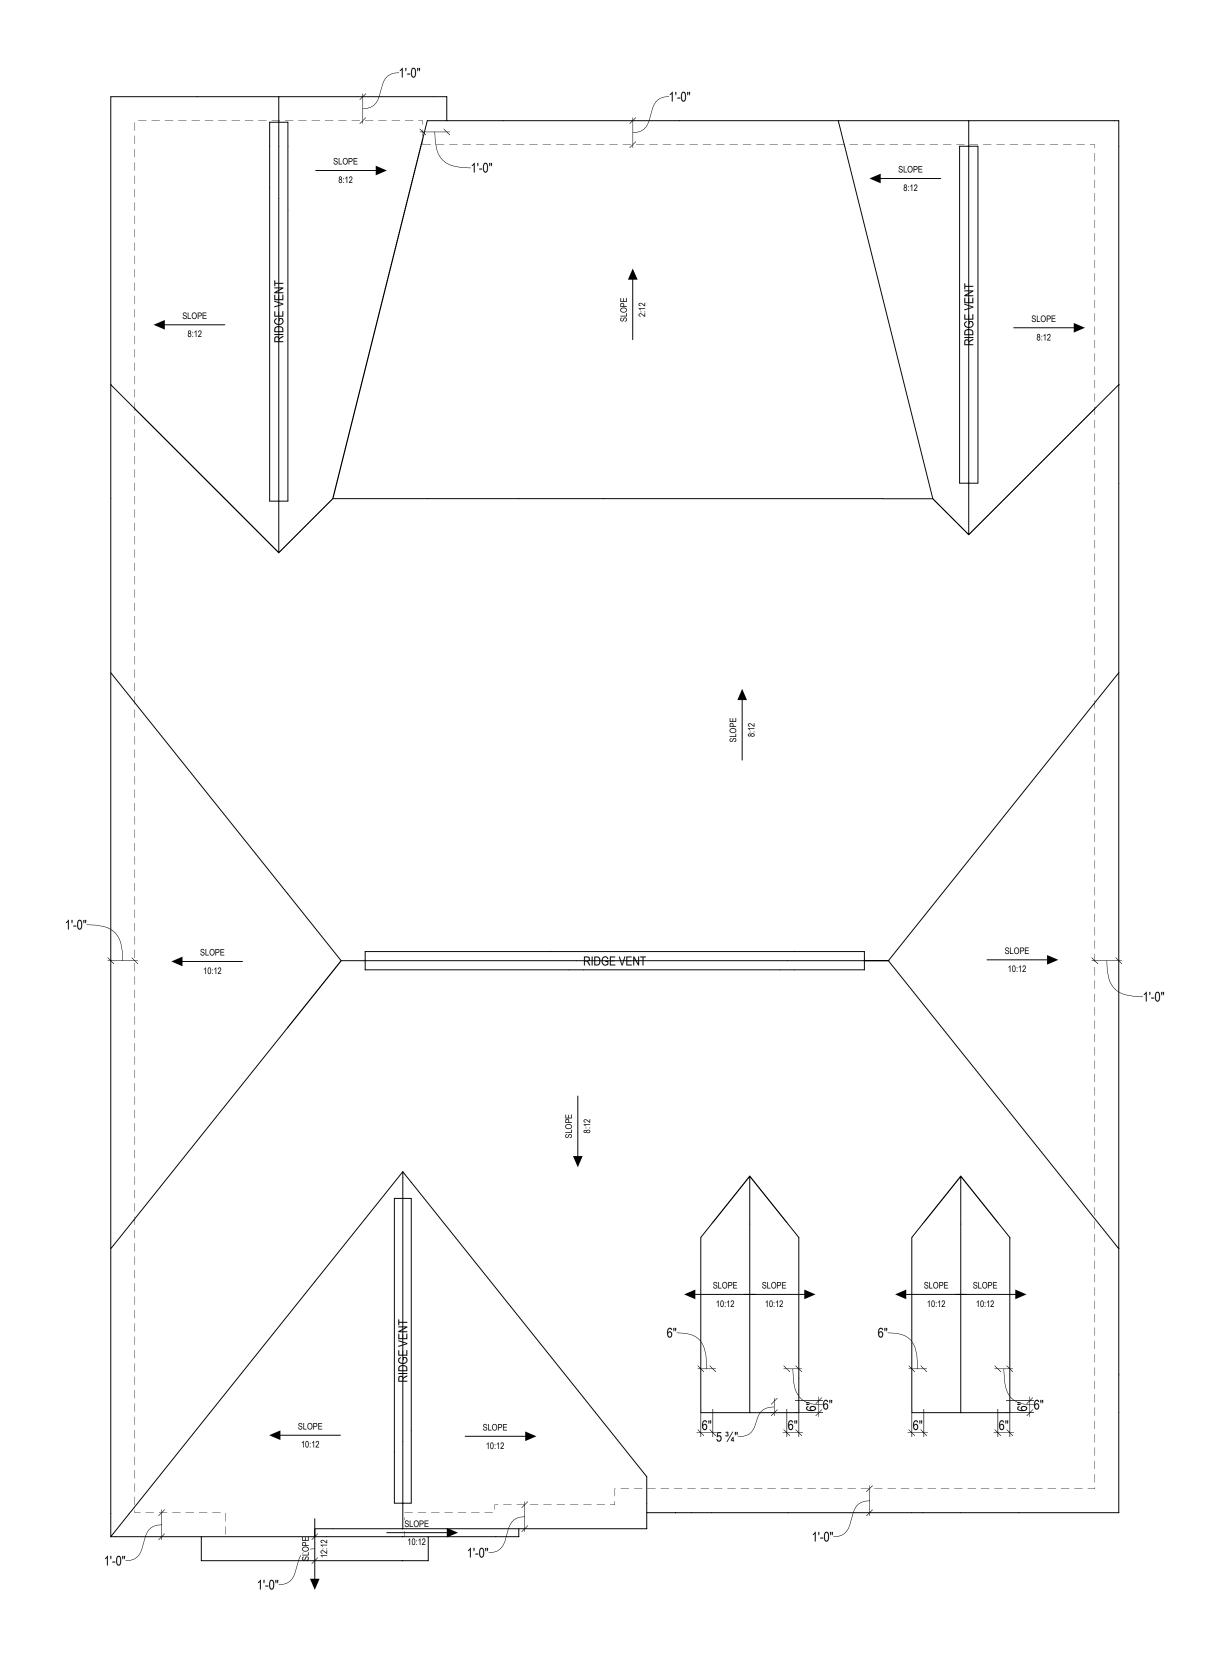

Roof Plan

1/4" = 1'-0" (WHEN PRINTED ON 22x34) 1/8" = 1'-0" (WHEN PRINTED ON 11x17)

A-200

Lot 60: Guilford French Country at Duncans Creek

New Home Inc

1611 Jones Franklin,

Raleigh, NC, 27606

DRAWN BY:


JJ/DREW

HANDING: RIGHT

ISSUE DATE: 11/11/1111


GENERAL ELEVATION NOTES:

- General Elevation Notes shall apply unless noted otherwise on plan.
- 1. Roof shall be finished with architectural composition shingles with slopes as noted on plan.
- 2. Ridge Vent shall be provided and installed on all ridges greater than 6' in length per manufacturer's specifications.
- 3. Soffit Vent shall be continuous soffit vent.
- 4. House Wrap, "tyvek" or approved equal shall be installed over entire exterior wall per manufacturer's specifications and recommendations.
- 5. Flashing shall be provided above all door and window openings, above finish wall material changes and at wall surfaces where lower roof areas abut vertical wall surfaces.
- 6. Porch Railings shall be provided at all porch walking surfaces greater than 30" above adjacent finished grade. It shall be 36" high with guards spaced no more than 4" apart. Consult community specifications for material.
- 7. Finish Wall Material shall be as noted on elevation drawings.
- 8. Brick Veneer, if included on elevation shall be tied to wall surface with galvanized corrugated metal ties at a rate of 24" oc horizontally and 16" oc vertically so that no more than 2.67sf of brick is supported by (1) tie. Space between face of wall and back face of brick shall be limited to a maximum of 1". Flashing shall be provided behind brick above all wall openings and at base of brick wall. Flashing shall be a minimum of 6-mil poly or other corrosion resistant material and shall be installed so that it laps under the house wrap material a minimum of 2". Weepholes shall be provided at a rate of 48" oc and shall not be less than 3/16" in diameter and shall be located immediately above flashing.
- 9. Brick Veneer Support Lintels shall be provided if brick veneer is included on elevation. Lintels shall be provided as listed in the following schedule and shall have a minimum bearing length of 6". Masonry Lintels shall be provided so that deflection is limited to 1/600.

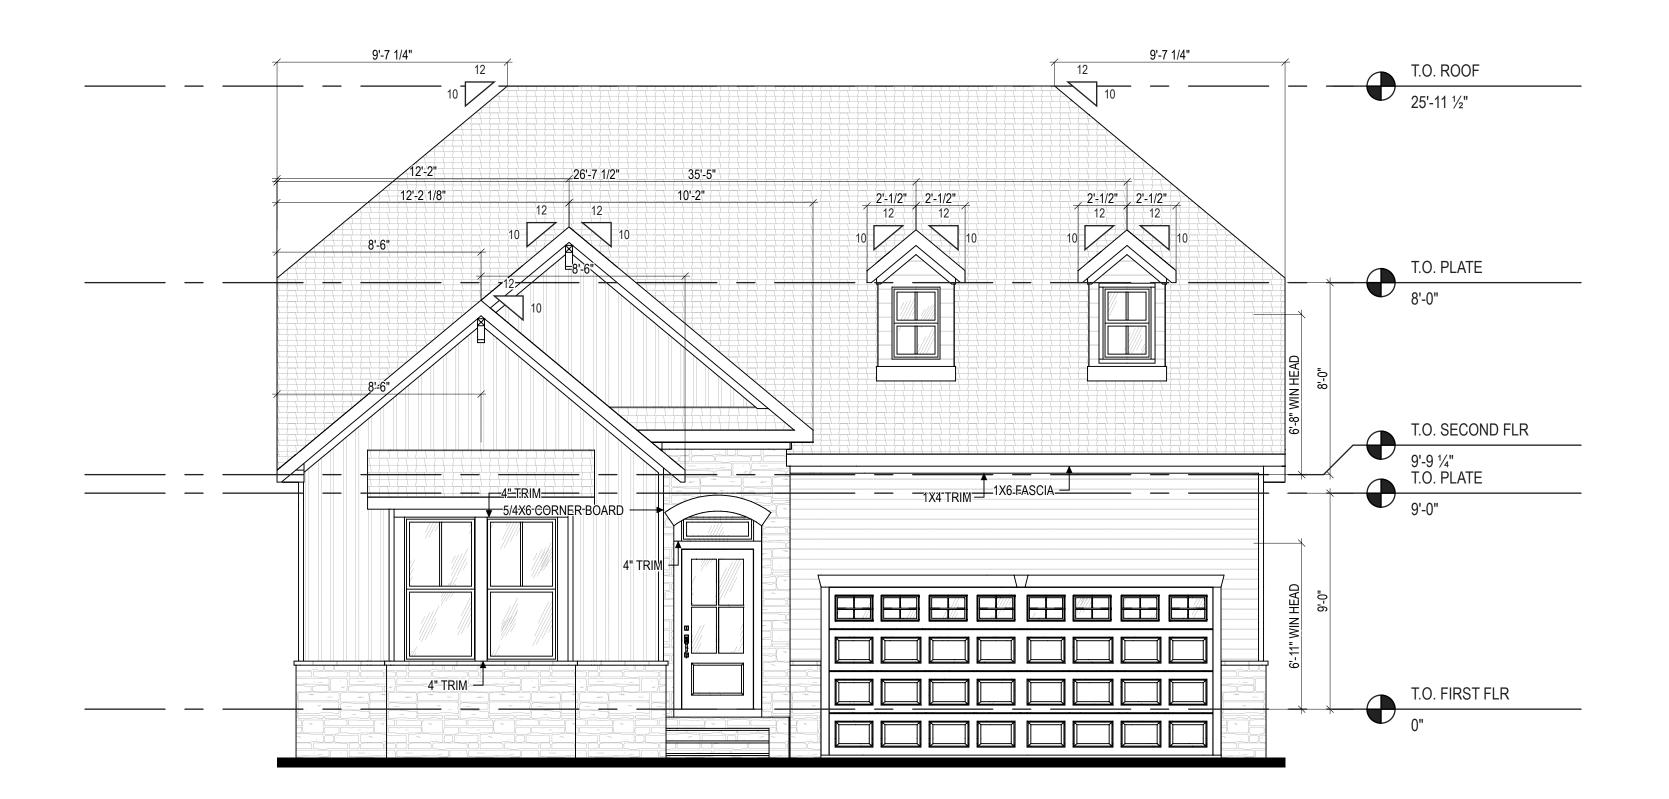

Front Elevation

1/4" = 1'-0" (WHEN PRINTED ON 22x34) 1/8" = 1'-0" (WHEN PRINTED ON 11x17)

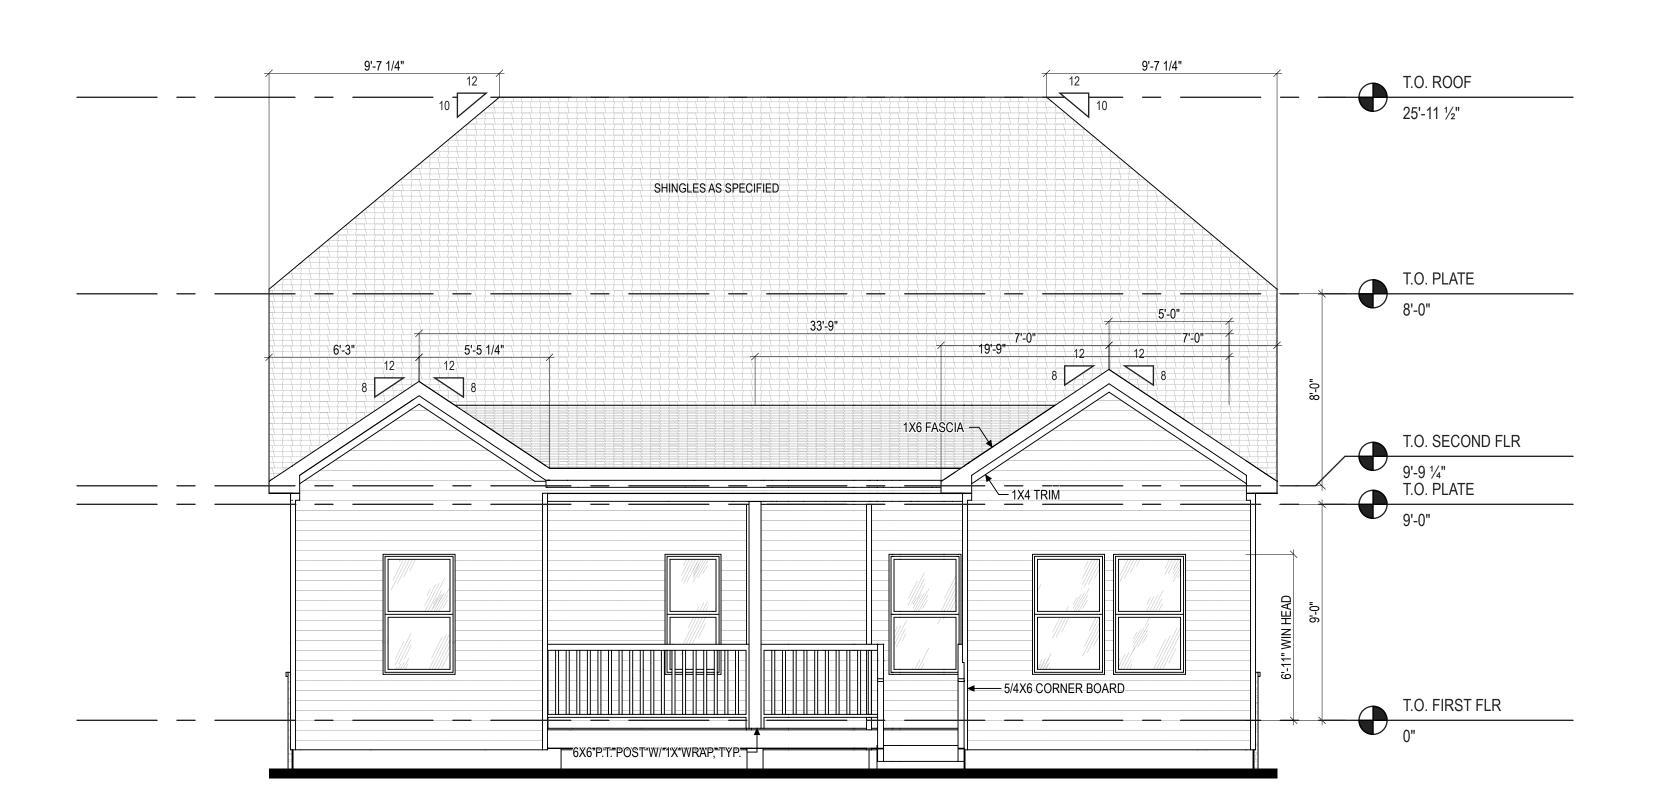

Back Elevation

1/4" = 1'-0" (WHEN PRINTED ON 22x34) 1/8" = 1'-0" (WHEN PRINTED ON 11x17) New Home Inc 1611 Jones Franklin, Raleigh, NC, 27606 Lot 60: Guilford French Country at Duncans Creek - Front and Back DRAWN BY:

JJ/DREW HANDING: 11/11/1111

GENERAL ELEVATION NOTES:

General Elevation Notes shall apply unless noted otherwise on plan.

1. Roof shall be finished with architectural composition shingles with slopes as noted on plan.

2. Ridge Vent shall be provided and installed on all ridges greater than 6' in length per manufacturer's specifications.

3. Soffit Vent shall be continuous soffit vent.

4. House Wrap, "tyvek" or approved equal shall be installed over entire exterior wall per manufacturer's specifications and recommendations.


5. Flashing shall be provided above all door and window openings, above finish wall material changes and at wall surfaces where lower roof areas abut vertical wall surfaces.

6. Porch Railings shall be provided at all porch walking surfaces greater than 30" above adjacent finished grade. It shall be 36" high with guards spaced no more than 4" apart. Consult community specifications for material.

7. Finish Wall Material shall be as noted on elevation


8. Brick Veneer, if included on elevation shall be tied to wall surface with galvanized corrugated metal ties at a rate of 24" oc horizontally and 16" oc vertically so that no more than 2.67sf of brick is supported by (1) tie. Space between face of wall and back face of brick shall be limited to a maximum of 1". Flashing shall be provided behind brick above all wall openings and at base of brick wall. Flashing shall be a minimum of 6-mil poly or other corrosion resistant material and shall be installed so that it laps under the house wrap material a minimum of 2". Weepholes shall be provided at a rate of 48" oc and shall not be less than 3/16" in diameter and shall be located immediately above flashing.

9. Brick Veneer Support Lintels shall be provided if brick veneer is included on elevation. Lintels shall be provided as listed in the following schedule and shall have a minimum bearing length of 6". Masonry Lintels shall be provided so that deflection is limited

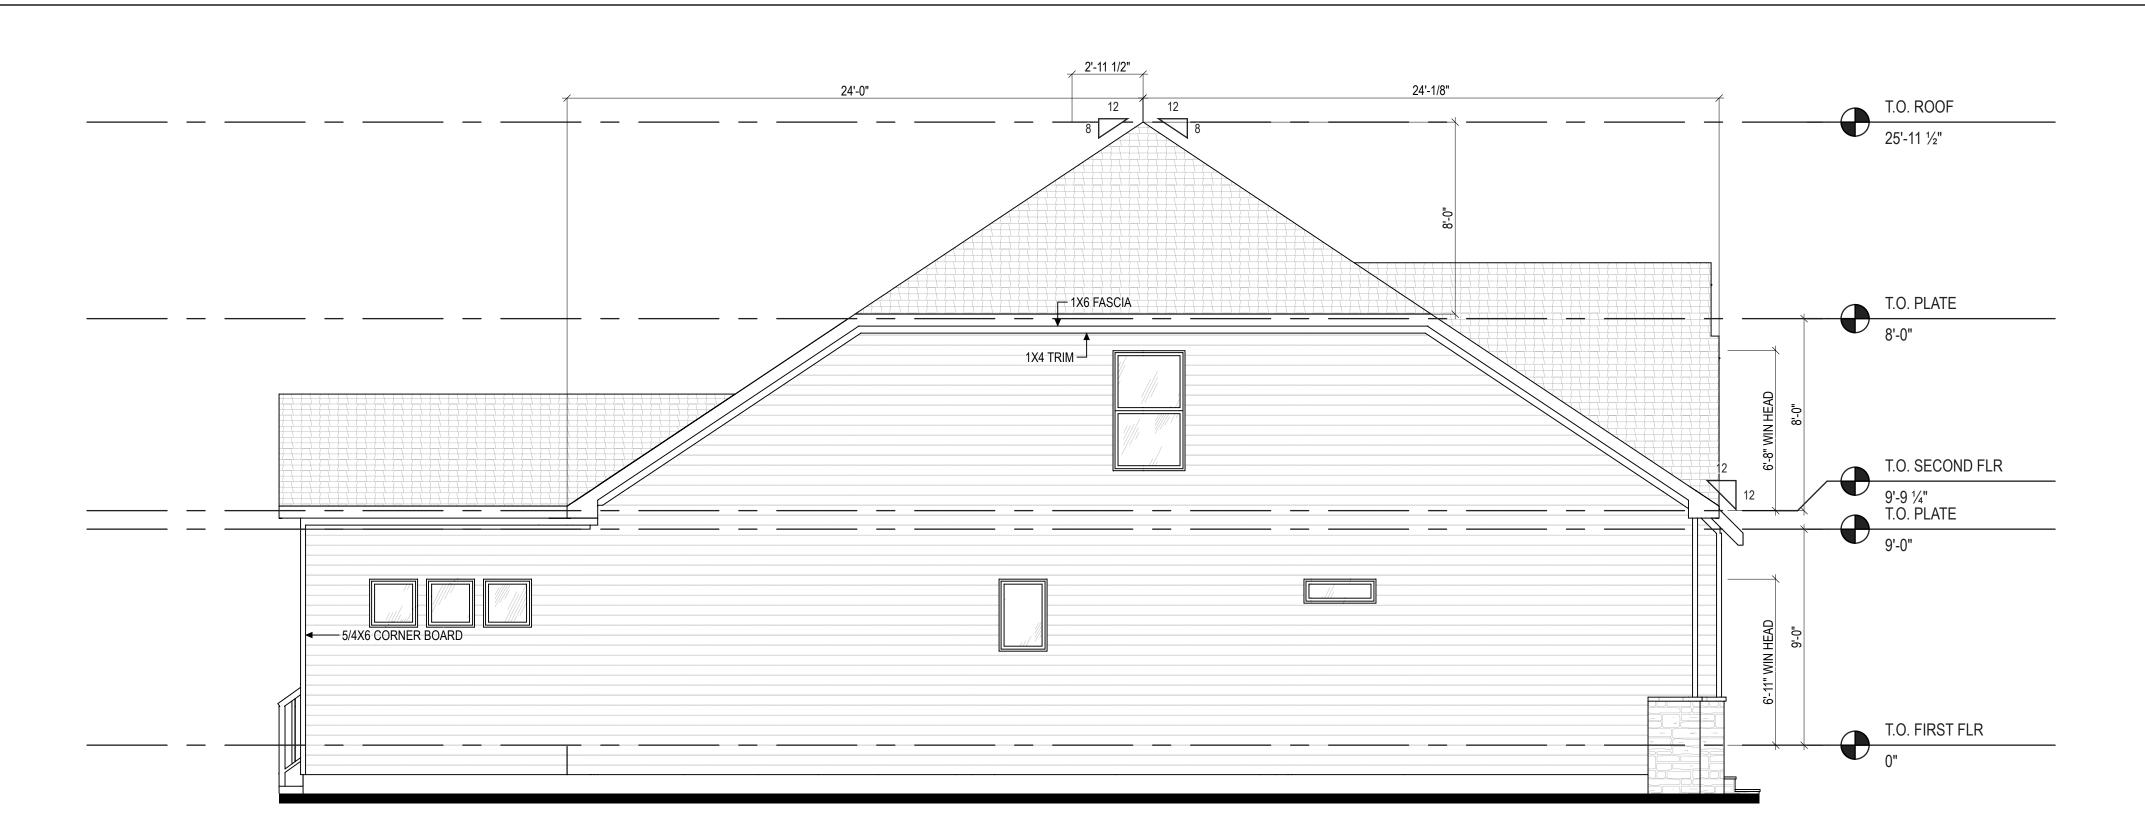

Left Elevation

1/4" = 1'-0" (WHEN PRINTED ON 22x34)

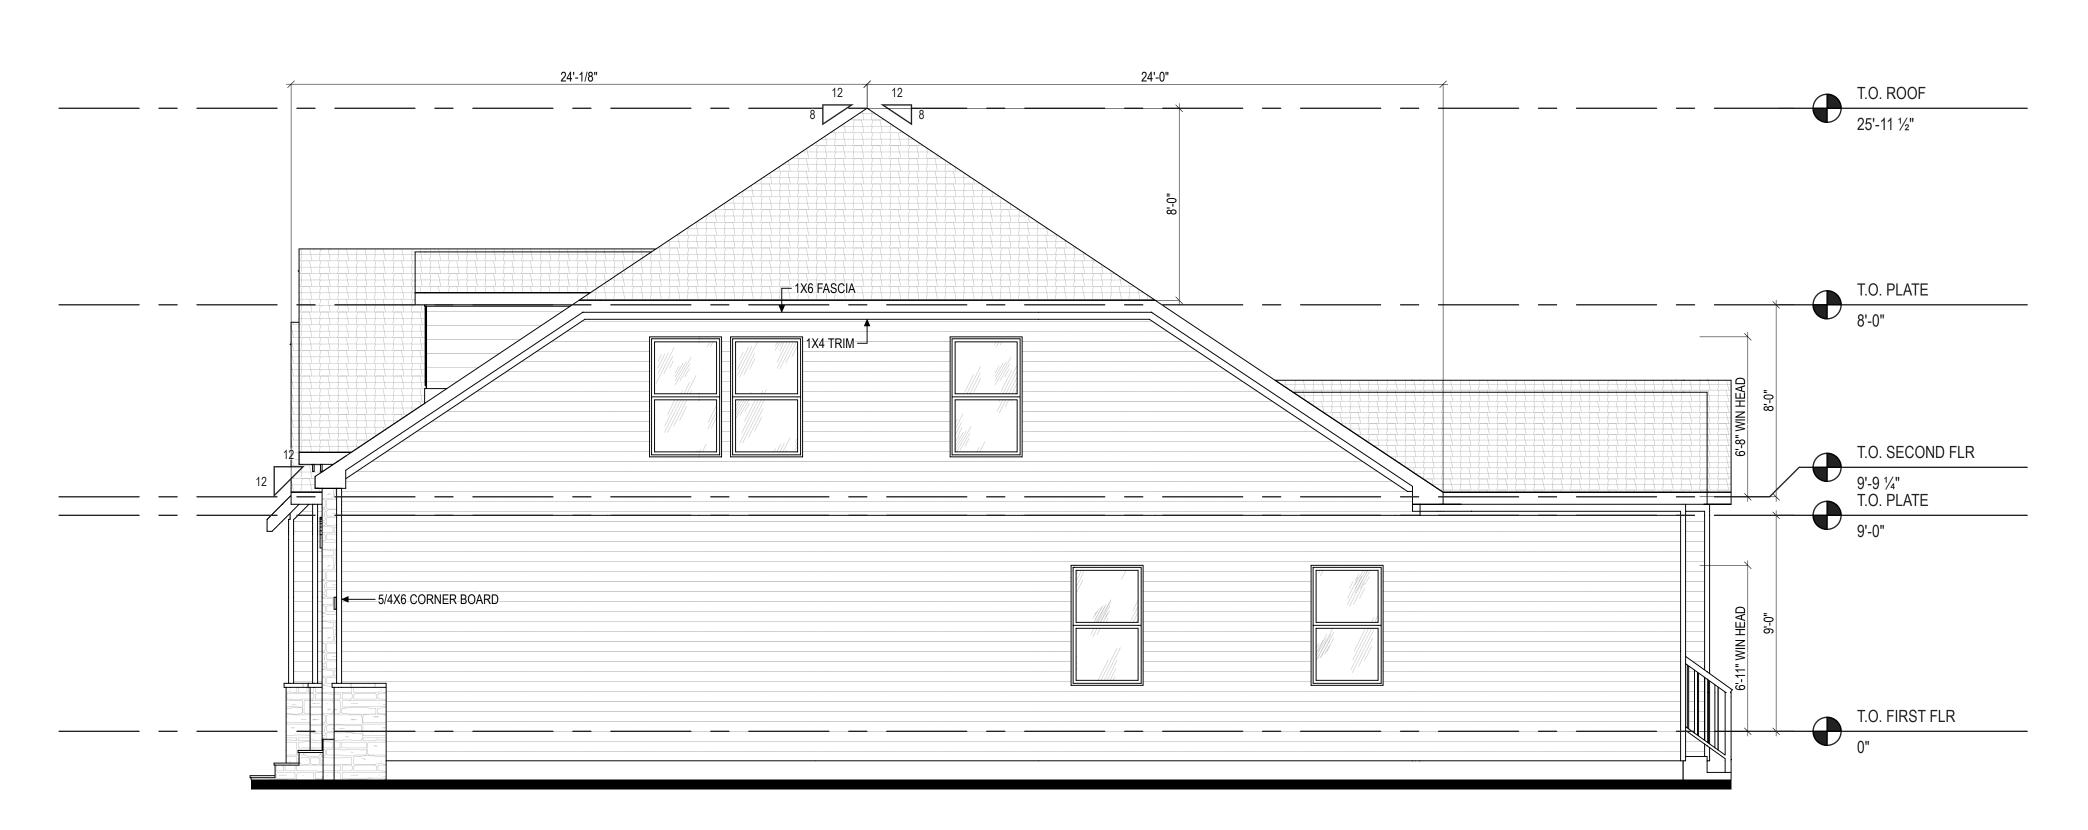


Right Elevation


1/4" = 1'-0" (WHEN PRINTED ON 22x34) 1/8" = 1'-0" (WHEN PRINTED ON 11x17)

New Home Inc 1611 Jones Franklin, Raleigh, NC, 27606 Lot 60: Guilford French Country at Duncans Creek DRAWN BY:

JJ/DREW HANDING: 11/11/1111



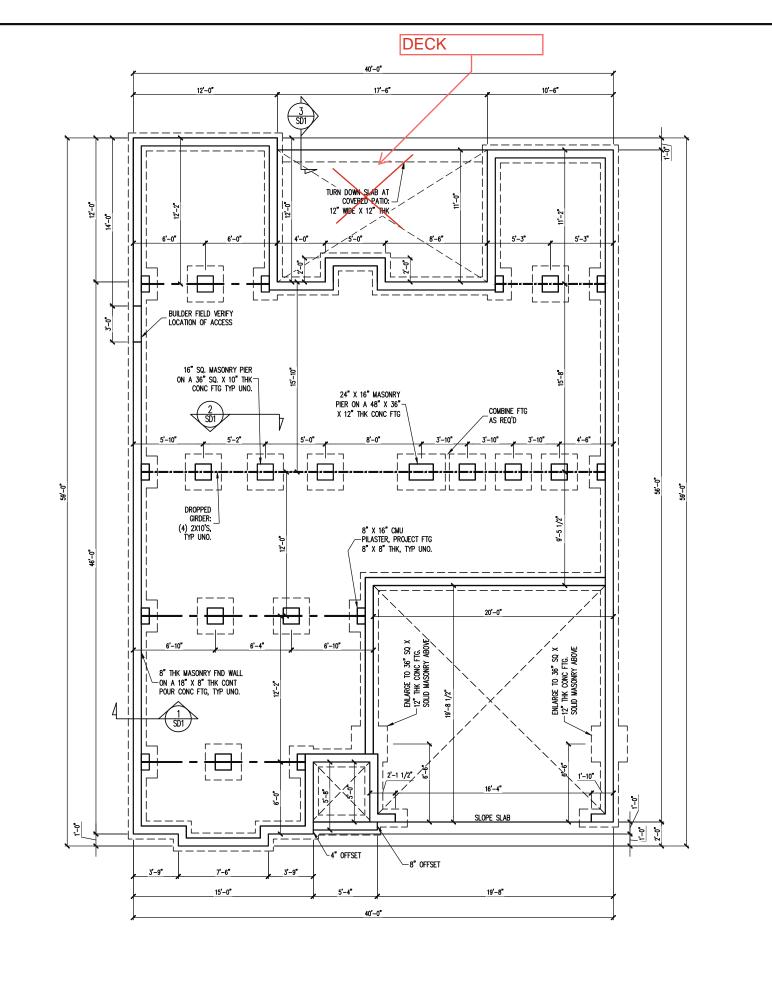

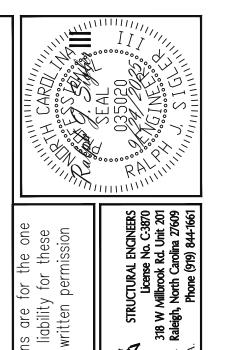

P.A. These plans are for the one A. assumes no liability for these

permission

written

location without

whole s. P.A.

ngineering

NEW HOME INC
STRUCTURAL ADDENDUM

REV # REF PROJ #

492 BEACON HILL ROAD FRENCH COUNTRY

ELEVATION:

10C

ENG: RJS/ZCH DATE: 9/24/2025

PLAN

GUILFORD

6

NOTES:

-HEIGHT AND BACKFILL LIMITATIONS FOR
FOUNDATION WALLS ARE TO BE GOVERNED
BY THE NCSBC, LATEST EDITION.
REINFORCEMENT AND GROUTING SHALL BE
DETERMINED BY FINAL SITE CONDITIONS.

-PLUMBING SHOWN FOR REFERENCE ONLY. BUILDER VERIEY FINAL FIXTURE LOCATIONS, SIZES AND REQUIREMENTS PRIOR TO INSTALLATION.


1/8" = 1'-0"

FOUNDATION PLAN

| ∃ .⊑ | PROJECT NO. |
|--------------|-------------|
| ineerin | 25-29-009 |
| ng: | |
| = = | SHEET NO. |
| Sills Tom | S 1 |
| | 1 of 8 |

this plan is the property of Engineering Tech Associates, P./ and for the client listed. Engineering Tech Associates, P.A. Iced, in whole or in part, for construction at any other locat are reproduced, time use at the location design of

The structural

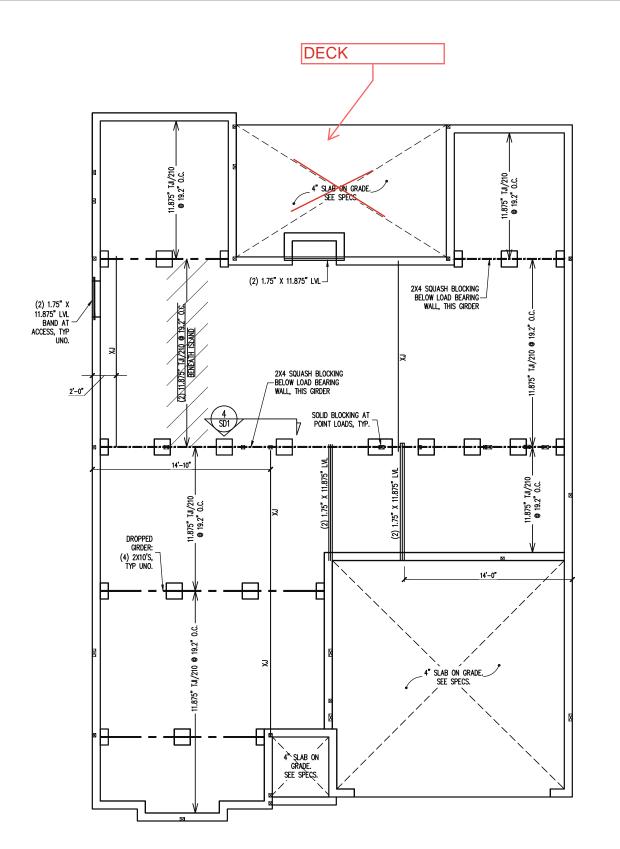

The structural design of this plan is the property of Engineering Tech Associates, P.A. These plans are for the one time use at the location and for the client listed. Engineering Tech Associates, P.A. assumes no liability for these plans if they are reproduced, in whole or in part, for construction at any other location without written permission

and for the client listed. Engineering Tech Associate ociates, P.A.

| NEW HOME INC. |
| SCOPE | STRUCTURAL ADDENDUM |
| LOC | 492 BEACON HILL ROAD | REV # REF PROJ # |
| ELEVATION: FRENCH COUNTRY |

DATE: 9/24/2025

PLAN GUILFORD

PROJECT NO. 25-29-009 SHEET NO.

S2

2 of 8

written permission

STRUCTURAL ENGINERS

Bicense No. C.3870

318 W Millbrook Rd. Unit 201

Raleigh, North Carolina 27609

Phone (919) 844-1661

Ingineering


ech G


CRAWLSPACE FRAMING PLAN

1/8" = 1'-0"

GIRDER LEGEND

I-JOIST SQUASH BLOCKING REQUIRED

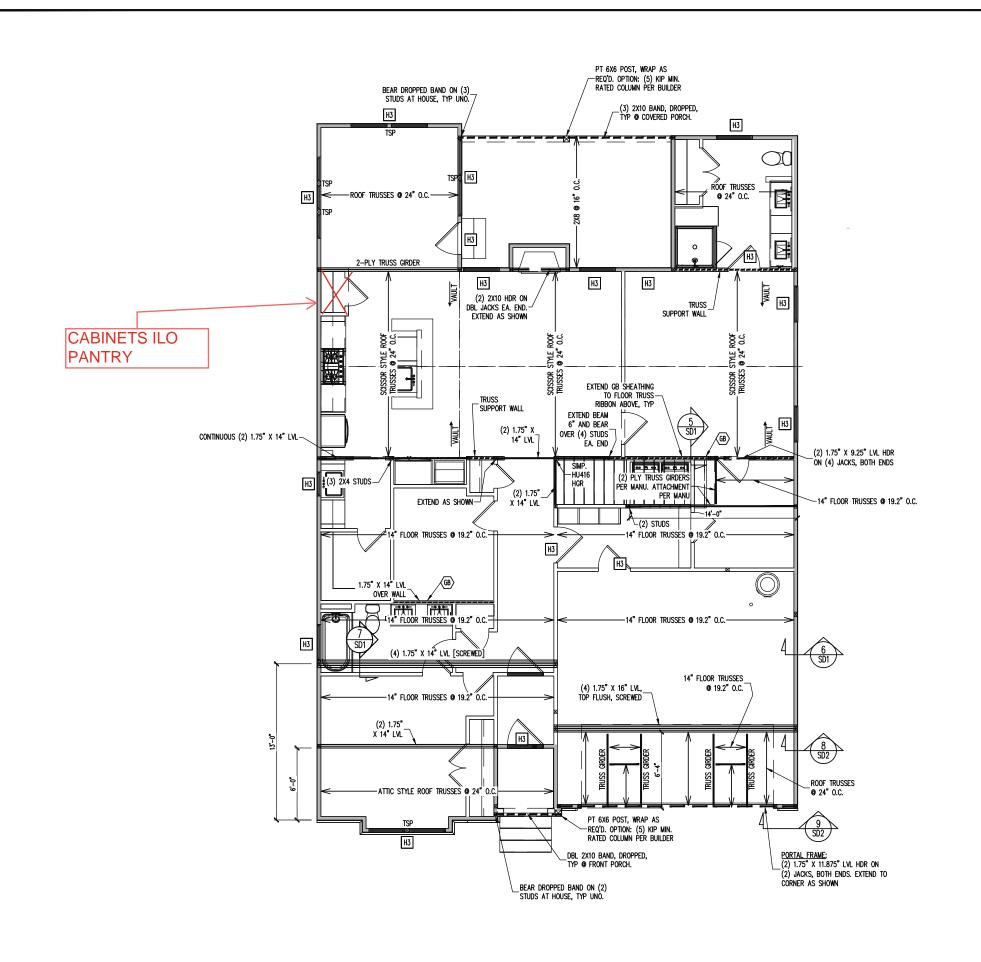

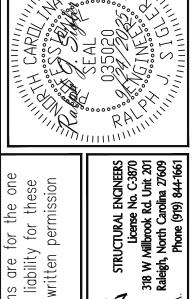

the one these

CONSTRUCTION SPECIFICATIONS INSTANT REFERENCES

REFER TO THE CONSTRUCTION SPECIFICATIONS SECTIONS FOR THE FOLLOWING INFORMATION:

PART 1.01: CURRENT GOVERNING CODE

PART 14: STUD SUPPORT FOR BEAMS

PART 17: KING STUDS FOR EXTERIOR WALLS

SEE DETAIL / CONSTRUCTION SPECIFICATIONS SHEETS FOR I-JOISTS ALLOWABLE SUBSTITUTIONS

WALL BRACING

SHADED WALLS:

ALL EXTERIOR STUD WALLS, EXTERIOR SIDE, ARE TO BE CONTINUOUSLY SHEATHED WITH 7/16 APA RATED OSB NAILED TO STUDS WITH 8d NAILS @ 6" O.C. AT PANEL EDGES, 12" O.C. IN PANEL FIELD.

- WSP ONE SIDE OF INTERIOR WALL OR INSIDE OF EXTERIOR WALL WITH 3/8" MIN. THICKNESS WOOD STRUCTURAL PANELING. ATTACH WSP TO STUD WALL WITH 8d NAILS @ 6" O.C. AT PANEL EDGES, 12" O.C. IN PANEL FIELD.
- GB INTERIOR BRACED WALL. 1/2" GB SECURED PER TABLE R602.10.2 OF THE 2018 NCRBC.
 (FASTENERS @ 7" O.C.) BOTH SIDES OF WALL OR (FASTENERS @ 4" O.C.) ONE SIDE OF WALL AT STAIRS (BUILDER PERMITTED TO SUBSTITUTE "WSP" FOR ANY "GB" WALL)

PROVIDED CONTINUOUS SHEATHING = 192' MIN.

REFERENCE PART 16.02 OF CONSTRUCTION SPECIFICATIONS FOR GENERAL WIND BRACING INFORMATION.

HEADER SCHEDULE

- H1 SINGLE 2X4 TURNED FLAT (A)
- H2 (2) 2X4'S ON SINGLE JACKS (B)
- H3 (2) 2X10'S ON SINGLE JACKS (C)
- H4 (2) 1.75" X 9.25" LVL'S ON DBL JACKS
- H5 (3) 2X10'S ON SINGLE JACKS
- (A) TYPICAL FOR INTERIOR NON LOAD BEARING WALLS ONLY, ROUGH OPENING 38" MAX.
- (B) TYPICAL FOR INTERIOR NON LOAD BEARING WALLS ONLY, ROUGH OPNG 38" TO 74" MAX.
- (C) TYPICAL FOR ALL CONDITIONS NOT LISTED IN (A) OR (B) UNO.

-HEADERS IN NON LOAD BEARING INTERIOR
WALLS ARE NOT LABELED.

1ST FLOOR FRAMING PLAN

WALLS AND CEILING 1/8" = 1'-0"

permission for for liability written are plans NO without These assumes location P.A. Ä Associates, other Associates, any Tech at Engineering lech construction Engineering for of listed. property part, .⊆ the client 0 is the whole S P A plan for and this reproduced, location of design are the structural they at nse

plans

time

Ihe


NEW HOME INC STRUCTURAL ADDENDUM BEACON HILL ROAD FRENCH COUNTRY 492 LOC:


ENG: RJS/ZCH DATE: 9/24/2025 **PLAN**

GUILFORD PROJECT NO. 25-29-009

SHEET NO.

S3 3 of 8

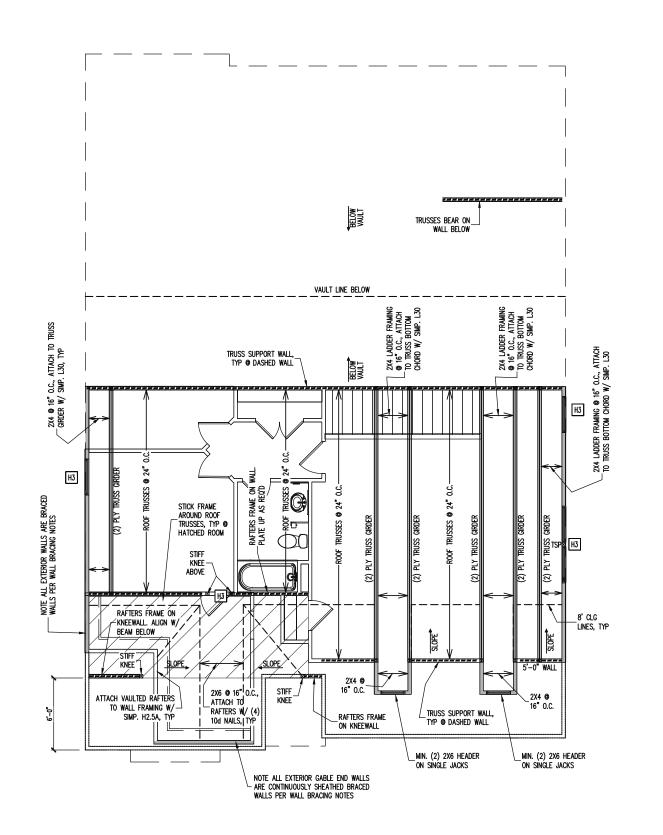

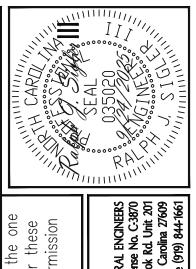

STRUCTURAL ENGINEERS
License No. C-3870
318 W Millbrook Rd. Unit 201
Raleigh, North Carolina 27609
Phone (919) 844-1661 ngineering

These plans are for the one sumes no liability for these

permission

without

location

assumes

Ä

Associates,

Tech

of

property

is the

this plan

of

design

The structural

time use

are

they at

plans

CONSTRUCTION SPECIFICATIONS INSTANT REFERENCES

REFER TO THE CONSTRUCTION SPECIFICATIONS SECTIONS FOR THE FOLLOWING INFORMATION:

PART 1.01: CURRENT GOVERNING CODE

PART 14: STUD SUPPORT FOR BEAMS

PART 17: KING STUDS FOR EXTERIOR WALLS

SEE DETAIL / CONSTRUCTION SPECIFICATIONS SHEETS FOR I—JOISTS ALLOWABLE SUBSTITUTIONS

WALL BRACING

SHADED WALLS:

ALL EXTERIOR STUD WALLS, EXTERIOR SIDE, ARE TO BE CONTINUOUSLY SHEATHED WITH 7/16 APA RATED OSB NAILED TO STUDS WITH 8d NAILS @ 6" O.C. AT PANEL EDGES, 12" O.C. IN PANEL FIELD.

PROVIDED CONTINUOUS SHEATHING = 34' MIN.

REFERENCE PART 16.02 OF CONSTRUCTION SPECIFICATIONS FOR GENERAL WIND BRACING INFORMATION.

HEADER SCHEDULE

- H1 SINGLE 2X4 TURNED FLAT (A)
- H2 (2) 2X4'S ON SINGLE JACKS (B)
- H3 (2) 2X10'S ON SINGLE JACKS (C)
- H4 (2) 1.75" X 9.25" LVL'S ON DBL JACKS
- H5 (3) 2X10'S ON SINGLE JACKS
- (A) TYPICAL FOR INTERIOR NON LOAD BEARING WALLS ONLY, ROUGH OPENING 38" MAX.
- (B) TYPICAL FOR INTERIOR NON LOAD BEARING WALLS ONLY, ROUGH OPNG 38" TO 74" MAX.
- (C) TYPICAL FOR ALL CONDITIONS NOT LISTED IN (A) OR (B) UNO.

-HEADERS IN NON LOAD BEARING INTERIOR WALLS ARE NOT LABELED.

2ND FLOOR FRAMING PLAN

WALLS AND CEILING 1/8" = 1'-0"

Associates, other NEW HOME INC.
STRUCTURAL ADDENDUM any at Engineering lech construction Engineering BEACON HILL ROAD FRENCH COUNTRY for listed. part, 492 the client .⊆ o ELEVATION: whole S P A 10C for and reproduced, the location


ENG: RJS/ZCH DATE: 9/24/2025 **PLAN**


PROJECT NO. 25-29-009

GUILFORD

SHEET NO.

S4 4 of 8

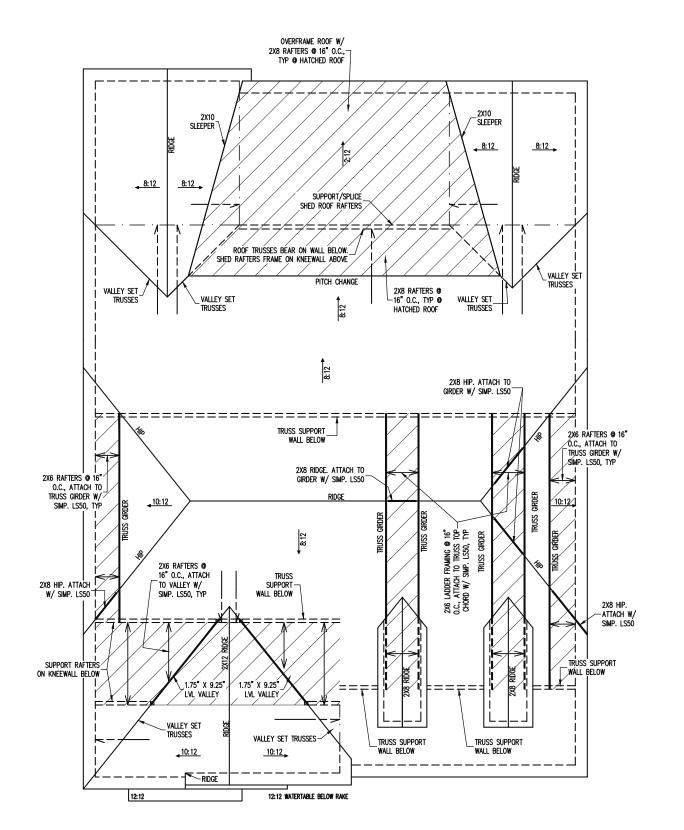

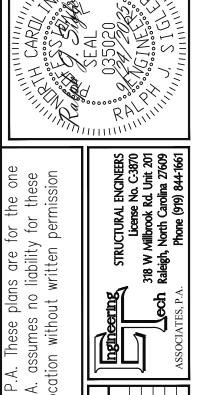

ngineering

NEW HOME INC.
STRUCTURAL ADDENDUM
ON HILL ROAD

492 BEACON HILL ROAD

FRENCH COUNTRY

ELEVATION:

10C

ENG: RJS/ZCH

DATE: 9/24/2025

PLAN

GUILFORD

PROJECT NO.

C

written

location without

Ä

Engineering Tech Associates, igineering Tech Associates, P... construction at any other lo

Engineering

this plan is the property of and for the client listed. En Iced, in whole or in part, for

for

whole S P A

they are reproduced,

plans

time use at the location The structural design of

FRAMING NOTES

ROOF ONLY

-ROOF TRUSSES PER MANU. TYPICAL U.N.O.
-VERIFY ALL HEEL HEIGHTS, ROOF PITCHES,
AND ARCHITECTURAL OVERHANGS PRIOR TO CONSTRUCTION

TRUSS UPLIFT CONNECTORS

EXPOSURE B. 120 MPH, ANY PITCH 24" O.C. MAX ROOF TRUSS SPACING

TRUSSES SHALL BE ATTACHED TO SUPPORT WALL FOR UPLIFT RESISTANCE. CONTINUOUS OSB WALL SHEATHING BELOW PROVIDES CONTINUOUS UPLIFT RESISTANCE TO FOUNDATION. ALL TRUSSES SUPPORTED BY INTERMEDIATE SUPPORT WALLS, KNEEWALLS OR BEAMS SHALL BE ATTACHED TO SUPPORTING MEMBER PER SCHEDULE BELOW.


ROOF SPAN IS MEASURED HORIZONTALLY BETWEEN FURTHEST SUPPORT POINTS.

CONNECTOR NAILING PER TABLE 602.3(1) NCRBC 2018 EDITION

OVER 18'

(1) SIMPSON H2.5A HURRICANE CLIP TO DBL TOP PLATE OR BEAM

| 9 | 25-29-009 | | | | | |
|---|------------|--|--|--|--|--|
| 7 | SHEET NO. | | | | | |
| | S 5 | | | | | |
| | 5 of 8 | | | | | |

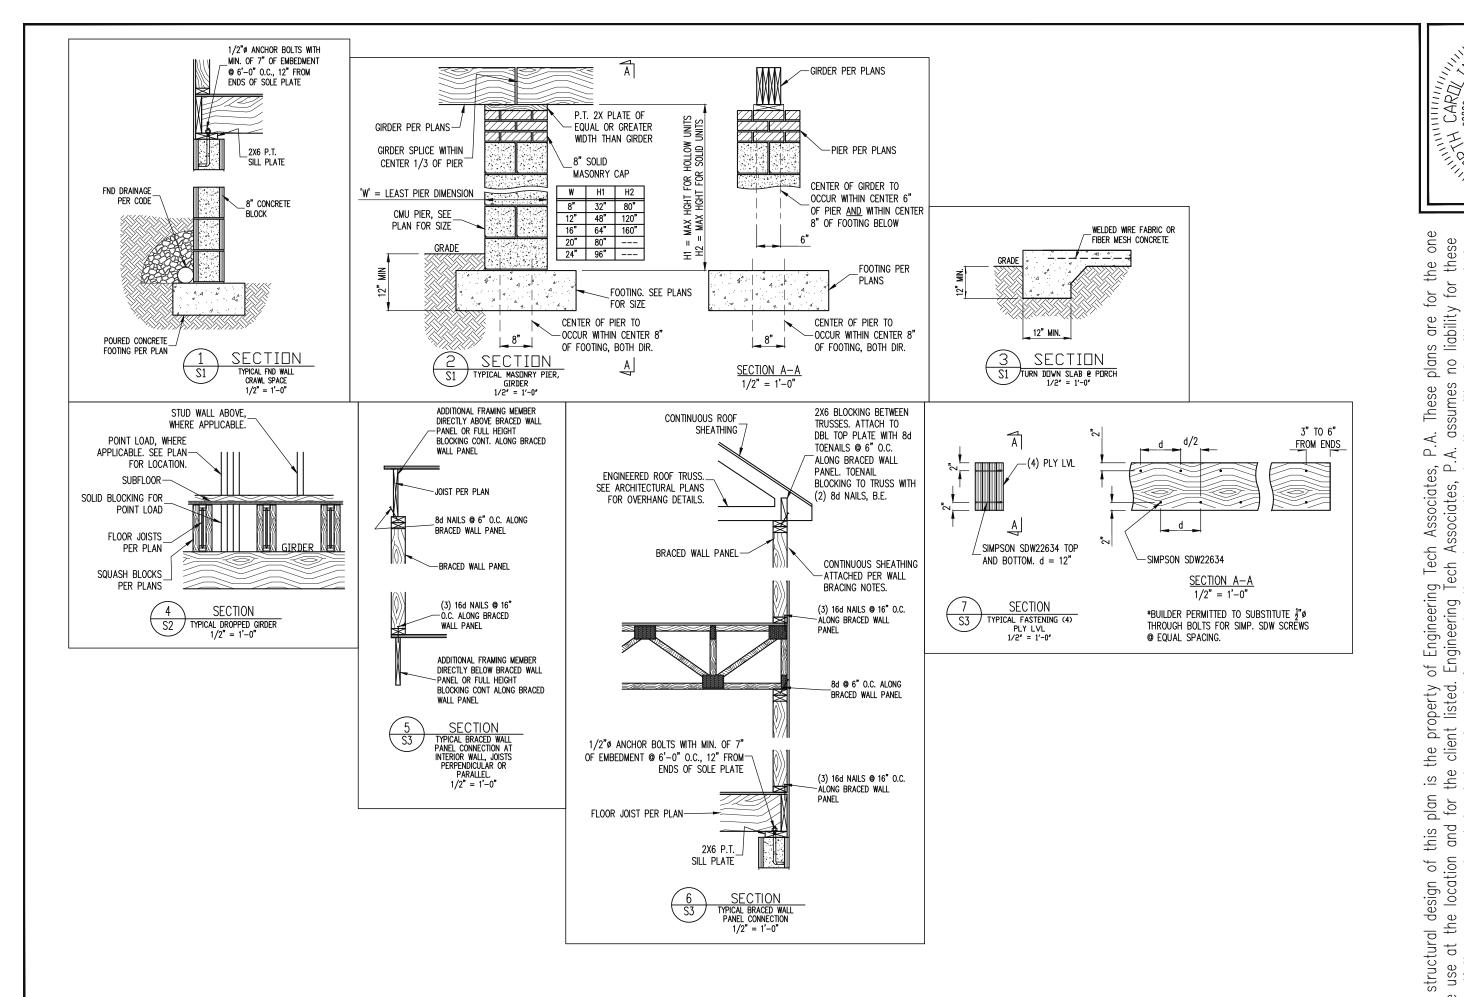

. These plans are for the vivacumes no liability for these the one permission

STRUCTURAL ENGINEERS
License No. C-3870
318 W Millbrook Rd. Unit 201
Raleigh, North Carolina 27609
Phone (919) 844-1661 nglu

written

without

location

Associates, at any other

any

at

Engineering Tech for construction o

for

part,

the client I whole or in

for

and

location

nse

whole s. P.A.

reproduced,

are the

they at

plans time

assumes

NEW HOME INC.
STRUCTURAL ADDENDUM
ALTO REV # REF PROJ # BEACON HILL ROAD FRENCH COUNTRY

> ELEVATION: LOC: ENG: RJS/ZCH


492

DATE: 9/24/2025 **PLAN GUILFORD**

PROJECT NO. 25-29-009

SHEET NO.

SD1 6 of 8

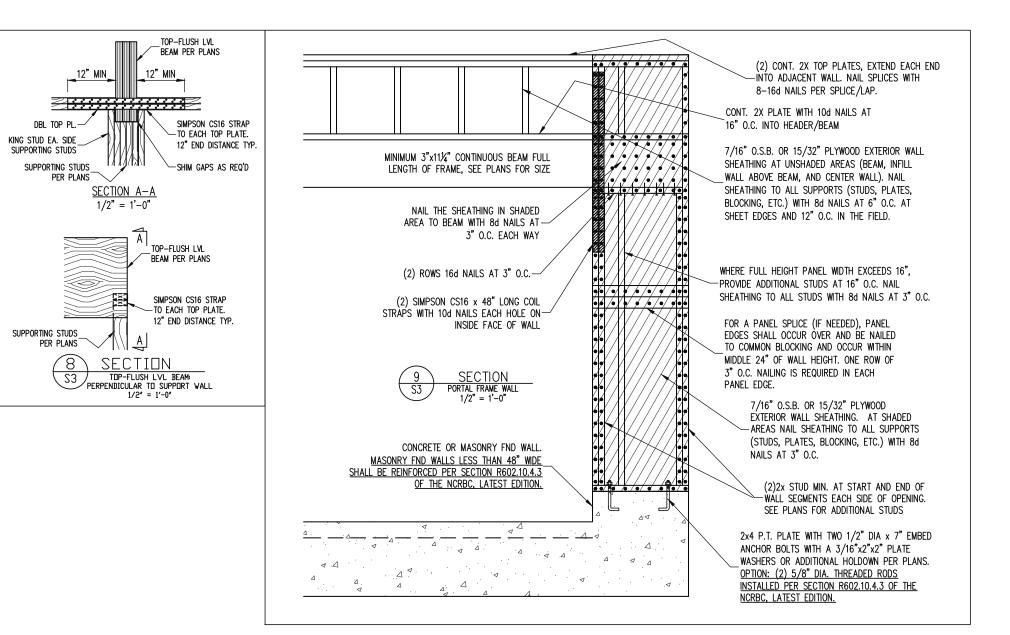

for the one

STRUCTURAL ENGINEERS
License No. C:3870
318 W Millbrook Rd. Unit 201
Raleigh, North Carolina 27609
Phone (919) 844-1661 ngheering

These plans are for the one ssumes no liability for these

permission

written

without

location

h Associates, at any other

construction

for

whole s. P A

reproduced,

are

they at

plans time

assumes

P.A.

Tech Associates,

Engineering Tech

of

plan for

design of this

structural

Engineering

n is the property o the client listed. I whole or in part, f

and

the location

nse

NEW HOME INC.
STRUCTURAL ADDENDUM
TO A TREV # REF PROJ # BEACON HILL ROAD FRENCH COUNTRY 492 ELEVATION: LOC:


> ENG: RJS/ZCH DATE: 9/24/2025

PLAN GUILFORD

PROJECT NO. 25-29-009

SHEET NO. SD2

7 of 8

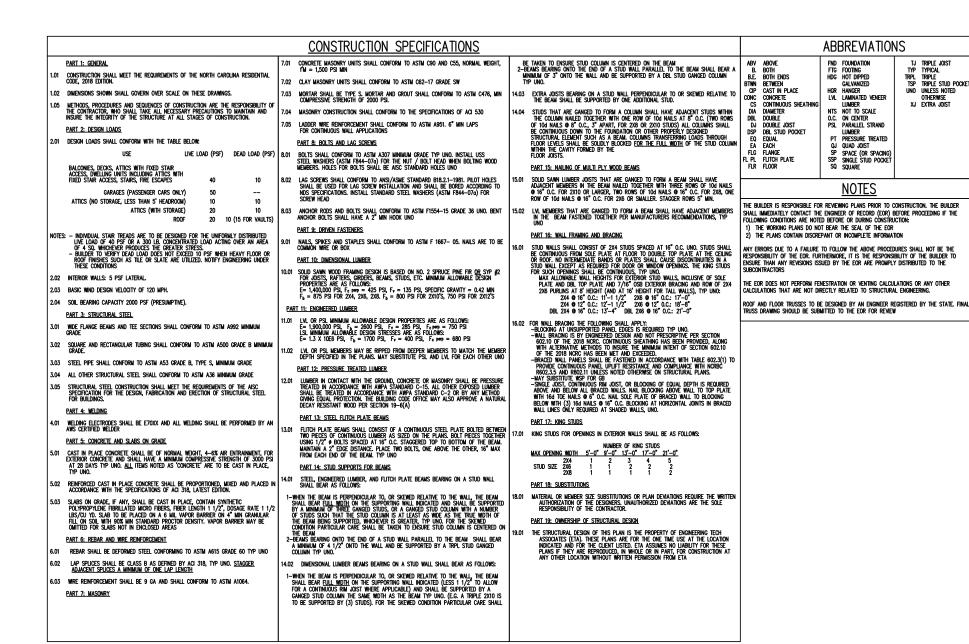

the one permission liability for these for written are These plans N0 without assumes location P.A. Ä ┙. Tech Associates, other Associates, any at Engineering Tech construction Engineering for Of the client listed. whole or in part, f property is the whole P A plan for .⊆ and this reproduced, location design of are the structural they at nse ± plans time

SEAL STORY OF THE CARACTURAL S

Ingineering STRUCTURAL ENGINEERS
License No. C-3870
318 W Milbrook Rd. Unit 201
ASSOCIATES, P.A. Phone (919) 844-1661

RE PROJ # DATE COL

SCOPE STRUCTURAL ADDENDUM
LOC: 492 BEACON HILL ROAD REV # REF P
ELEVATION: FRENCH COUNTRY

ENG: RJS/ZCH DATE: 9/24/2025

PLAN GUILFORD

PROJECT NO. 25-29-009

SHEET NO.

8 of 8