OAK HAVEN						
	ABBREVIATIONS					
	ABV	ABOVE	HDR	HEADER	A.A.	PRESSURE TREATED WD
	AFF	ABOVE FINISH FLOOR	HGT	HEIGHT	PWD	POWDER
	С	CARPET	H.R.	HALF ROUND	R	RISER
	CAB	CABINET	HS	HARD SURFACE	RAD	RADIUS
	CI	CENTER LINE	HWD	HARDWOOD (FLOORS)	REF	REFRIGERATOR
	CLG	CEILING	I.L.O.	N LIEU OF		REVISION
	COL	COLUMN	ISUL	NSULATED(TION)	R&M	RANGE W/MICROWAVE
	CONC	CONCRETE	INT	NTERIOR	RM	ROOM
	CPT	CARPET	ITC	N THE CLEAR	R.O.	ROUGH OPENING
	DBL	DOUBLE	KIT	KITCHEN	R/S	ROD & SHELF(S)
	DIM	DIMENSION	K/S	KNEE SPACE	SD	SMOKE DETECTOR
	DN	DOWN (STAIRS)	LÍV	LIVING	SEC	SECTION
	DRY	DRYER MACHINE	LTL	LINTEL	SQ.FT.	SQUARE FOOTAGE
	DTL	DETAIL	LVR	LOUVER	SH	SINGLE HUNG
	EA	EACH	MAX	MAXIMUM	STD	STANDARD
	EB	EYEBROW	MIN	MINIMUM		TEMPERED (GLASS)
	ELEV	ELEVATION	MISC	MISCELLANEOUS		TRANSOM
	ELEC	ELECTRIC(AL)	MULL	MULLION(ED)	TYP	TYPICAL
	EQ	EQUAL	N/A	NOT APPLICABLE	UNF	Unfinished
	EXT	EXTERIOR	0A	OVERALL	U.N.O.	UNLESS NOTED OTHERWISE
	F.F.	FINISH FLOOR (LINE)	OBS	OBSCURE (GLASS)	VB	VANITY BASE
	FXD	FIXED GLASS	0.C.	ON CENTER	W	WASHER
	FIN	FINISH	0.H.	OVERHANG	WD	WOOD
	FLR	FLOOR(ING)	OPNG	OPENING	WH	WATER HEATER
	FP	FIREPLACE	0PT	OPTIONAL	WIC	WALK-IN CLOSET
	FUR	FURRED(ING)	PED	PEDESTAL (SINK)	W/ W/0	WITH or WITHOUT
	GFI	GROUND FAULT CIRCUIT INTERRUPT	OSB	ORIENTED STRAND BOARD	WP	WATERPROOF(ING)
	HB	HOSE BIB	PL	PLATE (HEIGHT)		

GENERAL NOTES

1 - GENERAL BUILDING & DESIGN REQUIREMENTS

1) THE ATTACHED PLANS & SPECIFICATIONS ARE THE SOLE PROPERTY OF TRI POINTE HOMES ANY UNAUTHORIZED USE OF THESE PLANS WITHOUT PRIOR WRITTEN CONSENT OF TRI POINTE HOMES IS STRICTLY

TRI POINTE HOMES DESIGNS & BUILDS HOUSING AS SET FORTH BY THE FORMAT AND PROVISIONS OF TH INTERNATIONAL RESIDENTAL CODE (IRC), AND THE NATIONAL ELECTRIC CODE (NEC). ANY NON-CONFORMING DOCUMENTS DISCOVERED BY THE CONTRACTOR OR HIS AGENTS SHALL BE CALLED TO THE IMMEDIATE ATTENTION OF TRI POINTE HOMES BY CALLING (469)329-0470.

) THESE PLANS ARE SUBJECT TO MODIFICATIONS TO MEET CODE REQUIREMENTS AND/OR TO FACILITATE MECHANICAL/ ELECTRICAL/ PLUMBING INSTALLATION AND/ OR TO IMPLEMENT DESIGN IMPROVEMENTS. ANY

INTENTION TO MODIFY THESE PLANS MUST BE APPROVED IN WRITING BY TRI POINTE HOMES
4) CONTRACTOR SHALL BE RESPONSIBLE FOR VERIFYING ALL DIMENSIONS AFFECTING CONTRACTOR'S PRODUCTS, INSTALLATIONS, OR FABRICATIONS IN THE FIELD PRIOR TO EXPEDITING THE CONSTRUCTION OF SUCH WORK. FIELD VERIFY ALL DIMENSIONS — DO NOT SCALE DRAWINGS!! CONTRACTOR IS RESPONSIBLE FOR SURVEYING THE PROJECT AND BECOMING FAMILIAR WITH THE EXISTING CONDITIONS AND SCOPE OF WORK INCLUDING BUT NOT LIMITED TO SITE AND SOIL BEARING CONDITIONS.
5) ERRORS AND OMISSIONS WHICH MAY OCCUR IN THE CONTRACT DOCUMENTS SHALL BE BROUGHT TO THE

OF THE ARCHITECT, IN WRITING, AND WRITTEN INSTRUCTION SHALL BE OBTAINED FROM TO PROCEEDING WITH CONSTRUCTION. THE CONTRACTOR SHALL BE OBTAINED PRIOR TO PROCEEDING WITH CONSTRUCTION. THE CONTRACTOR SHALL BE HELD RESPONSIBLE FOR ANY ERRORS, DISCREPANCIES, OR OMISSIONS FOR WHICH THE CONTRACTOR FAILED TO NOTIFY THE ARCHITECT PRIOR TO

2 - SITE CONSTRUCTION

BACK FILL SHALL BE FREE FROM VEGETATION AND CONSTRUCTION DEBRIS

) BACK FILL SHALL BE PLACED IN LIFTS AND COMPACTED IN SUCH A MANNER AS BACKFILL TO NOT DAM. THE FOUNDATION WALLS OR ANY WATERPROOFING/ DAMPPROOFING MATERIALS.

3 - CONCRETE

1) SLOPE ON GARAGE SLAB SHALL BE 1/8" PER FOOT TOWARDS VEHICLE DOOR. SLOPE ON PORCH AND

4 - MASONRY

ALL EXTERIOR BRICK MUST MEET ASTM C-216 FOR "SW" CONDITIONS

2) MASONRY VENEER SHALL BE ATTACHED TO SUPPORTING WALLS w/ CORRUGATED METAL TIES IN ACCORDANCE WITH R703.7.4.1 - I.R.C. OR LOCAL CODE REQUIREMENTS

) WEEPHOLES SHALL BE PROVIDED ALONG THE OUTSIDE WYTHE OF EXTERIOR MASONRY WALLS AT 33" O.C. MAX, SHALL BE A MIN. OF 3/16" IN DIAMETER, AND LOCATED IMMEDIATELY ABOVE THE FLASHING PER 18703.7.6 – LR.C.

5 - METALS

6 - WOOD AND PLASTICS

7 - THERMAL & MOISTURE PROTECTION

FIRE STOPPING AND/ OR DRAFT STOPPING SHALL MEET THE REQUIREMENTS OF IRC R602.8.) ATTIC VENTILATION SHALL BE PROVIDED AT 1/300 to 0F THE AREA OF THE SPACE VENTILATED. CROSS VANILATION WITH HALF OF THE VENTILATED AREA SHALL BE PROVIDED BY ROOF VENTS AND THE OTHER HALF BY SOFFIT VENTS. VENTS SHALL BE PLACED SO AS TO NOT ALLOW INFILTRATION OF RAIN OR SNOW.) PROVIDE APPROVED TILE BACKER DRYWALL FOR ALL SHOWER AND BATH SPACE PROVIDE ATTIC VENTILATION PER IRC-R806.1

8 - DOORS AND WINDOWS

-) REVIEW ALL WINDOW HDR HEIGHTS PER PLATE HT. AND VERIFY W/ ELEVATIONS AND CORNICE DETAILS TEMPERED GLASS SHALL BE USED IN HAZARDOUS AREAS AS DESCRIBED IN SECTION R308.4 - LR.C.
- FRONT DOOR WIDTH PER IRC-R311.3
- GARAGE DOOR PER IRC-R309.1

FMERGENCY EGRESS SHALL MEET REQUIREMENTS OF SECTION R310 - LR C 2018 - SLEEPING ROOMS HALL HAVE AT LEAST ONE EGRESS OPENING OF NOT LESS THAN 5.7 SF AND A CLEAR OPENING OF NOT LESS THAN 20" WIDE X 24" HIGH AND SHALL NOT BE MORE THAN 44" ABOVE THE FLOOR

15 - MECHANICALS

WOOD BUILT CHIMNEYS AND FIREPLACES SHALL BE INSTALLED PER MANUFACTURER'S INSTRUCTIONS AND RE SUBJECT TO MECHANICAL INSPECTION PER IRC SECTION R1002.) EXTERIOR AIR INTAKE FOR COMBUSTION AIR PER IRC SECTION AS REQUIRED BY LOCAL MUNICIPALITY

16 - ELECTRICAL

ALL FLECTRICAL INSTALLATION SHALL MEET THE REQUIREMENTS OF THE NATIONAL ELECTRIC CODE (NEC) MATERIAL AND EQUIPMENT SHALL BEAR THE LABEL OF APPROVAL OF THE UNDERWRITERS ABORATORIES, INC.

) ELECTRICAL CONTRACTOR SHALL VERIFY SPACE REQUIRED FOR METER INSTALLATION BEFORE ONSTRUCTION AND SHALL NOTIFY GENERAL CONTRACTOR OF ANY DISCREPANCIES.

VERIFY LOCATION OF ALL RECEPTACLES FOR APPLIANCES WITH MANUFACTURER SPECIFICATIONS. GROUND FAULT INTERRUPTS SHALL BE LOCATED PER THE NEC

ALL SWITCHES SHALL BE INSTALLED AT 3'-6" ABOVE FINISHED FLOOR TO CENTERLINE OF SWITCH VLESS NOTED OTHERWISE

) ALL CONVENIENCE OUTLETS SHALL BE INSTALLED W/ CENTERLINE OF OUTLET LOCATED 1'-3" ABOVE INISHED FLOOR UNLESS NOTED OTHERWISE

ALL CONVENIENCE OUTLETS WITH SWITCHES TO BE SWITCH AT TOP ONLY.

ALL EXTERIOR WALL BRACKET FIXTURES SHALL BE INSTALLED AS NOTED ON PLANS.

APPROVED SMOKE DETECTORS SHALL BE LOCATED ON EVERY STORY OF THE DWELLING UNIT AS PER IRC CTION R317 (SEE SHEET B1.1 FOR LOCATIONS). WHERE MORE THAN ONE DETECTOR IS REQUIRED THEY SHALL BE INTERCONNECTED. POWER SOURCE SHALL BE BUILDING POWER w/ BATTERY BACKUP.)) CONDUCTORS SHALL BE OF COPPER.

GENERAL FRAMING SPECS AND CONSTRUCTION NOTES STAIRS:

1) THE MAXIMUM RISER HEIGHT SHALL BE 7 3/4 INCHES AND THE MINIMUM TREAD DEPTH SHALL BE 10 NCHES IN ACCORDANCE WITH SECTION I.R.C.

HANDRAILS HAVING MINIMUM AND MAXIMUM HEIGHTS OF 34 INCHES AND 38 INCHES SHALL BE OVIDED ON AT LEAST. ONE SIDE OF STAIRWAYS IN ACCORDANCE WITH SECTION R315.1 - I.R.C HANDRAIL AND BALUSTRADE (WHERE PRESENT) SHALL BE CONSTRUCTED. ACCORDING TO IRC. ALL REQUIRED HAND RAILS SHALL BE CONTINUOUS THE FULL LENGTH OF THE STAIRS W/ 2 OR MORE SERS FROM A POINT ABOVE THE THE TOP RISER OF A FLIGHT TO A POINT ABOVE THE LÓWEST RISER OF THE FLIGHT. ENDS SHALL BE RETURNED OR SHALL TERMINATE AT NEWEL POSTS OR SAFETY TERMINALS. ANDRAILS ADJACENT TO A WALL SHALL HAVE A SPACE OF NOT LESS THAN 1.5" BETWEEN THE WALL

WALLS:

) ALL DIMENSIONS ARE FROM FACE OF STUD TO FACE OF STUD. ALL STUDS ARE 3 1/2" UNLESS NOTED. LL DIMENSIONS PRESENTED HERE ARE FRAME DIMENSIONS ONLY.

SEPARATION BETWEEN THE RESIDENCE AND THE GARAGE SHALL BE MAINTAINED BY INSTALLATION OF $rac{1}{2}^n$ GYPSUM BOARD ON ALL COMMON WALLS. 2-STORY HOMES REQUIRE 5/8" TYPE X GYPSUM BOARD AT CARAGE CEILINGS WHERE HABITABLE ROOMS ARE PRESENT ABOVE.

FLOORS:

STRUCTURAL FLOOR MEMBERS SHALL NOT BE CUT, BORED, OR NOTCHED IN EXCESS OF THE LIMITATIONS ECIFIED IN IRC

) THE ENDS OF EACH JOIST, BEAM, OR GIRDER SHALL HAVE NOT LESS THAN 1.5 INCHES OF BEARING ON WOOD OR METAL AND NOT LESS THAN 3 INCHES ON MASONRY OR CONCRETE OR AS OTHERWISE SPECIFIED

) ALL DIMENSIONAL FLOOR JOISTS TO BE PER ENGINEER STRUCTURAL PLANS.

FRAMING:

ALL FRAMING DIMENSIONS TO FACE OF MEMBER.

ALL BEARING HEADERS TO BE PER ENGINEERING PLANS. FIRE STOPPING AND/ OR DRAFT STOPPING SHALL MEET THE REQUIREMENTS OF IRC R602.8.

ROOF

) HIP AND VALLEY RAFTERS SHALL BE SUPPORTED AT RIDGE DOWN TO BEARING PARTITION. CUT ENDS OF AFTERS SHALL BE FULLY SUPPORTED WALL AND RIDGE

) REQUIRED VENTILATION AREAS CALCULATED AT 1/300 RATIO.

SQUARE FOOTAGE

Elevation "A"

(Slab S.F.)	
Slab Area	Sq. Ft
FIRST FLOOR	1674
2 BAY GARAGE	405
PORCH	24
COVERED OUTDOOR LIVING	162
Total Slab Area	226

(Outside of Frame S.F.)		
A/C Area	Sq. Ft.	
FIRST FLOOR	1674	
Total A/C Area	1674	
Non-A/C Area	Sq. Ft.	
2 BAY GARAGE	405	
PORCH	24	
COVERED OUTDOOR LIVING	162	
Total Non-A/C Area	541	

(Inside of Frame	S.F.)
C Area	Sq. Ft.
RST FLOOR	1625
otal A/C Area	1625

NOTE: ALL OPTIONAL SQUARE FOOTAGES
LISTED ARE INDEPENDENT OF AND IN
ADDITION TO BASE SQUARE FOOTAGES

OPTIONS XT. COV. OUTDOOR LIVING +114

REQUIRED AT **GARAGE SIDE & NON-GARAGE SIDE**

BUILDING CODE COMPLIANCE

CONSTRUCTION PLANS DESIGNED TO MEET OR EXCEED MINIMUM CODE REQUIREMENTS OF 2018 LR (

FLECTRICAL PLANS DESIGNED TO MEET OR EXCEED MINIMUM.

TABLE OF CONTENTS

SHEET NO.	TYPE OF SHEET/LAYOUT
"G0.01"	COVER SHEET & GEN. NOTES
"G0.11"	REVISIONS & SYMBOLS
"S1.10A"	BASE FOUNDATION PLAN — ELEVATION 'A'
"A1.10A"	FIRST FLOOR PLAN - ELEVATION 'A'
"01.A10"	FLOOR PLAN OPTIONS
"A2.01A"	EXTERIOR ELEVATIONS - 'A'
"A2.02A"	EXTERIOR ELEVATIONS - 'A'
"A2.03A"	EXTERIOR ELEVATIONS - OPTIONS - 'A'
"A2.04A"	EXTERIOR ELEVATIONS - OPTIONS - 'A'
"A3.01A"	ROOF PLAN - ELEVATION 'A'
"A3.02A"	ROOF PLAN - OPTION - ELEVATION 'A'
"A4.01"	INTERIOR DETAIL SHEET
"E1.10A"	1ST FLR. ELECTRICAL PLAN — ELEVATION 'A'
"E1.11A"	1ST FLR. ELECTRICAL PLAN UPGRADE OPTIONS — ELEVATION 'A'
"01.E10"	1ST FLR. ELECTRICAL PLAN OPTIONS
"01.E11"	1ST FLR. ELECTRICAL PLAN UPGRADE OPTIONS
"D1.0"	DETAILS

Serenity Lot 292

5919-03 Oak Haven Elevation A Right Hand Garage Under 9.000 FT²

*Opt. Primary Bath 1 w/ Zero Entry Pan

*Opt. Grab Bars at Primary Shower

*Opt. Grab Bars at Primary Water Closet

*Opt. Pre-Plumbing w/ Hand Shower

*Opt. Laundry Sink w/ Base & Upper Cabs *Opt. Outdoor Living Patio

*Opt. Screened Covered Outdoor Living

*Opt. Office ILO Flex Space

*Opt. Bath 2 Shower ILO Tub w/ Vikrell Walls

*Opt. Recirculating Tankless Water Heater

*Opt. UV Light Air Cleaner

*Opt. Fire-Rated Garage Side

*Opt. Fire-Rated Non-Garage Side

SYMBOLS



Dointe C H O M E S C HUO, SUITE 400, RALEICH, NO 275077

Blvd Business Operation 5440 Wade Park Blv Suite 400 Raleigh, NC 27607

GENERAL ૐ 0 SHE

SUBDIVISION: ADDRESS: LOT: 292

10-01-24 Issue Date: ACC

5919-03

OAK HAVEN

G0.01

REVISION INDEX			
REL. #	DESCRIPTION	DATE	DRAWN BY
5919-03	NEW PLAN	10/01/2024	ACC
	ADDED ATTIC PULL-DOWN, REVISED ROD/SHELF IN PRIMARY WIC, ADDED OPTIONS - SCREENED COVERED OUTDOOR LIWING, GOURMET KITCHEN KITCHEN KITCHEN, ZERO ENTRY SHOWER AT PRIMARY BATH, ADDED TRIM SURROUNDING VENTS AT VARIOUS ELEVATIONS, REVISED BENCH DETAIL, ADDED OPT. LAUINDRY CABINETS, ADDED (2) 4-LED LIGHTS IN GARAGE, REVISED LECT LIGHTING AND SWITCHES IN PRIMARY BATH, ADDED DISHWASHER ACCESSIBLE DISCONNECT SWITCH AND COUNTER-TOP AIR SWITCH FOR DISPOSAL NOTES	01/19/2025	ACC
	ADDED SHOWER NICHE NOTE, ADDED CURB TO SHOWERS, REVISED INT/EXT FIREPLACE DEPTHS, REVISED OPENING HEADER HEIGHTS THROUGHOUT, REVISED BEAR EXTERIOR DOOR TO 3, ADDED DOOR HEIGHTS TO MAIN FLOOR NOTES, ADDED BATH ACCESSORY HEIGHTS TO MAIN FLOOR NOTES, ADDED ZERO ENTRY SHOWER DETAIL, REMOVED PRIMARY BATH 2 OPTION, ADDED DUTIONG FUNING PATO OPTION, ADDED AUTIONAL SHOWER NICHE DETAIL, ADDED GOURMET KITCHEN INTERIOR, REVISED ELECTRICAL / ELECTRICAL OPTION AT GREAT ROOM AND PRIMARY BATH.	04/13/2025	ACC
	ADDED TYPICAL CLOSET ROD AND SHELF DETAILS, ADDED SHOWER NICHE DETAILS, REMOVED KITCHEN ISLAND "TOP SIZE" NOTE, REDUCED KITCHEN ISLAND SIZE, REVISED CLOSET ROD AND SHELF, ADDED OPT. FIREPLACE TO FOUNDATION PLAN, ADDED GABLE WINDOW DIMENSIONS, ADDED INSIDE PORCH PARTIAL ELEVATIONS, ADDED VARIOUS ELECTRICAL, NOTES, ADDED SWITCHES TO OPTIONAL ELECTRICAL SHEETS,	07/27/2025	ACC
	ADDED OPTIONAL BEAMS IN PRIMARY SUITE, ADDED OPTIONAL GRAB BARS IN ALL BATHS, REVISED TOWEL BAR AND HOLDER HEIGHTS	09/06/2025	ACC

	l

tri pointe HOMES 5440 WAE PARK BLVD, SUITE 400, RALEIGH, NG 27607

Business Operations 5440 Wade Park Blvd Suite 400 Raleigh, NC 27607

SUBDIVISION: ALTIS ® SERENITY
ADDRESS: FUGUAY-VARINA, NC 27526
LOT: 292 BLOCK:


Issue Date: 10-01-24

Drawn By: ACC

5919-03

OAK HAVEN

G0.11

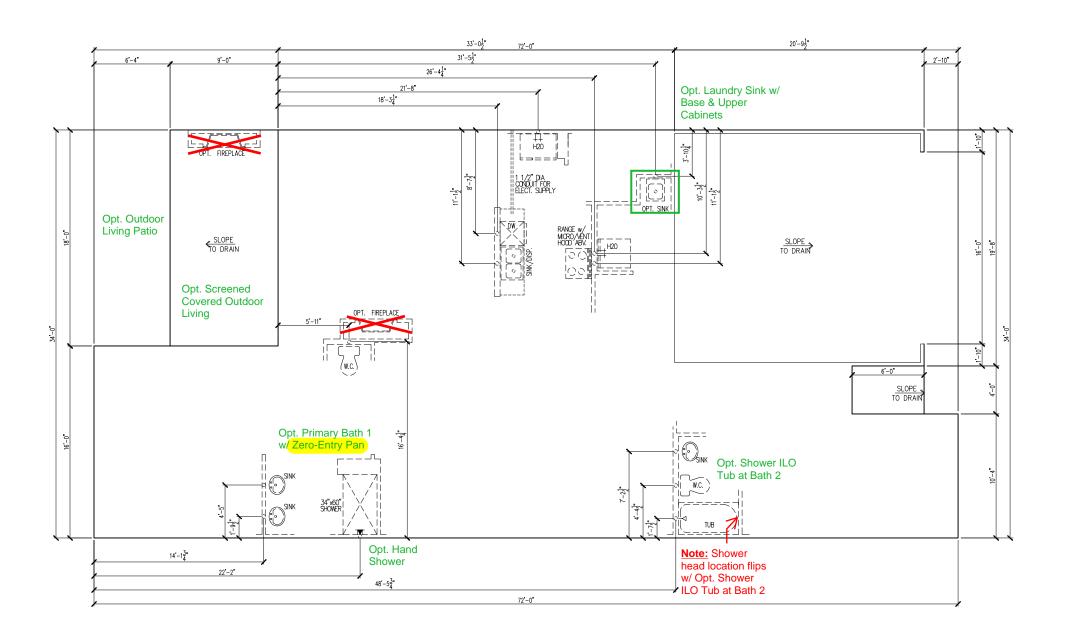

tri pointe.

H o M E S

5440 WADE PARK BLVD, SUITE 400, RALEIGH, NC 27607

Business Operations 5440 Wade Park Blvd Suite 400 Raleigh, NC 27607

BASE FOUNDATION PLAN
IVISION: ALTIS @ SERENITY
ESS: 1182 SERENE CROSSING
ESS: ELOUINY VARIAN ALTIS OF THE CONTROL OF THE CONTR

SUBDIVISION: ALTIS @ SERENITY
ADDRESS: 182 SERENE CROSSING,
LOT: 292 BLOCK:

Issue Date: 10-01-24
Drawn By: ACC

5919-03

OAK HAVEN

S1.10A

MAIN FLOOR NOTES EXPLANATION ALL NON-DIMENSIONED PARTITIONS ARE 3-1/2" ROUGH ALL ANGLED PARTITIONS ARE 45 DEGREES UNLESS NOTED PROVIDE MIN. 2-2x12's w/ 1/2" PLYWD. FLITCH PLATE AT ALL EXTERIOR WALL OPENINGS & INTERIOR BEARING WALL OPENINGS ALL EXTERIOR DIM'S ARE TO FACE OF STUDS U.N.O. ALL TRUSSES TO BEAR ON EXTERIOR WALLS AND/OR GIRDER TRUSS MFG. TO SIZE MEMBERS, FASTENERS, HANGERS & SET SPACING FOR ALL TRUSSES WINDOW SUPPLIER TO VERIFY AT LEAST ONE WINDOW IN ALL BEDROOMS TO HAVE A CLEAR EGRESS OPENING OF 5.7 SQ. FT. w/MIN DIM'S OF 24" IN HT AND 20" IN WIDTH; SILL HT NOT TO EXCEED 44" AFF ALL BALUSTER TO BE SPACED SUCH THAT A 4" SPHERE CANNOT PASS BETWEEN BALUSTER ALL ELEC. & MECH. EQUIPMENT & METERS ARE SUBJECT TO RELOCATION DUE TO FIELD CONDITIONS; CONTRACTOR TO FOR ADDITIONAL NOTES, SEE GENERAL NOTES ON TITLE SHEET ALL TYP. WINDOWS 6'-0" IN HT AND SMALLER, THE HEAD HEIGHT SHALL BE 8'-10" ABOVE FINISHED FLOOR (U.N.O.) STRUCTURAL ENGINEERING PROVIDED BY OTHERS REFER TO INTERIOR ELEVATIONS SHEET TO VIEW BUBBLE INTERIOR DOOR HEIGHTS ARE AS FOLLOWS - PRIMARY SUITE, PRIMARY BATH, & PRIMARY CLOSET ARE 8' TALL DOORS. ALL OTHER DOORS ARE 6'-8". BATH ACCESSORY INSTALLATION HEIGHTS ARE MEASURED TO CENTER OF ACCESSORY TR - 20" ABV. VANITY COUNTER-TO TR - 60" A.F.F. OPT. GRAB BAR (GB) - 36" A.F.F. SHUT-OFF VALVE TO BE LOCATED IN GARAGE ROD AND SHELF HEIGHTS ARE MEASURED TO TOP OF ROD AND

BOTTOM OF SHELVES - SEE D-1.0 FOR DETAILS: 1R1S -ROD - 5'-8" 2R2S -TOP ROD - 6'-8"

TOP SHELF - 6'-10"

BOTTOM ROD - 3'-4"

Serenity Lot 292 5919-03 Oak Haven Elevation A Right Hand Garage Under 9.000 FT²

*Opt. Primary Bath 1 w/ Zero Entry Pan

*Opt. Grab Bars at Primary Shower

*Opt. Grab Bars at Primary Water Closet

*Opt. Pre-Plumbing w/ Hand Shower

*Opt. Laundry Sink w/ Base & Upper Cabs

*Opt. Outdoor Living Patio

*Opt. Screened Covered Outdoor Living

*Opt. Office ILO Flex Space


*Opt. Bath 2 Shower ILO Tub w/ Vikrell Walls

*Opt. Recirculating Tankless Water Heater

*Opt. UV Light Air Cleaner

*Opt. Fire-Rated Garage Side

*Opt. Fire-Rated Non-Garage Side

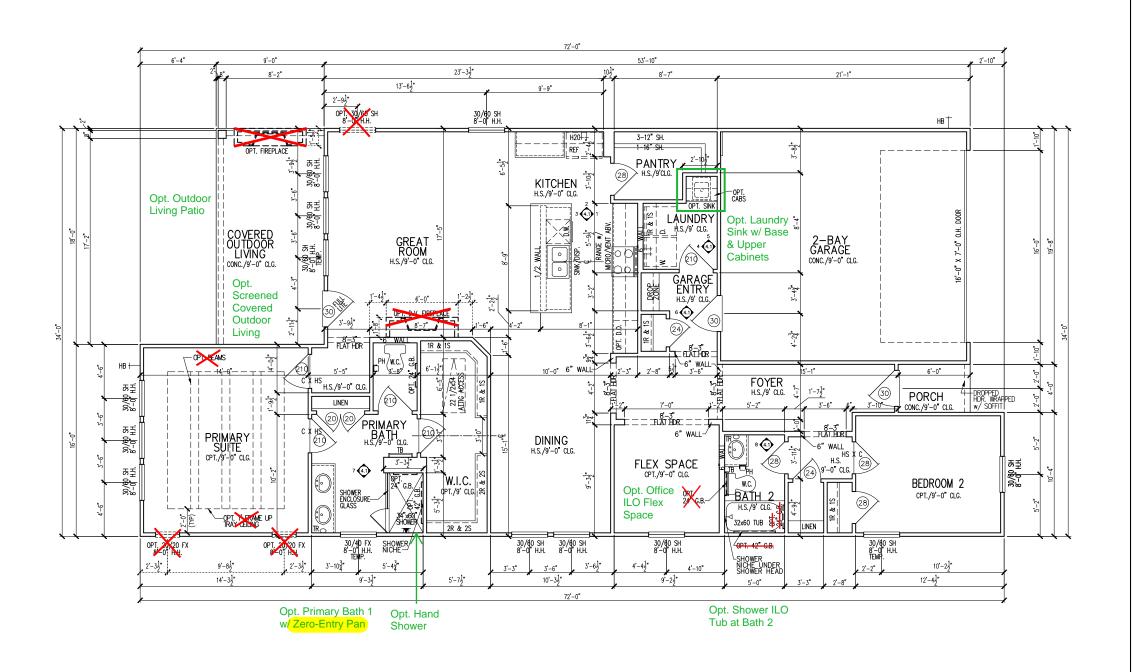

UNDER 9,000 FT² FIRE-RATED WALL
REQUIRED AT
GARAGE SIDE &
NON-GARAGE SIDE

tri pointe.
HOMES

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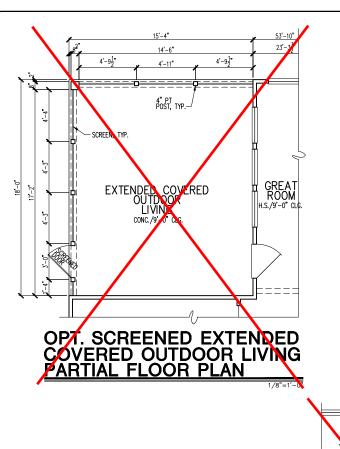
Issue Date: 10-01-24


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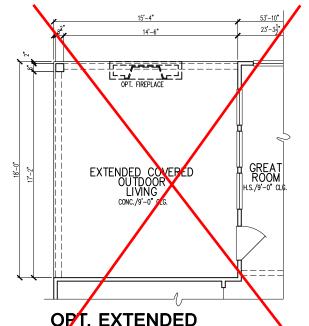
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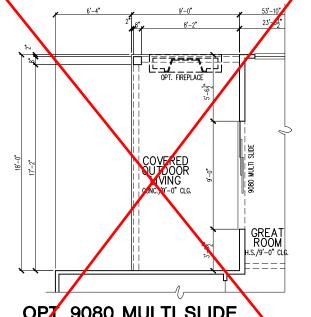
OAK HAVEN

A1.10








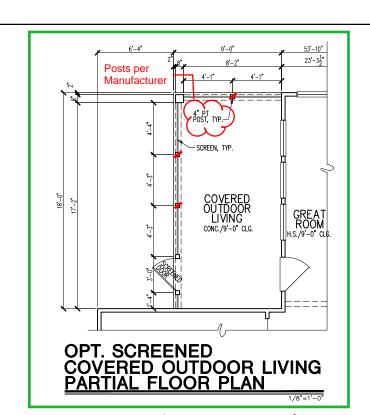

OPT. EXTENDED COVERED OUTDOOR LIVING PARTIAL FLOOR PLAN

OP7. 9080 MULTI SLIDE DOOR AT GREAT RROM PARTIAL FLOOR PLAN



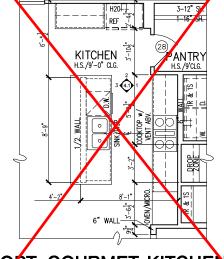

OPT. GOURMET KITCHEN 1 PARTIAL FLOOR PLAN

OPT. GOURMET KITCHEN 2 PARTIAL FLOOR PLAN

OFFICE

OPT. OFFICE ILO FLEX SPACE PARTIAL FLOOR PLAN

30/60 SH 8'-0" H.H.

PARTIAL FLOOR PLAN W.I.C. LINEN CPT./9' CLG PRIMARY (219) Bath 1 w/ **OPT. PRIMARY BATH 1**

PARTIAL FLOOR PLAN

8 🐠 32x60 SHWR. ∜BATH 2≫ SHOWER NICHE UNDER SHOWER HEAD **OPT. SHOWER**

ILO TUB AT BATH 2 PARTIAL FLOOR PLAN

Opt. Hand

10-01-24 ssue Date: ACC

SUBDIVISION;ALTIS @ SERENITY

ADDRESS:

Point B S H O M E S H O M E S

は

Business Operations 5440 Wade Park Blvd Suite 400 Raleigh, NC 27607

OPTIONS

FLOOR

5919-03

OAK HAVEN

01.A10

MAIN FLOOR NOTES

EXPLANATION

TRUSS U.N.O.

1. ALL NON-DIMENSIONED PARTITIONS ARE 3-1/2" ROUGH

ALL ANGLED PARTITIONS ARE 45 DEGREES UNLESS NOTED OTHERWISE (U.N.O.)

PROVIDE MIN. 2-2x12's w/ 1/2" PLYWD. FLITCH PLATE AT ALL EXTERIOR WALL OPENINGS & INTERIOR BEARING WALL OPENINGS

ALL EXTERIOR DIM'S ARE TO FACE OF STUDS U.N.O.

ALL TRUSSES TO BEAR ON EXTERIOR WALLS AND/OR GIRDER

TRUSS MFG. TO SIZE MEMBERS, FASTENERS, HANGERS & SET SPACING FOR ALL TRUSSES

WINDOW SUPPLIER TO VERIFY AT LEAST ONE WINDOW IN ALL BEDROOMS TO HAVE A CLEAR EGRESS OPENING OF 5.7 SQ. FT. w/MIN DIM's OF 24" IN HT AND 20" IN WIDTH; SILL HT NOT TO

ALL BALUSTER TO BE SPACED SUCH THAT A 4" SPHERE CANNOT PASS BETWEEN BALUSTER

ALL ELEC. & MECH. EQUIPMENT & METERS ARE SUBJECT TO RELOCATION DUE TO FIELD CONDITIONS; CONTRACTOR TO

FOR ADDITIONAL NOTES, SEE GENERAL NOTES ON TITLE SHEET

ALL TYP. WINDOWS 6'-0" IN HT AND SMALLER, THE HEAD HEIGH SHALL BE 8'-10" ABOVE FINISHED FLOOR (U.N.O.)

STRUCTURAL ENGINEERING PROVIDED BY OTHERS

REFER TO INTERIOR ELEVATIONS SHEET TO VIEW BUBBLE CALLOUTS

PRIMARY BATH, & PRIMARY CLOSET ARE 8' TALL DOORS. ALL OTHER DOORS ARE 6'-8".

BATH ACCESSORY INSTALLATION HEIGHTS ARE MEASURED TO CENTER OF ACCESSORY

TB - 60" A.F.F. TR - 20" ABV. VANITY COUNTER-TOP TP - 26" A.F.F. OPT. GRAB BAR (GB) - 36" A.F.F.

SHUT-OFF VALVE TO BE LOCATED IN GARAGE


BOTTOM OF SHELVES - SEE D-1.0 FOR DETAILS: 2R2S -TOP ROD - 6'-8" SHELF - 5'-10" TOP SHELF - 6'-10"

BOTTOM ROD - 3'-4"

REF

KITCHEN H.S./9'-0" CLG.

ANTRY H.S. /9'CLG.

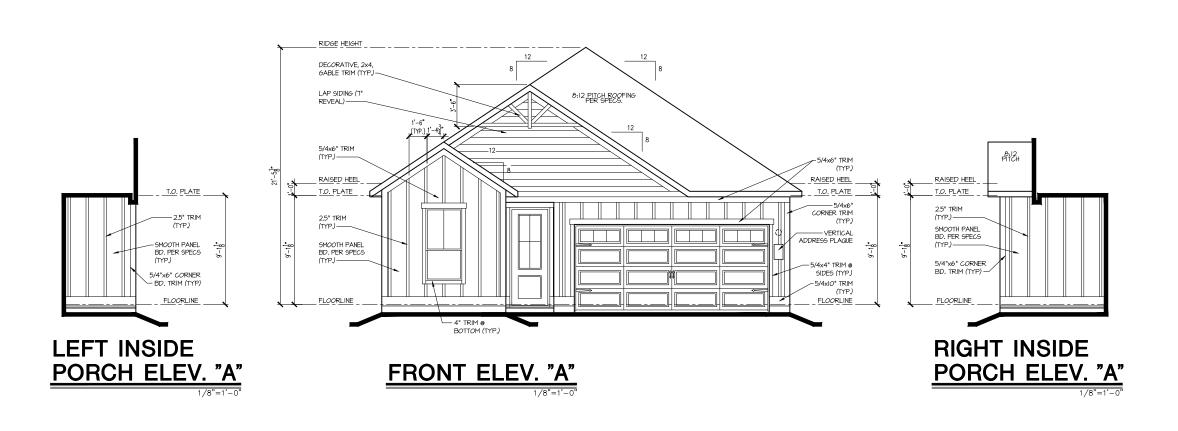

Serenity Lot 292


5919-03

Oak Haven

Elevation A Right Hand Garage

Under 9,000 FT²

- *Opt. Primary Bath 1 w/ Zero Entry Pan
- *Opt. Grab Bars at Primary Shower
- *Opt. Grab Bars at Primary Water Closet
- *Opt. Pre-Plumbing w/ Hand Shower
- *Opt. Laundry Sink w/ Base & Upper Cabs
- *Opt. Outdoor Living Patio
- *Opt. Screened Covered Outdoor Living
- *Opt. Office ILO Flex Space
- *Opt. Bath 2 Shower ILO Tub w/ Vikrell Walls
- *Opt. Recirculating Tankless Water Heater
- *Opt. UV Light Air Cleaner
- *Opt. Fire-Rated Garage Side
- *Opt. Fire-Rated Non-Garage Side

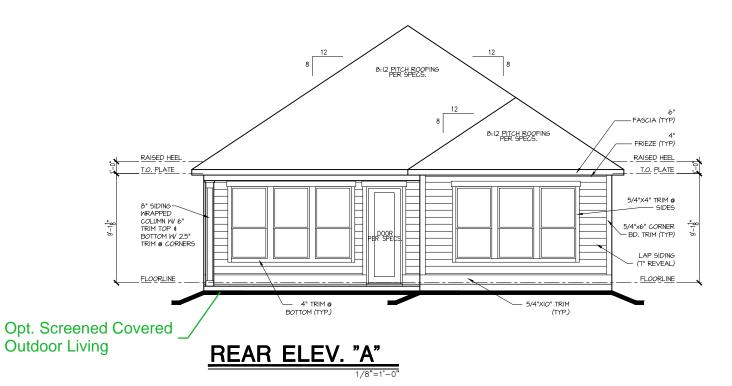

UNDER 9,000 FT² -FIRE-RATED WALL REQUIRED AT GARAGE SIDE & NON-GARAGE SIDE Tribointe HOMES HOMES A400 WADE PARK BLVD. SUITE 400, RALEICH, NC 27607

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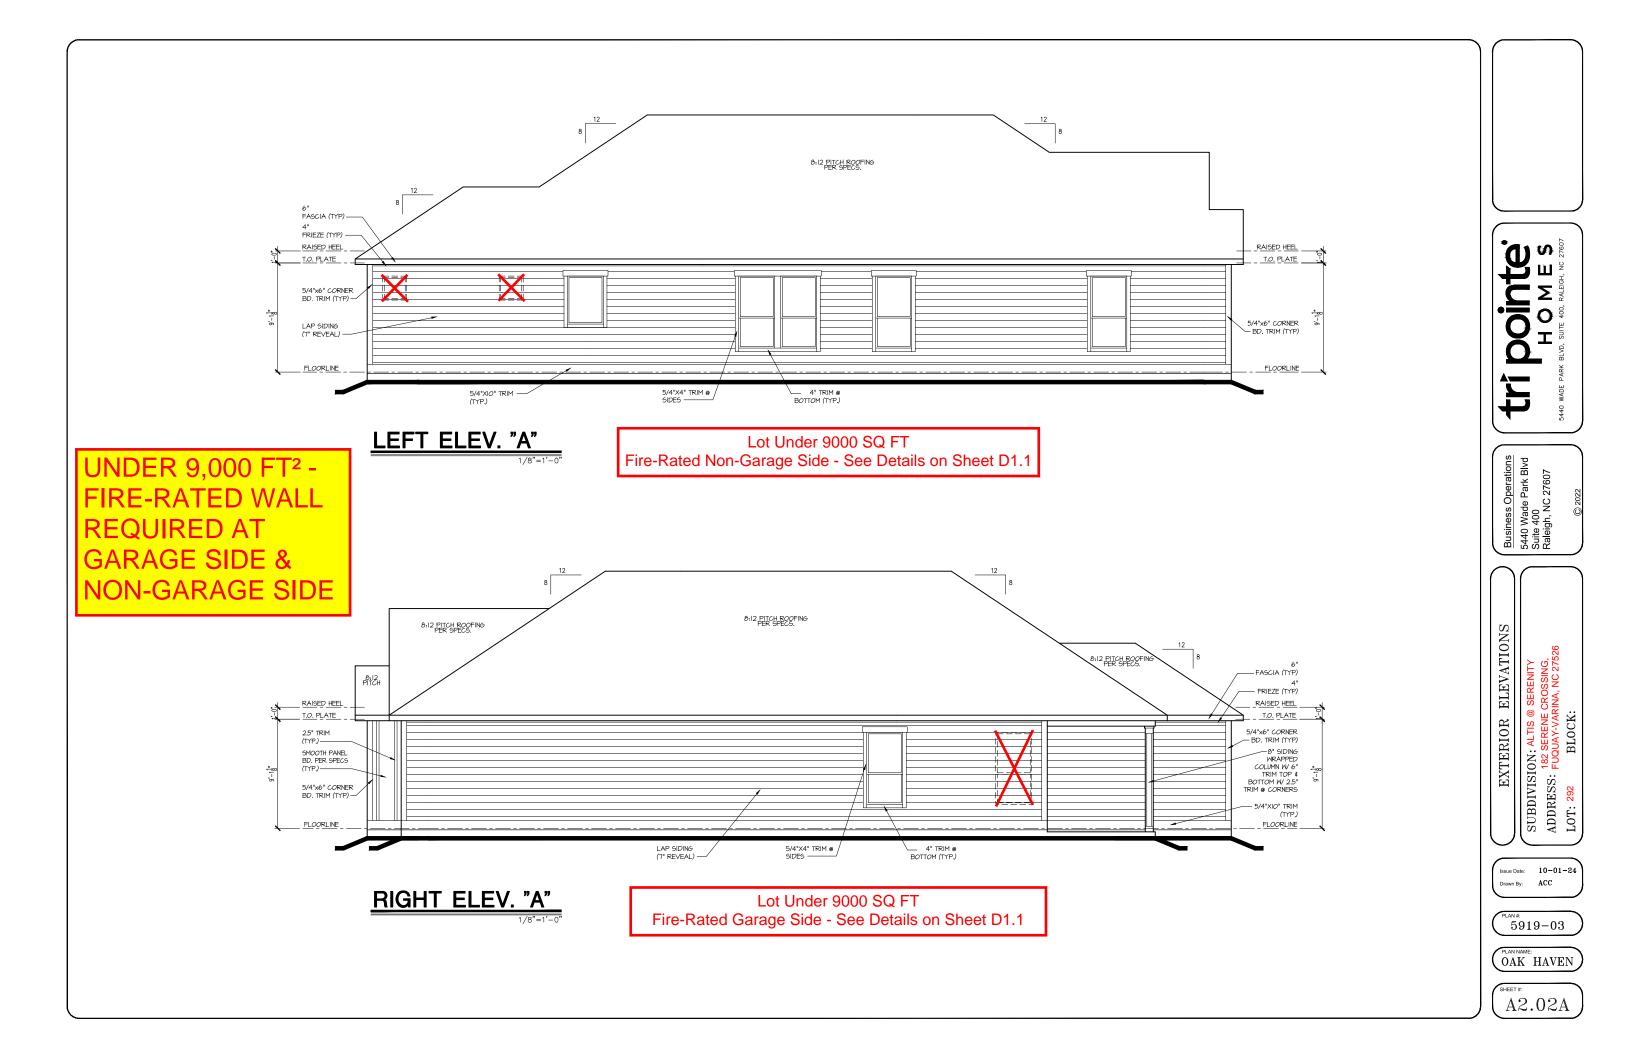
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LOT: 292 BLOCK:


Issue Date: 10-01-24
Drawn By: ACC

5919-03

OAK HAVEN

(A2.01A



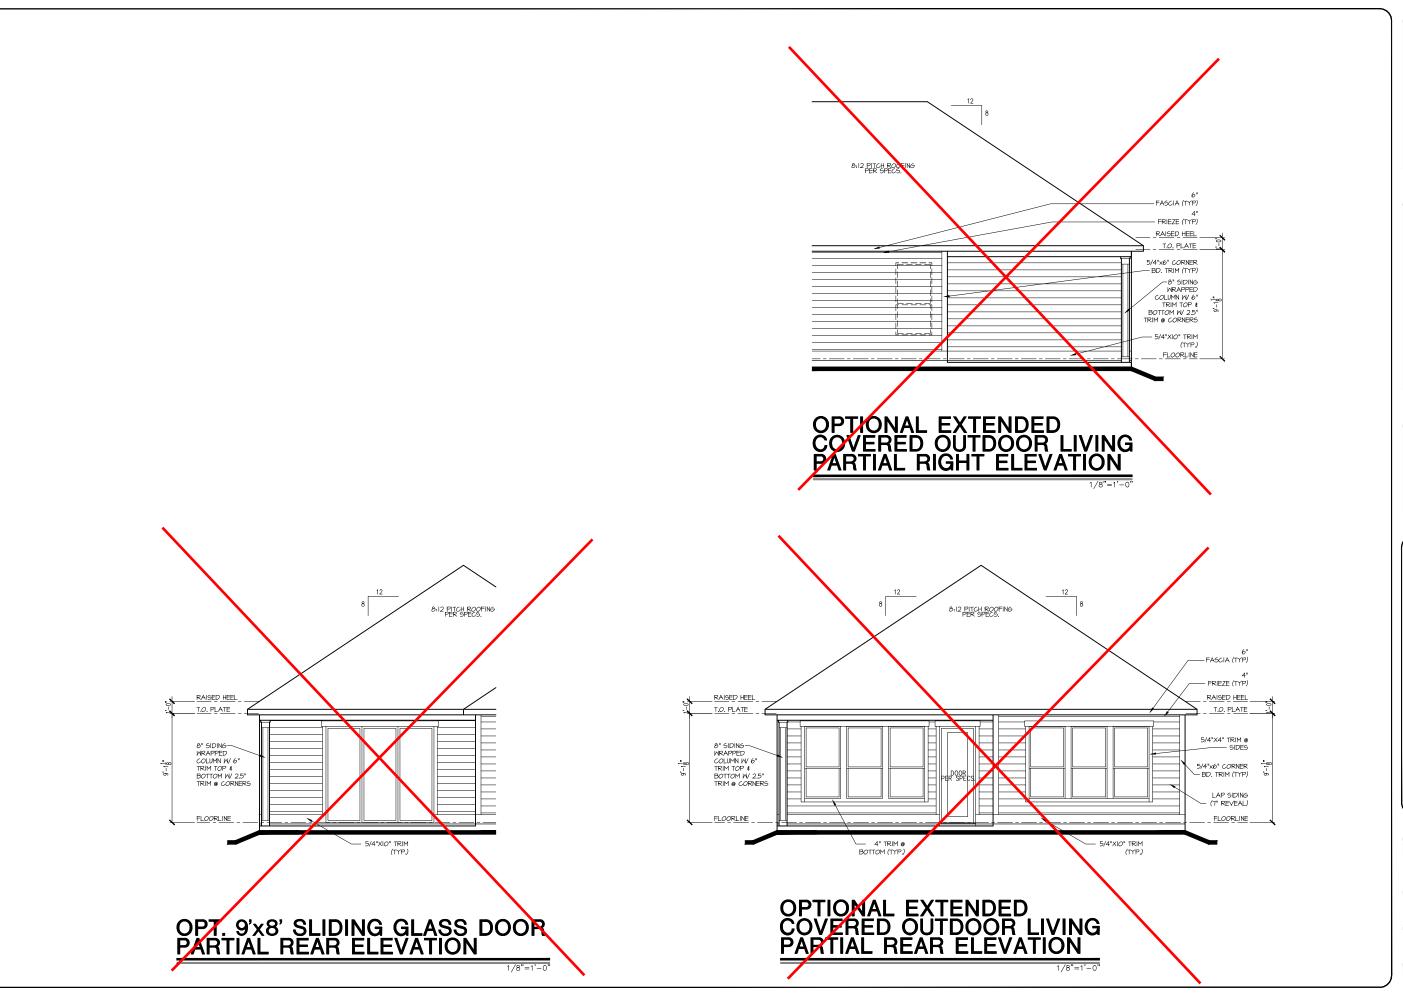

tri pointe Homes 5440 WADE PARK BLVD, SUITE 400. RALEIGH, NG 27607

Business Operations 5440 Wade Park Blvd Suite 400 Raleigh, NC 27607


OPTIONS SUBDIVISION: ALTIS @ SERENITY
182 SERENE CROSSING,
182 SERENE CROSSING,
102 SERENE CROSSING,
103 SERENE CROSSING,
104 SERENE SERENE CROSSING,
105 SERENE CRO EXTERIOR ELEVATIONS


Issue Date: 10-01-24 Drawn By: ACC

5919-03

OAK HAVEN

A2.03A

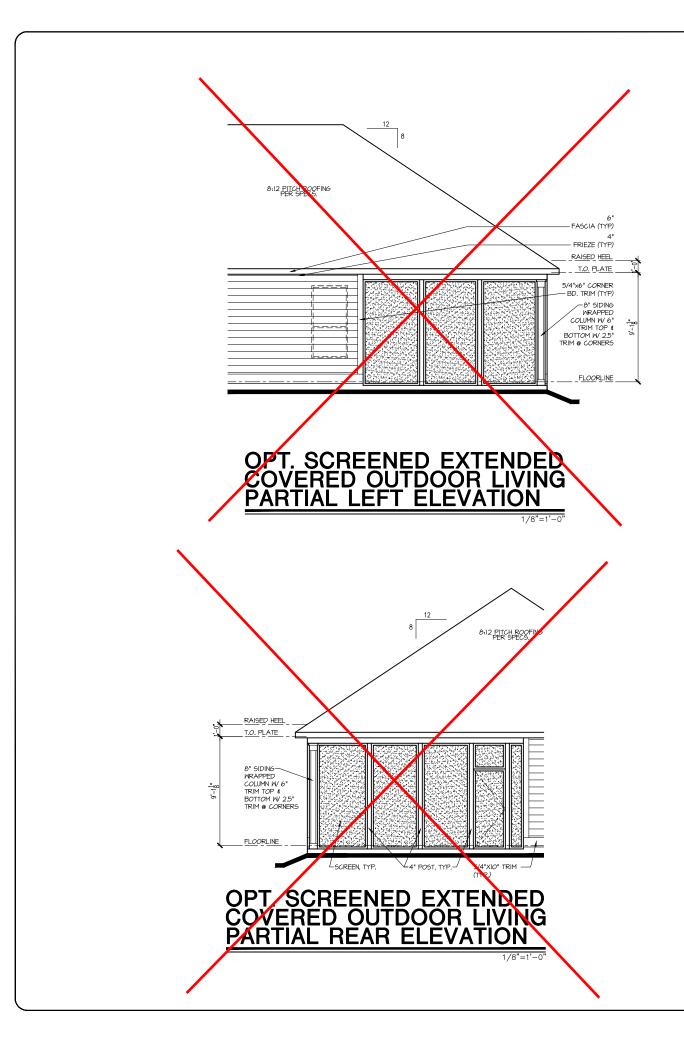

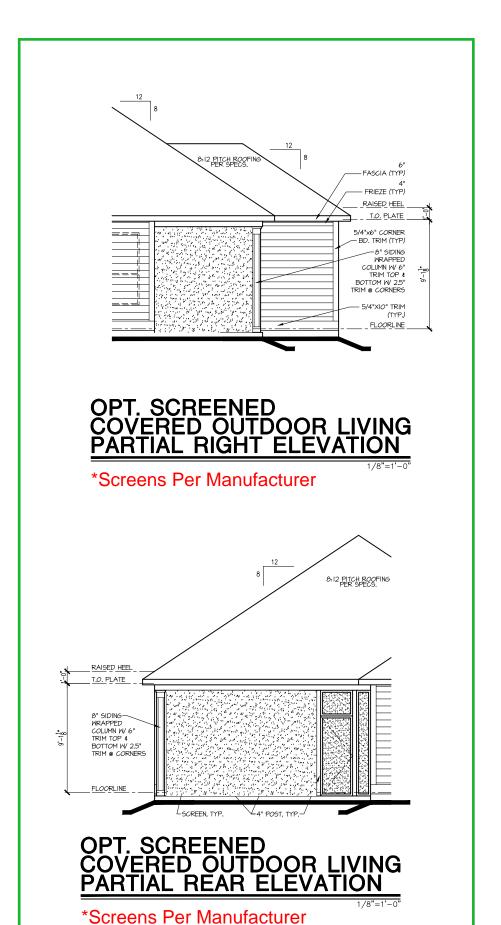

Dointe HOMES RR BLYD. SALEIGH, NG 27607

Business Operations 5440 Wade Park Blvd Suite 400 Raleigh, NC 27607


OPTIONS SUBDIVISION: ALTIS @ SERENITY
182 SERENE CROSSING,
ADDRESS: FUQUAY-VARINA, NC 275
LOT: 292
BLOCK: EXTERIOR ELEVATIONS


Issue Date: 10-01-24 ACC

5919-03

OAK HAVEN

A2.04A

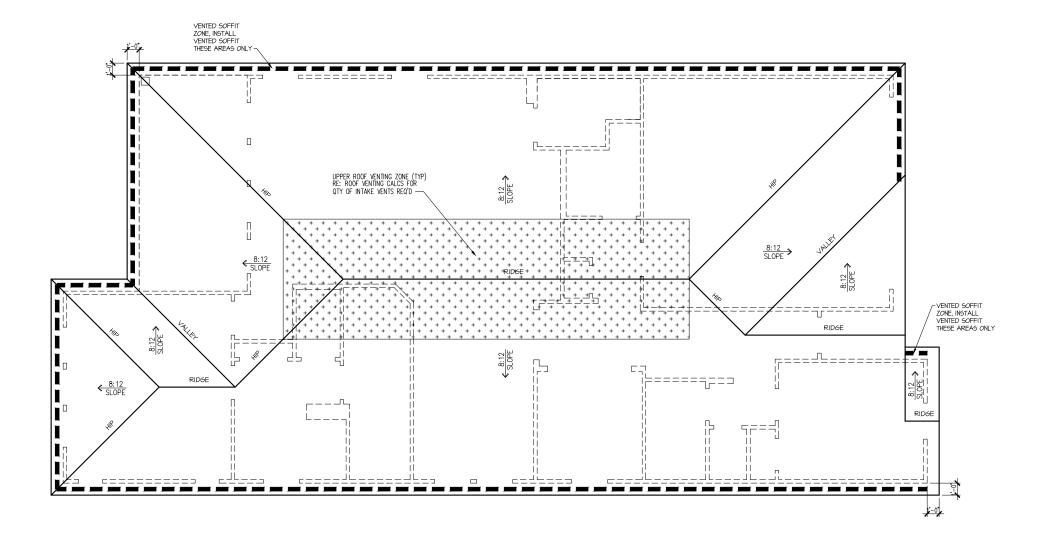

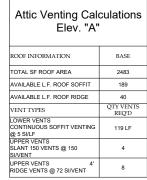

NOTE:
OTY OF UPPER VENTS SHOWN COVERS 100% OF UPPER VENTING. NO MIXING OF VENT TYPES FOR UPPER VENTING IS FIGURED FOR IN THIS TABLE.



Dointe HOMES ** BLYD, SALEGH, NG 27807

Business Operations 5440 Wade Park Blvd Suite 400 Raleigh, NC 27607

SUBDIVISION: ALTIS @ SERENITY
ADDRESS: FUQUAY-VARINA, NC 2752
LOT: 292
BLOCK: ROOF PLAN


Issue Date: 10-01-24

Drawn By: ACC

5919-03

OAK HAVEN

A3.01A

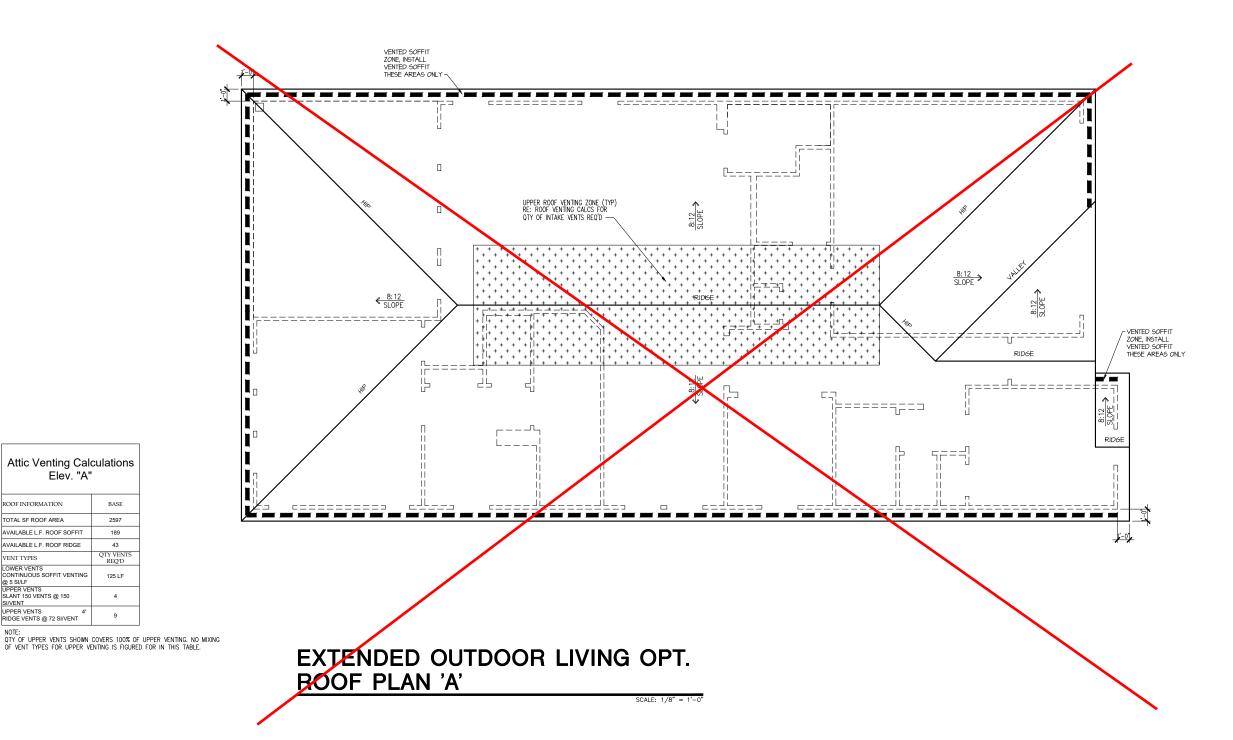

Attic Venting Calculations Elev. "A"

BASE

189

ROOF INFORMATION

TOTAL SF ROOF AREA AVAILABLE L.F. ROOF SOFFIT

AVAILABLE L.F. ROOF RIDGE

VENT TYPES
LOWER VENTS
CONTINUOUS SOFFIT VENTING
@ 5 SIJLE
UPPER VENTS
SLANT 150 VENTS @ 150
SIJVENT
UPPER VENTS
4'
RIDGE VENTS @ 72 SIJVENT

Business Operations 5440 Wade Park Blvd Suite 400 Raleigh, NC 27607

OPTION ROOF


SUBDIVISION: ALTIS @ SI 182 SERENE CR ADDRESS: FUQUAY-VARIN LOT: 292 BLOCK:

Issue Date: 10-01-24 Drawn By: ACC

5919-03

OAK HAVEN

A3.02A

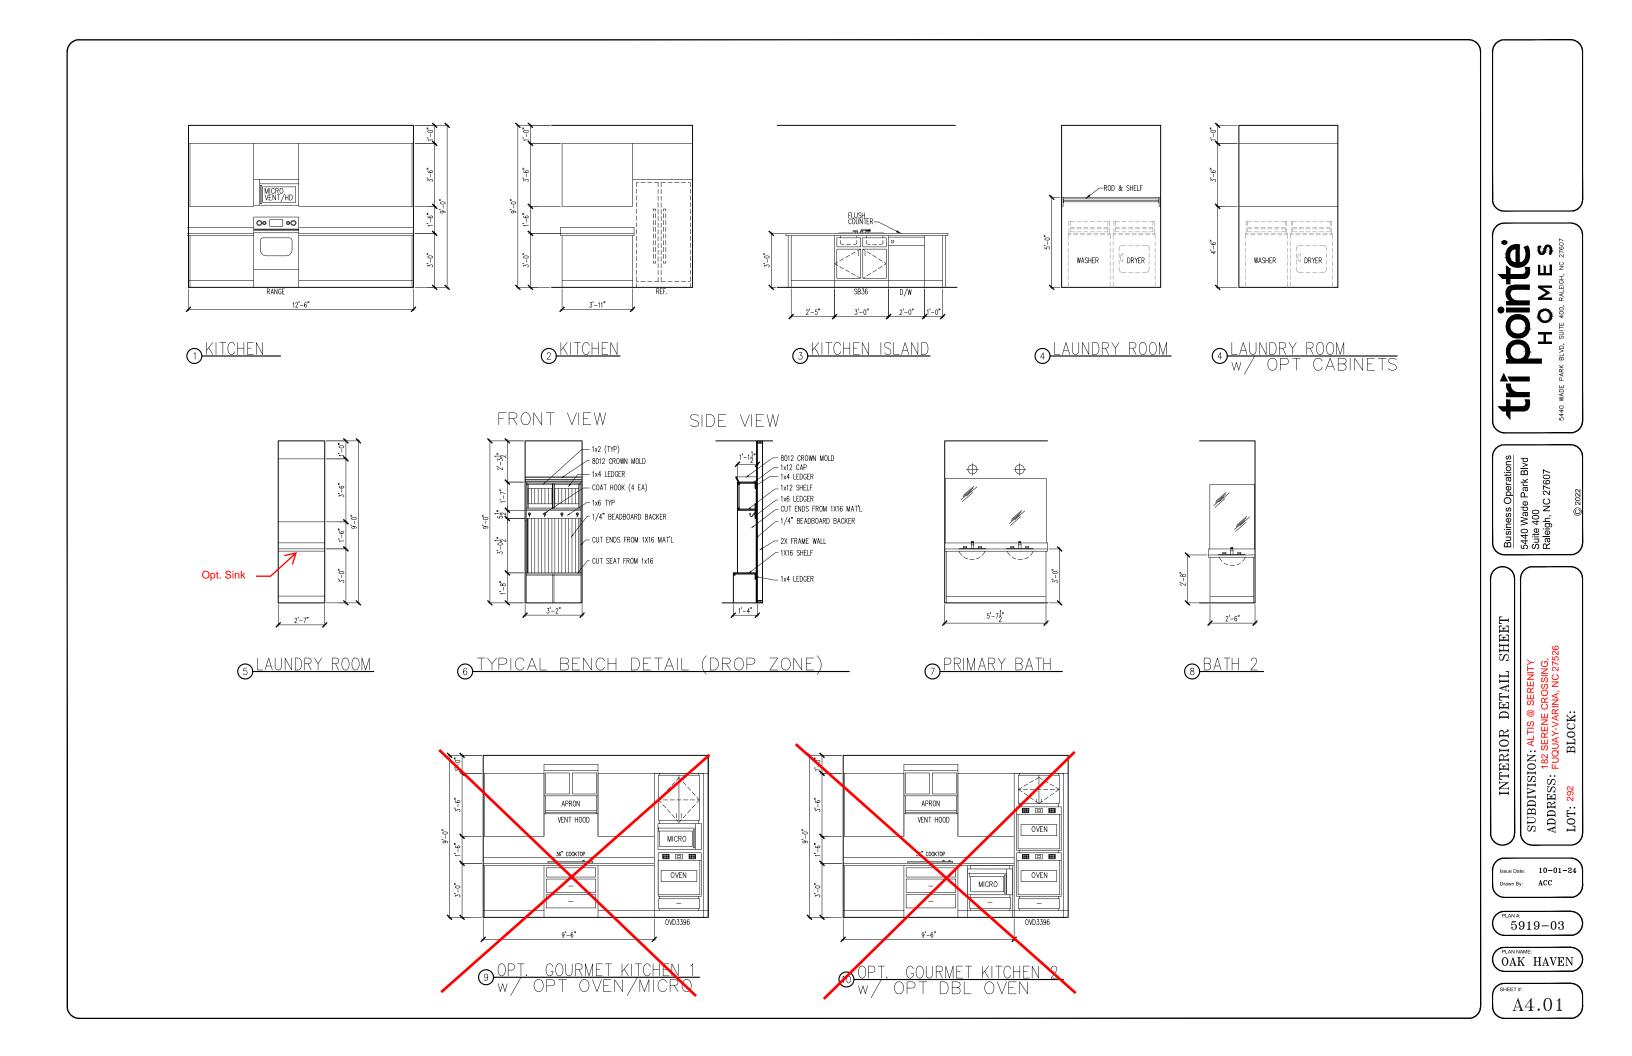


ELECTRICAL I SCHEDU	FIXTURE LE
DESCRIPTION	SYMBOL
110V OUTLET	Ф
220V OUTLET	\$ 220
1/2 HOT OUTLET	₩
GFI OUTLET	∜\$, GFI
WP GFI OUTLET	% WP/GFI
GARAGE DOOR OPENER OUTLET	Ø GDO
SECURITY SYSTEM	∯SEC SYS
DISHWASHER	⊕DW
JUNCTION BOX	(I)
CEILING MOUNTED LIGHT	
CEILING FAN w/ LIGHT KIT	ERAVIDE
RECESSED CEILING LIGHT	Ø
RECESSED WATER PROOF LIGHT) ⊠ WP
WALL MOUNTED LIGHT	φ
WALL MOUNTED PUSH BUTTON	₫ PB
TWO WAY SWITCH	\$
THREE WAY SWITCH	³\$
FOUR WAY SWITCH	*\$
DIMMER SWITCH	\$ ^{DIM}
EXHAUST VENTS	S VENT TO EXT
LOW VOLTAGE PANEL	\$
PHONE OUTLET	● PH
TV OUTLET	⊕ TV
DATA & RG6 COMBO BOX	•
SMOKE DETECTOR	<u>(S</u>)
CARBON MONOXIDE SMOKE DETECTOR COMBO	⊚ CM/SD
DOOR CHIMES	CHIMES
ELECTRICAL PANEL	EP EP
SURFACE MOUNT LED	
EXTERIOR WALL MOUNT UPLIGHT	8
SOFFIT MOUNT FLOOD LIGHT	43
UNDER COUNTER LIGHTING	-coo- UCL
SMURF TUBE	

ELECTRICAL NOTES:

- PROVIDE AND INSTALL LOCALLY CERTIFIED PROVIDE AND INSTALL LOCALLY CERTIFIED SMOKE AND CARBON MONOXIDE DETECTORS REQUIRED BY NATIONAL FIRE PROTECTION ASSOCIATION (NFPA) AND MEETING THE REQUIREMENTS OF ALL GOVERNING CODES PROVIDE AND INSTALL GROUD FAULT CIRCUIT—INTERRUPTERS (GF) AS REQUIRED BY NATIONAL ELECTRIC CODE (NEC) AND MEETING THE REQUIREMENTS OF ALL GOVERNING CODES. ELECTRICAL CONTRACTOR TO PROVIDE REQUIRED DIRECT HOOK-UPS/CUITOFS.
- REQUIRED DIRECT HOOK-UPS/CUTOFFS.
- REQUIRED DIRECT HOOK—UPS/CUIOFFS.
 HVAC CONTRACTOR TO VERIFY THERMOSTAT
 LOCATIONS.
 ALL ELECTRICAL AND MECHANICAL EQUIPMENT
 (I.E. FURNACES, A/C UNITS, ELECTRICAL PANELS,
 SANITARY SUMP PITS, DRAIN TILE SUMP, AND
 WATER HEATERS) ARE SUBJECT TO RELOCATION
 DUE TO FIELD CONDITIONS.

. 48".TO.CL . .12". TO.CL . WATER SOFTENER AND SUMP OUTLETS. 12" .TO .CL 48" TO CL FRONT DOOR COACH LIGHT. GARAGE DOOR COACH LIGHT, (ABOVE GARAGE FLOOR). . . . 84" . TO CL THERMOSTAT. .54" TO CL . .84" TO CL DOORBELL CHIMES. LEVEL W/ DR .HANDLE DOORBELL BUTTON. KITCHEN HOOD FAN "WHIP". . . .66". TO CL KITCHEN WALL HUNG MICROWAVE OUTLET . . KITCHEN DISHWASHER RECEPTACLE. JUNDER SINK
KITCHEN RANGE. 24".TO.CL
KITCHEN REFRIGERATOR. 48". TO. CL
WASHER/DRYER OUTLET. 48". TO. CL KITCHEN DISHWASHER RECEPTACLE.

CL = CENTER LINE 1 = FIELD VERIFY 2 = MASTER BATH STANDARD 30" HIGH VANITY TO BE RAISED 4"

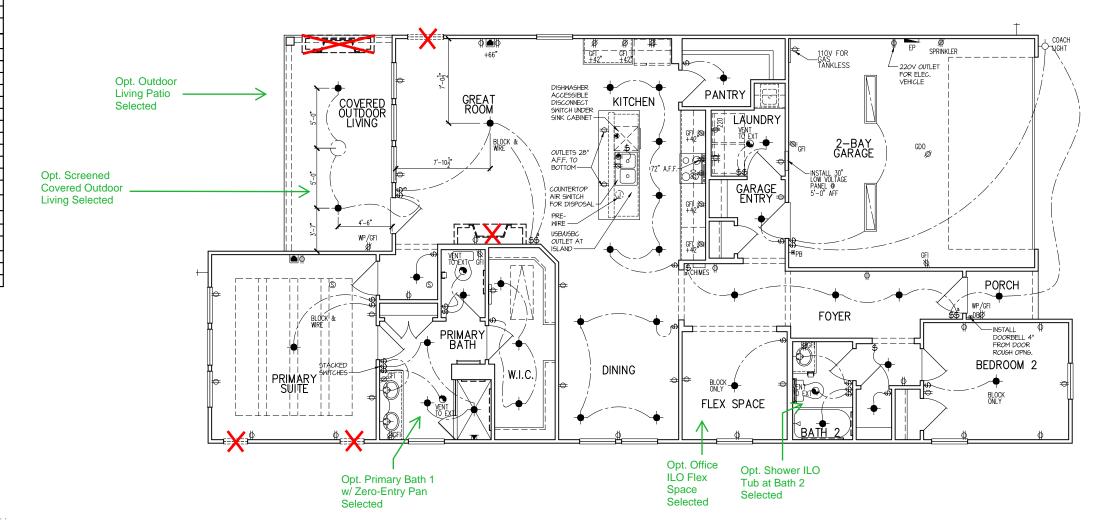

Dointe HOMES K BLVD, SUITE 400, RALEIGH, NC 27607

Business Operations 5440 Wade Park Blvd Suite 400 Raleigh, NC 27607

 PLAN ELECTRICAL 1st FLOOR

SUBDIVISION: ALTIS @ SERENITY
ADDRESS: FUQUAY-VARINA, NC 27527
LOT: 292 BLOCK:

Issue Date: 10-01-24 ACC

5919-03

OAK HAVEN

E1.10A

ELECTRICAL I SCHEDU	FIXTURE LE
DESCRIPTION	SYMBOL
110V OUTLET	Ф
220V OUTLET	Ψ Φ 220
1/2 HOT OUTLET	₩ 220
GFI OUTLET	₩ GFI
WP GFI OUTLET	₩P/GFI
GARAGE DOOR OPENER OUTLET	Ø GDO
SECURITY SYSTEM	∯ SEC SYS
DISHWASHER	⊕ DW
JUNCTION BOX	Ũ
CEILING MOUNTED LIGHT	
CEILING FAN w/ LIGHT KIT	BROVIDE
RECESSED CEILING LIGHT	Ø
RECESSED WATER PROOF LIGHT	™ MP
WALL MOUNTED LIGHT	9
WALL MOUNTED PUSH BUTTON	d ı PB
TWO WAY SWITCH	\$
THREE WAY SWITCH	*\$
FOUR WAY SWITCH	\$
DIMMER SWITCH	\$ ^{DIM}
EXHAUST VENTS	SVENT TO EXT
LOW VOLTAGE PANEL	
PHONE OUTLET	● PH
TV OUTLET	● TV
DATA & RG6 COMBO BOX	
SMOKE DETECTOR	Ŝ
CARBON MONOXIDE SMOKE DETECTOR COMBO	⊚ CM/SD
DOOR CHIMES	CHIMES
ELECTRICAL PANEL	EP EP
SURFACE MOUNT LED	
EXTERIOR WALL MOUNT UPLIGHT	88
SOFFIT MOUNT FLOOD LIGHT	445
UNDER COUNTER LIGHTING	ess-UCL
SMURF TUBE	

ELECTRICAL NOTES:

- 1. PROVIDE AND INSTALL LOCALLY CERTIFIED SMOKE AND CARBON MONOXIDE DETECTORS AS REQUIRED BY NATIONAL FIRE PROTECTION ASSOCIATION (NPA) AND MEETING THE REQUIREMENTS OF ALL GOVERNING CODES PROVIDE AND INSTALL GROUND FAULT CIRCUIT—INTERRUPTERS (GF) AS REQUIRED BY NATIONAL ELECTRIC CODE (NEC) AND MEETING THE REQUIREMENTS OF ALL GOVERNING CODES.


 3. ELECTRICAL CONTRACTOR TO PROVIDE REQUIRED DIRECT HOOK—UPS/CUTOFFS.

 4. HVAC CONTRACTOR TO VERIFY THERMOSTAT LOCATIONS.

 5. ALL ELECTRICAL AND MECHANICAL EQUIPMENT (LE. FURNACES, A/C UNITS, ELECTRICAL PANELS, SANITARY SUMP PITS, DRAIN TILE SUMP, AND WATER HEATERS) ARE SUBJECT TO RELOCATION DUE TO FIELD CONDITIONS.

DUE TO FIELD CONDITIONS.
ELECTRICAL DEVICES: ABOVE FINISHED FLOOR:
SWITCHES OVER COUNTER
WALL OUTLETS OVER COUNTER
+42" TO BOTTOM OF HORIZONTAL OUTLET(TYP. @ COUNTER)
REMAINING SWITCHES
WALL OUTLETS
BATH VANITY BRACKET OUTLET 1,2 (1" ABOVE TOP OF VANITY)
WATER SOFTENER AND SUMP OUTLETS 48" TO CL
EXTERIOR GFI OUTLETS
GARAGE GFI (ABOVE GARAGE FLOOR) 48" TO CL
FRONT DOOR COACH LIGHT
GARAGE DOOR COACH LIGHT, (ABOVE GARAGE FLOOR) 84".TO CL
THERMOSTAT
DOORBELL CHIMES
DOORBELL BUTTON DR .HANDLE
KITCHEN HOOD FAN "WHIP"
KITCHEN WALL HUNG MICROWAVE OUTLET 72" TO CL
KITCHEN DISHWASHER RECEPTACLE UNDER SINK
KITCHEN RANGE
KITCHEN REFRIGERATOR
WASHER/DRYER OUTLET
CL = CENTER LINE

CL = CENTER LINE 1 = FIELD VERIFY 2 = MASTER BATH STANDARD 30" HIGH VANITY TO BE RAISED 4"

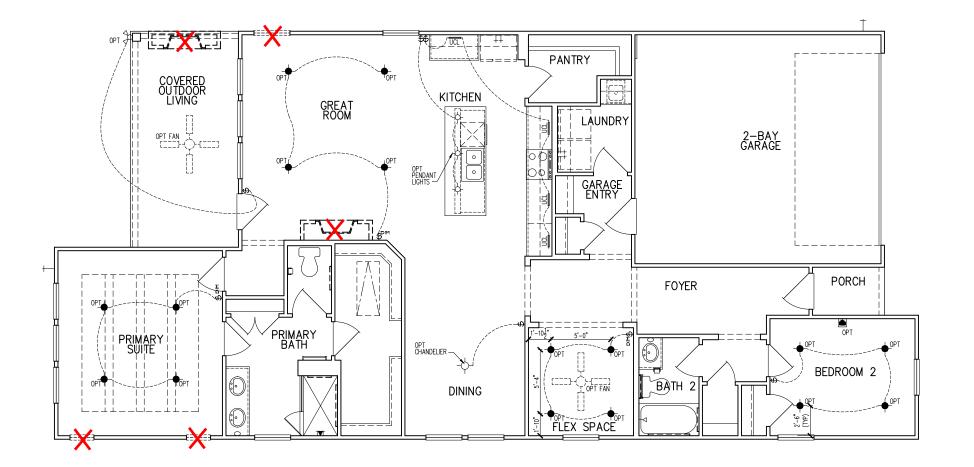

Check BOO for Selected Electrical **Options**

Dointe HOMES RR BLVD. SUITE 400, RALEGOH, NG 27/607

Business Operations 5440 Wade Park Blvd Suite 400 Raleigh, NC 27607

OPITONS SUBDIVISION: ALTIS @ SERENITY
ADDRESS: FUQUAY-VARINA, NC 27526
LOT: 292 BLOCK:


Issue Date: 10-01-24 ACC


5919-03

OAK HAVEN


E1.11A



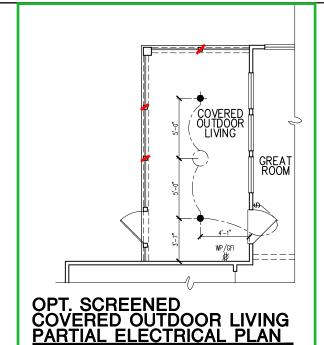

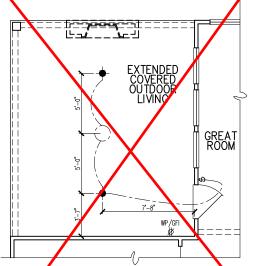



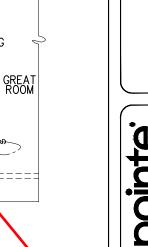

COVERED I

W.I.C.

PRIMARY BATH

OPT. PRIMARY BATH 1

PARTIAL ELECTRICAL PLAN

Dointe S HOME S HOW, SUITE 400, RALEGE, NG 27607 **0** \$ 九

Business Operations 5440 Wade Park Blvd Suite 400 Raleigh, NC 27607

OPTIONS PLAN


SUBDIVISION: ALTIS @ ELEC. ADDRESS: LOT: 292

10-01-24 Issue Date: ACC


5919-03

OAK HAVEN

01.E10

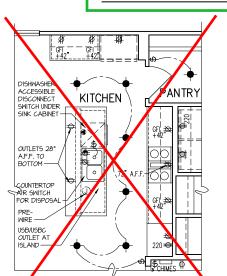



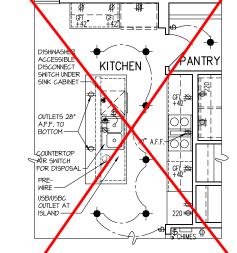



STACKED SWITCHES -

OPT. GOURMET KITCHEN 2 PARTIAL ELECT. PLAN

BRACINE)E(WP WALL MOUNTED LIGHT TWO WAY SWITCH THREE WAY SWITCH FOUR WAY SWITCH DIMMER SWITCH EXHAUST VENTS LOW VOLTAGE PANEL DATA & RG6 COMBO

CHIMES

EP

₩P/GFI ØrGDO

∯ SEC SYS ●DW

ELECTRICAL FIXTURE SCHEDULE

DESCRIPTION

110V OUTLET 220V OUTLET

1/2 HOT OUTLET WP GFI OUTLET
GARAGE DOOR OPENE

SECURITY SYSTEM

DISHWASHER


JUNCTION BOX

CARBON MONOXIDE SM DETECTOR COMBO

DOOR CHIMES


FLECTRICAL PANEL SURFACE MOUNT LE

EXTERIOR WALL MOUNT UPLIGHT SOFFIT MOUNT FLOOD LIG

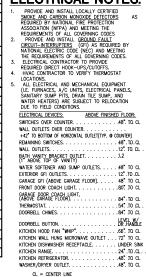


CL = CENTER LINE 1 = FIELD VERIFY 2 = MASTER BATH STANDARD 30" HIGH VANITY TO BE RAISED 4"




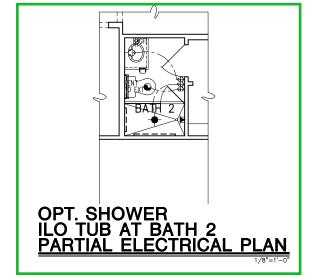





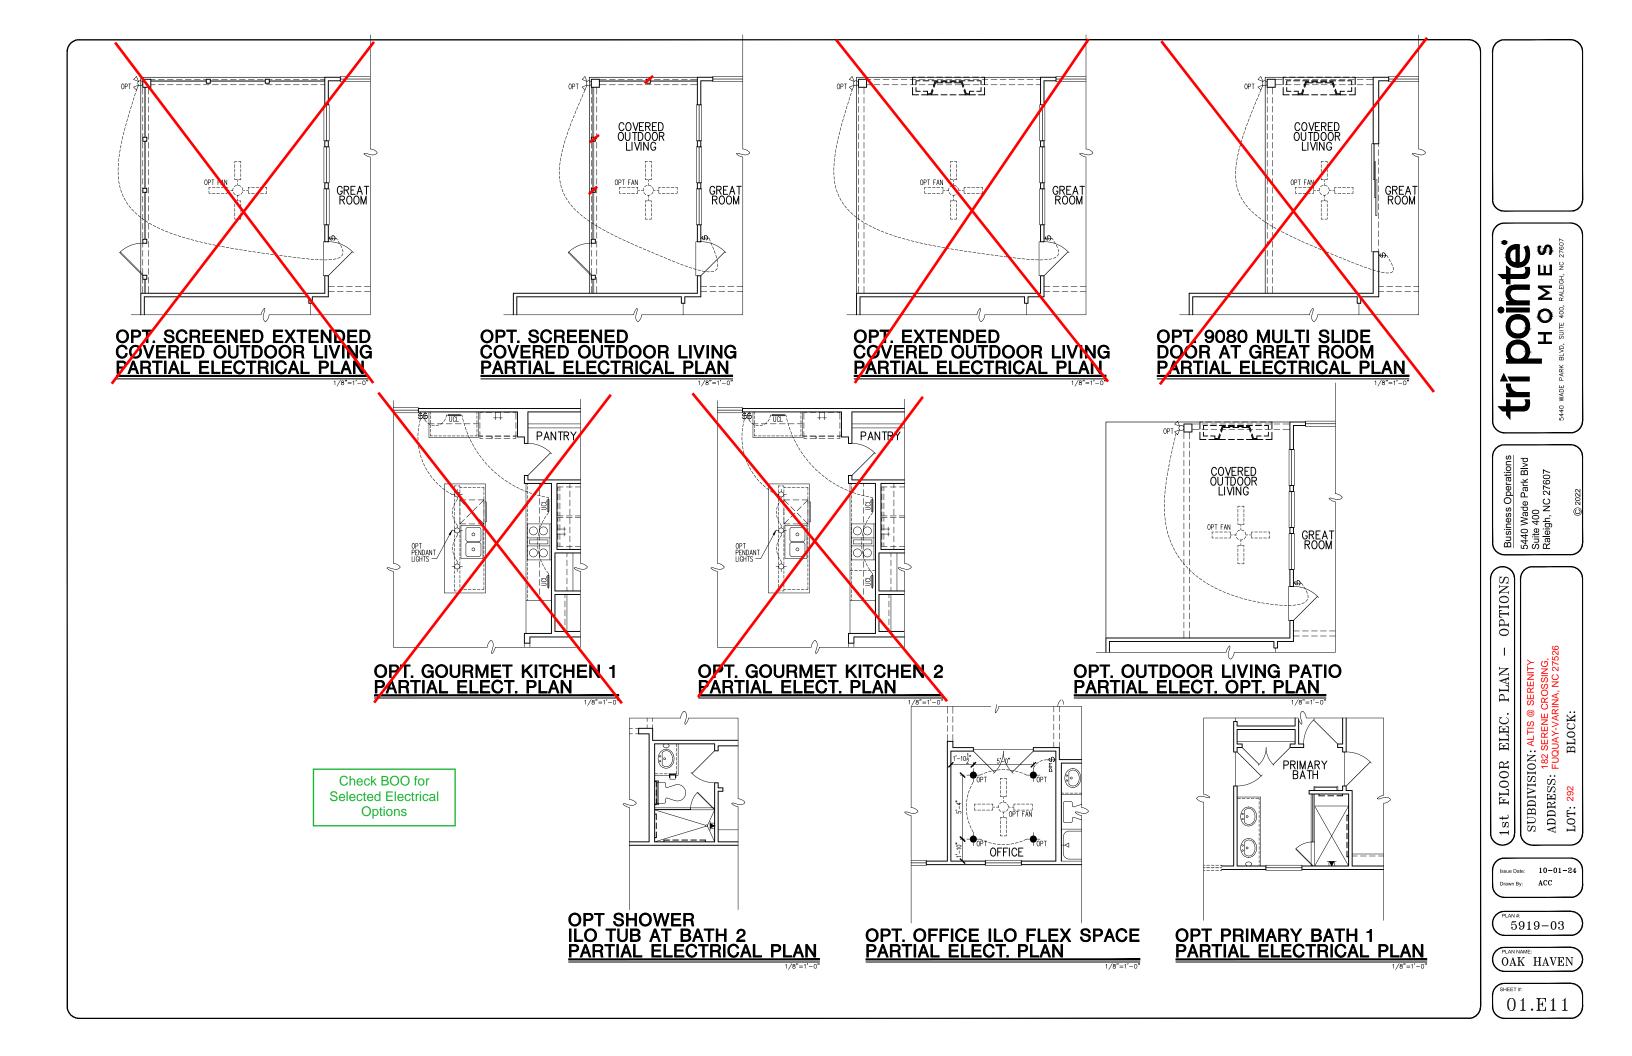

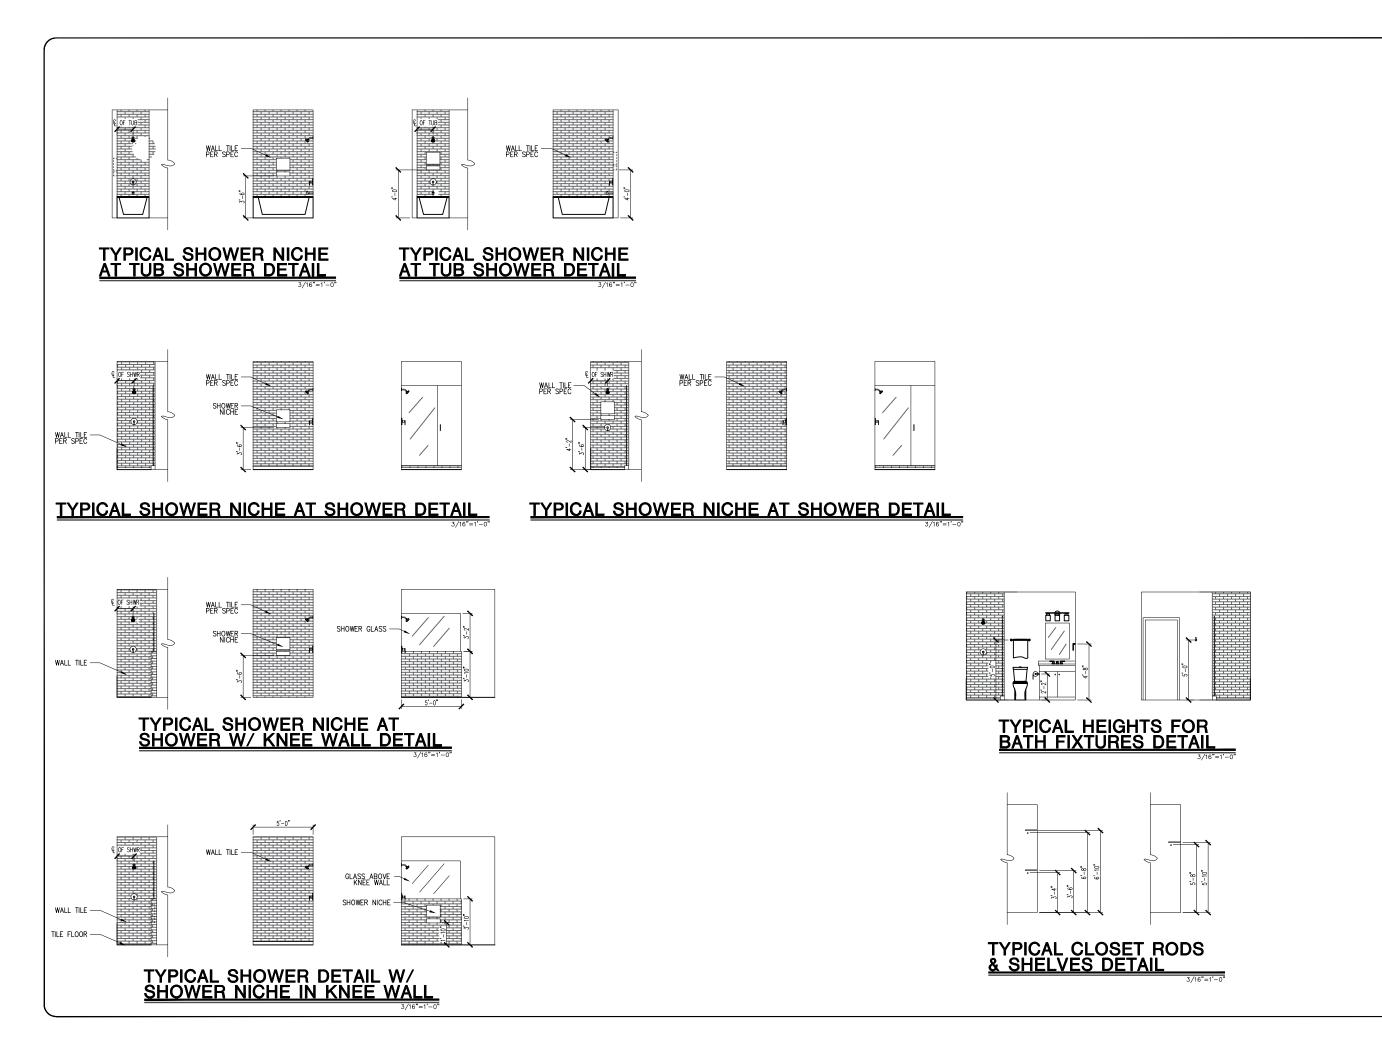

Tribonte BARK BLVD, SUITE 400, RALEIGH, NC 27607

Business Operations 5440 Wade Park Blvd Suite 400 Raleigh, NC 27607

DETAILS
: ALTIS @ SERENITY
SERENE CROSSING,
DUAY-VARINA, NC 27526


SUBDIVISION: ALTIS @ SERENITY
ADDRESS: FUQUAY-VARINA, NC 27
LOT: 292 BLOCK:

Issue Date: 10-01-24
Drawn By: ACC


PLAN #: 5919-03


OAK HAVEN

D1.0

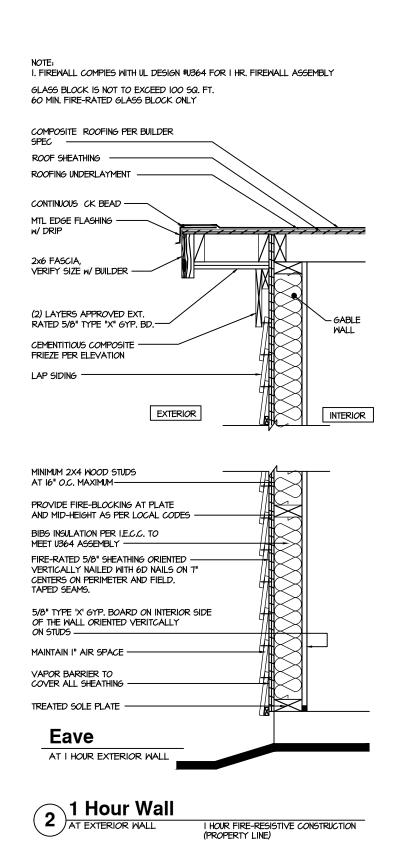

NOTE: I. FIREMALL COMPIES WITH UL DESIGN #U364 FOR I HR. FIREMALL ASSEMBLY GLASS BLOCK IS NOT TO EXCEED IOO SQ. FT. 60 MIN. FIRE-RATED GLASS BLOCK ONLY

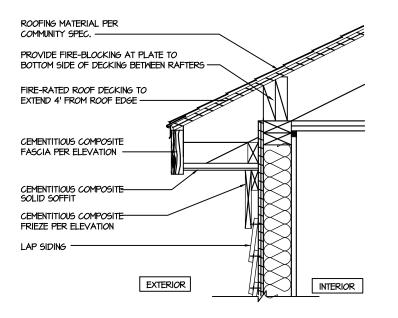

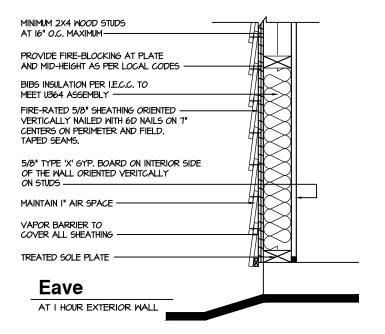



I HOUR FIRE-RESISTIVE CONSTRUCTION (PROPERTY LINE) tri pointe HOMES 840 WADE PARK BLVD. SUITE 400, RALFICH, NC 27607

Business Operations 5440 Wade Park Blvd Suite 400 Raleigh, NC 27607

TT/

SUBDIVISION: ALTIS @ SERENIT 182 SERENE CROSSING ADDRESS: FUQUAY-VARINA, NC 2

Issue Date: 10-01-24

Drawn By: ACC

5919-03

OAK HAVEN

D1.1

GENERAL STRUCTURAL NOTES

FLOOR FRAMING

- I IOISTS/TRUSSES SHALL BE DESIGNED BY MANUE TO MEET OR EXCEED L/480 LIVE LOAD DEFLECTION CRITERIA. (EXCLUDES STONE/MARBLE OR WET BED CONSTRUCTED FLOORS - CONTACT M&K FOR EXCLUDED FLOOR DESIGNS)
- PER THE GUIDELINES OF THE TILE COUNCIL OF NORTH AMERICA (TCNA HANDBOOK), IT SHALL BE THE FLOOR FINISH INSTALLER'S RESPONSIBILITY TO VERIEY THAT THE FINISHES TO BE INSTALLED MATCH THE DESIGN CRITERIA NOTED ABOVE (UNDER "DESIGN
- FLOOR SYSTEMS & SHEATHING HAVE BEEN DESIGNED TO SUPPORT ADDITIONAL DEAD LOAD FROM CERAMIC TILE (EXCLUDING MARBLE OR STONE). HOWEVER, IT SHALL BE THE FLOOR FINISH INSTALLER'S RESPONSIBILITY TO PROVIDE PROPER UNDERLAYMENT, UNCOUPLING MEMBRANE AND MORTAR/GROUT PER THE ASSEMBLY DESIGNATIONS IN THE TONA HANDBOOK (TILE COUNCIL OF NORTH AMERICA).
- AT I-JOIST FLOORS, PROVIDE I 1/8" MIN. OSB RIM BOARD.
- METAL HANGERS SHALL BE SPECIFIED BY MANUFACTURER, U.N.O.
- I-JOIST/TRUSS SHOP DWGS. SHALL BE SUBMITTED TO ARCH. & ENG. FOR REVIEW AND APPROVAL PRIOR TO FABRICATION OR DELIVERY
- FLOOR SHEATHING SHALL BE 23/32" A.P.A. RATED 'STURD-I-FLOOR' 24" O.C. EXPOSURE I (OR APPROVED EQUAL) WITH TONGUE AND GROOVE EDGES. FASTEN TO FRAMING MEMBERS W GLUE AND
- 2 ½" x 0.131" NAILS @ 6"o.c. @ PANEL EDGES € @ 12"o.c. FIELD.
- 2 3" x 0.120" NAILS @ 4" O.C. @ PANEL EDGES & @ 8" O.C. FIELD. - 2 3 × 0.113" NAILS @ 3" O.C. @ PANEL EDGES \$ @ 6" O.C. IN FIELD

ROOF FRAMING

- ROOF SHEATHING SHALL BE 7/16" A.P.A. RATED SHEATHING 24/16 EXPOSURE I (OR APPROVED EQUAL). FASTEN TO FRAMING MEMBERS
- W/ 2 ½" x 0.131" NAILS @ 6"o.c. @ PANEL EDGES \$ @ 12" O.C. FIELD.
- · w/ 2 🖁 × 0.120" NAILS 🥑 4"o.c. 💇 PANEL EDGES 🕏 🗗 O.C. FIELD. - w/ 2 3 × 0.113" NAILS @ 3"o.c. @ PANEL EDGES & @ 6" O.C. FIELD.
- WITHIN 48" OF ALL ROOF FDGES RIDGES & HIPS FASTEN ROOF SHEATHING FIELDS PER EDGE NAILING SPEC.
- EASTEN FACH ROOF TRUSS TO TOP PLATE W/ SIMPSON H25T CLIP (OR APPROVED EQUAL) • ALL BEARING POINTS. PROVIDE (2) H2.51 CLIPS AT 2-PLY GIRDER TRUSSES, (3) H2.5T CLIPS AT 3-PLY GIRDER TRUSSES & ROOF BEAMS - AT ALL BEARING POINTS.
- METAL HANGERS SHALL BE SPECIFIED BY THE MANUFACTURER, U.N.O.
- ROOF TRUSS SHOP DWGS SHALL BE SUBMITTED TO ARCH & ENG FOR REVIEW AND APPROVAL PRIOR TO FABRICATION OR DELIVERY
- ERECT AND INSTALL ROOF TRUSSES PER WTCA & TPI'S BCSI I "GUIDE TO GOOD PRACTICE FOR HANDLING, INSTALLING & BRACING
- OF METAL PLATE CONNECTED WOOD TRUSSES." SUPPORT SHORT SPAN ROOF TRUSSES W/2x4 LEDGER FASTENED TO

FRAMING w/(2) 3" x 0.120" NAILS @ 16" O.C. (UP TO 7' SPAN).

CONNECTION SPECIFICATIONS (TYP. U.N.O.)

DESCRIPTION OF BLDG. ELEMENT	3"x0.131" NAILS	3"x0.120" NAIL5
JOIST TO SOLE PLATE	(3) TOENAILS	(3) TOENAILS*
SOLE PL. TO JOIST/RIM OR BLK'G	NAILS @ 4" o.c.	NAILS @ 4" o.c.
STUD TO PLATE	(4) TOENAILS/ (3)END NAILS	(4) TOENAILS/ (4)END NAILS*
RIM TO TOP PLATE	TOENAILS @ 6" o.c.	TOENAILS @ 4" o.c.*
BLK'G. BTWN. JOISTS TO TOP PL.	(3) TOENAILS EA. END	(3) TOENAILS EA. END*
DOUBLE STUD	NAILS @ 16" O.C.	NAILS @ 16" o.c.
DOUBLE TOP PLATE	NAILS @ 12" o.c.	NAILS @ 8" o.c.
DOUBLE TOP PLATE LAP SPLICE	(I2) NAILS IN LAPPED AREA	(15) NAILS IN LAPPED AREA
	(24" MIN.)	(24" MIN.)
TOP PLATE LAP @ CORNERS & INTERSECTING WALLS	(3) NAILS	(3) NAILS
RAFTER/TRUSS TO TOP PLATE	(4) TOENAILS +	(4) TOENAILS +
	(I) SIMPSON H2.5T	(I) SIMPSON H2.5T
GAB. END TRUSS TO DBL. TOP PL.	TOENAILS @ 8" o.c.	TOENAILS @ 6" o.c.
R.T. w/ HEEL HT. 9 1/4" TO 12"	2XIO BLK EVERY 3RD BAY FASTENED TO DBL. TOP PLATE W/ TOENAILS @ 6" O.C.	2XIO BLK EVERY 3RD BAY FASTENED TO DBL. TOP PLATE w/ TOENAILS @ 4" O.C.
R.T. w/ HEEL HT. 12" TO 16"	2XI2 BLK EVERY 3RD BAY FASTENED TO DBL. TOP PLATE W/ TOENAILS @ 6" O.C.	2XI2 BLK EVERY 3RD BAY FASTENED TO DBL. TOP PLATE w/ TOENAILS @ 4" O.C.
R.T. w/ HEEL HT. UP TO 24"	LAP WALL SHTG. W/ DBL. TOP PL. \$ INSTALL ON TRUSS VERT FASTEN W/ NAILS @ 6" O.C.	LAP WALL SHTG. W/ DBL. TOP PL. \$ INSTALL ON TRUSS VERT FASTEN W/ NAILS @ 6" O.C.*
R.T. w/ HEEL HT. 24" TO 46"	LAP WALL SHTG. W/ DBL. TOP PL. & INSTALL ON TRUSS VERT FASTEN W/ NAILS @ 6" O.C. PROVIDE 2x BLK @ EA. BAY AT TOP OF HEEL	LAP WALL SHTG. W/ DBL. TOP PL. & INSTALL ON TRUSS VERT FASTEN W/ NAILS @ 6" O.C. PROVIDE 2x BLK @ EA. BAY AT TOP OF HEEL.
WALL TO FOUNDATION	WALL SHTG. LAP W/ SILL PL. & FASTENED PER SHEAR WALL FASTENING SPEC.	

2½"x0.113 IS AN ACCEPTABLE ALTERNATIVE TO A 3"x0.120", SAME SPACING OR NUMBER OF NAILS

GENERAL STRUCTURAL NOTES

DESIGN LOADING

- DESIGN IS BASED ON 2018 NORTH CAROLINA STATE BUILDING CODE: RESIDENTIAL CODE.
- WOOD FRAME ENGINEERING IS BASED ON NDS, "NATIONAL DESIGN SPECIFICATION FOR WOOD CONSTRUCTION" - LATEST EDITION.

DESIGN LOADS SNOW = 15 PSF (12 PSF GROUND SNOW, TRUSSES) ROOF

LIVE = 20 PSF (REDUCIBLE BASED ON ROOF PITCH) DEAD = 7 PSF T.C., IO PSF B.C. LOAD DURATION FACTOR = 1.25

FLOOR LIVE = 40 PSF (30 PSF @ SLEEPING AREAS) DEAD = 10 PSF (I-JOISTS), 15 PSF (FLOOR TRUSSES)

ADD'L IO PSE @ CERAMIC TILE IN KITCHEN SUNROOMS, BATHS, FOYER, LAUND, & MUDRIN

2,000 PSF ASSUMED ALLOWABLE BEARING PRESSURE (TO BE VERIFIED BY BUILDER)

115 MPH, EXPOSURE B

GENERAL FRAMING

- ALL TYP, NAIL FASTENER REQUIREMENTS ARE NOTED IN STANDARD CONNECTIONS TABLE (IRC TABLE R602.3(1)) OR ON PLANS. ALL NAILS SPECIFIED ARE MIN DIAMETER AND LENGTH REQUIRED FOR CONNECTION. ALL HANGER NAILS SHALL BE INSTALLED PER MANUFACTURER'S REQUIREMENTS FOR MAX CHARTED CAPACITY NOTE: HANGERS USE COMMON NAIL DIAMETERS NOT TYPICAL FRAMING GUN NAILS.
- EXT & INT BEARING WALLS SHALL BE 2x4 OR 2x6 (AS SHOWN ON PLANS) @ 16" O.C. SPF/SP #2 GRADE LUMBER, OR BETTER, U.N.O.. · WALLS OVER 12' TALL SHALL BE PER PLAN.
- ALL INTERIOR BEARING WALLS ARE ASSUMED TO BE SHEATHED W/ GYP WALL BOARD (ONE SIDE MIN.) OR PROVIDE MID HT. BLOCKING.
- ALL HEADERS, BEAMS & OTHER STRUCTURAL MEMBERS SHALL BE SPRUCE-PINE-FIR #2 (SPE) OR SOUTHERN PINE #2 (SP) LUMBER, OR BETTER, SUPPORT ALL HEADERS/ BEAMS W/ (1)2x JACK STUD & (1)2x KING STUD MINIMUM
- THE NUMBER OF STUDS SPECIFIED AT A SUPPORT INDICATES THE NUMBER OF JACK STUDS REQUIRED, U.N.O.,
- ALL NON-BEARING INTERIOR STUD WALLS SHALL BE CONSTRUCTED WITH 2x 'STUD' GRADE MEMBERS SPACED @ 24" O.C. (MAX., U.N.O.)

 • HEADERS IN NON-LOAD BEARING WALLS SHALL BE: (I)2x4/6 FLAT @ OPENINGS UP TO 4', (2)2x4/6 FLAT UP TO 8'.
- ALL FRAMING LUMBER SHALL BE DRIED TO 15% MC (KD-15)
- ENGINEERED LUMBER BEAMS TO MEET OR EXCEED THE FOLLOWING: • 'LVL' - Fb=2600 psi; Fv=285 psi; E=2.0x10^6 psi
- ENGINEERED LUMBER POSTS TO MEET OR EXCEED THE FOLLOWING 'LVL' - Fb=2400 psi; FcII=2500 psi; E=I.8xI0^6 psi
- FOR 2 & 3 PLY BEAMS OF EQUAL 134" MAX, WIDTH, FASTEN PLIES TOGETHER WITH 3 ROWS OF 3"X0.120" NAILS @ 8" O/C OR 2 ROWS 18"x3K" SIMPSON SDS SCREWS (OR 3K" TRUSSI OK SCREWS) @ 16" GREATER. APPLY EASTENING AT BOTH FACES FOR 3-PLY CONDITION. LOCATE TOP & BOTTOM NAILS/SCREWS 2" FROM EDGE. SOLID 31/3" OR 51/4" BEAMS ARE ACCEPTABLE, USE 2 ROWS OF NAILS FOR 2x6 \$ 2x8 MEMBERS
- TOGETHER WITH 3 ROWS OF 1/2"x6" SIMPSON SDS SCREWS (OR 6 3/4" TRUSSLOK SCREWS) @ 16" O/C. USE A MINIMUM OF 4 ROWS FOR BEAM DEPTHS OF 14" OR GREATER, APPLY FASTENING AT BOTH FACES (ONE SIDE ONLY FOR TRUSSLOK SCREWS). LOCATE TOP ANI BOTTOM SCREWS 2" FROM EDGE. A SOLID 7" BEAM IS ACCEPTABLE
- PROVIDE SOLID BLOCKING IN FLOOR SYSTEM UNDER ALL POSTS CONTINUOUS TO FND./BEARING. BLOCKING TO MATCH POST ABOVE.
- ALL EXTERIOR 4x4 WOOD POSTS SHALL HAVE SIMPSON BCS2-2/4 CAP & ABW44 BASE, U.N.O.
- BUILDER RESPONSIBLE TO DETERMINE CORROSION-RESISTANCE REQUIREMENTS AND COMPATIBILITY OF HARDWARE FASTENERS AND CONNECTORS FOR ENVIRONMENTAL EXPOSURE AND IN CONTACT W/ PRESERVATIVE-TREATED WOOD OF ACTUAL FINAL CONDITIONS AND SOURCED MATERIALS. CONTACT LUMBER & HARDWARE SUPPLIERS TO COORD.

NON-GARAGE SIDE

GENERAL STRUCTURAL NOTES

FOUNDATION

- DESIGN IS BASED ON 2018 NORTH CAROLINA STATE BUILDING CODE:
- FOOTING DESIGN 2,000 PSF ALLOWABLE SOIL BEARING
- FASTEN 2x4/6 SILL PLATES TO CONC FND WITH A MINIMUM OF 2
- ANCHORS PER PLATE 12" MAX FROM PLATE ENDS UTILIZING: • I/2" DIA. ANCHOR BOLTS @ 6'-0" O.C,7" MIN. EMBEDMENT
- I/2" DIA. x 6" LONG SIMPSON TITEN HD @ 6'-0" O.C.
- SIMPSON MASA ANCHOR STRAPS @ 6'-0" O.C. (CONCRETE)
- ALL LUMBER EXPOSED TO WEATHER OR IN CONTACT W/ PERIMETER FOUNDATION SHALL BE PRESERVATIVE TREATED SOUTHERN PINE #2.
- BUILDER TO VERIEY CORROSION-RESISTANCE COMPATIBILITY OF HARDWARE & FASTENERS IN CONTACT W/ PRESERVATIVE-TREATED WOOD CONTACT LIMBER & HARDWARE SUPPLIERS TO COORD
- FOOTINGS SHALL BE PLAIN CONCRETE, U.N.O.
- CONCRETE DESIGN BASED ON ACL 318, CONCRETE SHALL ATTAIN THE FOLLOWING MIN. COMPRESSIVE STRENGTHS IN 28 DAYS, U.N.O. f'c = 3,000 psi: FOOTINGS & INTERIOR SLABS ON GRADE 3500 psi: GARAGE & EXTERIOR SLABS ON GRADE fu = 60.000 psi
- ALL CONCRETE EXPOSED TO THE WEATHER SHALL NOT HAVE LESS THAN 5% OR MORE THAN 7% AIR ENTRAINMENT
- ALL FOOTINGS SHALL BEAR BELOW FROST LINE (TYP.) OR 12" MIN IN REGIONS WHERE CODE FROST DEPTH IS NOT APPLICABLE. CONSULT SOILS REPORT OR BUILDING DEPT. FOR MINIMUM DEPTH BELOW GRADE
- FOOTINGS AND SLABS ON GRADE SHALL BEAR ON VIRGIN SOIL OR
- PROVIDE CONTROL JOINTS AT ALL INSIDE CORNERS OF SLAB EDGES, AND OTHER LOCATIONS WHERE SLAB CRACKS ARE LIKELY TO DEVELOP
- . JOINTS SHALL BE LOCATED @ 10'-0" O.C. (RECOMMENDED) OR 15'-0" O.C. (MAXIMUM)
- JOINT GRID PATTERN SHALL BE AS CLOSE TO SQUARES AS POSSIBLE (I:I RATIO), WITH A MAXIMUM OF I:I.5 RATIO
- CONTROL JOINTS SHALL <u>NOT</u> BE INSTALLED IN STRUCTURAL DIMENSIONS BY OTHERS, BUILDER TO VERIFY

HOLD-DOWN SCHEDULE

	•	025 507 111 001 125 022
	SYMBOL	SPECIFICATION
	► HD-I	SIMPSON CSI6 STRAP TIE W/ 14" END LENGTH
	► HD-2	SIMPSON M6TC66 STRAP TIE w/ 24" END LENGTH
	▶ HD-3	SIMPSON HTT4 HOLD-DOWN *
	► HD-4	SIMPSON HDU5-SDS2.5 HOLD-DOWN *

► HD-5 SIMPSON STHDI4RJ HOLD-DOWN * UTILIZE SIMPSON "SET-3G" EPOXY SYSTEM TO FASTEN %" DIA. THREADED ROD INTO CONCRETE FOUNDATION. PROVIDE 12" MIN. EMBEDMENT INTO CONCRETE. INSTALL PER MANUE, RECOMMENDATIONS, DO NOT LOCATE ANCHORS WITHIN I 3/4" OF EDGE OF FOUNDATIO

Serenity **Elevation A**

MEANS & METHODS NOTES

THE STRUCTURE IS DESIGNED TO BE SELF SUPPORTING AND STABLE AFTER THE BUILDING IS FINISHED AND ALL PLAN, DETAIL, AND NOTE SPECIFICATIONS HAVE BEEN COMPLETED. IT IS THE CONTRACTOR'S SOLE RESPONSIBILITY TO DETERMINE THE ERECTION PROCEDURES AND SEQUENCE TO THE SAFETY OF THE BUILDING AND ITS COMPONENTS DURING CONSTRUCTION. THIS INCLUDES BUT IS NOT LIMITED TO, THE ADDITION OF NECESSARY SHORING, SHEETING, TEMPORARY BRACING, GUYS, AND TIE-DOWNS. CONTRACTOR SHALL BE RESPONSIBLE FOR ALL SHORING AND BRACING REQUIRED TO STABILIZE AND PROTECT EXISTING AND ADJACENT STRUCTURES AND SYSTEMS DURING COURSE OF DEMOLITION AND CONSTRUCTION

STRUCTURAL DESIGN AND SPECIFICATIONS ASSUME THAT ALL SUPPORTING AND NON-SUPPORTING ELEMENTS IN CONTACT WITH FLOOR FRAMING ARE LEVEL, INCLUDING, BUT NOT LIMITED TO: FOUNDATIONS SLABS ON GRADE, BEAMS, WALLS, AND NON-BEARING ELEMENTS. IT IS THE CONTRACTOR'S RESPONSIBILITY TO VERIEY LEVELNESS AND MAKE ADJUSTMENTS AS NECESSARY, INCLUDING CONSIDERATION OF THOSE AREAS THAT MAY BE WITHIN CONTRACTUAL, INDUSTRY OR WARRANTY TOLERANCES.

VENEER LINTEL SCHEDULE

SPAN (MAX)	HEIGHT OF VENEER ABOVE LINTEL	STEEL ANGLE SIZE
3'-0"	20 FT. MAX	L3"x3"x¼"
	3 FT. MAX	L3"x3"x¼"
6'-0"	I2 FT. MAX	L4"x3"x¼"
	20 FT. MAX	L5"x3½"x¾"
8'-0"	3 FT. MAX	L4"x4"x¼" *
8-0	I2 FT. MAX	L5"x3½"x¾"
	I6 FT. MAX	L6"x3½"x¾"
9'-6"	I2 FT. MAX	L6"x3½"x¾6"
16'-0"	2 FT. MAX	L7"x4"x½" **
1	3 FT, MAX	L8"x4"x½" **

- ALL LINTELS

 **SHALL SHOPE 7.2 %* 3 ½* VENEER w/ 40 psi MAXIMM MEIGHT.

 (16 SHALL HAVE 4" NIN, EEARNIG

 (16 SHALL HAVE 4" NIN, EEARNIG

 (16 SHALL HAVE 5" NIN, EEARNIG

 **(16 SHALL HAVE 16 SHIDED PACK TO HEADER IN WALL 446"02. w/ ½* DIA x 3 ½*

 LONG LAG SCREPES IN 2" LONG VERTICALLY SLOTTED HOLES.

 **MALL ER FORSTEDE PACK TO ROCKIT HE GET HOLES.

 **ALL LINTELS SHALL BE LONG LEG VERTICALLY SLOTTED HOLES.

 **ALL LINTELS SHALL BE LONG LEG VERTICAL.*

 **ALL LINTELS SHALL BE LONG LEG VERTICAL.*

 **HALL SHAPPLIST TO SHE 3 ½* WILE OVER THE BEARNIG LENGTH ONLY. THIS

 **SHE'S SHAPPLIST HAS TOR ANY LINTEL CADITION NOT ENCOMPASSED BY THE ABOVE PRAVAMETERS.

** FOR QUEEN VENEER USE L4%3%*.

** FOR 3½" VENEER ONLY, SEE PLAN FOR VENEER SUPPORT IF VENEER < 3½" THICK.

I-JOIST MANUFACTURER

ADDITIONAL NOTES FOR TRUSS \$

ROOF TRUSS, FLOOR TRUSS AND ENGINEERED JOISTS SHALL BE DESIGNED TO MEET THE DEFLECTION CRITERIA BELOW, UNLESS NOTED OTHERWISE ON PLAN. MULHERN & KULP CANNOT BE HELD RESPONSIBLE FOR ANY STRUCTURAL ISSUES
RELATED TO ANY BUILDING COMPONENT IF COMPONENT SHOP DRAWINGS ARE NOT SUBMITTED TO M&K FOR REVIEW PRIOR TO FABRICATION, DELIVERY, OR INSTALLATION.

TRUSSES/LIGISTS SHALL BE DESIGNED SO THAT DIFFERENTIAL DEFLECTION BETWEEN ADJACENT PARALLEL TRUSSES/JOISTS OR GIRDER TRUSSES/FLUS BEAMS DO NOT EXCEED THE FOLLOWING: ROOF TRUSSES.

- I/4" DEAD LOAD
- FLOOR TRUSSES, ATTIC TRUSSES, & I-JOISTS; I/8" DEAD LOAD ABSOLUTE DEAD LOAD DEFECTION OF FLOOR

TRUSSES/ATTIC TRUSSES WHEN ADJACENT TO FLOOR FRAMING BY OTHERS SHALL BE LIMITED TO 3/16". (NO DIFFERENTIAL DEFLECTION)

FLOOR JOIST NOTES

- ALL FLOOR JOISTS SHALL BE THE DEPTI SPECIFIED ON PLAN - FLOOR JOISTS SERIES & SPACING IS PER THE
- FLOOR JOIST MANUF. SPACING SHALL NOT EXCEED 19.2" O.C. (MAX.)
- @ LOCATION OF TILE: SPACING SHALL NOT EXCEED 16" O.C. (MAX.)

LATERAL/WALL BRACING & WALL SHEATHING SPECIFICATIONS

THIS MODEL HAS BEEN DESIGNED TO RESIST LATERAL FORCES RESULTING FROM:

5 MPH WIND IN 2018 NCSBC:RO

(115 MPH WIND SPEED IN ASCE 7-10 WIND MAP, PER IRC R301,2,1,1) EXP. B, RISK CAT. 2 & SEISMIC CAT. A/B.

THE DESIGN WAS COMPLETED PER 2015 IBC (SECTION 1609) & ASCE 7-10, AS PERMITTED BY R301.1.3 OF THE 2018 NCSBC:RC, ACCORDINGLY THIS MODEL, AS DOCUMENTED AND DETAILED HEREWITHIN, IS ADEQUATE TO RESIST THE CODE REQUIRED LATERAL FORCES.

DESIGN WIND UPLIET LOADS HAVE BEEN CALCULATED UTILIZING ASCE 7-10 (ACCEPTED ENGINEERING PRACTICE) AS ALLOWED PER 2018 NCSBC:RC SECTION R802.II.I.I. THIS MODEL HAS BEEN DETAILED WHERE REQUIRED & ENGINEERED TO RESIST THE WIND UPLIFT LOAD PATH PER SECTIONS R602.3.5& R802.II.

EXT. WALL SHEATHING SPECIFICATION

- 7/16" OSB OR 15/32" PLYWOOD: FASTEN SHEATHING W/ 2 ₹x0.113 NAILS @ 6" O.C. AT EDGES & @ 12" O.C. IN THE PANEL FIELD. (TYP, U.N.O.) ALL SHEATHING PANELS SHALL BE ORIENTED
- VERTICALLY (LONG DIRECTION PARALLEL TO STUDS) AND INSTALLED FULL HEIGHT OF SHEAR WALL - OR 2x HORIZONTAL BLOCKING SHALL BE PROVIDED TO SUPPORT ALL UNSUPPORTED PANEL EDGES & EDGE
- ALL EXT. WALLS SHALL BE CONTINUOUSLY SHEATHED AND ARE CONSIDERED SHEAR WALLS.
- ALT. STAPLE CONNECTION SPEC: 1 3/4" 16 GA STAPLES (1/6" CROWN) @ 3" O.C. AT EDGES \$ @ 6" O.C IN FIELD.

<u>3" O.C. EDGE NAILING</u>

 AT DESIGNATED AREAS - FASTEN PANEL EDGES OF WOOD STRUCTURAL WALL SHEATHING TO FRAMING W 2 🖁 × 0.113" NAILS @ 3" O.C. AND 12" O.C. IN THE PANEL FIELD NO STAPLE ALTERNATIVE AVAILABLE AT THIS SPEC. ALL SHEATHING PANELS SHALL BE ORIENTED VERTICALLY (LONG DIRECTION PARALLEL TO STUD) AND INSTALLED FULL HEIGHT OF SHEAR WALL - OR - 2x HORIZONTAL BLOCKING SHALL BE PROVIDED TO SUPPORT UNSUPPORTED PANEL EDGES AND 3" O.C. EDGE FASTENING.

TYP. UNIT SEPARATION WALL SHEATHING SPECIFICATION

•1/2" OR 5/8" GYPSUM WALL BOARD: FASTEN GWB SHEATHING TO FRAMING W/ 1 \$"X0.086" COOLER NAILS OR I 1/4" DRYWALL SCREWS @ 7" O.C. " PANEL EDGES & PANEL FIELD (INCLUDING T&B PLATES

- SEE CONNECTION SPECIFICATIONS CHART FOR STANDARD SHEAR TRANSFER DETAILING. IF ADDITIONAL CAPACITY IS REQUIRED BY DESIGN. T WILL BE SPECIFICALLY NOTED ON PLAN.
- DESIGN ASSUMES 16" O.C MAX. STUD SPACING, U.N.O.
- ALL STRUCTURAL PANELS ARE TO BE DIRECTLY APPLIED TO STUD FRAMING.
- PRE-MANUFACTURED PANELIZED WALLS: FASTEN TOGETHER END STUDS OF WALL PANELS SHFATHED W/ OSB OR PLYWOOD W/ 3" x 0.120" NAILS @ 4" O.C. (THRU ONE SIDE ONLY)

INDICATES EXTENT OF INT. OSB SHEARWALL, BLOCKED PANEL EDGES. AND/OR 3" O.C. EDGE NAILING

INDICATES HOLDOWN

MULHERN+KULP RESIDENTIAL STRUCTURAL ENGINEERING Parkway, Suite 250 🕶.



lulhern+Kulp project numbe

243-2402 SMK

MF(ssue date: 08-14-2024

REVISIONS initial: 1/06/202 SMM LAME, OPT. EXT. COVID. PORCH, 2/16/2024 MEM

ADDED DORMER TO ELEV. D 5/15/2025 MISC. ARCH. UPDATE

pointe HOMES

NOTE MOD GENERAL

SERENITY MASTER SET RALEIGH, NC 03 5919

S0.0

NOTE: OPT. OUTDOOR

Serenity Lot 292 5919-03 - Oak Haven **Elevation A**



MULHERN+KULP

RESIDENTIAL STRUCTURAL ENGINEERING
3655 Buojade Parkney, Sale 250 - Aphresta, 6A 3002
p.778-777-0014 - multimatoperm
NC LICENSE # C-3825

243-24029

issue date: 08-14-2024

REVISIONS:

11/06/2024 SMM NAME, OPT. EXT. COVID. PORCH, 12/16/2024 ADDED DORNIER TO ELEV. D 5/15/2025 MISC. ARCH. UPDATE MEM

tri pointe

BEAM / HEADER

INDICATES EXTENT OF INT.

OSB SHEARWALL AND/OR


EXTENT OF VALLEY TRUSS OVERFRAMING

2 24" O.C. (MAX.)

INDICATES HOLDOWN

* INDICATES POST ABOVE. PROVIDE SOLID

TYPICAL STRUCTURAL NOTES

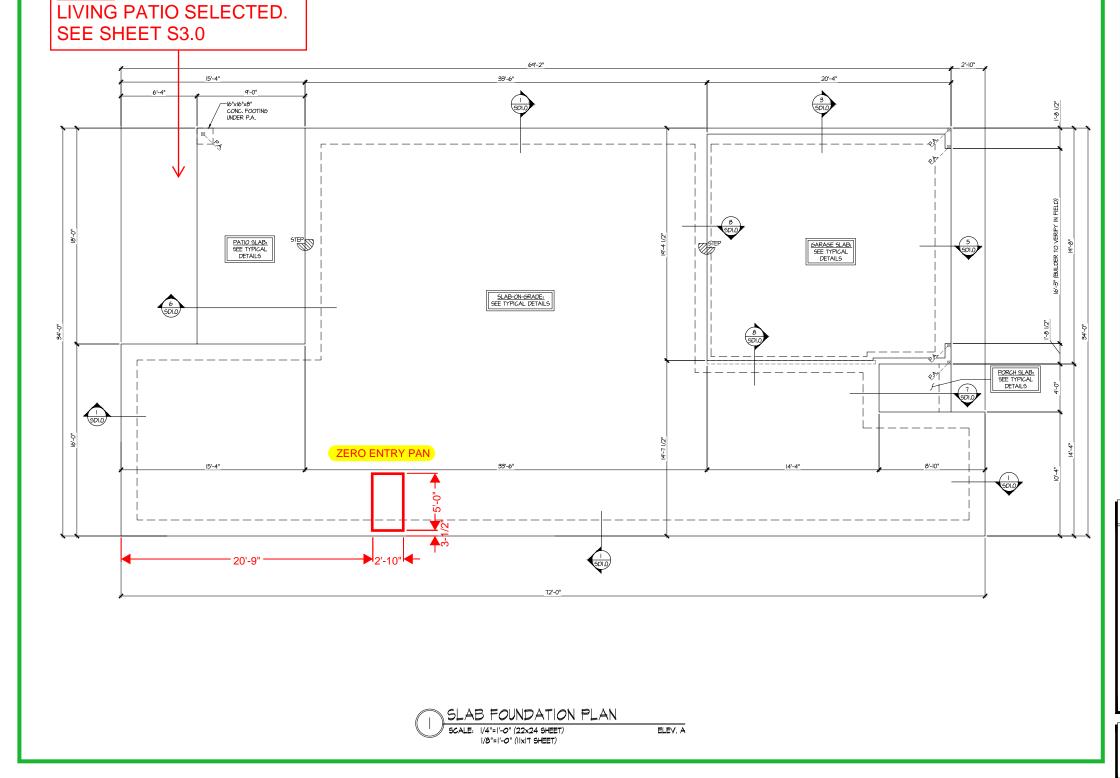

LEGEND

INTERIOR BEARING WALL

• ==== BEARING WALL ABOVE (B.W.A.)

3" O.C. EDGE NAILING

REFER TO SO.O FOR & SCHEDULES


FOUNDATION PLAN

S1.0

5919-03 MODEL

SERENITY MASTER SET RALEIGH, NC

Serenity Lot 292 5919-03 - Oak Haven **Elevation A**

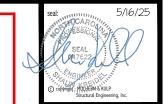

MULHERN+KULP

RESIDENTIAL STRUCTURAL ENGINEERING

3655 Broleside Parkway, Sale 250 - Aphrenta, SA 3002

P.770-777-0074 - multimateproom

NC Licence # C-3625

243-24029

MEG issue date: 08-14-2024

REVISIONS:

11/06/2024 SMM NAME, OPT. EXT. COVID. PORCH, 12/16/2024 ADDED DORNIER TO ELEV. D 5/15/2025 MISC. ARCH. UPDATE MEM

tri pointe

FOUNDATION PLAN

5919-03 MODEL

► INDICATES HOLDOWN

* INDICATES POST ABOVE. PROVIDE SOLID

BLOCKING UNDER POST OR JAMB ABOVE

JL METAL HANGER


REFER TO SO.O FOR

TYPICAL STRUCTURAL NOTES

SCHEDULES

SERENITY MASTER SET RALEIGH, NC

S1.1

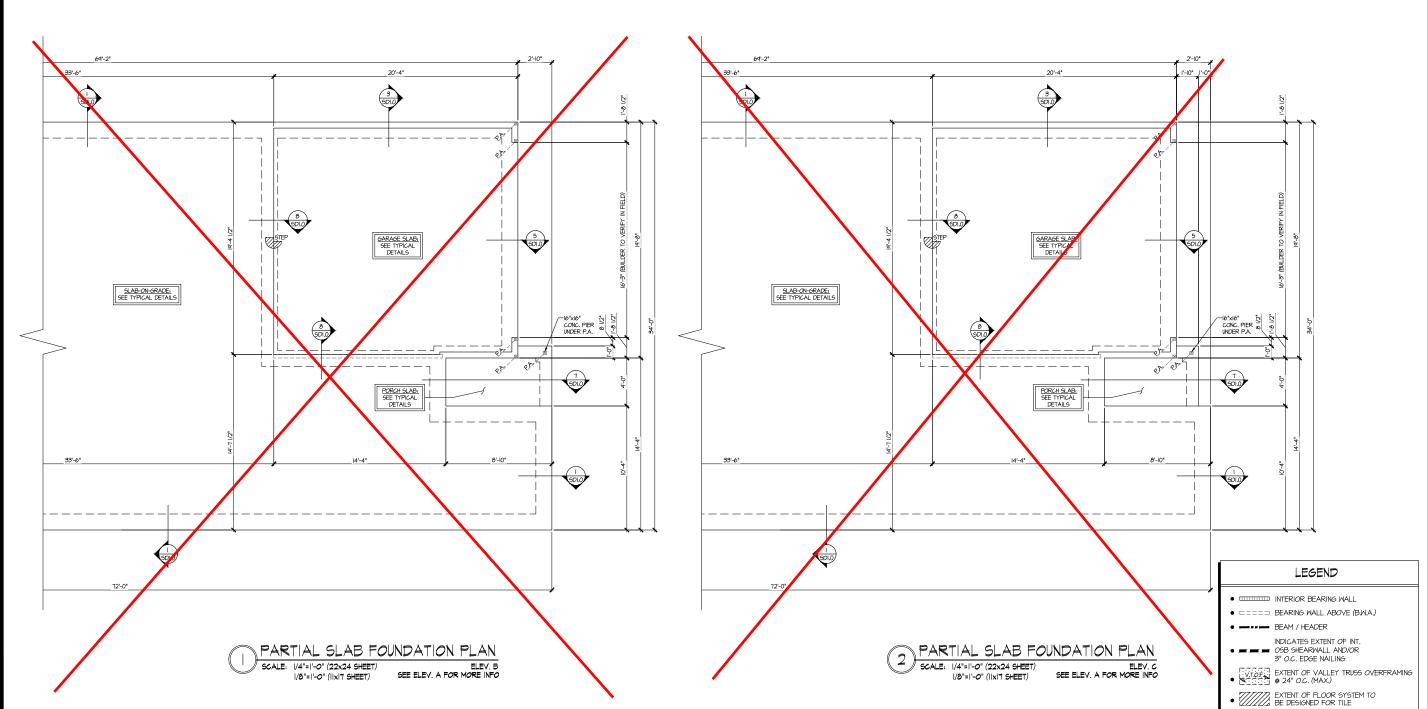

Serenity Lot 292 5919-03 - Oak Haven **Elevation A**



MULHERN+KULP

RESIDENTIAL STRUCTURAL ENGINEERING

SEES Broiside Parkwey, Sale 250 - Aphresia, 6A 3002

P.TR.TT. 404 - Instructions

NC License # C-3825



243-24029

MEG issue date: 08-14-2024

REVISIONS:


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tri pointe

FOUNDATION PLAN

5919-03 MODEL SERENITY MASTER SET RALEIGH, NC

S1.2

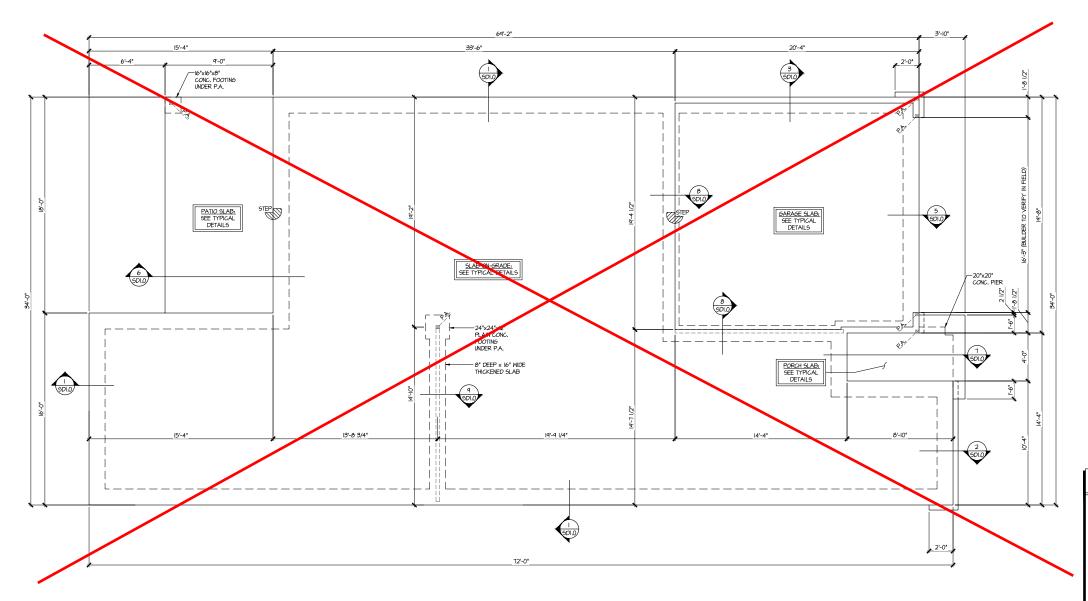

SLAB FOUNDATION PLAN SCALE: 1/4"=1'-0" (22x24 SHEET)

ELEV. D

LEGEND

INTERIOR BEARING WALL

• ==== BEARING WALL ABOVE (B.W.A.)

BEAM / HEADER

INDICATES EXTENT OF INT.

OSB SHEARWALL AND/OR 3" O.C. EDGE NAILING

EXTENT OF VALLEY TRUSS OVERFRAMING
24" O.C. (MAX.)


INDICATES HOLDOWN

* INDICATES POST ABOVE. PROVIDE SOLID BLOCKING UNDER POST OR JAMB ABOVE

REFER TO SO.O FOR TYPICAL STRUCTURAL NOTES & SCHEDULES

UNDER 9,000 FT² -NON-GARAGE SIDE

Serenity Lot 292 5919-03 - Oak Haven **Elevation A**

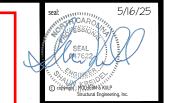

MULHERN+KULP
RESIDENTIAL STRUCTURAL ENGINEERING



Mulhern+Kulp project number:

243-24029

MEG issue date: 08-14-2024

REVISIONS:

initial: II/06/2024 UPDATED MODEL OPT. OFFICE SMM NAME, OPT. EXT. COVID. PORCH, 12/16/2024 ADDED DORNIER TO ELEV. D 5/15/2025 MISC. ARCH. UPDATE MEM

tri pointe

FOR 9'-I" PLATE HEIGHT

INTERIOR BEARING WALL

• ==== BEARING WALL ABOVE (B.W.A.)

INDICATES EXTENT OF INT.

OSB SHEARWALL AND/OR 3" O.C. EDGE NAILING

TYPICAL STRUCTURAL NOTES

THIS LEVEL HAS BEEN DESIGNED

LEGEND

EXTENT OF VALLEY TRUSS OVERFRAMING
24" O.C. (MAX.)

NDICATES HOLDOWN


INDICATES POST ABOVE. PROVIDE SOLID BLOCKING UNDER POST OR JAMB ABOVE.

REFER TO SO.O FOR & SCHEDULES


ROOF FRAMING PLAN 5919-03 MODEL

S2.0

SERENITY MASTER SET RALEIGH, NC

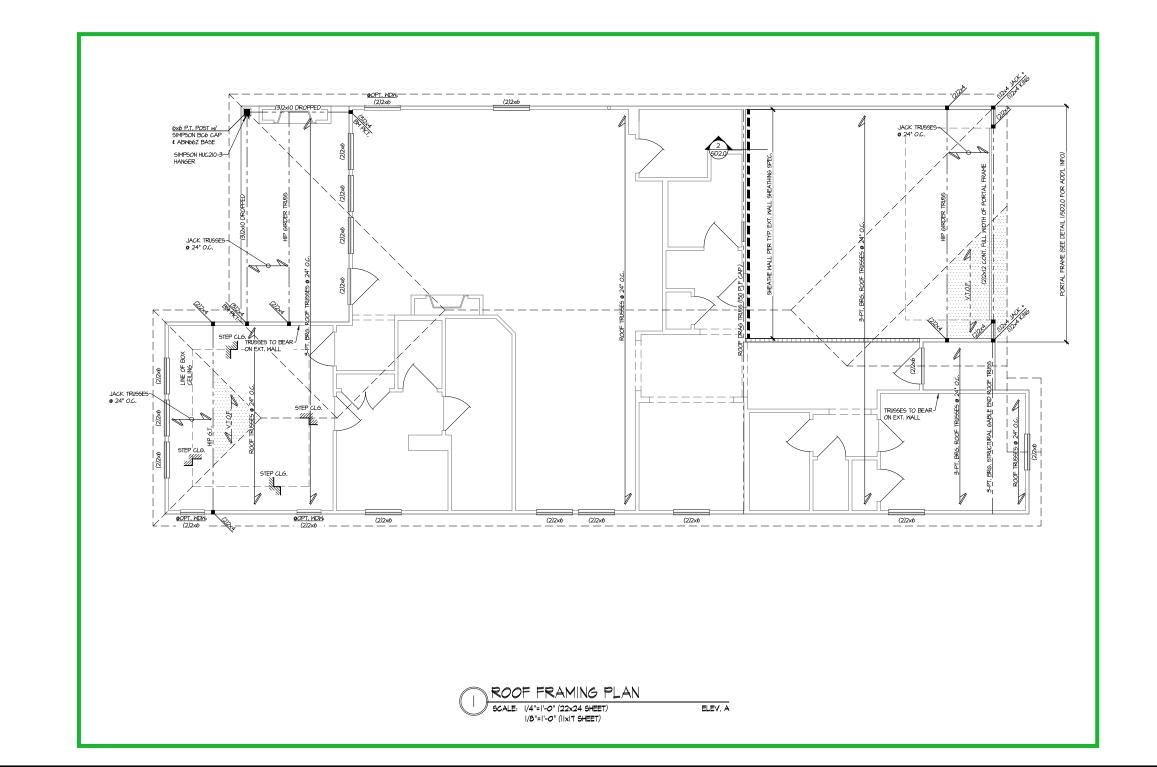

Serenity Lot 292 5919-03 - Oak Haven **Elevation A**

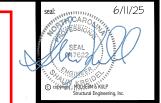

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RESIDENTIAL STRUCTURAL ENGINEERING

243-24029

MEG issue date: 08-14-2024

REVISIONS:

11/06/2024 SMM NAME, OPT. EXT. COVID. PORCH, 12/16/2024 ADDED DORMER TO ELEV. D 5/15/2025 MISC. ARCH. UPDATE MEM

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ROOF FRAMING PLAN

5919-03 MODEL

SERENITY MASTER SET RALEIGH, NC

► INDICATES HOLDOWN

* INDICATES POST ABOVE. PROVIDE SOLID

BLOCKING UNDER POST OR JAMB ABOVE

JL METAL HANGER

REFER TO SO.O FOR


TYPICAL STRUCTURAL NOTES

SCHEDULES

THIS LEVEL HAS BEEN DESIGNED


FOR 9'-I" PLATE HEIGHT

S2.1

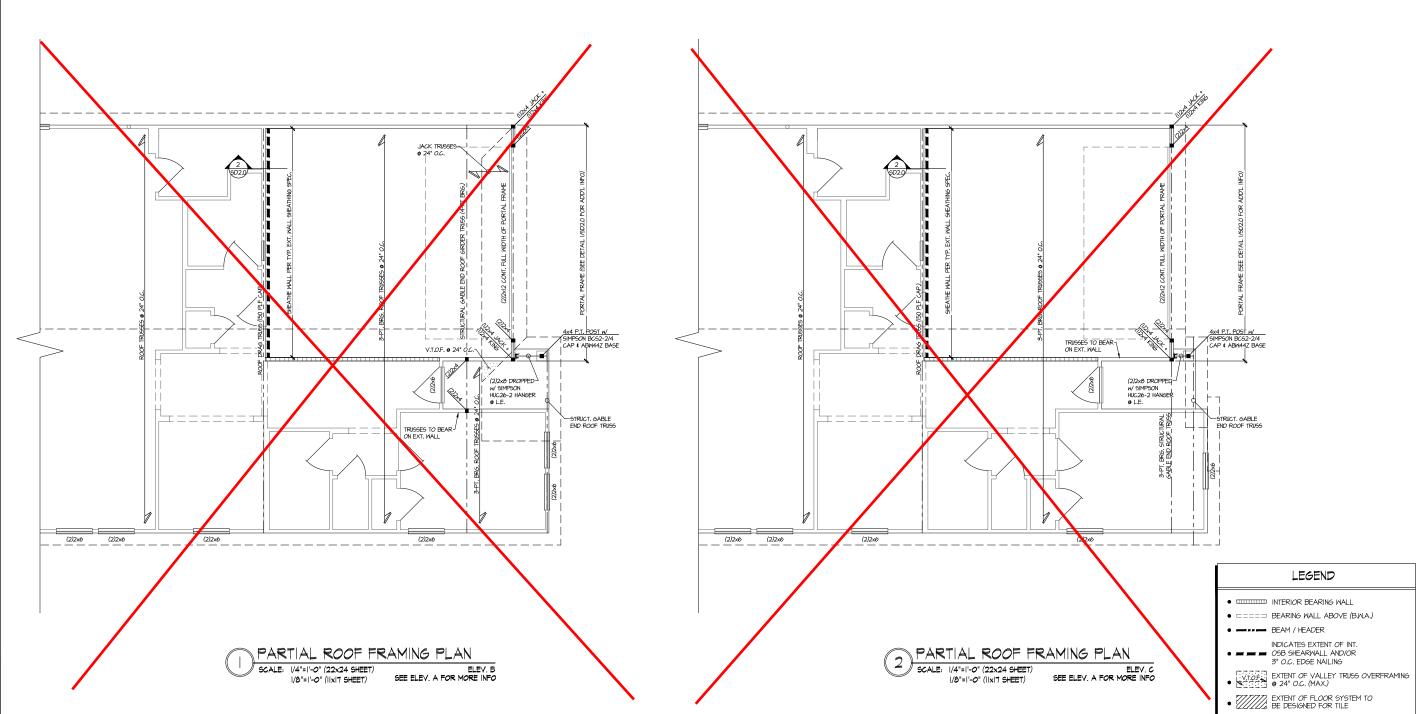

UNDER 9,000 FT² -FIRE-RATED WALL REQUIRED AT GARAGE SIDE & NON-GARAGE SIDE

Serenity Lot 292 5919-03 - Oak Haven Elevation A

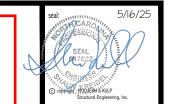

MULHERNHAL STRUCTURAL ENGINEERING
SEES BRodelde Perkvey, Shire 250 - Aphretia, SA 2002
p.776-777-0074 - multimodepoor



Mulhern+Kulp project number:

243-24029

project mgr: SMK drawn by: MEG issue date: 08-14-2024

REVISIONS:

date: initial: SMM uponte Mode, NAME, OPT, EXT, COVID, PORCH, OPT, CFECE: 12/16/20/24 ADDED DORMER TO ELEV, D 5/15/20/25 JPP MSC, ARCH, UPONTE

tri pointe HOMES

THIS LEVEL HAS BEEN DESIGNED FOR 9'-1" PLATE HEIGHT

LEGEND

- INTERIOR BEARING WALL
- BEAM / HEADER
- INDICATES EXTENT OF INT.

 OSB SHEARMALL AND/OR


 3" O.C. EDGE NAILING
- EXTENT OF VALLEY TRUSS OVERFRAMING
 24" O.C. (MAX.)
- F/7.7/7.7 EVTENT OF ELOOP GYGTEM
- NDICATES HOLDOWN
- METAL HANG
- INDICATES POST ABOVE. PROVIDE SOLID BLOCKING UNDER POST OR JAMB ABOVE.

REFER TO SO.O FOR
TYPICAL STRUCTURAL NOTES
\$ SCHEDULES


ROOF FRAMING PLAN


5919–03 MODEL Serenity Master set Raleigh, nc


S2.2

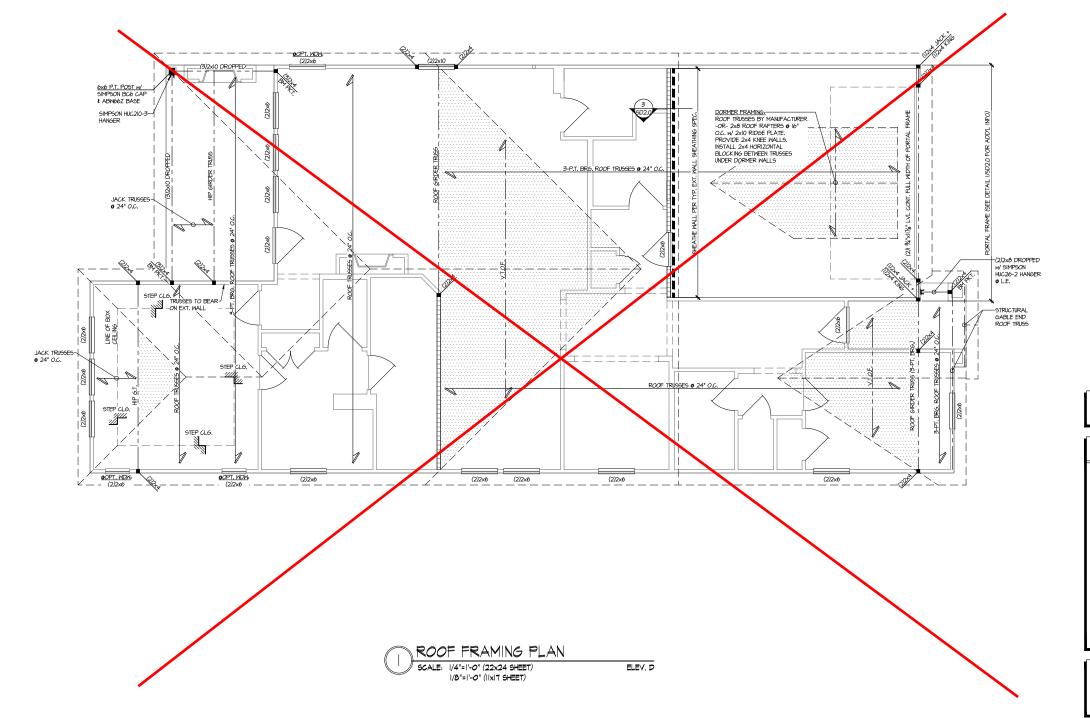


UNDER 9,000 FT² -NON-GARAGE SIDE

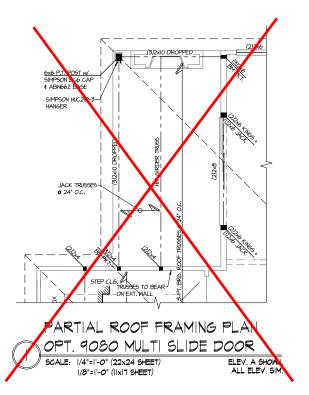

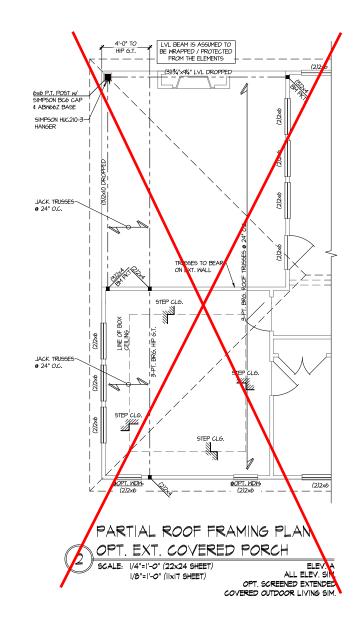

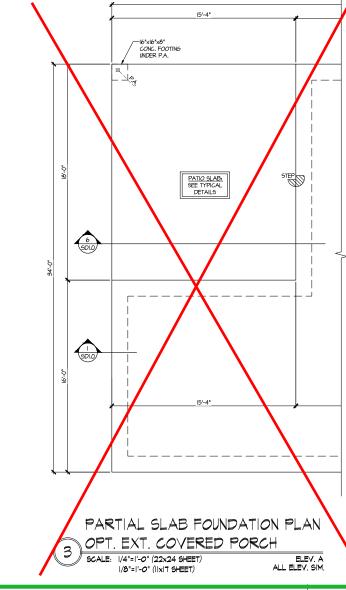

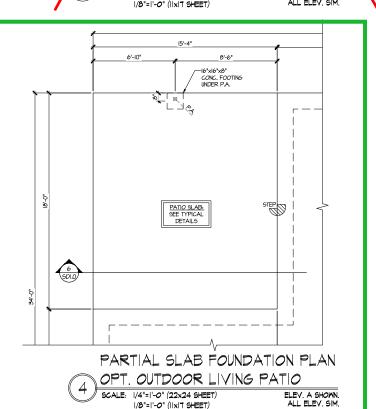

Serenity Lot 292 5919-03 -Oak Haven **Elevation A**



MULHERN+KULP

RESIDENTIAL STRUCTURAL ENGINEERING

3655 Broloside Parkway, Suita 250 - Aphiestra, GA 3002

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NC Licence # C-3825



Mulhern+Kulp project number

243-24029

MEG issue date: 08-14-2024

REVISIONS:

initial: SMM NAME, OPT. EXT. COVID. PORCH, 11/06/2024 12/16/2024 ADDED DORMER TO ELEY, D 5/15/2025 MISC, ARCH, UPDATE MEM

tri pointe

THIS LEVEL HAS BEEN DESIGNED FOR 9'-I" PLATE HEIGHT

LEGEND

- IIIIII INTERIOR BEARING WALL
- BEAM / HEADER
- INDICATES EXTENT OF INT. ■ 09B SHEARWALL AND/OR 3" O.C. EDGE NAILING
- EXTENT OF VALLEY TRUSS OVERFRAMING
- ► INDICATES HOLDOWN
- | INDICATES POST ABOVE. PROVIDE SOLID BLOCKING UNDER POST OR JAMB ABOVE

REFER TO SO.O FOR TYPICAL STRUCTURAL NOTES & SCHEDULES

PLANS **OPTION FRAMING**


MODEI

-03

5919-

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SERENITY MASTER SET RALEIGH, NC

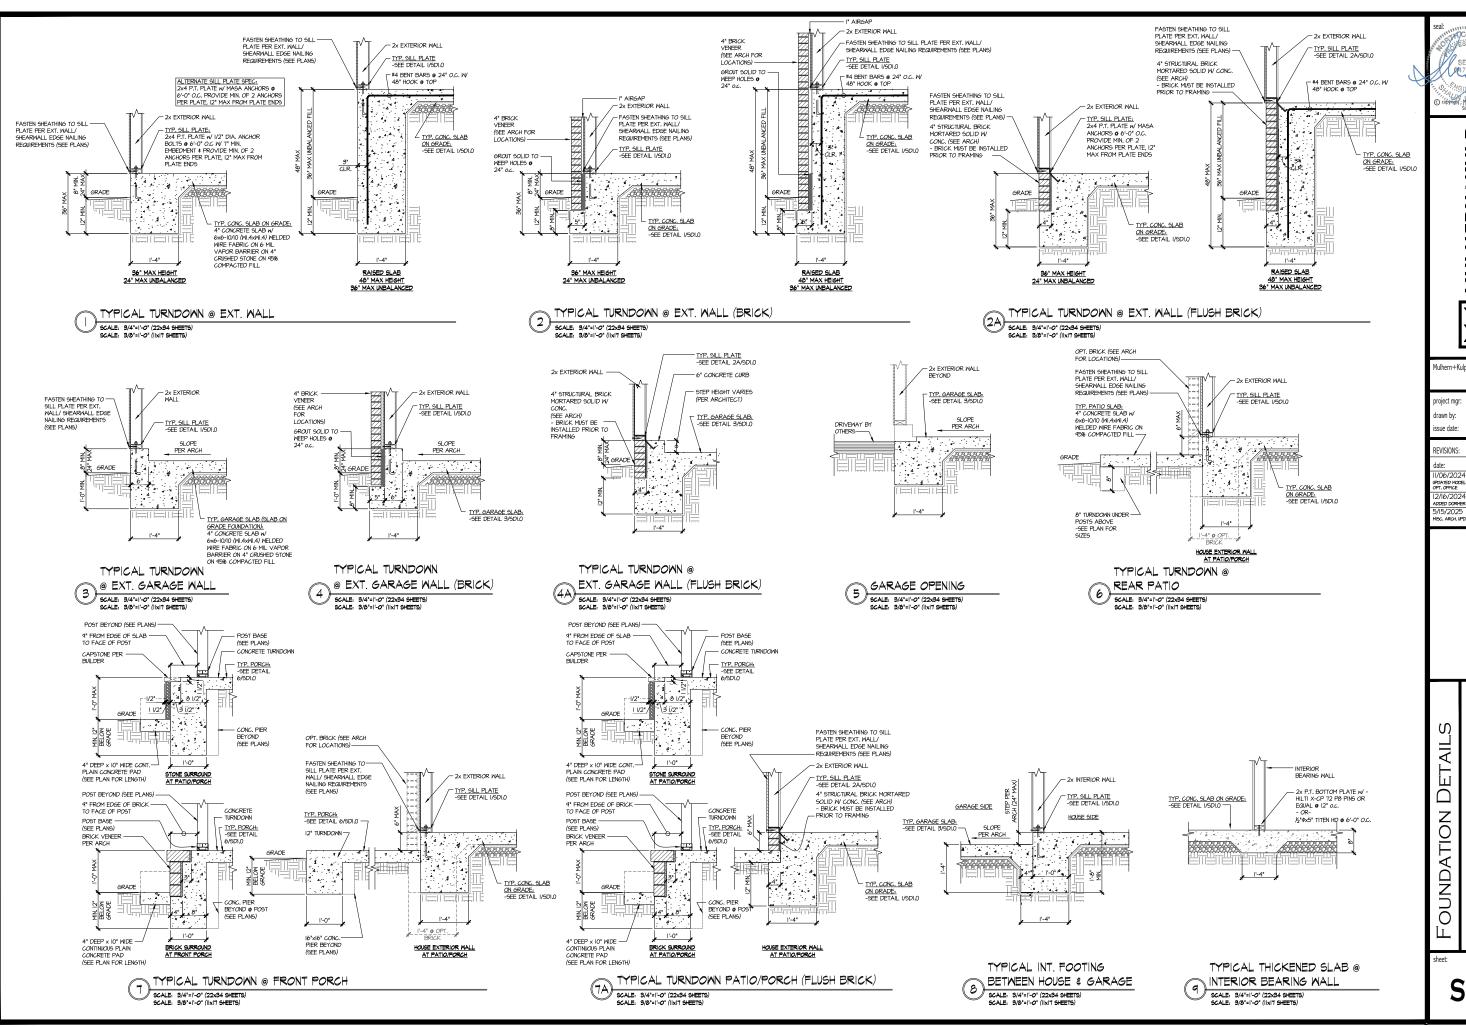

MULHERN+KULP
RESIDENTIAL STRUCTURAL ENGINEERING

lulhern+Kulp project number 243-2402

SMK MEC issue date: 08-14-2024


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SERENITY MASTER SET RALEIGH, NC 5919

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RESIDENTIAL STRUCTURAL ENGINEERING
SEES Bruscide Parkney, Sule 250 - Aphresia, 6A 3002
p.770-777-0074 - multimochanic



Aulhern+Kulp project number

243-24029

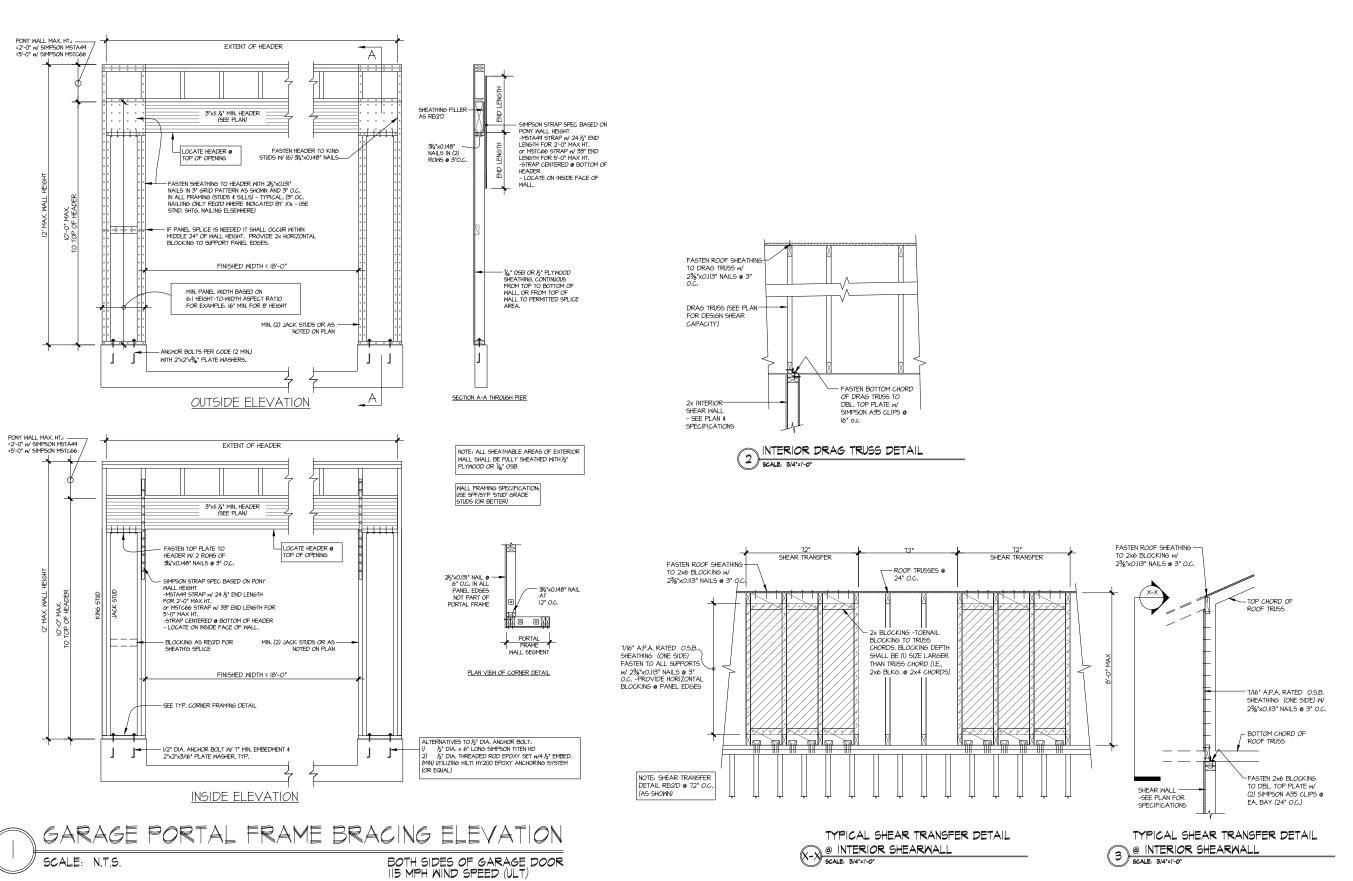SMK MEC issue date: 08-14-2024

REVISIONS:


initial: SMM NAME, OPT. EXT. COVID. PORCH, 11/06/2024 12/16/2024 ADDED DORMER TO ELEV. D 5/15/2025 MISC. ARCH. UPDATE MEM

tri pointe

FRAMING DETAILS MODEI

SERENITY MASTER SET RALEIGH, NC -03 5919-


SD2.0

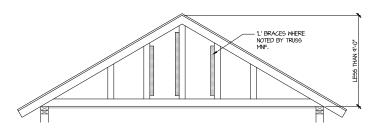

'L' BRACES FASTENED TO VERTICALS MEERE RECO'D BY TRUSS MANUFACTURER, FASTEN W 16d GUN NAILS (0.131 x 3 1/2") @ 6" O.C.

GABLE END TRUSS SHEATHED-WITH OSB.

FASTEN BOTTOM CHORD OF — GABLE END TRUSS TO DBL. TOP PLATE w/ 3"x0.120" (MIN.) TOE-NAILS & 8" O.C.

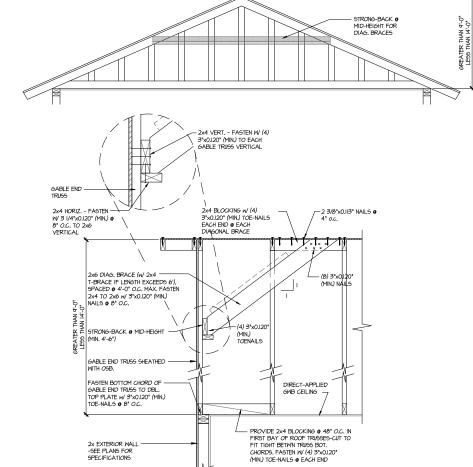

TYPICAL GABLE END BRACING DETAIL SCALE: NOME REQUIDED TRUSS REQ'D @ GABLE END TRUSS HEIGHT UP TO 9'-0'

DIRECT-APPLIED GWB CEILING —

- PROVIDE 2x4 BLOCKING ● 48" O.C. IN FIRST BAY OF ROOF TRUSSES-CUT TO FIT TIGHT BETWN TRUSS BOT. CHORDS, FASTEN W (3) 3 J V4"x0.120" (MIN.) TOE-NAILS @ EACH END

BRACE GABLE END TRUSSES PER ABOVE DETAIL WHEN GABLE HEIGHT IS LESS THAN 9"-0". "L" BRACES REQUIRED WHERE NOTED BY TRUSS MANUFACTURER.

BRACE GABLE END TRUSSES PER ABOVE DETAIL WHEN GABLE HEIGHT EXCEEDS 9'-0'. "L' BRACES NOT REQUIRED.

TYPICAL GABLE END BRACING DETAIL SCALE. NONE REQUIRE GABLE END TRUSS

REQ'D @ GABLE END TRUSS HEIGHT BETWN 9'-0" TO 14'-0"

MULHERN+KULP
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Mulhern+Kulp project number:

243-24029

SMK MEG issue date: 08-14-2024

REVISIONS: 11/06/2024

initial: SMM NAME, OPT. EXT. COVID. PORCH, 12/16/2024 ADDED DORMER TO ELEV. D 5/15/2025 MISC. ARCH. UPDATE MEM

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FRAMING DETAILS 5919-03 MODEL SERENITY MASTER SET RALEIGH, NC

SD2.1