MODEL 623L - GARAGE LEFT

THE FARM LOT 8

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AREA SCHEDULE

FIRST FLOOR HEATED	918 SF
SECOND FLOOR HEATED	1,258 SF
TOTAL HEATED AREA	2,176 SF
GARAGE *	367 SF
COVERED FRONT PORCH **	44 SF
TOTAL COVERED AREA	2,587 SF
OPT. REAR COVERED PORCH/SUNROOM	120 SF

- * ADD 252 SF @ THIRD-CAR GARAGE OPTION
- ** 120 SF @ ELEV. C & FULL PORCH OPTION @ ELEV. A/B

covered rear porch gas line in kitchen vent to outside

GENERAL NOTES

1. STAIRS: ALL STAIRS SHALL BE CONSTRUCTED IN ACCORDANCE WITH THE REQUIREMENTS ESTABLISHED BY THE ADOPTED BUILDING CODE. STAIR INFORMATION - MAXIMUM STAIR RISER 8-1/4"; MINIMUM STAIR TREAD 9" WITH A 3/4" - 1-1/4" NOSING ON STAIRS WITH SOLID RISER. MINIMUM STAIR HEADROOM 6'-8" CLEAR MEASURED VERTICALLY FROM THE STAIR NOSING OR FROM THE FLOOR SURFACE OF THE LANDING OR PLATFORM. MINIMUM CLEAR STAIR OPENING WIDTH SHALL NOT BE LESS THAN 36 INCHES. STAIRS WITH OPEN RISERS SHALL BE CONSTRUCTED TO PREVENT THE PASSAGE OF A SPHERE OF 4 INCHES OR MORE IN DIAMETER THROUGH THE RISER OPENINGS. THE GREATEST RISER HEIGHT WITHIN ANY FLIGHT OF STAIRS SHALL NOT EXCEED THE SMALLEST BY MORE THAN 3/8 INCHES. THE GREATEST TREAD RUN WITHIN ANY FLIGHT OF STAIRS SHALL NOT EXCEED THE SMALLEST BY MORE THAN 3/8 INCHES.

2. HANDRAILS AND GUARDRAILS: HANDRAILS MUST HAVE A MINIMUM AND MAXIMUM HEIGHT OF 34 INCHES

- SHALL BE PROVIDED ONE AT LEAST ON SIDE OF STAIRWAYS OF FOUR OR MORE RISERS. HANDRAILS SHALL BE CONTINUOUS THE FULL LENGTH OF THE STAIRS. ENDS SHALL BE RETURNED OR SHALL TERMINATE IN NEWEL POSTS OR SAFETY TERMINALS. ALL STAIRWAY HANDRAILS SHALL HAVE A CIRCULAR CROSS SECTION WITH AND OUTSIDE DIAMETER OF AT LEAST 1-1/4 INCHES AND NOT GREATER THAN 2 INCHES MAX. OR APPROVED RAILS OF EQUIVALENT GRASPABILITY. HANDRAILS PROJECTING FROM THE WALL SHALL HAVE A SPACE OF NOT LESS THAN 1-1/2 INCHES BETWEEN THE WALL AND THE HANDRAIL. GUARDRAILS NOT LESS THAN 36 INCHES IN HEIGHT AND SHALL BE INSTALLED AT ALL PORCHES, BALCONIES, OR RAISED FLOOR SURFACES LOCATED MORE THAN 30 INCHES ABOVE THE FLOOR OR GRADE BELOW.
- 3. WINDOW SUPPLIER IS TO CERTIFY THAT THE WINDOWS PROVIDED FOR BEDROOMS MEET THE GOVERNING BUILDING CODE EGRESS AND FALL PREVENTION REQUIREMENTS. IF LARGER WINDOWS ARE REQUIRED THAN THOSE SHOWN ON THE PLANS, THE SUPPLIER SHALL NOTIFY THE BUILDER AND THE BUILDER SHALL SUBSTITUTE THE LARGER WINDOWS FOR THOSE SHOWN ON THE PLANS. THE BUILDER SHALL CONFIRM WINDOW SIZES BY COMPLETING THE ROUGH FRAME OPENINGS BEFORE THE WINDOWS ARE ORDERED. GLAZING AT ALL WINDOWS, DOORS, TUBS, FIXED GLASS PANELS, SIDELIGHTS, ETC. MUST MEET THE REQUIREMENTS OF THE GOVERNING CODE WITH SPECIAL ATTENTION PAID TO GLAZING AT HAZARDOUS LOCATIONS PER IRC SECTION R308.
- 4. ALL VENTED CRAWL OR ATTIC SPACES SHALL BE PROVIDED WITH VENTS TO ALLOW A FLOW OF AIR THROUGH THE SPACE. FREE VENT AREA IS TO BE AS FOLLOWS: CRAWL VENTS SHOULD EQUAL 1/150 OF GROUND AREA, ROOF VENTS 1/300 OF CEILING AREA WITH VENTS DISTRIBUTED PER THE GOVERNING BUILDING CODE. PROVIDE ACCESS OPENINGS TO CRAWL (18"X 24" MIN.) AND ATTIC (22" X 30" MIN. WITH 30" HEADROOM) OR SIZED FOR REMOVAL OF MECHANICAL EQUIPMENT IF LOCATED IN ATTIC PER IRC M1305.1.3.
- 5. WHERE DRAWINGS OR INFORMATION IS IN CONFLICT WITH OTHER DRAWINGS OR DETAILS, THE BUILDER SHALL NOTIFY THE ARCHITECT IN WRITING PRIOR TO THE COMMENCEMENT OF CONSTRUCTION IN ORDER THAT A CLARIFICATION NOTICE CAN BE ISSUED.
- 6. ALL COMPONENTS AND CLADDING SHALL BE ATTACHED FOR WIND SPEED REQUIREMENTS NOTED ON THIS COVER SHEET OR PER THE GOVERNING BUILDING OFFICIAL'S REQUIREMENTS.

02. SITE WORK

- 1. PRESUMED SOIL BEARING CAPACITY IS NOTED ON THIS COVER SHEET. THE BUILDER IS RESPONSIBLE FOR VERIFYING THIS BEARING CAPACITY. ALL FOOTINGS SHALL BEAR ON UNDISTURBED SOIL OR
- 2. THE BOTTOM OF ALL FOOTINGS SHALL BE BELOW THE FROST LINE AS DEFINED BY THIS COVER SHEET, THE DRAWINGS OR THE GOVERNING BUILDING OFFICIAL'S REQUIREMENTS AND/OR 12" MINIMUM. 3. FOR BASEMENT CONDITIONS, THE MAXIMUM VERTICAL DISTANCE MEASURED FROM THE TOP OF A BASEMENT FLOOR SLAB TO THE OUTSIDE FINISHED GRADE SHALL NOT EXCEED DISTANCES FOR THE WALL THICKNESS AS SHOWN IN TABLES R-404.1.1 (1-4) OR R-404.1.2 (1-9) BASED ON
- 4. DO NOT BACKFILL UNTIL WALLS HAVE CURED AND THE ENTIRE BUILDING STRUCTURE ABOVE IS IN
- EQUALLY ON ALL SIDES, COMPACTED TO 95% MAXIMUM DRY DENSITY PER ASTM D698 5. FINISHED GRADE SHALL SLOPE AWAY FROM THE BUILDING AT A MINIMUM SLOPE OF 6 INCHES PER FOR
- A MINIMUM DISTANCE OF 10 FEET FROM THE BUILDING PER IRC SECTION R401.3 6. TERMITE TREATMENT - TREAT INTERIOR AND EXTERIOR EARTH AT PERIMETER WITH EPA APPROVED TERMICIDE. SPRAY BORA-CARE OR EQ. TERMICIDE & MOLD TREATMENT ON STUDS 3 FEET ABOVE SLABS PER MANUFACTURER'S RECOMMENDATIONS. PROVIDE TERMITE SHIELDS WHERE SHOWN ON PLANS.
- 03. CAST-IN-PLACE CONCRETE 1. CONCRETE SHALL HAVE A MINIMUM 28-DAY COMPRESSIVE STRENGTH OF 3,000 PSI. EXTERIOR SLABS TO BE 3,000 PSI, MIN. 5% & MAX. 7% AIR ENTRAINED CONCRETE.
- 2. CONCRETE PLACEMENT SHALL COMPLY WITH RECOMMENDATIONS OF ACI 332. 3. CONCRETE SLABS SHALL HAVE POLYPROPYLENE FIBER ADDITIVE (1.5 LB/CY) OR WWF REINFORCEMENT 6 X 6, W1.4 X W1.4 PER ASTM A 185 LOCATED MIDWAY THROUGH THE SLAB THICKNESS. ALL SLABS ARE TO BEAR ON COMPACTED FILL TESTED FOR 95% MAXIMUM DRY DENSITY PER ASTM D698.
- DEFORMED. 5. PROVIDE A 6 MIL POLYETHELENE MOISTURE VAPOR BARRIER MEMBRANE PER ASTM E1745 CLASS A

4. REINFORCING STEEL WHERE SHOWN ON PLANS SHALL CONFORM TO ASTM A615, GRADE 60 MIN.,

- UNDER INTERIOR AND GARAGE CONCRETE SLABS AND FOOTINGS WHERE INDICATED ON THE DRAWINGS. LAP SHEETS 6" MIN. AT JOINTS.
- 6. COVERED PORCHES SLABS SHALL SLOPE AT A MINIMUM SLOPE OF 1/8" PER FOOT TO DRAIN WATER AWAY FROM EXTERIOR WALLS. UNCOVERED PATIO SLABS SHALL SLOPE AT 1/4" PER FOOT.
- 1. CONCRETE MASONRY UNITS (CMU) SHALL CONFORM TO ASTM C90, GRADE N, NORMAL WEIGHT UNITS. 2. MORTAR TO BE TYPE 'M' WITH A 28 DAY COMPRESSIVE STRENGTH OF 2,000 PSI. PROVIDE CONTINUOUS HORIZONTAL JOINT REINFORCING EVERY OTHER COURSE. MORTAR TO MEET ASTM C270 STANDARDS.
- 3. GROUT SHALL MEET THE REQUIREMENTS OF ASTM C476 WITH A 28 DAY COMPRESSIVE STRENGTH OF 2,500 PSI. GROUT ALL CELLS RECEIVING ANCHORS AND THE TOP COURSE OF ALL BEARING WALLS. 4. FACE BRICK SHALL BE STANDARD SIZE AND COMPLY WITH ASTM C216, RUNNING BOND WITH TOOLED
- JOINT APPLICATION. SECURE BRICK VENEER TO WALL STUDS WITH 22 GA. GALV. METAL TIES ATTACHED TO STUDS WITH 8d NAILS SPACING AS SHOWN ON PLANS. 5. APPLY A BITUMINOUS WATERPROOF MEMBRANE TO THE EXTERIOR OF ALL BASEMENT WALLS TO BE BELOW
- GRADE AFTER BACKFILLING. 6. MANUFACTURED STONE WHERE SHOWN ON PLANS, SHALL BE INSTALLED IN STRICT ACCORDANCE
- WITH MANUFACTURER'S INSTALLATION INSTRUCTIONS AND DETAILS AND THE MASONRY VENEER MANUFACTURERS ASSOCIATION (MVMA) "INSTALLATION GUIDE AND DETAILING OPTIONS FOR COMPLIANCE WITH ASTM C1780 IN ACCORDANCE WITH SECTION R703.12. 05. STRUCTURAL STEEL
- 1. STEEL BEAMS AND PLATES SHALL CONFORM WITH ASTM A36. STEEL COLUMNS SHALL CONFORM TO ASTM A53.
- 2. ALL STRUCTURAL STEEL SHALL BE INSTALLED IN ACCORDANCE WITH CURRENT AISC SPECIFICATIONS AND "STEEL CONSTRUCTION MANUAL." ALL PIPE COLUMNS SHALL BE STANDARD WEIGHT STEEL COLUMNS IN ACCORDANCE WITH ASTM A500 AND FINISHED WITH CORROSION RESISTANT COATING PER ASTM B117. STEEL COLUMNS AT BASEMENT LOCATIONS SHALL PENETRATE THE BASEMENT SLAB DOWN TO THE TOP OF THE COLUMN FOOTING BELOW SLAB.

1. FRAMING LUMBER SHALL BE IDENTIFIED BY A GRADE MARK OR EVALUATION STAMP WHICH PROVIDES THE FOLLOWING MINIMUM DESIGN VALUES:

FRAMING LUMBER HEM/SYP/SPF #2 OR BETTER Fb = 875 PSISYP #2 OR BETTER Fb = 975 PSIFc = 425 PSISTANDARD Fb = 275 PSI

- 2. CONSTRUCTION SHALL BE IN ACCORDANCE WITH THE AMERICAN WOOD COUNCIL (AWC), "WOOD FRAME CONSTRUCTION MANUAL" (WFCM) AND SHALL COMPLY WITH SECTION R301.1 TO SUPPORT
- SEALED BY A STATE-LICENSED DESIGN PROFESSIONAL, FOR APPROVAL PRIOR TO FABRICATION. INSTALL TRUSSES AND ENGINEERED LUMBER IN STRICT ACCORDANCE WITH THE SHOP DRAWINGS AND WTCA-B1,B2, B3 AND B7. ALL POINT LOADS, PARTIAL UNIFORM LOADS OR COMBINATIONS THEREOF SHALL BE DETERMINED BY THE TRUSS MANUFACTURER AND ACCOUNTED FOR IN THE DESIGN OF THE ROOF AND/OR FLOOR SYSTEM.
- 4. PREFABRICATED WOOD-I-JOISTS SHALL BE RATED PER ASTM D5055 AND INSTALLED PER SHOP DRAWINGS AND DETAILS PROVIDED BY THE MANUFACTURER. 5. HANGERS, ANCHORS AND FASTENERS, WHEN CALLED FOR IN SHOP DRAWINGS OR THESE DRAWINGS,
- SHALL BE INSTALLED IN COMPLIANCE WITH THE MANUFACTURER'S INSTRUCTIONS. ALL HANGERS, FRAMING ANCHORS AND FASTENERS IN CONTACT WITH PRESSURE TREATED WOOD TO BE STAINLESS STEEL OR GALVANIZED PER G185 RATING 'Z-MAX' COATING BY SIMPSON OR 'TRIPLE ZINC' BY USP.
- 6. BEAMS AND HEADERS ARE TO BEAR ON JACK STUDS AS NOTED ON THE PLANS, SHOP DRAWINGS, OR PER CODE PROVIDE SOLID BLOCKING BELOW ALL JACK STUDS FORMING A CONTINUOUS BEARING LINE TO THE FOUNDATION 7. ALL LUMBER IN CONTACT WITH EARTH, CONCRETE OR MASONRY SHALL BE PRESSURE TREATED. FIELD TREAT
- SAWED, DRILLED OR NOTCHED TREATED LUMBER PER AWPA M4-15. 8. PROVIDE STRUCTURAL SHEATHING WHERE NOTED ON PLANS. ALL WOOD SHEATHING SHALL BE APA RATED FOR INTENDED USE AND SUPPORT SPANS. INSTALL ROOF SHEATHING WITH "H" CLIPS BETWEEN TRUSSES. 9. INSTALL FIREBLOCKING PER R302.11 TO CUT OFF DRAFT OPENINGS AT ALL INTERCONNECTIONS BETWEEN
- CONCEALED VERTICAL AND HORIZONTAL SPACES, BETWEEN STORIES, AND BETWEEN THE TOP STORY AND ROOF 10. STUDS FOR EXTERIOR WALLS SHALL BE SIZED PER THE GOVERNING RESIDENTIAL CODE
- 11. ALL NOTCHES AND CUTS IN FRAMING SHALL NOT EXCEED MAX. DIMENSIONS AS DEFINED IN SECTION R602.6.
- 1. INSTALL INSULATION MATERIALS TO MEET THE 'R' VALUES AS SHOWN ON THE DRAWINGS. FIT INSULATION TIGHT INTO SPACES AND LEAVE NO GAPS OR VOIDS. PROVIDE RIGID INSULATION WHERE SHOWN ON PLANS. AT INTERIOR WALLS SEAL ALL JOINTS. SEAMS AND PENETRATIONS TO PREVENT AIR LEAKAGE PER N1102.4
- 2. INSTALL FIBERGLASS/ASPHALT ROOF SHINGLES IN ACCORDANCE WITH MANUF. INSTRUCTIONS AND ASPHALT ROOFING MANUFACTURERS ASSOC. "ASPHALT ROOFING RESIDENTIAL MANUAL." SHINGLES ARE TO BE CERTIFIED MIN. CLASS C FIRE RESISTANCE PER ASTM E108 OR UL 790 AND WIND RESISTANCE CLASS PER ASTM D 3161 OR D7158 FOR WIND SPEED. INSTALL UNDERLAYMENT PER ROOF SLOPE AND SECTION R905.2.2 AND CONFORMING TO ASTM D226 TYPE I.
- 3. INSTALL FLASHING, SHEET METAL, GUTTERS AND DOWNSPOUTS PER PLANS AND PER "ASPHALT ROOFING RESIDENTIAL MANUAL" AND "ARCHITECTURAL SHEET METAL MANUAL" BY SMACNA. INSTALL FLASHING AT ALL ROOF TO WALL CONDITIONS. EXTERIOR OPENINGS AND ELSEWHERE WHERE REQUIRED.
- 4. INSTALL A WATER-RESISTIVE BARRIER ON ALL WALLS. HOUSEWRAPS SHOULD MEET ASTM D5034 FOR DURABILITY, D779 FOR WATER RESISTANCE AND E96 FOR PERMEABILITY AND BE INSTALLED PER MANUF. INSTALLATION INSTRUCTIONS. PRE-WEATHERIZED SHEATHING SHALL BE TAPED AND SECURED PER MANUF. INSTALLATION INSTRUCTIONS.
- INSTALL SIDING AND ACCESSORY COMPONENTS IN STRICT ACCORDANCE WITH MANUFACTURER'S INSTRUCTIONS WIND PRESSURE RESISTANCE TO BE DETERMINED BY ASTM E330.

08. DOORS, WINDOWS AND GLASS

- INSTALL DOORS IN ACCORDANCE WITH MANUFACTURER'S WRITTEN INSTALLATION RECOMMENDATIONS. 2. ALL ALUMINUM AND/OR VINYL (PVC) AND/OR WOOD WINDOWS AND DOORS SHALL CONFORM TO CLASS R WITH DP PERFORMANCE GRADE AS NOTED ON THE COVER SHEET, TESTED PER AAMA/WDMA/CSA 101/I.S.2/A440 FOR THE APPLICABLE WINDOW AND DOOR TYPES SHOWN ON THE DRAWINGS. INSTALL TEMPERED GLASS AND WINDOWS WHERE NOTED ON PLANS OR AS REQUIRED BY CODE. ENERGY PERFORMANCE RATINGS FOR U VALUES AND SHGC SHALL
- BE AS NOTED ON THE COVER SHEET AND TESTED PER NFRC 100 AND NFRC 200 RESPECTIVELY. 3. INSTALLATION AND FLASHING OF WINDOWS AND DOORS TO BE IN ACCORDANCE WITH MANUFACTURERS WRITTEN
- INSTALLATION INSTRUCTIONS AND ASTM E2112. 4. INSECT SCREENS TO BE IN ACCORDANCE WITH ANSI/SMA 1004, ANSI/SMA 2006, OR ANSI/SMA 3001.
- 5. PROVIDE AND INSTALL HARDWARE PER OWNER'S SCHEDULE. 6. GARAGE DOORS SHALL BE CERTIFIED IN ACCORDANCE WITH ASTM/DASMA 108 FOR THE
- APPLICABLE WIND PRESSURES AS NOTED ON THE COVER SHEET.
- 09. FINISHES
- 1. GYPSUM WALL BOARD, GYPSUM SHEATHING MATERIALS AND ACCESSORIES SHALL BE INSTALLED IN ACCORDANCE WITH IRC R702.3 AND WITH GA-253 "APPLICATION OF GYPSUM SHEATHING" PUBLISHED BY THE GYPSUM ASSOCIATION. 2. INSTALL FLOOR COVERINGS AS SHOWN ON PLANS OR PER OWNER'S SCHEDULE PER MANUF. INSTALLATION INSTRUCTIONS.
- 10. SPECIALTIES 1. PROVIDE KITCHEN AND BATH CABINETS FIXTURES AND APPLIANCES, FIREPLACE, HARDWARE AND MISC. ITEMS PER OWNERS SCHEDULE. INSTALLATIONS TO BE IN ACCORDANCE WITH APPROVED SHOP DRAWINGS AND MANUFACTURER'S
- INSTALLATION INSTRUCTIONS. PRE-FAB FIREPLACES TO BE UL LISTED AND COMPLY WITH UL 127. <u>11-14. N/A</u>

15. MECHANICAL

- 1. INSTALL VENTILATORS AND HEATING AND AIR CONDITIONING SYSTEMS AS SHOWN ON PLANS OR PER OWNER'S SCHEDULE. SIZE ALL EQUIPMENT PER ACCA MANUAL S AND J AND INSTALL FOR FUTURE ACCESS SERVICE AND REMOVAL. PROVIDE COMBUSTION AIR WHEN REQUIRED PER SECTION M1701. ALL DUCTWORK AND PIPING LOCATED IN UNCONDITIONED SPACES SHALL BE INSULATED AND SEALED PER CODE. INSTALL DRYER DUCT TO OUTSIDE WITH SMOOTH METAL DUCTING WITHOUT SCREWS AND WITH MINIMUM BENDS, MAXIMUM DUCT LENGTH PER IRC M1502.
- STRUCTURE WITH A BACKDRAFT DAMPER IN ACCORDANCE WITH THE CURRENT CODE. 3. PROVIDE A PROGRAMABLE THERMOSTAT, MANUALS FOR MECHANICAL AND WATER HEATING EQUIPMENT, ENERGY COMPLIANCE CERTIFICATE AND ALL OTHER REQUIREMENTS OF THE CURRENT ENERGY CODE.

2. VENTING: ALL DRYERS AND BATH EXHAUSTS MUST BE VENTED DIRECT TO THE EXTERIOR OF THE

- 16. ELECTRICAL 1. TERMINAL HOOK UP IS REQUIRED FOR ALL FIXTURES, APPLIANCES, MOTORS, FANS AND CONTROLS. LOCATION OF OUTLETS AND EQUIPMENT ON PLANS IS APPROXIMATE, EXACT ROUTING OF WIRING AND OUTLETS SHALL
- BE GOVERNED BY STRUCTURAL CONDITIONS AND OBSTRUCTIONS. 2. ALL ELECTRICAL BREAKERS AND CONTROLS SHALL BE PROPERLY LABELED. INSTALL GFCI PROTECTED AND AFCI OUTLETS WHERE SHOWN ON PLANS OR AS REQUIRED BY CODE. MATERIAL AND EQUIPMENT SHALL BEAR A UL LABEL. LIGHT FIXTURES MUST MEET CLEARANCES STATED IN THE NEC. INSTALL LIGHT SWITCHES AT 3' 6" A.F.F. AND OUTLETS
- 12" A.F.F. TO CENTERLINE U.N.O. 3. INSTALL ELECTRIC SMOKE DETECTORS, CARBON MONOXIDE/ALARMS WHERE SHOWN ON PLANS. ALL DETECTORS MUST BE INTER-CONNECTED AND INCORPORATE A BATTERY BACK-UP. INSTALL PER NFPA 72 AND UL 217 REQUIREMENTS. CO ALARMS TO COMPLY WITH NFPA 720 AND UL 2034. COMBINATION SMOKE/CO ALARMS MUST BE LISTED PER UL 2034. 4. PROVIDE HIGH EFFICACY LAMPS IN PERMANENT FIXTURES PER GOVERNING RESIDENTIAL ENERGY CODE.
- 1. INSTALL PLUMBING FIXTURES, SUPPLY AND WASTE LINES PER GOVERNING CODE. ALL NOTCHES AND CUTS IN FRAMING SHALL NOT EXCEED MAX. DIMENSIONS AS DEFINED IN THE GOVERNING CODE. PROTECT PLUMBING LINES AND REINFORCE STUD WALL NOTCHES WITH 16 GA. METAL PLATES.

BUILDING CODE SUMMARY

Location.		,			
Proposed Use: Owner: Contact Person:	Detached Single	Family Dwelling			
	Chesapeake Ho	mes			
	Brad Blough	Telephone #:	(919) 256-3060	E-mail:	bblough@cheshomes.com
DESIGNER OF RE	ECORD:				

DESIGNER	OF RECORD:			
<u>Designer</u>	<u>Name</u>	<u>License #</u>	Telephone #:	<u>E-mail:</u>
Architect	James W. Wentling	NC-Arch. # 4642	(215) 568-2551	JamesWentling @wentlinghouseplans.com
Structural:	Jonathan A. Troxler	NC-P.E # 27845	(919) 878-1617	jtroxler @southernengineers.com

BUILDING DATA:

Code.	2018 North Carolina State Residential Code
	2015 IRC with North Carolina Amendments

Various Locations, NC Market

DESIGN LOADS:

Live Load:	20 PSF	Attic With Permanent Stair:
Live Load:	40 PSF	Attic Without Permanent Stair:
Live Load Sleeping Rooms:	30 PSF	Attic Without Storage:

CLIMATIC & GEOGRAPHIC DESIGN CRITERIA:

Ground Snow Load:_	20 PSF	
Design Wind Speed:	115-120 MPH	Ex
Seismic Site Class:	С	Ris
Seismic Design Cate	gory: B	
Weathering:	Moderate	
Frost Line:	12"	
Termite Decay:	Moderate to Heavy	
Winter Design Temp.	: 20 Degrees	
Climata Zana:	4 A	

Design Pressure PSF xposure:<u> B </u> isk Group:<u>II</u> Windows + Doors: 25

Climate Zone:

ENERGY EFFICIENCY:

Minimum Insulation: Ceiling:

R-38 (R-30 w/ Raised Heel Truss Floors: Glazing 'U' Value: SHGC:

(Note: Minimum insulation values per Southern Energy Reports)

SOIL BEARING CAPACITIES:

Presumptive Bearing Capacity: 2,000 PSF

ABBREVIATIONS					
TEXT	DESCRIPTION	TEXT	<u>DESCRIPTION</u>		
BRG.	: BEARING	MAX.	: MAXIMUM		
COMP.	: COMPRESSOR	MIN.	: MINIMUM		
CLG.	: CEILING	O.C.	: ON CENTER		
C.J.	: CEILING JOISTS	OPT.	: OPTIONAL		
CONC.	: CONCRETE	OSB	: ORIENTED STRAND BOARD		
COND.	: CONDITION	P.T.	: PRESSURE TREATED		
DBL. JST.	: DOUBLE JOIST	R.	: RISERS		
DIA.	: DIAMETER	REF.	: REFIGERATOR		
DWG.	: DRAWING	REQ.	: REQUIRED		
DWO.	: DRYWALL OPENING	R & S	: ROD AND SHELF		
E. M.	: ELECTRIC METER	R.R.	: ROOF RAFTERS		
ENG.	: ENGINEERED	R.T.	: ROOF TRUSSES		
E.P.	: ELECTRICAL PANEL	S.C.	: SOLID CORE - 1-3/4" THICK OR 20 MIN. RATED DOOR		
EQ.	: EQUAL	S.S.	: SELECT STRUCTURAL		
EXT.	: EXTERIOR	SHOW.	: SHOWER		
FOUND.	: FOUNDATION	S.L.	: SIDE LITE		
FTG.	: FOOTING	SPEC.	: SPECIFICATIONS		
H.P.D.	: HINGED PATIO DOOR	Т.	: TREADS		
H.	: HIGH	T.M.	: TRUSS MANUFACTURER		
НВ	: HOSE BIBB	TEMP.	: TEMPERED		
INCL.	: INCLUDED	T.O.F.	: TOP OF FOUNDATION		
INT.	: INTERIOR	TYP.	: TYPICAL		
J.M.	: JOIST MANUFACTURER	U.N.O.	: UNLESS NOTED OTHERWISE		
J.S.	: JACK STUDS	VAN.	: VANITY		
F.A.U.	: FORCED AIR UNIT	W/	: WITH		

(215) 568-2551 email -information@ wentlinghouseplans.com


LAND TITLE BUILDING 100 SOUTH BROAD STREET, PHILADELPHIA, PA 19110

JAMES WENTLING/

ARCHITECT

ARCHITECTURE LAND PLANNING

GRAPHICS THE CESSATION OF SUCH CONSTRUCTION

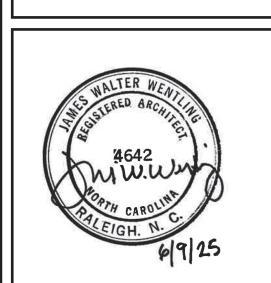

REVISIONS		
MARK	DATE	DESCRIPTION
JM	01-27-25	623 CLIENT REV.
JW	02-07-25	REV. PER 2/5/25 CALL
TT	03-20-25	REV. PER MTG.
TT	04-03-25	REV. PER COST. EMS
DN	05-14-25	STRUCT. DWG. REVIEW
DN	05-21-25	STRUCT. DWG. REVIEW
JW	06-09-25	CORRECT ELEV. C PORCE

	. . .	CORRECT ELEVICETORCH
PROJECT NO.	110	0.0
	113-	-88
DATE	01-08-	18
	01-00-	10
SCALE	NO GO	TALE.
	NO SO	CALE
DRAWN BY	DN	
	DN	
CHECKED BY	1337	
	JW	
ISSUED FOR	DEDIA	HTC/CONCTDUCTION
	PERM	IITS/CONSTRUCTION


MODEL 623L GARAGE LEFT

CHESAPEAKE HOMES OF NC 3100 Smoketree Court Suite 210

Raleigh, NC 27604 (919) 256-3060

(919) 556-0690 Fax

CONTENTS AND PROJECT INFORMATION

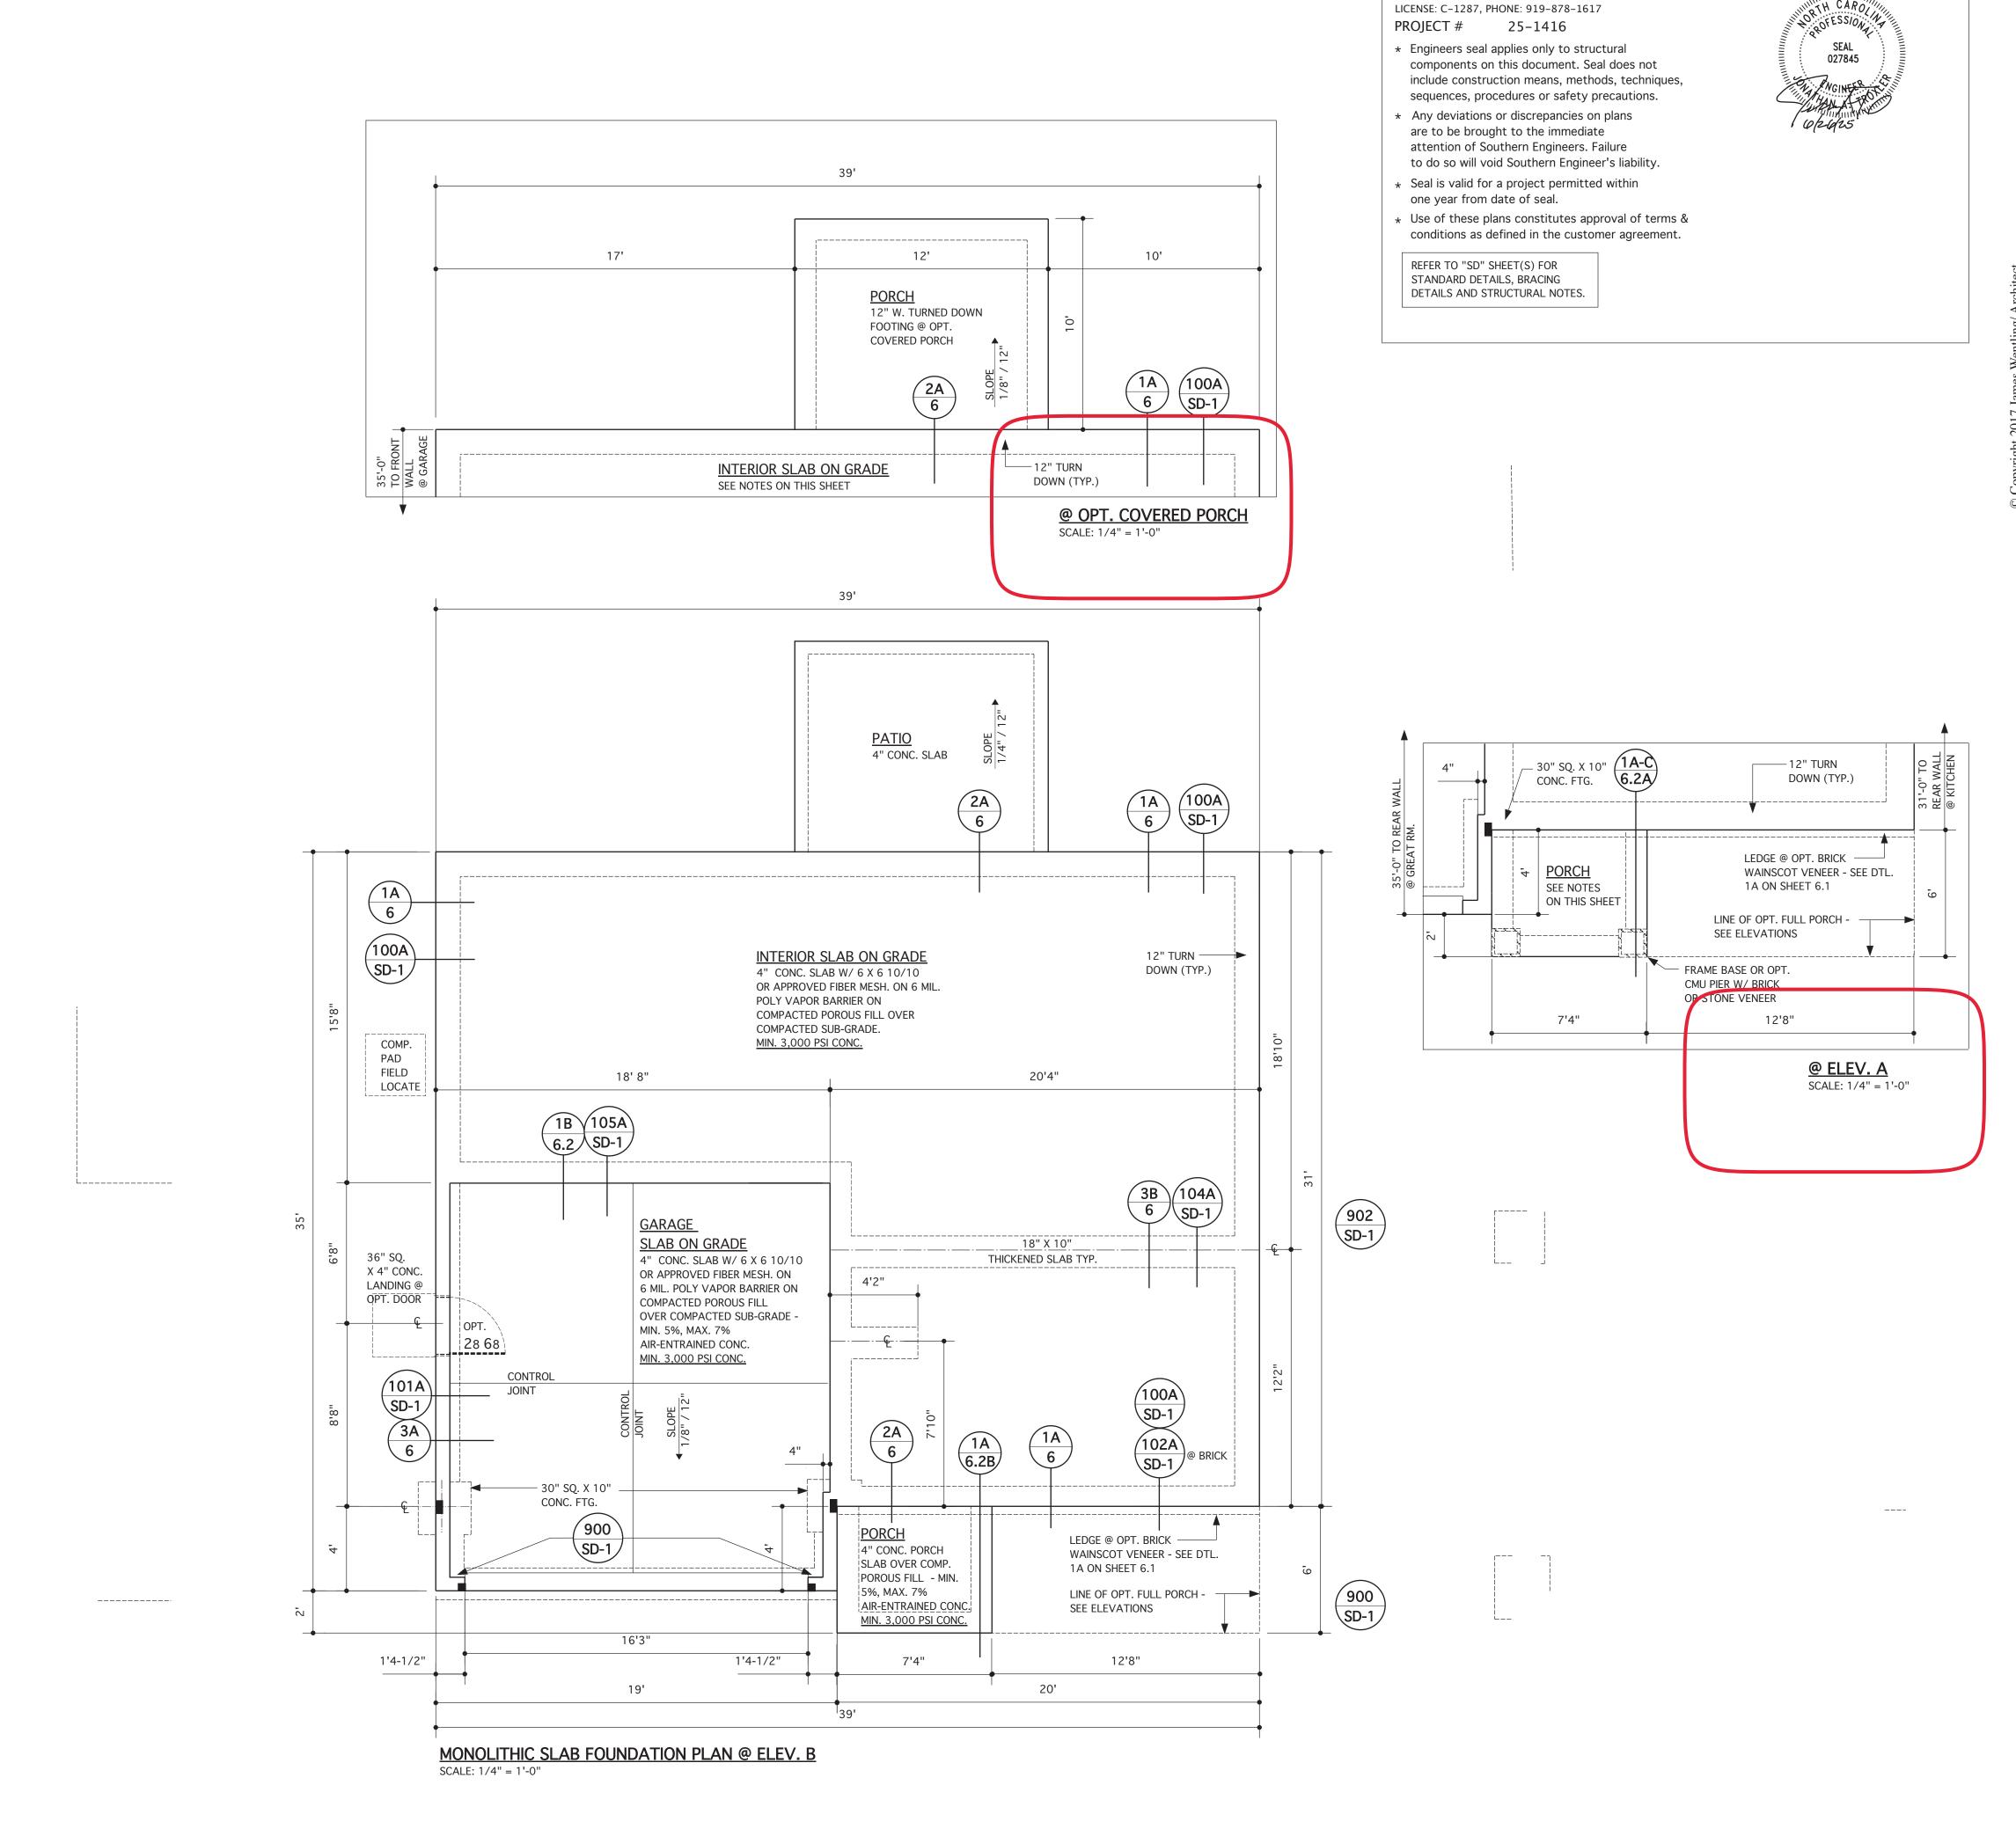

STRUCTURAL DESIGN BY: SOUTHERN ENGINEERS, P.A.

3716 BENSON DR., RALEIGH, NC 27609

JAMES WENTLING/ ARCHITECT

LAND TITLE BUILDING 100 SOUTH BROAD STREET, SUITE 1524


(215) 568-2551 email -information@ wentlinghouseplans.com

PHILADELPHIA, PA 19110

ARCHITECTURE LAND PLANNING

LAND PLANNING GRAPHICS

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REVIS	SIONS	
MARK	DATE	DESCRIPTION
DN	01-16-25	REV. 62100 PER NEW FIRST
JM	01-27-25	623 CLIENT REV.
JW	02-07-25	REV. PER 2/5/25 CALL
TT	03-20-25	REV. PER MTG.
TT	04-03-25	REV. PER COST. EMS
DN	05-14-25	STRUCT. DWG. REVIEW
DN	05-21-25	STRUCT. DWG. REVIEW

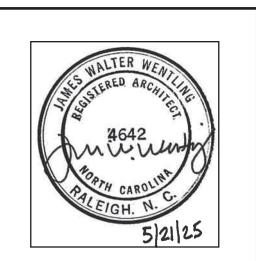PROJECT NO.	
	113-88
DATE	01-08-18
SCALE	
	AS NOTED
DRAWN BY	DN
CHECKED BY	JW
ISSUED FOR	PERMITS/CONSTRUCTION

PROJECT TITLE

MODEL 623L GARAGE LEFT

CHESAPEAKE

HOMES OF NC 3100 Smoketree Court, Suite 210 Raleigh, NC 27604 (919) 256-3060 (919) 556-0690 Fax

DRAWING T

MONOLITHIC SLAB FOUNDATION PLAN

WALLS ARE DIMENSIONED TO FACE OF STUD AND ARE 3-1/2" THICK UNLESS NOTED OTHERWISE. (SEE SHEET SD-1 FOR ADDITIONAL NOTES & DETAILS) (SEE FLOOR SYSTEM LAYOUT AND SHOP DRAWINGS FOR ADDITONAL INFORMATION AND

NOTE: SEE ELEVATIONS FOR OPT. BRICK OR STONE WAINSCOT/VENEER TYPES & LOCATIONS

TO VERIFY BEAM & JOIST SIZES AND LOCATIONS.)

SEE SD SHEETS FOR PORTAL FRAME DETAILS APA-PF: APA PORTAL FRAME APA-PF-END: END CONDITION FOR APA PORTAL FRAME CS-PF: CONTINUOUS PORTAL FRAME CONSTRUCTION <u>CS-PF-END:</u> END CONDITION FOR CONTINUOUS PORTAL FRAME

PORTAL FRAME LEGEND

STRUCTURAL DESIGN BY: SOUTHERN ENGINEERS, P.A. 3716 BENSON DR., RALEIGH, NC 27609 LICENSE: C-1287, PHONE: 919-878-1617 PROJECT # 25-1416

- * Engineers seal applies only to structural components on this document. Seal does not include construction means, methods, techniques, sequences, procedures or safety precautions.
- * Any deviations or discrepancies on plans are to be brought to the immediate attention of Southern Engineers. Failure to do so will void Southern Engineer's liability.
- * Seal is valid for a project permitted within
- * Use of these plans constitutes approval of terms & conditions as defined in the customer agreement.

DETAILS AND STRUCTURAL NOTES.



WOOD I-JOISTS (14" DEPTH)

- (SHALL BE ONE OF THE FOLLOWING): * TJI 210 BY TRUS JOIST
- * LPI 20 PLUS BY LP * BCI 5000s 1.8 BY BC
- * BLI 40 BY onCENTER
- * ALL JOIST SPACING TO BE 24" O.C. (UNLESS NOTED OTHERWISE)
- * ALL I-JOISTS SHALL BE INSTALLED ACCORDING TO MANUFACTURER'S SPECIFICATIONS.
- * INSTALL SQUASH BLOCKS, WEB STIFFENERS, ETC. AS REQUIRED BY AND ACCORDING TO THE I-JOIST MANUFACTURER'S SPECIFICATIONS AND INSTRUCTIONS.
- * HANGERS FOR I-JOISTS ARE THE RESPONSIBILITY OF THE I-JOIST SUPPLIER.





JAMES WENTLING/

LAND TITLE BUILDING 100 SOUTH BROAD STREET,

PHILADELPHIA, PA 19110

ARCHITECT

(215) 568-2551

email -information@

ARCHITECTURE

LAND PLANNING

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COPYRIGHT PROTECTION ACT OF 1990." THE

ARRANGEMENT AND COMPOSITION OF

REPRESENTED CAN LEGALLY RESULT

SPACES AND ELEMENTS OF THE DESIGN.

PROTECTION INCLUDES BUT IS NOT LIMITED TO, THE OVERALL FORM AS WELL AS THE

UNDER SUCH PROTECTION, UNAUTHORIZED

IN THE CESSATION OF SUCH CONSTRUCTION

OR BUILDINGS BEING SEIZED AND/OR RAISED

USE OF THESE PLANS, WORKS, OR FORMS

AS THE "ARCHITECTURAL WORKS

GRAPHICS

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REVISIONS			
MARK	DATE	DESCRIPTION	
JM	01-27-25	623 CLIENT REV.	
JW	02-07-25	REV. PER 2/5/25 CALL	
TT	03-20-25	REV. PER MTG.	
TT	04-03-25	REV. PER COST. EMS	
DN	05-14-25	STRUCT. DWG. REVIEW	
DN	05-21-25	STRUCT. DWG. REVIEW	
JW	06-09-25	CORRECT ELEV. C PORCH	


PROJECT NO.	
	113-88
DATE	
	01-08-18
SCALE	A C NOTED
	AS NOTED
DRAWN BY	
	DN
CHECKED BY	JW
ISSUED FOR	DED MEG (GO) (GD) (GE)
1	PERMITS/CONSTRUCTION

MODEL 623L GARAGE LEFT


CHESAPEAKE HOMES OF NC

3100 Smoketree Court, Suite 210 Raleigh, NC 27604 (919) 256-3060 (919) 556-0690 Fax

FIRST FLOOR PLANS

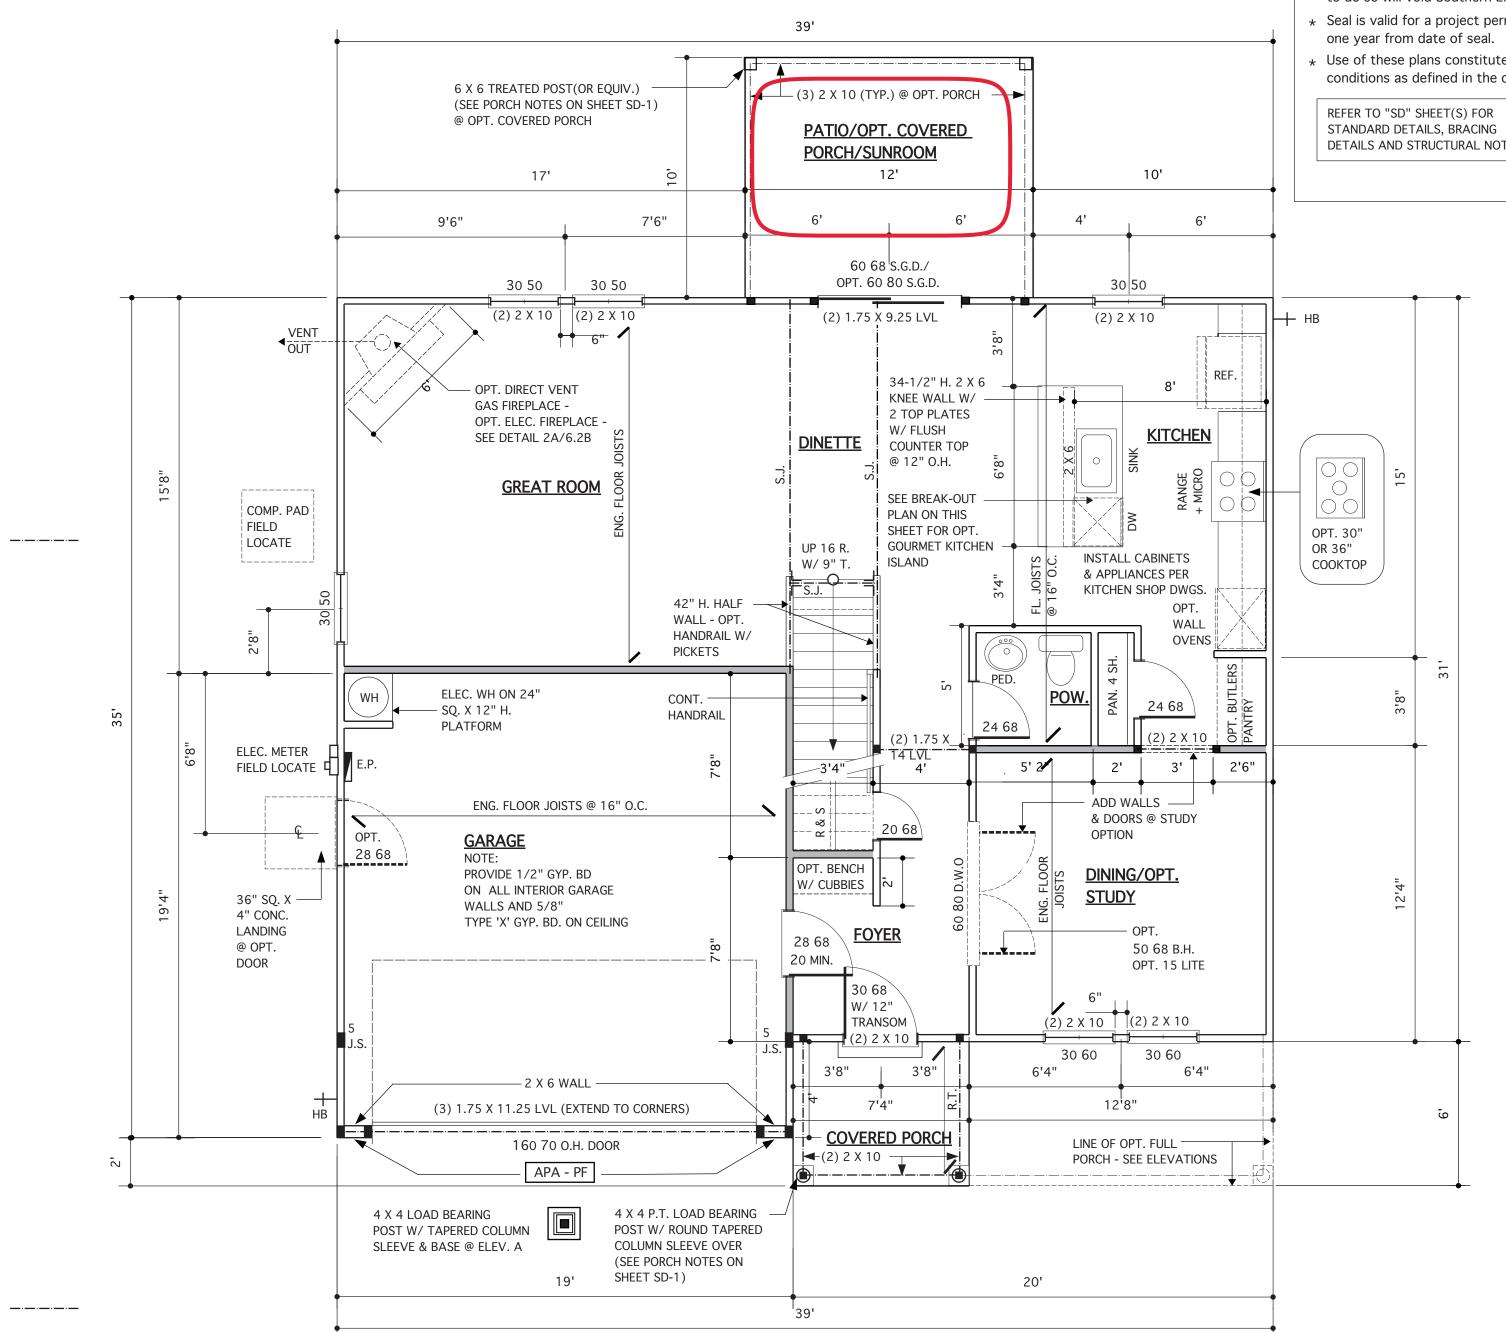

FIRST FLOOR PLAN @ ELEV. A/B SCALE: 1/4" = 1'-0" - 9'-0" CLG. U.N.O.

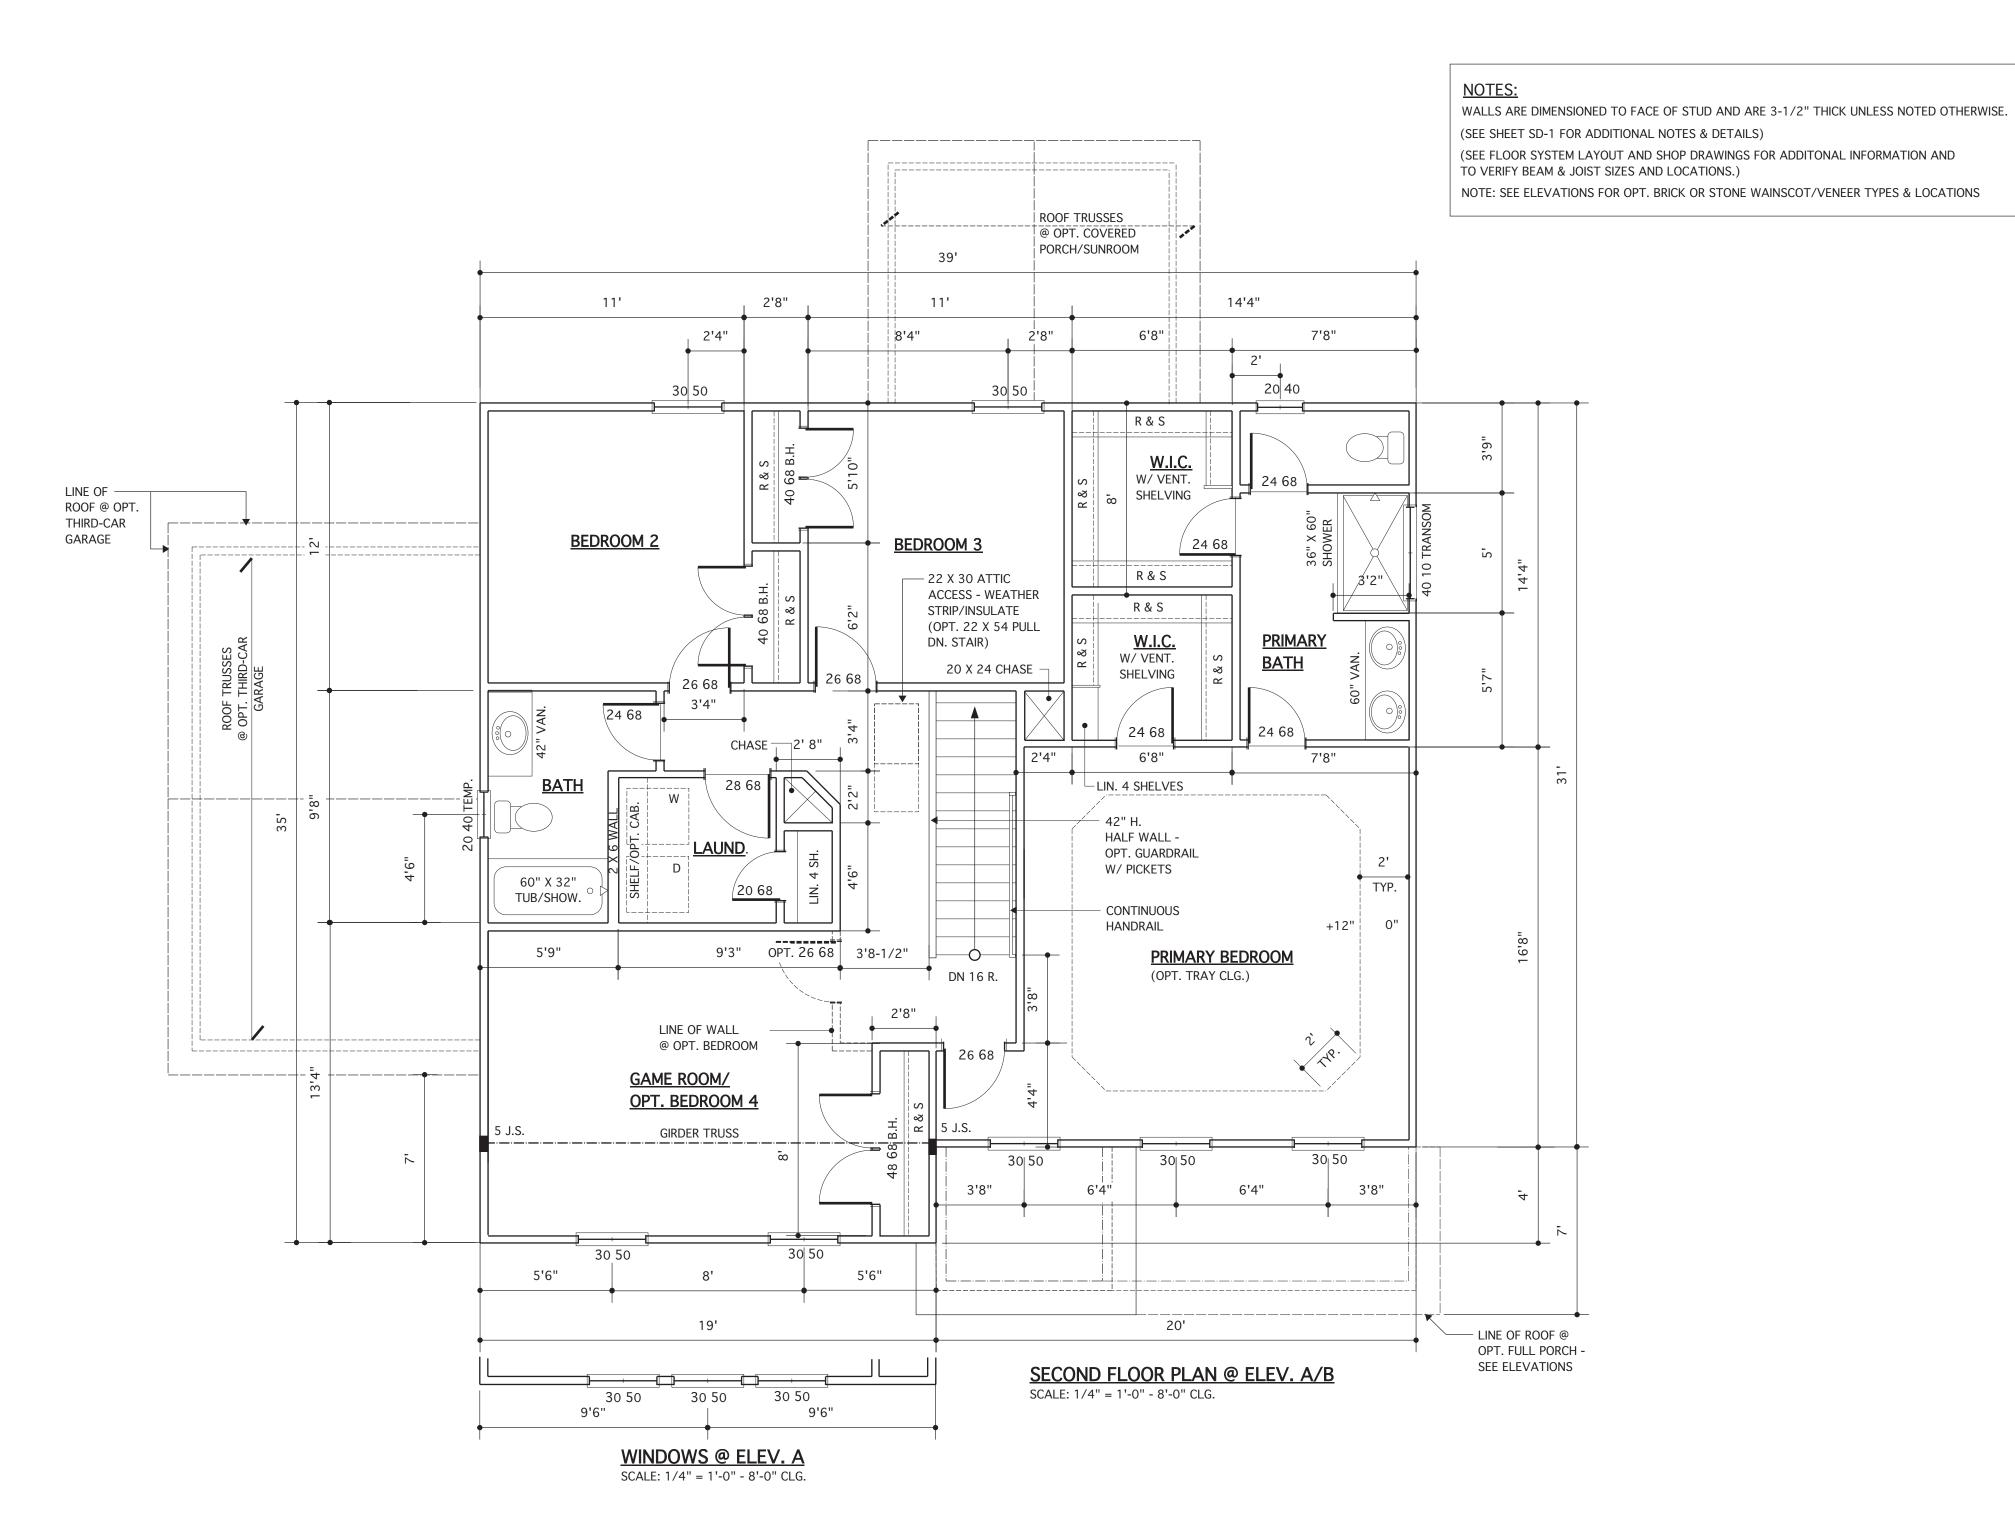

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REFER TO "SD" SHEET(S) FOR STANDARD DETAILS, BRACING DETAILS AND STRUCTURAL NOTES.

one year from date of seal.



ARCHITECTURE LAND PLANNING **GRAPHICS**

JAMES WENTLING/

LAND TITLE BUILDING 100 SOUTH BROAD STREET,

PHILADELPHIA, PA 19110

ARCHITECT

(215) 568-2551 email -information@

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REVISIONS			
MARK	DATE	DESCRIPTION	
DN	01-16-25	REV. 62100 PER NEW FIRST	
JM	01-27-25	623 CLIENT REV.	
JW	02-07-25	REV. PER 2/5/25 CALL	
TT	03-20-25	REV. PER MTG.	
TT	04-03-25	REV. PER COST. EMS	
DN	05-14-25	STRUCT. DWG. REVIEW	
JW	06-09-25	CORRECT ELEV. C PORCH	


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DATE	01-08-18
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DRAWN BY	DN
CHECKED BY	JW
ISSUED FOR	PERMITS/CONSTRUCTION


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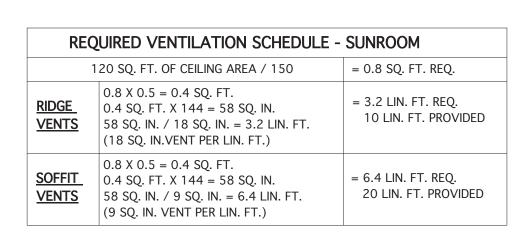
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SECOND FLOOR **PLANS**







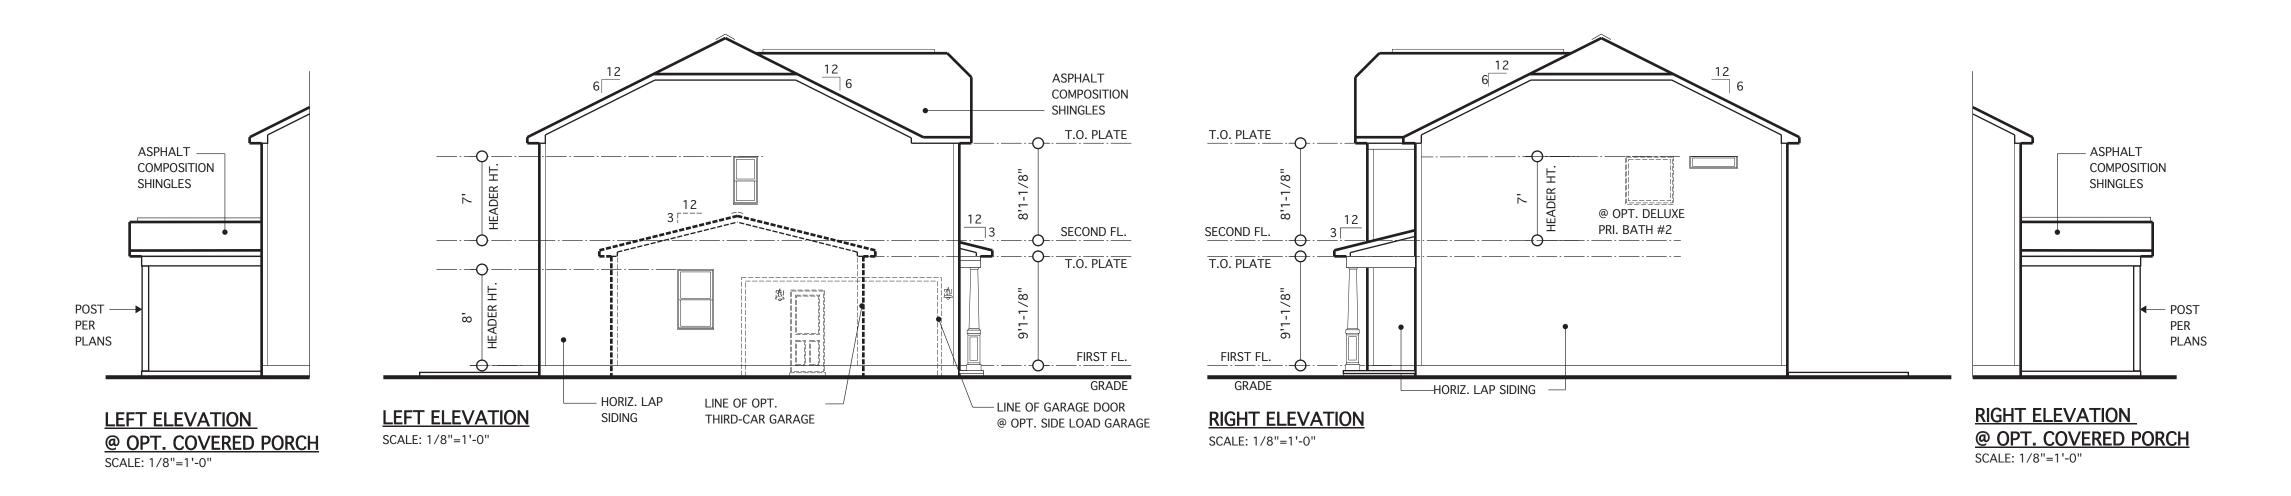


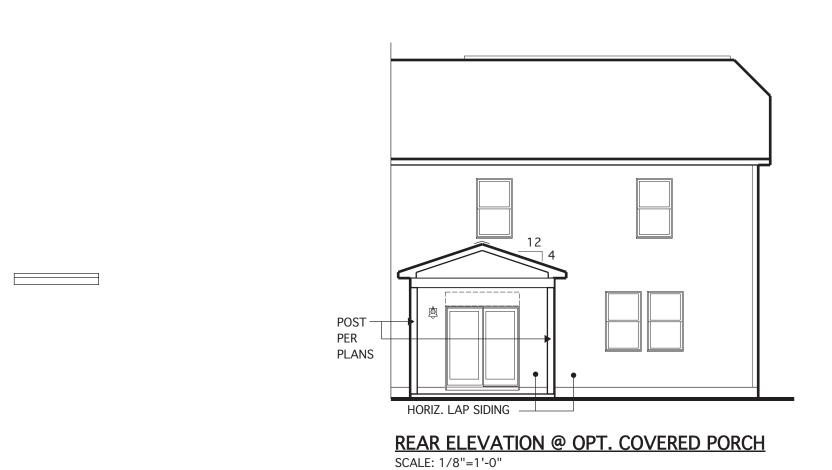
REQUIRED VENTILATION SCHEDULE - MAIN HOUSE					
1,285 SQ. FT. OF CEILING AREA / 300 = 4.28 SQ. FT. REQ.					
RIDGE VENTS	4.28 X 0.5 = 2.14 SQ. FT. 2.14 SQ. FT. X 144 = 308 SQ. IN. 308 SQ. IN. / 18 SQ. IN. = 17.2 LIN. FT. (18 SQ. IN. VENT PER LIN. FT.)	= 17.2 LIN. FT. REQ. 50 LIN. FT. PROVIDED			
SOFFIT VENTS	4.28 X 0.5 = 2.14 SQ. FT. 2.14 SQ. FT. X 144 = 308 SQ. IN. 308 SQ. IN. / 9 SQ. IN. = 34.2 LIN. FT. (9 SQ. IN. VENT PER LIN. FT.)	= 34.2 LIN. FT. REQ. 67 LIN. FT. PROVIDED			


CODE REFERENCE: 2018 NCSBC, RESIDENTIAL CODE, SEC. R806.2

NOTE:


BUILDING ELEMENTS ARE TO BE APPLIED TO MEET LOCAL WINDLOAD REQUIREMENTS

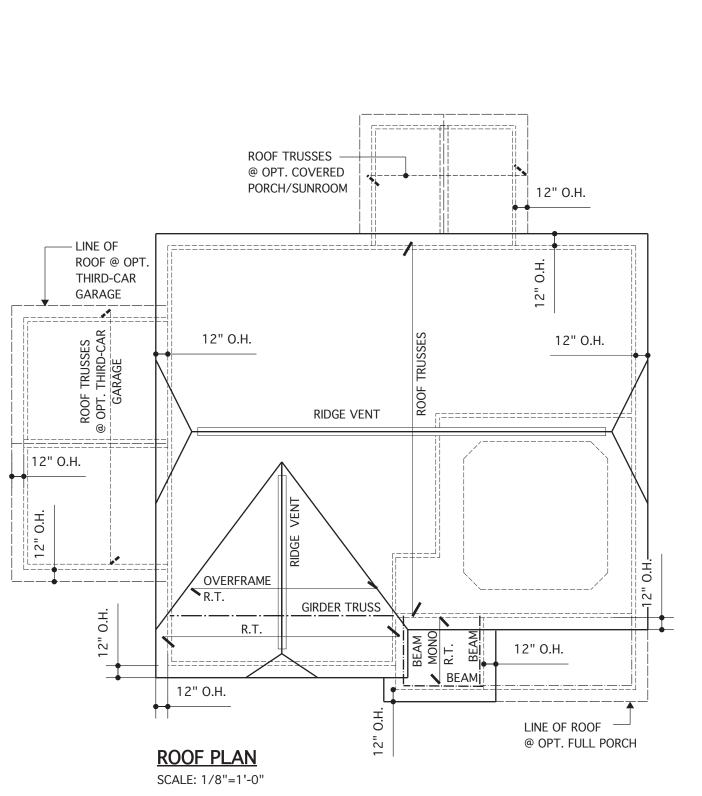

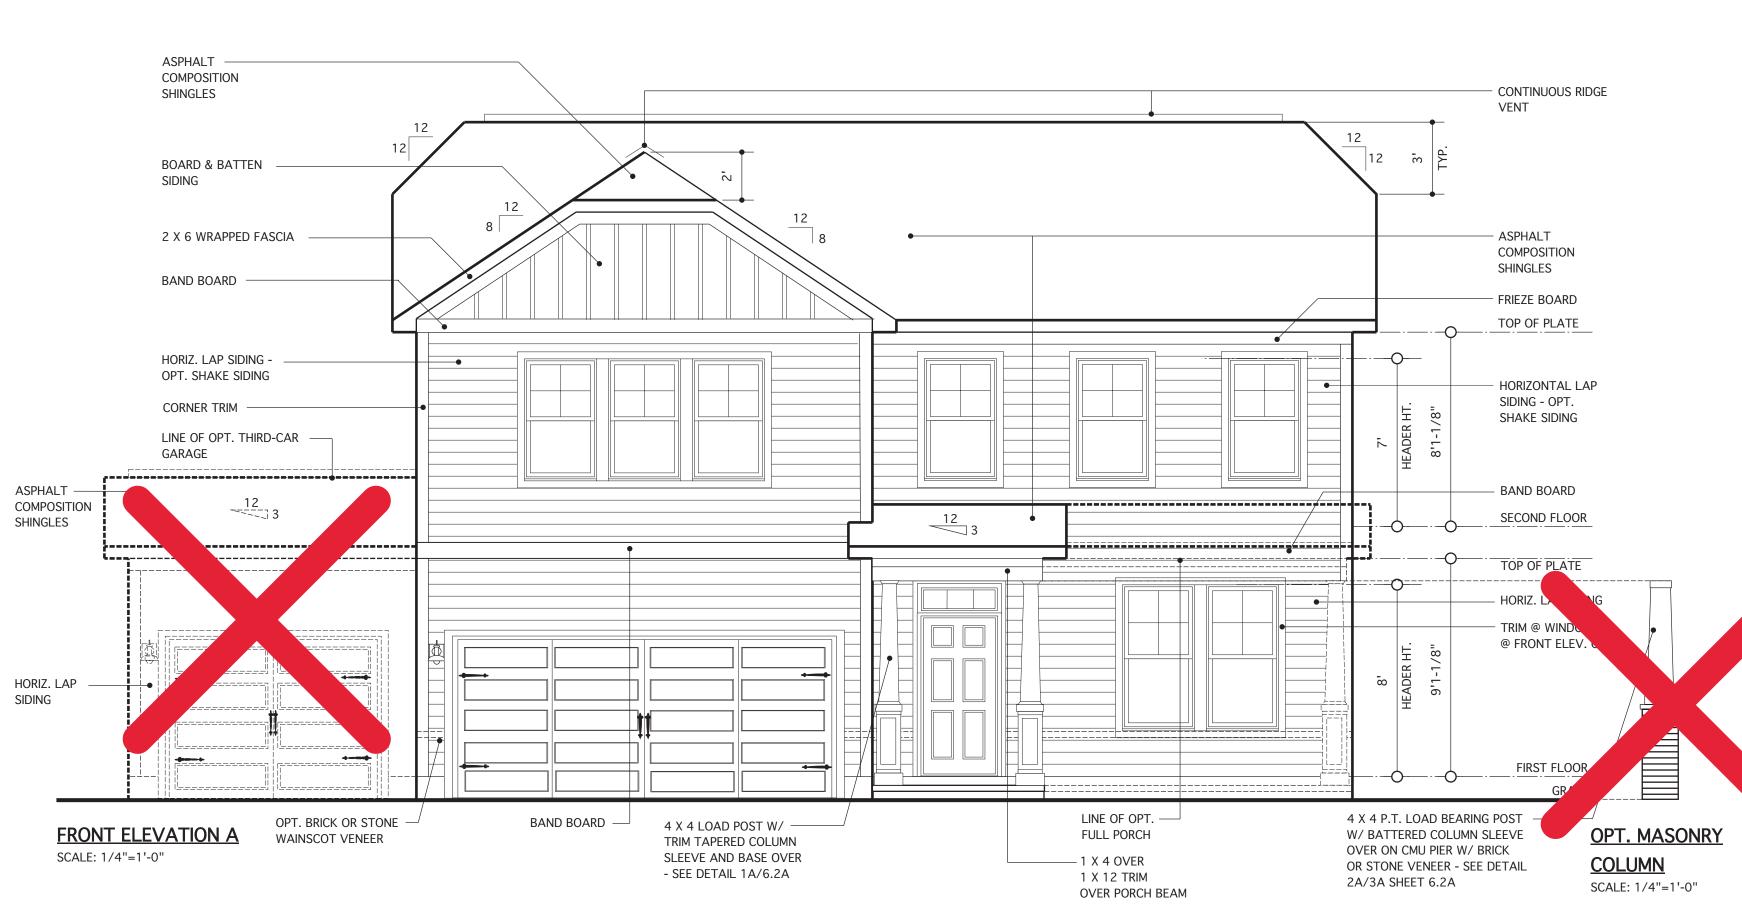

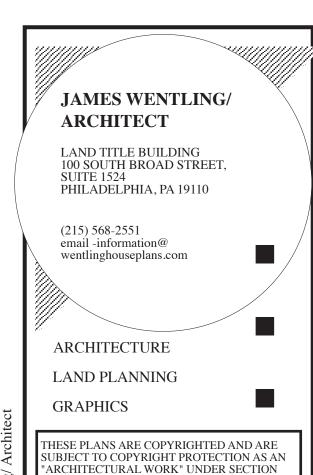

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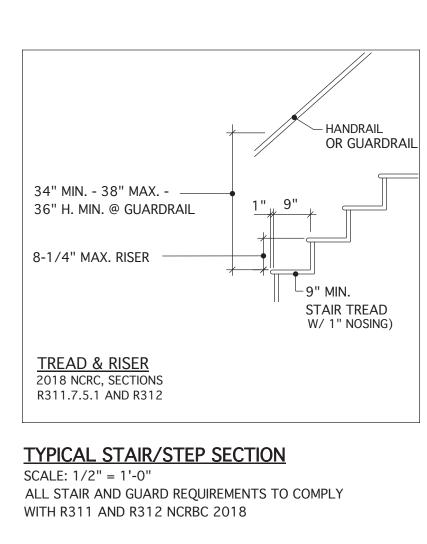
MARK	DATE	DESCRIPTION
СН	05-11-23	CONVERT 113-69/ADD THIRD-CAR GARAGE OP
DN	01-16-25	REV. 62100 PER NEW FIRS
JM	01-27-25	623 CLIENT REV.
JW	02-07-25	REV. PER 2/5/25 CALL
TT	03-20-25	REV. PER MTG.
TT	04-03-25	REV. PER COST. EMS
DN	05-21-25	STRUCT. DWG. REVIEW

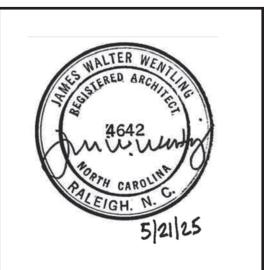PROJECT NO.	
	113-88
DATE	01-08-18
SCALE	AS NOTED
DRAWN BY	DN
CHECKED BY	JW
ISSUED FOR	PERMITS/CONSTRUCTION

MODEL 623L
GARAGE LEFT

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> ELEVATION A & ROOF PLAN




WD. POST ANCHOR TO STEPS AND TIE INTO RAILING 1-1/4" MIN. DIA. LESS THAN 4" OPENING BETWEEN BALUSTERS/PICKETS -4" SPHERE CAN NOT PASS THROUGH BALUSTERS/PICKETS 4" MIN. PERIMETER -6-1/4" MAX. PERIMETER 34" MIN. - 38" MAX. - -36" H. MIN. @ GUARDRAIL NOT EXCEED 2-1/4" 9" MIN. STAIR TREAD W/ 1" NOSING 8-1/4" MAX. RISER APPROX. GRADE STAIR-SIDE OPENING SHALL NOT ALLOW 6" DIA. SPHERE PASSAGE **HANDRAIL CROSS SECTIONS & DIMENSION: HANDRAIL & GUARDRAIL** 2018 NCRC, SECTION 2018 NCRC, SECTIONS R311.7..8.5 R311.7 AND R312

TYPICAL RAILING @ PORCH/DECK

SCALE: 1/2" = 1'-0"

(PROVIDE GUARDRAIL BOTH SIDES WHEN HEIGHT ABOVE GRADE EXCEEDS 30"/ PROVIDE HANDRAIL ONE SIDE OF STEPS WHERE 4 OR MORE RISERS)

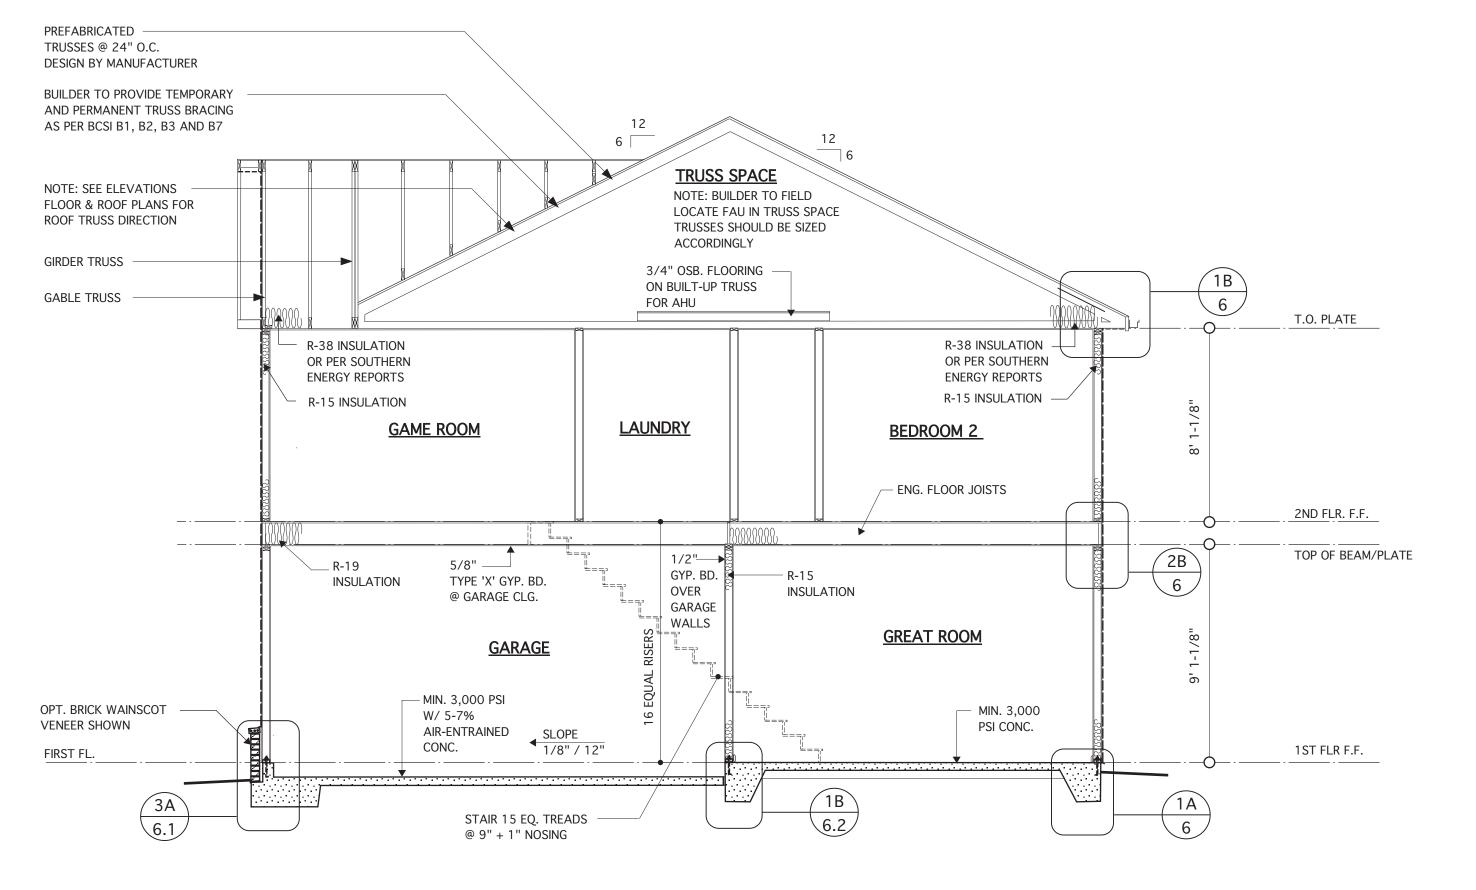

TYPICAL BUILDING SECTION @ ELEV. A/B SCALE: 1/4" = 1'-0"

100 SOUTH BROAD STREET, SUITE 1524 PHILADELPHIA, PA 19110 (215) 568-2551 email -information@ wentlinghouseplans.com

JAMES WENTLING/

ARCHITECT


LAND TITLE BUILDING

ARCHITECTURE

LAND PLANNING

GRAPHICS

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MARK	DATE	DESCRIPTION
DN	02-04-19	CONVERT HIGHGATE
СН	01-03-20	MINOR UPDATE
СН	05-11-23	CONVERT 113-69/ADD THIRD-CAR GARAGE OPT.
DN	01-16-25	REV. 62100 PER NEW FIRST
JW	02-07-25	REV. PER 2/5/25 CALL
TT	03-20-25	REV. PER MTG.
TT	04-03-25	REV. PER COST. EMS

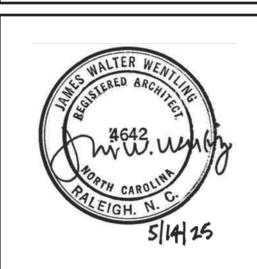
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DATE	01-08-18
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	DN
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ISSUED FOR	PERMITS/CONSTRUCTION


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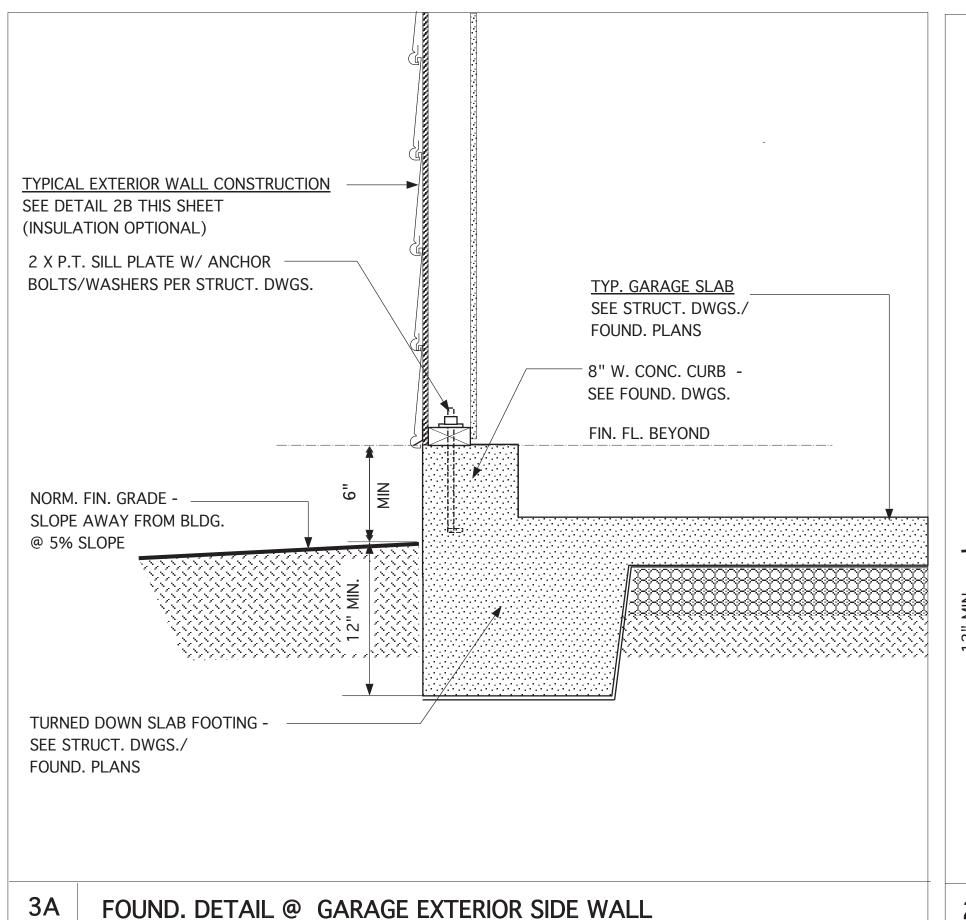
CHESAPEAKE HOMES OF NC


3100 Smoketree Court, Suite 210 Raleigh, NC 27604 (919) 256-3060 (919) 556-0690 Fax


BUILDING SECTION



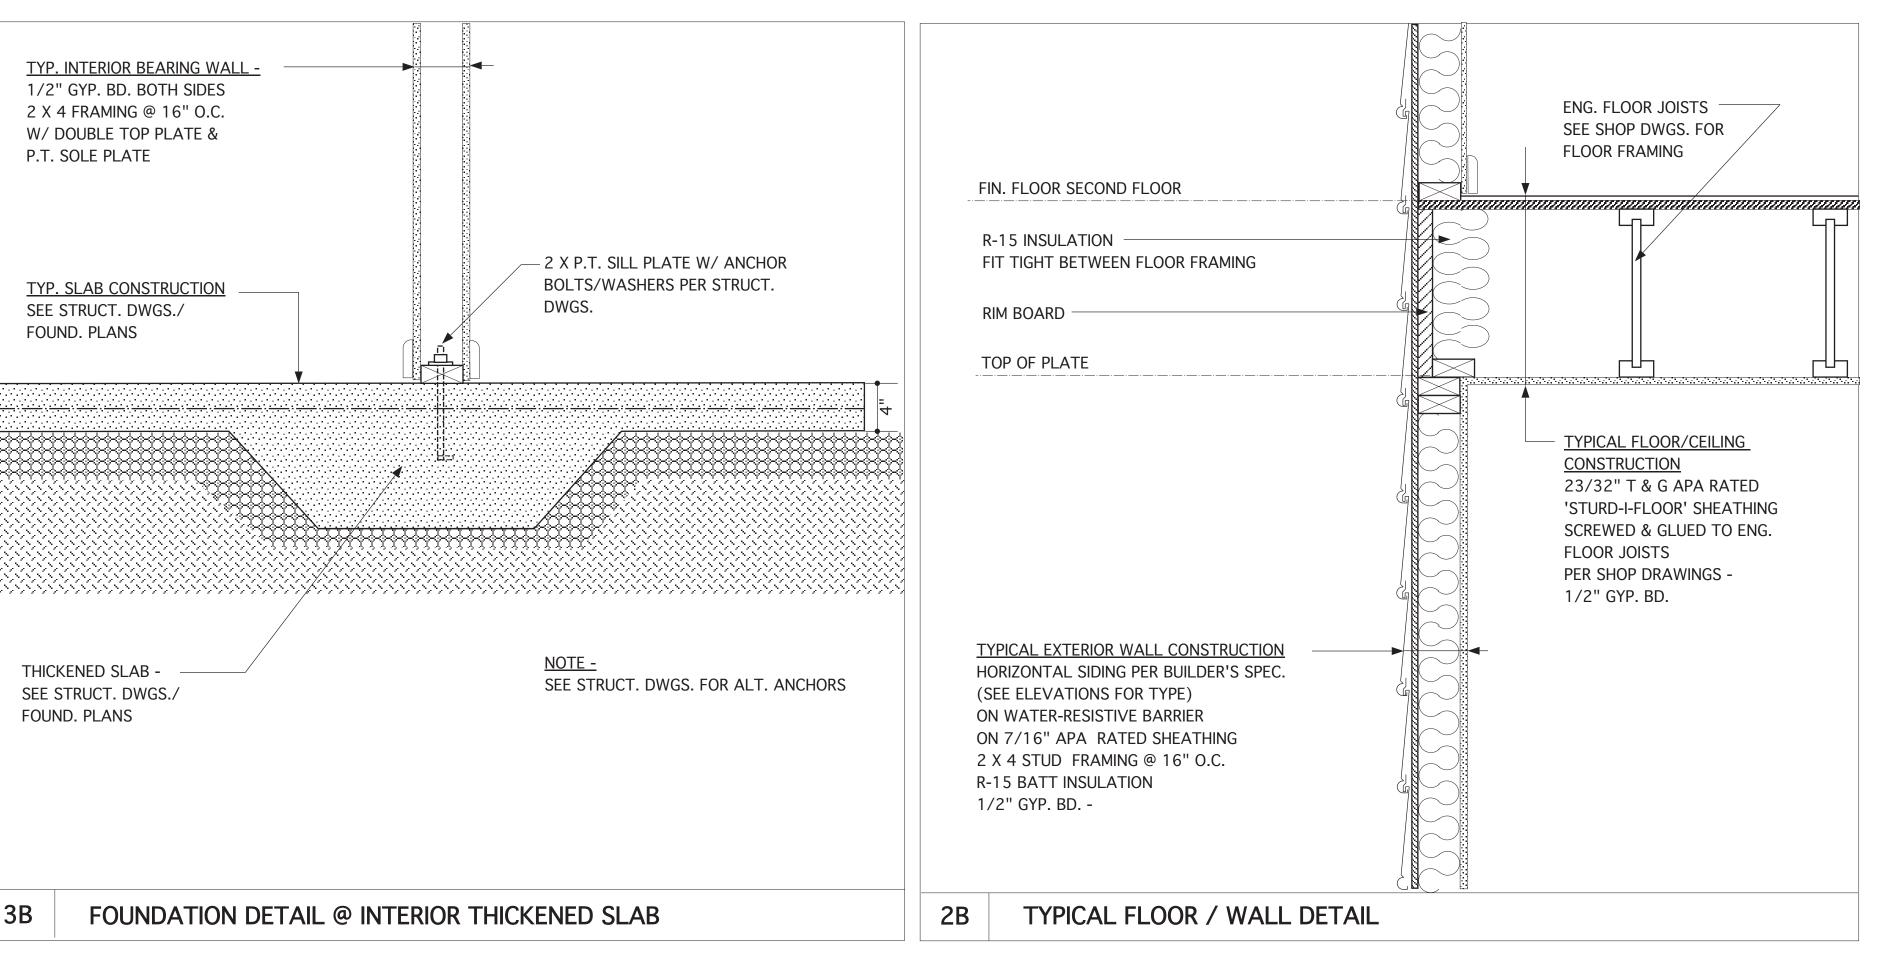

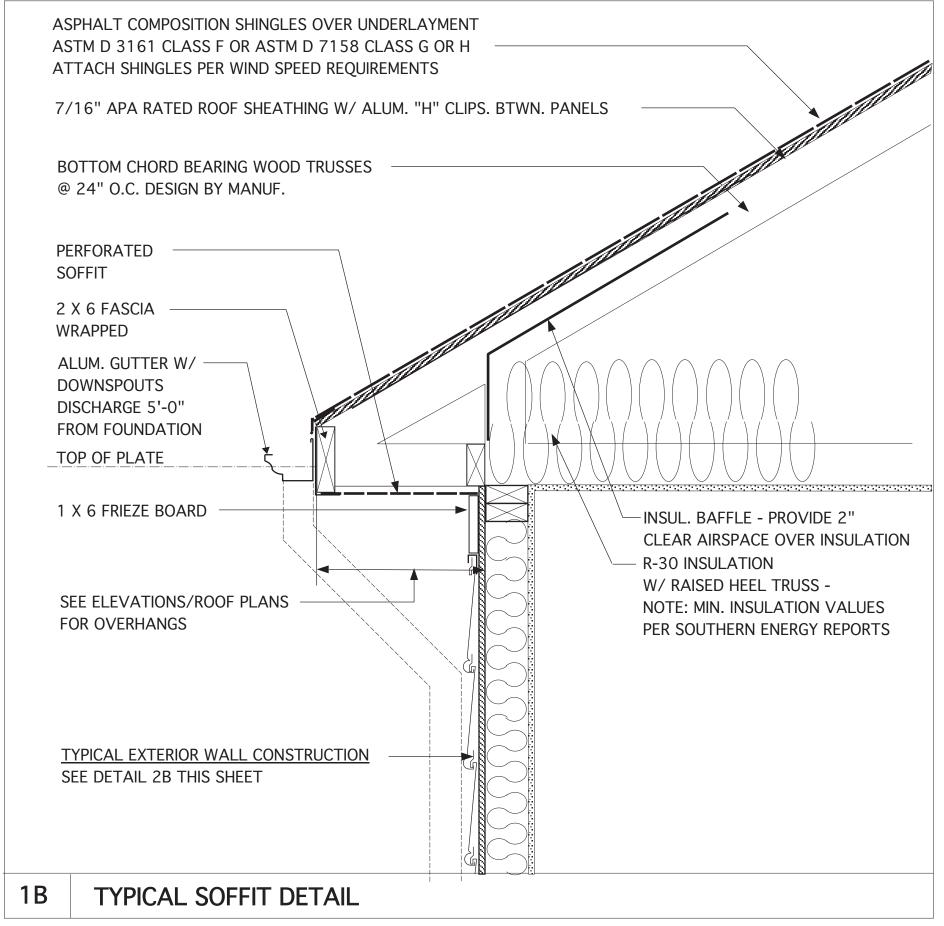

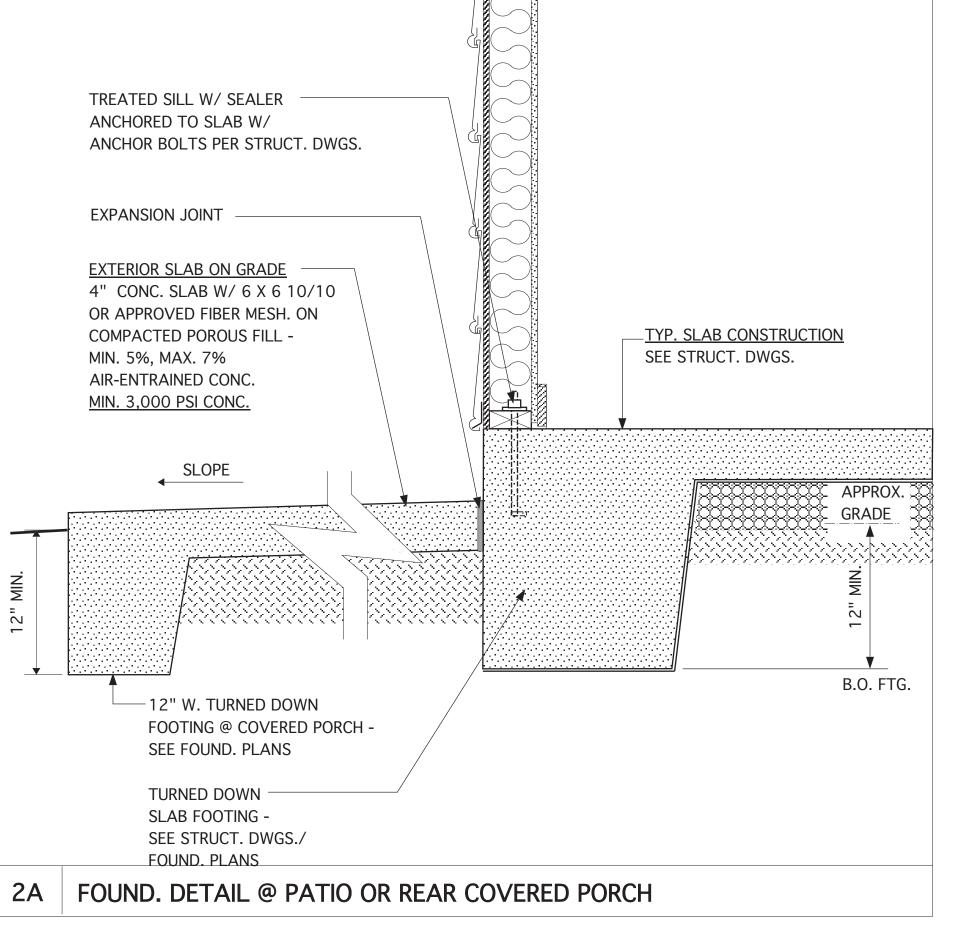

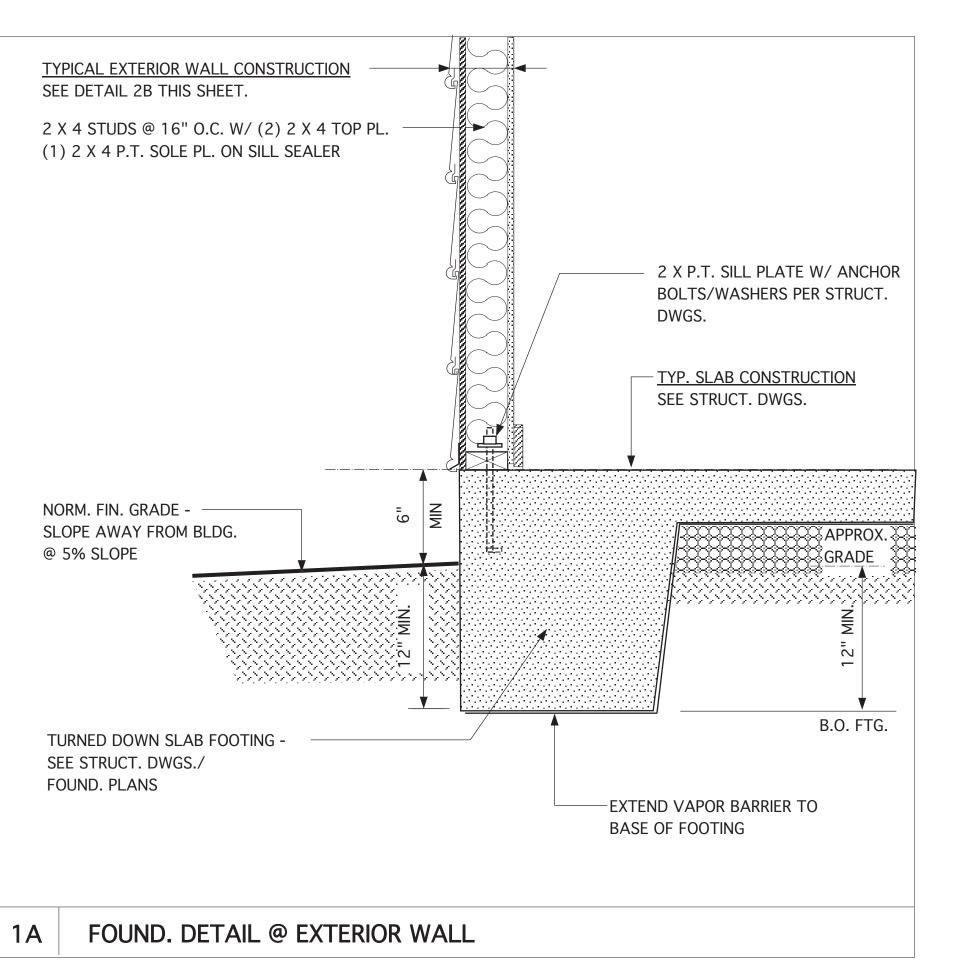



LAND TITLE BUILDING 100 SOUTH BROAD STREET, SUITE 1524 PHILADELPHIA, PA 19110


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A DOLUTE CELLIDE

ARCHITECTURE
LAND PLANNING


LAND PLANNING
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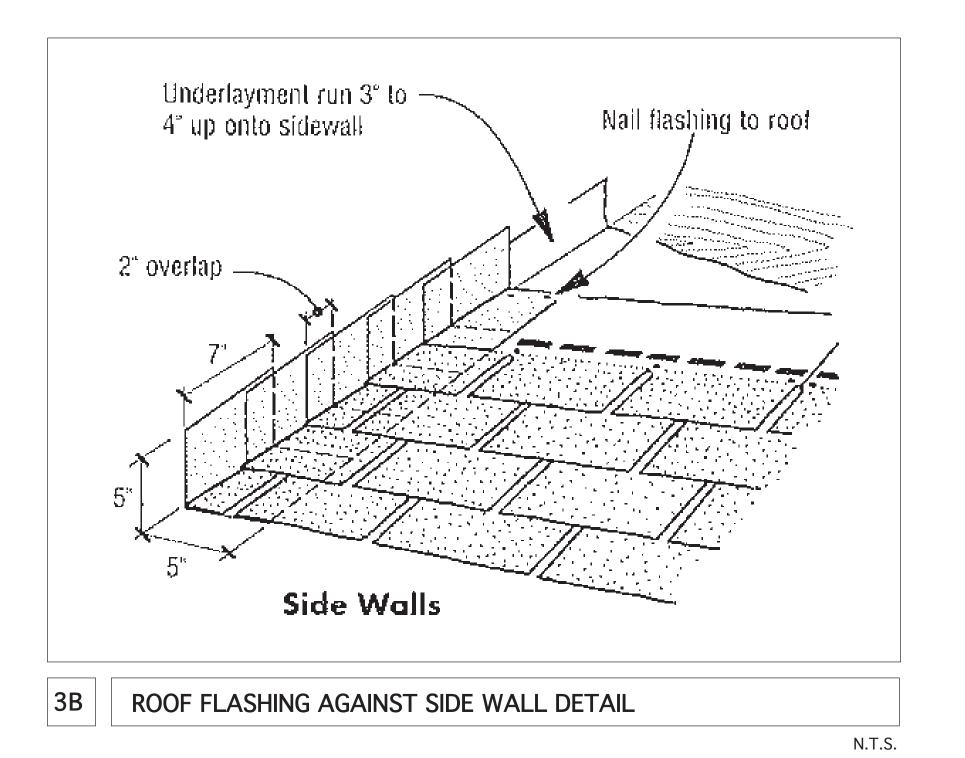



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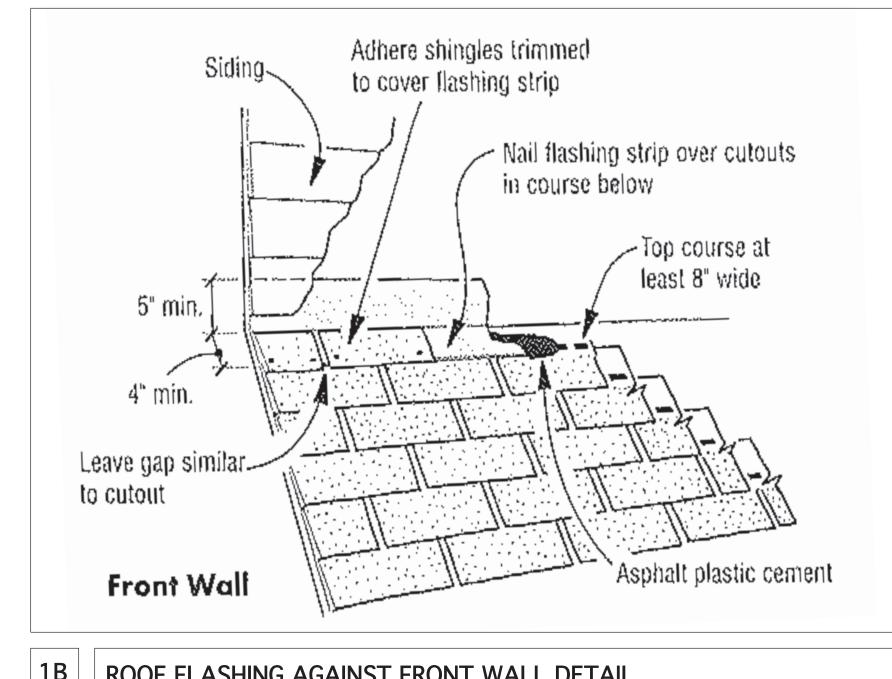
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	DN
CHECKED BY	JW
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ISSUED FOR	PERMITS/CONSTRUCTION
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MONOLITHIC SLAB FOUNDATION, WALL AND SOFFIT DETAILS




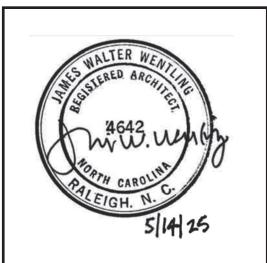


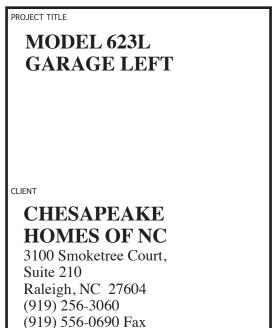



ROOF FLASHING AGAINST FRONT WALL DETAIL

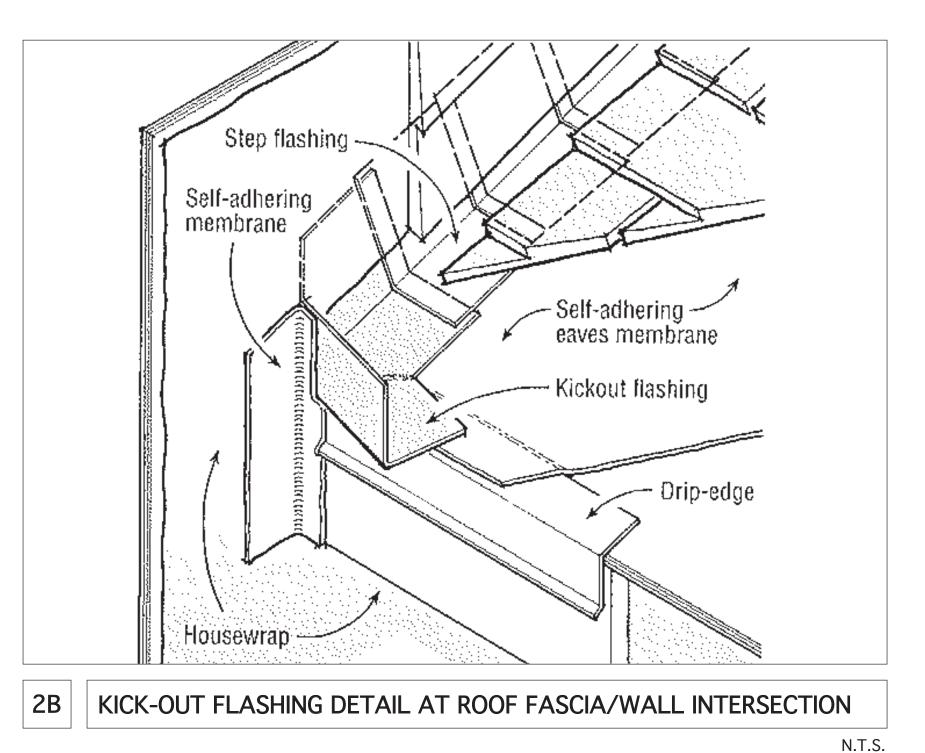N.T.S.

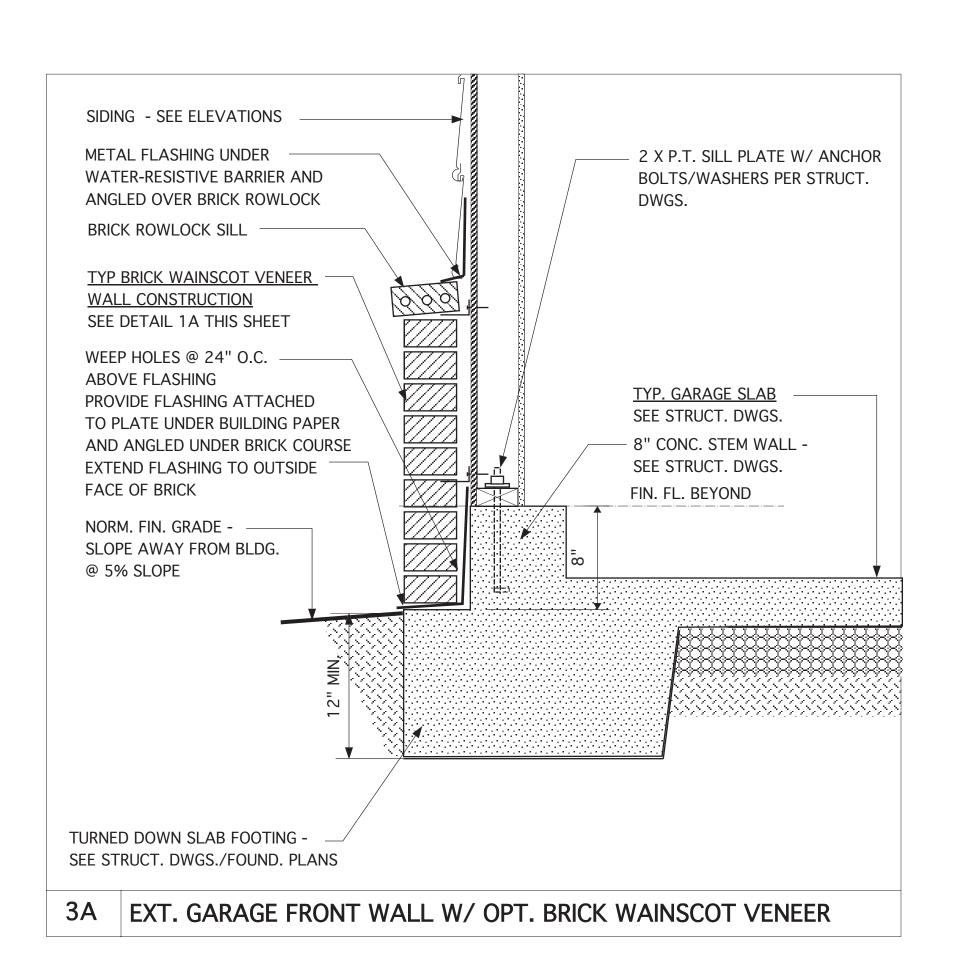

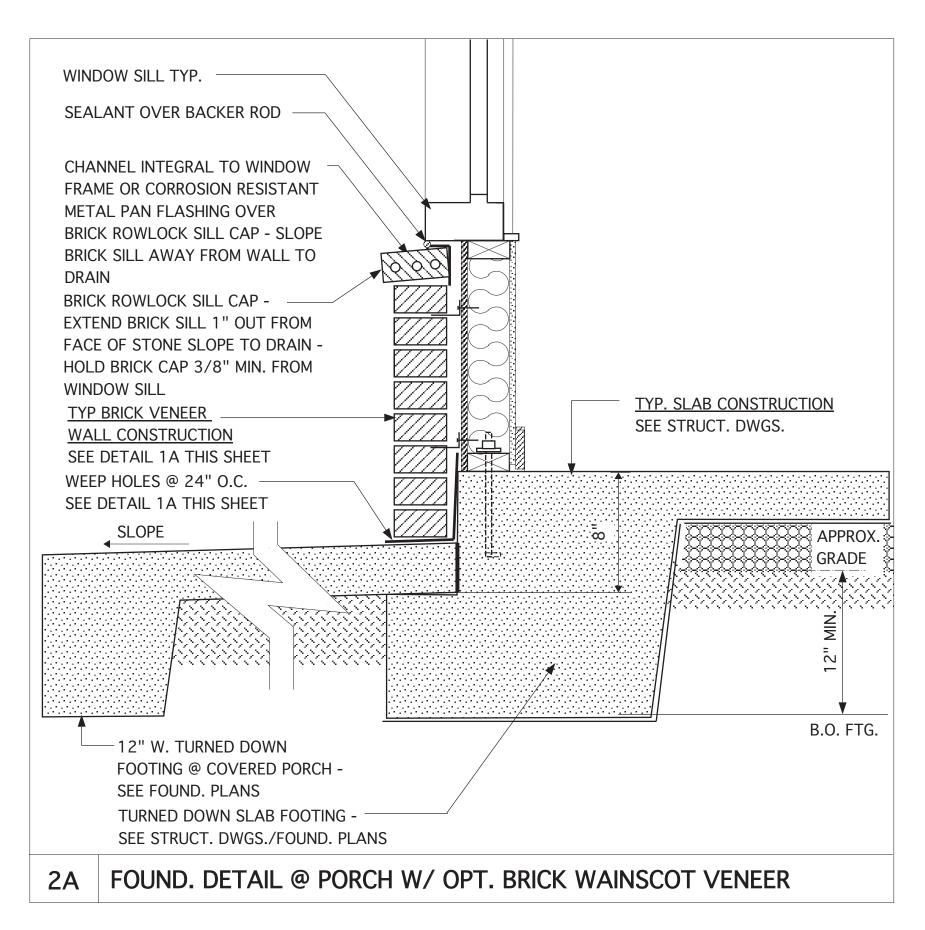

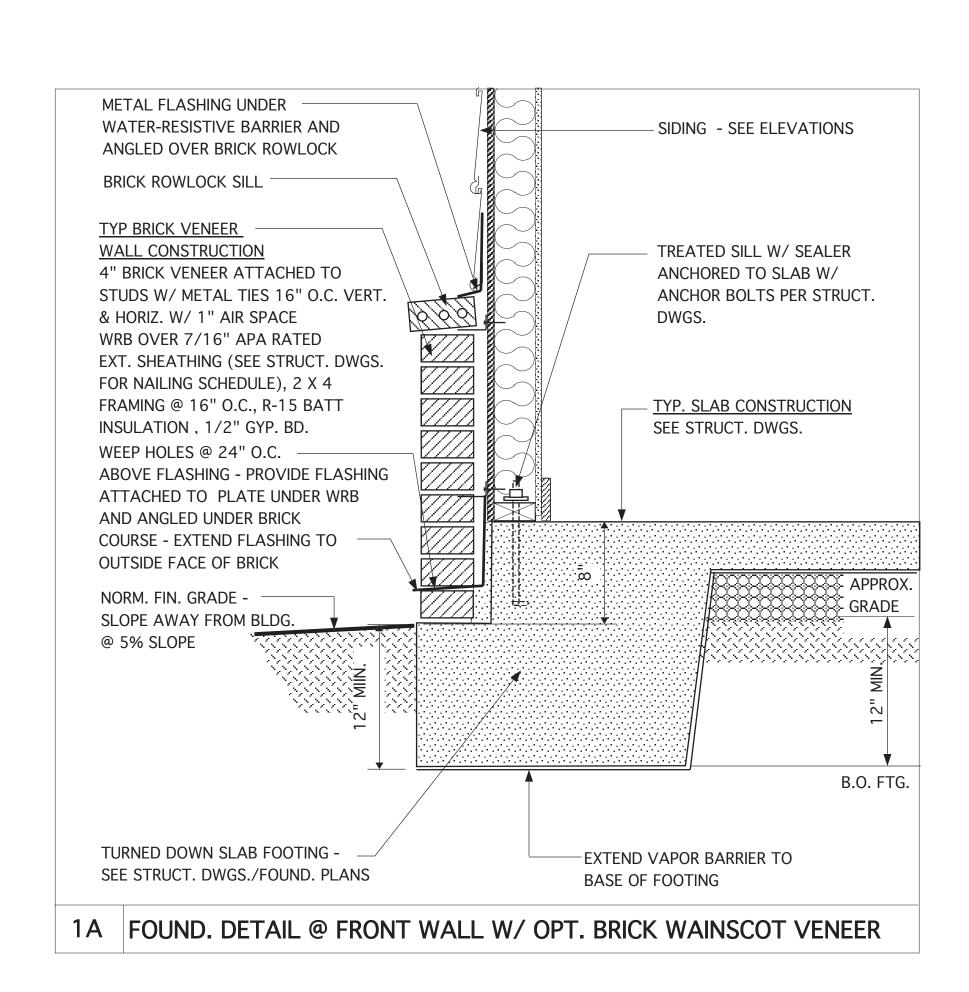

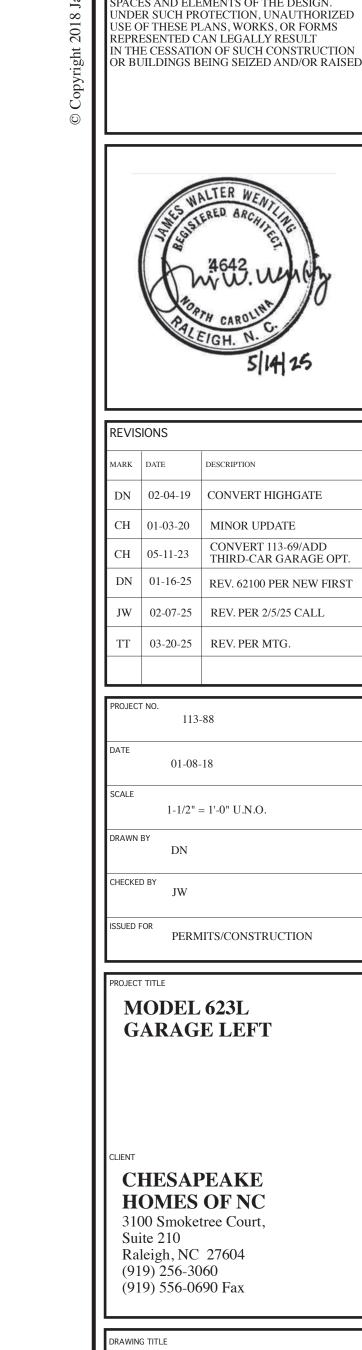

MONOLITHIC SLAB

FOUNDATION AND

WALL DETAILS

JAMES WENTLING

LAND TITLE BUILDING 100 SOUTH BROAD STREET,

PHILADELPHIA, PA 19110

ARCHITECT

SUITE 1524

(215) 568-2551 email -information@ wentlinghouseplans.com

ARCHITECTURE

LAND PLANNING


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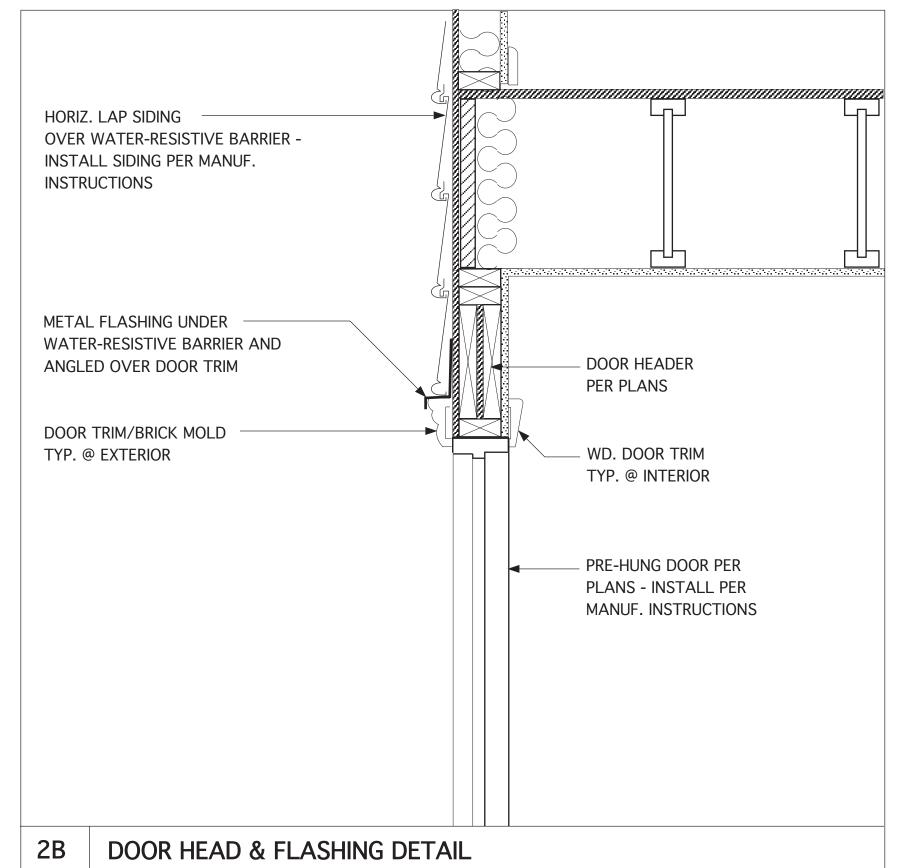
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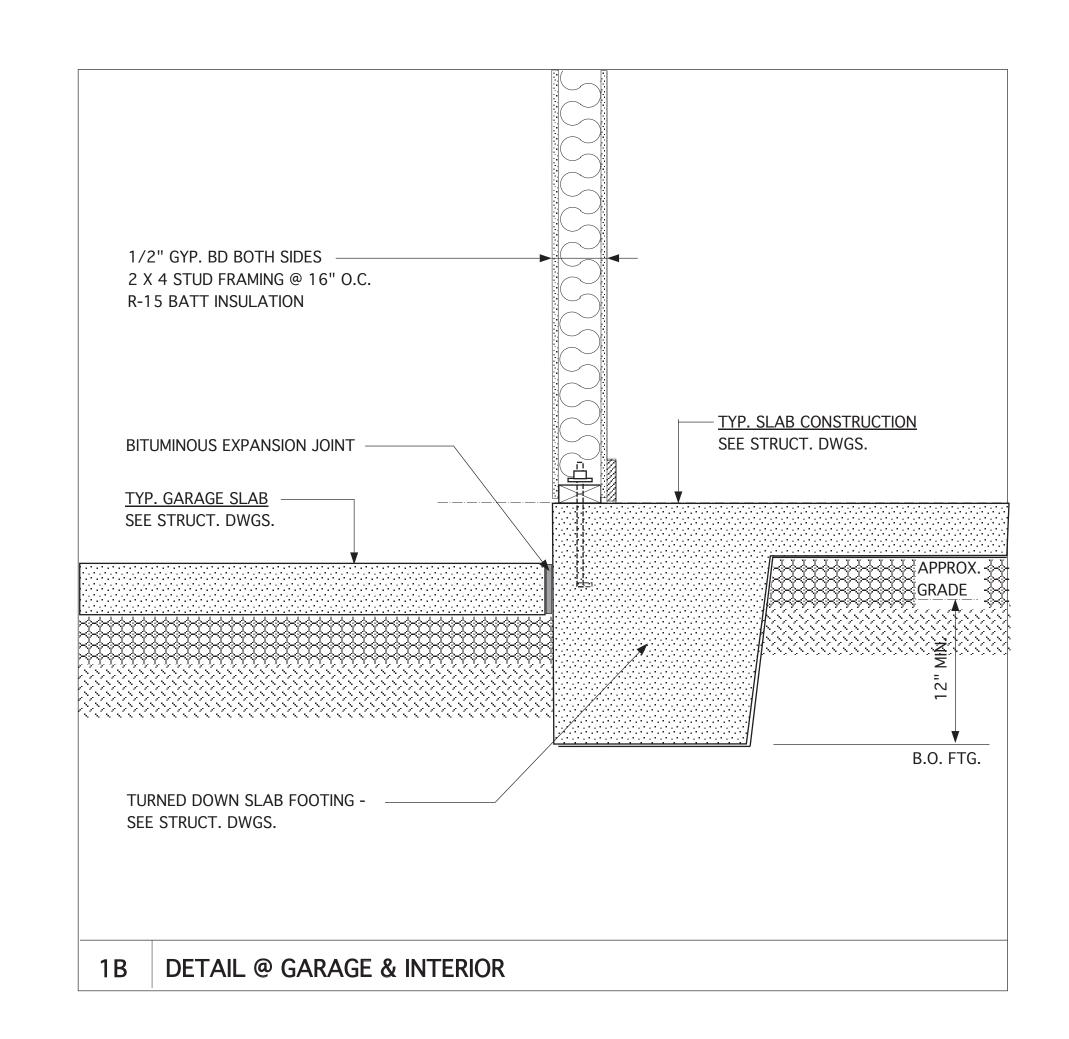
ARCHITECTURAL WORK" UNDER SECTION 102 OF THE COPYRIGHT ACT, 17 U.S.C. AS AMENDED DECEMBER 1, 1990 AND KNOWN AS THE "ARCHITECTURAL WORKS


O, THE OVERALL FORM AS WELL AS THE


GRAPHICS






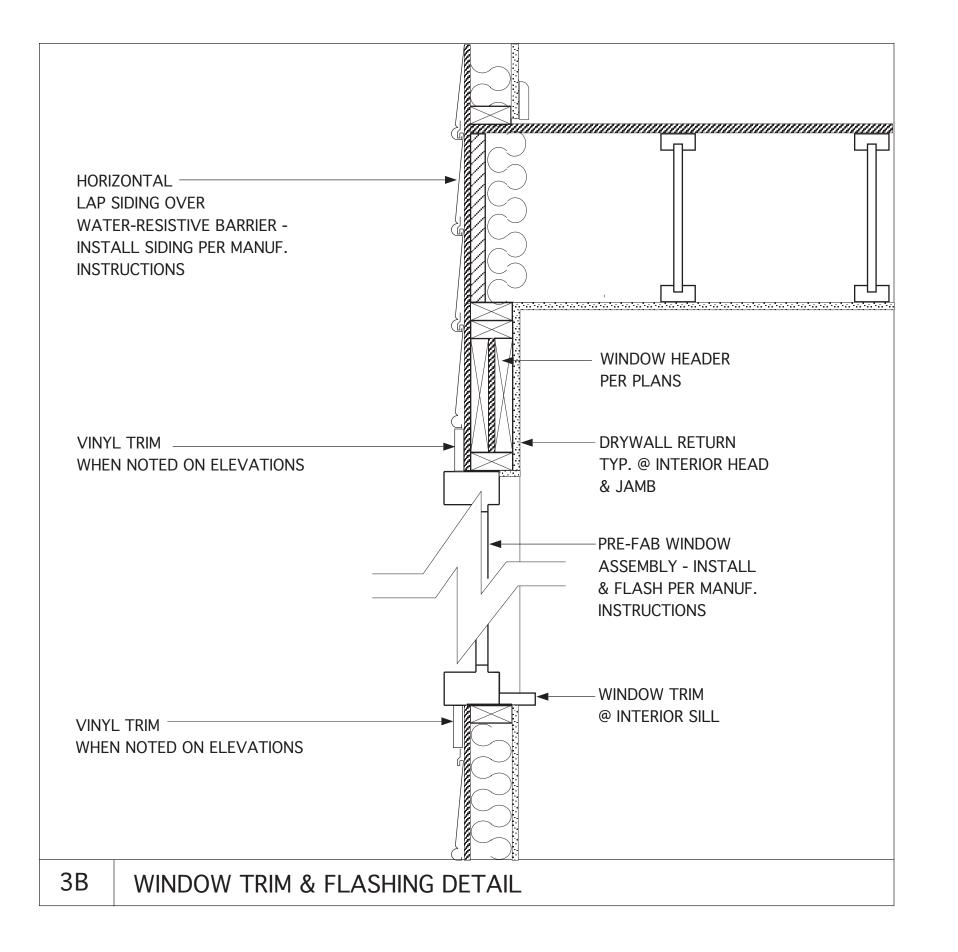

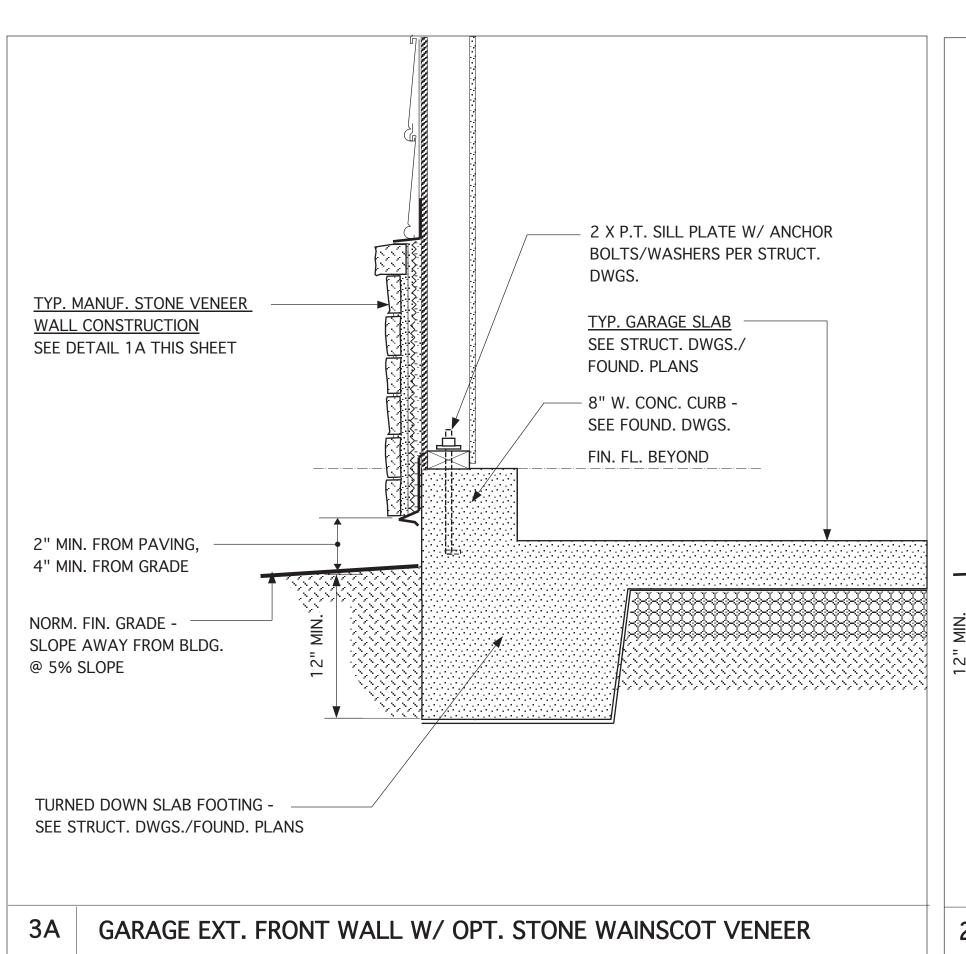

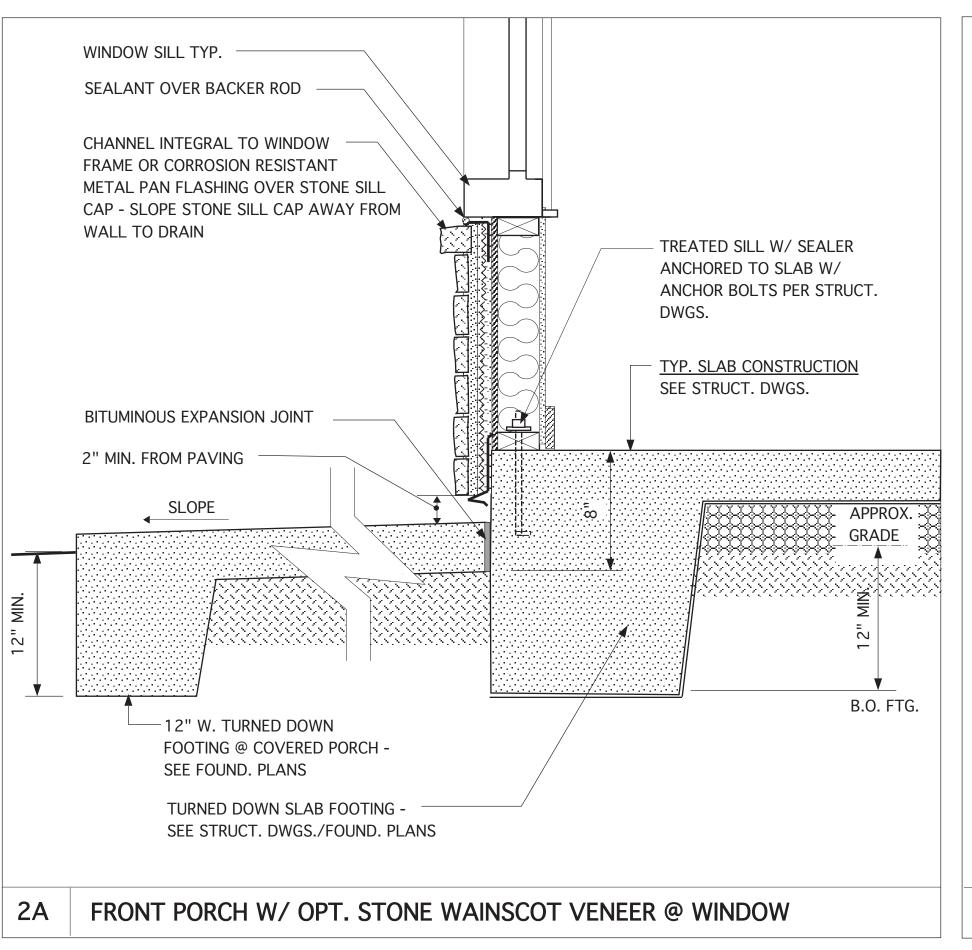

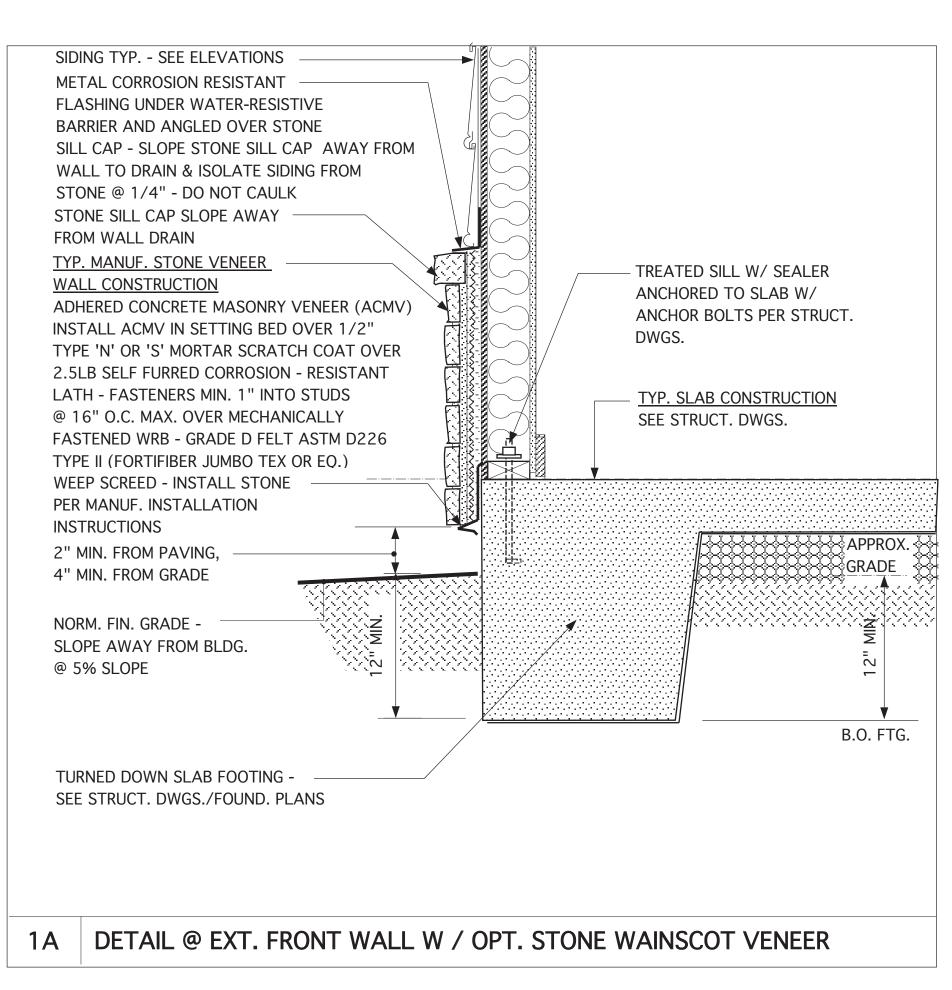



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REVIS	REVISIONS		
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DN	02-04-19	CONVERT HIGHGATE	
СН	01-03-20	MINOR UPDATE	
СН	05-11-23	CONVERT 113-69/ADD THIRD-CAR GARAGE OPT.	
DN	01-16-25	REV. 62100 PER NEW FIRST	
JW	02-07-25	REV. PER 2/5/25 CALL	


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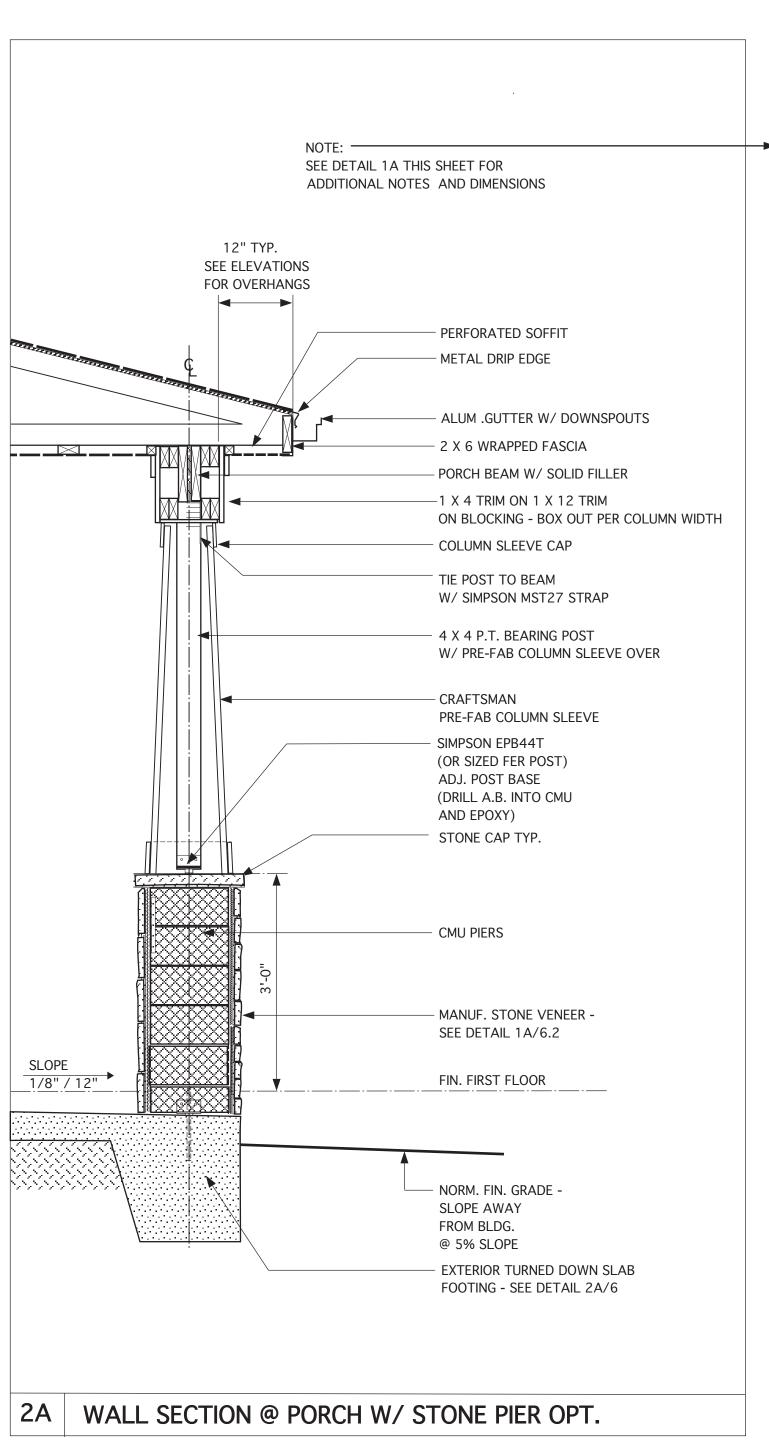
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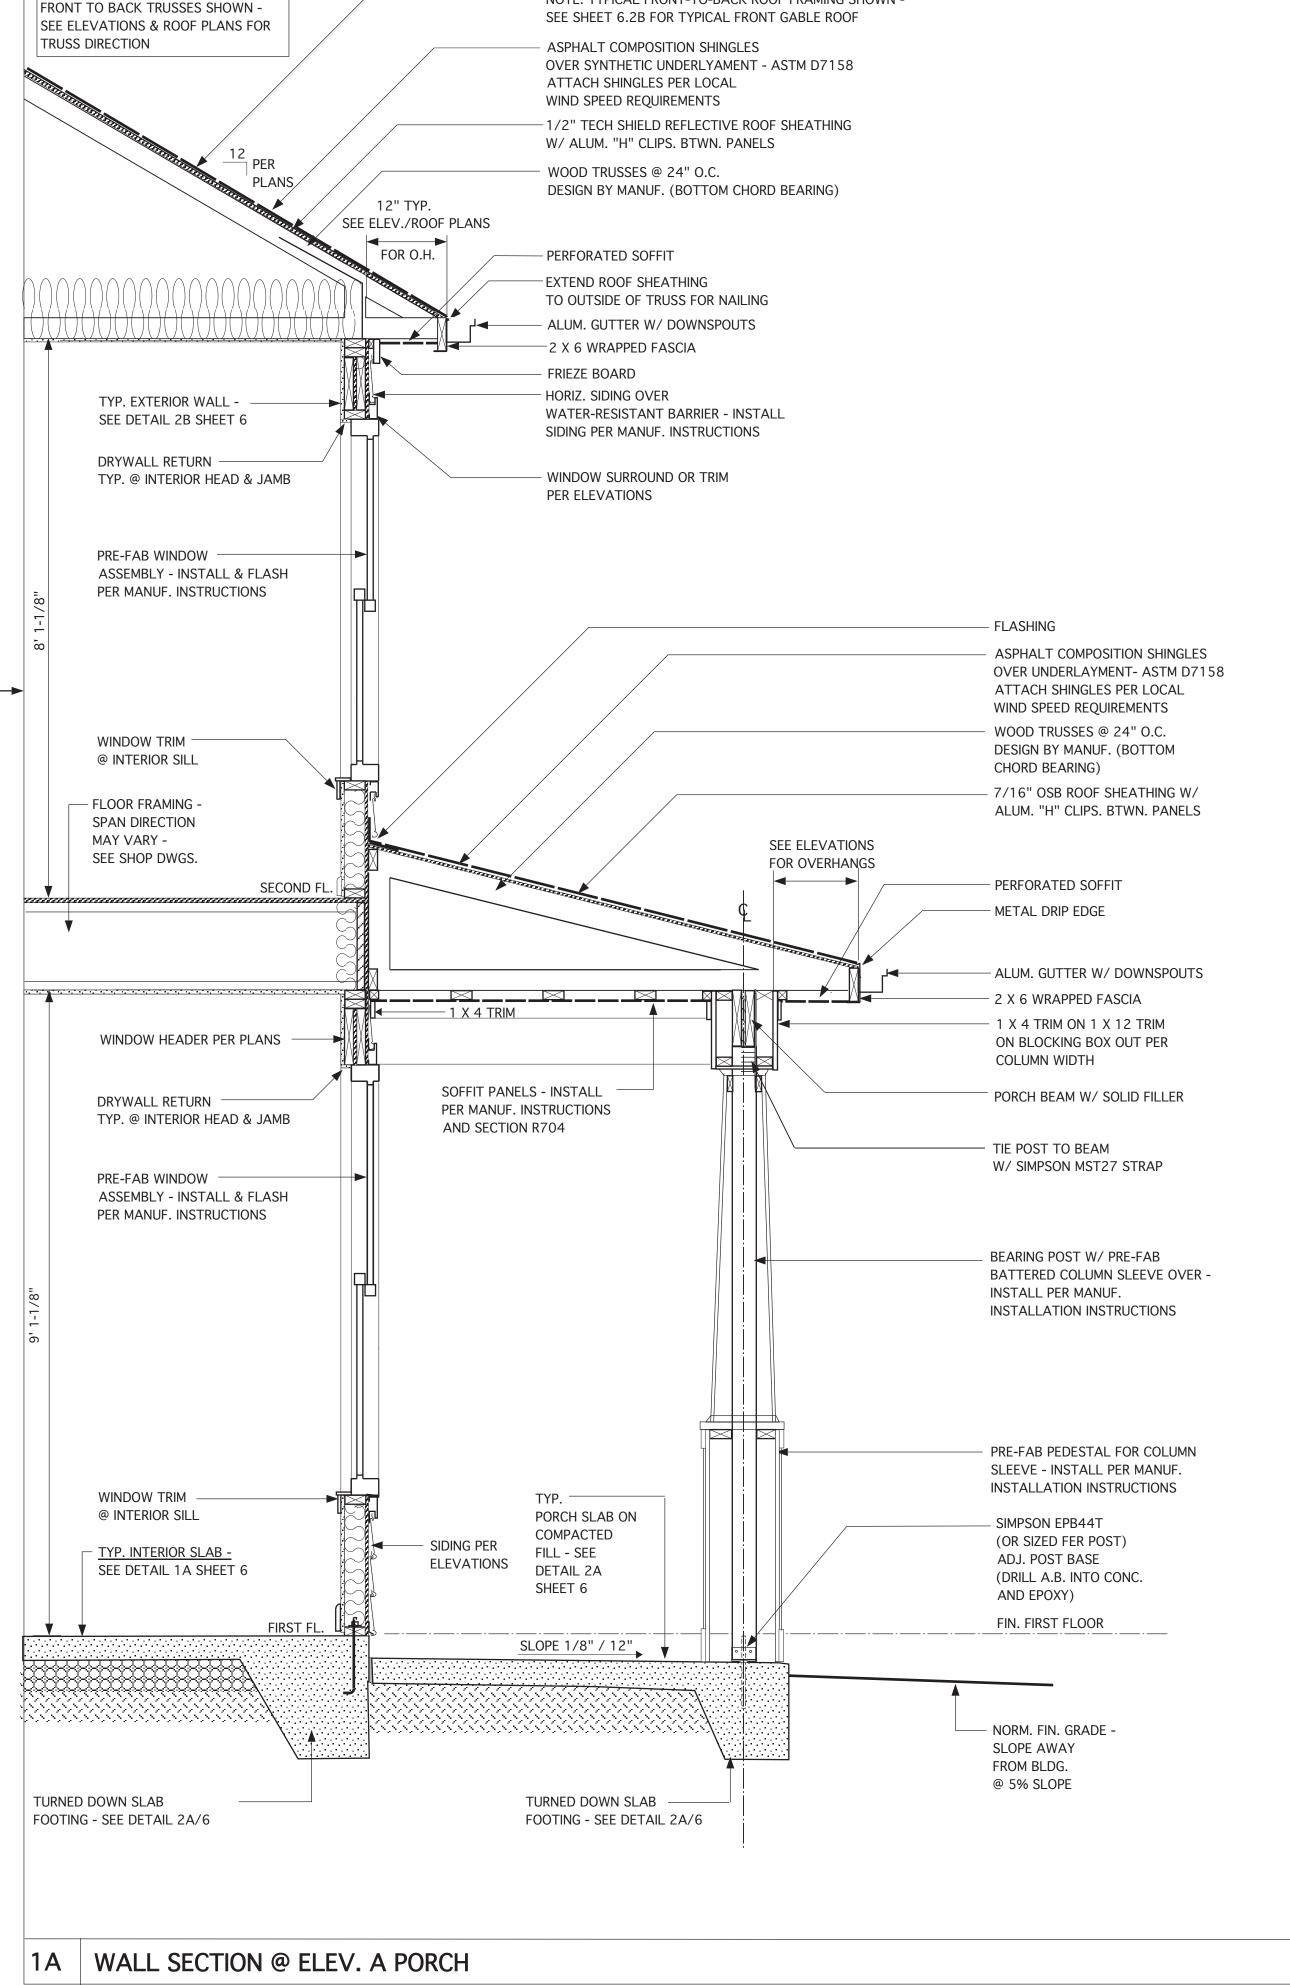
CHESAPEAKE
HOMES OF NC
3100 Smoketree Court,
Suite 210
Raleigh, NC 27604
(919) 256-3060
(919) 556-0690 Fax

MONOLITHIC SLAB
FOUNDATION
AND WALL DETAILS

6.2





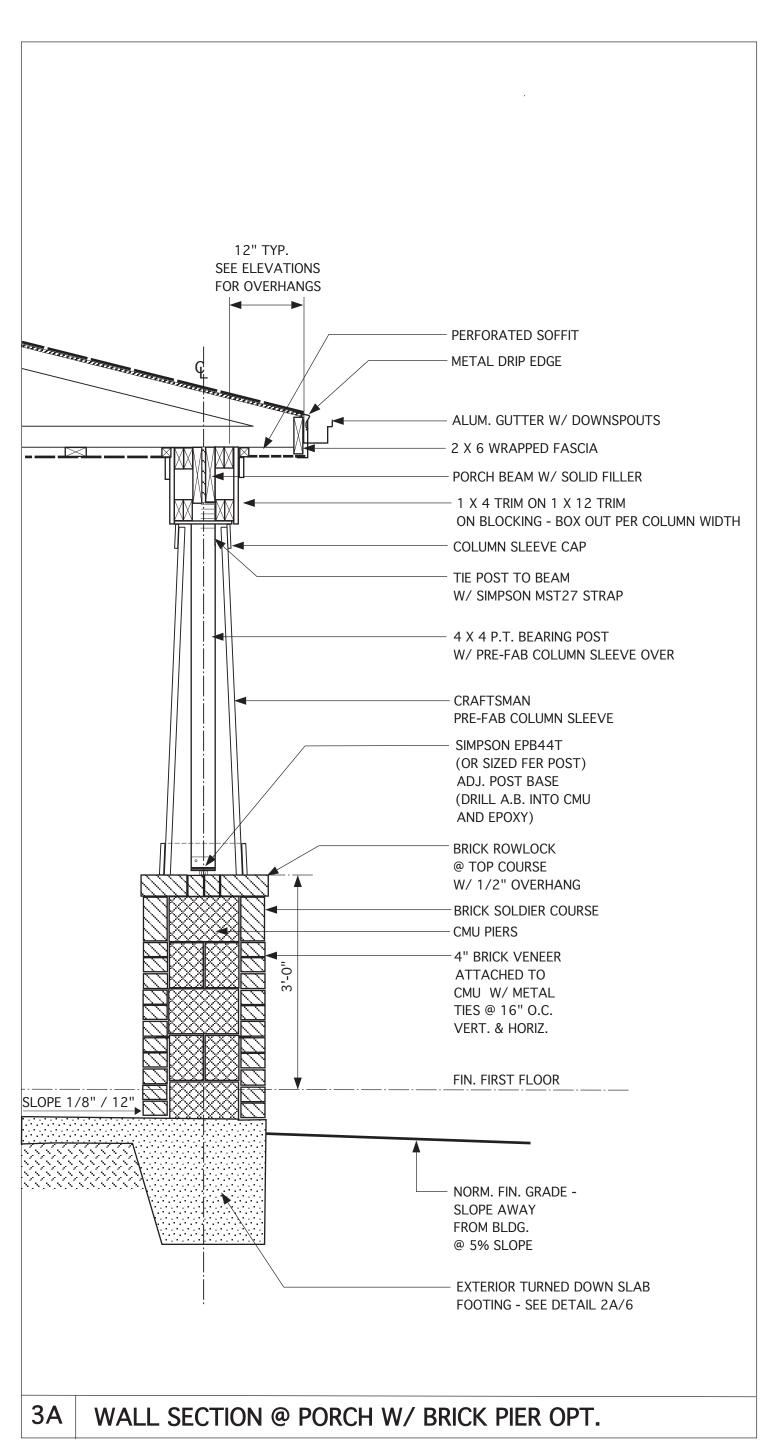

NOTE: TYPICAL FRONT-TO-BACK ROOF FRAMING SHOWN -



PHILADELPHIA, PA 19110

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ARCHITECTURE

LAND PLANNING

GRAPHICS

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PROJECT NO.	113-88
DATE	
	01-08-18
SCALE	
	3/4" = 1'-0"
DRAWN BY	
	DN
CHECKED BY	
	JW
ISSUED FOR	
	PERMITS/CONSTRUCTION


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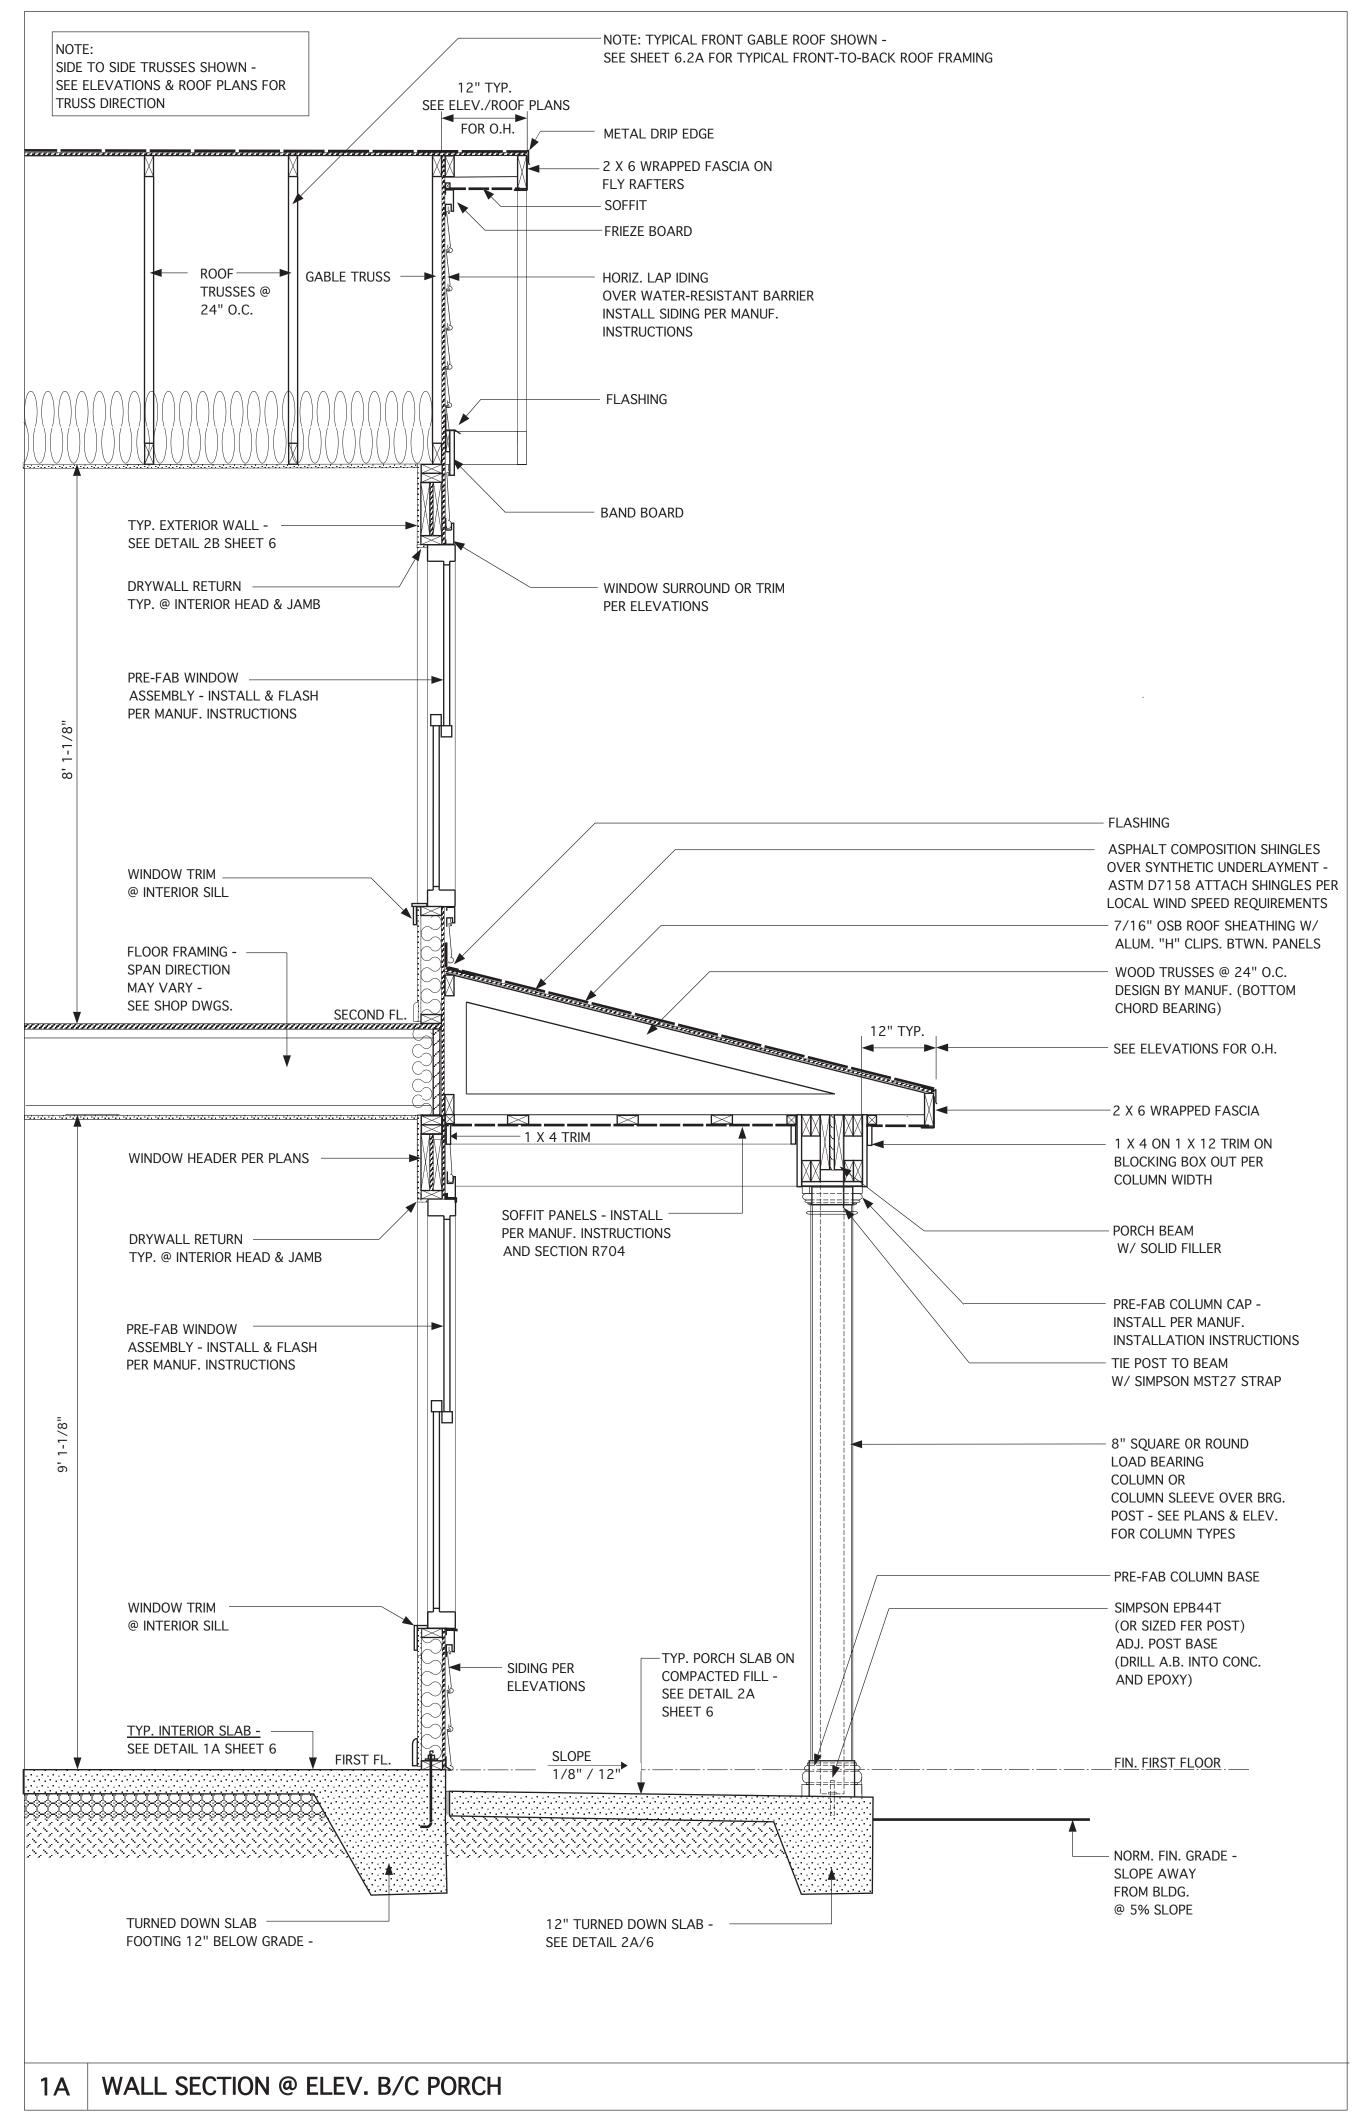
CHESAPEAKE

HOMES OF NC 3100 Smoketree Court, Suite 210 Raleigh, NC 27604 (919) 256-3060 (919) 556-0690 Fax

DRAWING TITLE

ELEVATION A -DETAILS



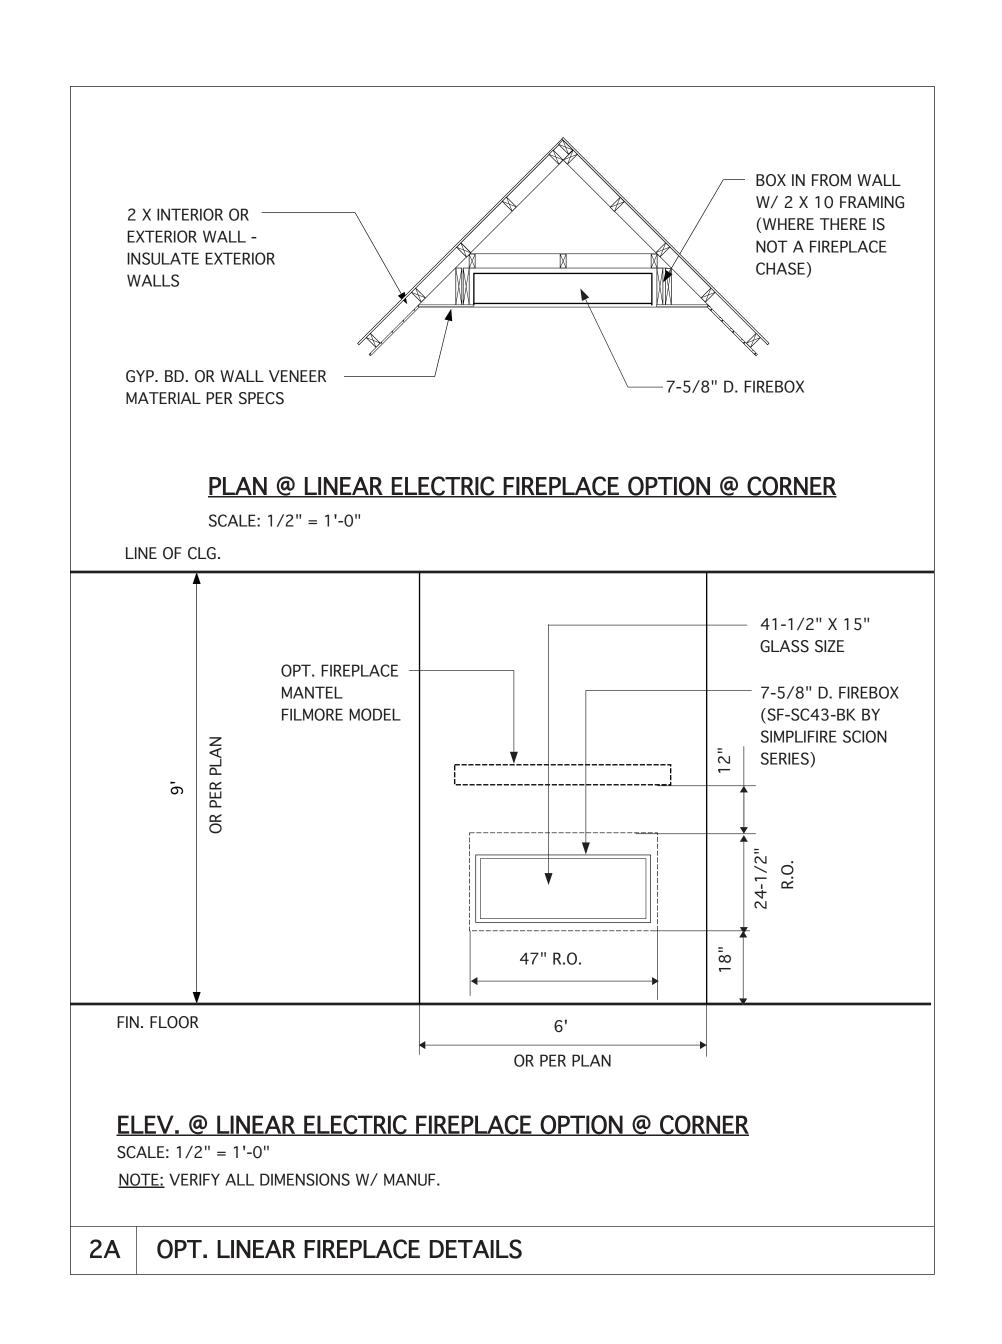




SUITE 1524 PHILADELPHIA, PA 19110

(215) 568-2551 email -information@ wentlinghouseplans.com

ARCHITECTURE

LAND PLANNING
GRAPHICS

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REVIS	SIONS	
MARK	DATE	DESCRIPTION
DN	02-04-19	CONVERT HIGHGATE
СН	01-03-20	MINOR UPDATE
СН	05-11-23	CONVERT 113-69/ADD THIRD-CAR GARAGE OPT.
DN	01-16-25	REV. 62100 PER NEW FIRST
JW	02-07-25	REV. PER 2/5/25 CALL

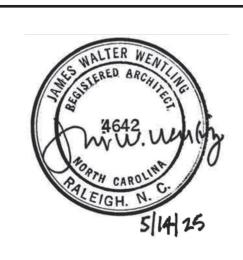PROJECT NO.	113-88
DATE	
	01-08-18
SCALE	
	3/4" = 1'-0" U.N.O.
DRAWN BY	
	DN
CHECKED BY	
	JW
ISSUED FOR	
	PERMITS/CONSTRUCTION

MODEL 623L GARAGE LEFT


CHESAPEAKE HOMES OF NC 3100 Smoketree Court,


3100 Smoketree Cou Suite 210 Raleigh, NC 27604 (919) 256-3060 (919) 556-0690 Fax

DRAWING T

ELEVATION B -DETAILS

6.2B

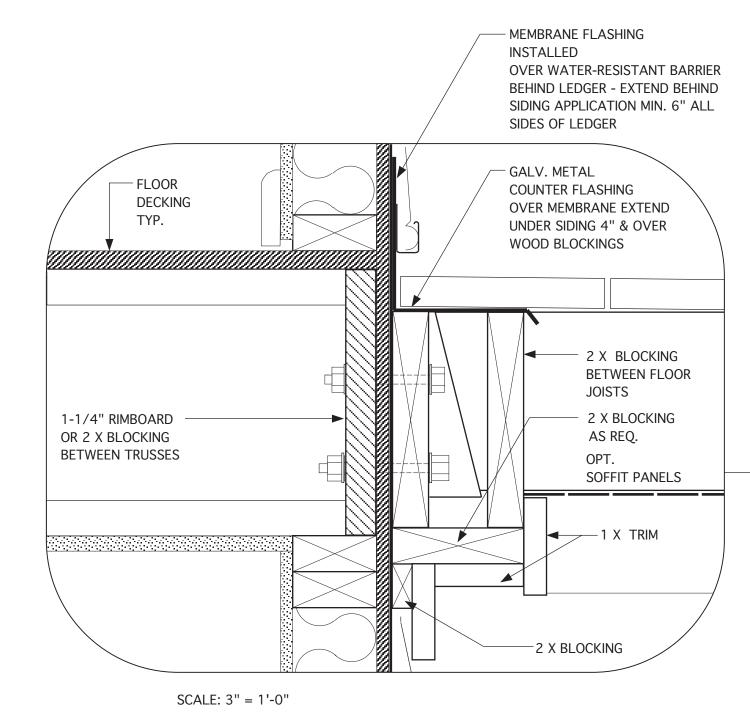

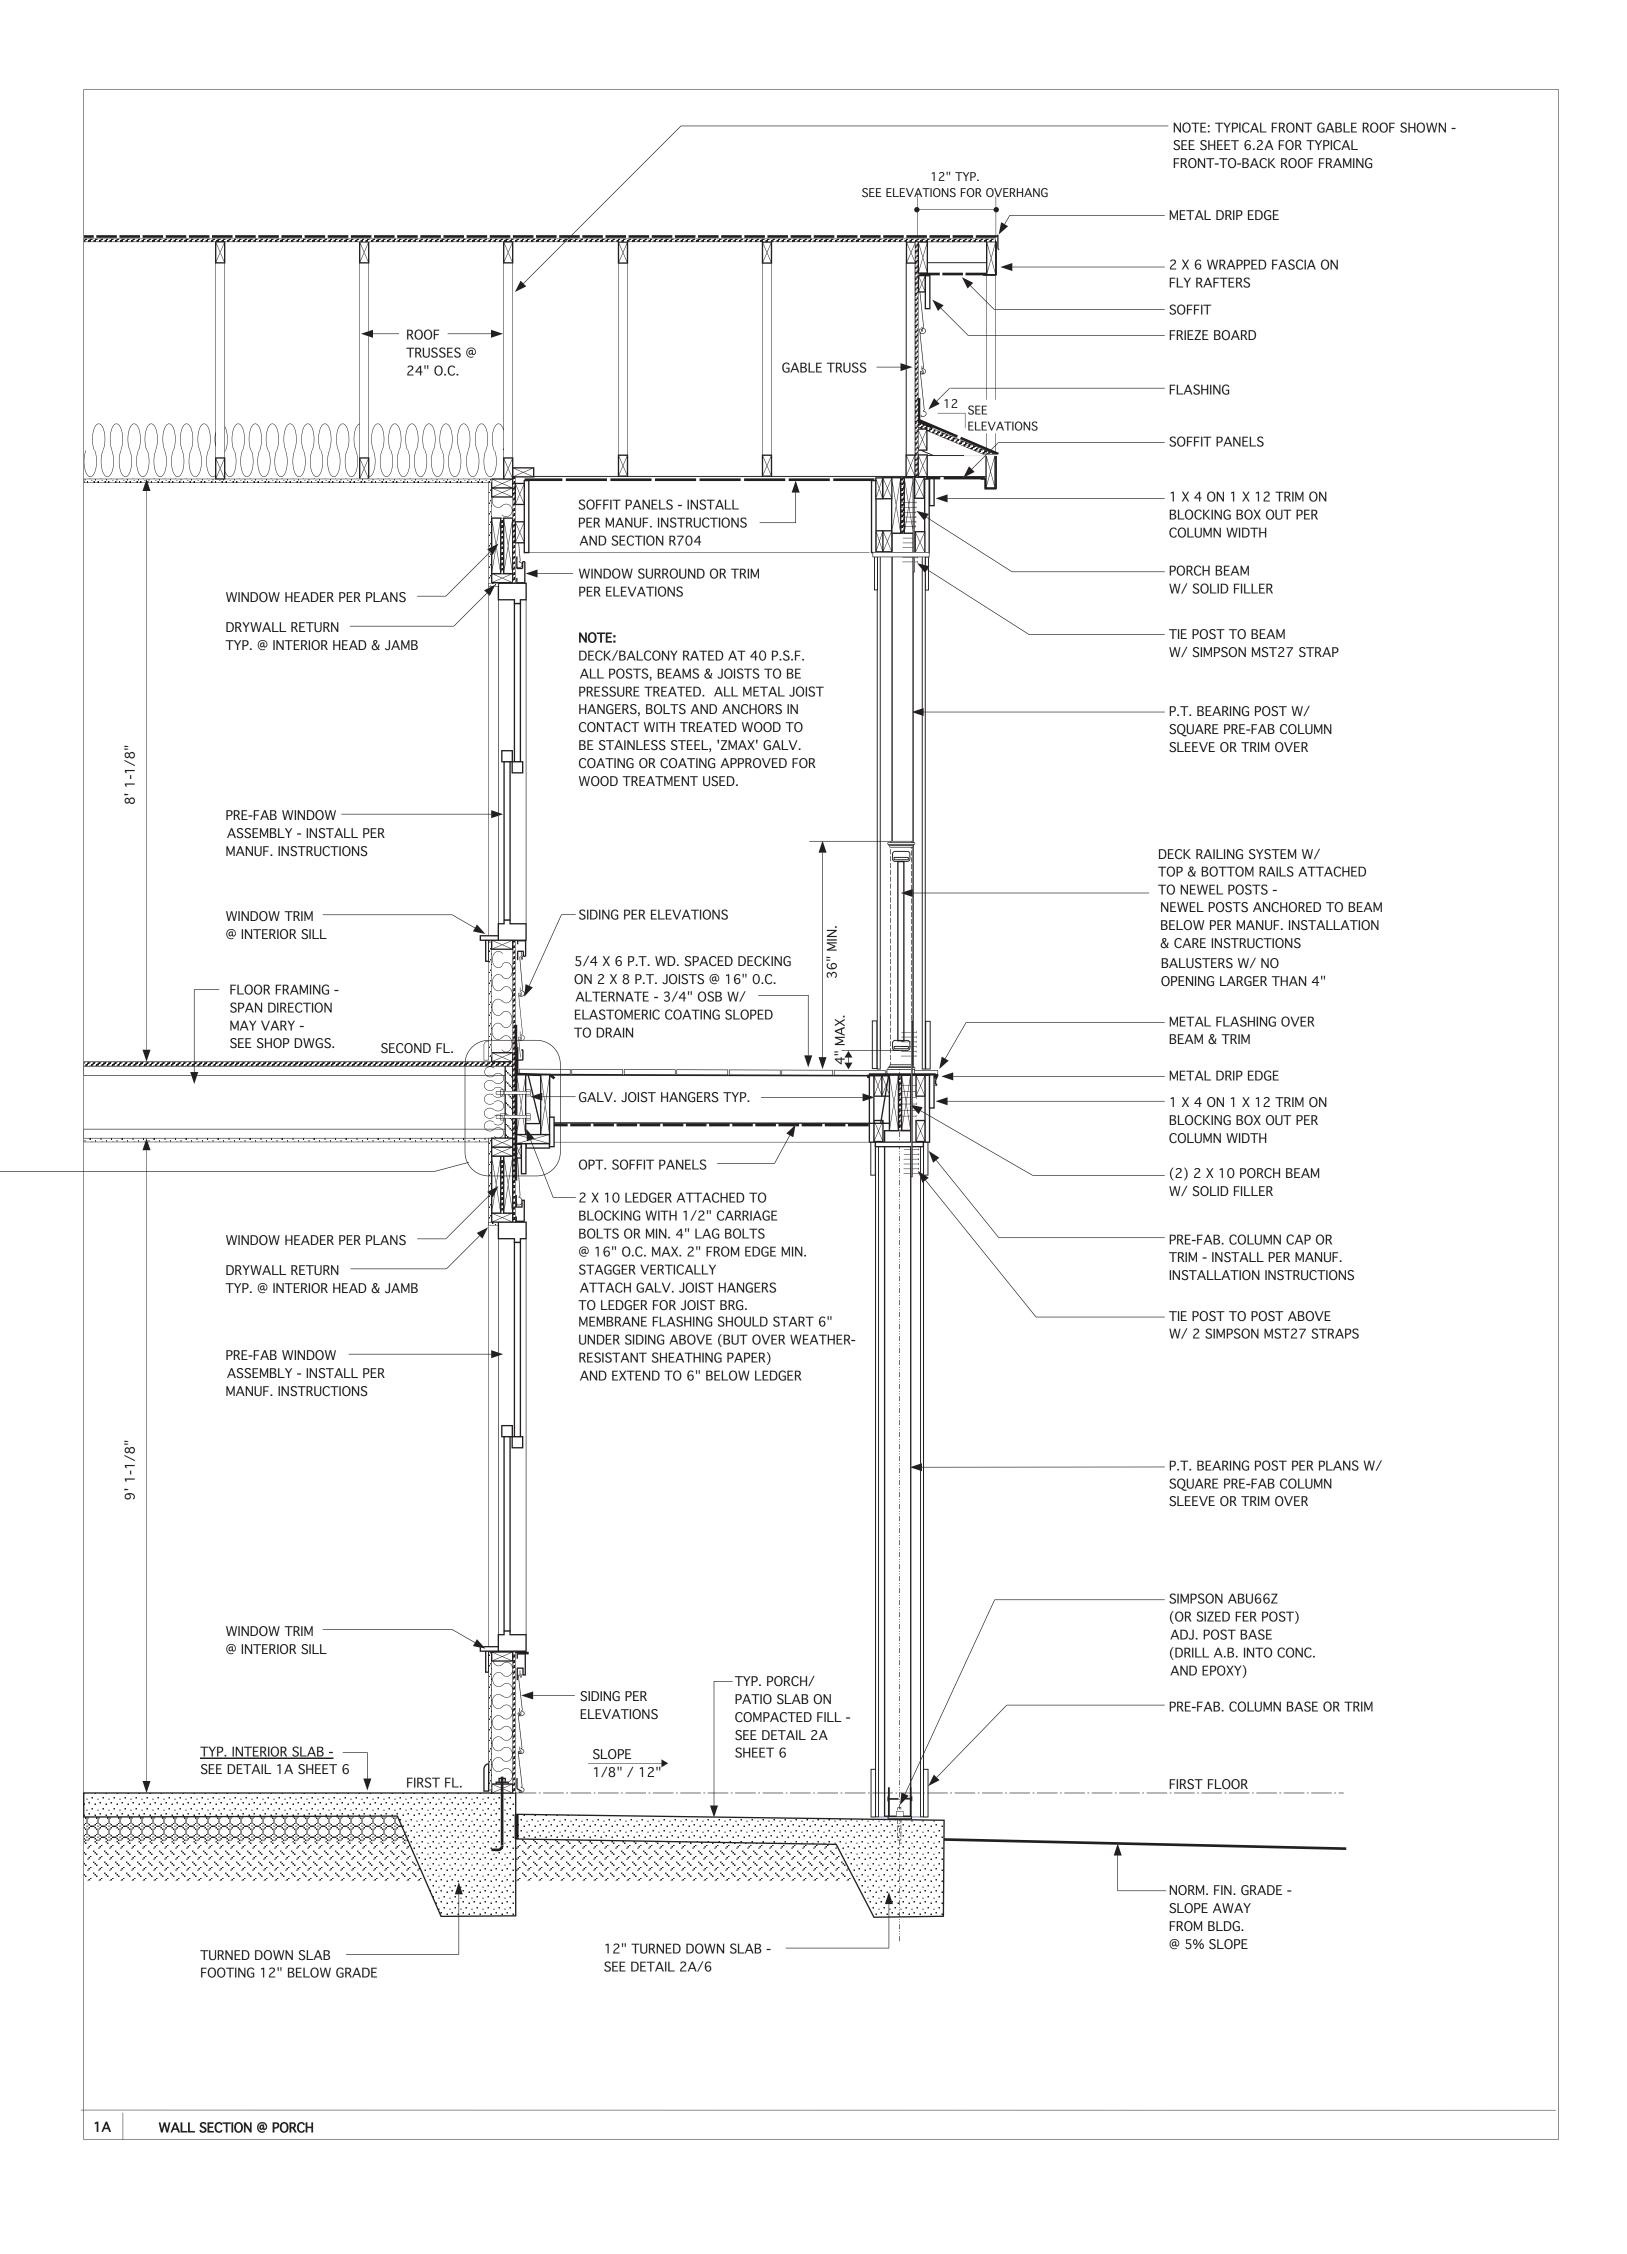



LAND TITLE BUILDING 100 SOUTH BROAD STREET, SUITE 1524 PHILADELPHIA, PA 19110


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REVIS	IONS	
MARK	DATE	DESCRIPTION
DN	01-16-25	REV. 62100 PER NEW FIRST
JW	02-07-25	REV. PER 2/5/25 CALL

PROJECT NO.	
	113-88
DATE	05-31-23
SCALE	3/4" = 1'-0"
DRAWN BY	СН
CHECKED BY	JW
ISSUED FOR	PERMITS/CONSTRUCTION

PROJECT TITLE

MODEL 623L GARAGE LEFT


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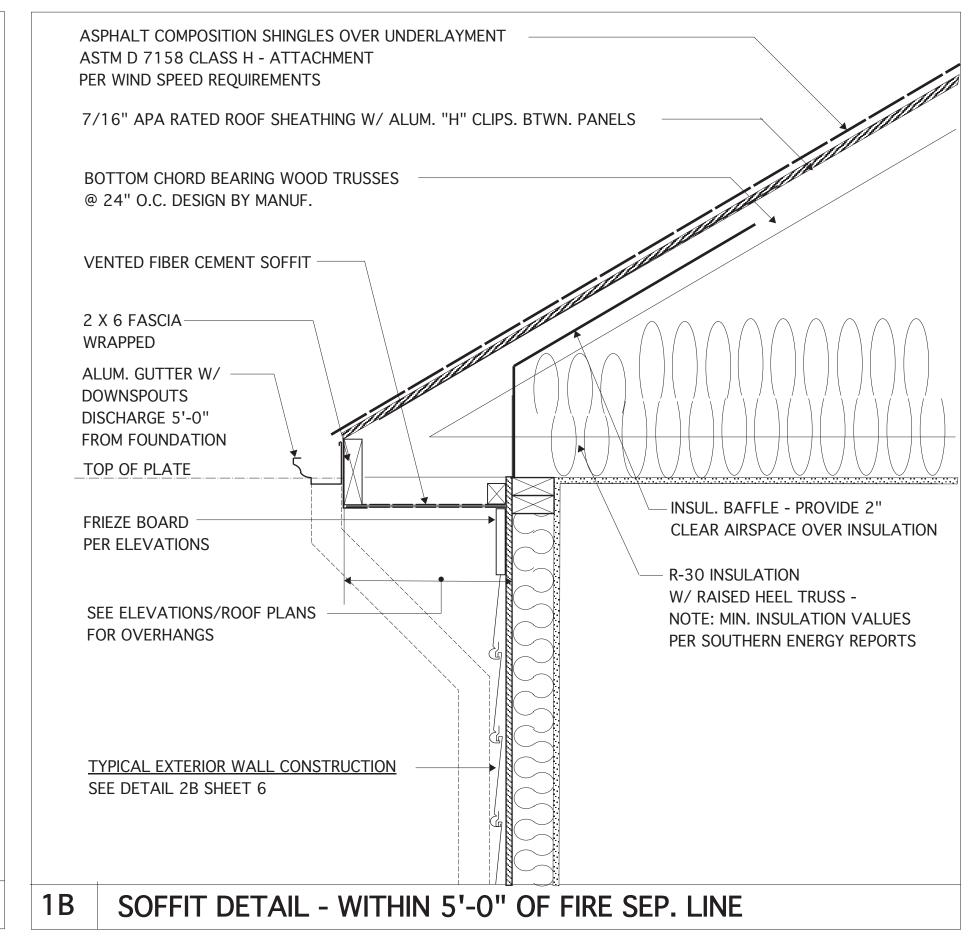
3100 Smoketree Court, Suite 210 Raleigh, NC 27604 (919) 256-3060 (919) 556-0690 Fax

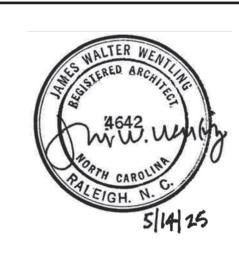
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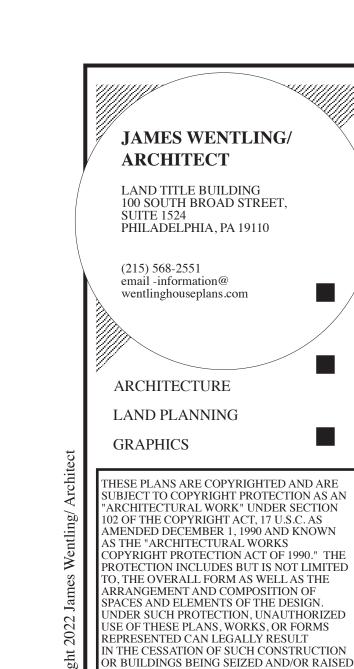
ELEVATION C -DETAILS


6 2C





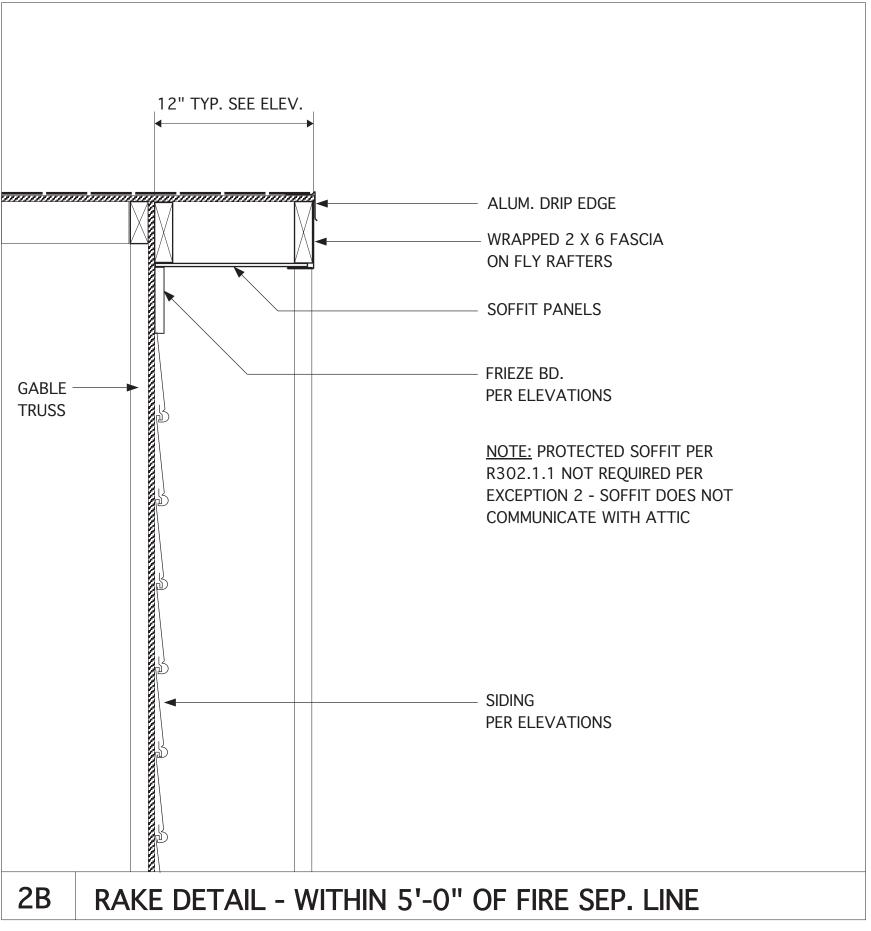

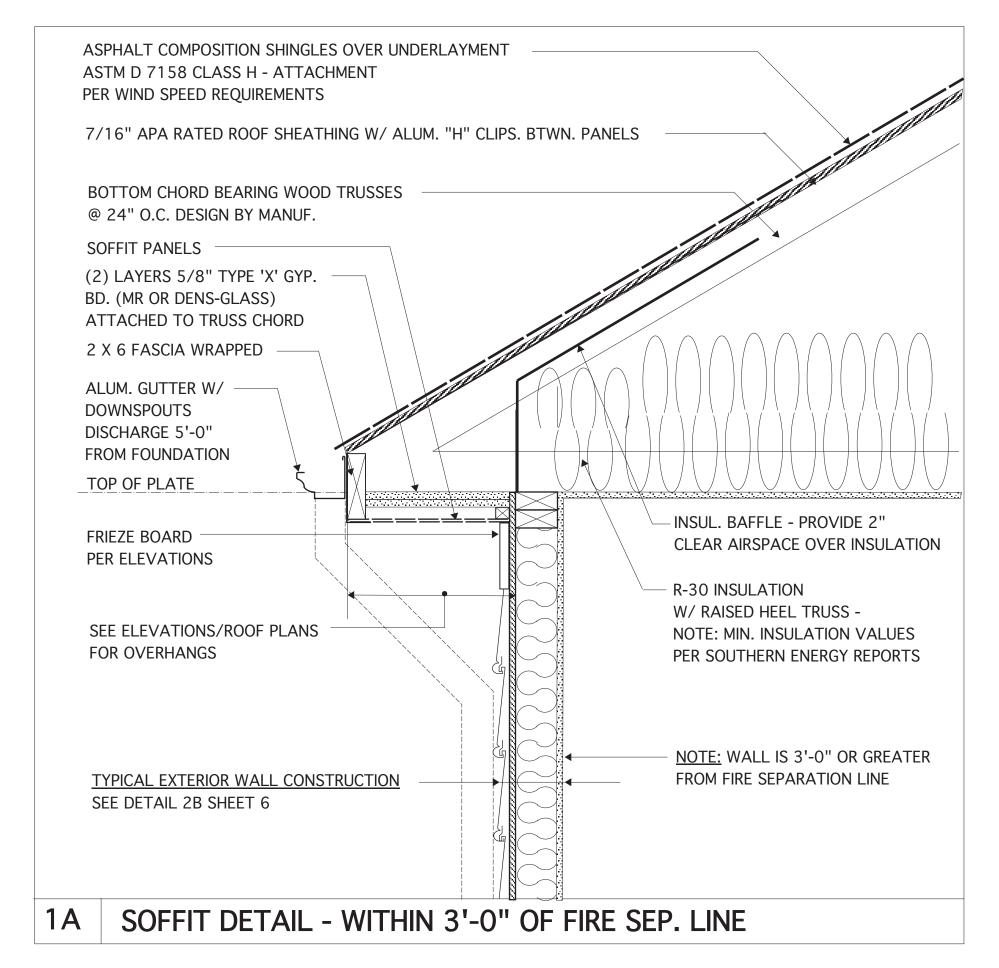

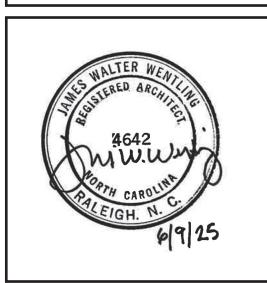

DN 04-07-25 PROTECTED SOFFIT DTL.

REVISIONS

JW 06-	09-25	CORRECT ELEV. C PORCH
PROJECT NO.	112.00	
	113-88	3
DATE		
DAIL	03-06	i-24
SCALE	03-06	

PERMITS/CONSTRUCTION


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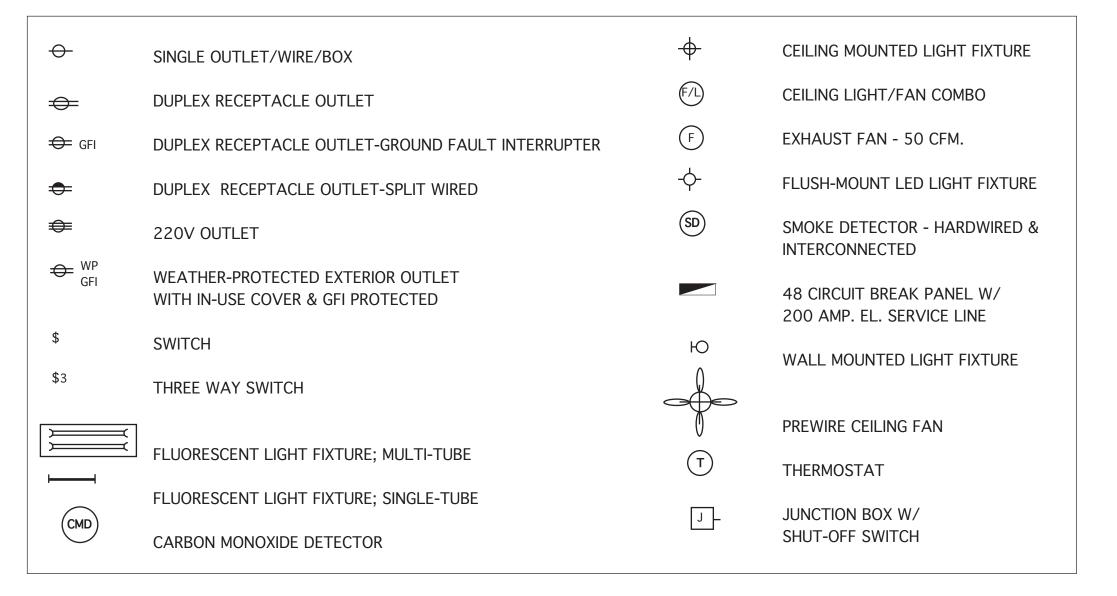
CHESAPEAKE
HOMES OF NC
3100 Smoketree Court,
Suite 210
Raleigh, NC 27604
(919) 256-3060
(919) 556-0690 Fax

DD OTE CTEI

PROTECTED SOFFIT DETAILS

6.3



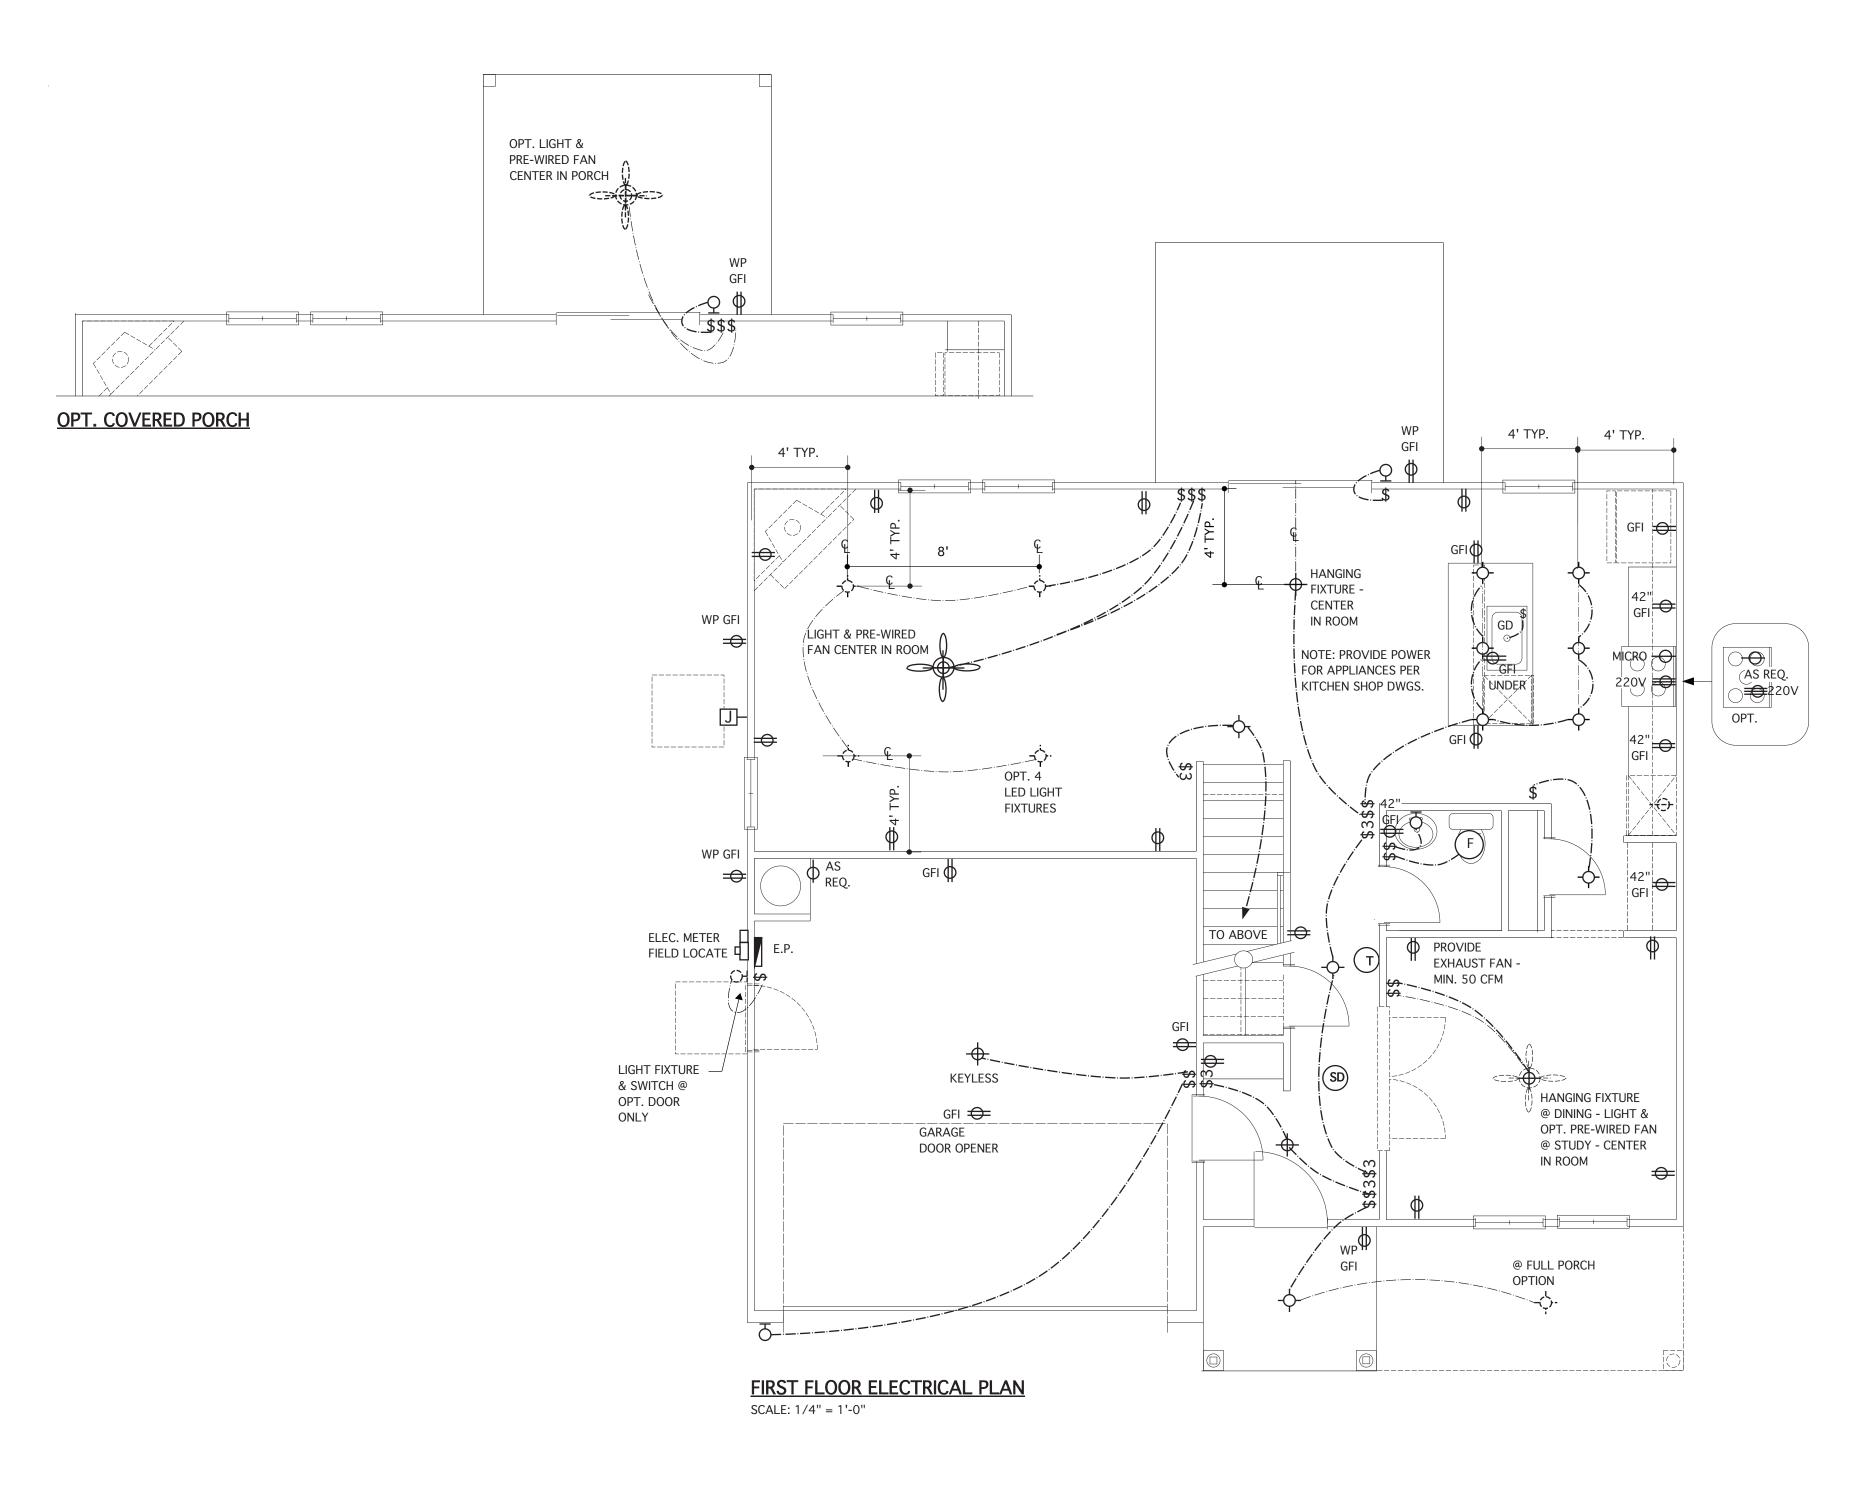




LAND TITLE BUILDING 100 SOUTH BROAD STREET, SUITE 1524 PHILADELPHIA, PA 19110

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ARCHITECTURE
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REVIS	SIONS	
MARK	DATE	DESCRIPTION
СН	01-03-20	GOURMET KIT.
СН	05-11-23	CONVERT 113-69/ADD THIRD-CAR GARAGE OPT.
DN	01-16-25	REV. 62100 PER NEW FIRST
TT	03-20-25	REV. PER MTG.
TT	04-03-25	REV. PER COST. EMS
DN	05-14-25	STRUCT. DWG. REVIEW
DN	05-21-25	STRUCT. DWG. REVIEW

	<u>'</u>
PROJECT NO.	
	113-88
DATE	01.00.10
	01-08-18
SCALE	
	AS NOTED
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	JW
ISSUED FOR	


PROJECT TITLE

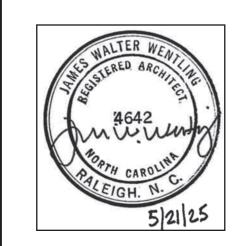MODEL 623L GARAGE LEFT


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DRAWING TITL

FIRST FLOOR ELECTRICAL PLANS

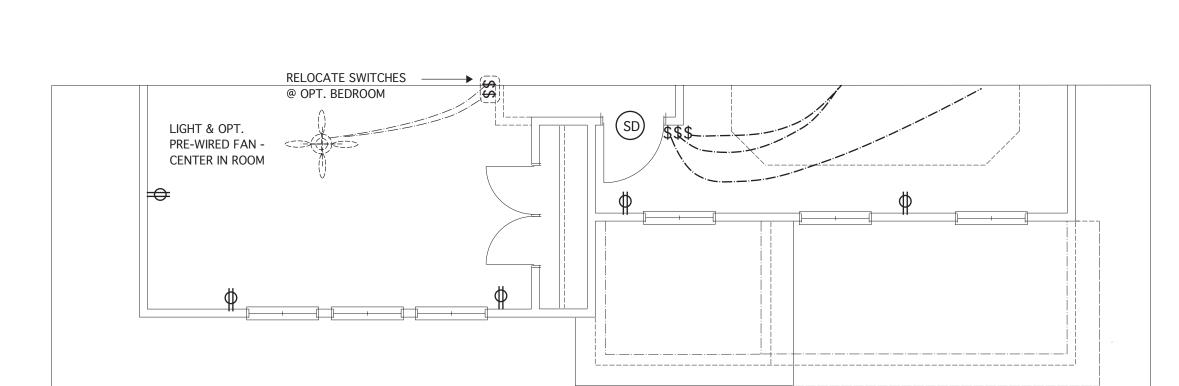

SECOND FLOOR PLAN @ ELEV. A
SCALE: 1/4" = 1'-0"

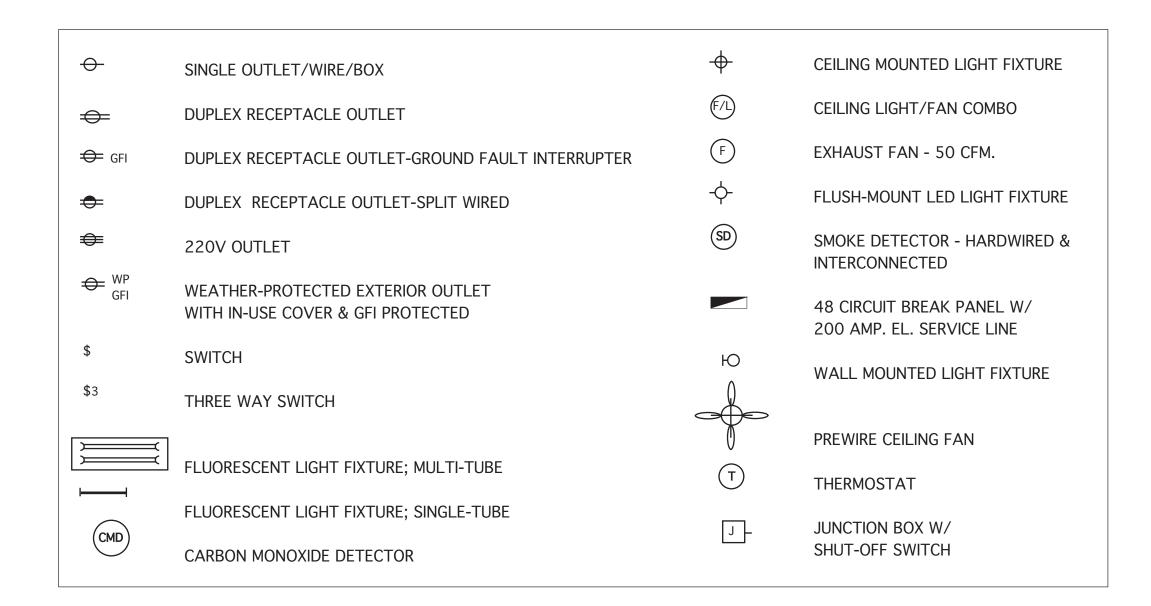

JAMES WENTLING/ ARCHITECT

LAND TITLE BUILDING 100 SOUTH BROAD STREET,

PHILADELPHIA, PA 19110

(215) 568-2551
email-information@

wentlinghouseplans.com

ARCHITECTURE

I AND PLANNING

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GRAPHICS

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REVIS	SIONS	
MARK	DATE	DESCRIPTION
DN	02-26-19	STRUCT. DWGS. REV.
СН	01-03-20	MINOR UPDATE
СН	05-11-23	CONVERT 113-69/ADD THIRD-CAR GARAGE OPT.
DN	01-16-25	REVISE 62100
TT	03-20-25	REV. PER MTG.
TT	04-03-25	REV. PER COST. EMS
JW	06-09-25	CORRECT ELEV. C PORCH

PROJECT NO.	113-88
DATE	01-08-18
SCALE	AS NOTED
DRAWN BY	DN
CHECKED BY	JW
ISSUED FOR	PERMITS/CONSTRUCTION

PROJECT T

MODEL 623L GARAGE LEFT

CHESAPEAKE

HOMES OF NC 3100 Smoketree Court, Suite 210 Raleigh, NC 27604 (919) 256-3060 (919) 556-0690 Fax

DRAWING TITLE

SECOND FLOOR ELECTRICAL PLANS

7.1

STRUCTURAL NOTES NC (2018 NCRC): Wind: 115-120 mph

- ENGINEER'S SEAL APPLIES ONLY TO STRUCTURAL COMPONENTS INCLUDING ROOF RAFTERS, HIPS, VALLEYS, RIDGES, FLOORS, WALLS, BEAMS AND HEADERS, COLUMNS, CANTILEVERS, OFFSET LOAD BEARING WALLS, PIER & GIRDER SYSTEM, FOOTING, AND PILING SYSTEM. ENGINEER'S SEAL DOES NOT CERTIFY DIMENSIONAL ACCURACY OR ARCHITECTURAL LAYOUT INCLUDING ROOF SYSTEM. ALL REQUIREMENTS FOR PROFESSIONAL CERTIFICATION SHALL BE PROVIDED BY THE APPROPRIATE PROFESSIONAL. SOUTHERN ENGINEERS, P.A. CERTIFIES ONLY THE STRUCTURAL COMPONENTS AS SPECIFICALLY STATED.
- 2. ALL CONSTRUCTION SHALL CONFORM TO THE LATEST REQUIREMENTS OF THE 2018 NC RESIDENTIAL CODE, PLUS ALL LOCAL CODES AND REGULATIONS. THE STRUCTURAL ENGINEER IS NOT RESPONSIBLE FOR, AND WILL NOT HAVE CONTROL OF, CONSTRUCTION MEANS, METHODS, TECHNIQUES, SEQUENCES OR PROCEDURES, OR FOR SAFETY PRECAUTIONS AND PROGRAMS IN CONNECTION WITH THE CONSTRUCTION WORK, NOR WILL THE ENGINEER BE RESPONSIBLE FOR THE CONTRACTOR'S FAILURE TO CARRY OUT THE CONSTRUCTION WORK IN ACCORDANCE WITH THE CONTRACT DOCUMENTS. "CONSTRUCTION REVIEW" SERVICES ARE NOT PART OF OUR CONTRACT ALL MEMBERS SHALL BE FRAMED ANCHORED, TIED AND BRACED IN ACCORDANCE WITH GOOD CONSTRUCTION PRACTICE AND THE BUILDING CODE.
- 3. DESIGN LOADS (LISTED AS: LIVE LOAD, DEAD LOAD, DEFLECTION) ROOMS OTHER THAN SLEEPING ROOMS: (40 PSF, IO PSF, L/360) SLEEPING ROOMS: (30 PSF, IO PSF, L/360)
- ATTIC WITH PERMANENT STAIR: (40 PSF, IO PSF, L/360) ATTIC WITHOUT PERMANENT STAIR: (20 PSF, IO PSF, L/360)
- ATTIC WITHOUT STORAGE: (IO PSF, IO PSF, L/240) STAIRS: (40 PSF, IO PSF, L/360)
- EXTERIOR BALCONIES: (60 PSF, I0 PSF, L/360) DECKS: (40 PSF, IO PSF, L/360)
- GUARDRAILS AND HANDRAILS: (200 LBS) PASSSENGER VEHICLE GARAGES: (50 PSF, IO PSF, L/360)
- FIRE ESCAPES: (40 PSF, IO PSF, L/360) SNOW: (20 PSF)
- 4. WALLS SHALL BE BRACED BY SHEATHING WALLS ON ALL STORIES WITH WOOD STRUCTURAL PANELS. SEE FRAMING NOTES FOR THICKNESS AND NAILING REQUIREMENTS.
- 5. SEE APPENDIX M (DCA6) FOR EXTERIOR DECK REQUIREMENTS INCLUDING ATTACHMENTS FOR LATERAL LOADS.
- 6. CONCRETE SHALL HAVE A MINIMUM 28 DAY STRENGTH OF 3000 PSI AND A MAXIMUM SLUMP OF 5 INCHES UNLESS NOTED OTHERWISE (UNO). AIR ENTRAINED PER TABLE 402.2, ALL CONCRETE SHALL BE PROPORTIONED, MIXED, HANDLED, SAMPLED, TESTED, AND PLACED IN ACCORDANCE WITH ACI STANDARDS. ALL SAMPLES FOR PUMPING SHALL BE TAKEN FROM THE EXIT END OF THE PUMP. CONTROL JOINTS IN SLABS SHALL BE SPACED ON A GRID OF +-30 TIMES THE DEPTH (D). CONTROL JOINTS SHALL BE SAWCUT TO A DEPTH OF I/D. (I.E. 4" CONCRETE SLABS SHALL HAVE 1/4" DEEP CONTROL JOINTS SAWCUT IN SLAB ON A +-10'-0" x +-10'-0" GRID).
- ALLOWABLE SOIL BEARING PRESSURE ASSUMED TO BE 2000 PSF. THE CONTRACTOR MUST CONTACT A GEOTECHNICAL ENGINEER AND THE STRUCTURAL ENGINEER IF UNSATISFACTORY SUBSURFACE CONDITIONS ARE ENCOUNTERED. THE SURFACE AREA ADJACENT TO THE FOUNDATION WALL SHALL BE PROVIDED WITH ADEQUATE DRAINAGE, AND SHALL BE GRADED SO AS TO DRAIN SURFACE WATER AWAY FROM FOUNDATION WALLS.
- 8. ALL FRAMING LUMBER SHALL BE SPF #2 (Fb = 875 PSI) UNLESS NOTED OTHERWISE (UNO). ALL TREATED LUMBER SHALL BE SYP # 2. PLATE MATERIAL MAY BE SPF # 3 OR SYP #3 (Fc(perp) =
- 9. L.V.L. SHALL BE LAMINATED VENEER LUMBER: Fb=2600 PSI, Fv=285 PSI, E=1.9xI0 PSI. 9.I. P.S.L. SHALL BE PARALLEL STRAND LUMBER: Fb=2900 PSI, Fv=290 PSI, E=2.0xI0 PSI. 9.2. L.S.L. SHALL BE LAMINATED STRAND LUMBER: Fb=2250 PSI, Fv=400 PSI, E=1.55xI0 PSI. INSTALL ALL CONNECTIONS PER MANUFACTURERS INSTRUCTIONS.
- IO. ALL ROOF TRUSS AND I-JOIST LAYOUTS SHALL BE PREPARED IN ACCORDANCE WITH THE SEALED STRUCTURAL DRAWINGS. TRUSSES AND I-JOISTS SHALL BE INSTALLED ACCORDING TO THE MANUFACTURE'S SPECIFICATIONS. ANY CHANGE IN TRUSS OR I-JOIST LAYOUT SHALL BE COORDINATED WITH SOUTHERN ENGINEERS.
- II. ALL STRUCTURAL STEEL SHALL BE ASTM A-36. STEEL BEAMS SHALL BE SUPPORTED AT EACH END WITH A MINIMUM BEARING LENGTH OF 3 1/2" INCHES AND FULL FLANGE WIDTH. PROVIDE SOLID BEARING FROM BEAM SUPPORT TO FOUNDATION. BEAMS SHALL BE ATTACHED TO EACH SUPPORT WITH TWO LAG SCREWS (I/2" DIAMETER x 4" LONG). LATERAL SUPPORT IS CONSIDERED ADEQUATE PROVIDING THE JOIST ARE TOE NAILED TO THE SOLE PLATE. AND SOLE PLATE IS NAILED OR BOLTED TO THE BEAM FLANGE @ 48" O.C. ALL STEEL TUBING SHALL BE ASTM A500.
- 12. REBAR SHALL BE DEFORMED STEEL, ASTM615, GRADE 60. LAP ALL REBAR SPLICES 30 BAR
- 13. FLITCH BEAMS SHALL BE BOLTED TOGETHER USING (2) ROWS OF 1/2" DIAMETER BOLTS (ASTM A325) WITH WASHERS PLACED UNDER THE THREADED END OF BOLT. BOLTS SHALL BE SPACED AT 24" O.C. (MAX), AND STAGGERED AT THE TOP AND BOTTOM OF BEAM (2" EDGE DISTANCE), WITH 2 BOLTS LOCATED AT 6" FROM EACH END.
- 14. BRICK LINTELS (WHEN REQUIRED) SHALL BE 3 1/2"x3 1/2"x1/4" STEEL ANGLE FOR UP TO 6'-0" SPAN AND 6"x4"x5/16" STEEL ANGLE WITH 6" LEG VERTICAL FOR SPANS UP TO 9'-0". SEE PLANS FOR SPANS OVER 9'-0". SEE ALSO SECTION R703.8.3 LINTELS.

FRAMING NOTES NC (2018 NCRC): Wind: 115-120 mph

- BRACING METHOD AND TYPE: CONTINUOUSLY SHEATHED WSP: CS-WSP. NOTE THAT THE WALL BRACING AMOUNT PROVIDED ON THE PLANS (DETAILS AND SPECIFICATIONS) IS GREATER THAN THE AMOUNT OF WALL BRACING REQUIRED BY SECTION R602.10 OF THE CODE. SEE NOTES BELOW FOR DETAILS AND SPECIFICATIONS FOR WALL BRACING AND WALL FRAMING.
- 2. EXTERIOR WALL SHEATHING: WALLS SHALL BE BRACED BY SHEATHING WALLS ON ALL STORIES WITH WOOD STRUCTURAL PANEL SHEATHING (MSP) (EXPOSURE B: 1/16", EXPOSURE C: 15/32"), SHEATHING SHALL BE ATTACHED WITH 8d NAILS AT A 6"/12" NAILING PATTERN (6" OC AT PANEL EDGES AND 12" OC AT INTERMEDIATE SUPPORTS). INSTALL BLOCKING AT ALL PANEL EDGES.
- 3. WSP SHEATHING SHALL EXTEND TO THE UPPERMOST DOUBLE BEARING PLATE. BLOCK AT ROOF PER SECTION R602.10.4.5 AND ATTACH BRACED WALLS PER CODE. WSP SHEATHING BETWEEN FLOORS SHALL BE SPLICED ALONG CONTINUOUS BAND OR THE WSP SHEATHING MAY BE SPLICED ACROSS STUDS (CONTINUOUS ACROSS FLOOR SYSTEM) WITH BLOCKING AT PANEL EDGES. (MINIMUM 12" BEYOND FLOOR BREAK) OR OTHER APPROVED METHOD.
- 4. "HD" = HOLDOWN: HOLD-DOWN DEVICE (NOTED AS "HD" ON PLANS) SHALL BE AN 800 POUND CAPACITY ASSEMBLY AS NOTED ON PLANS. SEE DETAILS FOR HD ASSEMBLY. • **GROUND/FIRST FLOOR: USE "HD HOLD-DOWN DETAIL" ON SD SHEET
- (OR EQUIV.) • **UPPER FLOORS: ATTACH BASE OF KING STUD WITH A SIMPSON CS22 STRAP DOWN ACROSS THE BAND AND DOWN TO A STUD BELOW OR HEADER BELOW. EXTEND STRAP 7" MIN ALONG EACH STUD (OR HEADER) AND ATTACH EACH END W (7) 8d NAILS.
- 5. INTERIOR BRACED WALL: (NOTED AS "IBW" ON PLANS) ATTACH I/2" GYPSUM BOARD (GB) ON EACH SIDE OF WALL WITH A MIN. OF 5d COOLER NAILS OR #6 SCREWS @ 7" O.C. ALONG THE EDGES AND AT INTERMEDIATE SUPPORTS.
- INTERIOR BRACED WALL-WOOD STRUCTURAL PANEL: (NOTED AS "IBW-WSP" ON PLANS). ATTACH ONE SIDE WITH 16" WSP SHEATHING WITH 8d NAILS AT A 6"/12" NAILING PATTERN (6" OC AT PANEL EDGES AND 12" OC AT INTERMEDIATE SUPPORTS). INSTALL BLOCKING AT ALL PANEL EDGES, ATTACH GB OVER WSP AS REQUIRED, ATTACH OPPOSITE SIDE WITH I/2" GB WITH A MIN. OF 5d COOLER NAILS OR #6 SCREMS @ 7" OC ALONG THE EDGES AND AT INTERMEDIATE


HEADER/BEAM & COLUMN NOTES

- ALL EXTERIOR AND LOAD BEARING HEADERS SHALL BE MIN. (2)2x6 (4" WALL) OR (3)2x6 (6" WALL) WITH (I) SUPPORT STUD, UNLESS NOTED
- 2. THE NUMBER SHOWN AT BEAM AND HEADER SUPPORTS INDICATES THE NUMBER OF SUPPORT STUDS REQUIRED IN STUD POCKET OR COLUMN. THE NUMBER OF KING STUDS AT EACH END OF HEADERS IN EXTERIOR WALLS SHALL BE ACCORDING TO ITEM "d" IN TABLE R602.3(5) OR AS BELOW PER NODOL COMMENTARY "KING STUDS AT WALL OPENINGS" REVISED 1-9-2020:
- •• UP TO 3' SPAN: (I) KING STUD OVER 3' UP TO 6' SPAN: (2) KING STUDS OVER 6' UP TO 9' SPAN: (3) KING STUDS
- OVER 9' UP TO 12' SPAN: (4) KING STUDS OVER 12' UP TO 15' SPAN: (5) KING STUDS


TRUSS SYSTEM REQUIREMENTS NC (2018 NCRC): Wind: 115-120 mph

- TRUSS SYSTEM LAYOUTS (PLACEMENT PLANS) SHALL BE DESIGNED IN ACCORDANCE WITH SEALED STRUCTURAL PLANS. ANY NEED TO CHANGE TRUSSES SHALL BE COORDINATED WITH SOUTHERN
- TRUSS SCHEMATICS (PROFILES) SHALL BE PREPARED AND SEALED BY TRUSS MANUFACTURER.
- 3. ALL TRUSSES SHALL BE DESIGNED FOR BEARING ON SPF #2 OR #3 PLATES OR LEDGERS (UNO).
- 4. ALL REQUIRED ANCHORS FOR TRUSSES DUE TO UPLIFT OR BEARING SHALL MEET THE REQUIREMENTS AS SPECIFIED ON THE TRUSS SCHEMATICS.


- 4X4 (6x6) TRT'D POST (OR EQUAL). ATTACH TRUSSES (RAFTERS) AT PORCH WITH HURRICANE CONNECTORS.
- POST CAP: SIMPSON AC4-MAX (AC6-MAX) POST CAP AT CORNER: (2) SIMPSON LCE4 (MITER HEADER AT CORNER). HIGH WIND; ADD (I)
- 3. <u>POST BASE</u>: SIMPSON ABU44 (ABU66).
- 3.1. <u>MONO</u>: %" ANCHOR (EMBED 7") 3.2. CMU: 5/8" ANCHOR (EXTEND TO FOOTING -HIGH WIND ONLY)
- 4. POST BASE: WOOD FOUNDATION: (2) SIMPSON CSI6 STRAPS AT POSTS. EXTEND 12" ONTO EACH POST (UPPER AND LOWER) OR TO GIRDER.
- NOTE: EQUIVALENT POST CAP AND BASE ACCEPTABLE.

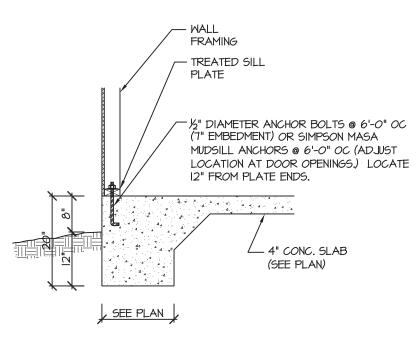


<u>MONOLITHIC SLAB FOOTING</u> (SIDING OR EQUAL)

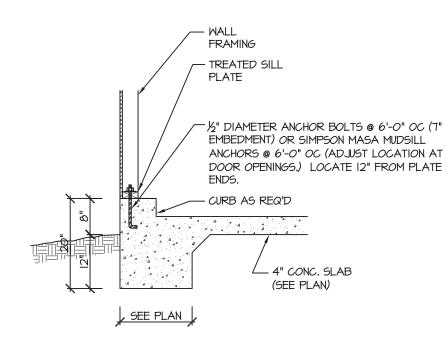


MONOLITHIC SLAB @ GARAGE

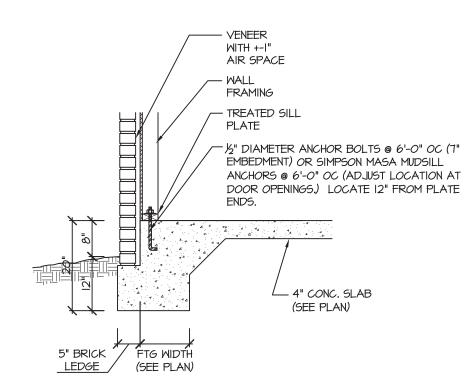



MONOLITHIC SLAB FOOTING

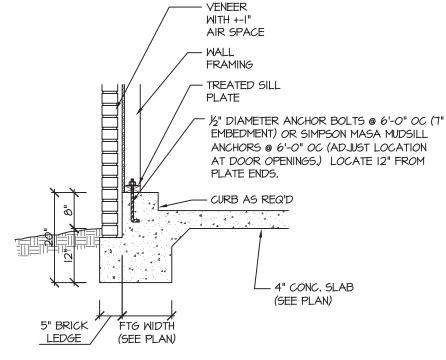



MONOLITHIC SLAB @ GARAGE

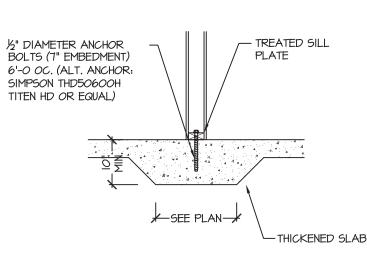


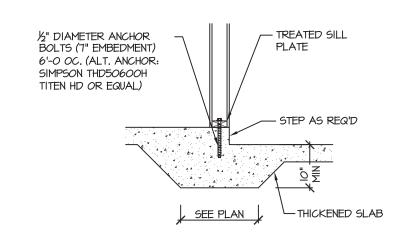

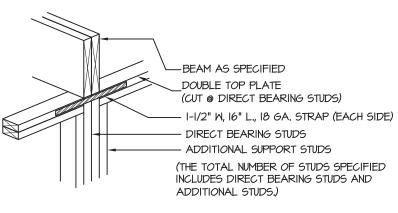

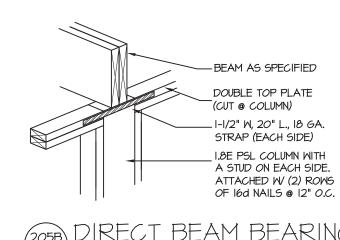

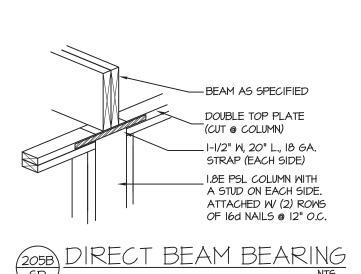

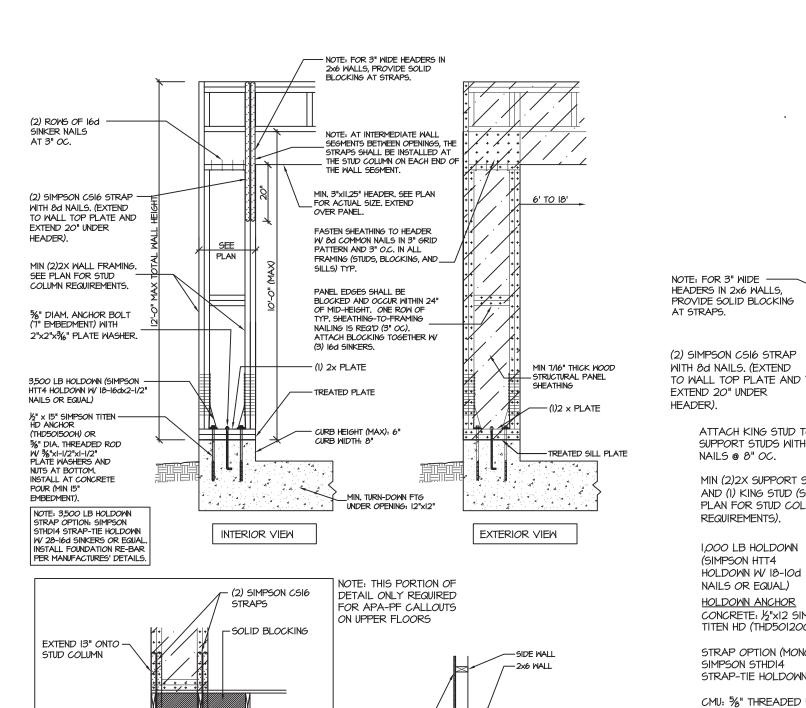

APA PORTAL FRAME W/ HOLD-DOWNS $^\prime$ DETAIL AND APPLICATION BASED ON APA TT-100F WITH USE OF TABLE I FOR APA PORTAL FRAME WITH HOLD-DOWN CAPACITIES.

LDBL TOP PLATE

BASE OF APA ON UPPER FLOOR

— 2X WALL FRAMING

- TREATED PLATE

-STRAP OPTION; MIN. #4 REBAR. SET 4" FROM TOP OF CURB.

/--(I) 2x PLATE

— HEADER (SEE PLAN)

EXTEND 13" ONTO -

STUD COLUMN

NOTE: 3,500 LB HOLDOWN STRAP OPTION: SIMPSON STHDI4 STRAP-TIE HOLDOWN W 20-16d SINKERS OR EQUAL. INSTALL FOUNDATION RE-BAR PER MANUFACTURES DETAILS.


3,500 LB HOLDOWN (SIMPSO

VENEER LEDGE

FOOTING SECTION

HTT4 HOLDOWN W/ -IB-I6dx2-I/2" NAIL5

OR EQUAL)

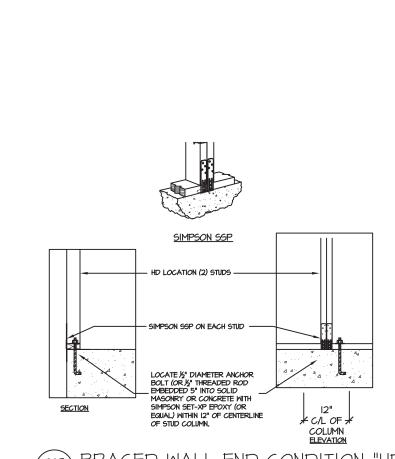

ATTACH KING STUD TO-

NAILS @ 8" OC.

REQUIREMENTS).

(SIMPSON HTT4

1,000 LB HOLDOWN

HOLDOWN W/ 18-10d NAILS OR EQUAL)

HOLDOWN ANCHOR

SIMPSON STHD14

CONCRETE: 1/2"x12 SIMPSON

TITEN HD (THD501200H)

STRAP OPTION (MONO:

STRAP-TIE HOLDOWN.

CMU: %" THREADED ROD

(HIGH WIND ZONE: EXTEND

END CONDITION DETAIL

^{5D}/ (FOR USE WITH SINGLE APA PORTAL FRAME CONDITION)

DETAIL AND APPLICATION BASED ON APA TT-100F WITH USE OF

TABLE I FOR APA PORTAL FRAME WITH HOLD-DOWN CAPACITIES.

(EMBEDDED 12") WITH

SIMPSON SET EPOXY.

ROD TO FOOTING)

3500 LB HOLDOWN

PLAN VIEW

SIMPSON HTT4 | SIMPSON STHD14

SUPPORT STUDS WITH IOD


MIN (2)2X SUPPORT STUDS

AND (I) KING STUD (SEE

PLAN FOR STUD COLUMN

SECTION 400 APA PORTAL FRAME W/ HOLD-DOWNS DETAIL AND APPLICATION BASED ON APA TT-100F WITH USE OF TABLE I FOR APA PORTAL FRAME WITH HOLD-DOWN



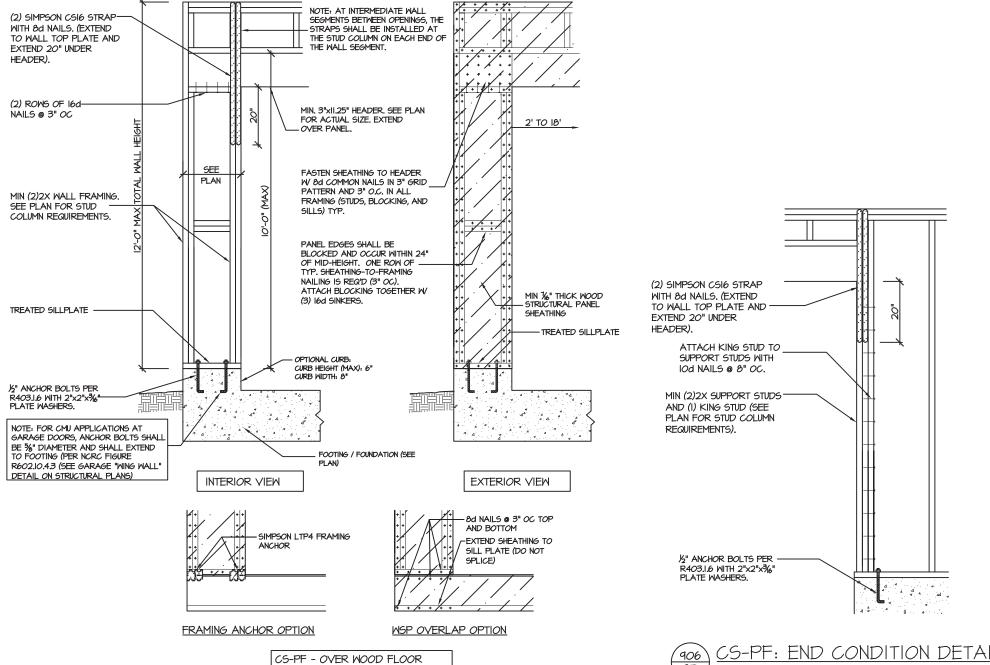

:S-PF: CONTINUOUS PORTAL FRAME CONSTRUCTION DETAIL AND APPLICATION BASED ON NORC FIGURE R602.IO.I - PORTAL FRAME CONSTRUCTION

<u>CS-PF: END CONDITION DETAIL</u> SD / (FOR USE WITH SINGLE CS-PF CONDITION) DETAIL AND APPLICATION BASED ON NORC FIGURE R602.10.1 - PORTAL FRAME CONSTRUCTION

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SD-MONO