

The Garner English Country

Signature Series

Lot: 50 | Duncans Creek 726 Beacon Hill Road Lillington, NC 27546

1ST FLOOR AREA				
	DESCRIPTION			
	REV.#	Creek	4 5 9	r «
2ND FLOOR AREA		The Garner English Country at Duncans	Coyon Choot	
		JJ/[WN BY: DREW	
		R	NDING: IGHT	
		8/19	DATE: 0/2025	
		G-	100)

New Home Inc

1611 Jones Franklin, Raleigh, NC, 27606

(c) 2025 New Home Inc

GENERAL NOTES AND SPECIFICATIONS:

1 GENERAL DATA

PROJECT DESCRIPTION:

THIS PROJECT IS FOR THE CONSTRUCTION OF A NEW SINGLE-FAMILY RESIDENCE, AND ASSOCIATED SITE WORK.

TYPICAL NOTES:

ALL WORK TO BE COORDINATED AND SCHEDULED BY THE OWNER.

ALL WORK, INCLUDING PLUMBING, HVAC AND ELECTRICAL WORK NOT DETAILED HEREIN, SHALL COMPLY WITH APPLICABLE STATE AND LOCAL BUILDING CODES AND THE BUILDING STANDARDS REFERENCED THEREIN.

ALL WORK SHALL CONFORM TO THE HIGHEST LEVELS OF THE APPROPRIATE INDUSTRY STANDARDS FOR CUSTOM WORK.

ALL ITEMS SPECIFIED HEREIN ARE TO BE USED WITHOUT SUBSTITUTION. IF THESE NOTES CONFLICT WITH THE OWNERS SCOPE OF WORK DOCUMENTS, THE NOTES HEREIN SHALL GOVERN AND TAKE PRECEDENT.

THE STRUCTURE IS DESIGNED TO BE SELF-SUPPORTING AND STABLE AFTER THE BUILDING IS FULLY COMPLETE. IT IS SOLELY THE CONTRACTORS RESPONSIBILITY TO ENSURE THE SAFETY OF THE BUILDING AND ITS COMPONENT PARTS DURING ERECTION. THIS INCLUDES THE ADDITION OF TEMPORARY BRACING THAT MAY BE REQUIRED.

IT IS SOLELY THE CONTRACTOR'S RESPONSIBILITY TO FOLLOW ALL APPLICABLE SAFETY CODES AND REGULATIONS DURING ALL PHASES OF CONSTRUCTION.

PLAN DIMENSIONS ARE TO FACE OF ROUGH FRAMING OR MASONRY UNLESS NOTED OTHERWISE. DIMENSIONS TO EXTERIOR WALLS INCLUDE 7/16" OSB WALL SHEATHING WITH WATER-RESISTIVE BARRIER, ROUNDED TO THE NEAREST 1/4".

FINISH FLOOR ELEVATION @ FIRST FLOOR LEVEL IS SET AT 0'-0". SEE SITE PLAN FOR ACTUAL FIRST FLOOR ELEVATION @ EACH BUILDING.

ALL @ INTERIOR PARTITIONS SHALL BE 2x4 STUDS @ 16" O.C. WITH 1/2" DRYWALL EACH SIDE. PLAN DIMENSION IS ASSUMED TO BE 3 1/2" UNLESS NOTED OTHERWISE. PROVIDE SOLID LUMBER BLOCKING FOR ALL WALL MOUNTED ITEMS.

SUBSTRATE (BACKER) FOR TILE IN SHOWERS/TUBS SHALL BE FIBER-CEMENT OR SIMILAR PER APPLICABLE CODE.

ALL INTERIOR COLORS AND FINISHES, NOT SPECIFIED HEREIN, TO BE SELECTED BY THE OWNER.

CONTRACTOR OR EXCAVATOR MUST CONTACT THE APPROPRIATE UTILITIES PROTECTION SERVICE AT LEAST 48 HOURS BUT NO MORE THAN 10 WORKING DAYS BEFORE BEGINNING ANY DIGGING PROJECT.

SOILS BEARING PRESSURE AS INDICATED ON THE STRUCTURAL ENGINEERING PLANS BY OTHER.

3 CONCRETE

REFER TO STRUCTURAL ENGINEERING PLANS BY OTHER.

SEE OWNER SCOPE OF WORK DOCUMENTS FOR ADDITIONAL REQUIREMENTS.

4 MASONRY

STONE /ENEER IF USED) TO BE MANUFACTURED STONE - REFER TO OWNERS SCOPE OF WORK DOCUMENT FOR MATERIAL SELECTION AND COLORS.

BRICK ACCENTS (IF USED) TO BE FULL SIZE UNITS, CUT TO THICKNESS OR SHAPE REQUIRED FOR THE SPECIFIC USE. REFER TO THE OWNERS SCOPE OF WORK DOCUMENT FOR MATERIAL SELECTION AND COLORS.

5 METALS

REFER TO STRUCTURAL ENGINEERING PLANS BY OTHER.

6 WOOD & PLASTICS

PROVIDE SOLID BLOCKING FOR ALL WALL MOUNTED ITEMS INCLUDING:

CABINETS & SHELVES

CLOSET RODS

• MIRRORS AND BATH ACCESSORIES

FRAMING LUMBER IN CONTACT WITH CONCRETE OR MASONRY OR EXPOSED TO THE EXTERIOR SHALL BE PRESERVATIVE PRESSURE TREATED. ANY WOOD, INCLUDING EXTERIOR SHEATHING. WITHIN 6" OF FINISHED GRADE SHALL BE PRESERVATIVE-PRESSURE TREATED.

ANY WOOD, INCLUDING EXTERIOR WALL SHEATHING, LESS THAN 2" VERTICALLY FROM CONCRETE STEPS, PORCH SLABS, PATIO SLABS AND SIMILAR HARD HORIZONTAL SURFACES SHALL BE PRESERVATIVE PRESSURE TREATED.

PROTECTION OF WOOD AND WOOD-BASED PRODUCTS AGAINST DECAY AS REQUIRED BY R317. PROTECTION AGAINST TERMITES AS REQUIRED BY R318.

FIRE BLOCKING TO COMPLY WITH R302.11.

REFER TO STRUCTURAL ENGINEERING PLANS BY OTHER.

CABINETS AND COUNTERTOPS

REFER TO OWNERS SCOPE OF WORK DOCUMENTS FOR CABINET, COUNTERTOP AND HARDWARE

INTERIOR TRIM

OF REFER TO OWNERS SCOPE OF WORK DOCUMENTS FOR REQUIRED INTERIOR TRIM PROFILES.

7 THERMAL & MOISTURE PROTECTION

WATER BARRIER THE WATER BARRIER SYSTEM IS AN INTEGRAL PART OF THE WALL SHEATHING

THERMAL INSULATION

• INSULATION TO HAVE THE FOLLOWING MINIMUM R-VALUES:

• EXTERIOR WALLS R=15 MIN.

• SLOPED CEILINGS (WITH ATTIC SPACE) R=38 OR R=30 WHEREVER THE FULL HEIGHT OF UNCOMPRESSED R=38 INSULATION EXTENDS OVER THE WALL TOP PLATE AT THE EAVES. • SLOPED CEILINGS (WITHOUT ATTIC SPACE) R=38 MIN., OR R=30 MIN. WHERE THERE IS NOT SUFFICIENT SPACE FOR REQ'D INSULATION.

• FLAT CEILINGS (WITH ATTIC SPACE) R=38 OR R=30 WHEREVER THE FULL HEIGHT OF UNCOMPRESSED R=38 INSULATION EXTENDS OVER THE WALL TOP PLATE AT THE EAVES.

• REFER TO OWNERS SCOPE OF WORK DOCUMENTS FOR INSULATION TYPES AND ADDITIONAL REQUIREMENTS.

ARCHITECTURAL SHINGLE ROOFING - SHINGLE ROOFING SHALL BE DIMENSIONAL ASPHALT TYPE WITH DIMENSION FEATURES. SEE OWNERS SCOPE OF WORK DOCUMENTS FOR MANUFACTURER, STYLE, COLOR AND ADDITIONAL REQUIREMENTS FOR INSTALLATION AND ACCESSORIES. • SHINGLES SHALL BE TESTED IN ACCORDANCE WITH AST D 7185.

• SHINGLES SHALL MEET THE CLASSIFICATION REQUIREMENTS FOR THE APPROPRIATE MAXIMUM BASIC WIND SPEED:

MAXIMUM BASIC WIND SPEED CLASSIFICATION REQUIREMENT • REFER TO STRUCTURAL ENGINEERING PLANS BY OTHER.

• ROOFING SHALL BE INSTALLED OVER ONE LAYER OF ASPHALT IMPREGNATED 15# ROOFING FELT. 2 LAYERS FOR ROOF PITCHES 2:12 - 4:12.

VALLEY LININGS TO BE INSTALLED PER R905.2.8.2

GUTTERS TO BE MINIMUM 5" ALUMINUM OGEE STYLE WITH 4" CORRUGATED RECTANGULAR ALUMINUM DOWNSPOUTS AT LOCATIONS AS INDICATED ON THE DRAWINGS.

DOWNSPOUTS TO BE CONNECTED TO UNDERGROUND STORM PIPING AND ROUTED TO DISCHARGE LOCATIONS AS SPECIFIED BY THE GENERAL CONTRACTOR. 12" WIDE (2" THICKNESS) RIGID FOAM LOCATED AT TOP OF FOOTER, SLOPING AWAY FROM THE UNIT TO PREVENT CONCRETE OVERFLOW AND ALLOW PIPE TO TIGHTLY FIT TO STEM WALL.

UNDERGROUND DRAINPIPES TO BE PROVIDED AT ALL COURTYARD SLAB CUTOUT LANDSCAPE AREAS TO PREVENT POOLING WATER.

LAP SIDING - REFER TO OWNERS SCOPE OF WORK DOCUMENTS FOR MATERIAL, MANUFACTURER. STYLE, COLOR AND OTHER REQUIREMENTS.

EXTERIOR TRIM & SOFFITS - REFER TO OWNERS SCOPE OF WORK DOCUMENTS FOR MATERIAL, MANUFACTURER, STYLE, COLOR AND OTHER REQUIREMENTS.

PROVIDE EXTERIOR TRIM OF SIZES INDICATED ON THE DRAWINGS.

8 DOORS & WINDOWS

EXTERIOR PATIO DOORS AND SLIDING PATIO DOORS - REFER TO OWNERS SCOPE OF WORK DOCUMENTS FOR MANUFACTURER, STYLE COLOR AND HARDWARE SELECTIONS. SIZES AS INDICATED ON THE DRAWINGS

• ALL DOORS TO HAVE LOW-E GLASS SAFETY GLAZING.

INTERIOR DOORS - REFER TO OWNERS SCOPE OF WORK DOCUMENTS FOR DOOR TYPE, STYLE AND HARDWARE SELECTIONS.

SIZES AS INDICATED ON THE DRAWINGS.

WINDOWS - REFER TO OWNERS SCOPE OF WORK DOCUMENTS FOR WINDOW MANUFACTURER, STYLE, COLOR AND HARDWARE SELECTIONS.

SIZES AS INDICATED ON THE DRAWINGS.

• ALL WINDOWS TO HAVE LOW-E INSULATING GLASS

• WINDOW MANUFACTURER SHALL PROVIDE TEMPERED GLASS AS REQUIRED BY R308.4 AT ALL HAZARDOUS LOCATIONS.

• WINDOW FALL PROTECTION AS REQUIRED BY R312.2.

• WRITTEN INSTALLATION INSTRUCTIONS SHALL BE PROVIDED BY THE WINDOW MANUFACTURER

FOR EACH WINDOW - SEE FULL INSTRUCTIONS FOR ALL ADDITIONAL REQUIREMENTS. ALL BEDROOM WINDOWS TO MEET EMERGENCY RESCUE OPENING CODE REQUIREMENTS. • WINDOW TRIM TO BE OFFSET MIN. 1/4" WHERE WINDOW MEETS TRIM FOR CAULKING. COORDINATE

WITH WINDOW SELECTION, PAD OUT THE TRIM IF NEEDED. • TRIM MATERIAL PER OWNERS SCOPE OF WORK DOCUMENTS. SIZES AS INDICATED ON THE DRAWINGS.

• SEE CURRENT BUILDING CODE FOR ALL ADDITIONAL REQUIREMENTS.

9 FINISHES

TILE FINISH.

DRYWALL WALLS AND CEILINGS- REFER TO OWNERS SCOPE OF WORK DOCUMENTS FOR REQUIRED DRYWALL FINISHES.

• PROVIDE TYPE-X GYPSUM PANELS AT LOCATIONS INDICATED ON THE DRAWINGS FOR FIRE-RATED ASSEMBLIES.

• ALL BATHROOMS TO HAVE MOISTURE-RESISTANT, PAPERLESS GYPSUM. • PROVIDE 1/2" TILE BACKER BOARD IN LIEU OF DRYWALL AT ALL WALL LOCATIONS REQUIRING A

INTERIOR FINISHES - REFER TO OWNERS SCOPE OF WORK DOCUMENTS FOR ALL INTERIOR FLOOR, WALL AND CEILING FINISHES.

10 SPECIALTIES

BATH ACCESSORIES - REFER TO OWNERS SCOPE OF WORK DOCUMENTS FOR REQUIRED BATH

FIREPLACE - REFER TO OWNERS SCOPE OF WORK DOCUMENTS FOR FIREPLACE REQUIREMENT AND SELECTIONS.

CLOSET ROODS AND SHELVING - REFER TO OWNERS SCOPE OF WORK DOCUMENTS FOR REQUIREMENTS AND SELECTIONS.

11 EQUIPMENT

APPLIANCES - REFER TO OWNERS SCOPE OF WORK DOCUMENTS FOR APPLIANCE SELECTIONS.

12 FURNISHINGS SECTION NOT USED

13 SPECIAL CONSTRUCTION SECTION NOT USED

14 CONVEYING SYSTEMS

SECTION NOT USED

22 PLUMBING

REFER TO PLUMBING PLANS BY OTHERS.

REFER TO HVAC PLANS BY OTHERS.

26 ELECTRICAL

REFER TO ELECTRICAL PLANS BY OTHERS.

Ш

New Home Inc 1611 Jones Franklin, Raleigh, NC, 27606

DATE									
DESCRIPTION									
REV.#	1	7	8	V	†	9	9	7	8

DRAWN BY: JJ/DREW

Specifications

and

eneral

HANDING: **RIGHT** ISSUE DATE: 8/19/2025


SHEET

(c) 2025 New Home Inc

GENERAL FLOOR PLAN NOTES:

General Floor Plan Notes shall apply unless noted otherwise on plan.

- 1. Wall Heights: Typically 9'-1 1/2" at first floor and second floor, and 9'-1 1/2" at attics U.N.O. All walls are constructed using a double top plate. Splices at Double Top Plate do not need to occur at Vertical Studs but must be at least 24" apart from Joint in other Top Plate layer. Special wall heights are noted on plans where they occur.
- 2. Wall Thickness is typically 3 1/2". 2x6 frame shall be used at walls that back up to plumbing fixtures. Walls greater than 10' high shall be framed with 2x6 framing or greater and will be noted as a special condition where it occurs on plan.
- 3. Typical header height shall be 7'-8" AFF at First Floor, and 7'-4" AFF at Second Floor U.N.O.
- 4. Jacks: Openings up to 3'-4" wide shall have (1) 2x4 jack stud SPF on each side. Openings greater than 3'-4" wide shall have (2) 2x4 jack studs SPF on each
- 5. Soffits, Coffered Ceilings, Trey Ceilings and other significant ceiling plan elements are shown on the floor plans and are denoted as single dashed lines. Unless specifically call out as included, Kitchens include soffits over wall cabinetry.
- 6. Door & Window Frames, where occurring near corners, shall be a minimum of 4 1/2" from corner. Except for walk-in closets with doors near a corner, doors at closets shall be centered on closet.
- 7. Windows: Shall have at least (1) window in each sleeping room, that meets egress. Shall be provided with tempered glass at hazardous glazing areas. False windows shall be installed with obscure
- 8. Closets for clothing or coat storage shall be equipped with 1 rod/shelf. Closets for linen shall have 4 open equal shelves. Closets for pantries shall have 4 equal wood shelves, painted.
- 9. Stair treads shall be a min of 9" deep, risers shall be a maximum of 8 1/4", unless noted otherwise, per the current North Carolina Residential Code.
- 10. Handrails and Guards at stairs shall be 34" above the finished surface of the ramp surface of the stair. Handrails at landings and overlooks of multilevel spaces shall be 36" above finished floor. Guards (pickets or balusters) shall be spaced with no more than 4" between guards.
- 11. Attic Access shall be provided at all attic area with a height greater than 30". Minimum clear attic access shall be 20" x 30". Pull down stairs and access doors in knee walls meeting minimum criteria are also acceptable.
- 12. Garage Door to Living Space shall be 2'-8" x 6'-8" minimum size and shall be 20 minute fire rated and weather sealed.
- 13. Garage Walls, as a minimum, shall be separated from living space by installing 1/2" gypsum board on the garage side of the wall. With habitable space above, the inside of all garage walls require 1/2" GWB supporting 5/8" type X GWB on ceiling.

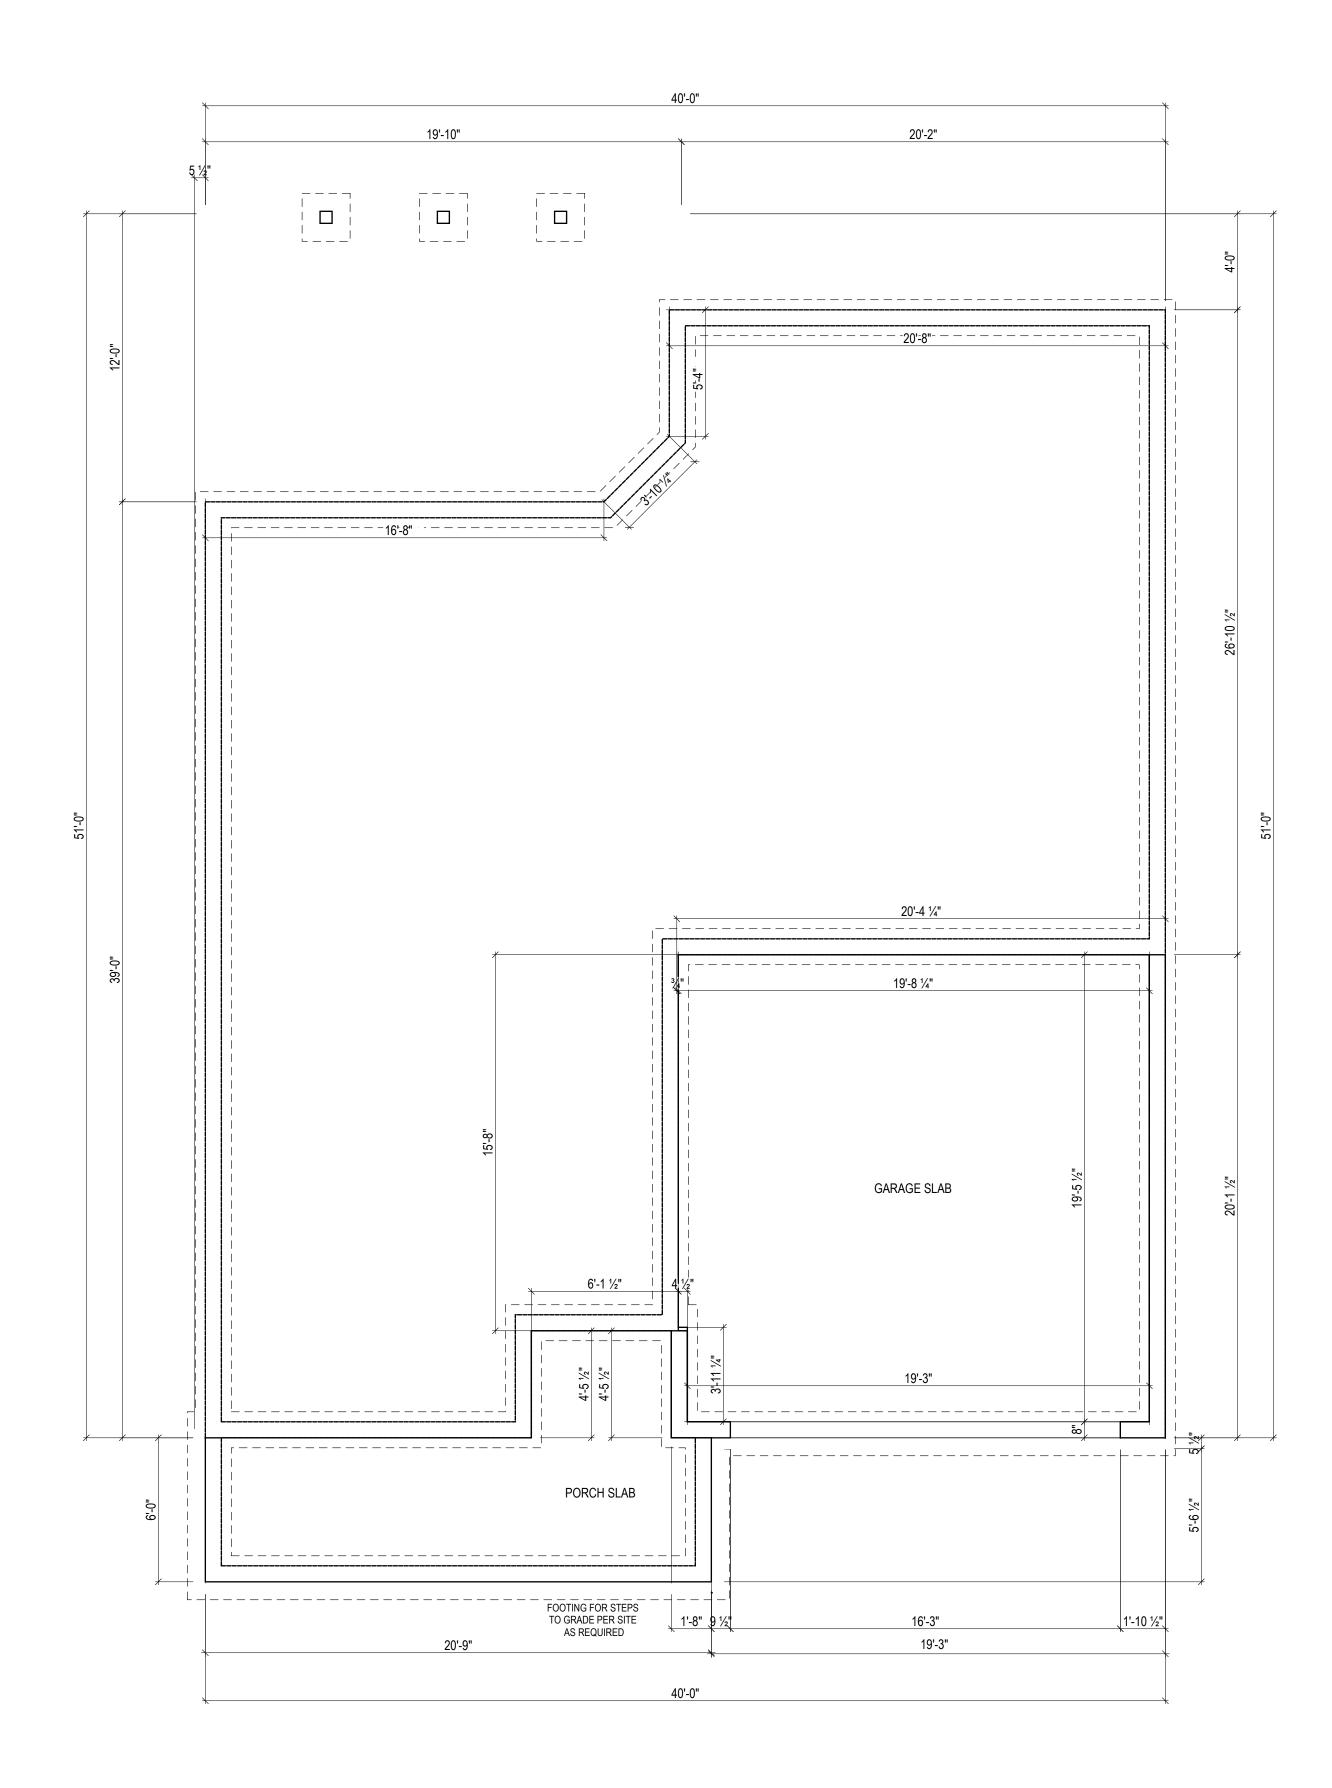

FOUNDATION PLAN - Crawlspace

1/4" = 1'-0" (WHEN PRINTED ON 22x34)

1/8" = 1'-0" (WHEN PRINTED ON 11x17)

DATE										
DESCRIPTION										
REV.#	-	2	3	-	†	5	9	7	8	

Country at Duncans **FOUNDATION PLAN**


JJ/DREW

8/19/2025

GENERAL FLOOR PLAN NOTES:

General Floor Plan Notes shall apply unless noted otherwise on plan.

- 1. Wall Heights: Typically 9'-1 1/2" at first floor and second floor, and 9'-1 1/2" at attics U.N.O. All walls are constructed using a double top plate. Splices at Double Top Plate do not need to occur at Vertical Studs but must be at least 24" apart from Joint in other Top Plate layer. Special wall heights are noted on plans where they occur.
- 2. Wall Thickness is typically 3 1/2". 2x6 frame shall be used at walls that back up to plumbing fixtures. Walls greater than 10' high shall be framed with 2x6 framing or greater and will be noted as a special condition where it occurs on plan.
- 3. Typical header height shall be 7'-8" AFF at First Floor, and 7'-4" AFF at Second Floor U.N.O.
- 4. Jacks: Openings up to 3'-4" wide shall have (1) 2x4 jack stud SPF on each side. Openings greater than 3'-4" wide shall have (2) 2x4 jack studs SPF on each side.
- Soffits, Coffered Ceilings, Trey Ceilings and other significant ceiling plan elements are shown on the floor plans and are denoted as single dashed lines. Unless specifically call out as included, Kitchens include soffits over wall cabinetry.
- Door & Window Frames, where occurring near corners, shall be a minimum of 4 1/2" from corner. Except for walk-in closets with doors near a corner, doors at closets shall be centered on closet.
- 7. Windows: Shall have at least (1) window in each sleeping room, that meets egress. Shall be provided with tempered glass at hazardous glazing areas. False windows shall be installed with obscure glazing.
- 8. Closets for clothing or coat storage shall be equipped with 1 rod/shelf. Closets for linen shall have 4 open equal shelves. Closets for pantries shall have 4 equal wood shelves, painted.
- 9. Stair treads shall be a min of 9" deep, risers shall be a maximum of 8 1/4", unless noted otherwise, per the current North Carolina Residential Code.
- 10. Handrails and Guards at stairs shall be 34" above the finished surface of the ramp surface of the stair. Handrails at landings and overlooks of multilevel spaces shall be 36" above finished floor. Guards (pickets or balusters) shall be spaced with no more than 4" between guards.
- 11. Attic Access shall be provided at all attic area with a height greater than 30". Minimum clear attic access shall be 20" x 30". Pull down stairs and access doors in knee walls meeting minimum criteria are also acceptable.
- 12. Garage Door to Living Space shall be 2'-8" x 6'-8" minimum size and shall be 20 minute fire rated and weather sealed.
- 13. Garage Walls, as a minimum, shall be separated from living space by installing 1/2" gypsum board on the garage side of the wall. With habitable space above, the inside of all garage walls require 1/2" GWB supporting 5/8" type X GWB on ceiling.

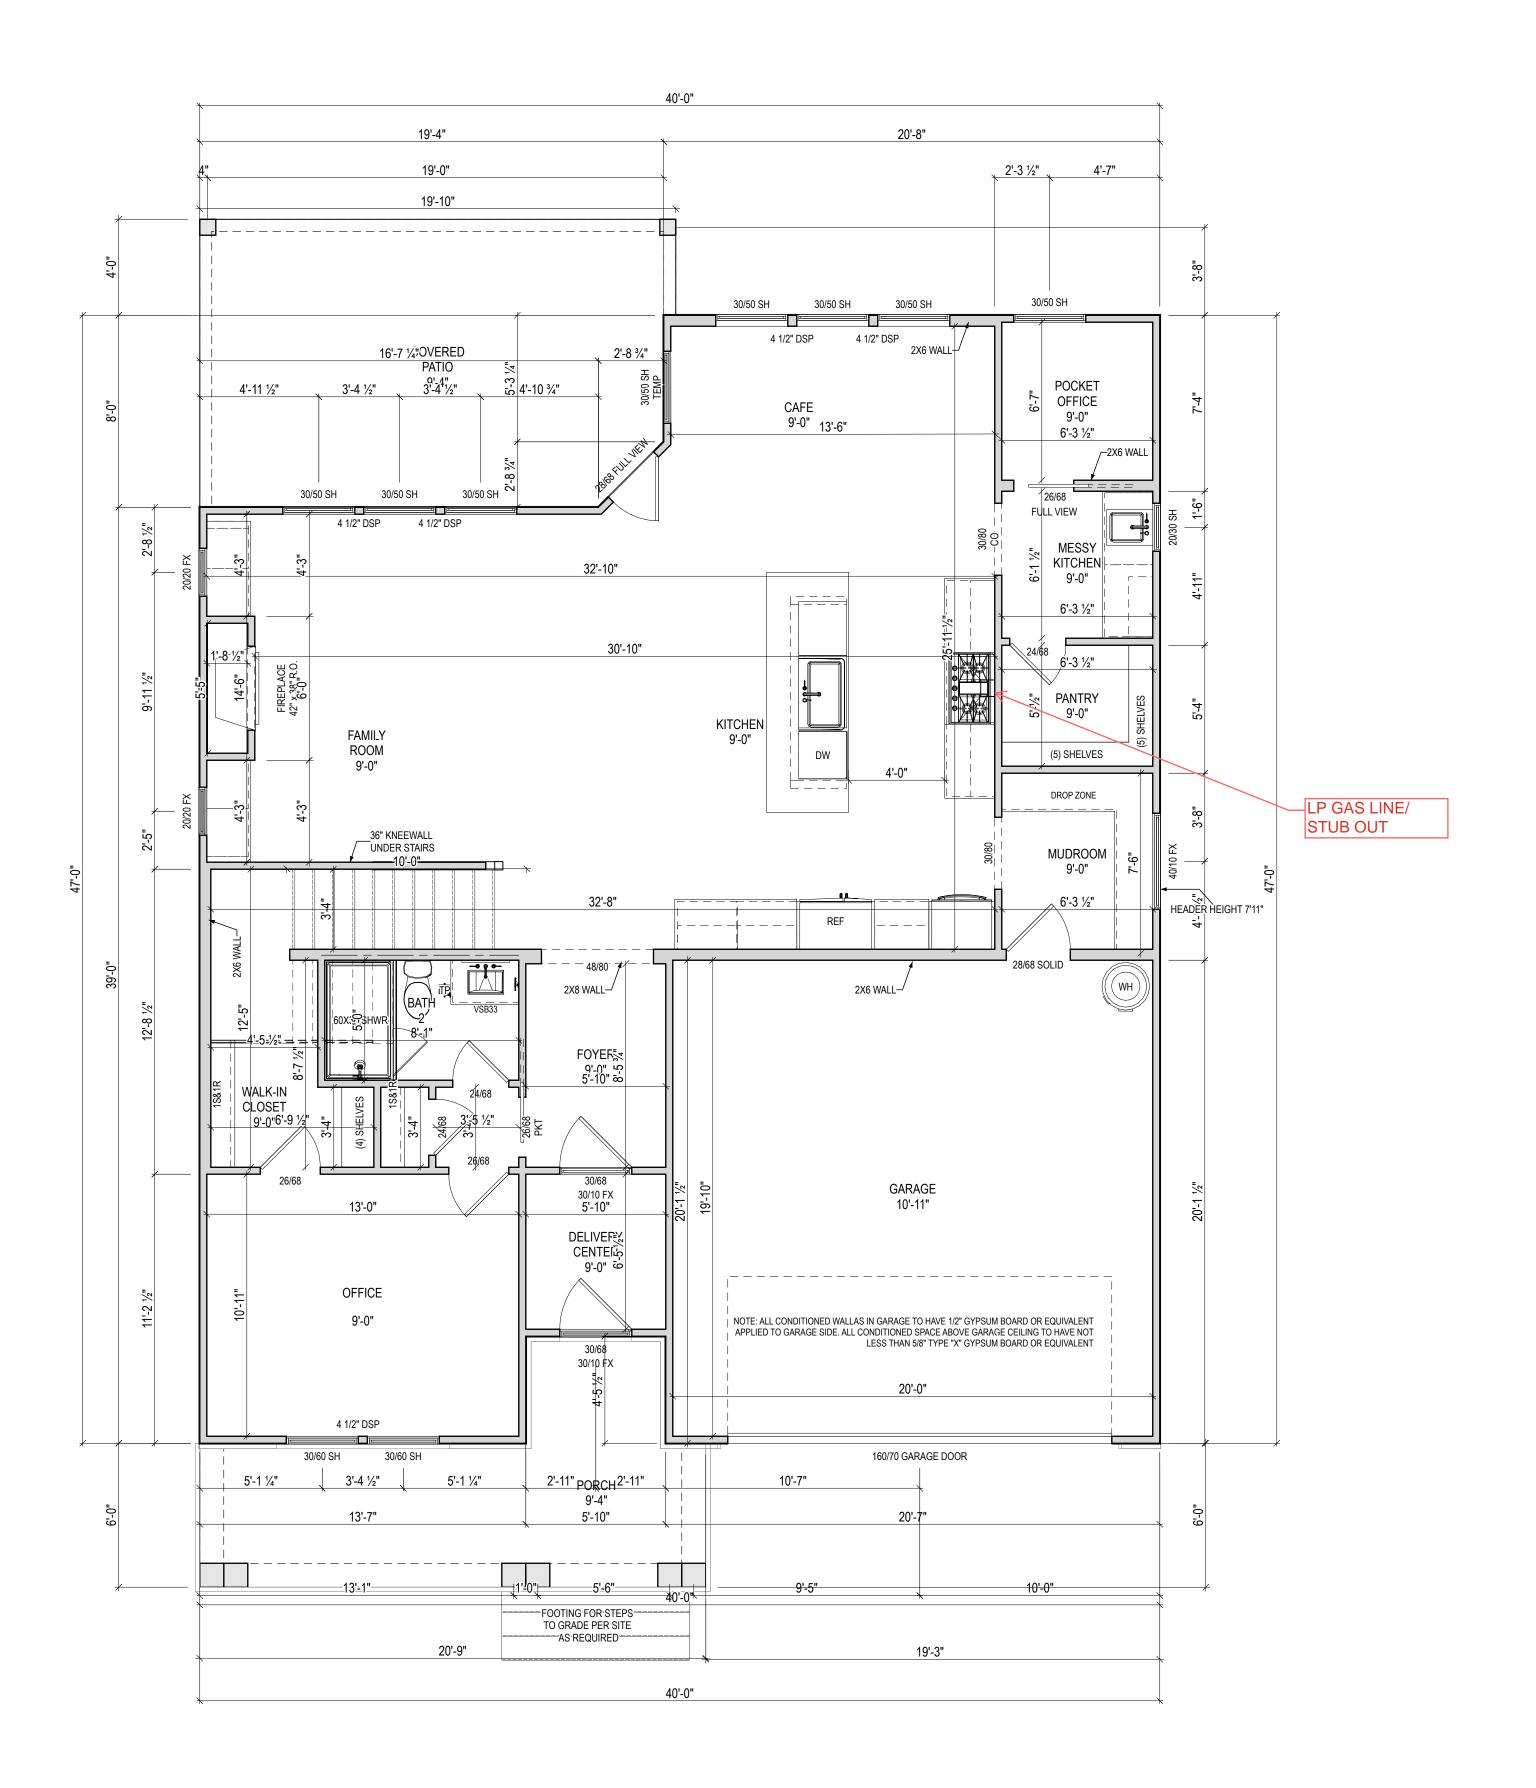

First Floor Plan

1/4" = 1'-0" (WHEN PRINTED ON 22x34) 1/8" = 1'-0" (WHEN PRINTED ON 11x17)

A-110

JJ/DREW

RIGHT

8/19/2025

Creek

English Country at Duncans

New Home Inc


1611 Jones Franklin,

Raleigh, NC, 27606

GENERAL FLOOR PLAN NOTES:


General Floor Plan Notes shall apply unless noted otherwise on plan.

- 1. Wall Heights: Typically 9'-1 1/2" at first floor and second floor, and 9'-1 1/2" at attics U.N.O. All walls are constructed using a double top plate. Splices at Double Top Plate do not need to occur at Vertical Studs but must be at least 24" apart from Joint in other Top Plate layer. Special wall heights are noted on plans where they occur.
- 2. Wall Thickness is typically 3 1/2". 2x6 frame shall be used at walls that back up to plumbing fixtures. Walls greater than 10' high shall be framed with 2x6 framing or greater and will be noted as a special condition where it occurs on plan.
- 3. Typical header height shall be 7'-8" AFF at First Floor, and 7'-4" AFF at Second Floor U.N.O.
- 4. Jacks: Openings up to 3'-4" wide shall have (1) 2x4 jack stud SPF on each side. Openings greater than 3'-4" wide shall have (2) 2x4 jack studs SPF on each
- Soffits, Coffered Ceilings, Trey Ceilings and other significant ceiling plan elements are shown on the floor plans and are denoted as single dashed lines. Unless specifically call out as included, Kitchens include soffits over wall cabinetry.
- Door & Window Frames, where occurring near corners, shall be a minimum of 4 1/2" from corner.
 Except for walk-in closets with doors near a corner, doors at closets shall be centered on closet.
- 7. Windows: Shall have at least (1) window in each sleeping room, that meets egress. Shall be provided with tempered glass at hazardous glazing areas. False windows shall be installed with obscure glazing.
- 8. Closets for clothing or coat storage shall be equipped with 1 rod/shelf. Closets for linen shall have 4 open equal shelves. Closets for pantries shall have 4 equal wood shelves, painted.
- 9. Stair treads shall be a min of 9" deep, risers shall be a maximum of 8 1/4", unless noted otherwise, per the current North Carolina Residential Code.
- 10. Handrails and Guards at stairs shall be 34" above the finished surface of the ramp surface of the stair. Handrails at landings and overlooks of multilevel spaces shall be 36" above finished floor. Guards (pickets or balusters) shall be spaced with no more than 4" between guards.
- 11. Attic Access shall be provided at all attic area with a height greater than 30". Minimum clear attic access shall be 20" x 30". Pull down stairs and access doors in knee walls meeting minimum criteria are also acceptable.
- 12. Garage Door to Living Space shall be 2'-8" x 6'-8" minimum size and shall be 20 minute fire rated and weather sealed.
- 13. Garage Walls, as a minimum, shall be separated from living space by installing 1/2" gypsum board on the garage side of the wall. With habitable space above, the inside of all garage walls require 1/2" GWB supporting 5/8" type X GWB on ceiling.

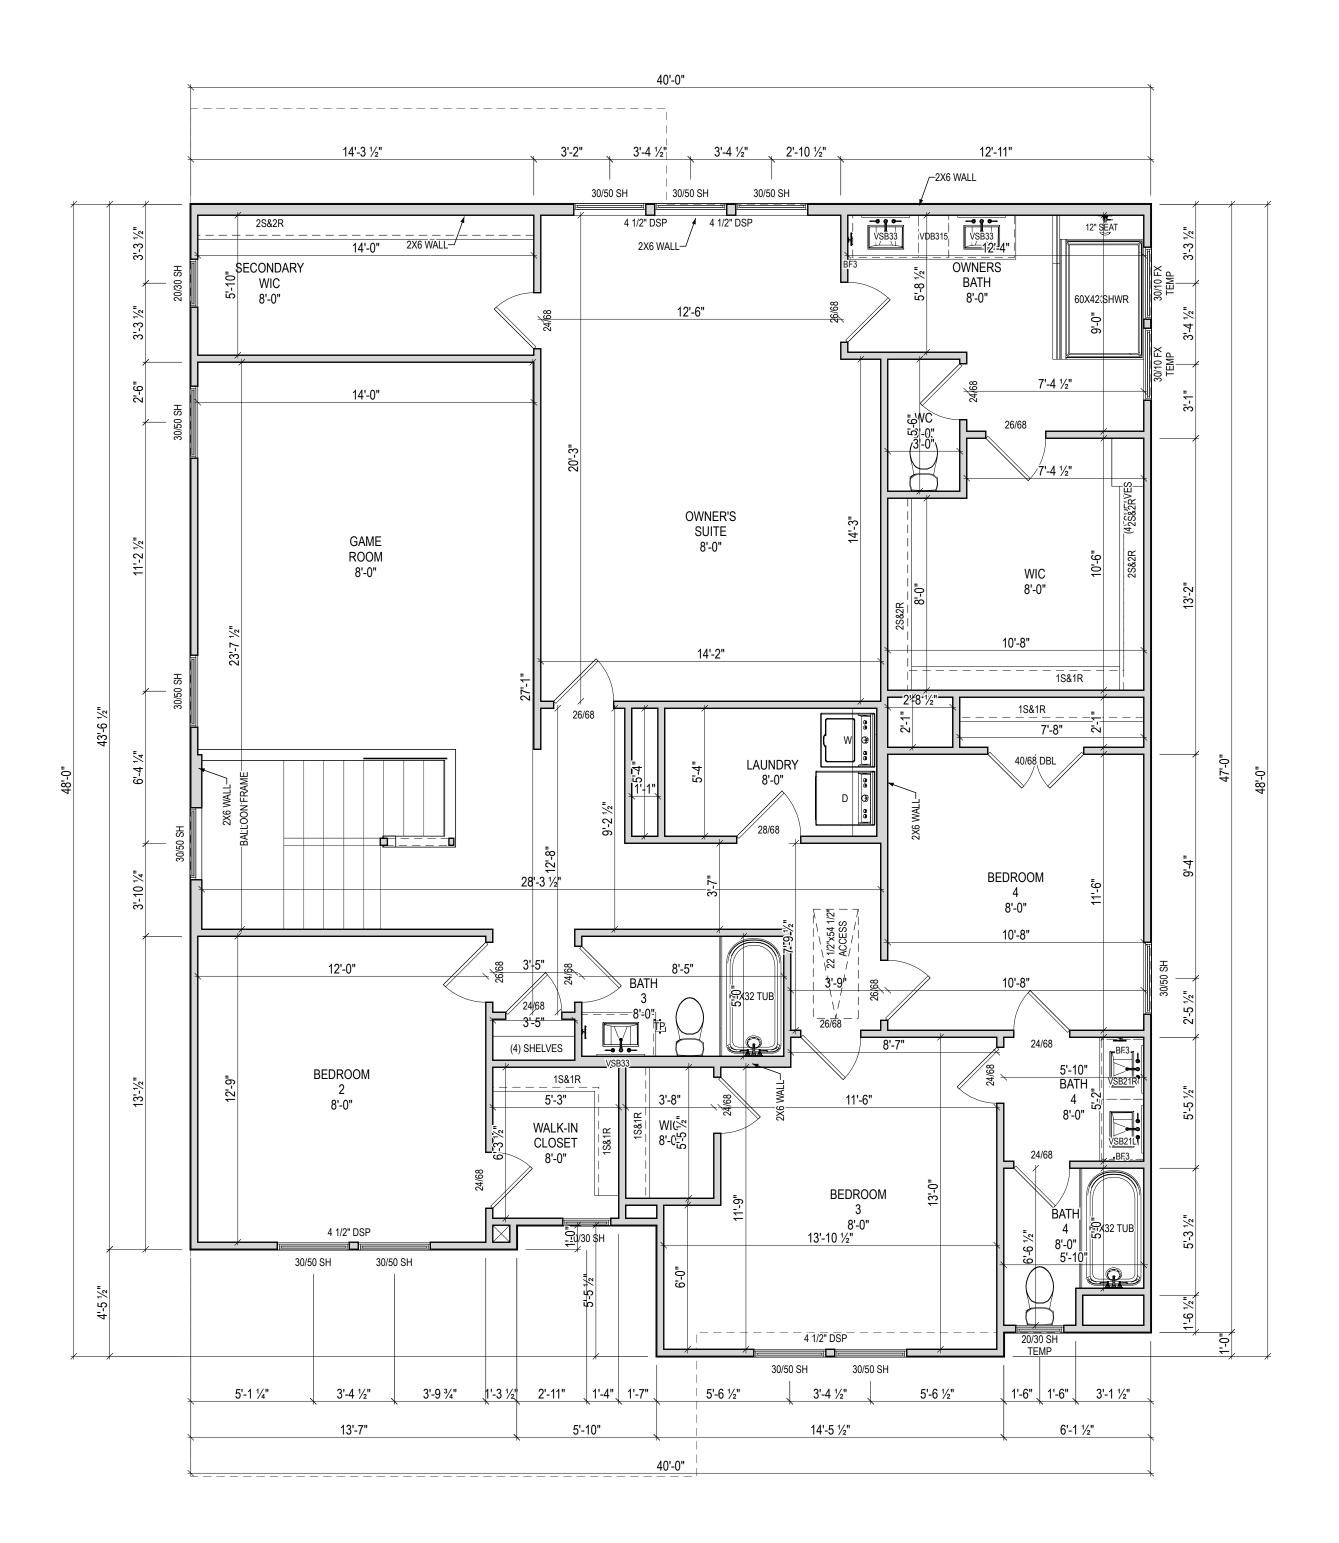

Second Floor Plan

1/4" = 1'-0" (WHEN PRINTED ON 22x34) 1/8" = 1'-0" (WHEN PRINTED ON 11x17)

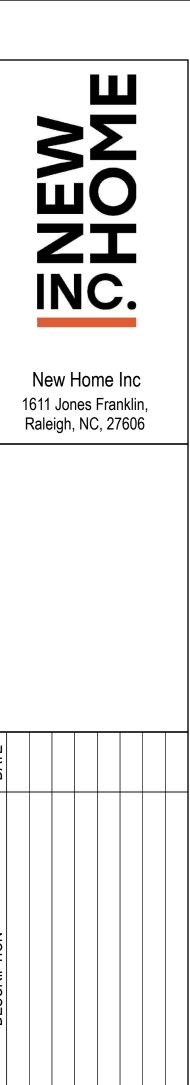

JJ/DREW

RIGHT

8/19/2025

Second Floor Plan

The Garner English Country at Duncans Creek

GENERAL ROOF PLAN NOTES:

1. ALL ROOF OVERHANGS TO BE 1'-0" UNLESS NOTED OTHERWISE


2. ALL TRAY CEILING TRAY HEIGHTS TO BE 12" UNLESS NOTED OTHERWISE

3. THESE PLANS ARE NOT TO BE SCALED FOR CONSTRUCTION PURPOSES.

4. IT IS THE CONTRACTOR'S RESPONSIBILITY TO VERIFY THE ACCURACY OF ALL DETAILS AND

DIMENSIONS.

5. 8'×16' ATTIC STORAGE
PLATFORM - PROVIDE 3/4" APA
RATED PLYWOOD SUB-FLOORING OR
OSB SHEATHING RATED FOR 20#/SF
ON BOTTOM CHORD OF TRUSSES.
TRUSS MANUFACTURER TO
ACCOUNT FOR ADDITIONAL LOADS

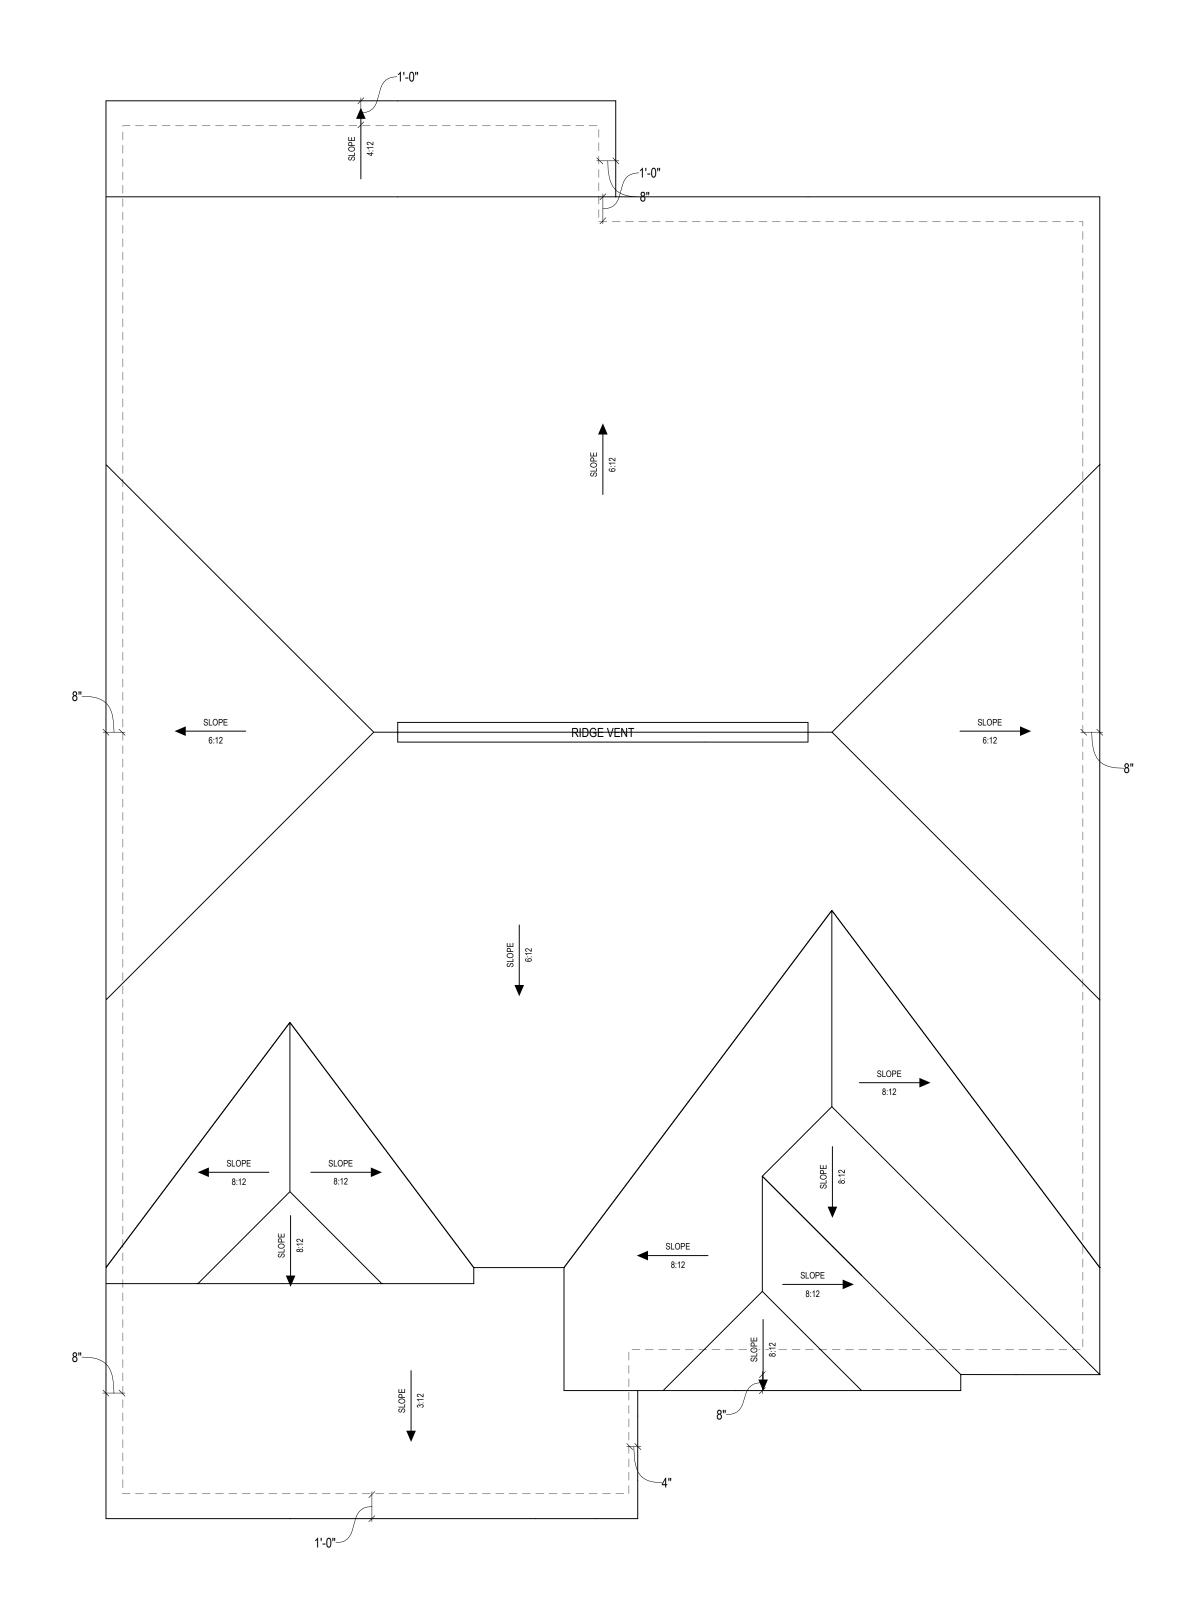

Roof Plan

1/4" = 1'-0" (WHEN PRINTED ON 22x34) 1/8" = 1'-0" (WHEN PRINTED ON 11x17)

A-200

JJ/DREW

ISSUE DATE: 8/19/2025

The Garner English Country at Duncans Creek

New Home Inc

1611 Jones Franklin,

Raleigh, NC, 27606

GENERAL ELEVATION NOTES:

General Elevation Notes shall apply unless noted otherwise on plan.

1. Roof shall be finished with architectural composition shingles with slopes as noted on plan.

Ridge Vent shall be provided and installed on all ridges greater than 6' in length per manufacturer's

3. Soffit Vent shall be continuous soffit vent.

specifications.

4. House Wrap, "tyvek" or approved equal shall be installed over entire exterior wall per manufacturer's specifications and recommendations.


5. Flashing shall be provided above all door and window openings, above finish wall material changes and at wall surfaces where lower roof areas abut vertical wall surfaces.

6. Porch Railings shall be provided at all porch walking surfaces greater than 30" above adjacent finished grade. It shall be 36" high with guards spaced no more than 4" apart. Consult community specifications for material.

7. Finish Wall Material shall be as noted on elevation drawings

8. Brick Veneer, if included on elevation shall be tied to wall surface with galvanized corrugated metal ties at a rate of 24" oc horizontally and 16" oc vertically so that no more than 2.67sf of brick is supported by (1) tie. Space between face of wall and back face of brick shall be limited to a maximum of 1". Flashing shall be provided behind brick above all wall openings and at base of brick wall. Flashing shall be a minimum of 6-mil poly or other corrosion resistant material and shall be installed so that it laps under the house wrap material a minimum of 2". Weepholes shall be provided at a rate of 48" oc and shall not be less than 3/16" in diameter and shall be located immediately above flashing.

9. Brick Veneer Support Lintels shall be provided if brick veneer is included on elevation. Lintels shall be provided as listed in the following schedule and shall have a minimum bearing length of 6". Masonry Lintels shall be provided so that deflection is limited

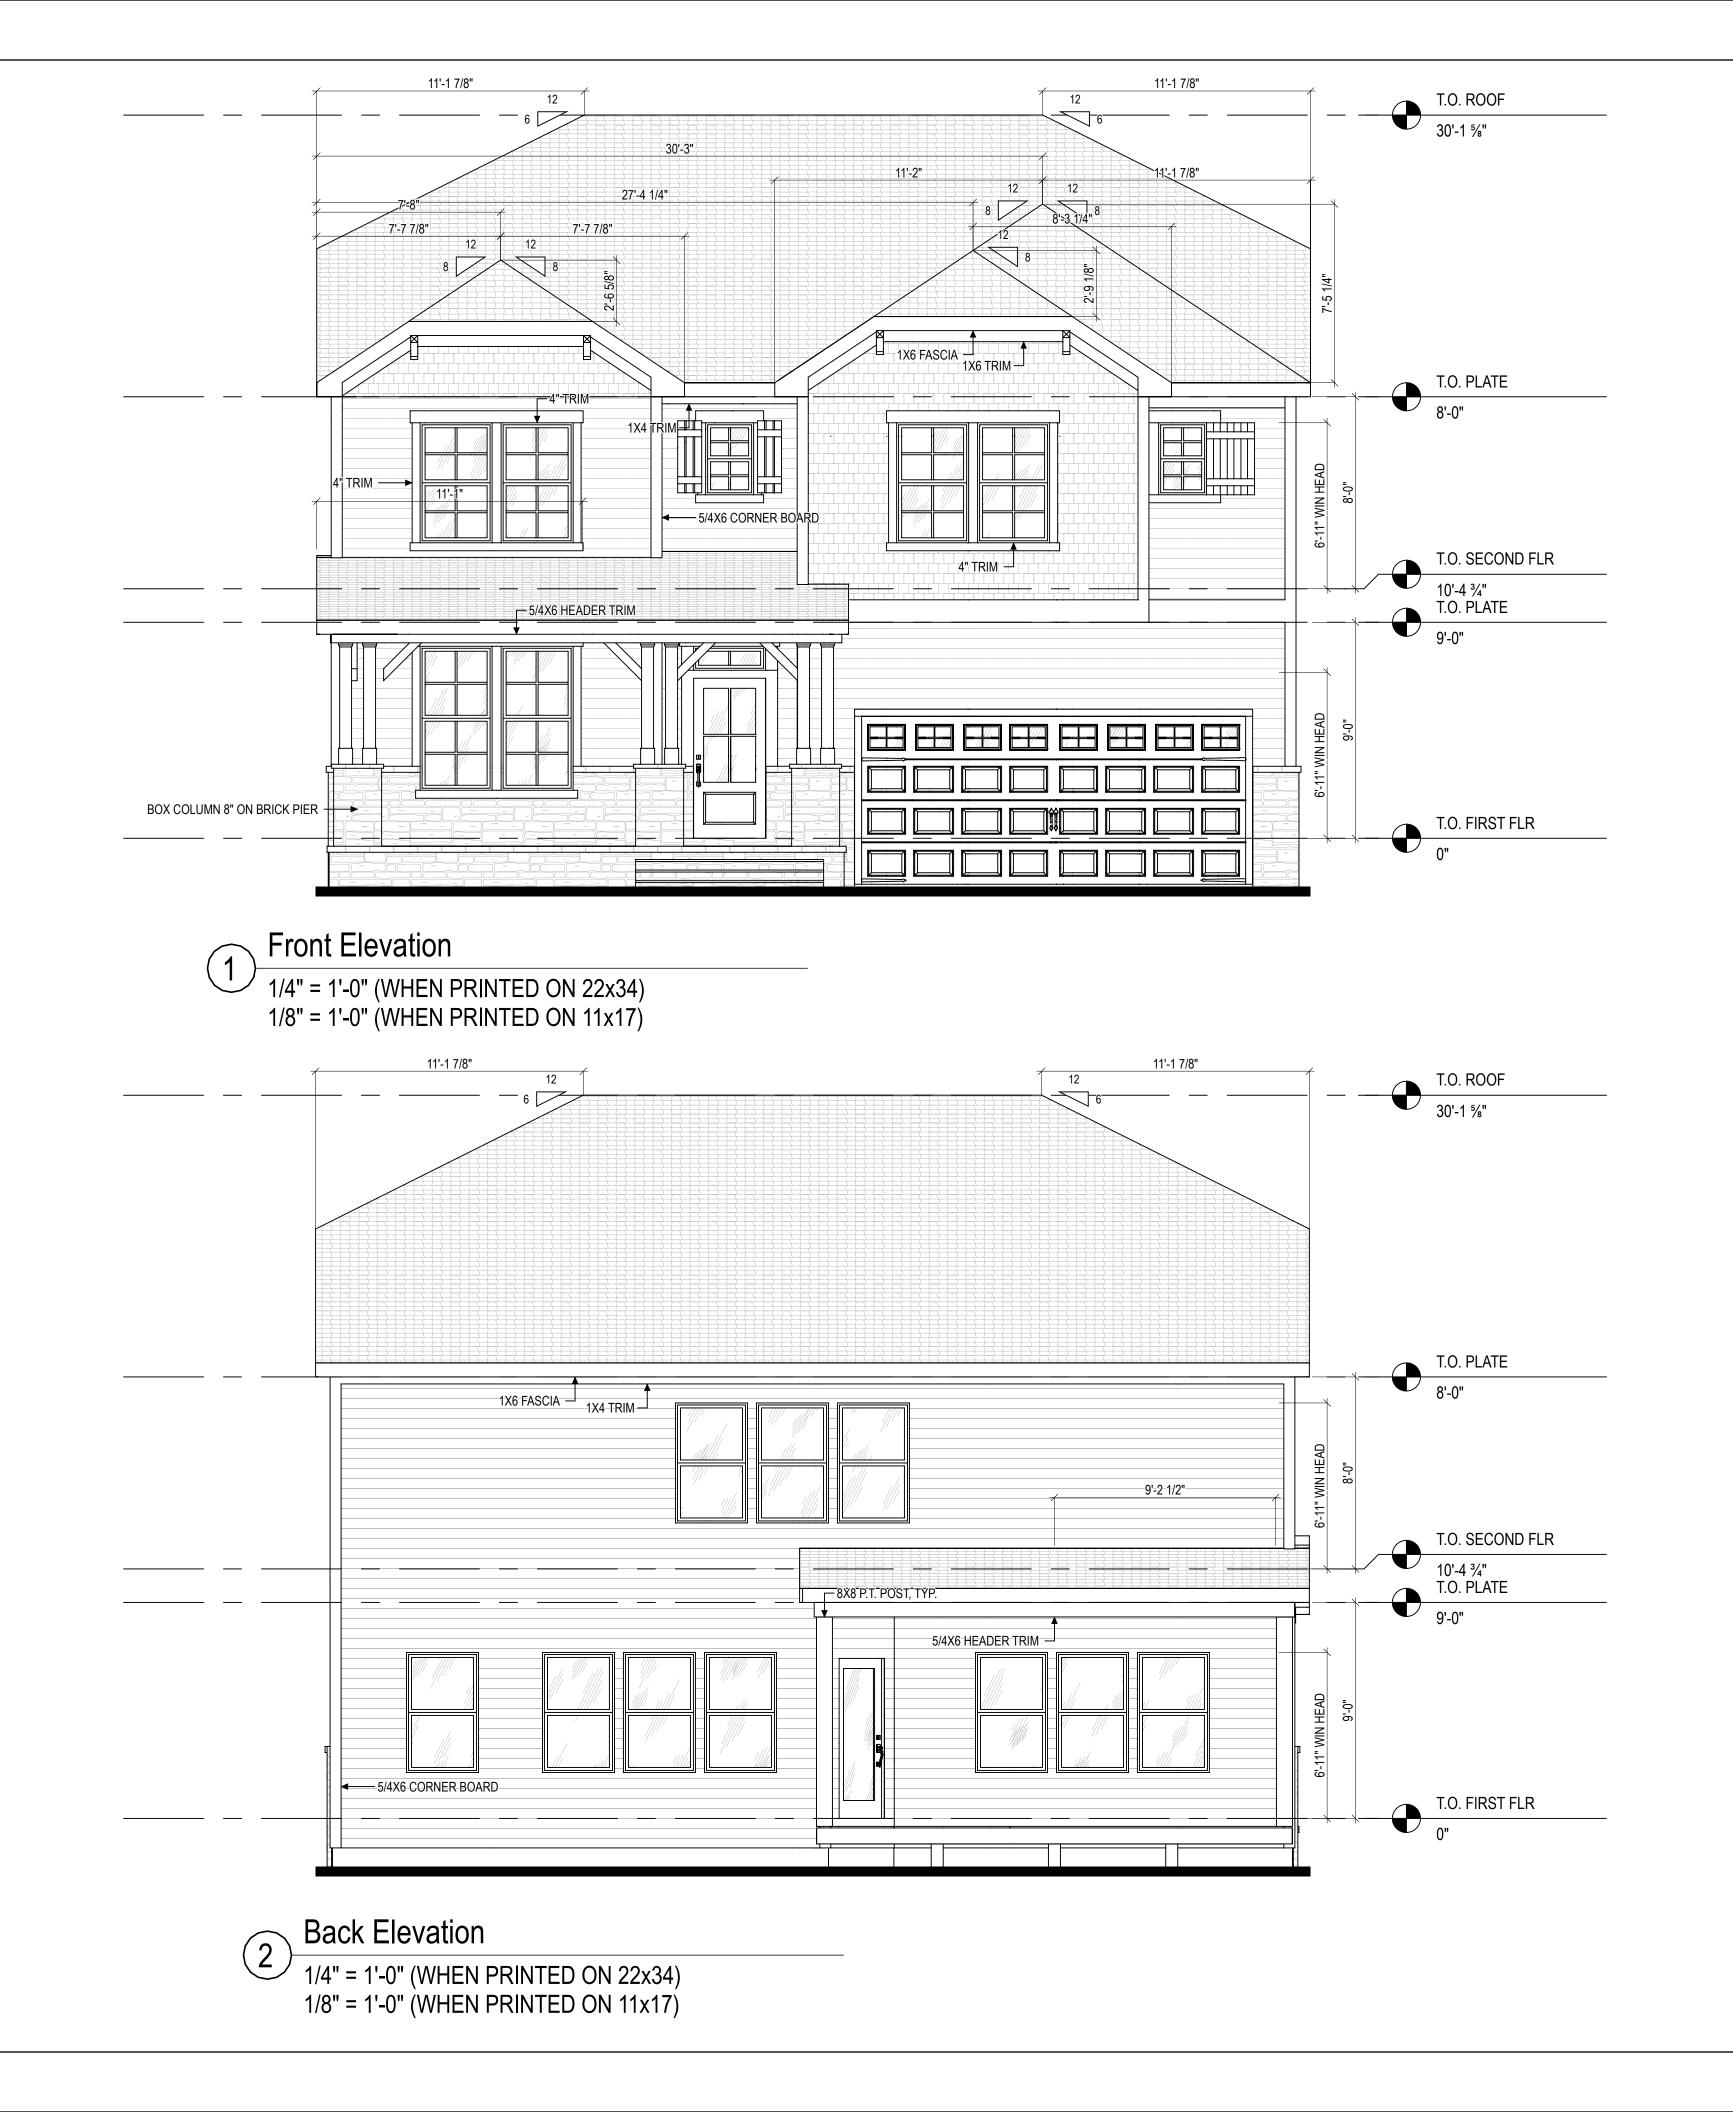

(c) 2025 New Home Inc

MOHIC.

New Home Inc 1611 Jones Franklin, Raleigh, NC, 27606

DATE				
DESCRIPTION				
#:				

Garner English Country at Duncans Creek

DRAWN BY:


JJ/DREW

RIGHT


ISSUE DATE:


8/19/2025

A-310

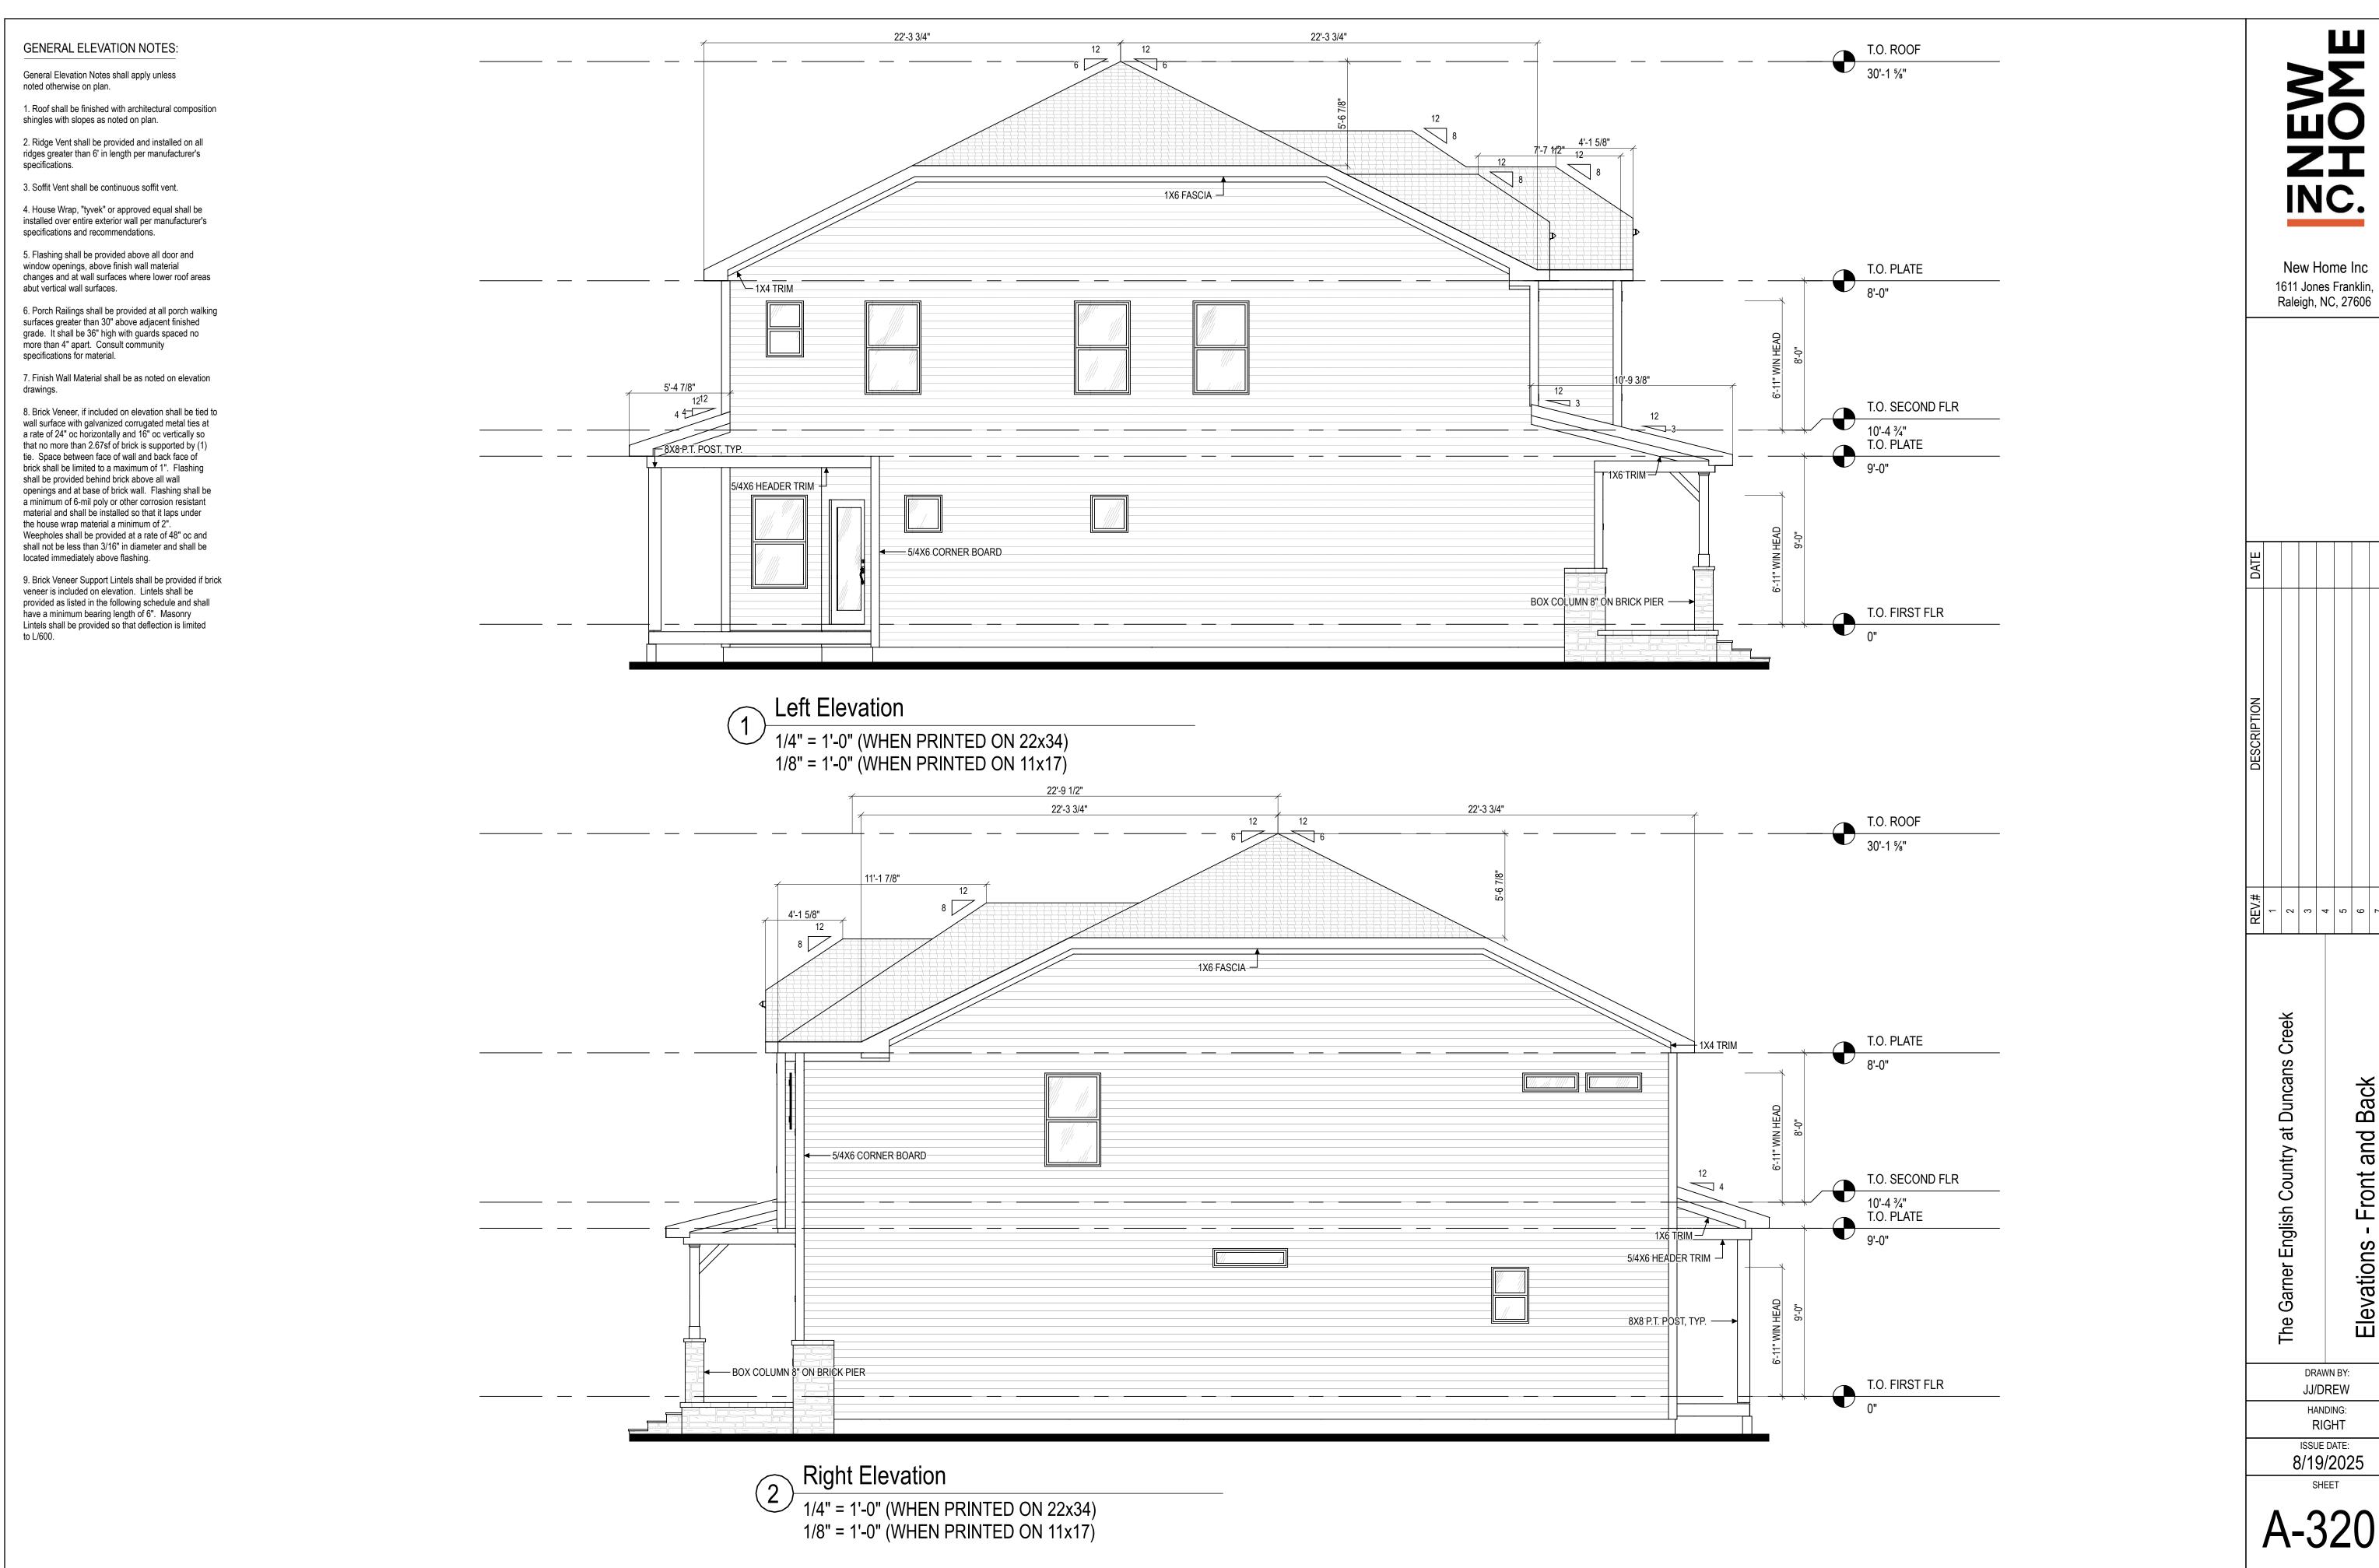



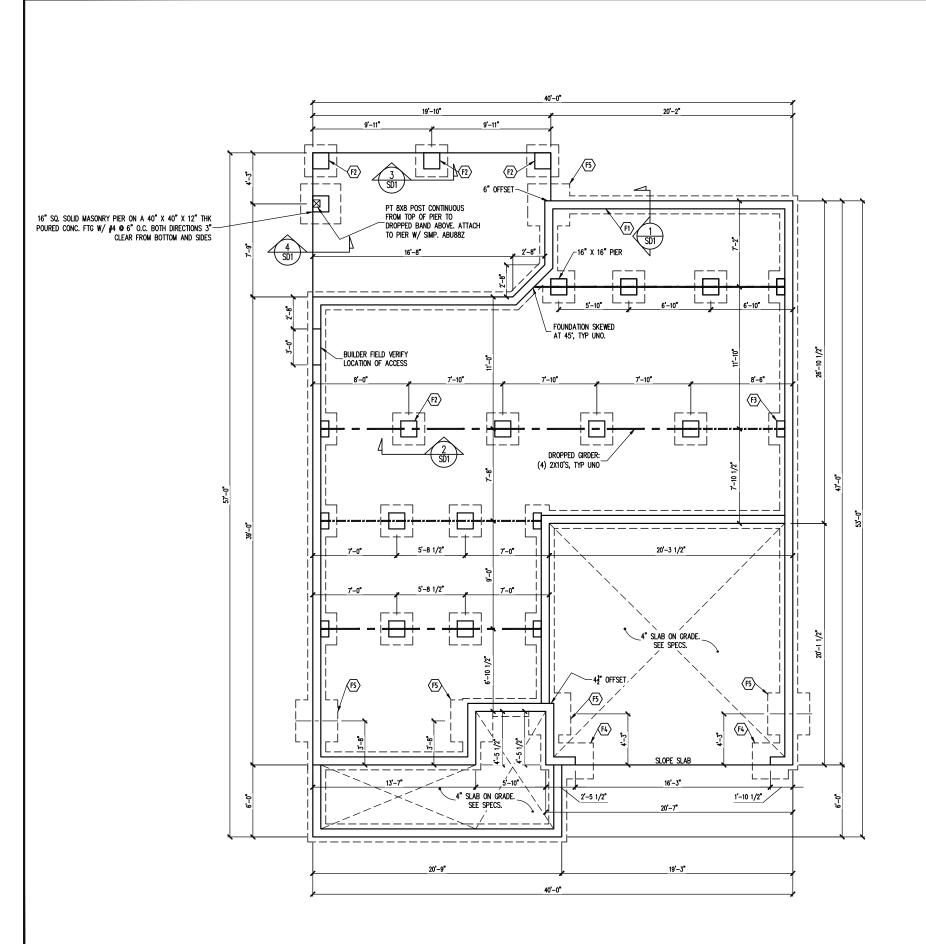

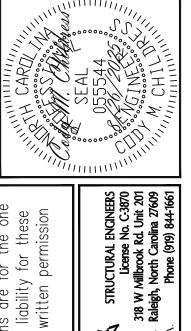

ngineering

FOUNDATION SCHEDULE

- ENLARGE FOOTING TO 42" SQ. X 12" THK. SOLID MASONRY ABOVE.

NOTES:

-HEIGHT AND BACKFILL LIMITATIONS FOR
FOUNDATION WALLS ARE TO BE GOVERNED
BY THE NCSBC, LATEST EDITION,
REINFORCEMENT AND GROUTING SHALL BE
DETERMINED BY FINAL SITE CONDITIONS.

-BUILDER TO FIELD LOCATE CRAWLSPACE ACCESS OPENING WITH MINIMUM DIMENSIONS OF 18X24. DO NOT LOCATE ACCESS OPENING BELOW POINT LOADS FROM ABOVE WITHOUT ENGINEER APPROVAL.

FOUNDATION PLAN

1/8" = 1'-0"

The structural design of

plans

25-29-006 SHEET NO. **S1** 1 of 8


PROJECT NO.

726 BEACON HILL ROAD ENGLISH COUNTRY

ELEVATION:

00

this plan is the property of Engineering Tech Associates, P.A. These plans are for the one and for the client listed. Engineering Tech Associates, P.A. assumes no liability for these iced, in whole or in part, for construction at any other location without written permission NEW HOME INC
STRUCTURAL ADDENDUM
TO A TO REV # REF PROJ # whole (s. P.A. they are reproduced, ENG: CMC/ZCH DATE: 8/26/2025 time use at the location **PLAN** THE GARNER

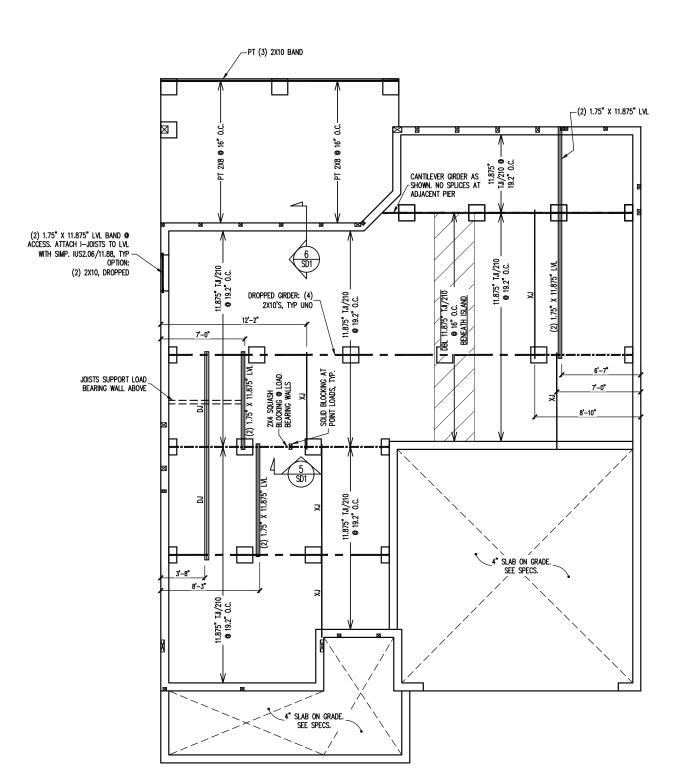

The structural design of this plan is the property of Engineering Tech Associates, P.A. These plans are for the one time use at the location and for the client listed. Engineering Tech Associates, P.A. assumes no liability for these plans if they are reproduced, in whole or in part, for construction at any other location without written permission whole is, P.A.

STRUCTURAL ADDENDUM

AND REV # REF PROJ # 726 BEACON HILL ROAD ENGLISH COUNTRY **ELEVATION:** LOC

ENG: CMC/ZCH

PLAN THE GARNER PROJECT NO. 25-29-006 SHEET NO. **S2**


2 of 8

Ingineering

C

STRUCTURAL ENCINEERS
License No. C-3870
318 W Millbrook Rd. Unit 201
Raleigh, North Carolina 27609
Phone (919) 844-1661

DATE: 8/26/2025 CRAWLSPACE FRAMING PLAN 1/8" = 1'-0"

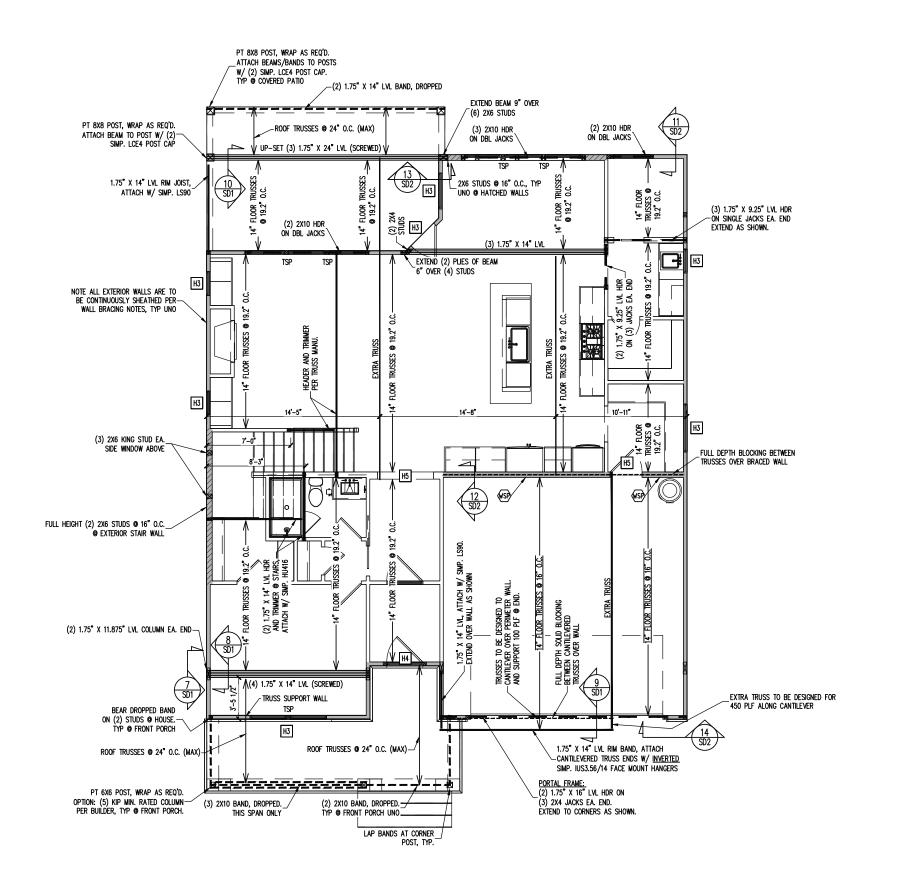

CONSTRUCTION SPECIFICATIONS INSTANT REFERENCES

for

are

plans

These

P.A.

Associates,

Tech

of

property

is the

plan

this

of

design

structural

Ihe

for

and

location

nse

0

whole P A

reproduced,

are the

they at

plans time

REFER TO THE CONSTRUCTION SPECIFICATIONS SECTIONS FOR THE FOLLOWING INFORMATION:

PART 1.01: CURRENT GOVERNING CODE

PART 14: STUD SUPPORT FOR BEAMS

PART 17: KING STUDS FOR EXTERIOR WALLS

SEE DETAIL / CONSTRUCTION SPECIFICATIONS
SHEETS FOR I—JOISTS ALLOWABLE SUBSTITUTIONS

WALL BRACING

SHADED WALLS:

ALL EXTERIOR STUD WALLS, EXTERIOR SIDE, ARE TO BE CONTINUOUSLY SHEATHED WITH 7/16 APA RATED OSB NAILED TO STUDS WITH 8d NAILS @ 6" O.C. AT PANEL EDGES, 12" O.C. IN PANEL FIELD.

WSP - ONE SIDE OF INTERIOR WALL OR INSIDE OF EXTERIOR WALL WITH 3/8" MIN. THICKNESS WOOD STRUCTURAL PANELING. ATTACH WSP TO STUD WALL WITH 8d NAILS @ 6" O.C. AT PANEL EDGES, 12" O.C. IN PANEL FIELD.

PROVIDED CONTINUOUS SHEATHING = 180' MIN.

REFERENCE PART 16.02 OF CONSTRUCTION SPECIFICATIONS FOR GENERAL WIND BRACING INFORMATION.

HEADER SCHEDULE

- H1 SINGLE 2X4 TURNED FLAT (A)
- H2 (2) 2X4'S ON SINGLE JACKS (B)
- H3 (2) 2X10'S ON SINGLE JACKS (C)
- H4 (2) 1.75" X 9.25" LVL'S ON DBL JACKS
- H5 (3) 2X10'S ON SINGLE JACKS
- (A) TYPICAL FOR INTERIOR NON LOAD BEARING WALLS ONLY, ROUGH OPENING 38" MAX.
- (B) TYPICAL FOR INTERIOR NON LOAD BEARING WALLS ONLY, ROUGH OPNG 38" TO 74" MAX.
- (C) TYPICAL FOR ALL CONDITIONS NOT LISTED IN (A) OR (B) UNO.

-HEADERS IN NON LOAD BEARING INTERIOR
WALLS ARE NOT LABELED.

1ST FLOOR FRAMING PLAN

WALLS AND CEILING 1/8" = 1'-0"

permission for liability written NO without assumes location ⋖ other Associates, any NEW HOME INC STRUCTURAL ADDENDUM at Engineering leci construction Engineering BEACON HILL ROAD COUNTRY for ENCLISH listed. part, 726 .⊆ the client

the one these

STRUCTURAL ENGINEERS
License No. C-3870
8 W Millbrook Rd. Unit 201
leigh, North Carolina 27609
Phone (919) 844-1661 318 W / Raleigh,

ELEVATIO

LOC:

ENG: CMC/ZCH

DATE: 8/26/2025

PLAN

THE GARNER


PROJECT NO.


25-29-006

SHEET NO.

S3

3 of 8

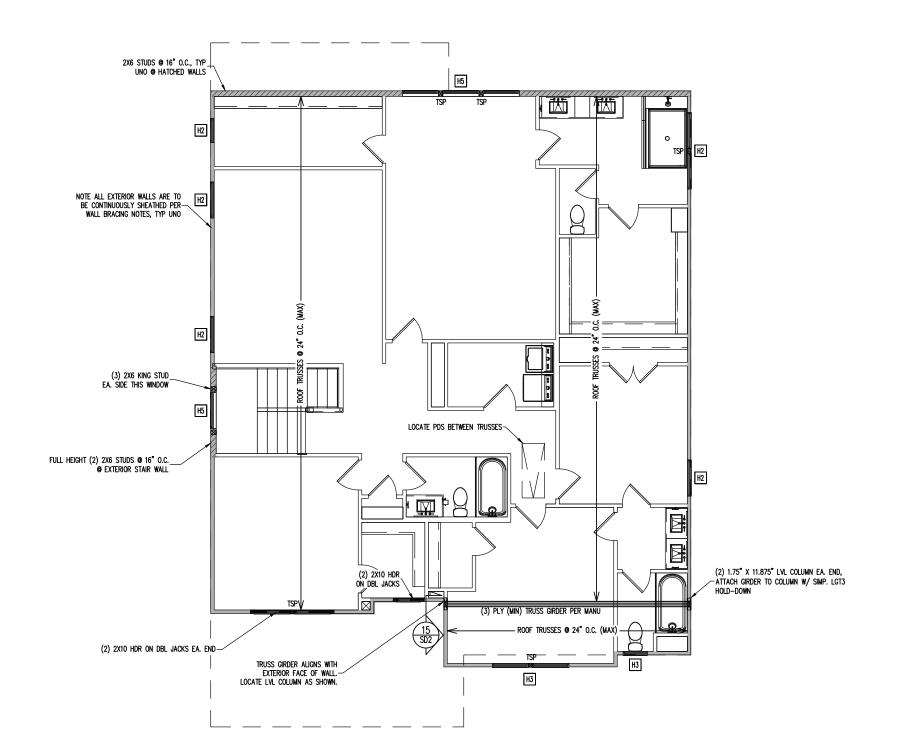

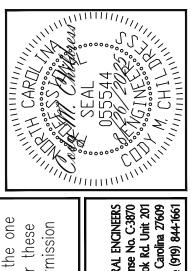

STRUCTURAL ENGINEERS
License No. C-3870
8 W Millbrook Rd. Unit 201
leigh, North Carolina 27609
Phone (919) 844-1661 318 W Mill: Raleigh, Nor

These plans are for the one sumes no liability for these

permission

without

assumes

Associates,

Tech

of

property

is the

this plan

of

design

The structural

the location

time use

are

they at

plans

CONSTRUCTION SPECIFICATIONS INSTANT REFERENCES

REFER TO THE CONSTRUCTION SPECIFICATIONS SECTIONS FOR THE FOLLOWING INFORMATION:

PART 1.01: CURRENT GOVERNING CODE

PART 14: STUD SUPPORT FOR BEAMS

PART 17: KING STUDS FOR EXTERIOR WALLS

SEE DETAIL / CONSTRUCTION SPECIFICATIONS SHEETS FOR I-JOISTS ALLOWABLE SUBSTITUTIONS

WALL BRACING

SHADED WALLS:

ALL EXTERIOR STUD WALLS, EXTERIOR SIDE, ARE TO BE CONTINUOUSLY SHEATHED WITH 7/16 APA RATED OSB NAILED TO STUDS WITH 8d NAILS © 6° O.C. AT PANEL EDGES, 12° O.C. IN PANEL FIELD.

PROVIDED CONTINUOUS SHEATHING = 176' MIN.

REFERENCE PART 16.02 OF CONSTRUCTION SPECIFICATIONS FOR GENERAL WIND BRACING INFORMATION.

HEADER SCHEDULE

- H1 SINGLE 2X4 TURNED FLAT (A)
- H2 (2) 2X4'S ON SINGLE JACKS (B)
- H3 (2) 2X10'S ON SINGLE JACKS (C)
- H4 (2) 1.75" X 9.25" LVL'S ON DBL JACKS
- H5 (3) 2X10'S ON SINGLE JACKS
- (A) TYPICAL FOR INTERIOR NON LOAD BEARING WALLS ONLY, ROUGH OPENING 38" MAX.
- (B) TYPICAL FOR INTERIOR NON LOAD BEARING WALLS ONLY, ROUGH OPNG 38" TO 74" MAX.
- (C) TYPICAL FOR ALL CONDITIONS NOT LISTED IN (A) OR (B) UNO.

-HEADERS IN NON LOAD BEARING INTERIOR
WALLS ARE NOT LABELED.

2ND FLOOR FRAMING PLAN

WALLS AND CEILING 1/8" = 1'-0"

location \forall other Associates, NEW HOME INC STRUCTURAL ADDENDUM any at Engineering lech construction Engineering **BEACON HILL ROAD** ENGLISH COUNTRY for listed. part, 726 .⊆ the client o whole S P A LOC: for and reproduced,


ENG: CMC/ZCH DATE: 8/26/2025

PLAN THE GARNER

PROJECT NO. 25-29-006

SHEET NO.

S4 4 of 8

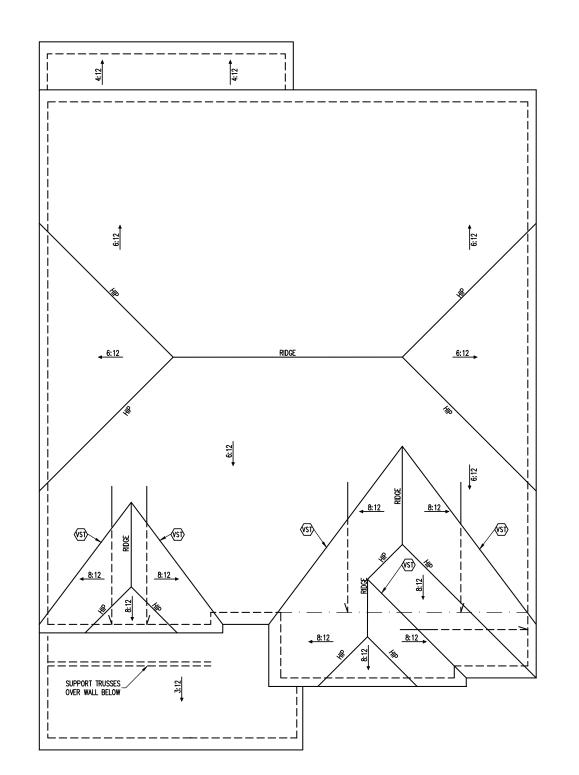



VALLEY SET TRUSSES PER MANU

FRAMING NOTES

ROOF ONLY

-ROOF TRUSSES PER MANU. TYPICAL U.N.O.
-VERIFY ALL HEEL HEIGHTS, ROOF PITCHES,
AND ARCHITECTURAL OVERHANGS PRIOR TO
CONSTRUCTION

TRUSS UPLIFT CONNECTORS EXPOSURE B. 120 MPH, ANY PITCH

EXPOSURE B. 120 MPH. ANY PITCH
24" O.C. MAX ROOF TRUSS SPACING
TRUSSES SHALL BE ATTACHED TO SUPPORT WALL
FOR UPUFT RESISTANCE. CONTINUOUS OSB WALL
SHEATHING BELOW PROVIDES CONTINUOUS UPLIFT
RESISTANCE TO FOUNDATION. ALL TRUSSES
SUPPORTED BY INTERMEDIATE SUPPORT WALLS,
KNEEWALLS OR BEAMS SHALL BE ATTACHED TO
SUPPORTING MEMBER PER SCHEDULE BELOW.

ROOF SPAN IS MEASURED HORIZONTALLY BETWEEN FURTHEST SUPPORT POINTS.

CONNECTOR NAILING PER TABLE 602.3(1) NCRBC 2018 EDITION

OVER 18'

(1) SIMPSON H2.5A HURRICANE CLIP TO DBL TOP PLATE OR BEAM

ROOF FRAMING PLAN

1/8" = 1'-0"

oduced, Associ	duced, in whole or Associates, P.A.	oduced, in whole or in part, for construction at any other location without written permission Associates, P.A.	n at (o yur	ther	ocation	without	written	permission
EN DA		NEW HOME INC.	ادِ				7		
IC: TE:	SCOPE	STRUCTURAL ADDENDUM	MDQN			I L			STRUCTURAL ENGINEERS
CM(8/2(: 10C	726 BEACON HILL ROAD	REV # REF PROJ # DATE	F PROJ #	TV DAT	<u> </u>	7	218 W N	License No. C-3870 License No. C-3870 Millhook Pd 1 Init 201
C/Z(6/20	ELEVATION:	LEVATION: ENGLISH COUNTRY					Zect Zect	λ Raleigh, N	Sech Raleigh, North Carolina 27609
CH 25						ASS	ASSOCIATES, P.A.	'	Phone (919) 844-1661

PLAN

THE GARNER


PROJECT NO.


25-29-006 SHEET NO. **S5**


5 of 8

The structural design of this plan is the property of Engineering Tech Associates, P.A. These plans are for the one time use at the location and for the client listed. Engineering Tech Associates, P.A. assumes no liability for these plans if they are reproduced, in whole or in part, for construction at any other location without written permission


they are reproduced, in

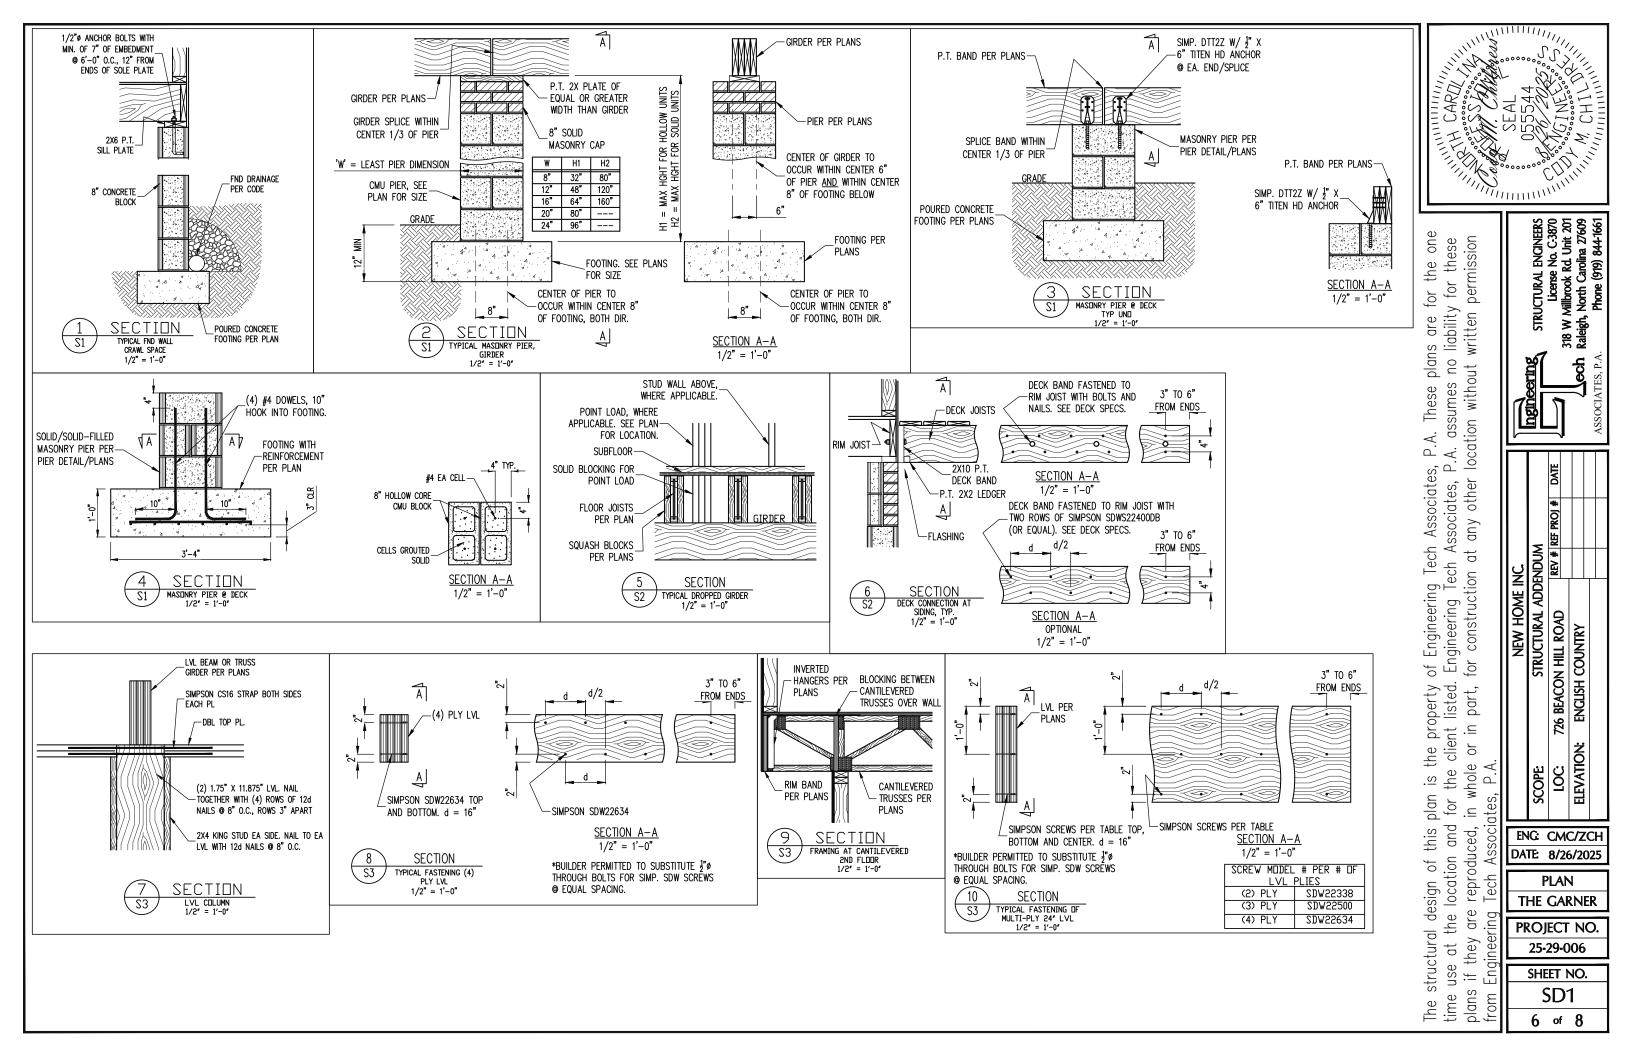

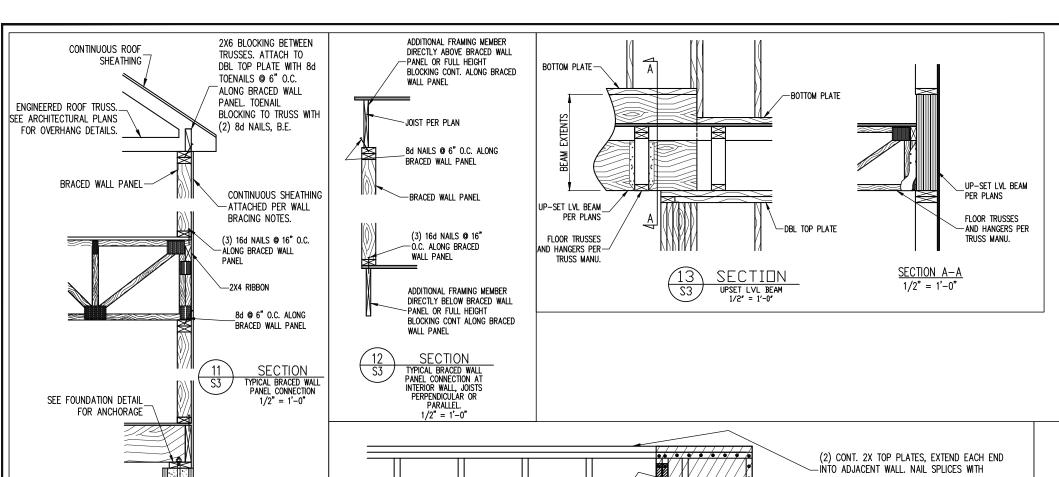

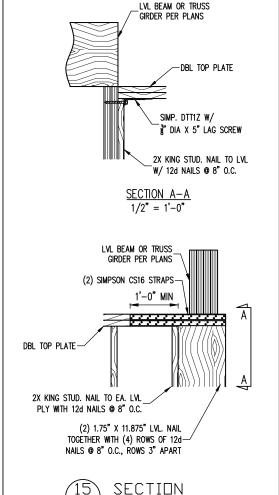

LVL COLUMN @ CORNER

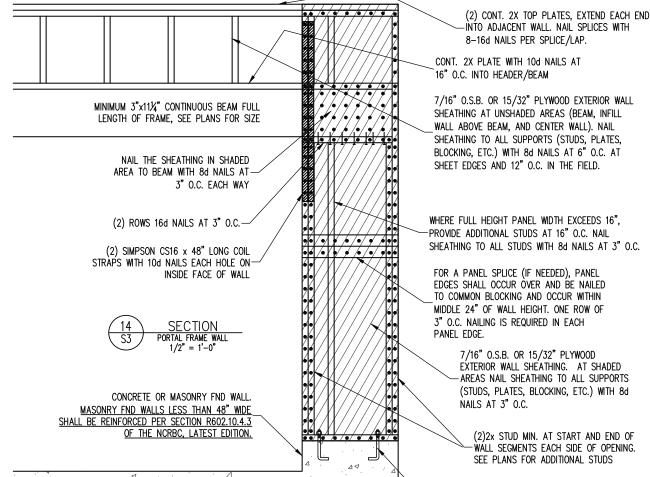


2x4 P.T. PLATE WITH TWO 1/2" DIA x 7" EMBED

WASHERS OR ADDITIONAL HOLDOWN PER PLANS. OPTION: (2) 5/8" DIA. THREADED RODS

ANCHOR BOLTS WITH A 3/16"x2"x2" PLATE

INSTALLED PER SECTION R602.10.4.3 OF THE

NCRBC, LATEST EDITION.

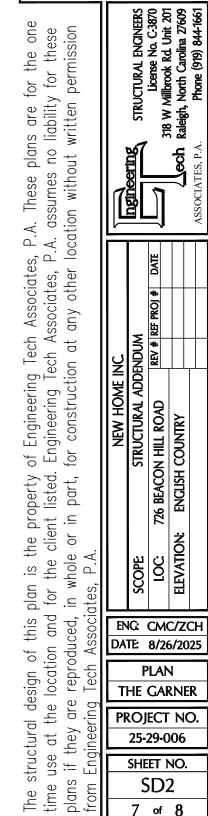

COUNTRY

ENCLISH (



DECK SPECIFICATIONS

A DEGLE OF THE EMPLOYER STATEMENT WHOLE IS AND OTHER HER HAND TO ATTACHED TO			
A DECK IS AN EXPOSED EXTERIOR WOOD FLOOR STRUCTURE WHICH MAY BE ATTACHED TO A STRUCTURE OR BE FREE STANDING, ROOFED PORCHES, OPEN OR SCREENED IN, MAY BE		JOIST SPAN	DECKING
Constructed using these provisions.		12" O.C.	1" S4S
		16" O.C.	1" T&G
SUPPORT POSTS SHALL BE SUPPORTED BY A FOOTING.		24" O.C.	1 1/4" S4S
WHEN ATTACHED TO A STRUCTURE, THE STRUCTURE TO WHICH ATTACHED SHALL HAVE A		32" O.C.	2" S4S
TREATED WOOD BAND FOR THE LENGTH OF THE DECK, OR CORROSION RESISTANT FLASHING	9. MA	XIMUM HEIGHT OF DECK SUPPORT POSTS	S IS AS FOLLOWS:
SHALL BE USED TO PREVENT MOISTURE FROM COMING IN CONTACT WITH THE UNTREATED			
EDAMING OF THE STOLICTURE THE DECK DAND AND THE STOLICTURE DAND SHALL DE		POST SIZE	MAX POST HEIGHT

Framing of the Structure. The Deck band and the Structure band shall be constructed in Control the Each other Except at Brock sheep and where plynood sheathing is required and properly flashed, soing shall not be included by the Structure and the Deck Band. If although to a Brick structure, wither flashing nor a treated band for the Brock Structure is required. In addition, the treated deck Band shall be constructed in contact with the Brock.

WHEN THE DECK IS SUPPORTED AT THE STRUCTURE BY ATTACHING THE DECK TO THE STRUCTURE, THE FOLLOWING ATTACHMENT SCHEDULES SHALL APPLY FOR ATTACHING THE DECK BAND TO THE STRUCTURE:

A. ALL STRUCTURES EXCEPT BRICK STRUCTURES

	JOIST I	ENGTH
	UP TO 8' MAX.	UP TO 16' MAX.
REQUIRED FASTENERS	ONE- 5/8" # BOLT @ 42" O.C. AND (2) ROWS OF 12d NAILS @ 8" O.C. OR TWO ROWS OF SIMPSON SDWS22400DB @ d = 32" O.C. STAGGERED	ONE- 5/8" # BOLT @ 20" O.C. AND (3) ROWS OF 12d NAILS @ 6" O.C. OR TWO ROWS OF SIMPSON SDWS22400DB @ d = 16" O.C. STAGGERED

Α.	RKICK	VENEER	SIKUC

L PL FLITCH PLATE FLR FLOOR

A . DRICK YE	NEEK SIKOCIONES	
	JOIST	LENGTH
	UP TO 8' MAX.	UP TO 16' MAX.
REQUIRED FASTENERS	ONE- 5/8" ø BOLT @ 28" O.C.	ONE- 5/8" ø BOLT @ 16" O.C.

- If the Deck band is supported by a 1/2" minimum masonry ledge along the foundation wall, 5/8" θ bolts spaced Φ 48" o.C. may be used for support.
- OTHER MEANS OF SUPPORT, SUCH AS JOIST HANGERS, MAY BE USED TO CONNECT DECK JOISTS TO A TREATED STRUCTURE BAND
- Girders shall bear directly on posts or be be connected to the sides of posts with 2– 5/8" θ bolts
- FLOOR DECKING SHALL BE NO. 2 GRADE TREATED SOUTHERN PINE OR EQUIVALENT. THE MINIMUM FLOOR DECKING THICKNESS SHALL BE AS FOLLOWS:

LAMINATED VENERY
LIMBER
NTS NOT TO SCALE
O.C. ON CENTER
PSL PARALLEL STRAND
LIMBER
P PRESSURE TREATED
QJ QUAD JOIST
SP SPACE (OR SPACING)
SQ SQUARE

NOTES

roof and floor trusses to be designed by an engineer registered by the state. Fina truss drawing should be submitted to the EOR for review

THE PLANS CONTAIN DISCREPANT OR INCOMPLETE INFORMATION

	THE POSTS WITH ONE - 5/8" # BOLT AT EACH END OF THE BRA
S:	1) ALL NAILS AND BOLTS ARE TO BE HOT DIPPED GALVANIZED.

MINIMUM EDGE DISTANCE FOR BUEIS IS 2 1/2.
 NAILS MUST PENETRATE THE SUPPORTING STRUCTURE BAND A MINIMUM OF 1 1/2".

ABBRE\

YP PL SP NO	TYPICAL TRIPLE TRIPLE STUD POCKET UNLESS NOTED	MANUFACTURER	DEPTH	SERIES	SIMPSON FACE MOUNT HGR	SIMPSON TOP FLANGE HGR
ΧJ	OTHERWISE EXTRA JOIST	BLUELINX BOISE CASCADE BOISE CASCADE INTERNATIONAL BEAMS	11.875" 11.875" 11.875" 11.875"	BLI 40 BCI 5000s BCI 6000s IB 400	IUS2.56/11.88 IUS2.06/11.88 IUS2.37/11.88 IUS2.56/11.88	ITS2.56/11.88 ITS2.06/11.88 ITS2.37/11.88 ITS2.56/11.88
		LP CORP NORDIC ROSEBURG WEYERHAEUSER WEYERHAEUSER	11.875" 11.875" 11.875" 11.875" 11.875"	LPI 20+ NI 40X RFPI 40s TJI 210 EEI-20	IUS2.56/11.88 IUS2.56/11.88 IUS2.56/11.88 IUS2.06/11.88 IUS2.37/11.88	ITS2.56/11.88 ITS2.56/11.88 ITS2.56/11.88 ITS2.06/11.88 ITS2.37/11.88

JOIST SPAN	DECKING			
12" O.C.	1" S4S			
16" O.C. 1" T&G 24" O.C. 1 1/4" S4				
32" O.C.	2" S4S			
IXIMUM HEIGHT OF DECK SUPPORT POSTS				

NOTES: 1) THIS TABLE IS BASED ON NO. 2 TREATED SOUTHERN PINE POSTS. 2) THIS TARLE IS RASED ON A MAXIMUM TRIBUTARY AREA OF 128 SO FT. 3) POST HEIGHT IS FROM TOP OF FOOTING TO BOTTOM OF GIRDER.

4X4 6X6

ENGINEERED

- DECKS SHALL BE BRACED TO PROVIDE LATERAL STABILITY BY ONE OF THE FOLLOWING METHODS:
- A. When the Deck Floor Height is less than 4'-0" and the Deck is attached to the structure in accordance with Section 4, Lateral Bracing is not required.
- B. 4X4 WOOD KNEE BRACES MAY BE PROMDED ON EACH COLUMN IN BOTH DIRECTIONS. THE KNEE BRACES SHALL ATTACH TO EACH POST AT A POINT NOT LESS THAN 1/3 OF THE POST LENGTH FROM THE TOP OF THE POST, AND THE BRACES SHALL BE ATTACHED BETWEEN 45° AND 60° FROM THE HORIZONTAL. KNEE BRACES SHALL BE ATTACHED AT
- C. FOR FREE STANDING DECKS WITHOUT KNEE BRACES OR DIAGONAL BRACING, LATERAL STABILITY MAY BE PROVIDED BY EMBEDDING THE POSTS IN CONCRETE IN ACCORDANCE WITH THE FOLLOWING:

POST SIZE	TRIBUT. AREA	POST HEIGHT	EMB. DEPTH	CONC. DIAM.
4X4 6X6	48 SQ. FT. 120 SQ. FT.	4'-0" 6'-0"	2'-6" 3'-6"	1'-0" 1'-8"

- D. 2X6 DIAGONAL VERTICAL CROSS BRACING SHALL BE PROVIDED IN TWO PERPENDICULAR DIRECTIONS FOR FREE STANDING DECKS OR PARALLEL TO THE STRUCTURE AT THE EXTERIOR COLUMN LINE FOR ATTACHED DECKS. THE BRACES SHALL BE ATTACHED TO

ABE	BREVIATION	۱S						ST SUBST	
	FOUNDATION FOOTING	TJ TYP	TRIPLE JOIST TYPICAL	NOTE: PLANS		JOIST DE	PTH, DIRECTIO	ON, AND SPACING	SPECIFIED ON
	HOT DIPPED GALVANIZED HANCED	TRPL TSP	TRIPLE TRIPLE STUD POCKET	MANUF	ACTURER	DEPTH	SERIES	SIMPSON FACE MOUNT HGR	SIMPSON TO FLANGE HGR

MANUFACTURER	DEPTH	SERIES	SIMPSON FACE MOUNT HGR	SIMPSON TOP FLANGE HGR
BLUELINX	11.875"	BLI 40	IUS2.56/11.88	ITS2.56/11.88
BOISE CASCADE	11.875"	BCI 5000s	IUS2.06/11.88	ITS2.06/11.88
BOISE CASCADE	11.875"	BCI 6000s	IUS2.37/11.88	ITS2.37/11.88
INTERNATIONAL	11.875"	IB 400	IUS2.56/11.88	ITS2.56/11.88
BEAMS			,	•
LP CORP	11.875*	LPI 20+	IUS2.56/11.88	ITS2.56/11.88
NORDIC	11.875"	NI 40X	IUS2.56/11.88	ITS2.56/11.88
ROSEBURG	11.875"	RFPI 40s	IUS2.56/11.88	ITS2.56/11.88
WEYERHAEUSER	11.875"	TJI 210	IUS2.06/11.88	ITS2.06/11.88
WEYERHAEUSER	11.875"	EEI-20	IUS2.37/11.88	ITS2.37/11.88

JOISTS NOT LISTED IN THE ABOVE TABLE MAY BE USED PROVIDED THEY MEET OR EXCEED THE PROPERTIES OF THOSE LISTED. SUBSTITUTE USP BRAND HANGERS WITH EQUIVALENT VALUES AS DESIRED.

one these permission the for for plans are for s no liability f written without These assumes location P.A. ⋖ ┙. Associates, Associates, at any other Tech at Engineering Tech construction Engineering for of listed. property part, client I the whole P A the <u>.s</u> plan for and this ced, reprodu location of design are the structural they at nse

±

plans

time

SEAL OSSS44 ARDL RAL ENGINERS anse No. C-3870 ook Rd. Unit 201 o Carolina 27609 e (919) 844-1661

STRUCTURAL E License N S W Millbrook Re North (318 W A Raleigh, ngmeering C REF PROJ

STRUCTURAL ADDENDUM BEACON HILL ROAD COUNTRY ENGLISH 726 **ELEVATION:** 00

> ENG: CMC/ZCH DATE: 8/26/2025

PLAN THE GARNER

PROJECT NO. 25-29-006

> SHEET NO. SD3

8 of 8