

2 X FASCIA **BRICK VENEERS)** 11. AIR SPACE. SPECIFICATIONS. O.C., 12" FROM CORNERS. 48" O.C. 15. FINISHED GRADE. 16. FOOTING WELDED WIRE FABRIC.

1. 15# FELT UNDERLAYMENT UNDER

COMPOSITION SHINGLES.

2. ROOF DECKING.

- 3. 2 X RAFTERS / ENGINEERED TRUSSES
- DOUBLE TOP PLATE.
- 2 X 4 RETURN.
- 3/4" FASCIA OR PVC TRIM COIL
- 1/4" PLYWOOD OR VINYL SOFFIT
- 1X FREIZE BOARD (TO BE USED WITH
- 10. INSULATION BOARD OR HOUSE WRAP
- 12 BRICK WITH BRICK TIES PER MANUFACTURER'S
- 13. 1/2" X 12" ANCHOR BOLTS, 6'-0"
- 14. FLASHING WITH WEEP HOLES @
- 17. COMPACTED EARTH FILL.
- 18. 6 MIL VAPOR BARRIER
- 19. 4" CONCRETE SLAB, 3,000 P.S.I. WITH 6" X 6" 10 GA. X 10 GA.
- 20. 1/2" GYPSUM BOARD.

FOUNDATION NOTES:


ALL FOOTINGS SHALL BEAR ON ORIGINAL **UNDISTURBED SOIL** THE 28 DAY COMPRESSIVE STRENGTH OF ALL **FOOTINGS IS 3000 PSI**

PROVIDE WATER PROOFING AND PERIMTER DRAINS AS REQUIRED

FOOTING WIDTHS ARE BASED ON A LOAD **BEARING SOIL CAPACITY OF 2000 PSI**

PROVIDE 6 MIL POLY VAPOR BARRIER TO COVER GROUND IN CRAWL SPACE AND GROUND UNDER POURED CONCRETE

ALL ANCHOR BOLTS TO BE 1/2" X 12" LONG. ANCHOR BOLTS SHALL BE SPACED AT A MAXIMUM OF 6' ON CENTER AND NO MORE THEN 1' FROM EACH CORNER

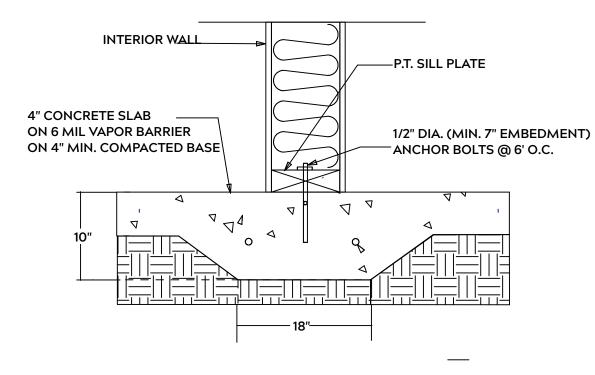

GENERAL FRAMING NOTES:

ALL LUMBER IN CONTACT WITH CONCRETE OR MASONRY SHALLE BE PRESSURE TREATED

FRAMING LUMBER SHALL BE SYP #2 GRADE AND / OR SPRUCE PINE FIR #1 AND / OR KILN DRIED

WHERE PRE-ENGINEERED JOISTS AND TRUSSES ARE USED, MANUFACTURER SHALL PROVIDE DRAWINGS / SCHEMATICS, WHICH SHALL BEAR OF A N.C. **ENGINEER**

STUDS AND JOISTS SHALL NOT BE CUT TO INSTALL PLUMBING OR WIRING WITHOUT ADDING METAL OR WOOD SIDE PANELS TO STRENGTHEN MEMBER TO ITS ORIGINAL CAPACITY

NAIL MULTIPLE MEMBERS WITH 2 ROWS OF 16d NAILS STAGGERED 32" O.C. AND USE 3 X 16d NAILS 2" IN AT EACH END.

NAIL FLOOR JOISTS TO SILL PLATE WITH WITH 8d TOE NAILS


ALL EXPOSED FRAMING ON PORCHES OR DECKS SHALL BE PRESSURE TREATED

PROVIDE WATERPROOFING AND DRAINS AS REQUIRED

ALL FRAMING TO BE 16" O.C. WALL FRAMING DIMENSIONS ARE BASED ON 2X4 OR 2X6 EXTERIOR WALLS AND 2X4 INTERIOR WALLS. DOULBE / TRIPLE JACK STUDS AS NECESSARY UNDER HEADERS AS REQUIRED

LVL'S TO BE SIZED BY OTHERS (TRUSS MANUFACTURER)

EXTERIOR WALL SECTION

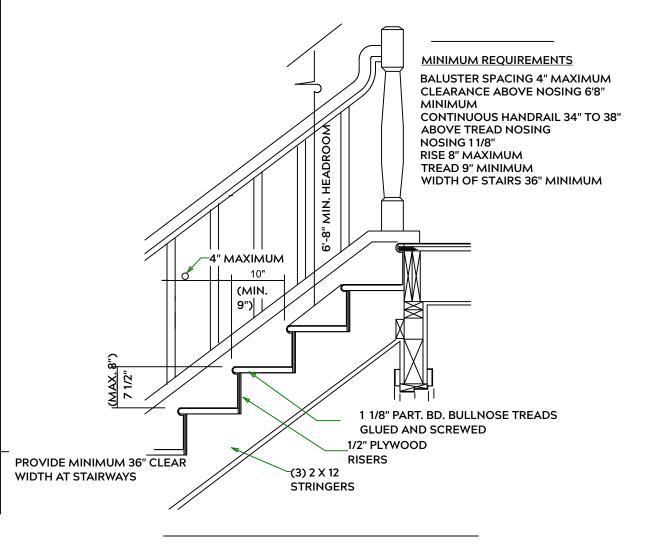

STAIR DETAIL

PLAN: Sarah

SHEETS

PROJECT ADDRESS: 18 Myrtle Oak Dr. Magnolia Hills Lot 34

Precision Custom Hor Raeford, NC @PrecisionCustomHor

DATE:


9/24/25


SCALE: 1/4" = 1'


SHEET:

A-3

LUG FOOTING

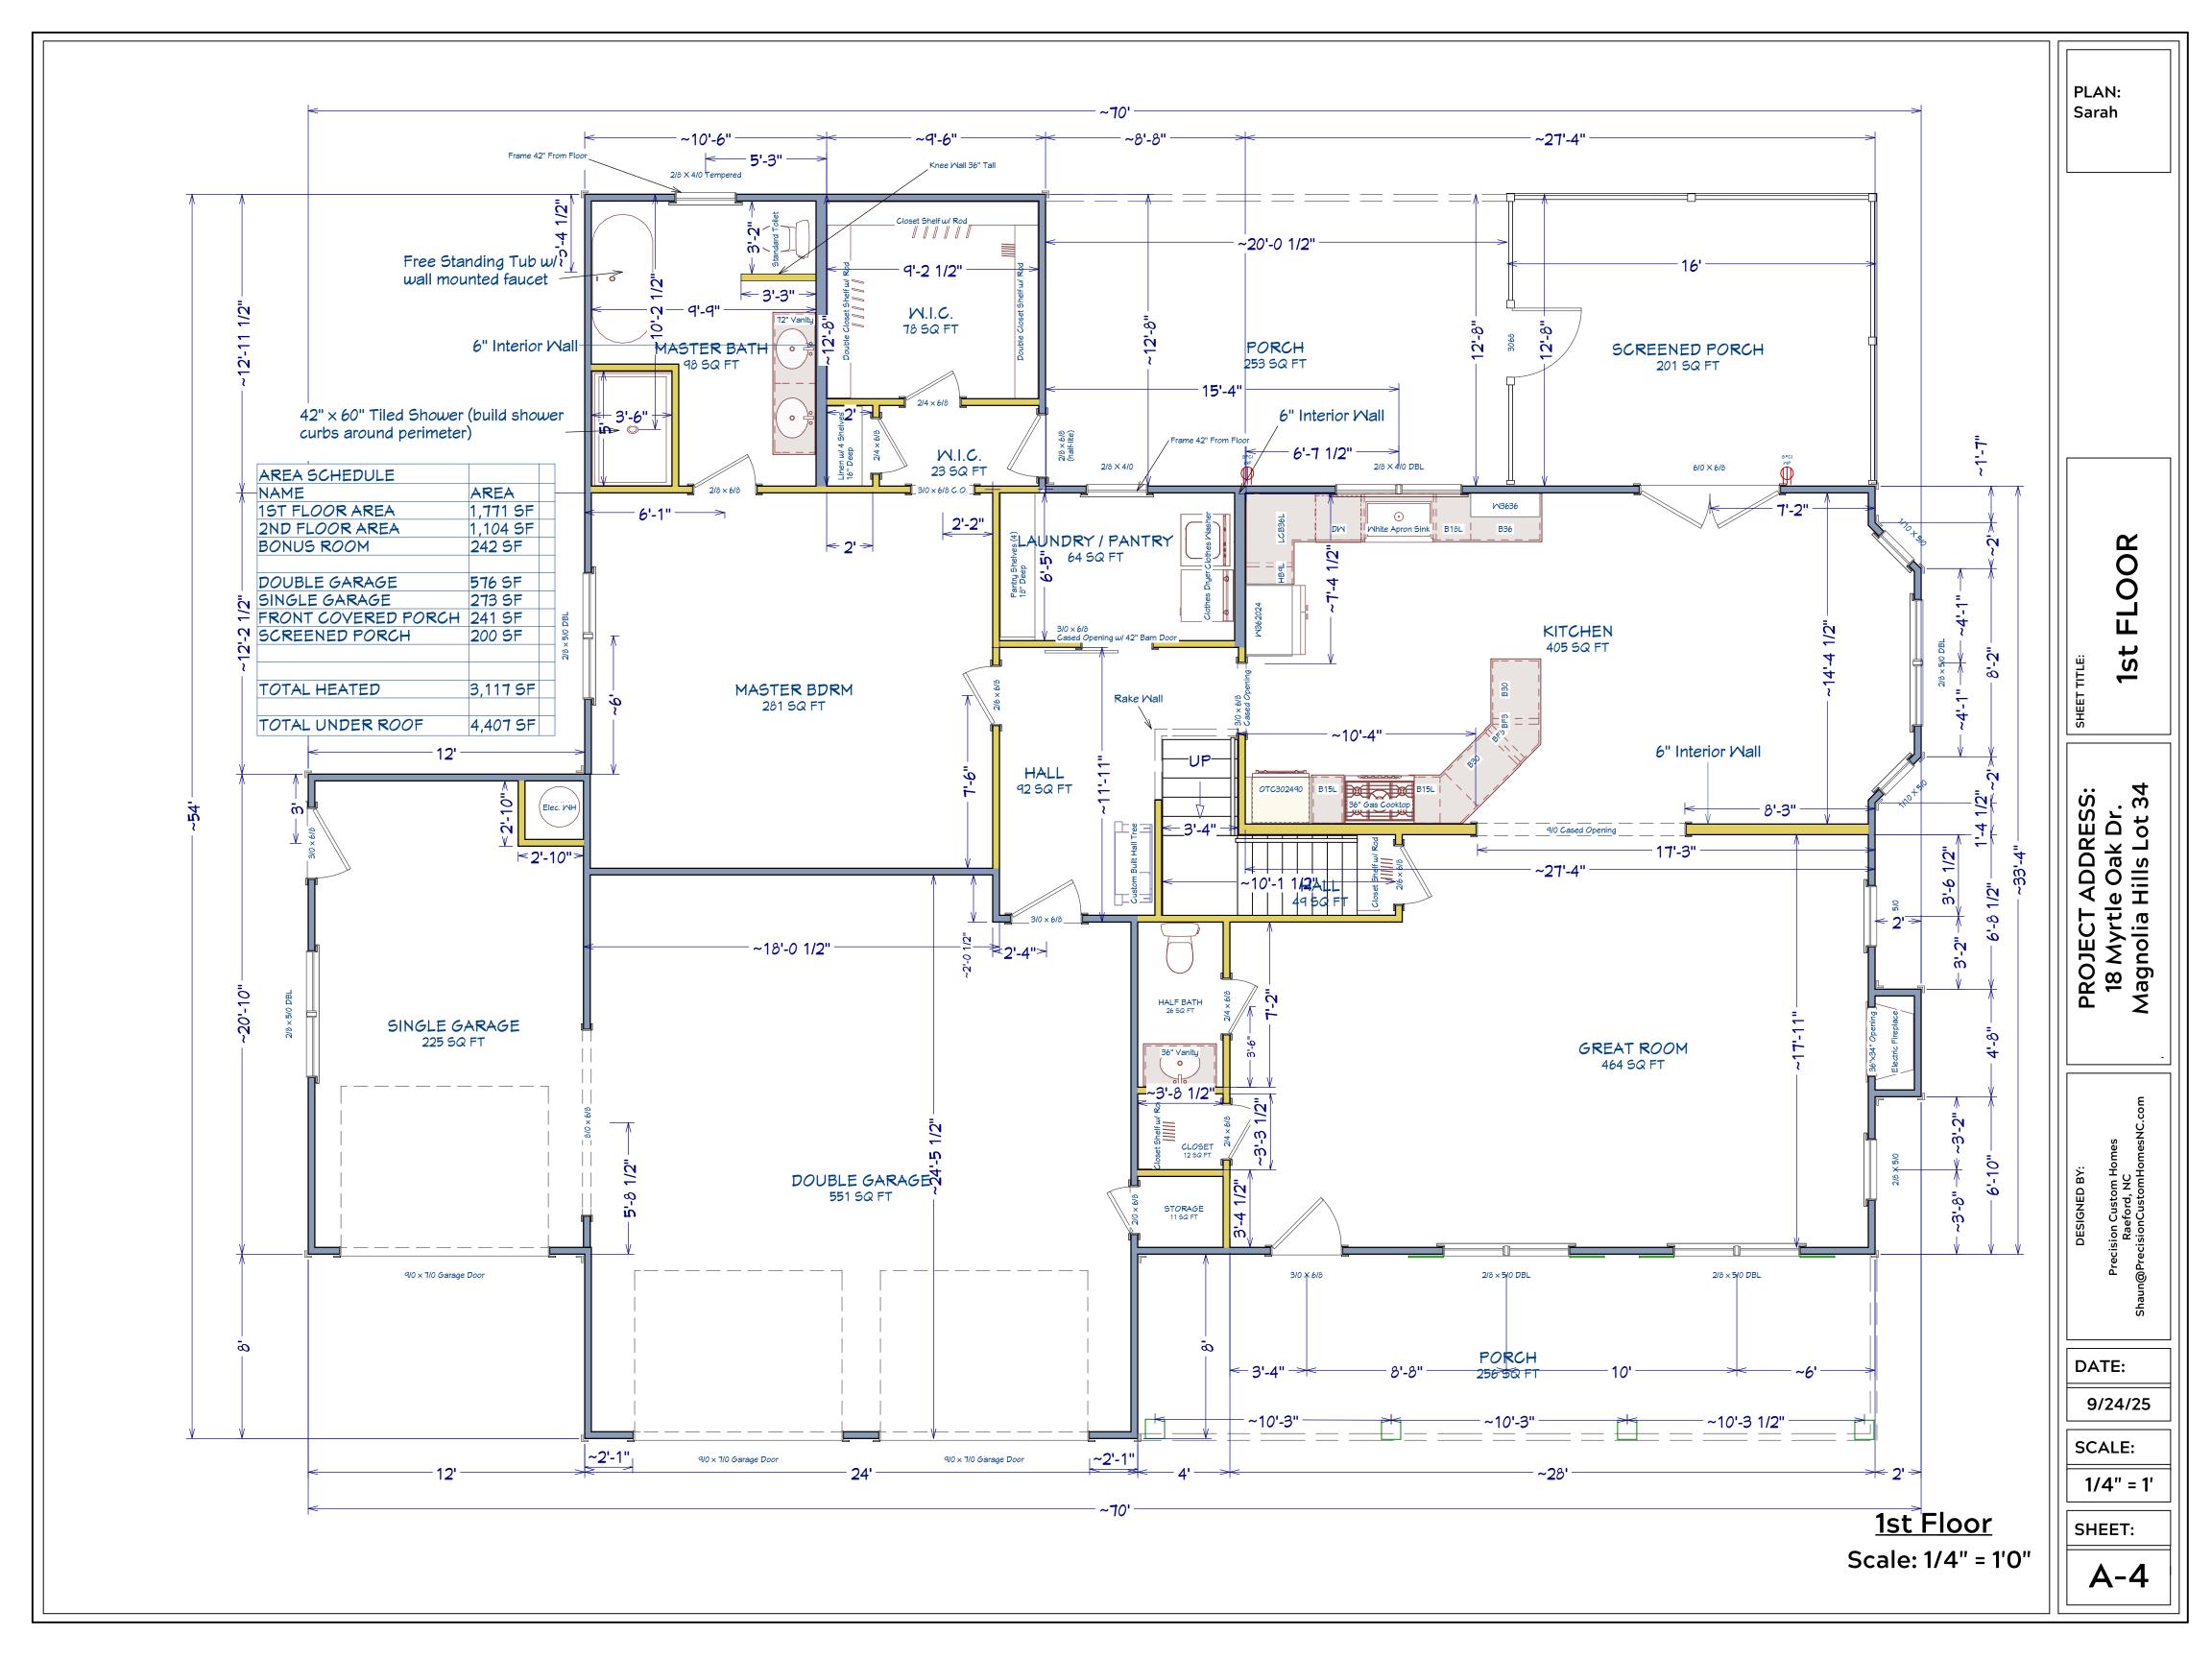

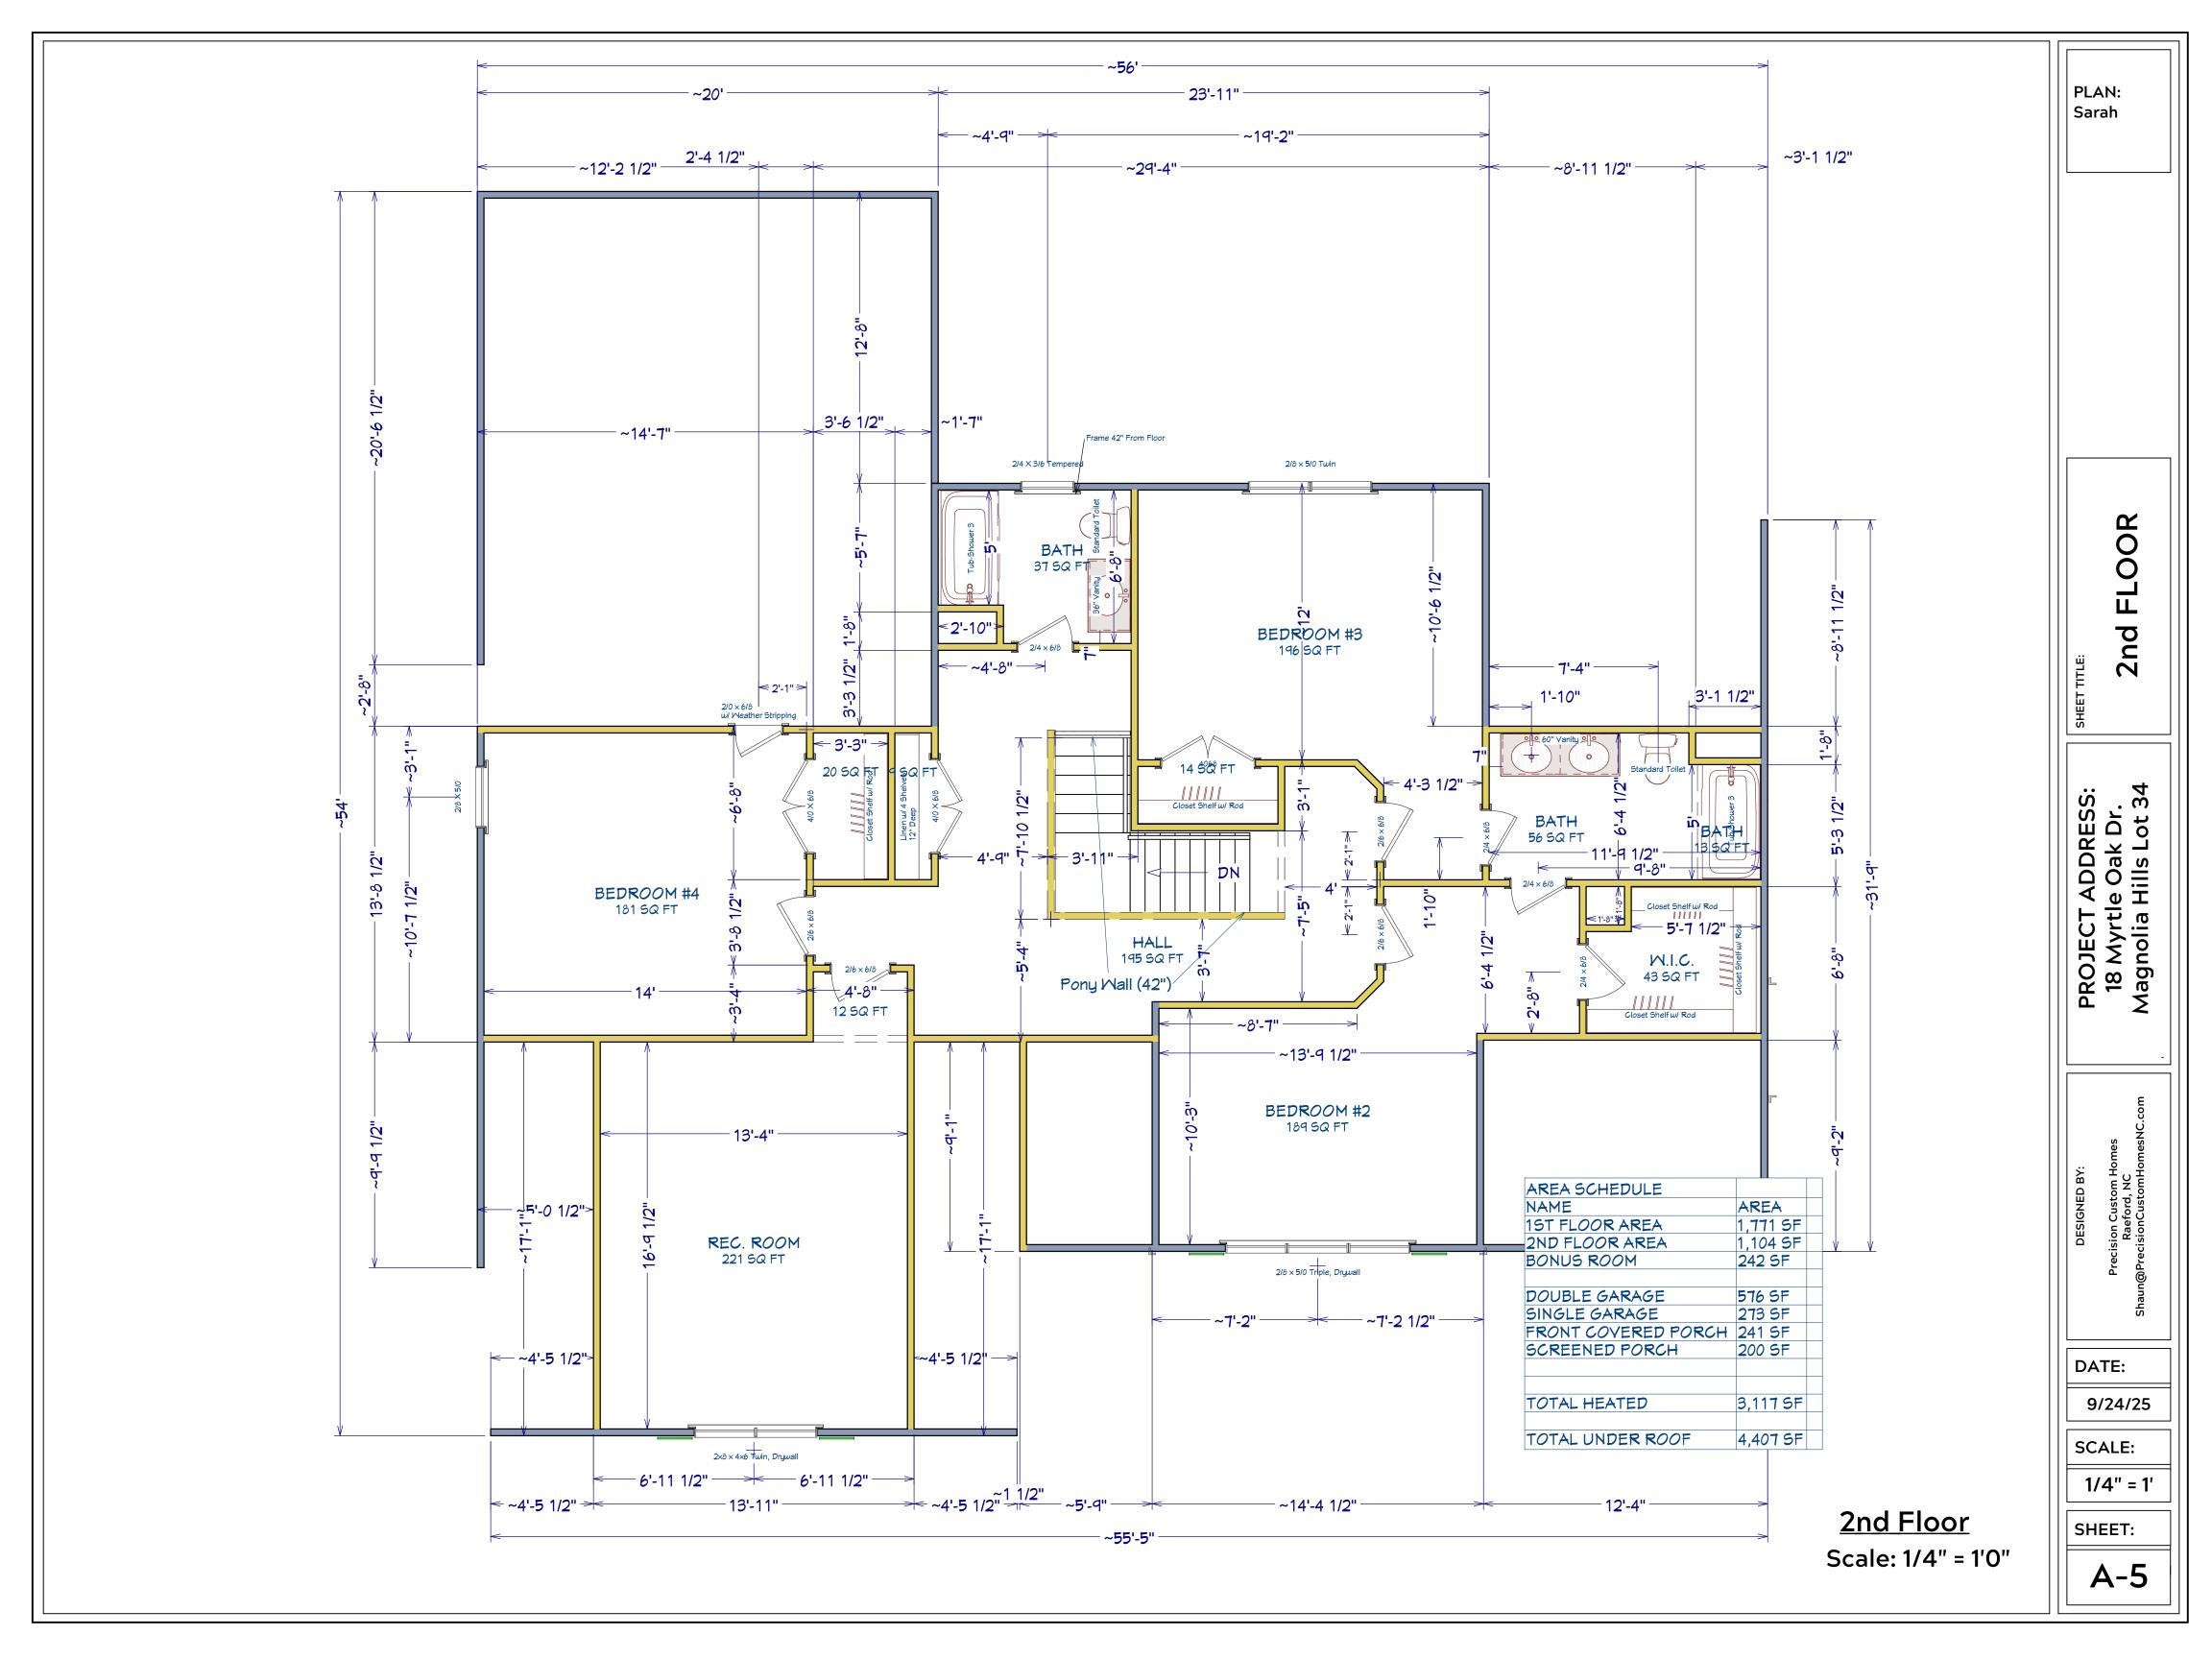

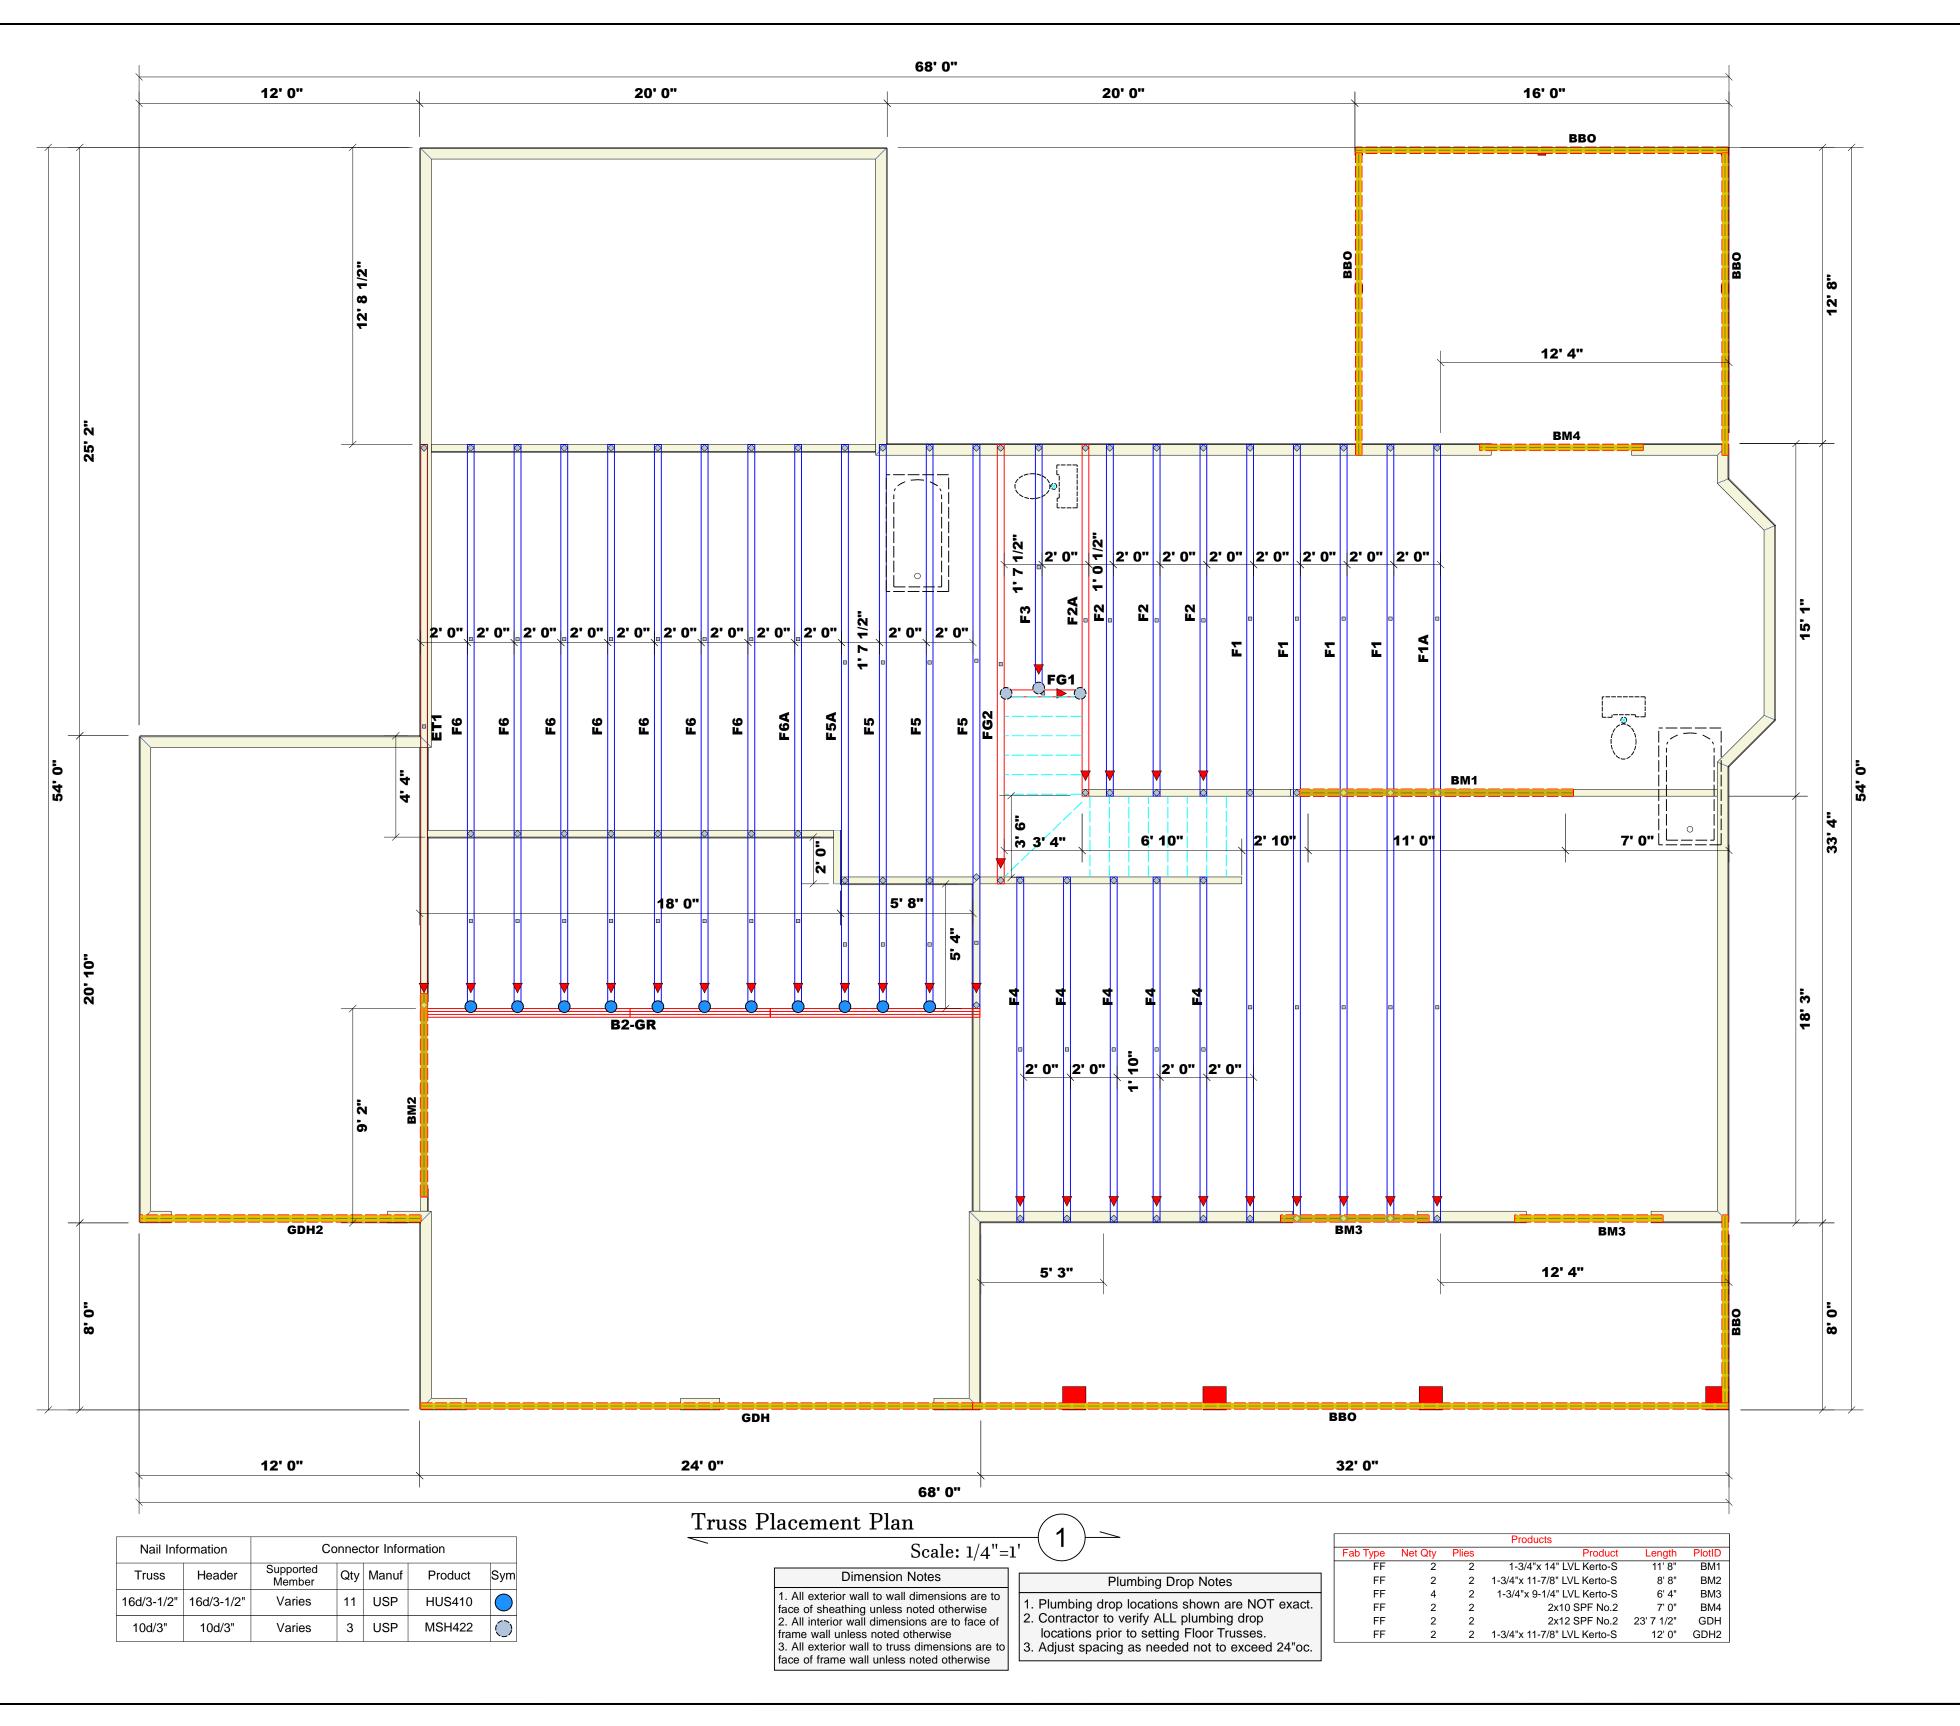



Reilly Road Industrial Park Fayetteville, N.C. 28309 Phone: (910) 864-8787 Fax: (910) 864-4444

Sales Area

LOAD CHART FOR JACK STUDS (BASED ON TABLES R502.5(1) & (b)) NUMBER OF JACK STUDS REQUIRED @ EA END OF

		1	HEADER/	GIRDE	5		
END REACTION (UP TO)	REQ'D STUDS FOR (2) PLY HEADER		END REACTION (UP TO)	REQ'D STUDS FOR (3) PLY HEADER		END REACTION (UP TO)	REQ'D STUDS FOR
1700	1		2550	1		3400	1
3400	2		5100	2		6800	2
5100	3		7650	3		10200	3
6800	4		10200	4		13600	
8500	5		12750	5		17000	5
10200	6		15300	6			
11900	7						
13600	8						
15300	9						

COUNTY	Cameron / Cumberland
ADDRESS	18 Myrtle Oak Drive
WODEL	Floor
DATE REV.	9/24/25
DRAWN BY	DRAWN BY Johnnie Baggett
SALESMAN	SALESMAN Neil Baggett

JOB NAME BUILDER QUOTE; THIS IS A TRUSS PLACEMENT DIAGRAM ONLY.

These trusses are designed as individual building components to be incorporated into the building design at the specification of the building designer. See individual design sheets for each truss design identified on the placement drawing. The building designer is responsible for temporary and permanent bracing of the roof and floor system and for the overall structure. The design of the truss support structure including headers, beams, walls, and columns is the responsibility of the building designer. For general guidance regarding bracing, consult BCSI-B1 and BCSI-B3 provided with the truss delivery package or online @ sbcindustry.com


Seal Date

SEAL DATE

251383

Precision Custom Homes

34 Magnolia Hills

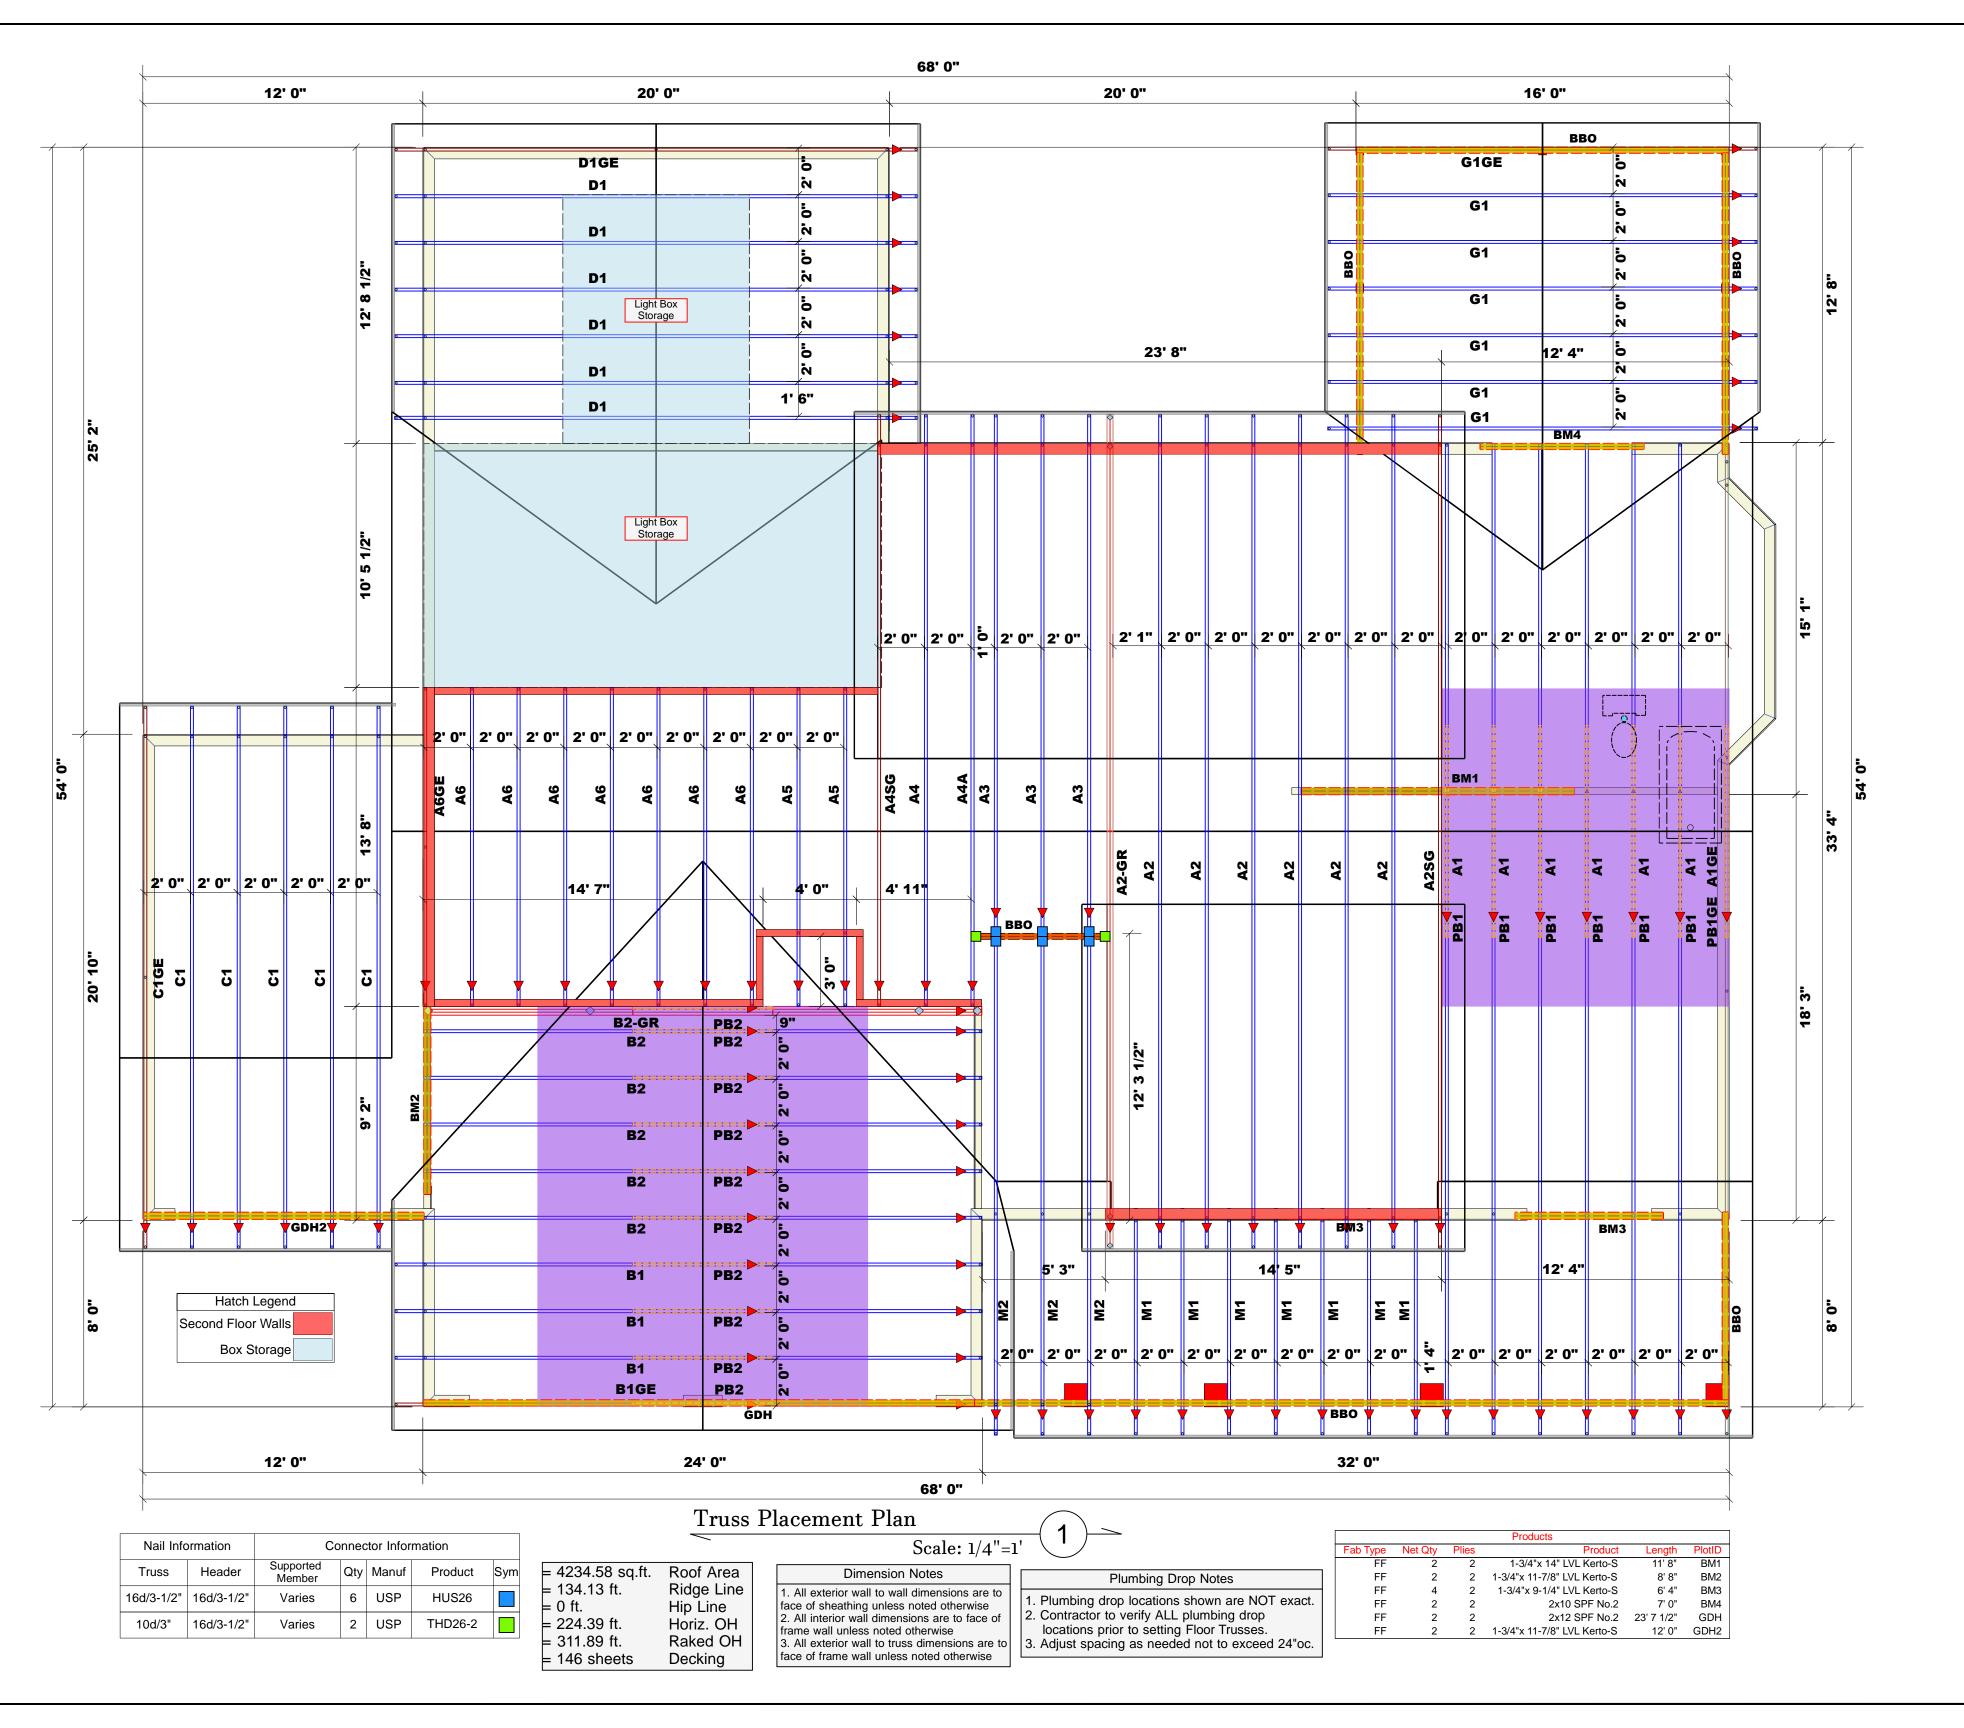

COMTECH **ROOF & FLOOR**

TRUSSES & BEAMS

Reilly Road Industrial Park Fayetteville, N.C. 28309 Phone: (910) 864-8787 Fax: (910) 864-4444

aring reactions less than or equal to 3000# are emed to comply with the prescriptive Code quirements. The contractor shall refer to the ached Tables (derived from the prescriptive

Sales Area

LOAD CHART FOR JACK STUDS (BASED ON TABLES R502.5(1) & (b)) NUMBER OF JACK STUDS REQUIRED @ EA END OF

		- 1	2				
END REACTION (UP TO)	REQ'D STUDS FOR (2) PLY HEADER		END REACTION (UP TO)	REQ'D STUDS FOR (3) PLY HEADER		END REACTION (UP TO)	
1700	1		2550	1		3400)
3400	2		5100	2		6800)
5100	3		7650	3		10200	Э
6800	4		10200	4		13600	Э
8500	5		12750	5		17000	C
10200	6		15300	6			
11900	7						
13600	8						
15300	9						

COUNTY	Cameron / Cumberland
ADDRESS	18 Myrtle Oak Drive
WODEL	Roof
DATE REV.	9/24/25
DRAWN BY	DRAWN BY Johnnie Baggett
SALESMAN	SALESMAN Neil Baggett

34 Magnolia Hills Precision Custom Homes Seal Date 251383 JOB NAME SEAL DATE **QUOTE** # PLAN THIS IS A TRUSS PLACEMENT DIAGRAM ONLY.

THIS IS A TRUSS PLACEMENT DIAGRAM ONLY. These trusses are designed as individual building components to be incorporated into the building design at the specification of the building designer. See individual design sheets for each truss design identified on the placement drawing. The building designer is responsible for temporary and permanent bracing of the roof and floor system and for the overall structure. The design of the truss support structure including headers, beams, walls, and columns is the responsibility of the building designer. For general guidance regarding bracing, consult BCSI-B1 and BCSI-B3 provided with the truss delivery package or online @ sbcindustry.com

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BUILDER

North Carolina 2018 - R402.1.5 Total UA

Property

Cameron, NC 28326 Model: Taggart

Community: Liberty Meadows

Organization

Southern Energy Manager Justin Smith

Inspection Status
Results are projected



Builder

SMG Precision Properties

Template - SMG Precision - Liberty Meadows lot 15 - CZ 3 slab -Liberty Meadows lot 15

This report is based on a proposed design and does not confirm field enforcement of design elements.

Building UA

Elements	NC Reference	As Designed
Ceilings	48.2	45.8
Above-Grade Walls	195.8	145.4
Windows, Doors and Skylights	122.8	110.6
Slab Floor:	76.0	99.0
Framed Floors	17.5	19.1
Foundation Walls	0.0	0.0
Rim Joists	8.8	7.1
Overall UA (Design must be equal or lower):	469.1	427.0

Requirements

	402.1.5	Total UA alternative compliance passes by 9.0%.	
\bigcirc	402.3.2	Average SHGC: 0.28 Max SHGC: 0.30	
	R402.4.2.2	Air Leakage Testing	Air sealing is 4.80 ACH at 50 Pa. It must not exceed 5.00 ACH at 50 Pa.
	R402.5	Area-weighted average fenestration SHGC	
	R402.5	Area-weighted average fenestration U-Factor	
	R404.1	Lighting Equipment Efficiency	
	Mandatory Checklist	Mandatory code requirements that are not checked by Ekotrope must be met.	
	R403.3.1	Duct Insulation	
	403.3.3	Duct Testing	

Design exceeds requirements for North Carolina 2018 Prescriptive compliance by 9%.

Name:	Justin Smith	Signature:	Justin Smith
Organization:	Southern Energy Management	Digitally signed:	8/9/22 at 11:22 AM

Property Cameron, NC 28326 Model: Taggart Community: Liberty Meadows

Template - SMG Precision - Liberty Meadows lot 15 - CZ 3 slab - ecoSelect Liberty Meadows lot 15

Organization Southern Energy Management

Justin Smith

Builder

SMG Precision Properties

Inspection Status Results are projected



General Building Informati	ion
Number Of Bedrooms	3
Number Of Floors	2
Conditioned Floor Area [sq. ft.]	2,776
Has Electric Vehicle Ready Space	No
Unconditioned, attached garage?	Yes
Conditioned Volume [cu. ft.]	24,676
Total Units in Building	1
Residence Type	Single family detached
Number of Floors in Building	-
Floor Number	-
Model	Taggart
Community	Liberty Meadows
RESNET/IECC 2006 Climate Zone	4A
IECC 2021 Climate Zone	3A

_		4.8	100	-
	ID ALA	TION	3 \M/	211
Fou	III U a	шог	IVV	411

None Present

Foundation Wall Library List

None Present

Slab								
Name	e Library Type	e Perimeter	Floor Grade	Carpet R	Exposed Masonry Area	Surface Area	Location	Enclosing
slab	Uninsulated	158	On Grade	1	0	1,234.0 ft²	Exposed Exterior	Conditioned Space

Slab Library	List						
Name	Wall Construction Type	Slab Completely Insulated?			Perimeter Insulation R Value	Thermal Break	Effective R-value
Uninsulated	Wood Frame / Other	No	0	0	0	No	0.00

Property Cameron, NC 28326 Model: Taggart Community: Liberty Meadows

Template - SMG Precision - Liberty Meadows lot 15 - CZ 3 slab - ecoSelect Liberty Meadows lot 15

Organization Southern Energy Management Justin Smith

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SMG Precision Properties

Inspection Status Results are projected



	Framed Floo	r				
ı	Name	Library Type	Carpet R	Floor Grade	Surface Area	Location
ı	over ambiant	R 19, 16"OC G1 Carpet	0	Above Grade	242.0 ft²	Exposed Exterior
	over garage	R 19, 16"OC G1 Carpet	0	Above Grade	131.0 ft²	Unconditioned, attached garage

Framed Floor Library List

Effective R-value R 19, 16"OC G1 Carpet 19.566

Rim Joist								
Name	Library Type	Surface Area	Location					
1st floor ambient	R 19 G1, 16"OC	131.0 ft²	Exposed Exterior					
1st floor garage	R 19 G1, 16"OC	27.0 ft²	Unconditioned, attached garage					

Rim Joist Library List Effective Insulation R-value R 19 G1, 16"OC 17.30

Nall				
Name	Library Type	Surface Color	Surface Area	Locatio
1st floor ambient	R 19 Adv. Framing G1 16" O.C	Medium	1,179.0 ft²	Exposed Exterio
1st floor garage	R 19 Adv. Framing G1 16" O.C	Medium	243.0 ft²	Unconditioned, attached garage
2nd floor ambient	R 19 Adv. Framing G1 16" O.C	Medium	1,472.0 ft²	Exposed Exterio

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Builder SMG Precision Properties Inspection Status Results are projected



Wall Library List

Effective R-value R 19 Adv. Framing G1 16" O.C 17.492

Glazing									
Name	Library Type	Wall Assignment	Foundation Wall Assignment	ls Operable	Overhang Depth	Overhang Ft To O Top	verhang Ft To Bottom	Orientation	Surface Area
front 2nd unshaded	33/28	2nd floor ambient		Yes	0	0	0	West	50.7 ft²
front shaded	33/28	1st floor ambient		Yes	6	2	6	West	10.5 ft²
front unshaded	33/28	1st floor ambient		Yes	0	0	0	West	26.7 ft²
left 2nd unshaded	33/28	2nd floor ambient		Yes	0	0	0	North	26.7 ft²
left unshaded	33/28	1st floor ambient		Yes	0	0	0	North	13.4 ft²
rear 2nd unshaded	33/28	2nd floor ambient		Yes	0	0	0	East	63.9 ft²
rear unshaded	33/28	1st floor ambient		Yes	0	0	0	East	72.1 ft²
right shaded	33/28	1st floor ambient		Yes	13.5	2	9	South	33.4 ft²
right unshaded	33/28	2nd floor ambient		Yes	0	0	0	South	13.4 ft²

Glazing Library List							
Name	Shgc	U-factor					
33/28	0.28	0.330					

	Skylight	
ı	None Present	

Skylight Library List

None Present

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Builder

SMG Precision Properties

Inspection Status Results are projected



Opaque Doo	r							
Name	Library Type	Wall Assignment	Foundation Wall Assignment		Solar Absorptance		Surface Area	Location
front entry	Fiberglass R-5	1st floor ambient		0.9	0.75	Medium	20.0 ft²	Exposed Exterior
garage entry	Fiberglass R-5	1st floor garage		0.9	0.75	Medium	20.0 ft²	Unconditioned, attached garage

Opaque Door Library List				
Nam	ne Effective U-factor			
Fiberglass R-5	5 0.200			

Roof Insulation									
Name	Library Type	Attic Exterior Area [ft²]	Clay or Concrete Roof Tiles		Surface Area	Location			
attic	R 38 Attic BLOWN FG G1 2x10 24"OC NO Radiant Barrier	2,362.29	No	Dark	1,607.0 ft²	Attic			

Roof Insulation Library List					
Name	Has Radiant Barrier	Effective R-value			
R 38 Attic BLOWN FG G1 2x10 24"OC NO	No	35.115			

Whole House	Infiltration		
Infiltration	Measurement Type	Shelter Class	ss
1974 CFM at 50 Pa	Blower-door tested	4	4

Mechanical Ventilation

None Present

Property Cameron, NC 28326 Model: Taggart Community: Liberty Meadows

Template - SMG Precision - Liberty Meadows lot 15 - CZ 3 slab - ecoSelect Liberty Meadows lot 15

Organization Southern Energy Management Justin Smith

Builder

None Present

SMG Precision Properties

Inspection Status Results are projected



ı	Lighting						
•	% Interior Fluorescent Lighting		ighting % Exte	erior Fluorescent % Lighting	Exterior LED Lighting	% Garage Fluorescent Lighting	% Garage LED Lighting
	0		90	0	0	0	0
	L						
ı	Onsite Gener	ration					
ľ			None Prese	ent			
i	Onsite Gener	ration Library					
			None Prese	ent			
ı	Solar Genera	ation					
ĺ			None Prese	ent			
ı	Dehumidifier						
			None Prese	ent			
ı	Dehumidifier	Library List					
			None Prese	ent			
ı	Whole House	e Fan					

Property Cameron, NC 28326 Model: Taggart Community: Liberty Meadows

Template - SMG Precision - Liberty Meadows lot 15 - CZ 3 slab - ecoSelect Liberty Meadows lot 15

Organization Southern Energy Management Justin Smith



Builder

SMG Precision Properties

Whole House Fan Library List

None Present

Conditioning Equipment									
Name	Library Type	Serial Number	Heating Percent Load	Cooling Percent Load	i Hot Water Percent Load	Location			
1st floor heat pump	z 24k 14 SEER 8.2hspf		44%	44%	0%	Attic			
2nd floor heat pump	z 24k 14 SEER 8.2hspf		56%	56%	0%	Attic			
Water Heating	z 50 gal. 0.95 EF Elec		0%	0%	100%	Unconditioned Garage			

Inspection Status

Results are projected

Equipment Type: z 24k 14 SEER 8.2hspf		
Equipment Type	Air Source Heat Pump	
Fuel Type	Electric	
Distribution Type	Forced Air	
Motor Type	PSC (Single Speed)	
Heating Efficiency	8.2 HSPF	
Heating Capacity [kBtu/h]	24	
Backup Fuel Type	Electric	
Switchover Temperature [°F]	0	
Backup Heating Efficiency	1 COP	
Use default Supplemental Heat	Yes	
Cooling Efficiency	14 SEER	
Cooling Capacity [kBtu/h]	24	

Equipment Type: z 50 gal. 0.95 EF Elec		
Equipment Type	Residential Water Heater	
Fuel Type	Electric	
Distribution Type	Hydronic Delivery (Radiant)	
Hot Water Efficiency	0.95 Energy Factor	
Tank Capacity (gal.)	50	
Hot Water Capacity [kBtu/h]	40	
Recovery Efficiency	0.98	

Property Cameron, NC 28326 Model: Taggart Community: Liberty Meadows

Template - SMG Precision - Liberty Meadows lot 15 - CZ 3 slab - ecoSelect Liberty Meadows lot 15

Organization Southern Energy Management Justin Smith

Builder

SMG Precision Properties

Inspection Status Results are projected



Distribution System	
Distribution Type	Forced Air
Heating Equipment	1st floor heat pump
Cooling Equipment	1st floor heat pump
Sq. Feet Served	1,234
# Return Grilles	2
Supply Duct R Value	8
Return Duct R Value	8
Supply Duct Area [ft²]	333.18
Return Duct Area [ft²]	123.4
Leakage to Outdoors	49 CFM @ 25Pa (3.97 / 100 ft²)
Total Leakage	49 CFM25
Total Leakage Duct Test Conditions	Post-Construction
Use Default Flow Rate	Yes
Duct 1	
Duct Location	Attic (well vented)
Percent Supply Area	70
Percent Return Area	70
Duct 2	
Duct Location	Conditioned Space
Percent Supply Area	30
Percent Return Area	30
Duct 3	
Duct Location	Conditioned Space
Percent Supply Area	0
Percent Return Area	0
Duct 4	
Duct Location	Conditioned Space
Percent Supply Area	0
Percent Return Area	0
Duct 5	0 10 10
Duct Location	Conditioned Space
Percent Supply Area	0
Percent Return Area	0
Duct 6	Conditioned Conse
Duct Location	Conditioned Space
Percent Supply Area	0
Percent Return Area	0

Property Cameron, NC 28326 Model: Taggart Community: Liberty Meadows

Template - SMG Precision - Liberty Meadows lot 15 - CZ 3 slab - ecoSelect Liberty Meadows lot 15

Organization

Southern Energy Management Justin Smith

Inspection Status

Results are projected

Builder

SMG Precision Properties



Distribution System	
Distribution Type	Forced Air
Heating Equipment	2nd floor heat pump
Cooling Equipment	2nd floor heat pump
Sq. Feet Served	1,542
# Return Grilles	2
Supply Duct R Value	8
Return Duct R Value	8
Supply Duct Area [ft²]	416.34
Return Duct Area [ft²]	154.2
Leakage to Outdoors	61 CFM @ 25Pa (3.96 / 100 ft²)
Total Leakage	61 CFM25
Total Leakage Duct Test Conditions	Post-Construction
Use Default Flow Rate	Yes
Duct 1	
Duct Location	Attic (well vented)
Percent Supply Area	100
Percent Return Area	100
Duct 2	
Duct Location	Conditioned Space
Percent Supply Area	0
Percent Return Area	0
Duct 3	
Duct Location	Conditioned Space
Percent Supply Area	0
Percent Return Area	0
Duct 4	
Duct Location	Conditioned Space
Percent Supply Area	0
Percent Return Area	0
Duct 5	
Duct Location	Conditioned Space
Percent Supply Area	0
Percent Return Area	0
Duct 6	
Duct Location	Conditioned Space
Percent Supply Area	0
Percent Return Area	0

HVAC Grading

HVAC Grading Not Conducted

Ceiling Fan		
Has Ceiling Fan	No	
Cfm Per Watt	100	

Property Cameron, NC 28326 Model: Taggart Community: Liberty Meadows

Template - SMG Precision - Liberty Meadows lot 15 - CZ 3 slab - ecoSelect Liberty Meadows lot 15

Organization Southern Energy Management Justin Smith

Builder

SMG Precision Properties





Water Distribution	
Water Fixture Type	Low-flow
Use Default Hot Water Pipe Length	No
Hot Water Pipe Length [ft]	92
At Least R3 Pipe Insulation?	No
Hot Water Recirculation System?	No
Recirculation System Pipe Loop Length [ft]	20
Drain Water Heat Recovery?	No

Clothes Dryer	
Cef	3.01
Fuel Type	Electric
Field Utilization	Timer Controls
Is Outside Conditioned Space	No
Clothes Dryer Available	Yes
Defaults Type	HERS Reference

Clothes Washer		
Label Energy Rating	153 kWh/Year	
Annual Gas Cost	\$12.00	
Electric Rate	\$0.11/kWh	
Gas Rate	\$1.22/Therm	
Capacity	3.31	
Imef	2.1547	
Defaults Type	Custom	
Load Type	Front-load	
Loads Per Week	6	
Is Outside Conditioned Space	No	
Clothes Washer Available	Yes	

Dishwasher	
Dishwasher Efficiency	270 kWh
Dishwasher Size	Standard
Annual Gas Cost	\$22.23
Electric Rate	\$0.12/kWh
Gas Rate	\$1.09/Therm
Is Outside Conditioned Space	No

Property Cameron, NC 28326 Model: Taggart Community: Liberty Meadows

- CZ 3 slab - ecoSelect Liberty Meadows lot 15

Template - SMG Precision - Liberty Meadows lot 15

Organization

Southern Energy Management Justin Smith

Builder

SMG Precision Properties





Appliances and Controls	
Thermostat Cooling Setpoint	* * * * 75.0
Thermostat Heating Setpoint	* * * * 70.0
Range/Oven Fuel	Electric
Convection Oven?	No
Induction Range?	No
Range/Oven Outside Conditioned Space?	No
Refrigerator Consumption	538 kWh/Year
Refrigerator Outside Conditioned Space?	No

Notes

Initial Inputs _____MS 07/05/22_

- -confirm HVAC specs
- -confirm water heater specs
- -confirm ventilation entry, modeled as air cycler
- -modeled to worst case orientation
- -confirm cfl lighting %