dowds **DESIGN COLLECTION, LLC**

> 1331 SAINT ANDREWS DR. **MEBANE, NC 27302** PHONE: 919-563-1818 LAURA.DOWDS1966@OUTLOOK.COM WWW.DOWDSHOUSEPLANS.COM



MONA SHIR WEST HAVEN, CT mona.pro.shir@outlook.com 443 962 1396

RESIDENCE

EARNHARDT


EVERY ATTEMPT HAS BEEN MADE IN THE PREPARATION OF THESE DRAWINGS TO AVOID MISTAKES. THE DESIGNER, OR ANYONE ASSOCIATED WITH THE DESIGNER, WILL NOT BE HELD LIABLE FOR ANY ERRORS OR OMISSIONS IN THESE DRAWINGS

ALL DRAWINGS SHOULD BE
REVIEWED BY LOCAL PROFESSIONAL
TO ASSURE CONFORMANCE WITH
LOCAL & STATE CODES.
ADDITIONAL ENGINEERING WORK IS
THE RESPONSIBILITY OF THE
CLIENT.

DATE/DESCRIPTION

PLAN NUMBER

0CS

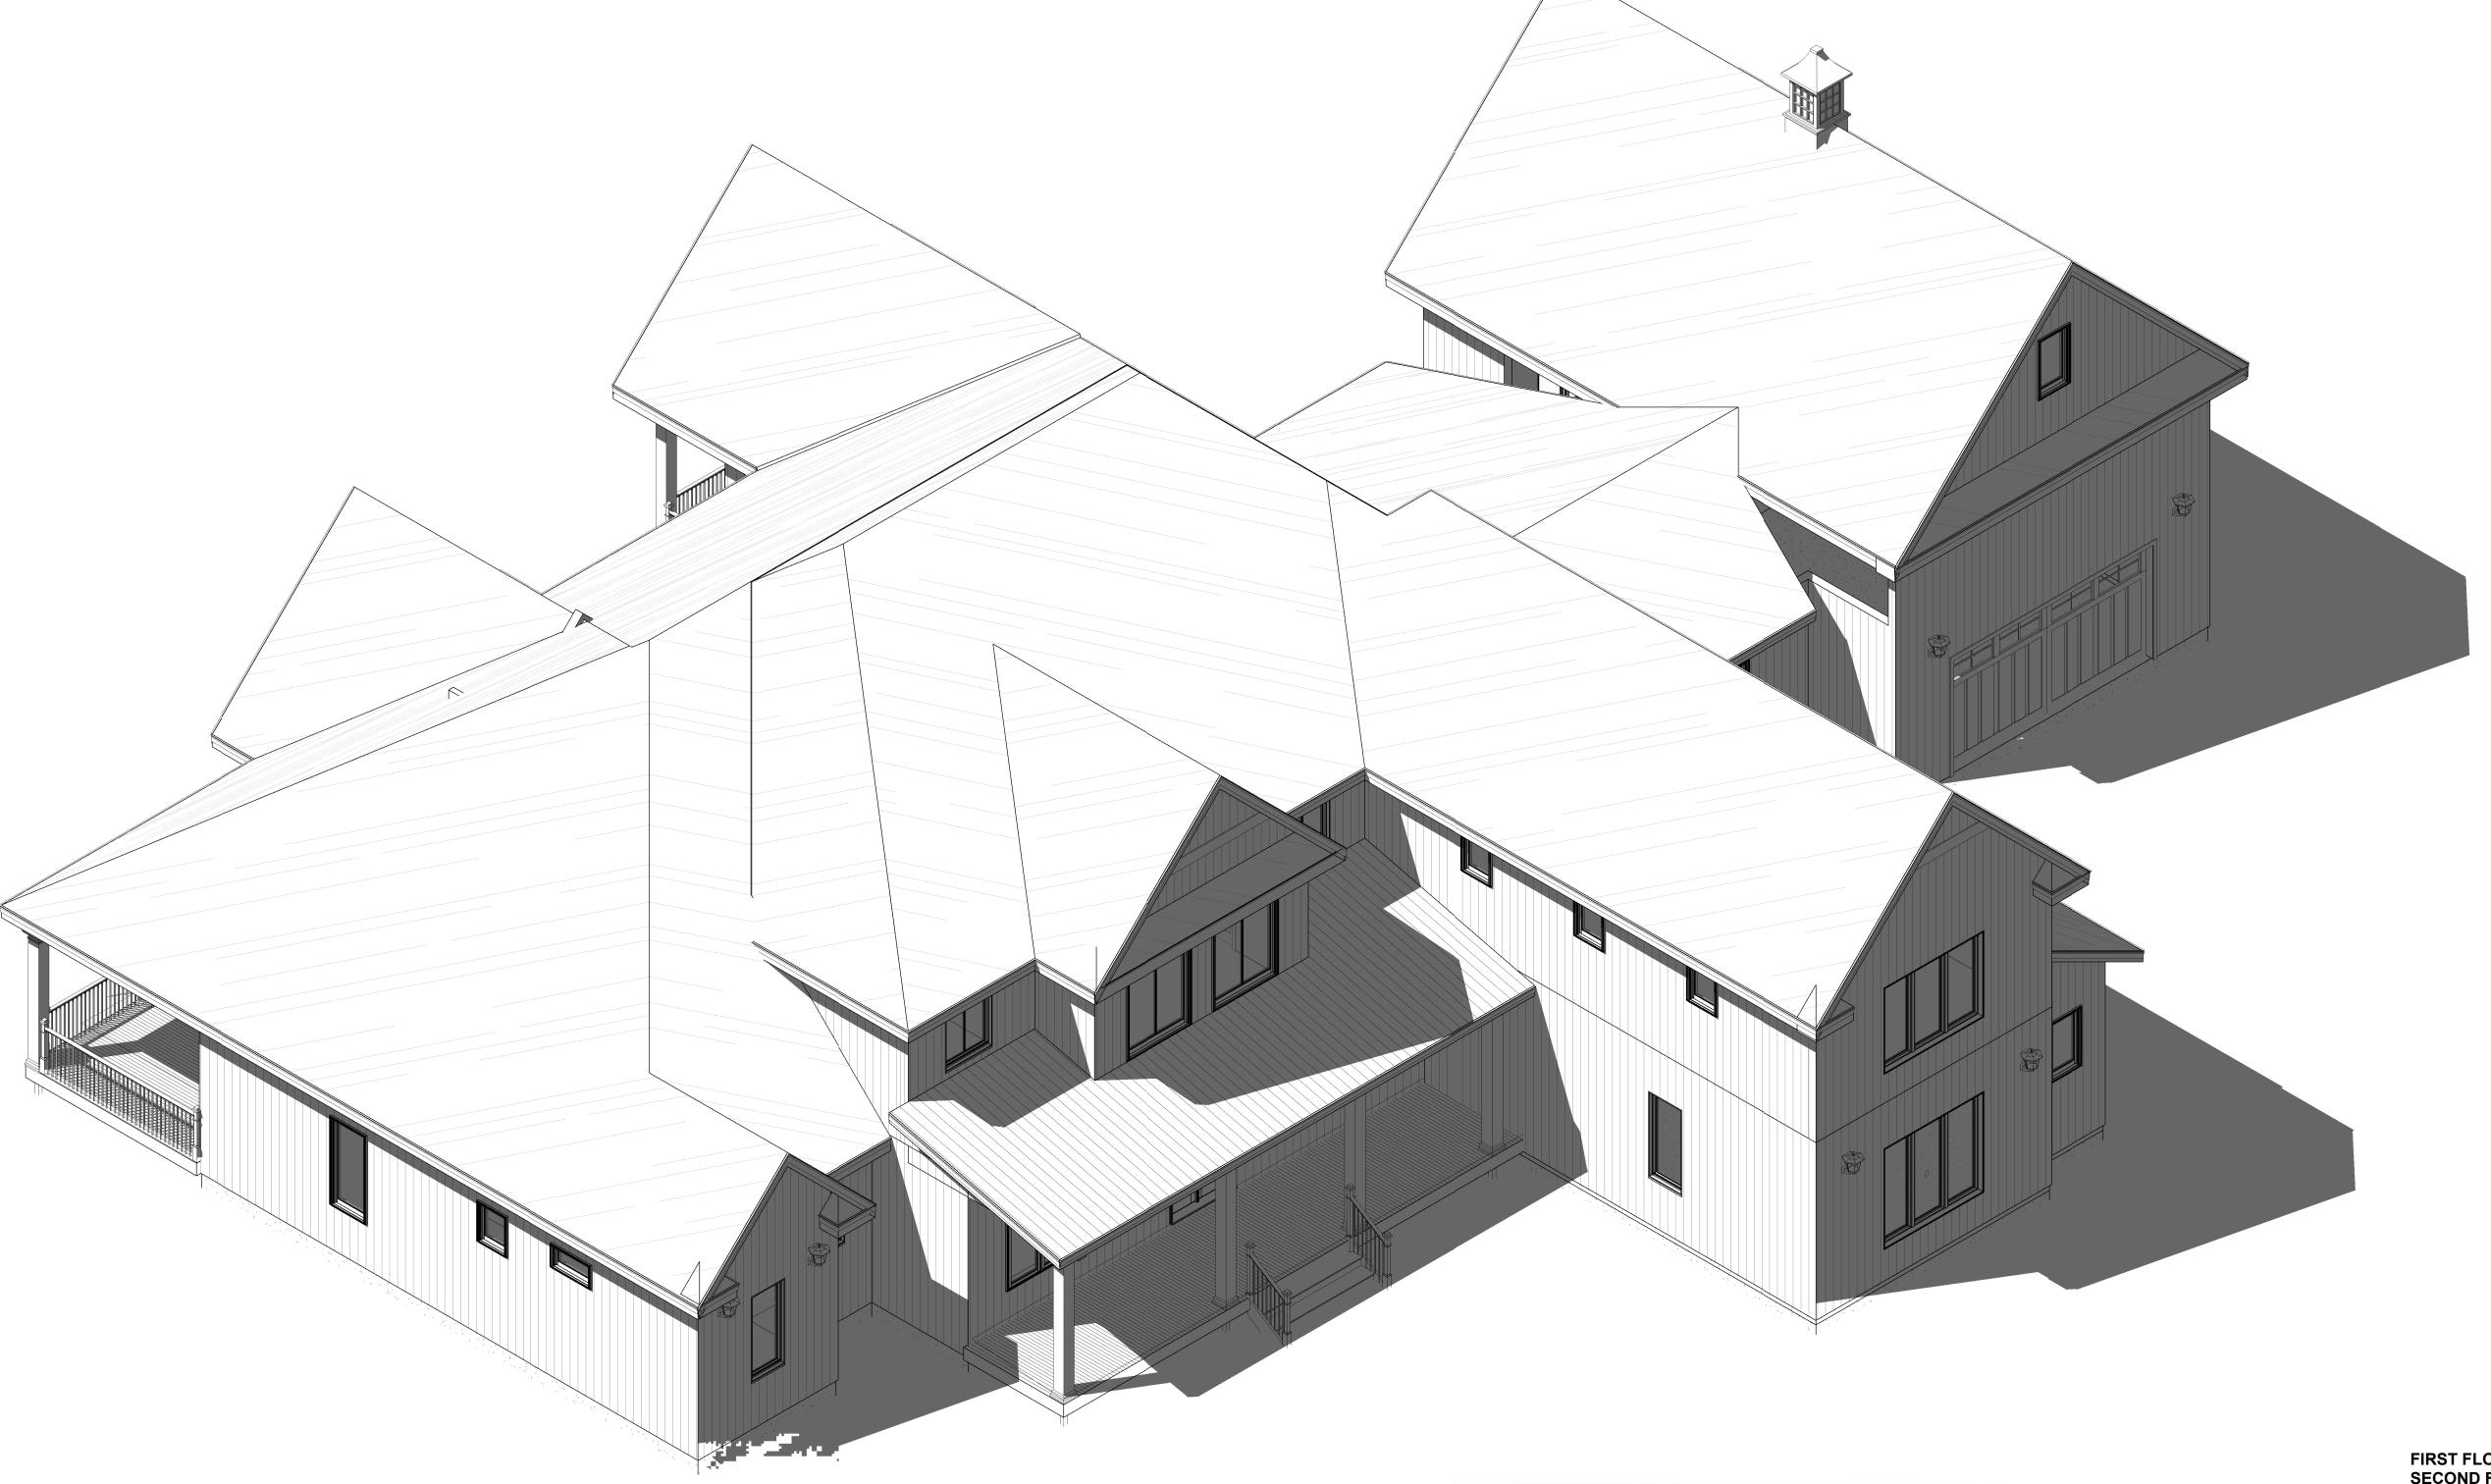


1 AERIAL

Dowds Design Collection, LLC. is a house plan design company and not structural engineers. The including structure, foundation, windows, and doors are a guide only for construction and all dimensions and notations attached need to be verified & confirmed by a structural engineer.



FIRST FLOOR SF - 4,121 SF SECOND FLOOR SF - 974 SF FRONT PORCH SF - 307 SF REAR PORCHES SF - 732 SF DOUBLE GARAGE SF - 972 SF SINGLE GARAGE SF - 610 SF STORAGE SF - 319 SF **UNFINISHED BONUS SF - 917 SF**

TOTAL HEATED 5,095 SF TOTAL UNHEATED 3,847 SF

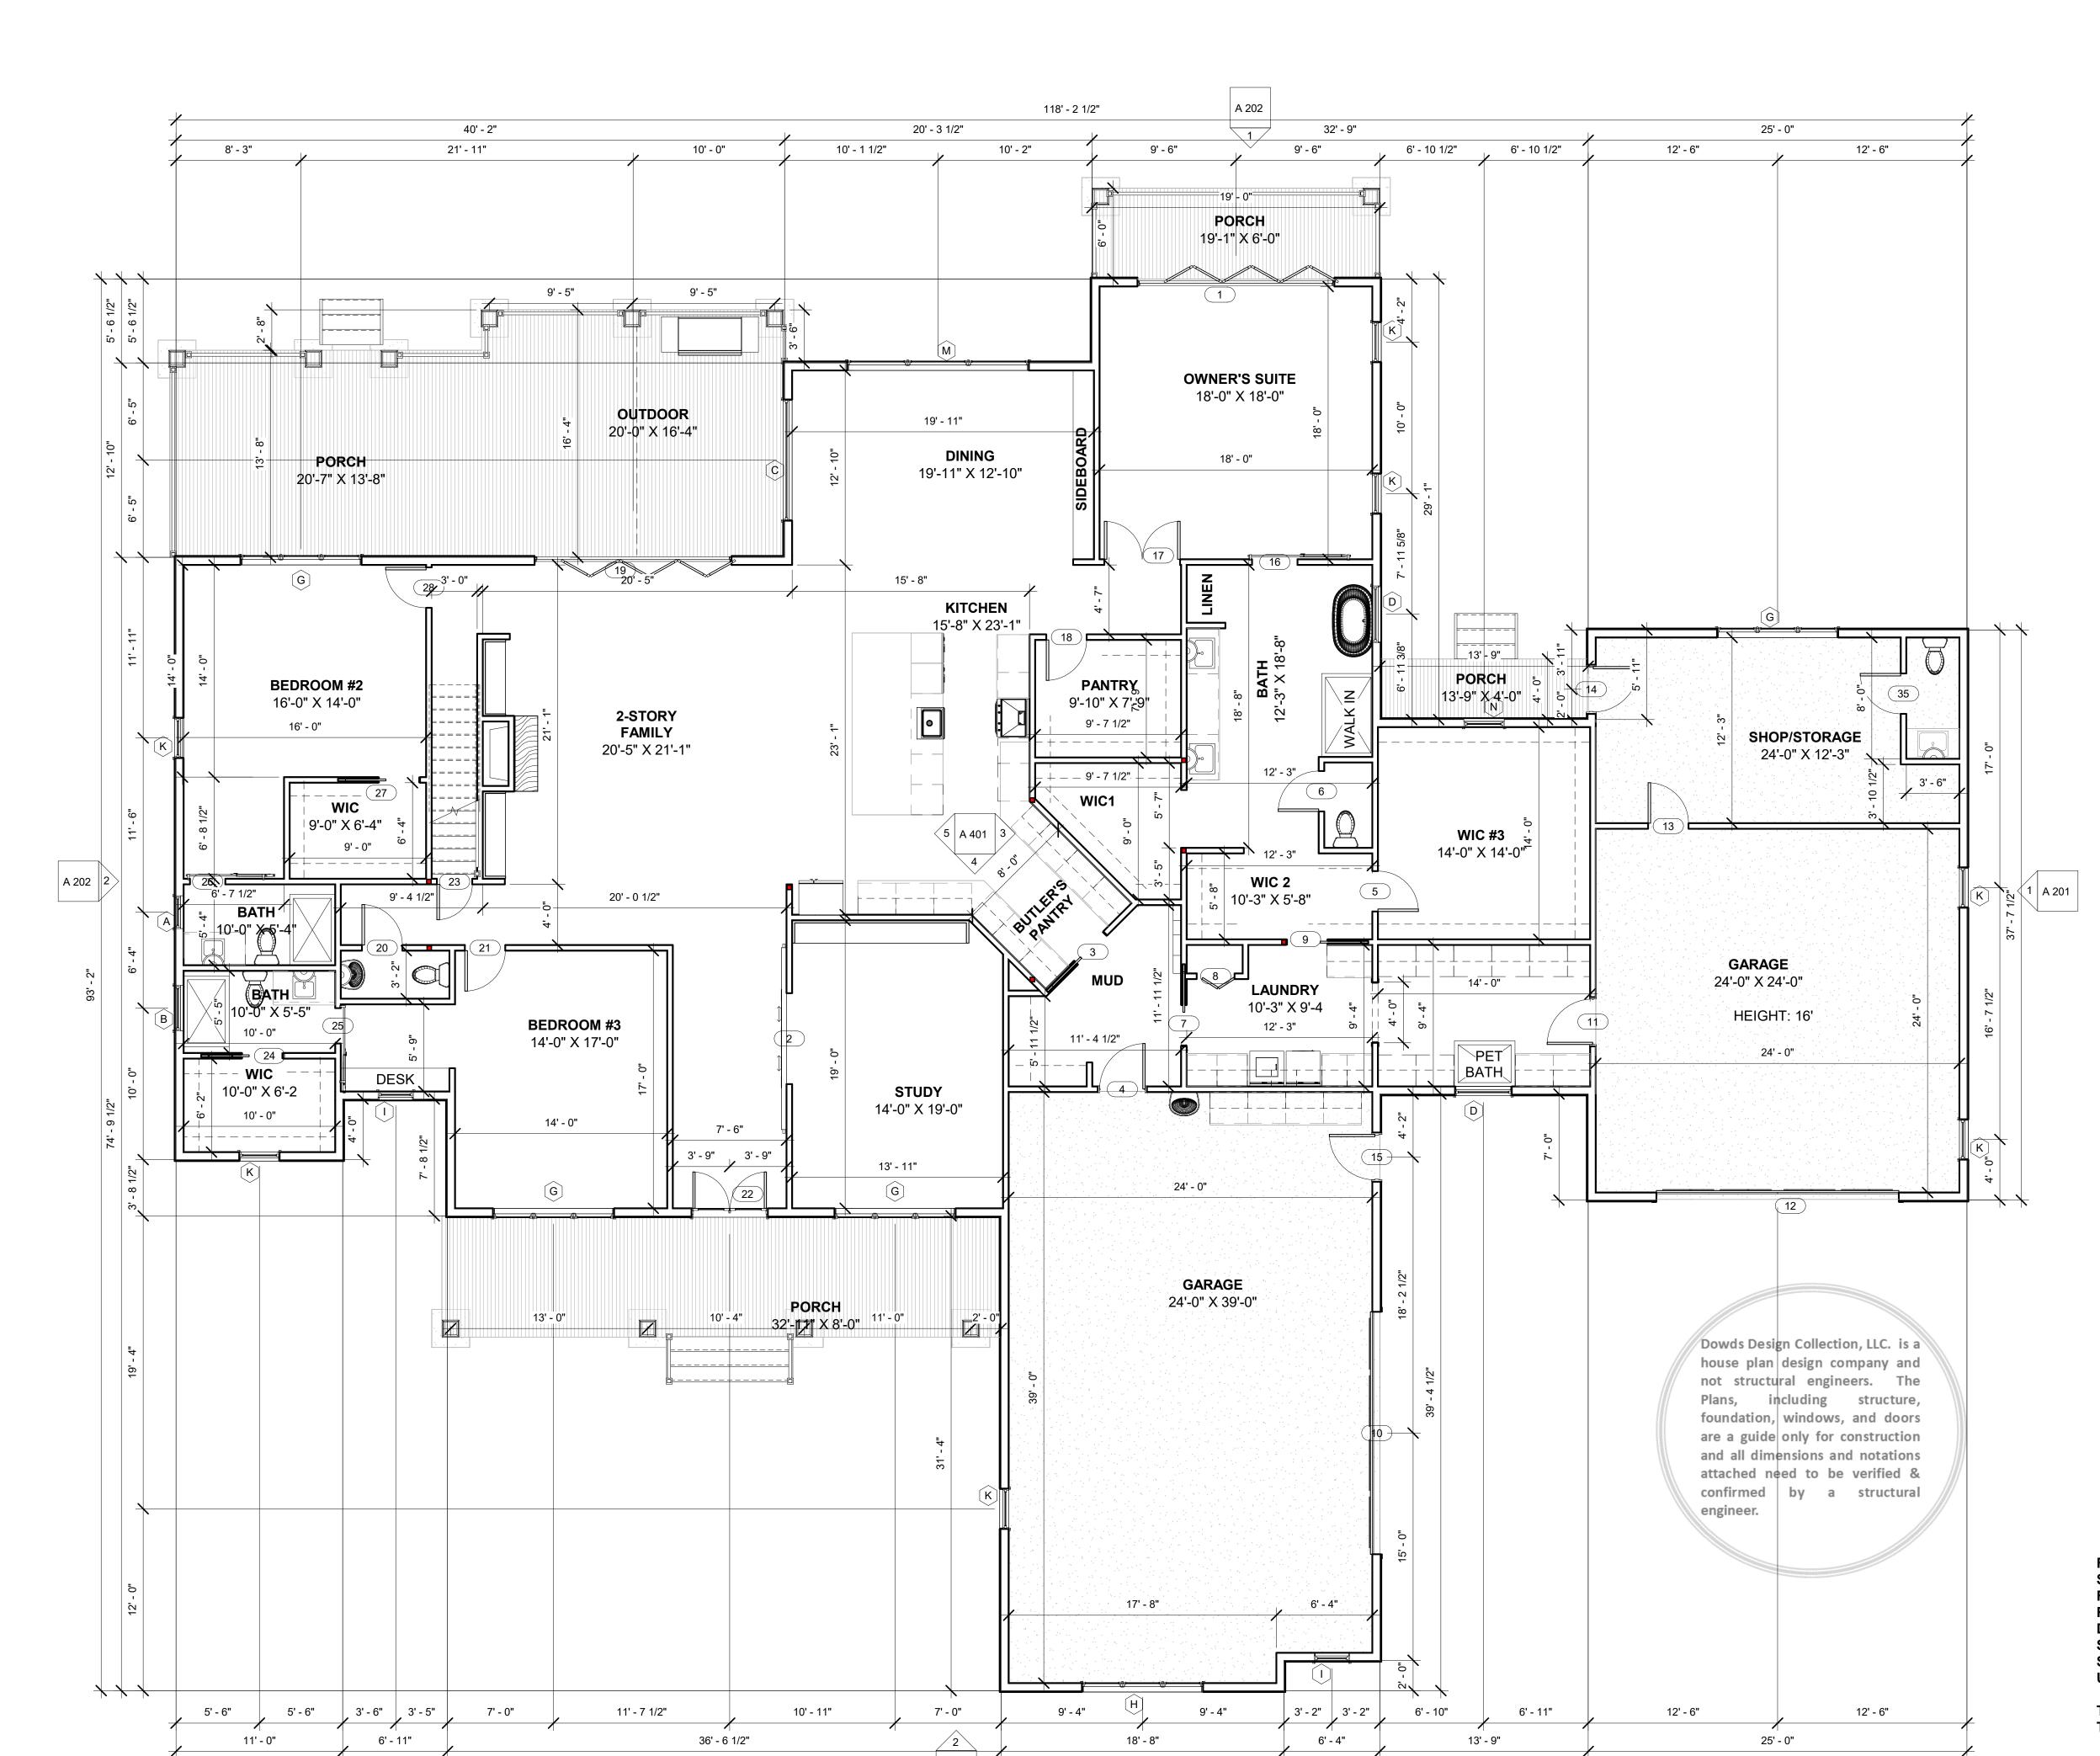

A 201

1 FIRST FLOOR 3/16" = 1'-0"



1331 SAINT ANDREWS DR.

MEBANE, NC 27302

PHONE: 919-563-1818

LAURA.DOWDS1966@OUTLOOK.COM


WWW.DOWDSHOUSEPLANS.COM

Mark 1 2	Type ACCARDIAN 13068	Width	Height
	ACCAPDIAN 13068		-
	ACCARDIAN 13000	13' - 0"	6' - 8"
_	6' Opening	6' - 0"	8' - 0"
3	2868 POCKET	2' - 8"	6' - 8"
4	3080 ENTRY	3' - 0"	8' - 0"
5	2868	2' - 8"	6' - 8"
6	2868	2' - 8"	6' - 8"
7	2868 POCKET	2' - 8"	6' - 8"
8	30" x 80"	2' - 6"	6' - 8"
9	2868 POCKET	2' - 8"	6' - 8"
10	16/0x8/0	16' - 0"	8' - 0"
11	3080 ENTRY	3' - 0"	8' - 0"
12	16/0x8/0	16' - 0"	8' - 0"
13	2868	2' - 8"	6' - 8"
14	3080 ENTRY	3' - 0"	8' - 0"
15	3080 ENTRY	3' - 0"	8' - 0"
16	BARN	3' - 0"	6' - 8"
17	5068 DOUBLE	5' - 0"	6' - 8"
18	2868	2' - 8"	6' - 8"
19	ACCARDIAN 13068	13' - 0"	6' - 8"
20	2868	2' - 8"	6' - 8"
21	2868	2' - 8"	6' - 8"
22	5068 FRENCH	5' - 0"	6' - 8"
23	2468	2' - 4"	6' - 8"
24	2868 POCKET	2' - 8"	6' - 8"
25	BARN 2468	2' - 4"	6' - 8"
26	BARN 2468	2' - 4"	6' - 8"
27	2868 POCKET	2' - 8"	6' - 8"
28	2868	2' - 8"	6' - 8"
29	2868	2' - 8"	6' - 8"
30	2868	2' - 8"	6' - 8"
31	5068 DOUBLE	5' - 0"	6' - 8"
32	2868	2' - 8"	6' - 8"
33	BARN	3' - 0"	6' - 8"
34	2868	2' - 8"	6' - 8"
35	2868	2' - 8"	6' - 8"

	Winde	ow Schedule	
Type Mark	Rough Width	Rough Height	Туре
Α	2' - 2 1/2"	2' - 8 1/2"	2228
В	3' - 0 1/2"	1' - 6 1/2"	3016 FIXED
С	8' - 0 1/2"	7' - 0 1/2"	4070
D	3' - 9 1/2"	4' - 6 1/2"	3946
E	8' - 0 1/2"	5' - 0 1/2"	3-2850
F	8' - 0 1/2"	1' - 5 1/2"	3-2815 AWNING
G	8' - 0 1/2"	6' - 0 1/2"	3-2860
Н	8' - 0 1/2"	7' - 0 1/2"	3-2870
I	2' - 4 1/2"	4' - 0 1/2"	2440
J	5' - 0 1/2"	6' - 1 1/2"	5061
K	2' - 8 1/2"	6' - 0 1/2"	2860
L	2' - 10 1/2"	2' - 10 1/2"	210210 FIXED
M	12' - 0 1/2"	7' - 0 1/2"	3-4070
N	2' - 8 1/2"	3' - 0 1/2"	2830
0	3' - 9 1/2"	4' - 0 1/2"	3940

FIRST FLOOR SF - 4,121 SF SECOND FLOOR SF - 974 SF FRONT PORCH SF - 307 SF REAR PORCHES SF - 732 SF DOUBLE GARAGE SF - 972 SF SINGLE GARAGE SF - 610 SF STORAGE SF - 319 SF UNFINISHED BONUS SF - 917 SF

TOTAL HEATED 5,095 SF TOTAL UNHEATED 3,847 SF

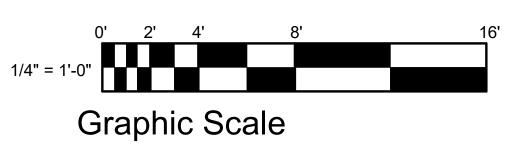

ZAR İAR

MONA SHIR WEST HAVEN, CT

mona.pro.shir@outlook.com 443 962 1396

RESIDENCE

ARNE

FIRST FLOOR PLAN

EVERY ATTEMPT HAS BEEN MADE IN
THE PREPARATION OF THESE
DRAWINGS TO AVOID MISTAKES.
THE DESIGNER, OR ANYONE
ASSOCIATED WITH THE DESIGNER,
WILL NOT BE HELD LIABLE FOR ANY
ERRORS OR OMISSIONS IN THESE
DRAWINGS

ALL DRAWINGS SHOULD BE
REVIEWED BY LOCAL PROFESSIONAL
TO ASSURE CONFORMANCE WITH
LOCAL & STATE CODES.
ADDITIONAL ENGINEERING WORK IS
THE RESPONSIBILITY OF THE
CLIENT.

REVISIONS

O DATE/DESCRIPTION

DATE PLAN NUMBER

ELT WOMB EN

	Door Schedul	е	
Mark	Туре	Width	Heigh
4	ACCADDIAN 42060	421 0"	C! O"
1	ACCARDIAN 13068	13' - 0"	6' - 8"
3	6' Opening	6' - 0"	8' - 0"
	2868 POCKET 3080 ENTRY	2' - 8"	6' - 8"
5		3' - 0"	8' - 0"
	2868	2' - 8"	6' - 8"
7	2868	2' - 8"	6' - 8"
	2868 POCKET	2' - 8"	6' - 8"
8	30" x 80"	2' - 6"	6' - 8"
9	2868 POCKET	2' - 8"	6' - 8"
10	16/0x8/0	16' - 0"	8' - 0"
11	3080 ENTRY	3' - 0"	8' - 0"
12	16/0x8/0	16' - 0"	8' - 0"
13	2868	2' - 8"	6' - 8"
14	3080 ENTRY	3' - 0"	8' - 0"
15	3080 ENTRY	3' - 0"	8' - 0"
16	BARN	3' - 0"	6' - 8"
17	5068 DOUBLE	5' - 0"	6' - 8"
18	2868	2' - 8"	6' - 8"
19	ACCARDIAN 13068	13' - 0"	6' - 8"
20	2868	2' - 8"	6' - 8"
21	2868	2' - 8"	6' - 8"
22	5068 FRENCH	5' - 0"	6' - 8"
23	2468	2' - 4"	6' - 8"
24	2868 POCKET	2' - 8"	6' - 8"
25	BARN 2468	2' - 4"	6' - 8"
26	BARN 2468	2' - 4"	6' - 8"
27	2868 POCKET	2' - 8"	6' - 8"
28	2868	2' - 8"	6' - 8"
29	2868	2' - 8"	6' - 8"
30	2868	2' - 8"	6' - 8"
31	5068 DOUBLE	5' - 0"	6' - 8"
32	2868	2' - 8"	6' - 8"
33	BARN	3' - 0"	6' - 8"
34	2868	2' - 8"	6' - 8"
35	2868	2' - 8"	6' - 8"

	Wind	ow Schedule	
Type Mark	Rough Width	Rough Height	Туре
Α	2' - 2 1/2"	2' - 8 1/2"	2228
В	3' - 0 1/2"	1' - 6 1/2"	3016 FIXED
С	8' - 0 1/2"	7' - 0 1/2"	4070
D	3' - 9 1/2"	4' - 6 1/2"	3946
E	8' - 0 1/2"	5' - 0 1/2"	3-2850
F	8' - 0 1/2"	1' - 5 1/2"	3-2815 AWNING
G	8' - 0 1/2"	6' - 0 1/2"	3-2860
Н	8' - 0 1/2"	7' - 0 1/2"	3-2870
I	2' - 4 1/2"	4' - 0 1/2"	2440
J	5' - 0 1/2"	6' - 1 1/2"	5061
K	2' - 8 1/2"	6' - 0 1/2"	2860
L	2' - 10 1/2"	2' - 10 1/2"	210210 FIXED
M	12' - 0 1/2"	7' - 0 1/2"	3-4070
N	2' - 8 1/2"	3' - 0 1/2"	2830
0	3' - 9 1/2"	4' - 0 1/2"	3940

Dowds Design Collection, LLC. is a house plan design company and not structural engineers. The including structure, foundation, windows, and doors are a guide only for construction and all dimensions and notations attached need to be verified & confirmed by a structural engineer.

dowds DESIGN COLLECTION, LLC

Graphic Scale

1331 SAINT ANDREWS DR. **MEBANE, NC 27302** PHONE: 919-563-1818 LAURA.DOWDS1966@OUTLOOK.COM WWW.DOWDSHOUSEPLANS.COM

ZAR İAR

MONA SHIR WEST HAVEN, CT mona.pro.shir@outlook.com 443 962 1396

\overline{O}	
Z	
Щ	
S	
M M	
T	
\preceq	
与	
8	
∀	

SECOND FLOOR PLAN

EVERY ATTEMPT HAS BEEN MADE IN THE PREPARATION OF THESE DRAWINGS TO AVOID MISTAKES. THE DESIGNER, OR ANYONE ASSOCIATED WITH THE DESIGNER, WILL NOT BE HELD LIABLE FOR ANY ERRORS OR OMISSIONS IN THESE DRAWINGS

ALL DRAWINGS SHOULD BE
REVIEWED BY LOCAL PROFESSIONAL
TO ASSURE CONFORMANCE WITH
LOCAL & STATE CODES.
ADDITIONAL ENGINEERING WORK IS
THE RESPONSIBILITY OF THE
CLIENT.

DATE/DESCRIPTION

PLAN NUMBER

A 102

14' - 2" ⁵ 14'-2" X 13'-10" HOME OFFICE 8'-9" X 14'-0" 9' - 9" BATH BEDROOM#4 ⁼; 9'-9" X 9'-3" 16'-5" X 15'-11" **UNFINISHED BONUS** 17'-8" X 48'-6" 17' - 8" 4' - 9" 4' - 9" 5' - 4 1/2" 6' - 11" 9' - 4" 9' - 6" 10' - 1 1/2" 16' - 11"

1 SECOND FLOOR 3/16" = 1'-0"

FIRST FLOOR SF - 4,121 SF

FRONT PORCH SF - 307 SF **REAR PORCHES SF - 732 SF DOUBLE GARAGE SF - 972 SF** SINGLE GARAGE SF - 610 SF

STORAGE SF - 319 SF

SECOND FLOOR SF - 974 SF

UNFINISHED BONUS SF - 917 SF

TOTAL HEATED 5,095 SF TOTAL UNHEATED 3,847 SF

PROVIDE FIRE BLOCKING IN CONCEALED SPACES OF STUDS VERTICALLY AT CEILING AND FLOOR LEVELS

HORIZONTALLY AT INTERVALS NOT EXCEEDING 10' - 0" AT ALL INTERCONNECTIONS BETWEEN CONCEALED VERTICAL AND HORZONTAL SPACES IN SPACES BETWEEN STAIR STRINGERS AT TOP AND BOTTOM OF RUN AT OPENINGS AROUND VENTS, PIPES AND DUCTS AT CEILING AND FLOOR LEVELS

ALL RIDGE, VALLEY AND RAFTER BRACING TO BEAR ON LOAD BEARING WALLS DESIGNED TO CARRY LOAD THROUGH ALL LEVELS AND TERMINATE AT FOUNDATION DESIGNED TO CARRY LOAD.

FIELD VERIFY ALL BEARING HEIGHTS

NOTE:

VENTILATION SHALL COMPLY WITH CODE. ENCLOSED ATTICS AND ENCLOSED RAFTER SPACES FORMED WHERE CEILINGS ARE APPLIED DIRECTLY TO THE UNDERSIDE OF ROOF RAFTERS SHALL HAVE CROSS VENTILATION FOR EACH SEPARATE SPACE BY VENTILATION OPENINGS PROTECTED AGAINST THE ENTRANCE OF RAIN OR SNOW. VENTILATING OPENINGS SHALL BE PROVIDED WITH CORROSION-RESISTANT WIRE MESH.

SEE SHEET S105 FOR ROOF FRAMING SIZES (STICK BUILT)

ROOF OVERHANG IS 1'- 4" **UNLESS NOTED OTHERWISE**

PROVIDE RIDGE VENTS AS CALCULATED TO MEET CODE

Dowds Design Collection, LLC. is a house plan design company and not structural engineers. The including structure, foundation, windows, and doors are a guide only for construction and all dimensions and notations attached need to be verified & by a structural confirmed engineer.

dowds

DESIGN COLLECTION, LLC

1331 SAINT ANDREWS DR. MONA SHIR WEST HAVEN, CT **MEBANE, NC 27302** PHONE: 919-563-1818 LAURA.DOWDS1966@OUTLOOK.COM

SIDENCE ROOF

EARNE


EVERY ATTEMPT HAS BEEN MADE IN THE PREPARATION OF THESE DRAWINGS TO AVOID MISTAKES. THE DESIGNER, OR ANYONE ASSOCIATED WITH THE DESIGNER, WILL NOT BE HELD LIABLE FOR ANY ERRORS OR OMISSIONS IN THESE DRAWINGS

ALL DRAWINGS SHOULD BE
REVIEWED BY LOCAL PROFESSIONAL
TO ASSURE CONFORMANCE WITH
LOCAL & STATE CODES.
ADDITIONAL ENGINEERING WORK IS
THE RESPONSIBILITY OF THE
CLIENT.

REVISIONS DATE/DESCRIPTION

PLAN NUMBER

Graphic Scale

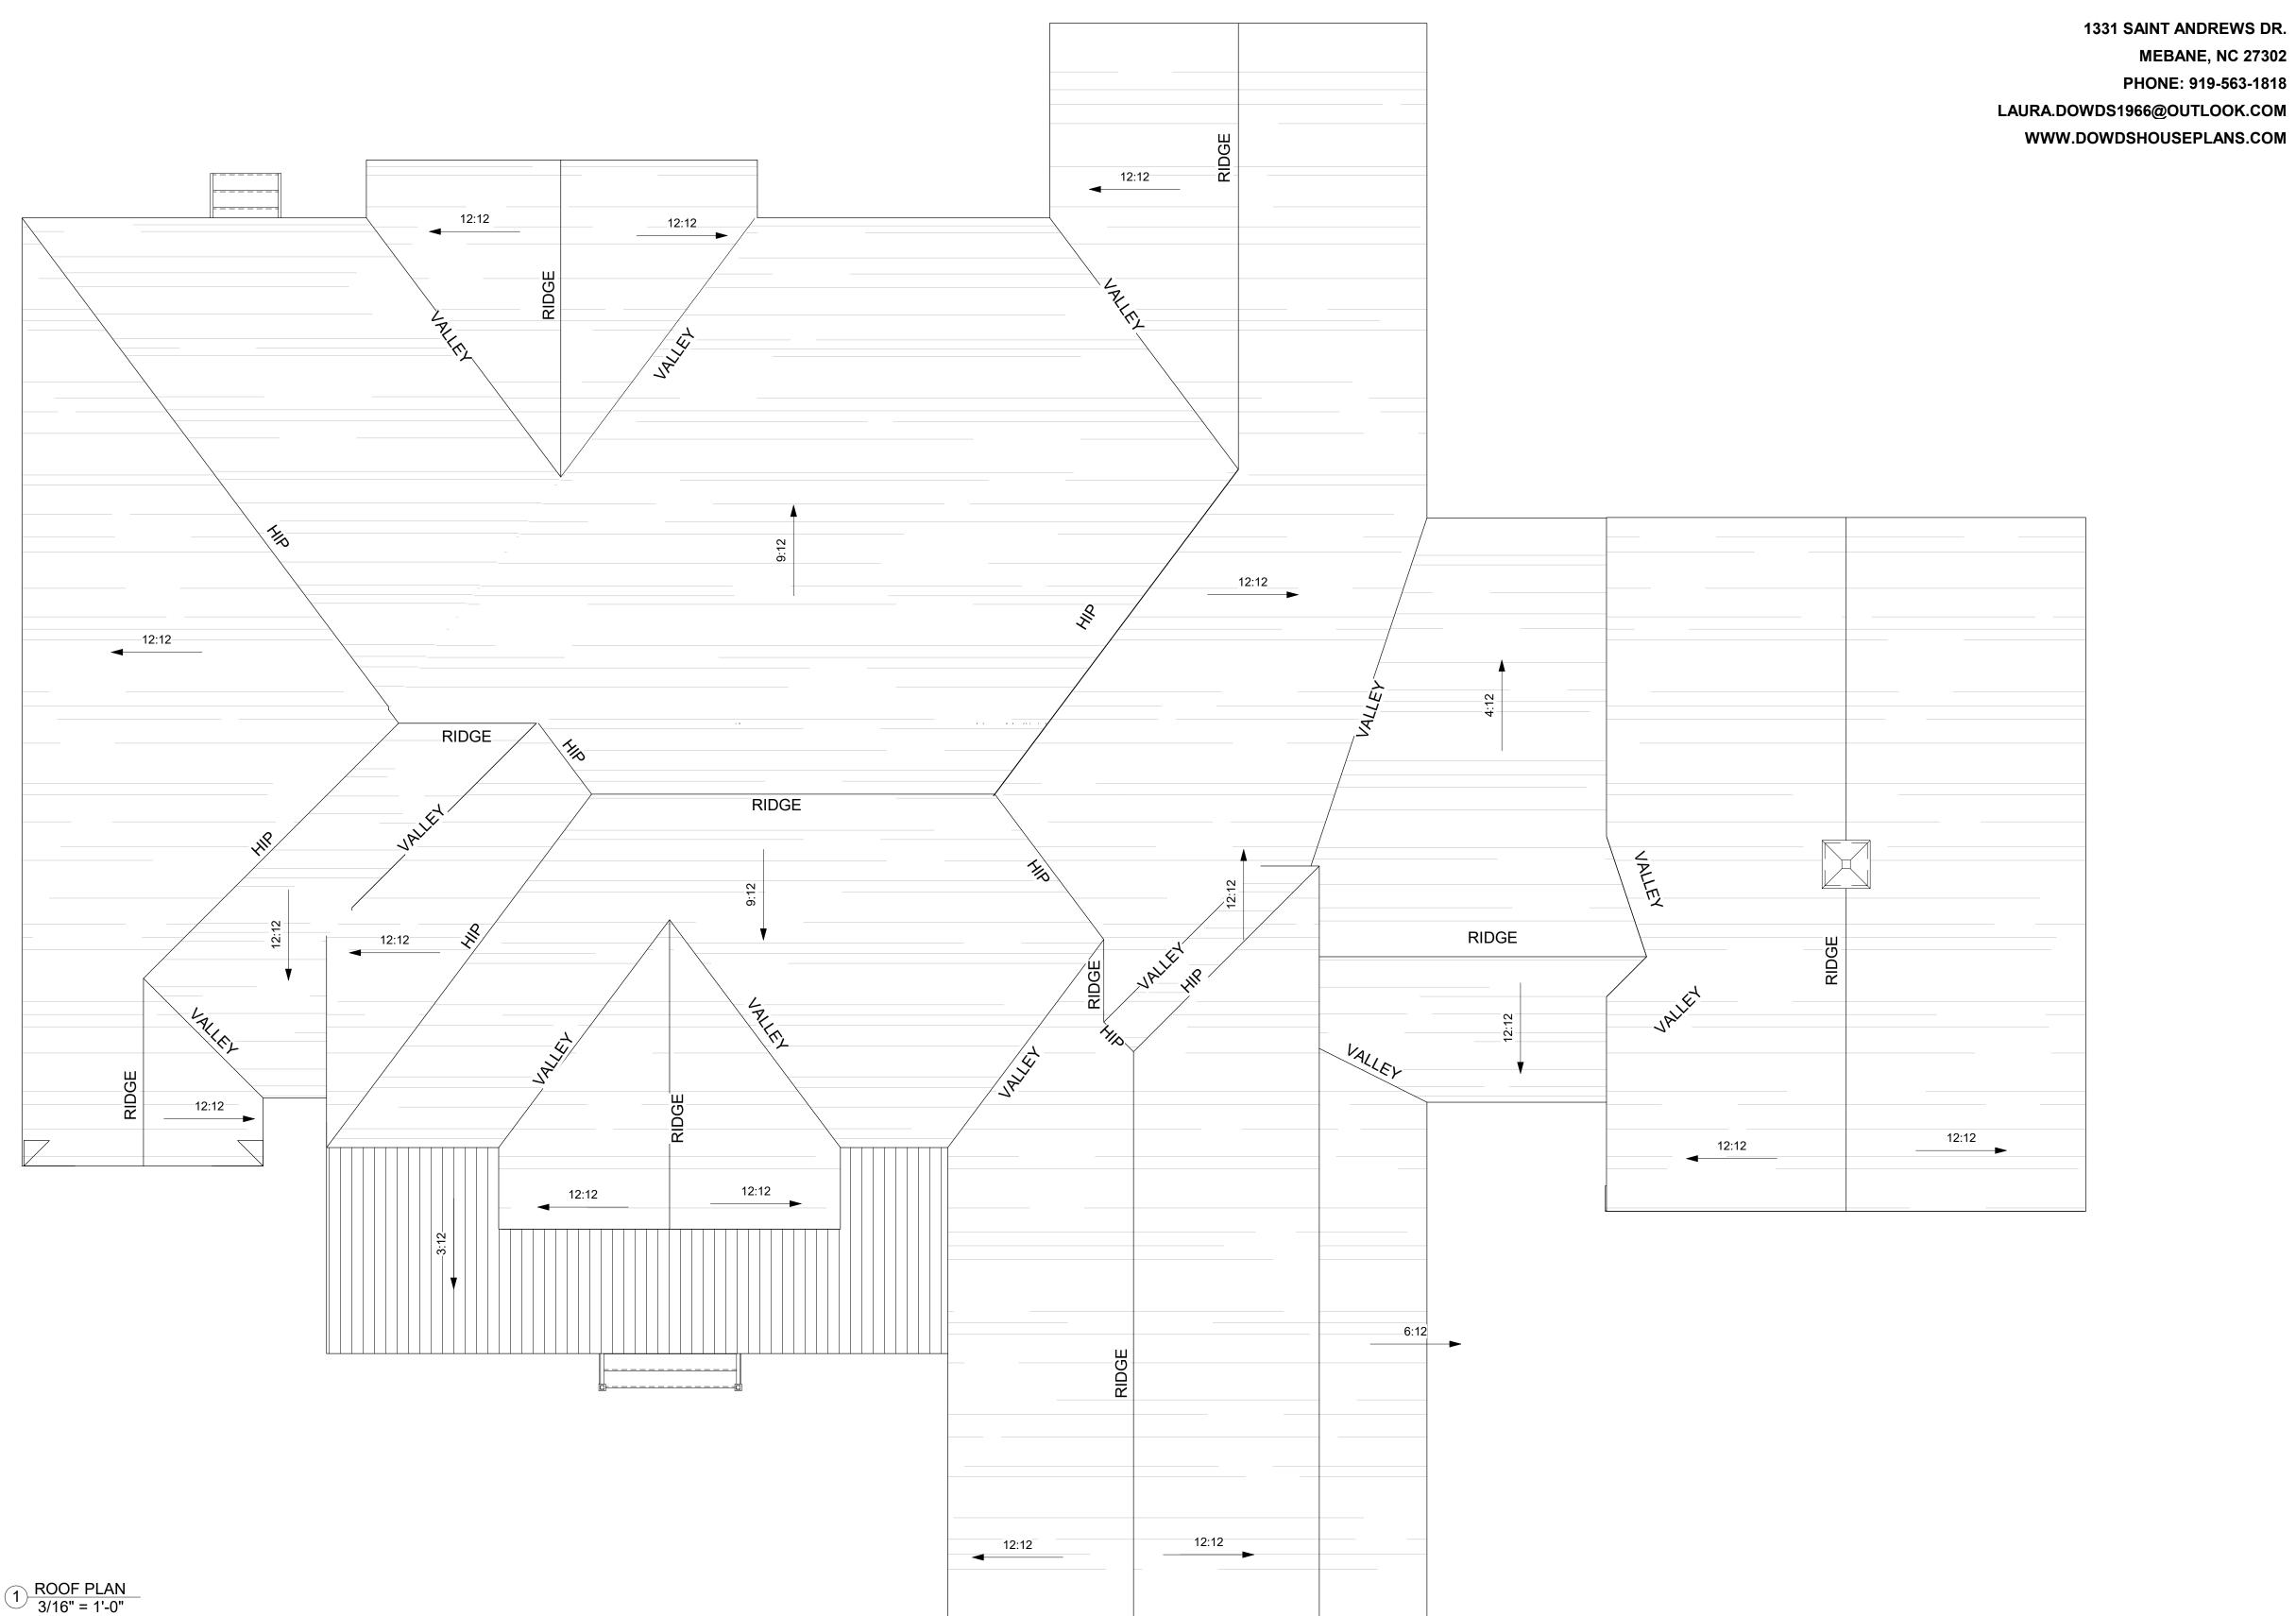

1 RIGHT ELEVATION 3/16" = 1'-0"



1331 SAINT ANDREWS DR.

MEBANE, NC 27302

PHONE: 919-563-1818

LAURA.DOWDS1966@OUTLOOK.COM

WWW.DOWDSHOUSEPLANS.COM

	Wind	low Schedule	
Type Mark	Rough Width	Rough Height	Type
A	2' - 2 1/2"	2' - 8 1/2"	2228
В	3' - 0 1/2"	1' - 6 1/2"	3016 FIXED
С	8' - 0 1/2"	7' - 0 1/2"	4070
D	3' - 9 1/2"	4' - 6 1/2"	3946
E	8' - 0 1/2"	5' - 0 1/2"	3-2850
F	8' - 0 1/2"	1' - 5 1/2"	3-2815 AWNING
G	8' - 0 1/2"	6' - 0 1/2"	3-2860
Н	8' - 0 1/2"	7' - 0 1/2"	3-2870
	2' - 4 1/2"	4' - 0 1/2"	2440
J	5' - 0 1/2"	6' - 1 1/2"	5061
K	2' - 8 1/2"	6' - 0 1/2"	2860
L	2' - 10 1/2"	2' - 10 1/2"	210210 FIXED
M	12' - 0 1/2"	7' - 0 1/2"	3-4070
N	2' - 8 1/2"	3' - 0 1/2"	2830
0	3' - 9 1/2"	4' - 0 1/2"	3940

FIRST FLOOR 0' - 0"

N 2-8-172 3-9-172 3840

O 3-9-172 3840

VINNT OR ALLIMINUM CLAD WOOD WINDOW WITH LOW PER HOULAN ELD GLASS SHINGLE ROOFING 20-2-176 PLATE

20-2-176 PLATE

10 PLATE

10 PLATE

10

2 FRONT ELEVATION 3/16" = 1'-0"

Dowds Design Collection, LLC. is a house plan design company and not structural engineers. The Plans, including structure, foundation, windows, and doors are a guide only for construction and all dimensions and notations attached need to be verified & confirmed by a structural engineer.

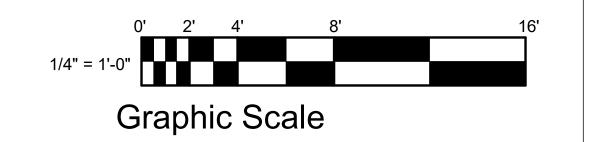

EVERY ATTEMPT HAS BEEN MADE IN THE PREPARATION OF THESE DRAWINGS TO AVOID MISTAKES. THE DESIGNER, OR ANYONE ASSOCIATED WITH THE DESIGNER, WILL NOT BE HELD LIABLE FOR ANY ERRORS OR OMISSIONS IN THESE DRAWINGS

ZAR İAR

MONA SHIR WEST HAVEN, CT

mona.pro.shir@outlook.com 443 962 1396

RESIDENCE

EARNE

EXTERIOR ELEVATIONS

ALL DRAWINGS SHOULD BE REVIEWED BY LOCAL PROFESSIONAL TO ASSURE CONFORMANCE WITH LOCAL & STATE CODES. ADDITIONAL ENGINEERING WORK IS THE RESPONSIBILITY OF THE CLIENT.

REVISIONS
NO DATE/DESCRIPTION

PLAN NUMBER

SHEET NUMBER

FIRST FLOOR
0' - 0"

Dowds Design Collection, LLC. is a

house plan design company and

not structural engineers. The

foundation, windows, and doors

are a guide only for construction

and all dimensions and notations

attached need to be verified &

confirmed by a structural

engineer.

structure,

including

1 REAR ELEVATION 3/16" = 1'-0"



Graphic Scale

MONA SHIR WEST HAVEN, CT 1331 SAINT ANDREWS DR. **MEBANE, NC 27302** PHONE: 919-563-1818 LAURA.DOWDS1966@OUTLOOK.COM WWW.DOWDSHOUSEPLANS.COM

ZAR İAR

RESIDENCE EXTERIOR ELEVATIONS

EARNHARDT

EVERY ATTEMPT HAS BEEN MADE IN THE PREPARATION OF THESE DRAWINGS TO AVOID MISTAKES. THE DESIGNER, OR ANYONE ASSOCIATED WITH THE DESIGNER, WILL NOT BE HELD LIABLE FOR ANY ERRORS OR OMISSIONS IN THESE DRAWINGS

ALL DRAWINGS SHOULD BE
REVIEWED BY LOCAL PROFESSIONAL
TO ASSURE CONFORMANCE WITH
LOCAL & STATE CODES.
ADDITIONAL ENGINEERING WORK IS
THE RESPONSIBILITY OF THE
CLIENT.

DATE/DESCRIPTION

PLAN NUMBER



MONA SHIR WEST HAVEN, CT 1331 SAINT ANDREWS DR. **MEBANE, NC 27302** PHONE: 919-563-1818 LAURA.DOWDS1966@OUTLOOK.COM

WWW.DOWDSHOUSEPLANS.COM

mona.pro.shir@outlook.com 443 962 1396

ZAR İAR

RESIDENCE ERIOR PERSPECTIVES EARNHARDT

EVERY ATTEMPT HAS BEEN MADE IN THE PREPARATION OF THESE DRAWINGS TO AVOID MISTAKES. THE DESIGNER, OR ANYONE ASSOCIATED WITH THE DESIGNER, WILL NOT BE HELD LIABLE FOR ANY ERRORS OR OMISSIONS IN THESE DRAWINGS

ALL DRAWINGS SHOULD BE
REVIEWED BY LOCAL PROFESSIONAL
TO ASSURE CONFORMANCE WITH
LOCAL & STATE CODES.
ADDITIONAL ENGINEERING WORK IS
THE RESPONSIBILITY OF THE
CLIENT.

PLAN NUMBER


A 203



1 FRONT PERSPECTIVE



Dowds Design Collection, LLC. is a house plan design company and not structural engineers. The including structure, foundation, windows, and doors are a guide only for construction and all dimensions and notations attached need to be verified & confirmed by a structural engineer.

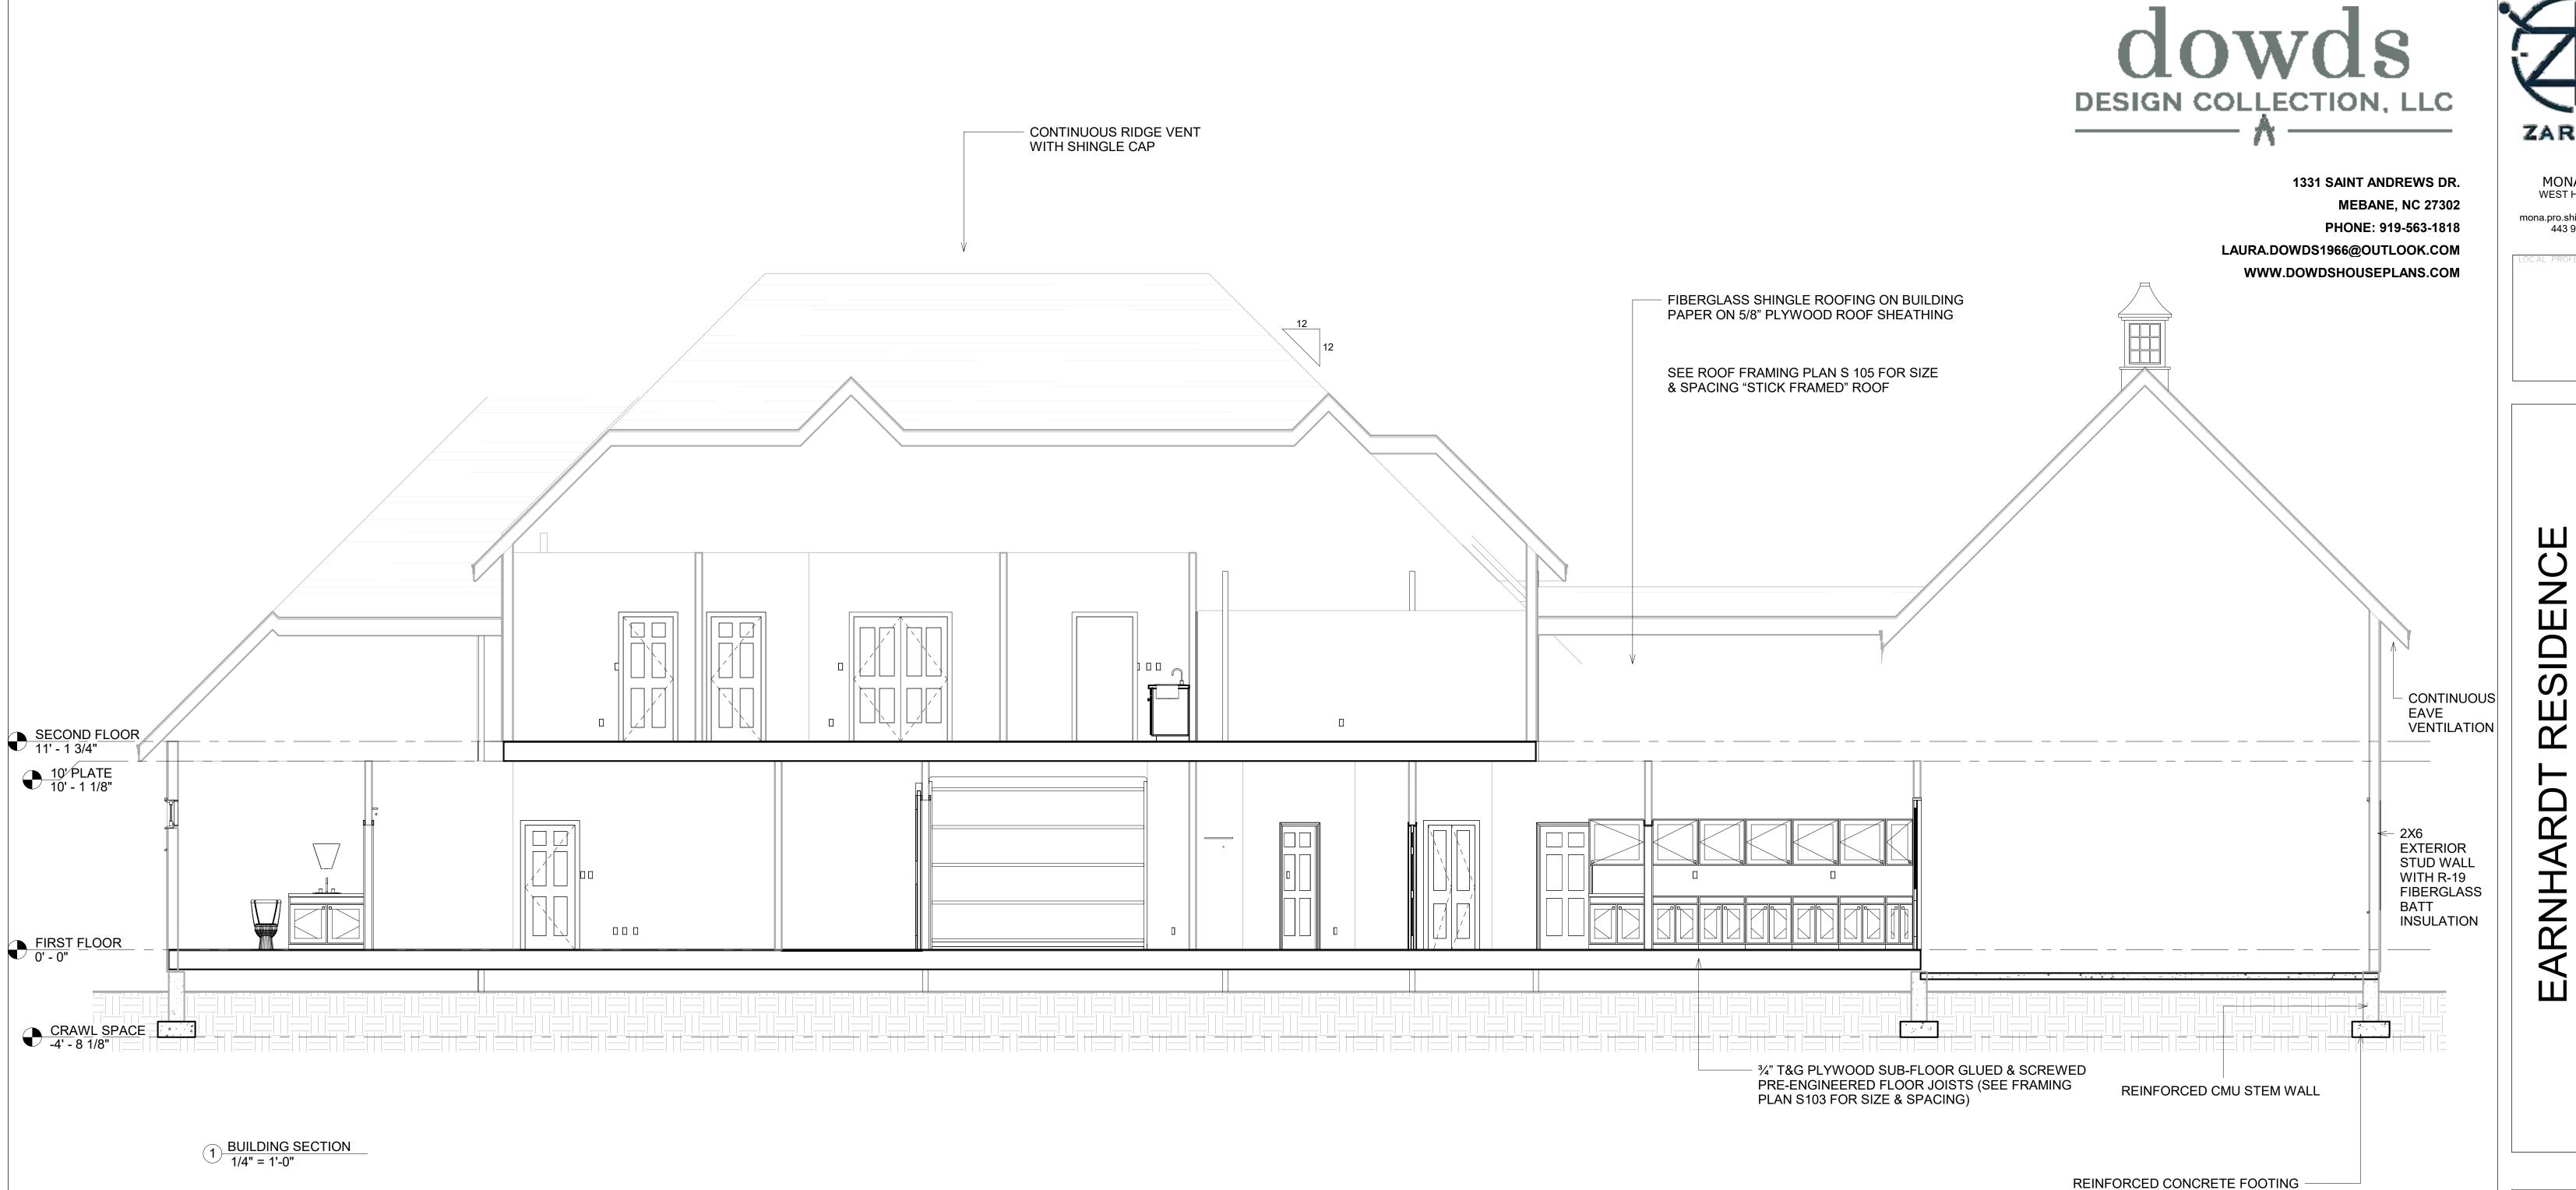


Dowds Design Collection, LLC. is a house plan design company and not structural engineers. The Plans, including structure, foundation, windows, and doors are a guide only for construction and all dimensions and notations attached need to be verified &

by a structural

confirmed

engineer.

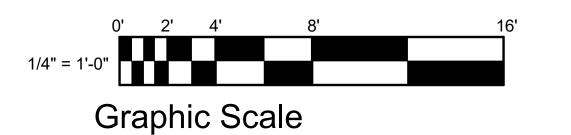

ZAR IAR

MONA SHIR WEST HAVEN, CT

mona.pro.shir@outlook.com 443 962 1396

HARDT RESIDENCE
BUILDING SECTION

EVERY ATTEMPT HAS BEEN MADE IN THE PREPARATION OF THESE DRAWINGS TO AVOID MISTAKES. THE DESIGNER, OR ANYONE ASSOCIATED WITH THE DESIGNER, WILL NOT BE HELD LIABLE FOR ANY ERRORS OR OMISSIONS IN THESE DRAWINGS

ALL DRAWINGS SHOULD BE
REVIEWED BY LOCAL PROFESSIONAL
TO ASSURE CONFORMANCE WITH
LOCAL & STATE CODES.
ADDITIONAL ENGINEERING WORK IS
THE RESPONSIBILITY OF THE
CLIENT.

DATE/DESCRIPTION

PLAN NUMBER

SHEET NUMBER

ZAR İAR MONA SHIR WEST HAVEN, CT 1331 SAINT ANDREWS DR. **MEBANE, NC 27302**

PHONE: 919-563-1818

LAURA.DOWDS1966@OUTLOOK.COM

WWW.DOWDSHOUSEPLANS.COM

mona.pro.shir@outlook.com 443 962 1396

ELEVATIONS & PERSPECTIVES

ARNHARD

INTERIOR

EVERY ATTEMPT HAS BEEN MADE IN THE PREPARATION OF THESE DRAWINGS TO AVOID MISTAKES. THE DESIGNER, OR ANYONE ASSOCIATED WITH THE DESIGNER, WILL NOT BE HELD LIABLE FOR ANY ERRORS OR OMISSIONS IN THESE DRAWINGS

ALL DRAWINGS SHOULD BE
REVIEWED BY LOCAL PROFESSIONAL
TO ASSURE CONFORMANCE WITH
LOCAL & STATE CODES.
ADDITIONAL ENGINEERING WORK IS
THE RESPONSIBILITY OF THE
CLIENT.


DATE/DESCRIPTION

PLAN NUMBER


A 401



2 INTERIOR PERSPECTIVE - GREAT ROOM

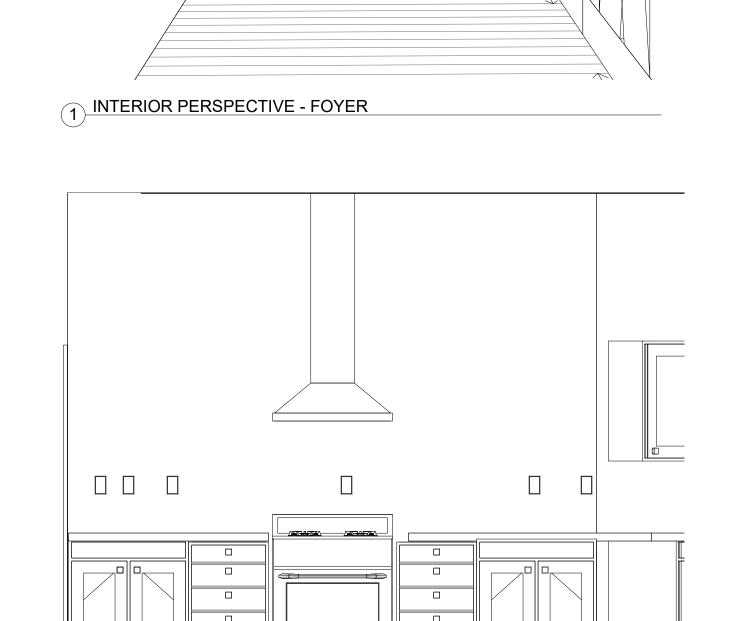

3 KITCHEN ELEVATION "A"
1/2" = 1'-0"

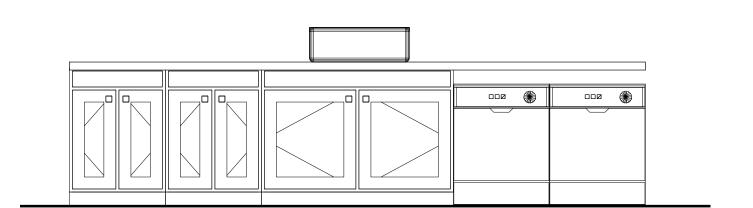

5 KITCHEN ELEVATION "C" 1/2" = 1'-0"

4 KITCHEN ELEVATION "B"
1/2" = 1'-0"

Dowds Design Collection, LLC. is a house plan design company and not structural engineers. The including structure, foundation, windows, and doors are a guide only for construction and all dimensions and notations attached need to be verified & confirmed by a structural engineer.


2 X CEILING JOISTS (SEE FRAMING PLAN) FIBERGLASS SHINGLES #15 LB ROOFING FELT 2" X " RAFTER (SEE FRAMING PLAN) R-38 BATT INSULATION (2) 2 X 6 TOP PLATE +7'-6" A.F.F. WINDOW HEADER 1/2" O.S.B. SHEATHING WINDOW AS SCHEDULED 3 EAVE DETAIL 1" = 1'-0"



FOR SHRINK / SWELL CONDITIONS


CONTACT LOCAL STRUCTURAL ENGINEER FOR FOUNDATION DESIGN - 1/2" G.W.B. (TYP.) 2 X 6 STUDS @ 16" O.C. AIR INFILTRATION BARRIER 2 X 6 BOTTOM PLATE R-19 BATT INSULATION - 3/4" T & G PLYWOOD SUBFLOORING GLUED & SCREWED ANCHOR BOLT AND 3" X 3" X 1/4" PLATE WASHER MIN. 15" EMBEDMENT 44" O.C. SPACING AND MIN. 12" FROM END OF PLATES AND ALL OUTSIDE CORNERS 8" CMU CONT. APPROX. GRADE BRICK VENEER CONT. CONCRETE FOOTING OR AS SOIL REQUIRES W/ (3) #5 REBAR

FOR SHRINK / SWELL CONDITIONS

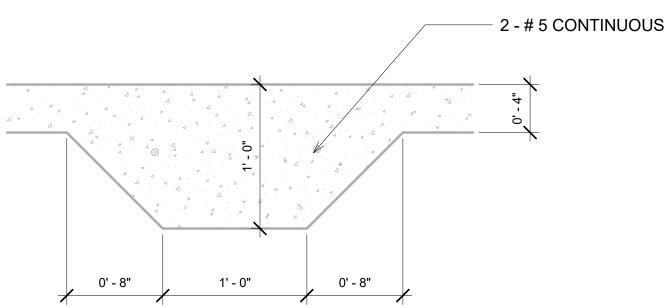

2 SLAB FOUNDATION DETAILS 1 1/2" = 1'-0"

Dowds Design Collection, LLC. is a house plan design company and not structural engineers. The including structure, foundation, windows, and doors are a guide only for construction and all dimensions and notations attached need to be verified & confirmed by a structural engineer.

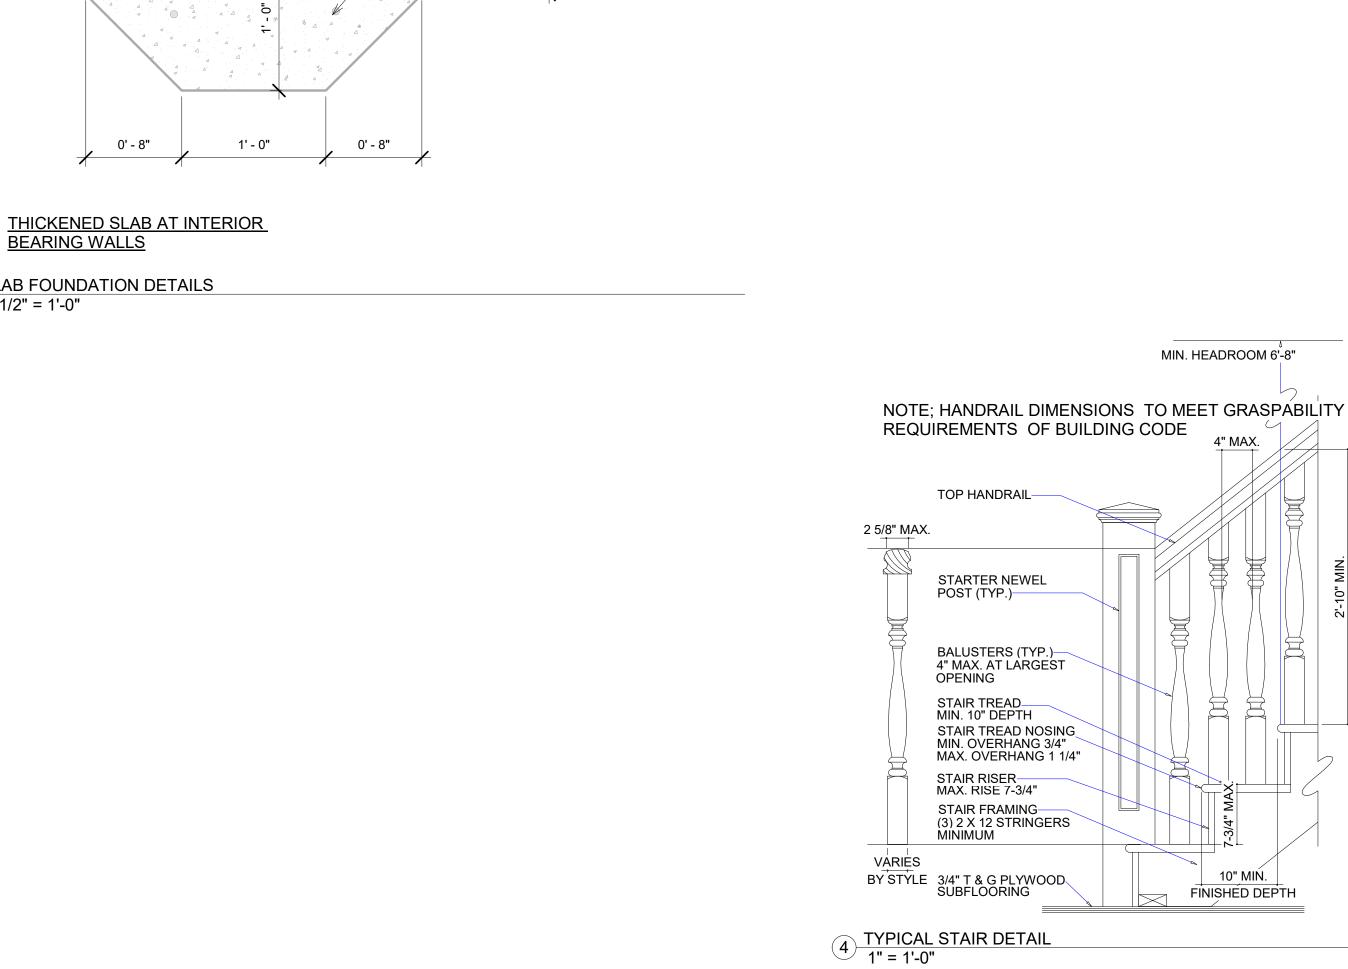



MIN. HEADROOM 6'-8"

FINISHÉD DEPTH

1331 SAINT ANDREWS DR. **MEBANE, NC 27302** PHONE: 919-563-1818 LAURA.DOWDS1966@OUTLOOK.COM WWW.DOWDSHOUSEPLANS.COM



MONA SHIR WEST HAVEN, CT

mona.pro.shir@outlook.com 443 962 1396

SIDENCE **DEATAILS** EARNE

EVERY ATTEMPT HAS BEEN MADE IN
THE PREPARATION OF THESE
DRAWINGS TO AVOID MISTAKES.
THE DESIGNER, OR ANYONE
ASSOCIATED WITH THE DESIGNER,
WILL NOT BE HELD LIABLE FOR ANY
ERRORS OR OMISSIONS IN THESE
DRAWINGS

ALL DRAWINGS SHOULD BE
REVIEWED BY LOCAL PROFESSIONAL
TO ASSURE CONFORMANCE WITH
LOCAL & STATE CODES.
ADDITIONAL ENGINEERING WORK IS
THE RESPONSIBILITY OF THE
CLIENT. DATE/DESCRIPTION

PLAN NUMBER

D 101

ZARIAR

1331 SAINT ANDREWS DR.

MEBANE, NC 27302

PHONE: 919-563-1818

LAURA.DOWDS1966@OUTLOOK.COM

WWW.DOWDSHOUSEPLANS.COM

MONA SHIR WEST HAVEN, CT

mona.pro.shir@outlook.com
443 962 1396

LOCAL PROFESSIONAL'S SEA

EARNHARDT RESIDENC FIRST FLOOR ELECTRICAL PLAN

EVERY ATTEMPT HAS BEEN MADE IN
THE PREPARATION OF THESE
DRAWINGS TO AVOID MISTAKES.
THE DESIGNER, OR ANYONE
ASSOCIATED WITH THE DESIGNER,
WILL NOT BE HELD LIABLE FOR ANY
ERRORS OR OMISSIONS IN THESE
DRAWINGS

ALL DRAWINGS SHOULD BE
REVIEWED BY LOCAL PROFESSIONAL
TO ASSURE CONFORMANCE WITH
LOCAL & STATE CODES.
ADDITIONAL ENGINEERING WORK IS
THE RESPONSIBILITY OF THE
CLIENT.

REVISIONS


NO DATE/DESCRIPTION

DATE PLAN NUMBER

SHEET NUMBER

Graphic Scale

E 101

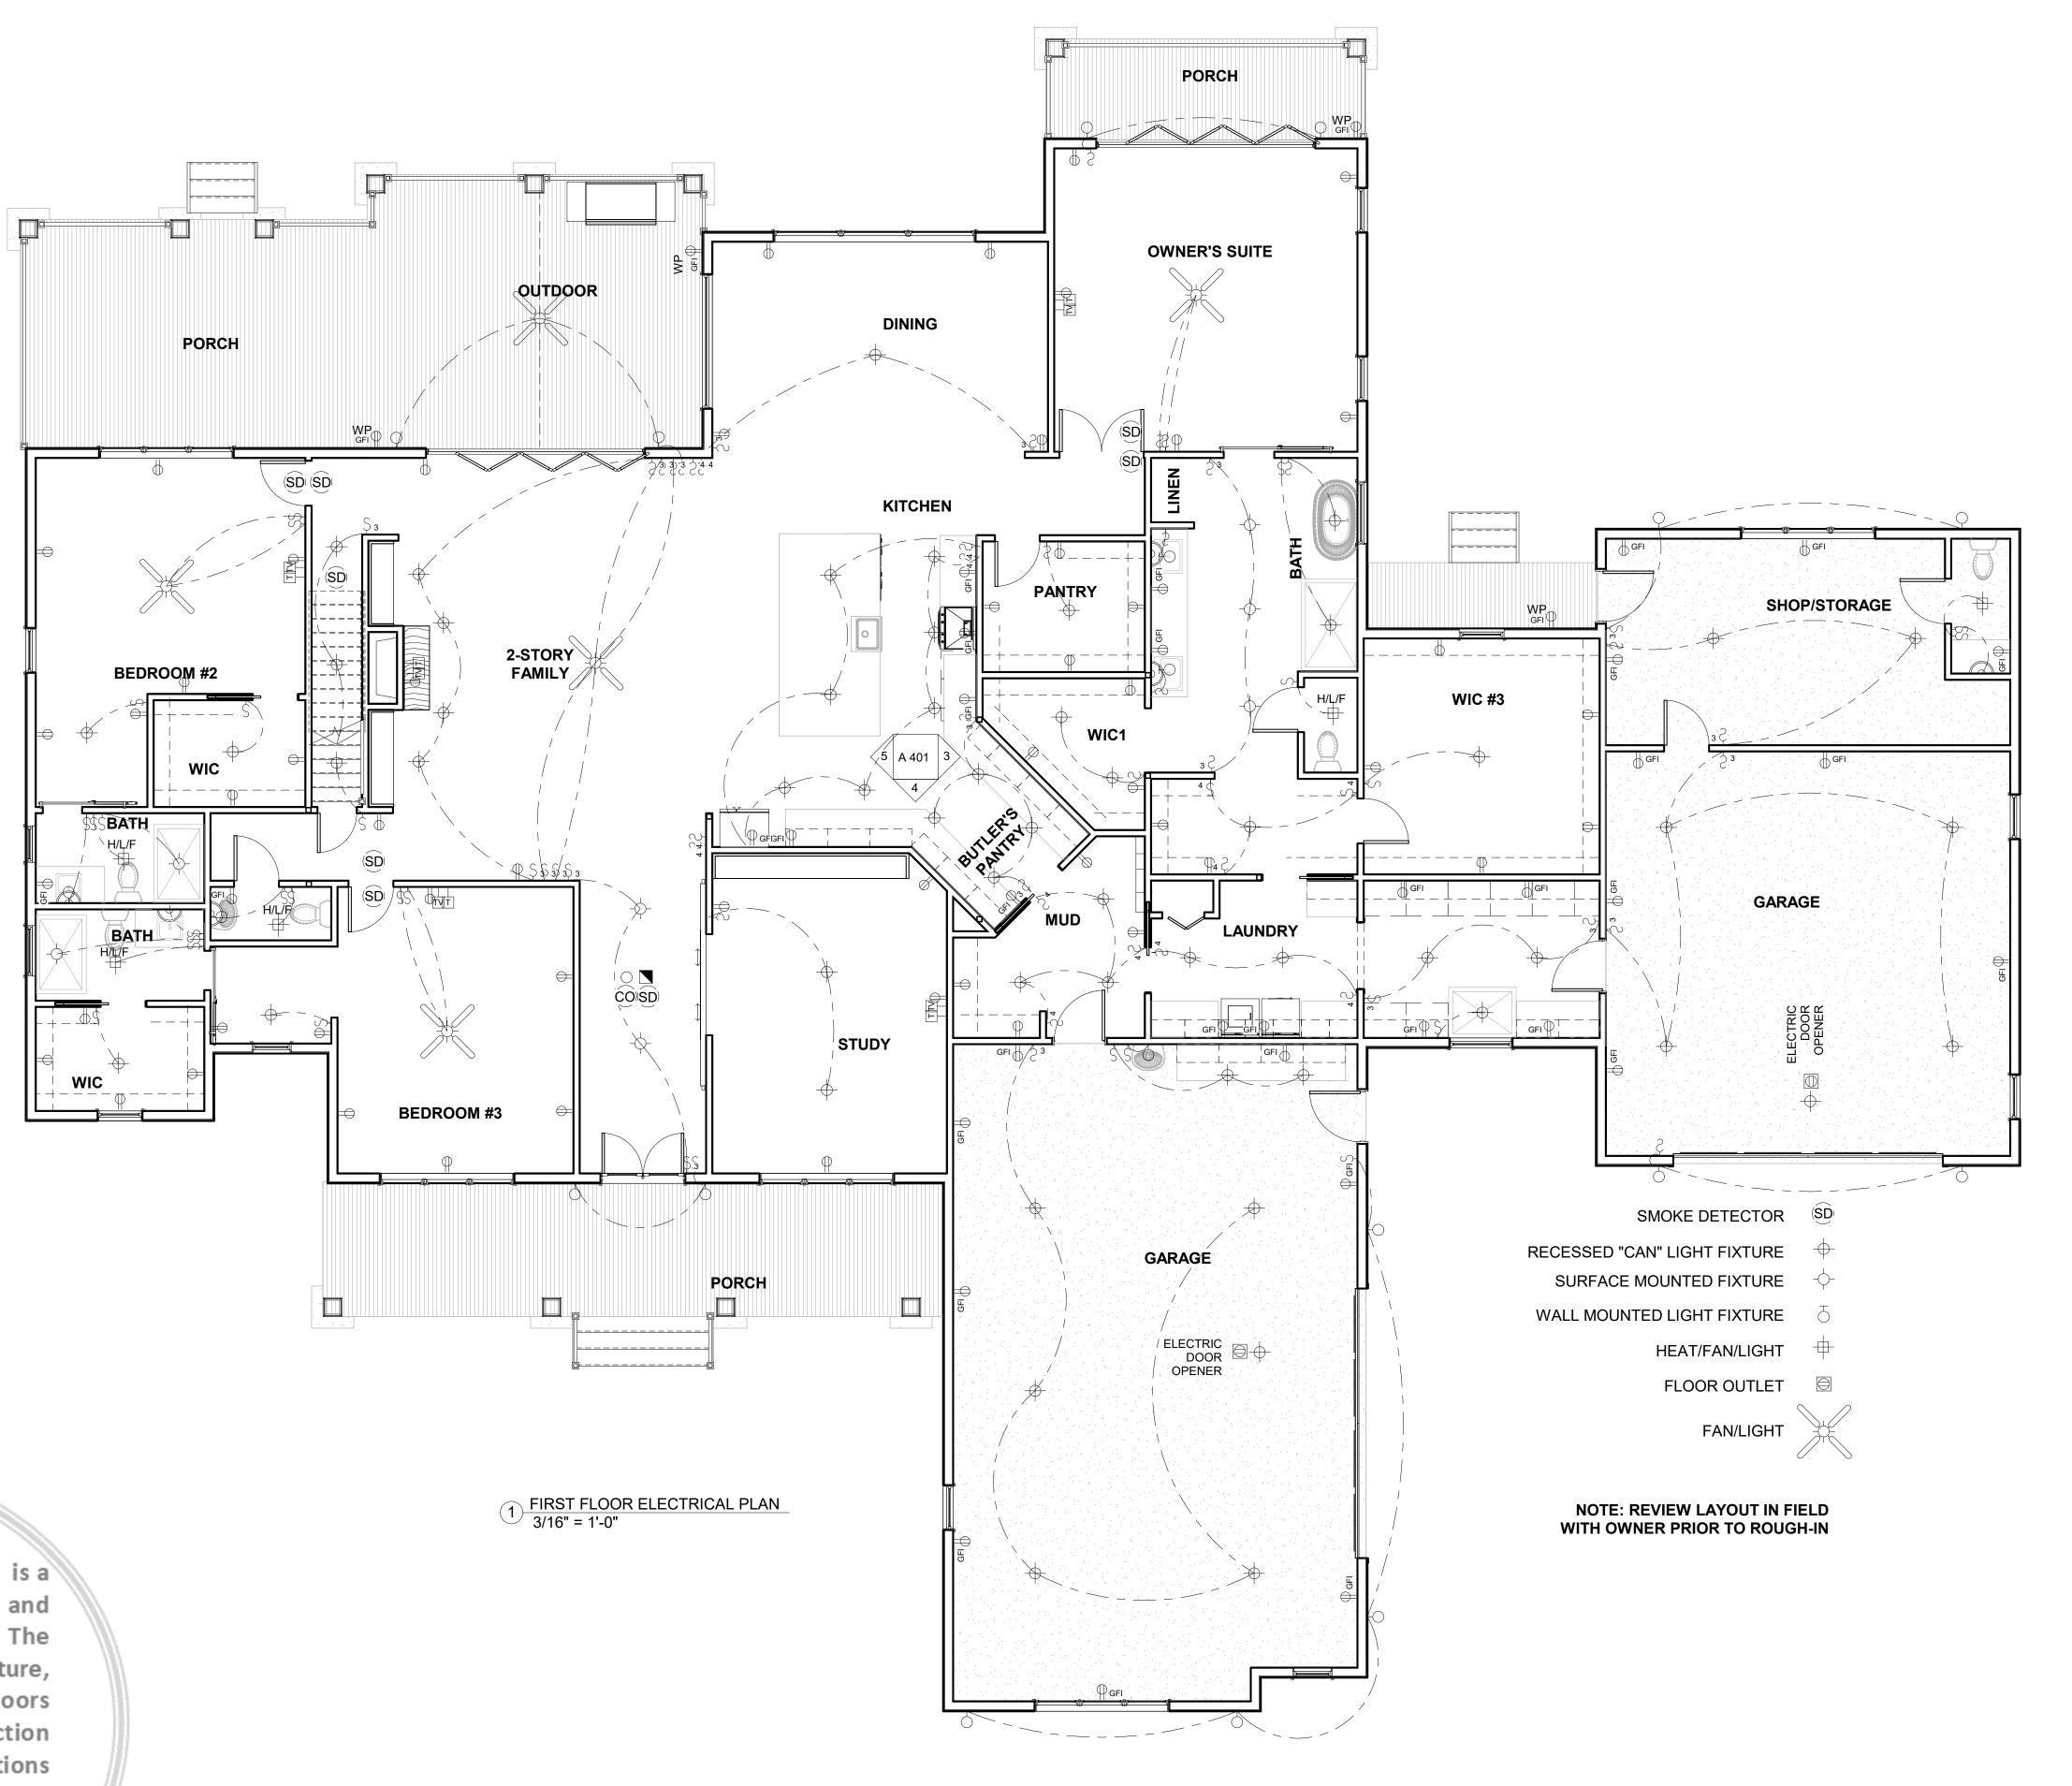

Dowds Design Collection, LLC. is a house plan design company and not structural engineers. The Plans, including structure, foundation, windows, and doors are a guide only for construction and all dimensions and notations attached need to be verified & confirmed by a structural engineer.



1331 SAINT ANDREWS DR. **MEBANE, NC 27302** PHONE: 919-563-1818 LAURA.DOWDS1966@OUTLOOK.COM

WWW.DOWDSHOUSEPLANS.COM

MONA SHIR WEST HAVEN, CT mona.pro.shir@outlook.com 443 962 1396

SECOND FLOOR ELECTRICAL PLAN EARNE

EVERY ATTEMPT HAS BEEN MADE IN THE PREPARATION OF THESE DRAWINGS TO AVOID MISTAKES. THE DESIGNER, OR ANYONE ASSOCIATED WITH THE DESIGNER, WILL NOT BE HELD LIABLE FOR ANY ERRORS OR OMISSIONS IN THESE DRAWINGS

ALL DRAWINGS SHOULD BE
REVIEWED BY LOCAL PROFESSIONAL
TO ASSURE CONFORMANCE WITH
LOCAL & STATE CODES.
ADDITIONAL ENGINEERING WORK IS
THE RESPONSIBILITY OF THE
CLIENT.

DATE/DESCRIPTION

PLAN NUMBER

E 102

Graphic Scale

SMOKE DETECTOR SD

HEAT/FAN/LIGHT

NOTE: REVIEW LAYOUT IN FIELD WITH OWNER PRIOR TO ROUGH-IN

FLOOR OUTLET

FAN/LIGHT


RECESSED "CAN" LIGHT FIXTURE

WALL MOUNTED LIGHT FIXTURE

SURFACE MOUNTED FIXTURE

confirmed by a structural

engineer.

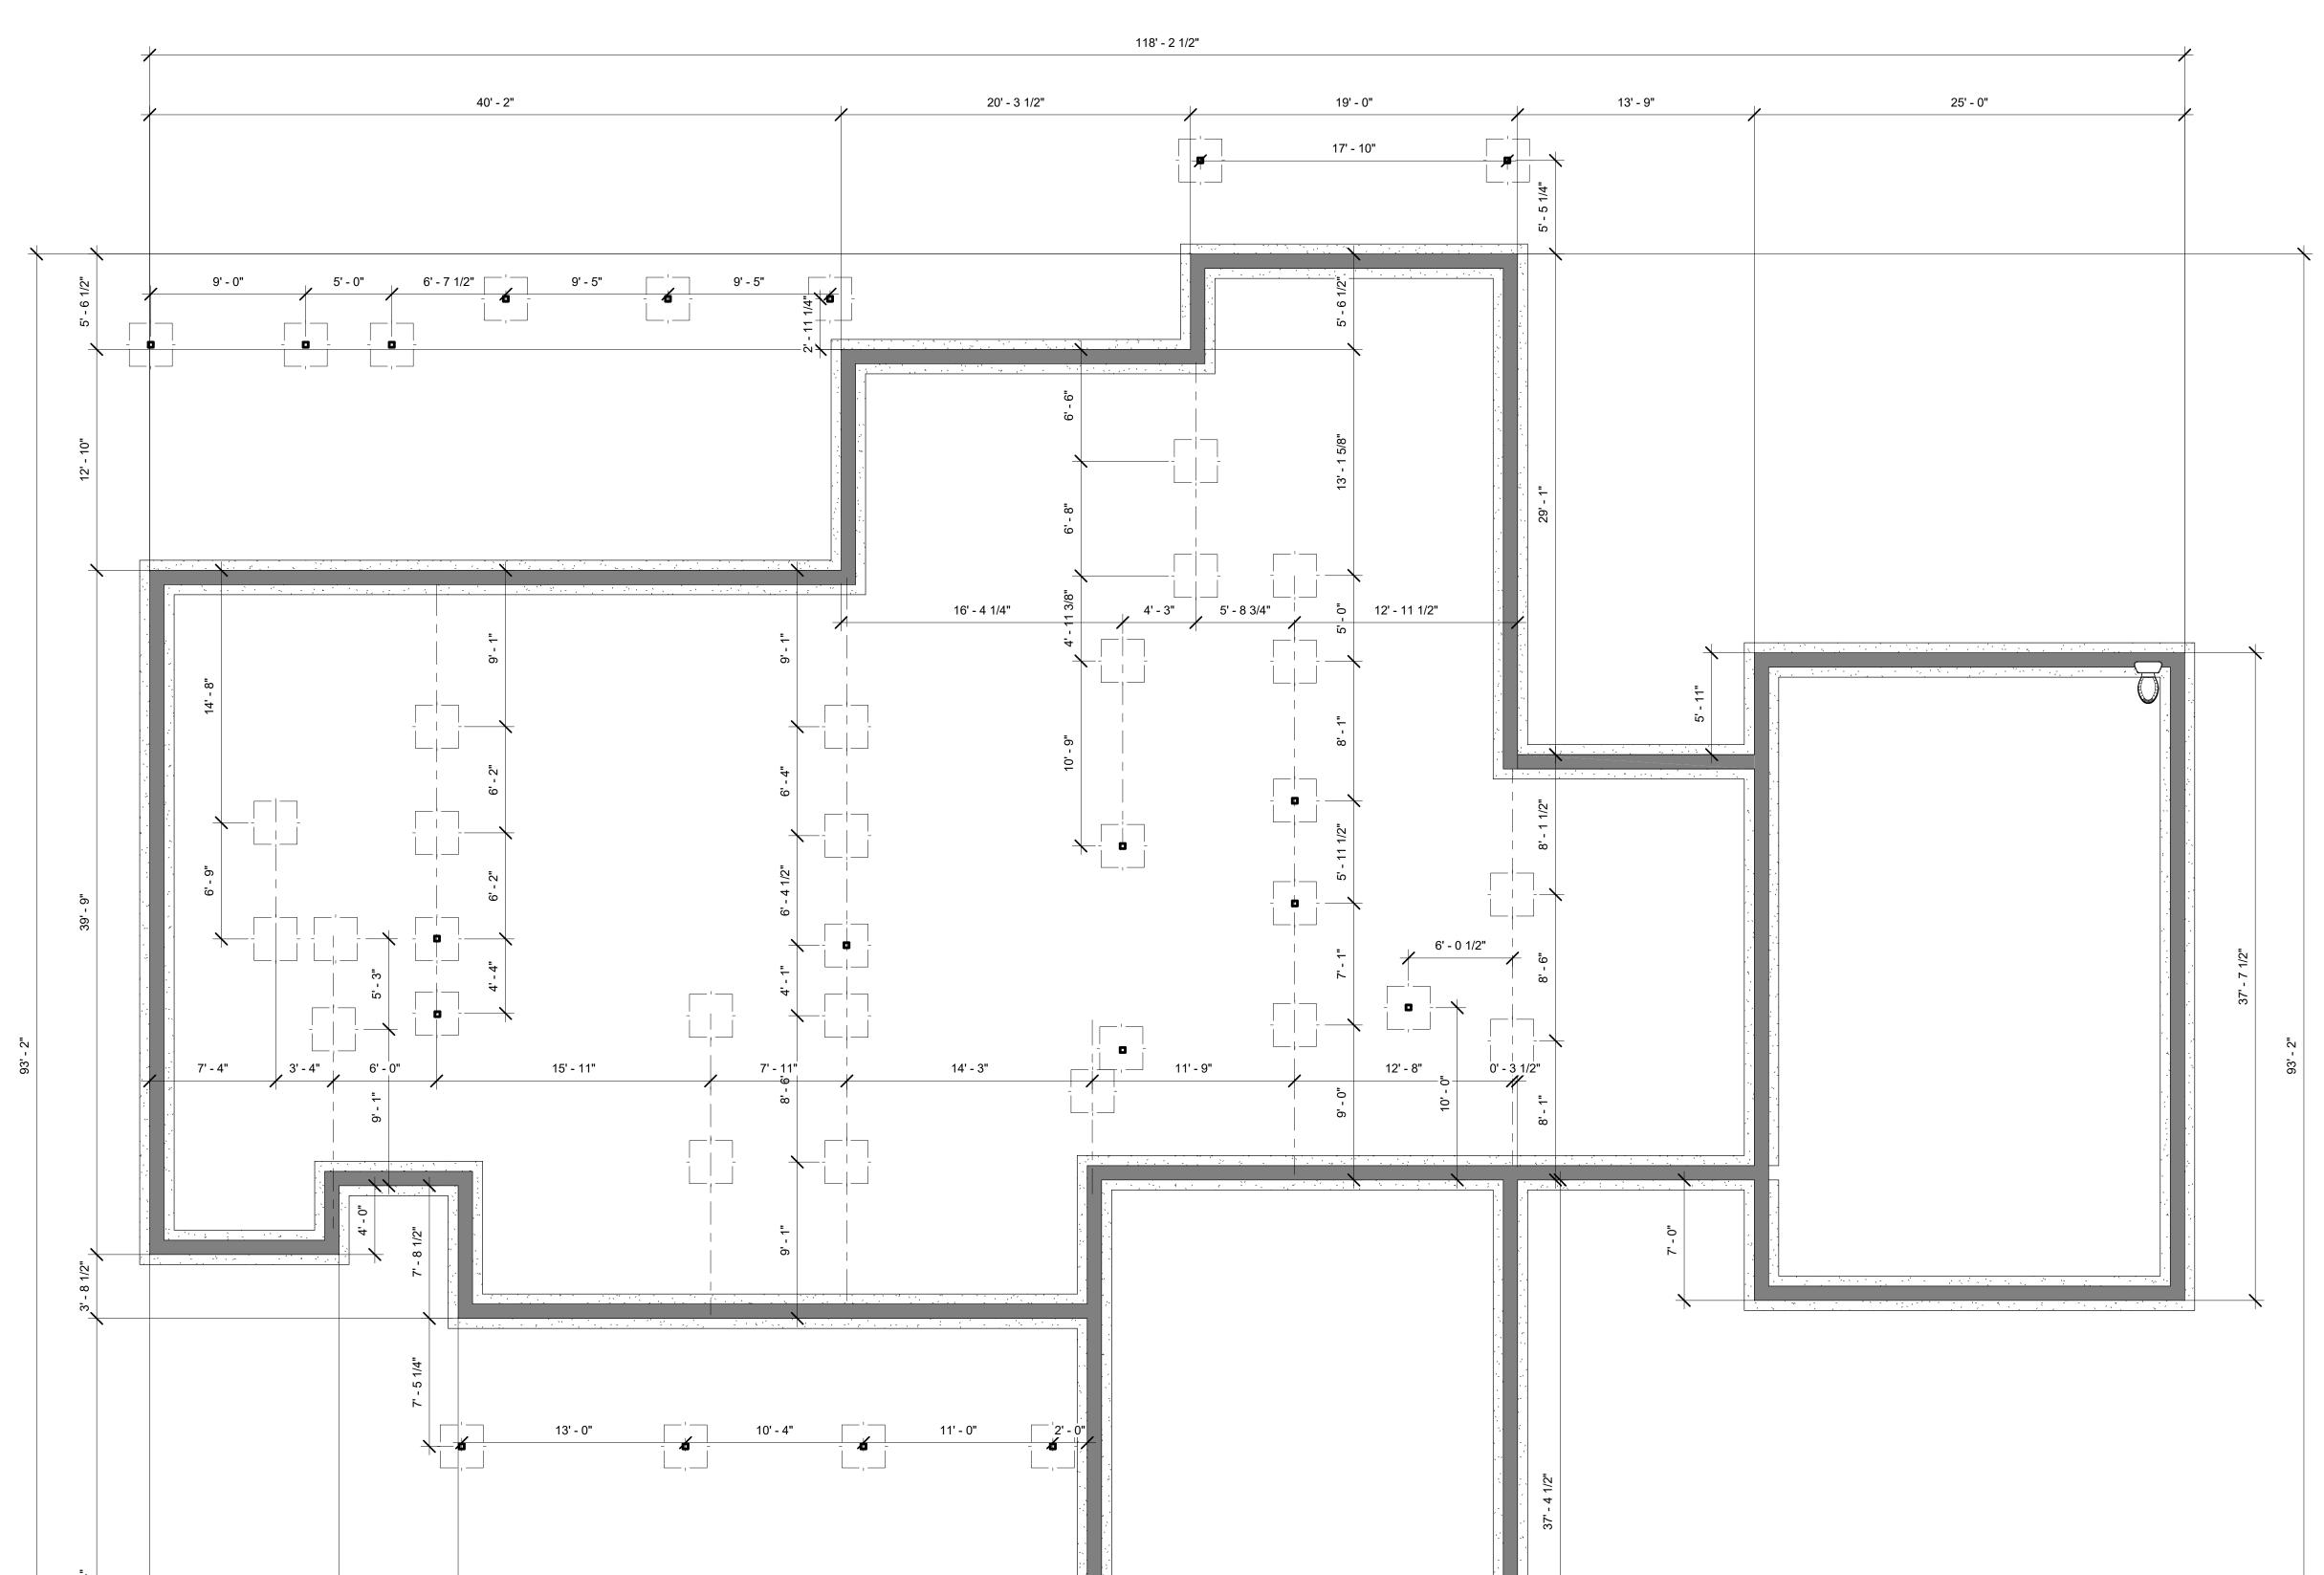

18' - 8"

6' - 4"

36' - 6 1/2"

11' - 0"

6' - 11"



1331 SAINT ANDREWS DR.


MEBANE, NC 27302


PHONE: 919-563-1818


LAURA.DOWDS1966@OUTLOOK.COM

WWW.DOWDSHOUSEPLANS.COM

Dowds Design Collection, LLC. is a house plan design company and not structural engineers. The Plans, including structure, foundation, windows, and doors are a guide only for construction and all dimensions and notations attached need to be verified & confirmed by a structural engineer.

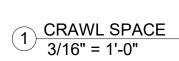

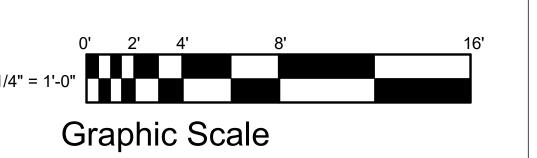

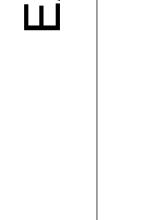

RESIDENCE

FOUNDATION PLAN

MONA SHIR WEST HAVEN, CT

mona.pro.shir@outlook.com 443 962 1396

EVERY ATTEMPT HAS BEEN MADE IN THE PREPARATION OF THESE DRAWINGS TO AVOID MISTAKES. THE DESIGNER, OR ANYONE ASSOCIATED WITH THE DESIGNER, WILL NOT BE HELD LIABLE FOR ANY ERRORS OR OMISSIONS IN THESE DRAWINGS

ALL DRAWINGS SHOULD BE
REVIEWED BY LOCAL PROFESSIONAL
TO ASSURE CONFORMANCE WITH
LOCAL & STATE CODES.
ADDITIONAL ENGINEERING WORK IS
THE RESPONSIBILITY OF THE
CLIENT.

REVISIONS
NO DATE/DESCRIPTION

DATE PLAN NUMBER

SHEET NUMBER

S 101

dowds **DESIGN COLLECTION, LLC**

PT 2X6 @ 16" O.C.

(2) PT 2X12

PT 2X6 @ 16" O.C.

MONA SHIR WEST HAVEN, CT 1331 SAINT ANDREWS DR. **MEBANE, NC 27302** mona.pro.shir@outlook.com 443 962 1396 PHONE: 919-563-1818 LAURA.DOWDS1966@OUTLOOK.COM

WWW.DOWDSHOUSEPLANS.COM

Ž Ш FLOOR FRAMING

ARNE

FIRST

EVERY ATTEMPT HAS BEEN MADE IN THE PREPARATION OF THESE DRAWINGS TO AVOID MISTAKES. THE DESIGNER, OR ANYONE ASSOCIATED WITH THE DESIGNER, WILL NOT BE HELD LIABLE FOR ANY ERRORS OR OMISSIONS IN THESE DRAWINGS

ALL DRAWINGS SHOULD BE REVIEWED BY LOCAL PROFESSIONAL TO ASSURE CONFORMANCE WITH LOCAL & STATE CODES. ADDITIONAL ENGINEERING WORK IS THE RESPONSIBILITY OF THE CLIENT.

DATE/DESCRIPTION

PLAN NUMBER

S 102 Graphic Scale

Danakh	TUR	40 PS	SF Live Load.	/ 10 PSF Dead	Load	40 PSF Live Load / 20 PSF Dead Load							
Depth	TJI®	12" o.c.	16" o.c.	19.2" o.c.	24" o.c.	12" o.c.	16" o.c.	19.2" o.c.	24" o.c.				
	110	18'-9"	17'-2"	15'-8"	14'-0"	18'-1"	15'-8"	14'-3"	12'-9"				
91/2"	210	19'-8"	18'-0"	17'-0"	15'-4"	19'-8"	17'-2"	15'-8"	14'-0"				
- "	230	20'-3"	18'-6"	17'-5"	16'-2"	20'-3"	18'-1"	16'-6"	14'-9"				
	110	22'-3"	19'-4"	17'-8"	15'-9"(1)	20'-5"	17'-8"	16'-1"(1)	14'-4"(1)				
	210	23'-4"	21'-2"	19'-4"	17'-3"(1)	22'-4"	19'-4"	17'-8"	15'-9"(1)				
113/8"	230	24'-0"	21'-11"	20'-5"	18'-3"	23'-7"	20'-5"	18'-7"	16'-7"(1)				
Angel I	360	25'-4"	23'-2"	21'-10"	20'-4"(1)	25'-4"	23'-2"	21'-10"(1)	17'-10"(I				
	560	28'-10"	26'-3"	24'-9"	23'-0"	28'-10"	26'-3"	24'-9"	20'-11"(1				
Ī	110	24'-4"	21'-0"	19'-2"	17'-2"(1)	22'-2"	19'-2"	17'-6"(1)	15'-0"(1)				
	210	26'-6"	23'-1"	21'-1"	18'-10"(1)	24'-4"	21'-1"	19'-2"(1)	16'-7"(1)				
14"	230	27'-3"	24'-4"	22'-2"	19'-10"(1)	25'-8"	22'-2"	20'-3"(1)	17'-6"(1)				
	360	28'-9"	26'-3"	24'-9"(1)	21'-5"(1)	28'-9"	26'-3"(1)	22'-4"(1)	17'-10"(1				
	560	32'-8"	29'-9"	28'-0"	25'-2"(1)	32'-8"	29'-9"	26'-3"(1)	20'-11"(1)				
	210	28'-6"	24'-8"	22'-6"(1)	19'-11"(1)	26'-0"	22'-6"(1)	20'-7"(1)	16'-7"(1)				
101	230	30'-1"	26'-0"	23'-9"	21'-1"(1)	27'-5"	23'-9"	21'-8"(1)	17'-6"(1)				
16"	360	31'-10"	29'-0"	26'-10"(1)	21'-5"(1)	31'-10"	26'-10"(1)	22'-4"(1)	17'-10"(1				
	560	361.111	221 1111	31' (1)'(1)	251 211(1)	26' 1"	211 64(1)	26' 3"(])	20' 11"(1				

TJI®	40 PS	F Live Load	/10 PSF Dead	Load	40 PS	SF Live Load.	/ 20 PSF Dead	Load
III	12" o.c.	16" o.c.	19.2" o.c.	24" o.c.	12" o.c.	16" o.c.	19.2" o.c.	24" o.c.
110	N.A.	N.A.	N.A.	15'-4"	N.A.	N.A.	16'-0"	12'-9"
210	N.A.	N.A.	21'-4"	17'-0"	N.A.	21'-4"	17'-9"	14'-2"
230	N.A.	N.A.	N.A.	19'-2"	N.A.	N.A.	19'-11"	15'-11 "
360	N.A.	N.A.	24'-5"	19'-6"	N.A.	24'-5"	20'-4"	16'-3"
560	N.A.	N.A.	29'-10"	23'-10"	N.A.	29'-10"	24'-10"	19'-10"

[•] Long-term deflection under dead load, which includes the effect of creep, has not been considered. **Bold italic** spans reflect initial dead load deflection exceeding 0.33".



L/480 Live Load Deflection 12" o.c. | 16" o.c. | 19.2" o.c. | 24" o.c. | 12" o.c. | 16" o.c. | 19.2" o.c. | 24" o.c. 19'-8" 18'-4" **27'-3"** 23'-9" 21'-8"(1) 17'-6"(1) 27'-3" 24'-10" 23'-6" 21'-1"(1) 28'-9" 26'-3" 24'-8"(1) 21'-5"(1) **28'-9"** 26'-3"(1) 22'-4"(1) 17'-10"(1) **560** 32'-8" 29'-8" 28'-0" 25'-2"(1) **32'-8" 29'-8"** 26'-3"(1) 20'-11"(1) L/360 Live Load Deflection (Minimum Criteria per Code)

-(2) PT 2X12 (2) PT 2X12 (2) PT 2X12-(2) PT 2X12 (2) PT 2X12 (2) PT 2X12 PT 2X8 @ 16" O.C.

PT 2X8 @ 16" O.C.

FIRST FLOOR FRAMING

Dowds Design Collection, LLC. is a house plan design company and not structural engineers. The including structure, foundation, windows, and doors are a guide only for construction and all dimensions and notations attached need to be verified & confirmed by a structural engineer.

Dowds Design Collection, LLC. is a

house plan design company and

not structural engineers. The

foundation, windows, and doors

are a guide only for construction

and all dimensions and notations

attached need to be verified &

confirmed by a structural

engineer.

structure,

including



ZAR IAR

1331 SAINT ANDREWS DR.

MEBANE, NC 27302

PHONE: 919-563-1818

LAURA.DOWDS1966@OUTLOOK.COM

WWW.DOWDSHOUSEPLANS.COM

MONA SHIR WEST HAVEN, CT mona.pro.shir@outlook.com 443 962 1396

OCAL PROFESSIONAL'S SEAL

EARNHARDT RESIDENC SECOND FLOOR FRAMING PLAN

EVERY ATTEMPT HAS BEEN MADE IN THE PREPARATION OF THESE DRAWINGS TO AVOID MISTAKES. THE DESIGNER, OR ANYONE ASSOCIATED WITH THE DESIGNER, WILL NOT BE HELD LIABLE FOR ANY ERRORS OR OMISSIONS IN THESE DRAWINGS

ALL DRAWINGS SHOULD BE
REVIEWED BY LOCAL PROFESSIONAL
TO ASSURE CONFORMANCE WITH
LOCAL & STATE CODES.
ADDITIONAL ENGINEERING WORK IS
THE RESPONSIBILITY OF THE
CLIENT.


REVISIONS

NO DATE/DESCRIPTION

PLAN NUMBER

SHEET NUMBER

S 103

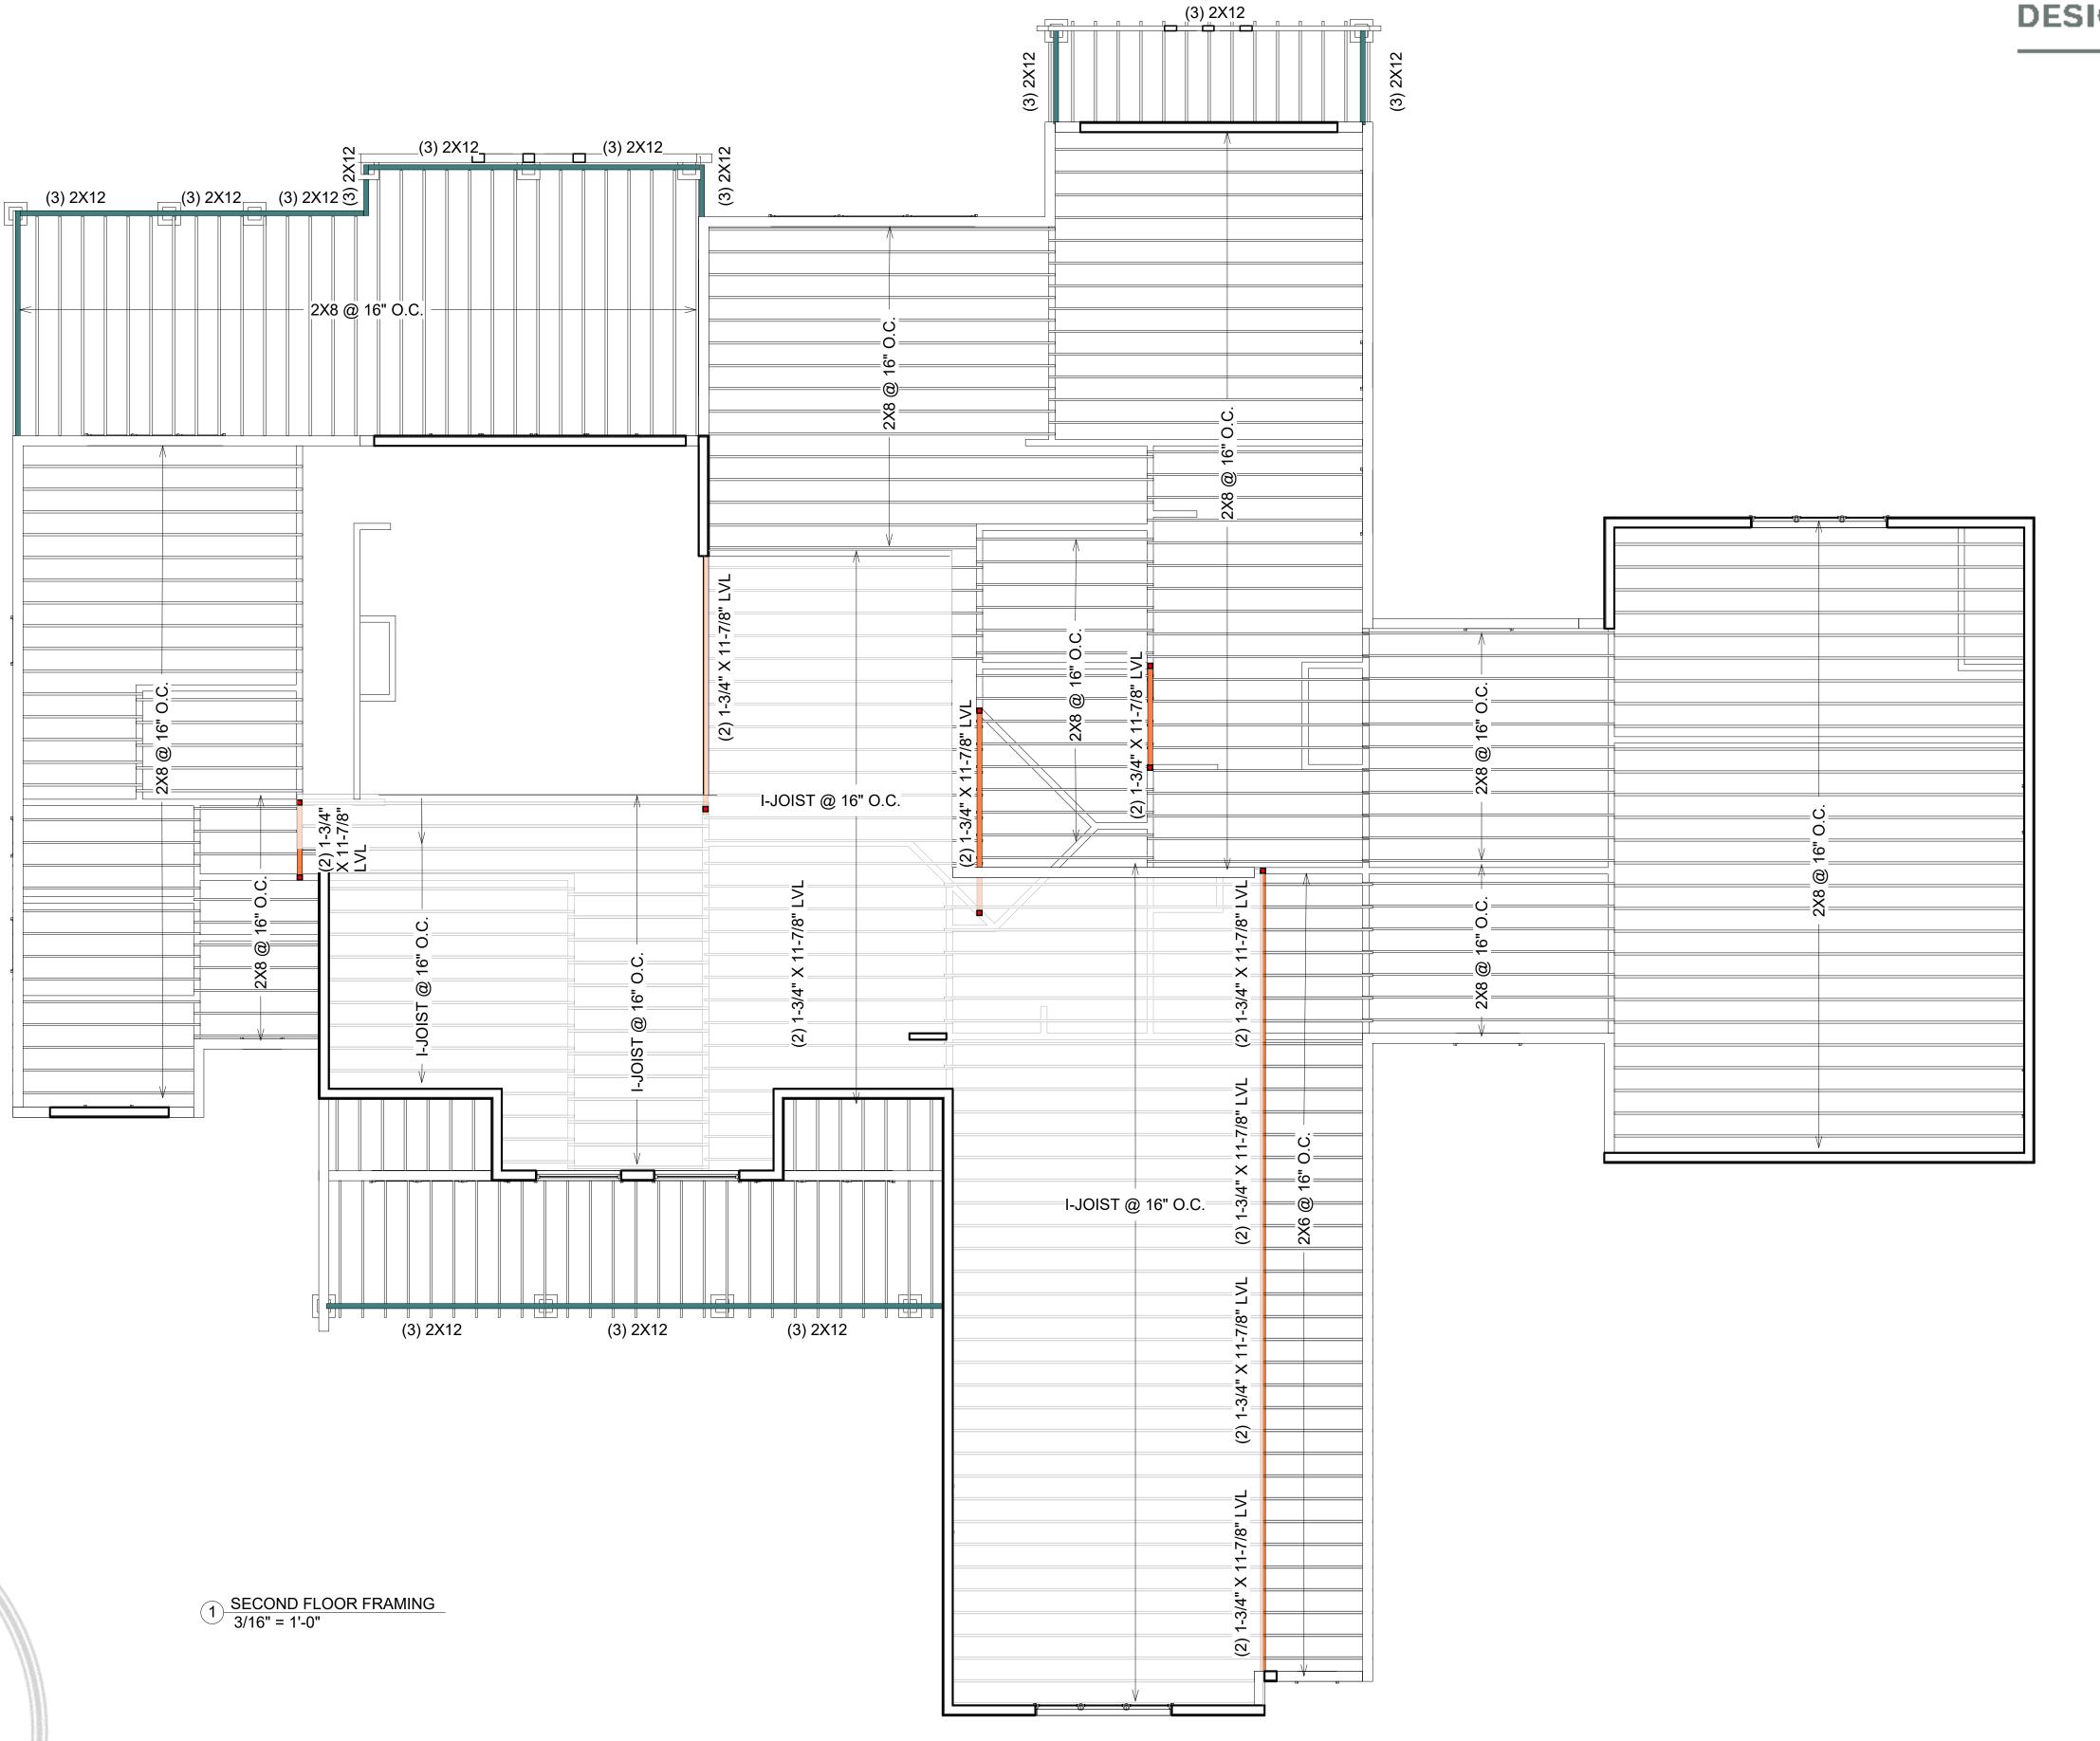

1331 SAINT ANDREWS DR. **MEBANE, NC 27302**

PHONE: 919-563-1818 LAURA.DOWDS1966@OUTLOOK.COM WWW.DOWDSHOUSEPLANS.COM

CEILING JOISTS

20# LIVE LOAD 10# DEAD LOAD L/360

Design Criteria: Strength - 20 lbs. per sq. ft. live load, plus 10 lbs. per sq. ft. dead load. Deflection - Limited in span in inches divided by 360 for live load only.

Table CJ-1

ZAR İAR

MONA SHIR WEST HAVEN, CT

mona.pro.shir@outlook.com 443 962 1396

RESIDENCE

EARNE

ILING FRAMING PLAN

		VIv						Spa	n (feet	and inc	hes)						
			2	2 x 4			2 1	6		24	2 1	8			2 x	10	
Species		8				*			spacing o	n center	center				(11.000		
or Group	Grade	12"	16"	19.2"	24"	12"	16"	19.2"	24"	12"	16"	19.2"	24"	12"	16"	19.2"	24"
Douglas Fir-	Sel. Struc.	9-1	8-3	7-9	7-3	14-4	13-0	12-3	11-4	18-10	17-2	16-1	15-0	24-1	21-10	20-7	19-1
Larch	No.1 & Btr.	8-11	8-1	7-8	7-1	14-1	12-9	12-0	11-2	18-6	16-10	15-10	14-8	23-8	21-6	20-2	18-9
	No. 1	8-9	8-0	7-6	7-0	13-9	12-6	11-9	10-11	18-2	16-6	15-6	14-2	23-2	21-1	19-5	17-4
	No.2	8-7	7-10	7-4	6-10	13-6	12-3	11-7	10-8	17-10	16-2	15-1	13-6	22-9	20-2	18-5	16-5
	No.3	7-10	6-10	6-2	5-7	11-6	9-11	9-1	8-1	14-7	12-7	11-6	10-3	17-9	15-5	14-1	12-7
Douglas Fir-	Sel. Struc.	8-3	7-6	7-0	6-6	12-11	11-9	11-1	10-3	17-0	15-6	14-7	13-6	21-9	19-9	18-7	17-3
South	No. 1	8-0	7-3	6-10	6-4	12-7	11-5	10-9	10-0	16-7	15-1	14-2	13-2	21-2	19-3	18-1	16-8
	No.2	7-10	7-1	6-8	6-2	12-3	11-2	10-6	9-9	16-2	14-8	13-10	12-10	20-8	18-9	17-8	16-0
	No.3	7-7	6-8	6-1	5-5	11-2	9-8	8-10	7-11	14-2	12-4	11-3	10-0	17-4	15-0	13-8	12-3
Hem-Fir	Sel. Struc.	8-7	7-10	7-4	6-10	13-6	12-3	11-7	10-9	17-10	16-2	15-3	14-2	22-9	20-8	19-5	18-0
	No.1 & Btr.	8-5	7-8	7-2	6-8	13-3	12-0	11-4	10-6	17-5	15-10	14-11	13-10	22-3	20-2	19-0	17-8
	No.1	8-5	7-8	7-2	6-8	13-3	12-0	11-4	10-6	17-5	15-10	14-11	13-10	22-3	20-2	19-0	17-1
	No.2	8-0	7-3	6-10	6-4	12-7	11-5	10-9	10-0	16-7	15-1	14-2	13-1	21-2	19-3	17-10	16-0
	No.3	7-8	6-8	6-1	5-5	11-2	9-8	8-10	7-11	14-2	12-4	11-3	10-0	17-4	15-0	13-8	12-3
Ѕргисе-	Sel. Struc.	8-0	7-3	6-10	6-4	12-7	11-5	10-9	10-0	16-7	15-1	14-2	13-2	21-2	19-3	18-1	16-10
Pine-Fir	No.1	7-10	7-1	6-8	6-2	12-3	11-2	10-6	9-9	16-2	14-8	13-10	12-10	20-8	18-9	17-8	16-3
(South)	No.2	7-7	6-11	6-6	6-0	11-11	10-10	10-2	9-6	15-9	14-3	13-5	12-6	20-1	18-3	17-1	15-3
	No.3	7-3	6-4	5-9	5-2	10-8	9-3	8-5	7-6	13-6	11-8	10-8	9-6	16-5	14-3	13-0	11-8
Western	Sel. Struc,	7-10	7-1	6-8	6-2	12-3	11-2	10-6	9-9	16-2	14-8	13-10	12-10	20-8	18-9	17-8	16-5
Woods	No.1	7-7	6-11	6-6	6-0	11-11	10-10	10-2	9-3	15-9	14-3	13-0	11-8	20-1	17-5	15-11	14-3
	No.2	7-4	6-8	6-3	5-10	11-7	10-6	9-10	9-2	15-3	13-10	13-0	11-8	19-5	17-5	15-11	14-3
	No.3	6-8	5-9	5-3	4-8	9-8	8-5	7-8	6-10	12-4	10-8	9-9	8-8	15-0	13-0	11-10	10-7

CEILING JOISTS

10# LIVE LOAD 10# DEAD LOAD L/360

Design Criteria: Strength - 10 lbs. per sq. ft. live load, plus 10 lbs. per sq. ft. dead load. Deflection - Limited in span in inches divided by 360 for live load only.

			Span (feet and inches)														
		1/4	1	2 x 4			2	x 6			2	K 8			2 x	10	
Species or Group						ē.			spacing	on center							
	Grade	12"	16"	19.2"	24"	12"	16"	19.2"	24"	12"	16"	19.2"	24"	12"	16"	19.2"	24"
Douglas Fir-	Sel. Struc.	11-6	10-5	9-10	9-1	18-0	16-4	15-5	14-4	23-9	21-7	20-4	18-10	30-4	27-6	25-11	24-1
Larch	No.1 & Btr.	11-3	10-3	9-8	8-11	17-8	16-1	15-2	14-1	23-4	21-2	19-11	18-6	29-9	27-1	25-5	23-3
TO SCHOOL TO A THE	No.1	11-1	10-0	9-5	8-9	17-4	15-9	14-10	13-9	22-11	20-10	19-5	17-5	29-2	26-0	23-9	21-3
	No.2	10-10	9-10	9-3	8-7	17-0	15-6	14-7	13-0	22-5	20-2	18-5	16-6	28-6	24-8	22-6	20-2
	No.3	9-7	8-4	7-7	6-10	14-1	12-2	11-1	9-11	17-10	15-5	14-1	12-7	21-9	18-10	17-2	15-5
Douglas Fir-	Sel. Struc.	10-4	9-5	8-10	8-3	16-3	14-9	13-11	12-11	21-5	19-6	18-4	17-0	27-5	24-10	23-5	21-9
South	No.1	10-1	9-2	8-8	8-0	15-11	14-5	13-7	12-7	20-11	19-0	17-11	16-7	26-9	24-3	22-10	20-5
	No.2	9-10	8-11	8-5	7-10	15-6	14-1	13-3	12-3	20-5	18-6	17-5	16-0	26-0	23-8	21-11	19-7
	No.3	9-5	8-2	7-5	6-8	13-9	11-11	10-10	9-8	17-5	15-1	13-9	12-4	21-3	18-5	16-9	15-0
Hem-Fir	Sel. Struc.	10-10	9-10	9-3	8-7	17-0	15-6	14-7	13-6	22-5	20-5	19-2	17-10	28-7	26-0	24-6	22-9
	No.1 & Btr.	10-7	9-8	9-1	8-5	16-8	15-2	14-3	13-3	21-11	19-11	18-9	17-5	28-0	25-5	23-11	22-3
	No.1	10-7	9-8	9-1	8-5	16-8	15-2	14-3	13-3	21-11	19-11	18-9	17-2	28-0	25-5	23-5	21-0
	No.2	10-1	9-2	8-8	8-0	15-11	14-5	13-7	12-7	20-11	19-0	17-11	16-0	26-9	24-0	21-11	19-7
	No.3	9-5	8-2	7-5	6-8	13-9	11-11	10-10	9-8	17-5	15-1	13-9	12-4	21-3	18-5	16-9	15-0
Ѕргисе-	Sel. Struc.	10-1	9-2	8-8	8-0	15-11	14-5	13-7	12-7	20-11	19-0	17-11	16-7	26-9	24-3	22-10	21-2
Pine-Fir	No.1	9-10	8-11	8-5	7-10	15-6	14-1	13-3	12-3	20-5	18-6	17-5	16-2	26-0	23-8	22-3	19-10
(South)	No.2	9-7	8-8	8-2	7-7	15-0	13-8	12-10	11-11	19-10	18-0	16-11	15-4	25-3	22-11	20-11	18-8
	No.3	8-11	7-9	7-0	6-4	13-0	11-3	10-4	9-3	16-6	14-3	13-0	11-8	20-2	17-5	15-11	14-3
Western	Sel. Struc.	9-10	8-11	8-5	7-10	15-6	14-1	13-3	12-3	20-5	18-6	17-5	16-2	26-0	23-8	22-3	20-2
Woods	No.1	9-7	8-8	8-2	7-7	15-0	13-8	12-7	11-3	19-10	17-6	16-0	14-3	24-8	21-4	19-6	17-5
	No.2	9-3	8-5	7-11	7-4	14-7	13-3	12-5	11-3	19-2	17-5	16-0	14-3	24-6	21-4	19-6	17-5
	No.3	8-2	7-0	6-5	5-9	11-11	10-4	9-5	8-5	15-1	13-0	11-11	10-8	18-5	15-11	14-6	13-0

__; __; __; (2) 1-3/4" X 11-7/8" LVL - 2X6 @ 16" O.C.

1 SECOND FLOOR CEILING FRAMING 3/16" = 1'-0"

Graphic Scale

EVERY ATTEMPT HAS BEEN MADE IN THE PREPARATION OF THESE DRAWINGS TO AVOID MISTAKES. THE DESIGNER, OR ANYONE ASSOCIATED WITH THE DESIGNER, WILL NOT BE HELD LIABLE FOR ANY ERRORS OR OMISSIONS IN THESE DRAWINGS ALL DRAWINGS SHOULD BE
REVIEWED BY LOCAL PROFESSIONAL
TO ASSURE CONFORMANCE WITH
LOCAL & STATE CODES.
ADDITIONAL ENGINEERING WORK IS
THE RESPONSIBILITY OF THE
CLIENT.

DATE/DESCRIPTIO

PLAN NUMBER

S 104

ROOF RAFTERS

No.1 & Btr.

Sel. Struc.

Design Criteria: Strength - 20 lbs. per sq. ft. snow load, plus 15 lbs. per sq. ft. dead load.

Deflection - Limited in span in inches divided by 360 for live load only.

20# SNOW LOAD 15# DEAD LOAD L/360

1 ROOF FRAMING PLAN 3/16" = 1'-0"

Span (feet and inches)

12" 16" 19.2" 24" | 12" 16" 19.2" 24" | 12" 16" 19.2" 24" | 12" 16" 19.2" 24"

 14-4
 13-0
 12-3
 11-4
 18-10
 17-2
 16-1
 15-0
 24-1
 21-10
 20-7
 19-1
 29-3
 26-7
 25-0
 23-3

 14-1
 12-9
 12-0
 11-2
 18-6
 16-10
 15-10
 14-8
 23-8
 21-6
 20-2
 18-9
 28-9
 26-1
 24-5
 21-10

 13-9
 12-6
 11-9
 10-11
 18-2
 16-6
 15-6
 14-1
 23-2
 21-1
 19-3
 17-3
 28-2
 24-5
 22-4
 20-0

 13-6
 12-3
 11-7
 10-7
 17-10
 16-2
 14-11
 13-4
 22-9
 20-0
 18-3
 16-4
 26-9
 23-2
 21-2
 18-11

 11-5
 9-10
 9-0
 8-1
 14-5
 12-6
 11-5
 10-3
 17-8
 15-3
 13-11
 12-6
 20-5
 17-9
 16-2
 14-6

 12-11
 11-9
 11-1
 10-3
 17-0
 15-6
 14-7
 13-6
 21-9
 19-9
 18-7
 17-3
 26-5
 24-0
 22-7
 21-0

 12-7
 11-5
 10-9
 10-0
 16-7
 15-1
 14-2
 13-2
 21-2
 19-3
 18-1
 16-7
 25-9
 23-5
 21-6
 19-2

 12-3
 11-2
 10-6
 9-9
 16-2
 14-8
 13-10
 12-10
 20-8
 18-9
 17-8
 15-10
 25-1
 22-6
 20-7
 18-5

 11-2
 9-8
 8-10
 7-10
 14-1
 12-2
 11-2
 10-0
 17-3
 14-11
 13-7
 12-2
 20-0
 17-3
 15-9
 14-1

 13-6
 12-3
 11-7
 10-9
 17-10
 16-2
 15-3
 14-2
 22-9
 20-8
 19-5
 18-0
 27-8
 25-1
 23-7
 21-11

 13-3
 12-0
 11-4
 10-6
 17-5
 15-10
 14-11
 13-10
 22-3
 20-2
 19-0
 17-8
 27-1
 24-7
 23-1
 20-11

 13-3
 12-0
 11-4
 10-6
 17-5
 15-10
 14-11
 13-10
 22-3
 20-2
 19-0
 17-0
 27-1
 24-2
 22-0
 19-9

 12-7
 11-5
 10-9
 10-0
 16-7
 15-1
 14-2
 13-0
 21-2
 19-3
 17-9
 15-10
 25-9
 22-6
 20-7
 18-5

 11-2
 9-8
 8-10
 7-10
 14-1
 12-2
 11-2
 10-0
 17-3
 14-11
 13-7
 12-2
 20-0
 17-3
 15-9
 14-1

 11-2
 9-6
 6-10
 7-10
 14-1
 12-2
 11-2
 10-0
 11-3
 14-1
 13-7
 12-2
 20-0
 11-3
 13-9
 14-1

 12-7
 11-5
 10-9
 10-0
 16-7
 15-1
 14-2
 13-2
 21-2
 19-3
 18-1
 16-10
 25-9
 23-5
 22-1
 20-6

 12-3
 11-2
 10-6
 9-9
 16-2
 14-8
 13-10
 12-10
 20-8
 18-9
 17-8
 16-1
 25-1
 22-10
 20-11
 18-8

 11-11
 10-10
 10-2
 9-6
 15-9
 14-3
 13-5
 12-5
 20-1
 18-3
 16-11
 15-2
 24-5
 21-6
 19-8
 17-7

 10-7
 9-2
 8-4
 7-6
 13-4
 11-7
 10-7
 9-5
 16-4
 14-2
 12-11
 11-7
 18-11
 16-5
 15-0
 13-5

 12-3
 11-2
 10-6
 9-9
 16-2
 14-8
 13-10
 12-10

dowds **DESIGN COLLECTION, LLC**

> MONA SHIR WEST HAVEN, CT mona.pro.shir@outlook.com 443 962 1396

SIDENCE **FRAMING** 00F EARNE

EVERY ATTEMPT HAS BEEN MADE IN
THE PREPARATION OF THESE
DRAWINGS TO AVOID MISTAKES.
THE DESIGNER, OR ANYONE
ASSOCIATED WITH THE DESIGNER,
WILL NOT BE HELD LIABLE FOR ANY
ERRORS OR OMISSIONS IN THESE
DRAWINGS


ALL DRAWINGS SHOULD BE REVIEWED BY LOCAL PROFESSIONAL TO ASSURE CONFORMANCE WITH LOCAL & STATE CODES. ADDITIONAL ENGINEERING WORK IS THE RESPONSIBILITY OF THE CLIENT.

DATE/DESCRIPTION

PLAN NUMBER

Graphic Scale

S 105

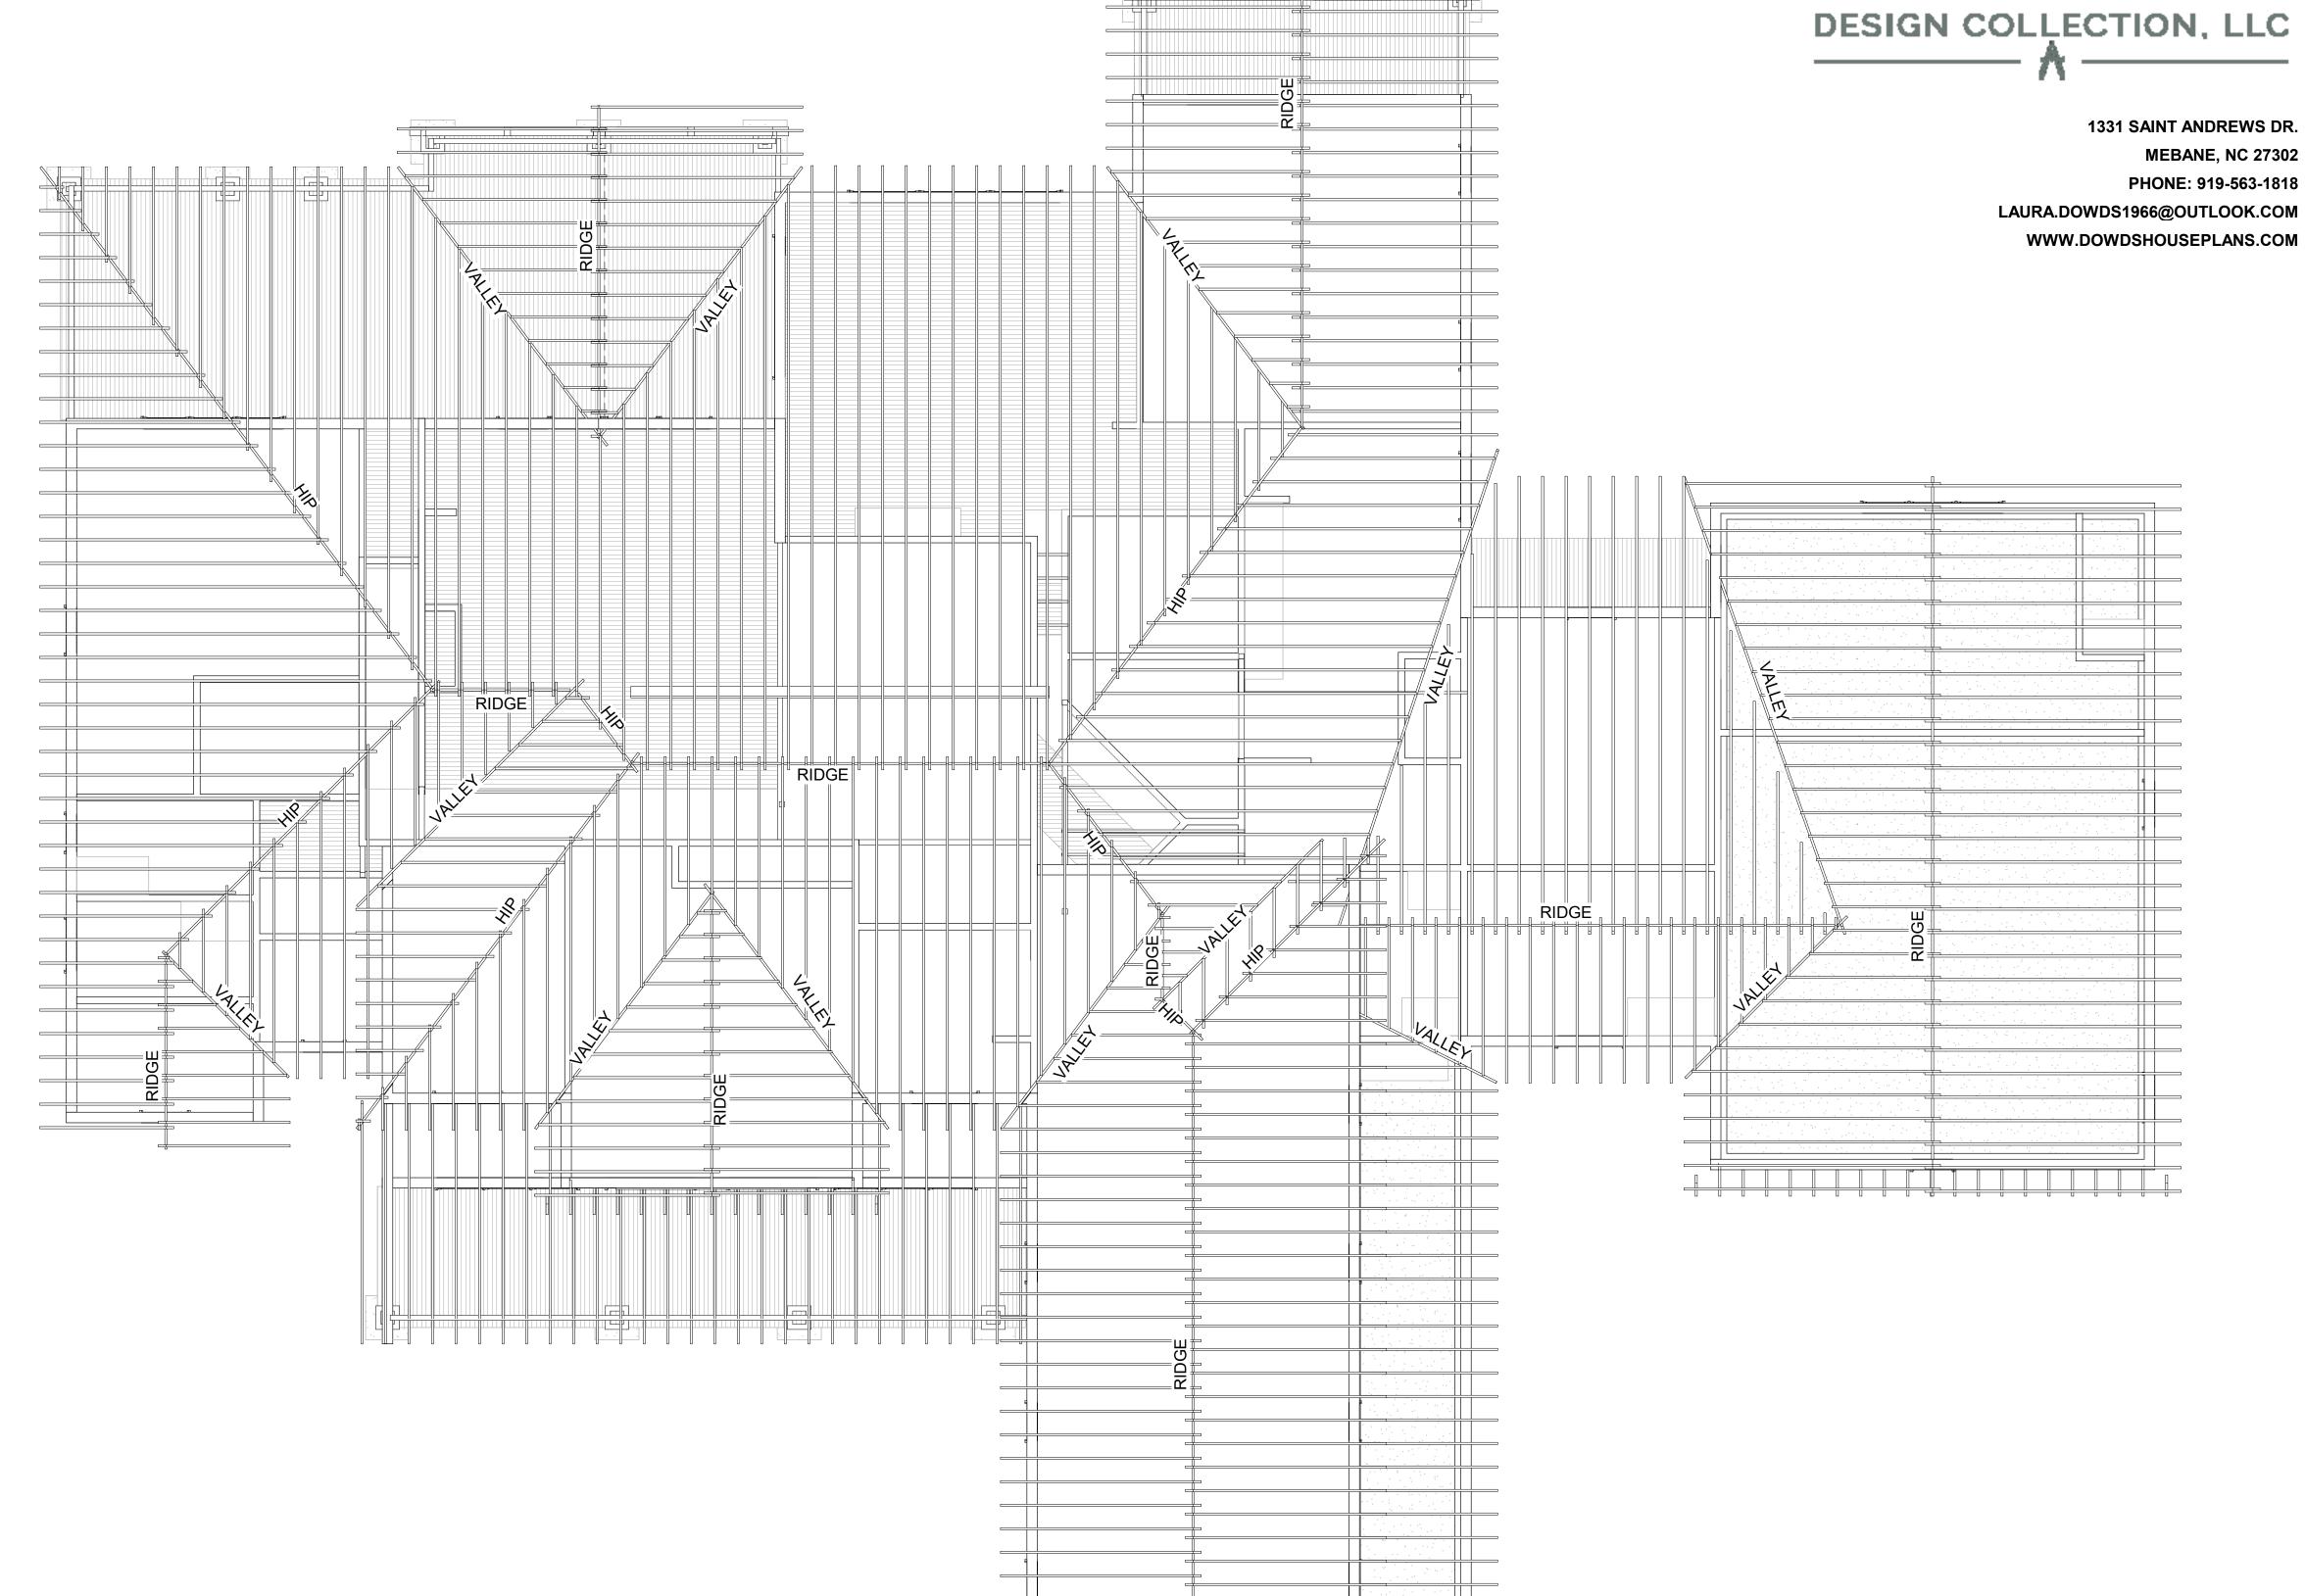

Dowds Design Collection, LLC. is a house plan design company and not structural engineers. The including structure, foundation, windows, and doors are a guide only for construction and all dimensions and notations attached need to be verified & confirmed by a structural engineer.