Wellers Knoll Lot 83 Ash ELEVATION 'B'



FRONT DOOR STYLE PER PURCHASE ORDER

INCLUDED OPTIONS:

1st FLOOR EXTENDED COVERED PORCH OPEN RAIL OWNERS SPA SHOWER LAUNDRY SINK

2nd FLOOR 2ND SINK @ BATH 2

	ELEVAT	ION 'B'			
	UNHEATED	HEATED			
FIRST FLOOR	0	1496			
SECOND FLOOR	0	891			
MECHANICAL	102	0			
REAR COVERED PORCH	89	0			
FRONT PORCH	125	0			
2-CAR GARAGE	449	0			
SUBTOTALS	765	2387			
TOTAL UNDER ROOF	TOTAL UNDER ROOF 3152				
0	PTIONS				
	UNHEATED S.F.	HEATED S.F.			

SOUTH DESIGNS (0) 919-556-2226 (F) 919-556-2228 www.southdesigns.com





2387 - ASH - RH

Cover Sheet 'B'

DRAWN BY: South Designs ISSUE DATE: 09/29/2018 CURRENT REVISION DATE: 10/13/2020

1/8" = 1'-0"
SHEET

CRAWL VENTING

1496 SQ FT OF FOUNDATION TO BE VENTED
150 SQ FT / 1 SQ FT = 9.97 SQ FT VENTILATION

VENTS 40 SQ IN = (0.278 SQ FT)

CRAWL VENT

 $\frac{9.97}{0.278} \frac{\text{SQ FT}}{\text{SQ FT}} = 35.87 \text{ VENTS REQUIRED}$

ACTUAL CRAWL VENTS PROVIDED 36

NOTE


WHERE AN APPROVED VAPOR BARRIER IS INSTALLED OVER GROUND SURFACE THE REQUIRED VENTILATION MAY BE REDUCED BY 50%.


General Floor Plan Notes


General Floor Plan Notes shall apply unless noted otherwise on plan.

- Wall Heights: Typically 9"-1 1/2" at first floor and second floor, and 8"-1 1/2" at attics U.N.O. All walls are constructed using a double top plate. Splices at Double Top Plate do not need to occur at Vertical Studs but must be at least 24" apart from Joint in other Top Plate layer. Special wall heights are noted on plans where they occur.
- Wall Thickness is typically 4" at exterior walls, 3 1/2" at interior. 2x6 frame shall be used at walls that back up to plumbing fixtures. Walls greater than 10' high shall be framed with 2x6 framing or greater and will be noted as a special condition where it occurs on plan.
- Typical header height shall be 8'-0" AFF at First Floor, and 7'-0" AFF at Second Floor U.N.O.
- Jacks: Openings up to 3'-4" wide shall have (1) 2x4 jack stud SPF on each side. Openings greater than 3'-4" wide shall have (2) 2x4 jack studs SPF on each side.
- Soffits, Coffered Ceilings, Trey Ceilings and other significant ceiling plan elements are shown on the floor plans and are denoted as single dashed lines. Unless specifically call out as included, Kitchens do not include soffits over wall cabinetry.
- Door & Window Frames, where occurring near corners, shall be a minimum of 4 1/2" from corner. Except for walk-in closets with doors near a corner, doors at closets shall be centered on closet.
- Windows: Shall have at least (1) window in each sleeping room, that meets egress. Shall be provided with tempered glass at hazardous glazing areas. False windows shall be installed with obscure alazina.
- Closets for clothing or coat storage shall be equipped with 1 rod/shelf (unless otherwise noted). Closets for linen shall have 5 open equal shelves. Closets for pantries shall have 5 equal wood shelves, painted.
- Stair treads shall be a min of 9" deep, risers shall be a maximum of 8 1/4", unless noted otherwise, per the current North Carolina Residential Code
- 10. Handrails and Guards at stairs shall be 34" above the finished surface of the ramp surface of the stair. Handrails at landings and overlooks of multilevel spaces shall be 36" above finished floor. Guards (pickets or ballsters) shall be spaced with no more than 4" between guards.
- Aftic Access shall be provided at all attic area with a height greater than 30". Minimum clear attic access shall be 20" x 30". Pull down stairs and access doors in knee walls meeting minimum criteria are also acceptable.
- 12.Garage Door to Living Space shall be 2'-8" x 6'-8" minimum size and shall be 20 minute fire rated and weather sealed.
- 13. Garage Walls, as a minimum, shall be separated from living space by installing 1/2" gypsum board on the garage side of the wall. With habitable space above, the inside of all garage walls require 1/2" GWB supporting 5/8" type X GWB on ceiling.

Wellers Knoll Lot 83

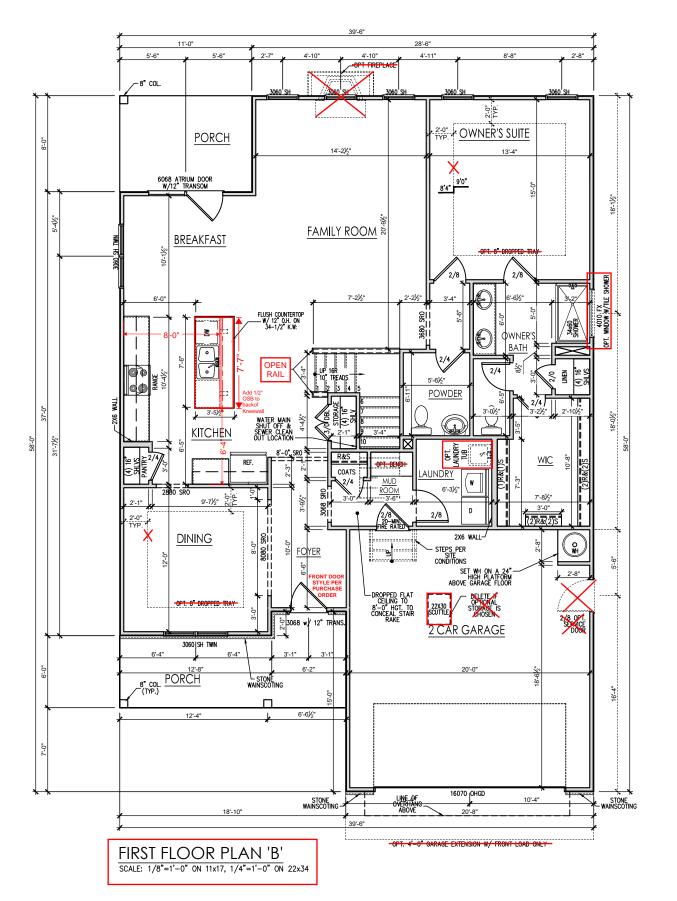


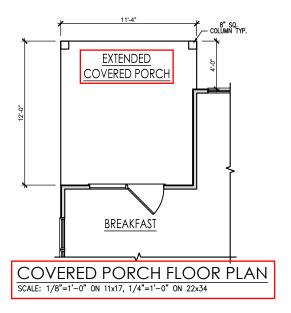

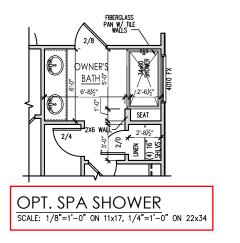



DAVIDSON HOMES

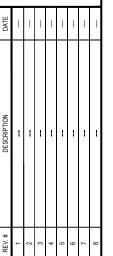

---First Floor Plan 'B

RH

1

ASH

2387

DRAWN BY: South Designs

ISSUE DATE: 09/29/2018


CURRENT REVISION DATE 10/13/2020 SCALE: 1/8" = 11-0"

2.1b

General Floor Plan Notes

General Floor Plan Notes shall apply unless noted otherwise on plan.

- Wall Heights: Typically 9-1 1/2" at first floor and second floor, and 8-1 1/2" at attics U.N.O. All walls are constructed using a double top plate. Splices at Double Top Plate do not need to occur at Vertical Studs but must be at least 24" apart from Joint in other Top Plate layer. Special wall heights are noted on plans where they occur.
- Wall Thickness is typically 4" at exterior walls, 3 1/2" at interior. 2x6 frame shall be used at walls that back up to plumbing fixtures. Walls greater than 10' high shall be framed with 2x6 framing or greater and will be noted as a special condition where it occurs on plan.
- Typical header height shall be 8'-0" AFF at First Floor, and 7'-0" AFF at Second Floor U.N.O.
- Jacks: Openings up to 3'-4" wide shall have (1) 2x4 jack stud SPF on each side. Openings greater than 3'-4" wide shall have (2) 2x4 jack studs SPF on each side.
- Soffits, Coffered Ceilings, Trey Ceilings and other significant ceiling plan elements are shown on the floor plans and are denoted as single dashed lines. Unless specifically call out as included, Kitchens do not include soffits over wall cabinetry.
- Door & Window Frames, where occurring near corners, shall be a minimum of 4 1/2" from corner. Except for walk-in closets with doors near a corner, doors at closets shall be centered on closet.
- Windows: Shall have at least (1) window in each sleeping room, that meets egress. Shall be provided with tempered glass at hazardous glazing areas.
 False windows shall be installed with obscure alazina.
- Closets for clothing or coat storage shall be equipped with 1 rod/shelf (unless otherwise noted). Closets for linen shall have 5 open equal shelves. Closets for pantries shall have 5 equal wood shelves, painted.
- Stair treads shall be a min of 9" deep, risers shall be a maximum of 8 1/4", unless noted otherwise, per the current North Carolina Residential Code
- 10. Handrails and Guards at stairs shall be 34" above the finished surface of the ramp surface of the stair. Handrails at landings and overlooks of multilevel spaces shall be 36" above finished floor. Guards (pickets or ballsters) shall be spaced with no more than 4" between guards.
- Affic Access shall be provided at all affic area with a height greater than 30". Minimum clear affic access shall be 20" x 30". Pull down stairs and access doors in knee walls meeting minimum criteria are also acceptable.
- 12. Garage Door to Living Space shall be 2'-8" x 6'-8" minimum size and shall be 20 minute fire rated and weather sealed.
- 13. Garage Walls, as a minimum, shall be separated from living space by installing 1/2" gypsum board on the garage side of the wall. With habitable space above, the inside of all garage walls require 1/2" GWB supporting 5/8" type X GWB on ceiling.

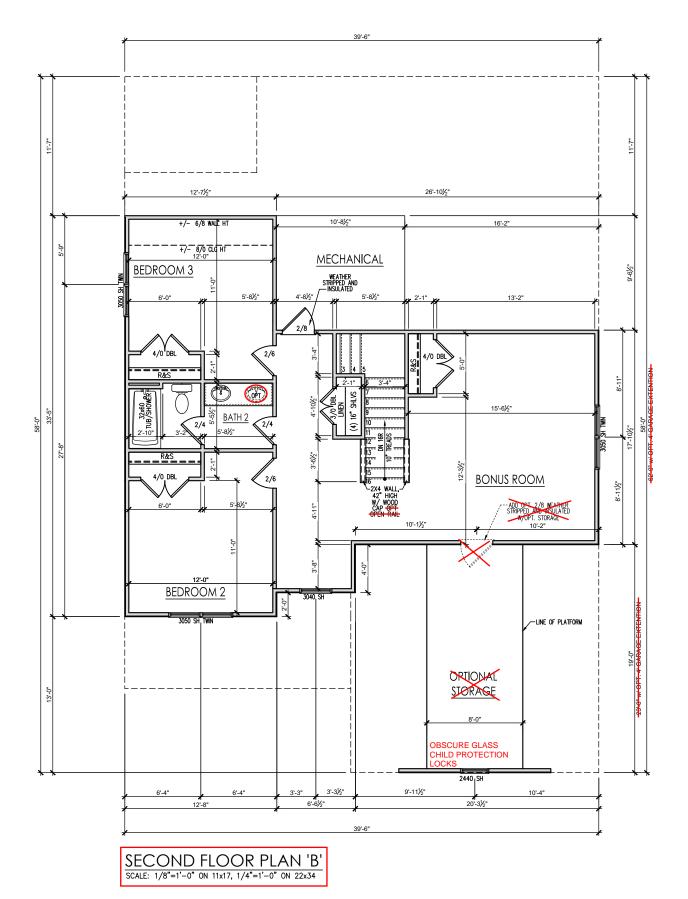

Wellers Knoll Lot 83



		4	DAVIDSON
--	--	---	----------

DATE								
DESCRIPTION								
REV. #	1	7	3	4	9	9	7	8

2387 - ASH - RH
--Second Floor Plan 'E

DRAWN BY: South Designs

ISSUE DATE: 09/29/2018

CURRENT REVISION DATE 10/13/2020 SCALE: 1/8" = 1'-0"

2.2b

General Elevation Notes

General Elevation Notes shall apply unless noted otherwise on plan.


- Roof shall be finished with architectural composition shingles with slopes as noted on plan.
- Ridge Vent shall be provided and installed on all ridges greater than 6' in length per manufacturer's specifications.
- 3. Soffit Vent shall be continuous soffit vent
- House Wrap, "tyvek" or approved equal shall be installed over entire exterior wall per manufacturer's specifications and recommendations.
- Flashing shall be provided above all door and window openings, above finish wall material changes and at wall surfaces where lower roof areas abut vertical wall surfaces.
- Porch Railings shall be provided at all porch walking surfaces greater than 30" above adjacent finished grade. It shall be 36" high with guards spaced no more than 4" apart. Consult community specifications for metabol.
- 7. Finish Wall Material shall be as noted on elevation drawings
- 8. Brick Veneer, if included on elevation shall be fied to wall surface with galvanized corrugated metal fies at a rate of 24" oc horizontally and 16" oc vertically so that no more than 2.67sf of brick is supported by (1) fie. Space between face of wall and back face of bricks shall be limited to a maximum of 1". Flashing shall be provided behind brick above all wall openings and at base of brick wall. Flashing shall be a minimum of 6-mil poly or other corrosion resistant material and shall be installed so that it laps under the house wrap material a minimum of 2". Weepholes shall be provided at a rate of 48" oc and shall not be less than 3/16" in diameter and shall be located immediately above flashing.
- Brick Veneer Support Lintels shall be provided if brick veneer is included on elevation. Lintels shall be provided as listed in the following schedule and shall have a minimum bearing length of 6°. Masonry Lintels shall be provided so that deflection is limited to LYADO.


Masonry Opening Lintel Schedule

Opening Size	Angle
--------------	-------

ot au	4'-0"		3-1/2" x 3-1/2" x 5/1
4'-1"	to	5'-6"	4" x 3-1/2" x 5/16" L
5'-7"	to	6'-6"	5" x 3-1/2" x 5/16" L
6'-7"	to	8'-4"	6" x 3-1/2" x 5/16" L
8'-5"	to	16'-4"	7" x 4" x 3/8" LLV


Wellers Knoll Lot 83

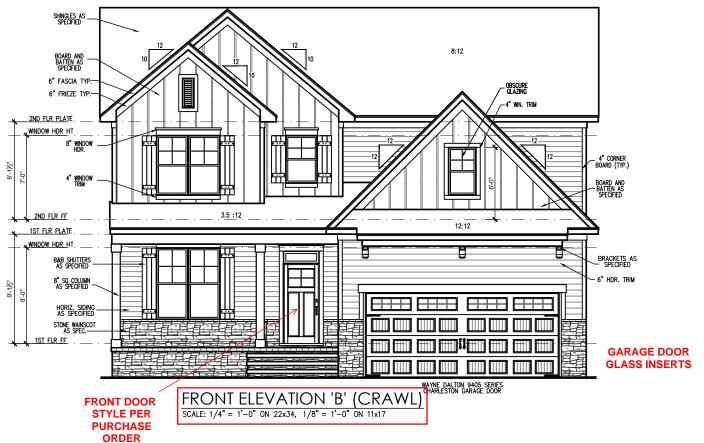

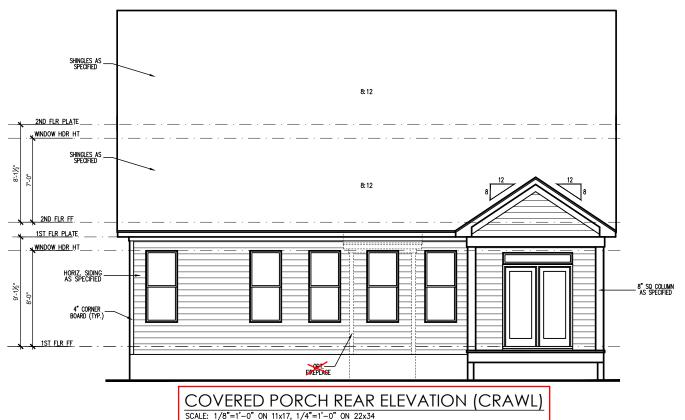





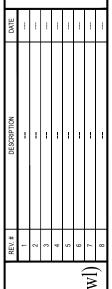

2387 - ASH - RH
--Front and Rear Elevations 'B' (Crawl)

DRAWN BY: South Designs ISSUE DATE: 09/29/2018

CURRENT REVISION DATE 10/13/2020 SCALE: 1/8" = 1'-0"

3.3b

General Elevation Notes


General Elevation Notes shall apply unless noted otherwise on plan.


- Roof shall be finished with architectural composition
- Ridge Vent shall be provided and installed on all ridges greater than 6' in length per manufacturer's specifications.
- 3. Soffit Vent shall be continuous soffit vent
- House Wrap, "tyvek" or approved equal shall be installed over entire exterior wall per manufacturer's specifications and recommendations.
- Flashing shall be provided above all door and
- Porch Railings shall be provided at all porch walking surfaces greater than 30" above adjacent finished
- Finish Wall Material shall be as noted on elevation
- Brick Veneer, if included on elevation shall be tied to wall surface with galvanized corrugated metal ties at a rate of 24" oc horizontally and 16" oc vertically so a rate of 24" oc horizontally and 16" oc vertically so that no more than 2.67s of brick is supported by (1) the Space between face of wall and back face of brick shall be limited to a maximum of 1". Flashing shall be provided behind brick above all wall openings and at base of brick wall. Flashing shall be a minimum of 6-mil poly or other corrosion resistant material and shall be installed so that it laps under the house warp material a minimum of 2".

 Weepholes shall be provided at a rate of 48" oc and shall not be less than 31/8" in diameter and shall be located immediately above flashing.
- Brick Veneer Support Lintels shall be provided if brick


7-7" to 6'-6" 5" x 3-1/2" x 5/16" LLV '-7" to 8'-4" 6" x 3-1/2" x 5/16" LLV	3-1/2" x 3-1/2" x 5/16" 4" x 3-1/2" x 5/16" LLV 5" x 3-1/2" x 5/16" LLV
Y-1" to 5'-6" 4" x 3-1/2" x 5/16" LLV Y-7" to 6'-6" 5" x 3-1/2" x 5/16" LLV Y-7" to 8'-4" 6" x 3-1/2" x 5/16" LLV	4" x 3-1/2" x 5/16" LLV 5" x 3-1/2" x 5/16" LLV 6" x 3-1/2" x 5/16" LLV
7'-7" to 6'-6" 5" x 3-1/2" x 5/16" LLV '-7" to 8'-4" 6" x 3-1/2" x 5/16" LLV	5" x 3-1/2" x 5/16" LLV 6" x 3-1/2" x 5/16" LLV
'-7" to 8'-4" 6" x 3-1/2" x 5/16" LLV	6" x 3-1/2" x 5/16" LLV
".5" to 14'.4" 7" v 4" v 2/9" IIV	7" x 4" x 3/8" LLV
-5 10 10-4 / X4 X5/6 LLV	

Wellers Knoll Lot 83

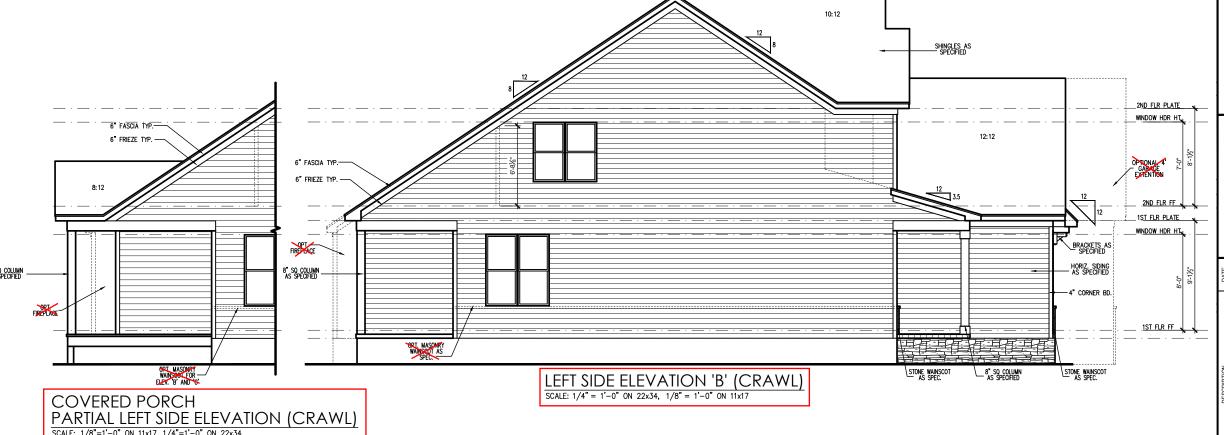

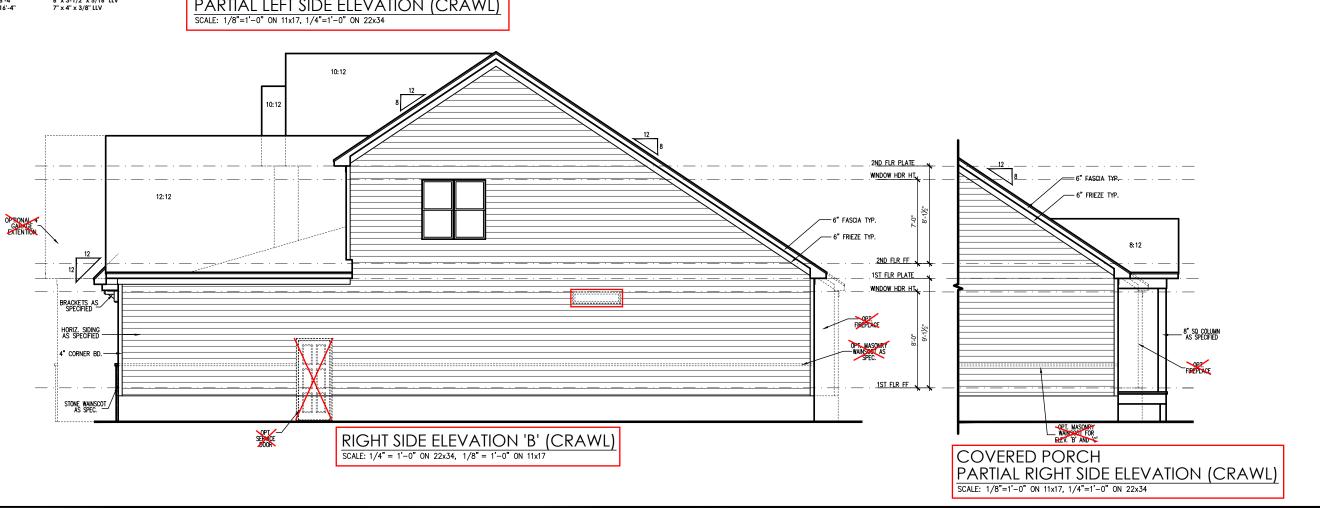



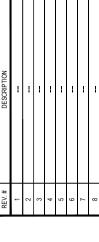

Side Elevations 'B' (Crawl) - RH -ASH 2387


DRAWN BY: South Designs ISSUE DATE: 09/29/2018 CURRENT REVISION DATE 10/13/2020

1/8" = 1'-0" 3.4b

	1,00
	- *
8.12	
16 LF RIDGE VENT	
10:12 10:12	51
11-0- 11-0-	0.01
ELEVATION 'B' ROOF PLAN SCALE: 1/4" = 1'-0" ON 22x34, 1/8" = 1'-0" ON 11x17	507-1
	1'-0"

	ATTIC VENT SCHEDULE								
	ELEVATION 'B'								
MAIN	HOUSE		SQ FTG	2034	AT	AT / NEAR RIDGE			AR EAVE
VENT TYPE	SQ. REQL	FT.	SQ. FT.	PERCENT OF TOTAL	POT LARGE (SQ. FT. EACH)	POT SMALL (SQ. FT. EACH)	RIDGE VENT (SQ. FT. PER LF)	EAVE VENT (SQ. IN. EACH)	CONT. VENT (SQ. IN. PER LF)
72.11112	RANGE			SUPPLIED	0.4236	0.2778	0.125	0.1944	0.0625
RIDGE VENT	2.71	3,39	3.00	45.28	0	0	24.00		
SOFFIT VENTS	4.07	3.39	3.63	54.72	0	Ů	24.00	0	58.00
TOTAL (MIN)	6.78	6.78	6.63	100.00	POT VENTS MAY BE REQUIRED IF THERE IS INSUFFICIENT RIDGE AVAILABLE				


^{*} SCHEDULE HAS BEEN CALCULATED ASSUMING EAVE VENTILATION AT 50-60% OF TOTAL AND RIDGE AT 40-50% OF TOTAL REQUIRED VENTILATION

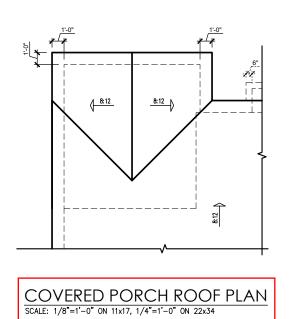

Wellers Knoll Lot 83





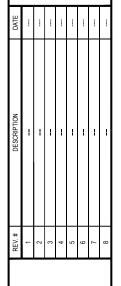


2387 - ASH - RH ---

DRAWN BY: South Designs ISSUE DATE:

ISSUE DATE:
09/29/2018

CURRENT REVISION DATE 10/13/2020 SCALE: 1/8" = 1'-0"

3.5b

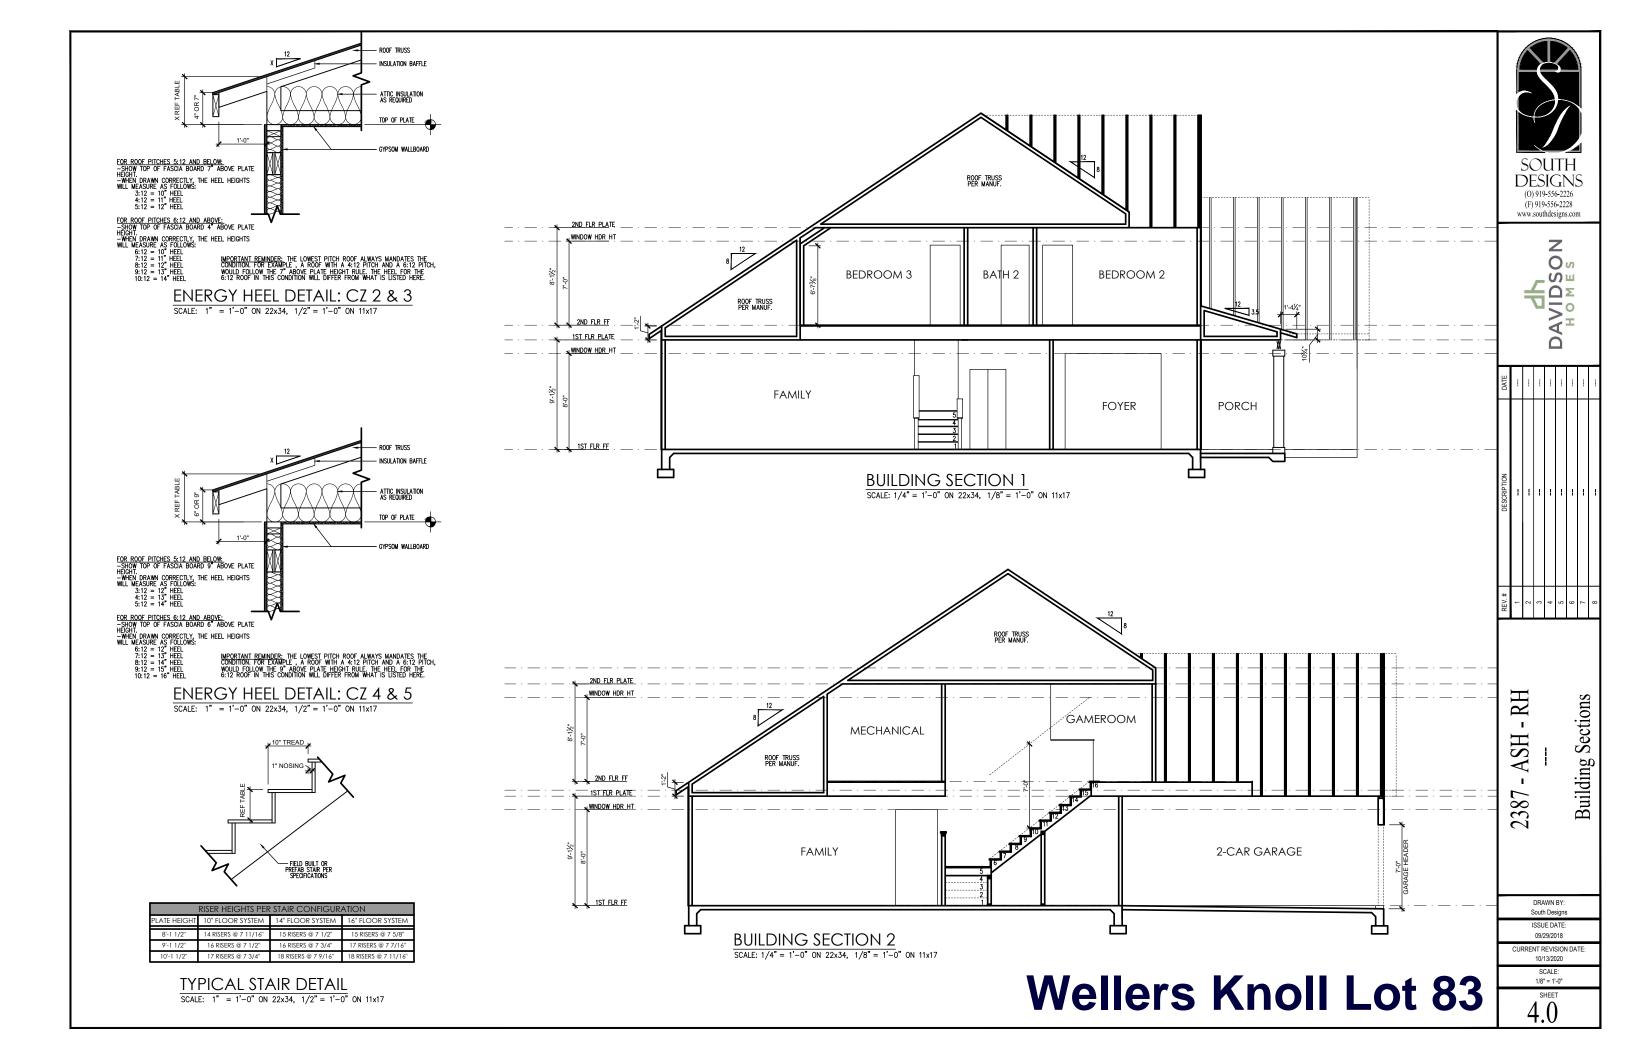

ELECTRICAL SYMBOL KEY LIGHT FIXTURES CEILING SURFACE MOUNT LIGHT RECESSED CAN LIGHT RECESSED CAN LIGHT WATERPROOF RECESSED CAN - EYEBALL ◆ PENDANT LIGHTING ₩ALL SCONCE ₩ALL MOUNT LIGHT FLOOD LIGHT DUPLEX OUTLET GFI OUTLET GFI-WP WATERPROOF GFI OUTLET SWITCHED 1/2 HOT DUPLEX OUTLET 220V OUTLET 220V OUTLET TELEPHONE OUTLET CATV (TELEVISION) OUTLET Ø CEILING MOUNTED DUP. OUTLET \$\mathcal{Q}_{\textstyle{LOOR}} \text{ FLOOR MOUNTED DUP. OUTLET **SWITCHES** \$ SINGLE POLE SWITCH \$3 THREE-WAY SWITCH THREE-WAY SWITCH \$4 FOUR-WAY SWITCH ELECTRICAL DISCONNECT MISC FIXTURES EXHAUST FAN UNCTION BOX ⊕_{220V} JUNCTION BOX 220V CARBON MONOXIDE DETECTOR OR SMOKE CO.SD CARBON MONOXIDE DETECTOR AND SMOKE DETECTOR ELECTRIC METER ELECTRICAL PANEL DOOR BELL CHIME DOOR BELL PUSH BUTTON CEILING FAN PREWIRE FLUORESCENT LIGHT

General Power and Lighting:

General Power and Lighting Notes shall apply unless noted otherwise on plans.


All work shall be installed per the current NC Residential Building Code, and the National Electric Code. Alarm devices shall meet NFPA 72.


- Smoke Alarms Shall be provided as a minimum of (1) per floor, including basements (fl applicable), (1) in each sleep room, and (1) outside each sleeping area, within the immediate vicinity of sleeping rooms. When more than one alarm is required, the alarm devices shall be interconnected in such a manner that the activation of one alarm will activate all of the alarms. Smoke alarms shall be bard wised to premanent nower and shall have shall be hard wired to permanent power and shall have
- Switches For lighting, fans, etc. shall be installed at heights illustrated on this page and shall be located a minimum of 4 1/2" from door openings to allow for the proper installation of door casings. Switches, thermostats security pads, and other similar devices shall be grouped together and installed thoughtfully for convenience of use and to avoid placement within centers of wall areas.

Note:
This plan is a diagram showing approximate locations of convenience outlets based on requirements found in the NC Residential Code and N.E.C. Actual positions may vary from

ELECTRICAL BOX HEIGHTS

Wellers Knoll Lot 83

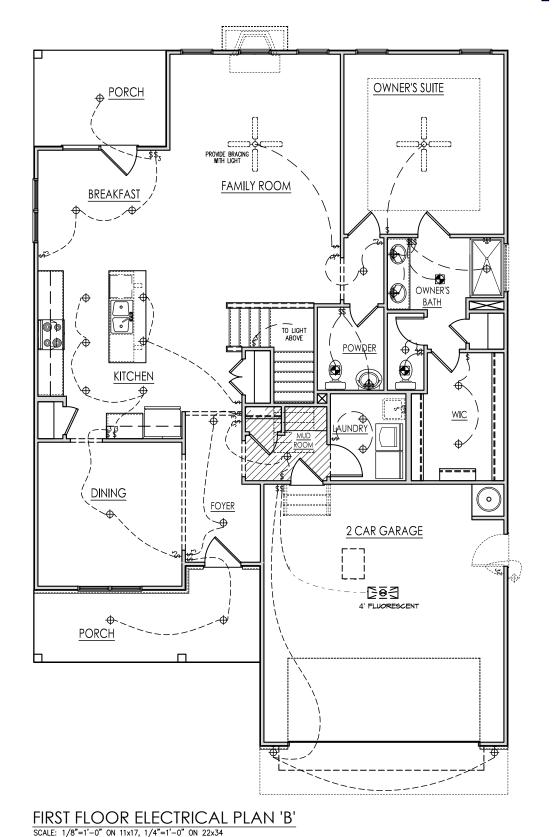


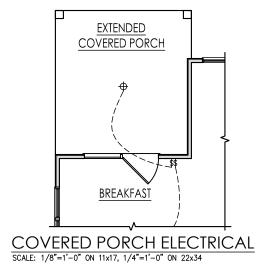







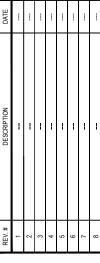

First Floor Electrical 'B' - RH -ASH 2387

> DRAWN BY: South Designs

ISSUE DATE:

09/29/2018 CURRENT REVISION DATE 10/13/2020

1/8" = 1'-0"

ELECTRICAL SYMBOL KEY LIGHT FIXTURES CEILING SURFACE MOUNT LIGHT RECESSED CAN LIGHT RECESSED CAN LIGHT WATERPROOF RECESSED CAN - EYEBALL ● PENDANT LIGHTING ₩ WALL SCONCE ₩ALL MOUNT LIGHT FLOOD LIGHT OUTLETS DUPLEX OUTLET **€**GFI OUTLET GEI-WP WATERPROOF GFI OUTLET SWITCHED 1/2 HOT DUPLEX OUTLET 220V OUTLET TELEPHONE OUTLET Ø CEILING MOUNTED DUP. OUTLET \$\mathcal{Q}_{\textstyle \textstyle \textsty **SWITCHES** \$ SINGLE POLE SWITCH \$3 THREE-WAY SWITCH \$4 FOUR-WAY SWITCH ELECTRICAL DISCONNECT MISC FIXTURES EXHAUST FAN UNCTION BOX ⊕_{220V} JUNCTION BOX 220V CARBON MONOXIDE DETECTOR OR SMOKE DETECTOR CARBON MONOXIDE DETECTOR AND SMOKE DETECTOR ELECTRIC METER ELECTRICAL PANEL DOOR BELL CHIME DOOR BELL PUSH BUTTON CEILING FAN PREWIRE FLUORESCENT LIGHT


General Power and Lighting:

General Power and Lighting Notes shall apply unless noted otherwise on plans.

All work shall be installed per the current NC Residential Building Code, and the National Electric Code. Alarm devices shall meet NFPA 72.


- Smoke Alarms Shall be provided as a minimum of (1)
 per floor, including basements (if applicable), (1) in each
 sleep room, and (1) outside each sleeping area, within
 the immediate vicinity of sleeping rooms. When more
 than one alarm is required, the alarm devices shall be
 interconnected in such a manner that the activation of
 one alarm will activate all of the alarms. Smoke alarms
 shall be hard wired to permanent power and shall have
 batter back-ups.
- 2. Switches For lighting, fans, etc. shall be installed at heights illustrated on this page and shall be located a minimum of 4 1/2" from door openings to allow for the proper installation of door casings. Switches, thermostats, security pads, and other similar devices shall be grouped together and installed thoughtfully for convenience of use and to avoid placement within centers of wall areas.

Note:
This plan is a diagram showing approximate locations of convenience outlets based on requirements found in the NC Residential Code and N.E.C. Actual positions may vary from what is shown on plan.

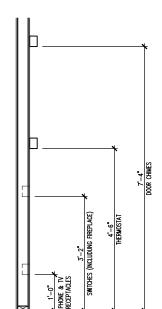

ELECTRICAL BOX HEIGHTS

Wellers Knoll Lot 83

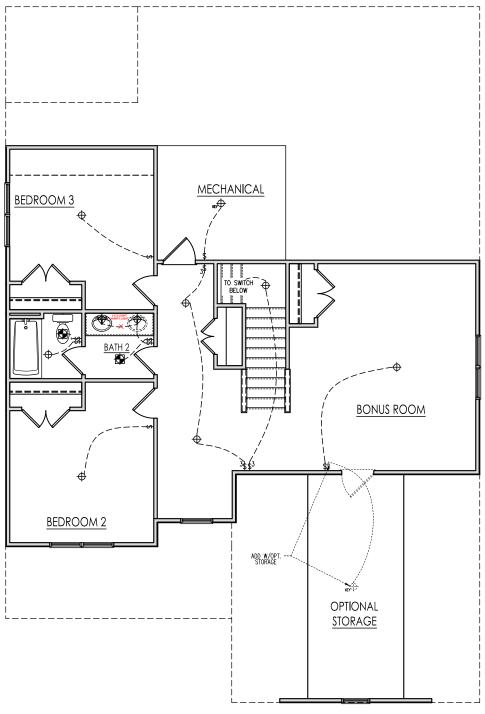

SECOND FLOOR ELECTRICAL PLAN 'B'

SCALE: 1/8"=1'-0" ON 11x17, 1/4"=1'-0" ON 22x34





DATE								
DESCRIPTION			1					
REV. #	1	2	3	4	2	9	7	8

2387 - ASH - RH
--Second Floor Electrical 'B'


DRAWN BY: South Designs


ISSUE DATE: 09/29/2018

CURRENT REVISION DATE: 10/13/2020

> SCALE: 1/8" = 1'-0"

5.2b

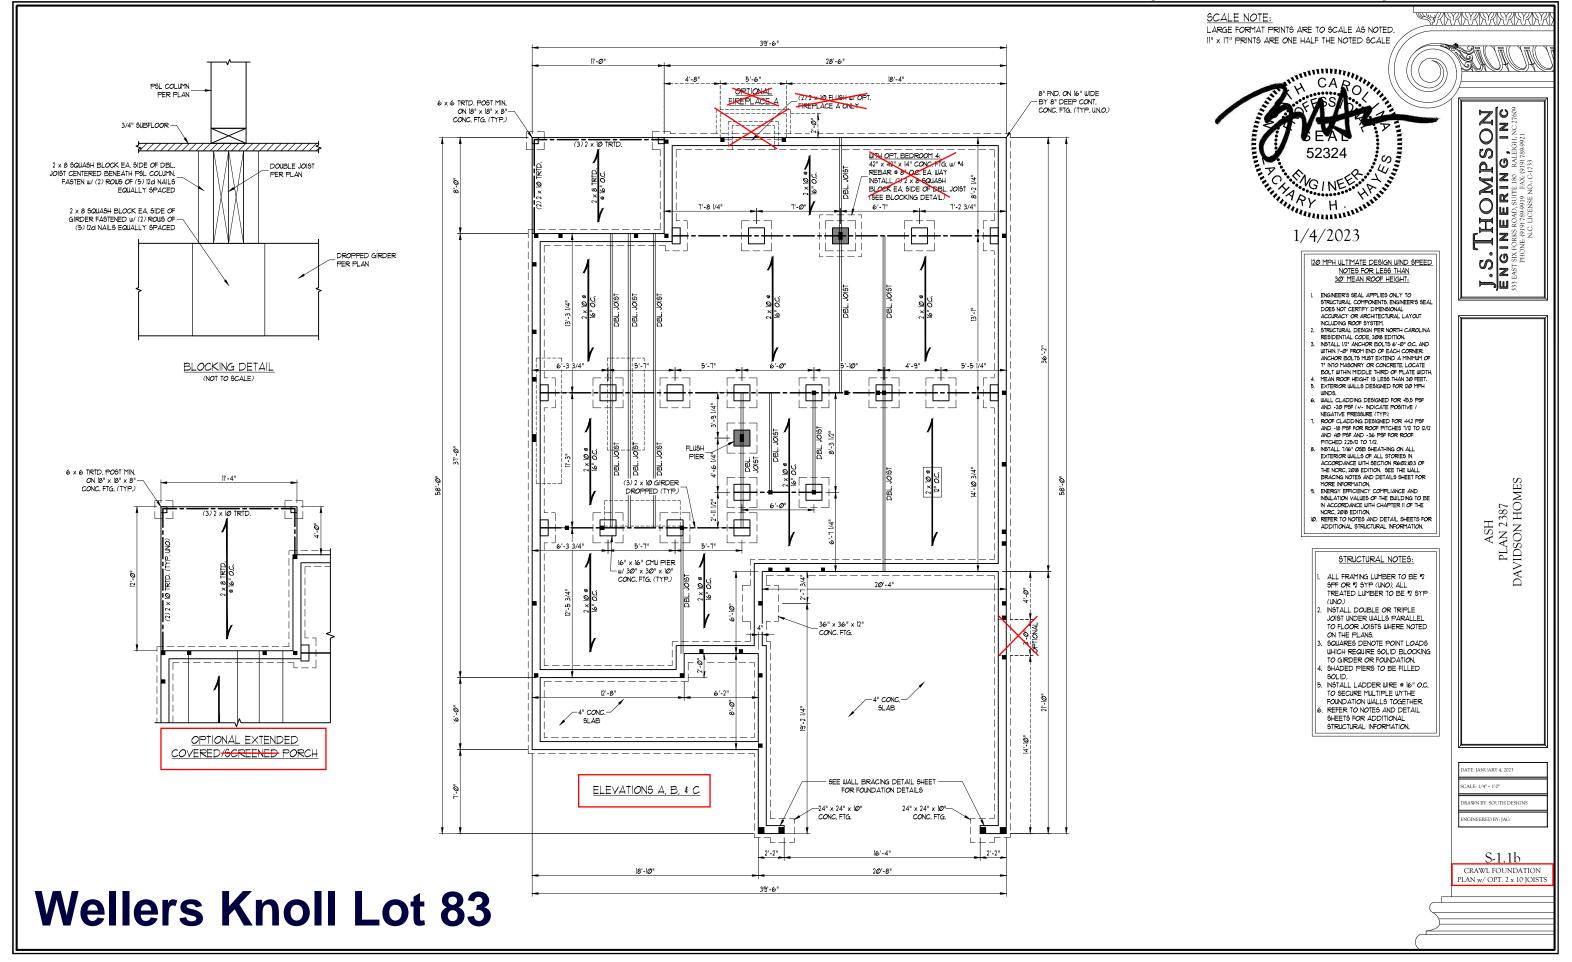

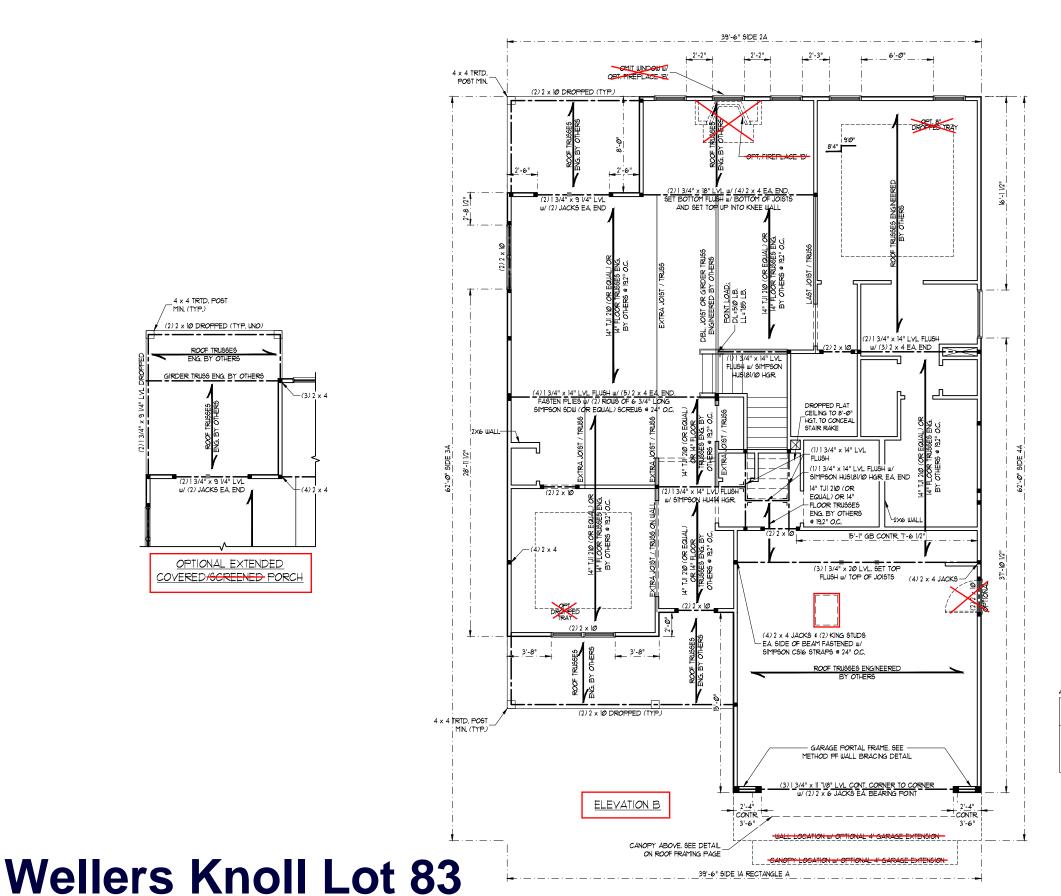

4 x 4 TRTD, POST

(2) 2 x 10 DROPPED (TYP. UNO)

GIRDER TRUSS ENG. BY OTHERS

w/ (2) JACKS EA. END

OPTIONAL EXTENDED

COVERED/GCREENED PORCH

SCALE NOTE:

LARGE FORMAT PRINTS ARE TO SCALE AS NOTED. 11" x 17" PRINTS ARE ONE HALF THE NOTED SCALE

"HILLIAN THE STATE OF THE STATE

1/4/2023

BRACED WALL DESIGN NOTES:

- BRACED WALL DESIGN PER SECTION R602:10 OF THE NCRC 2018 EDITION.
- CS-WSP REFERS TO "CONTINUOUS SHEATHING WOOD STRUCTURAL PANELS" CONTRACTOR 19 TO INSTALL 1/16" OSB ON ALL EXTERIOR WALLS ATTACHED W/ 8d NAILS SPACED 6" O.C. ALONG PANEL EDGES AND 12" O.C. IN THE FIELD.

 *GB REFERS TO "GYPSUM BOARD" CONTRACTOR IS TO INSTALL
- 1/2" (MIN.) GYPSUM WALL BOARD WHERE NOTED ON THE PLANS. FASTEN GB WITH I 1/4" SCREWS OR I 5/8" NAILS SPACED T" O.C. ALONG PANEL EDGES AND IN THE FIELD INCLUDING TOP AND BOTTOM PLATES.
- BRACED WALL DESIGN APPLIED IN WIND ZONES UP TO 130 MPH. FOR HIGH WIND ZONES, BRACE WALLS ARE TO BE CONSTRUCTED IN ACCORDANCE WITH CHAPTER 45 OF THE NORC 2018 EDITION. SEE NOTES AND DETAIL SHEETS FOR ADDITIONAL BRACED

WALL INFORMATION.

BRACED WALL DESIGN RECTANGLE B RECTANGLE A SIDE IA (FRONT LOAD) METHOD: C9-W9P/GB/PF
TOTAL REQUIRED LENGTH: 15.58'
TOTAL PROVIDED LENGTH: 21.88' METHOD: PF/C5-W5P TOTAL REQUIRED LENGTH: 2.4T' TOTAL PROVIDED LENGTH: 9" SIDE 2A METHOD: C5-WSP METHOD: CS-WSF TOTAL REQUIRED LENGTH: 15.58'
TOTAL PROVIDED LENGTH: 11.58' TOTAL REQUIRED LENGTH: 2.41'
TOTAL PROVIDED LENGTH: 14.0' SIDE 3A METHOD: C5-WSP SIDE 3B/4A COMBINED METHOD: CS-WSF TOTAL REQUIRED LENGTH: 10/31' TOTAL PROVIDED LENGTH: 56/61' TOTAL REQUIRED LENGTH: 12.31'
TOTAL PROVIDED LENGTH: 29.0'

SIDE 4A (SIDE LOAD) METHOD: CS-WSP TOTAL REQUIRED LENGTH: 10:31

SIDE 4B METHOD: C9-WSF TOTAL REQUIRED LENGTH: 20'

STRUCTURAL NOTES:

- ALL FRAMING LUMBER TO BE SPF 12 OR 12 SYP (UNO). ALL TREATED LUMBER TO BE SYP 2 (UNO). ALL LOAD BEARING HEADERS TO BE (2) 2 x 6
- INSTALL AN EXTRA JOIST UNDER WALLS PARALLEL
- TO FLOOR JOISTS WHERE NOTED ON THE PLANS.
 WINDOW AND DOOR HEADERS TO BE SUPPORTED w/ (1) JACK STUD AND (1) KING STUD EA, END (UNO. SEE TABLE R602.7.5 FOR ADDITIONAL KING STUD
- REQUIREMENTS.
 SQUARES DENOTE POINT LOADS WHICH REQUIRE SOLID BLOCKING TO GIRDER OR FOUNDATION. AL SQUARES TO BE (2) STUDS (UNO.)
- ALL 4 x 4 POSTS SHALL BE ANCHORED TO SLABS w/ SIMPSON ABU44 POST BASES (OR EQUAL) AND 6 x 6 POSTS w/ ABU66 POST BASES (OR EQUAL) INSTALLED WITH 100 LB CAPACITY UPLIFT CONNECTORS AT TOP (UNO.)
- FOR FIBERGLASS, ALUMINUM, OR COLUMN ENG. BY OTHERS, SECURE TO SLAB w/ (2) METAL ANGLES USING 2" CONC. SCREWS, FASTEN ANGLES TO COLUMNS W/ 1/4" THROUGH BOLTS W/ NUTS AND WASHERS. LOCATE ANGLES ON OPPOSITE SIDES OF COLUMN. THROUGH BOLTS MUST BE INSTALLED PRIOR TO SETTING COLUMN.
- REFER TO NOTES AND DETAIL SHEETS FOR ADDITIONAL STRUCTURAL INFORMATION.

ഗ THOMPS INEERING, S


RAWN BY: SOUTH DESIGN INEERED BY: JAG

S-2b SECOND FLOOR FRAMING PLAN

TABLE R602.7.5 MINIMUM NUMBER OF FULL HEIGHT KING STUDS AT EACH END OF HEADERS IN EXTERIOR WALLS

HEADER SPAN (FEET)	MINIMUM NUMBER OF FULL HEIGHT STUDS (KINGS)
UP TO 31	1
> 3' TO 6'	2
> 6' TO 9'	3
> 9' TO 12'	4
> 12' TO 15'	5

BCI 50005-18 JOISTS MAY BE USED IN SPACING INDICATED ON THE PLANS

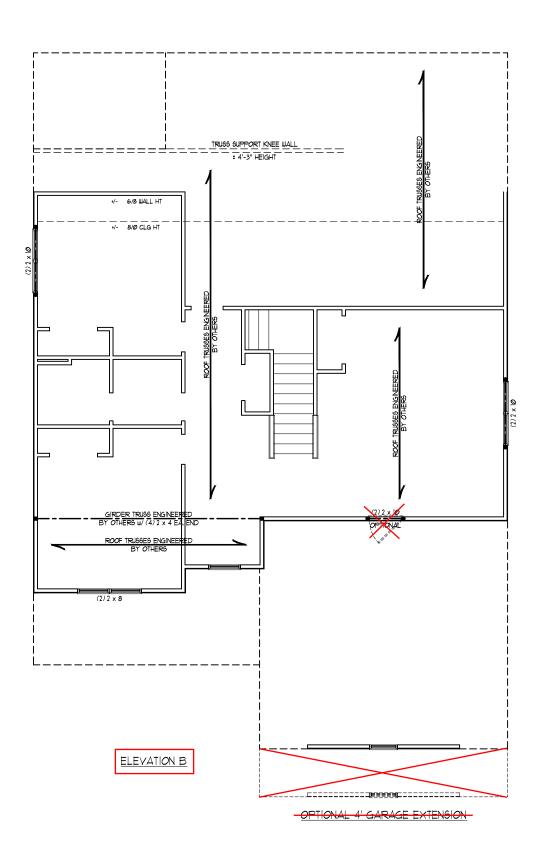

SCALE NOTE:

LARGE FORMAT PRINTS ARE TO SCALE AS NOTED. 11" x 17" PRINTS ARE ONE HALF THE NOTED SCALE



1/4/2023

BRACED WALL DESIGN NOTES:

- BRACED WALL DESIGN PER SECTION R602.10 OF THE NCRC 2018 EDITION.
- CONTRACTOR OF THE CONTINUOUS SHEATHING WOOD STRUCTURAL PANELS" CONTRACTOR 15 TO INSTALL TIME" OSB ON ALL EXTERIOR WALLS ATTACHED W/ 84 NAILS SPACED 6"
- ON ALL EXTERIOR WALLS AT TACHED W SO NAILS SPACED O OC. ALONG PANEL EDGES AND 12" OC. IN THE FIELD. 'GB REFERS TO "GYPSUM BOARD" CONTRACTOR IS TO INSTALL 1/2" (MIN.) GYPSUM WALL BOARD WHERE NOTED ON THE PLANS. FASTEN GB WITH I 1/4" SCREWS OR IS 75" NAILS SPACED T" OC. ALONG PANEL EDGES AND IN THE FIELD INCLUDING TOP AND
- BOTTOM PLATES.

 BRACED WALL DESIGN APPLIED IN WIND ZONES UP TO 130 MPH.

 FOR HIGH WIND ZONES, BRACE WALLS ARE TO BE CONSTRUCTED

 IN ACCORDANCE WITH CHAPTER 45 OF THE NCRC 2016 EDITION.

 SEE NOTES AND DETAIL SHEETS FOR ADDITIONAL BRACED
- WALL INFORMATION.

- PER SECTION R602.1032 OF THE 2018 NCRC, THE AMOUNT OF BRACING ON THE SECOND FLOOR EXCEEDS THE AMOUNT REQUIRED FOR THE FIRST FLOOR AND NO BRACED WALL
- ANALYSIS IS REQUIRED.
 SHEATH ALL EXTERIOR WALLS WITH 1/16" OSB SHEATHING
 ATTACHED WITH 80 NAILS AT 6" O.C. ALONG PANEL EDGES AND

STRUCTURAL NOTES:

- ALL FRAMING LUMBER TO BE 12 SPF OR 12 SYP (UNO).

 ALL LOAD BEARING HEADERS TO BE
- (2) 2 x 6 (UNO).

 3. WINDOW AND DOOR HEADERS TO BE SUPPORTED w/ (1) JACK STUD AND (1) KING STUD EA, END (UNO.), SEE TABLE R602.75 FOR ADDITIONAL KING STUD REQUIREMENTS.
- . SQUARES DENOTE POINT LOADS WHICH REQUIRE SOLID BLOCKING TO GIRDER OR FOUNDATION. SQUARES TO BE (2) STUDS (UNO.)
- REFER TO NOTES AND DETAIL SHEETS FOR ADDITIONAL STRUCTURAL INFORMATION.


TABLE R602.75 MINIMUM NUMBER OF FULL HEIGHT KING STUDS AT EACH END OF HEADERS IN EXTERIOR WALLS

HEADER SPAN (FEET)	MINIMUM NUMBER OF FUI HEIGHT STUDS (KINGS
UP TO 3'	1
> 3' TO 6'	2
> 6' TO 9'	3
> 9' TO 12'	4
> 12' TO 15'	5

THOMPSON
SINEERING, INC


DRAWN BY: SOUTH DESIG


Wellers Knoll Lot 83

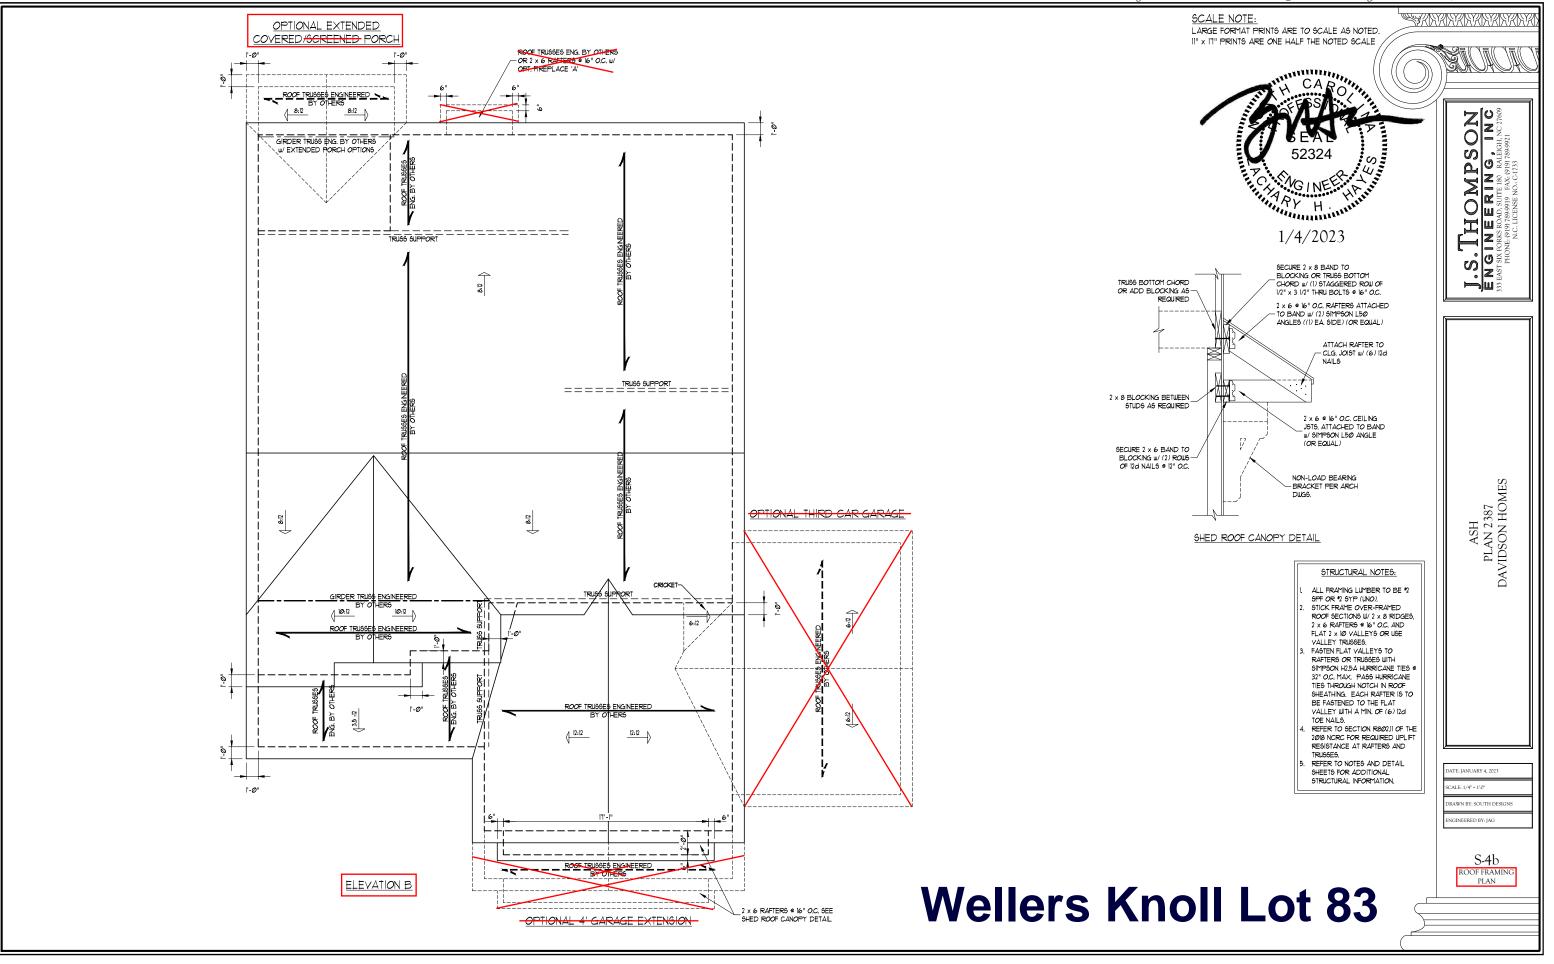



GENERAL WALL BRACING NOTES:


- WALL BRACING DESIGNED IN ACCORDANCE WITH CHAPTER 6 OF THE 2018 NC RESIDENTIAL BUILDING CODE (NCRC). TABLES AND FIGURES REFERENCED ARE FROM THE 2018 NCRC. SEE THIS SHEET FOR GENERAL DETAILS. REFER TO THE 2018 NCRC FOR ADDITIONAL INFORMATION AS NEEDED.
- BRACED EXTERIOR WALLS SUPPORTING ROOF TRUSSES AND RAFTERS, INCLUDING STORIES BELOW THE TOP FLOOR, HAVE
- BEEN DESIGNED PER R602.3.5 (3), WALL SHEATHING AND FASTENERS HAVE BEEN DESIGNED TO RESIST COMBINED UPLIFT AND SHEAR FORCES IN ACCORDANCE WITH ACCEPTED ENGINEERED PRACTICE. 4. SEE STRUCTURAL SHEETS FOR BRACED WALL LOCATIONS DIMENSIONS HOLD DOWN TYPE AND LOCATIONS BRACED WALL
- LINE KEY WITH WALL DESIGN SUMMARY OF REQUIRED/PROVIDED TOTALS FOR EACH WALL LINE AND ANY SPECIAL NOTES OR REQUIREMENTS.
- ALL EXTERIOR WALLS ARE TO BE SHEATHED WITH CS-WSP IN ACCORDANCE WITH SECTION R602.10.3 UNLESS NOTED OTHERWISE.
- 6. ALL EXTERIOR AND INTERIOR WALLS TO HAVE 1/2" GYPSUM INSTALLED, WHEN NOT USING METHOD "GB", GYPSUM TO BE FASTENED PER TABLE R1023.5. METHOD GB TO BE FASTENED PER TABLE R602.10.1
- CS-USP REFERS TO THE "CONTINUOUS SHEATHING WOOD STRUCTURAL PANELS" WALL BRACING METHOD. 1/16" OSB SHEATHING IS TO BE INSTALLED ON ALL EXTERIOR WALLS ATTACHED W/ 6d COMMON NAILS OR 8d (2 1/2" LONG X Ø/13" DIAMETER) NAILS SPACED 6" OC. ALONG PANEL EDGES AND 12" OC. IN THE FIELD (UNO.).
- GB REFERS TO THE "GYPSUM BOARD" WALL BRACING METHOD. 1/2" (MIN.) GYPSUM WALL BOARD IS TO BE INSTALLED ON BOTH SIDES OF THE BRACED WALL FASTENED WITH 1/4" SCREWS OR 15/8" NAILS SPACED TO OC. ALONG PANEL EDGES INCLUDING TOP AND BOTTOM PLATES AND INTERMEDIATE SUPPORTS (UN.O.). YERRY ALL FASTENER OPTIONS FOR 1/2" AND 5/8' GYPSUM PRIOR TO CONSTRUCTION. FOR INTERIOR FASTENER OPTIONS SEE TABLE RT02.35. FOR EXTERIOR FASTENER OPTIONS SEE TABLE R602.3(I). EXTERIOR GB TO BE INSTALLED VERTICALLY.
- REQUIRED BRACED WALL LENGTH FOR EACH SIDE OF THE CIRCUMSCRIBED RECTANGLE ARE INTERPOLATED PER TABLE R&OZ. 03, METHOD CS-MSP CONTRIBUTES ITS ACTUAL LENGTH, METHOD GB CONTRIBUTES 5 ITS ACTUAL LENGTH, AND METHOD PF CONTRIBUTES IS ITMES ITS ACTUAL LENGTH.

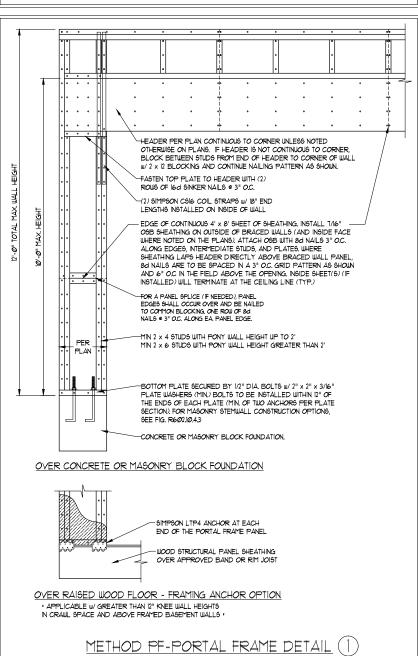


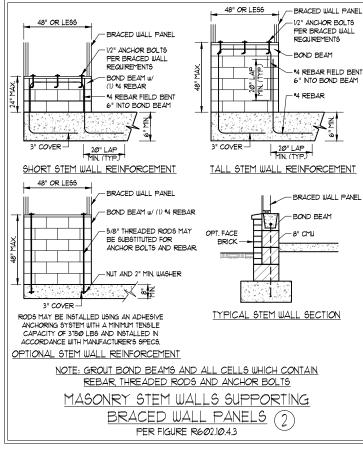

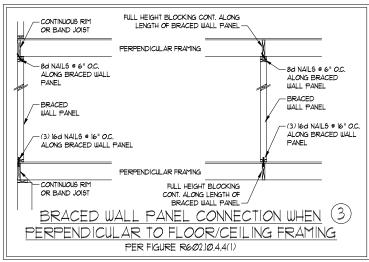


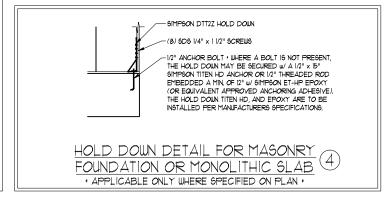


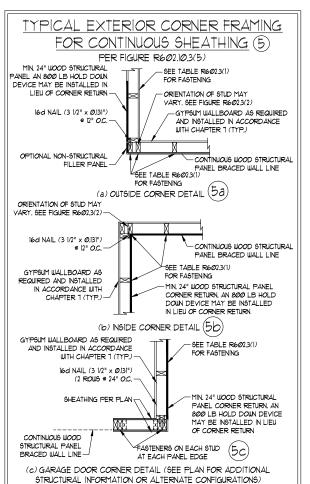


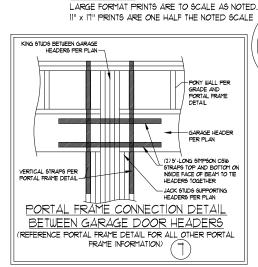

SCALE NOTE:

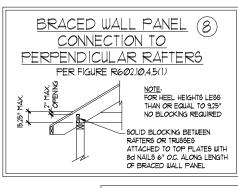

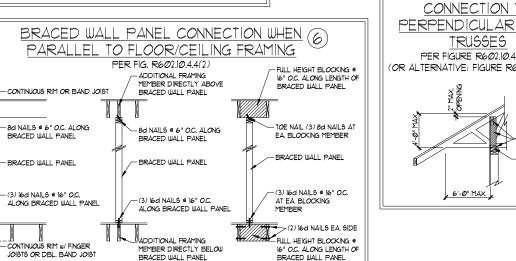

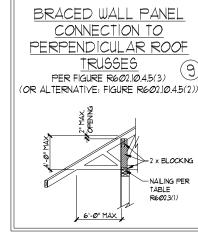

ATE: JANUARY 4, 2023 RAWN BY: SOUTH DESIGN INEERED BY: IAG

Н

1/4/2023

WALL BRACING NOTES AND DETAILS

Wellers Knoll Lot 83 '

This sealed page is to be used in conjunction with a full plan set engineered by J.S. Thompson Engineering, Inc. only. Use of this individual sealed page within architectural pages or shop drawings by others is a punishable offense under N.C. Statute § 89C-23



ASH PLAN 23 DAVIDSON F

D-3

GENERAL NOTES

- ENGINEER'S SEAL APPLIES ONLY TO STRUCTURAL COMPONENTS INCLUDING ROOF RAFTERS, HIPS, VALLEYS, RIDGES, FLOORS, WALLS, BEAMS, HEADERS, COLUMNS, CANTILEVERS, OFFSET LOAD BEARING WALLS, PIERS, GIRDER SYSTEM AND FOOTING. ENGINEER'S SEAL DOES NOT CERTIFY DIMENSIONAL ACCURACY OF ARCHITECTURAL LAYOUT INCLUDING ROOF. ENGINEER'S SEAL DOES NOT APPLY TO 1-JOIST OR FLOOR/ROOF TRUSS LAYOUT DESIGN AND ACCURACY.
- 2. ALL CONSTRUCTION SHALL CONFORM TO THE LATEST REQUIREMENTS OF THE NORTH CAROLINA RESIDENTIAL CODE (NCRC), 2018 EDITION, PLUS ALL LOCAL CODES AND REGULATIONS. THE STRUCTURAL ENGINEER IS NOT RESPONSIBLE FOR, AND WILL NOT HAVE CONTROL OF, CONSTRUCTION MEANS METHODS TECHNIQUES SEQUENCES OR PROCEDURES OR SAFETY PRECAUTIONS AND PROGRAMS IN CONNECTION WITH THE CONSTRUCTION WORK. NOR WILL THE ENGINEER BE RESPONSIBLE FOR THE CONTRACTORS FAILURE TO CARRY OUT THE CONSTRUCTION WORK IN ACCORDANCE WITH THE CONTRACT DOCUMENTS.
- 3. STRUCTURAL DESIGN BASED ON THE PROVISIONS OF THE NCRC, 2018 EDITION (R301.4 R301.7)

DESIGN CRITERIA;	LIVE LOAD (PSF)	DEAD LOAD (PSF)	DEFLECTION (IN)
ATTIC WITH LIMITED STORAGE	2Ø	10	L/240 (L/360 w/ BRITTLE FINISHES)
ATTIC WITHOUT STORAGE	10	10	L/3600
DECKS	40	10	L/360
EXTERIOR BALCONIES	40	10	L/360
FIRE ESCAPES	40	10	L/360
HANDRAILS/GUARDRAILS	200 LB OR 50 (PLF)	10	L/360
PASSENGER VEHICLE GARAGE	5Ø	10	L/360
ROOMS OTHER THAN SLEEPING ROOM	40	10	L/360
SLEEPING ROOMS	3Ø	10	L/360
STAIRS	40	10	L/360
WIND LOAD	(BASED ON TABLE R3Ø12)	4) WIND ZONE AND EXPOSURE.)
GROUND SNOW LOAD: Pa	2Ø (PSF)		

- I-JOIST SYSTEMS DESIGNED WITH 12 PSF DEAD LOAD AND DEFLECTION (IN) OF L/480
- FLOOR TRUSS SYSTEMS DESIGNED WITH 15 PSF DEAD LOAD
- FOR 115 AND 120 MPH WIND ZONES, FOUNDATION ANCHORAGE 15 TO COMPLY WITH SECTION R403,1.6 OF THE NCRC, 2018 EDITION, FOR 130 MPH, 140 MPH, AND 150 MPH WIND ZONES, FOUNDATION ANCHORAGE 15 TO COMPLY WITH SECTION 4504 OF THE NCRC, 2018 EDITION.
- 5. ENERGY EFFICIENCY COMPLIANCE AND INSULATION VALUES OF THE BUILDING TO BE IN ACCORDANCE WITH CHAPTER II OF THE NCRC, 2018 EDITION.

FOOTING AND FOUNDATION NOTES

- 1. FOUNDATION DESIGN BASED ON A MINIMUM ALLOWABLE BEARING CAPACITY OF 2000 PSF. CONTACT GEOTECHNICAL ENGINEER IF BEARING CAPACITY IS NOT ACHIEVED.
- 2. FOR ALL CONCRETE SLABS AND FOOTINGS, THE AREA WITHIN THE PERIMETER OF THE BUILDING ENVELOPE SHALL HAVE ALL VEGETATION, TOP SOIL AND FOREIGN MATERIAL REMOVED. FILL MATERIAL SHALL BE FREE OF VEGETATION AND FOREIGN MATERIAL. THE FILL SHALL BE COMPACTED TO ASSURE UNIFORM SUPPORT OF THE SLAB, AND EXCEPT WHERE APPROVED, THE FILL DEPTHS SHALL NOT EXCEED 24" FOR CLEAN SAND OR GRAVEL. A 4" THICK BASED COURSE CONSISTING OF CLEAN GRADED SAND OR GRAVEL SHALL BE PLACED. A BASE COURSE IS NOT REQUIRED WHERE A CONCRETE SLAB IS INSTALLED ON WELL-DRAINED OR SAND-GRAVEL MIXTURE SOILS CLASSIFIED AS GROUP I, ACCORDING TO THE UNITED SOIL CLASSIFICATION SYSTEM IN ACCORDANCE WITH TABLE R405,1 OF THE NCRC, 2018 EDITION,
- 3. PROPERLY DEWATER EXCAVATION PRIOR TO POURING CONCRETE WHEN BOTTOM OF CONCRETE \$LAB IS AT OR BELOW WATER TABLE. APPLICABLE, 3/4" - 1" DEEP CONTROL JOINTS ARE TO BE SAWED WITHIN 4 TO 12 HOURS OF CONCRETE FINISHING AND WALL LOCATIONS HAVE BEEN MARKED. ADJUST WHERE NECESSARY.
- 4. CONCRETE SHALL CONFORM TO SECTION R4022 OF THE NCRC, 2018 EDITION. CONCRETE REINFORCING STEEL TO BE ASTM A615 GRADE 60. WELDED WIRE FABRIC TO BE ASTM A185. MAINTAIN A MINIMUM CONCRETE COVER AROUND REINFORCING STEEL OF 3" IN FOOTINGS AND 1 1/2" IN SLABS. FOR POURED CONCRETE WALLS, CONCRETE COVER FOR REINFORCING STEEL MEASURED FROM THE INSIDE FACE OF THE WALL SHALL NOT BE LESS THAN 3/4". CONCRETE COVER FOR REINFORCING STEEL MEASURED FROM THE OUTSIDE FACE OF THE WALL. SHALL NOT BE LESS THAN 1 1/2" FOR *5 BARS OR SMALLER, AND NOT LESS THAN 2" FOR *6 BARS OR LARGER.
- 5. MASONRY UNITS TO CONFORM TO ACE 530/ASCE 5/TMS 402. MORTAR SHALL CONFORM TO ASTM C270.
- 6. THE UNSUPPORTED HEIGHT OF MASONRY PIERS SHALL NOT EXCEED FOUR TIMES THEIR LEAST DIMENSION FOR UNFILLED HOLLOW CONCRETE MASONRY UNITS AND TEN TIMES THEIR LEAST DIMENSION FOR SOLID OR SOLID FILLED PIERS. PERS MAY BE FILLED SOLID WITH CONCRETE OR TYPE M OR 5 MORTAR PIERS AND WALLS SHALL BE CAPPED WITH 8" OF SOLID MASONRY.
- 1. THE CENTER OF EACH OF THE PIERS SHALL BEAR IN THE MIDDLE THIRD OF ITS RESPECTIVE FOOTING. EACH GIRDER SHALL BEAR IN THE
- 8. ALL CONCRETE AND MASONRY FOUNDATION WALLS ARE TO BE CONSTRUCTED IN ACCORDANCE WITH THE PROVISIONS OF SECTION R404 OF THE NCRC, 2018 EDITION OR IN ACCORDANCE WITH ACI 318, ACI 332, NCMA TR68-A OR ACE 530/ASCE 5/TM5 402. MASONRY FOUNDATION WALLS ARE TO BE REINFORCED PER TABLE R404.1.(1), R404.1.(2), R404.1.(3), OR R404.1.(4) OF THE NCRC, 2018 EDITION. CONCRETE FOUNDATION WALLS ARE TO BE REINFORCED PER TABLE R404.1.(5) OF THE NCRC, 2018 EDITION. STEP CONCRETE FOUNDATION WALLS TO 2 x 6 FRAMED WALLS AT 16" OC WHERE GRADE PERMITS (UNO)

Wellers Knoll Lot 83

FRAMING NOTES

- ALL FRAMING LUMBER SHALL BE 12 SPF (Fb = 815 PSI, Fv = 315 PSI, E = 16000000 PSI) OR 12 SYP (Fb = 915 PSI, Fv = 115 PSI, E = 16000000 PSI) MINIMUM UNLESS NOTED OTHERWISE (UNO). ALL TREATED LUMBER SHALL BE 12 SYP MINIMUM UNLESS NOTED OTHERWISE (UNO).
- 2. LAMINATED VENEER LUMBER (LYL) SHALL HAVE THE FOLLOWING MINIMUM PROPERTIES: Fb =2600 PSI, Fv = 285 PSI, E = 1900000 PSI. LAMINATED STRAND LUMBER (LSL) SHALL HAVE THE FOLLOWING MINIMUM PROPERTIES: Fb = 2325 PSI, Fv = 310 PSI, E = 1550000 PSI. PARALLEL STRAND LUMBER (PSL) UP TO 1" DEPTH SHALL HAVE THE FOLLOWING MINIMUM PROPERTIES: Fc = 2500 PSI, E = 1800000 PSI. PARALLEL STRAND LUMBER (PSL) MORE THAN T" DEPTH SHALL HAVE THE FOLLOWING MINIMUM PROPERTIES: Fc = 2900 PSI, E = 20000000 PSI INSTALL ALL CONNECTIONS PER MANUFACTURER'S SPECIFICATIONS
- 3. STRUCTURAL STEEL SHALL CONFORM TO THE FOLLOWING ASTM SPECIFICATIONS

W AND WT SHAPES: CHANNELS AND ANGLES: ASTM A36 PLATES AND BARS ASTM A36

HOLLOW STRUCTURAL SECTIONS: ASTM A500 GRADE B

ASTM A53, GRADE B, TYPE E OR S

4. STEEL BEAMS SHALL BE SUPPORTED AT EACH END WITH A MINIMUM BEARING LENGTH OF 3 1/2" AND FULL FLANGE WIDTH (UNO). PROVIDE SOLID BEARING FROM BEAM SUPPORT TO FOUNDATION. BEAMS SHALL BE ATTACHED AT THE BOTTOM FLANGE TO EACH SUPPORT AS FOLLOWS (UNO):

A. WOOD FRAMING (2) 1/2" DIA. x 4" LONG LAG SCREWS B. CONCRETE (2) 1/2" DIA, x 4" WEDGE ANCHORS C. MASONRY (FULLY GROUTED) (2) 1/2" DIA. x 4" LONG SIMPSON TITEN HD ANCHORS

LATERAL SUPPORT IS CONSIDERED ADEQUATE PROVIDING THE JOISTS ARE TOE NAILED TO THE 2x NAILER ON TOP OF THE STEEL BEAM, AND THE 2X NAILER IS SECURED TO THE TOP OF THE STEEL BEAM w/ (2) ROWS OF SELF TAPPING SCREWS @ 16" O.C. OR (2) ROWS OF 1/2" DIAMETER BOLTS @ 16" O.C. IF 1/2" BOLTS ARE USED TO FASTEN THE NAILER, THE STEEL BEAM SHALL BE FABRICATED W/ (2) ROWS OF 9/16" DIAMETER HOLES @ 16" O.C.

- SQUARES DENOTE POINT LOADS WHICH REQUIRE SOLID BLOCKING TO GIRDER OR FOUNDATION, SHADED SQUARES DENOTE POINT LOADS FROM ABOVE WHICH REQUIRE SOLID BLOCKING TO SUPPORTING MEMBER BELOW.
- 6. ALL LOAD BEARING HEADERS TO CONFORM TO TABLE R602.7(1) AND R602.7(2) OF THE NCRC, 2018 EDITION OR BE (2) 2 x 6 WITH (1) JACK AND (1) KING STUD EACH END (UNO), WHICHEVER IS GREATER ALL HEADERS TO BE SECURED TO EACH JACK STUD WITH (4) 8d NAILS. ALL BEAMS TO BE SUPPORTED WITH (2) STUDS AT EACH BEARING POINT (UNO). INSTALL KING STUDS PER SECTION R602.7.5 OF THE NORTH CAROLINA RESIDENTIAL CODE, 2018 EDITION.
- 1. ALL BEAMS, HEADERS, OR GIRDER TRUSSES PARALLEL TO WALL ARE TO BEAR FULLY ON (1) JACK OR (2) STUDS MINIMUM OR THE NUMBER OF JACKS OR STUDS NOTED. ALL BEAMS OR GIRDER TRUSSES PERPENDICULAR TO WALL AND SUPPORTED BY (3) STUDS OR LESS ARE TO HAVE I 1/2" MINIMUM BEARING (UNO). ALL BEAMS OR GIRDER TRUSSES PERPENDICULAR TO WALL AND SUPPORTED BY MORE THAN (3) STUDS OR OTHER NOTED COLUMN ARE TO BEAR FULLY ON SUPPORT COLUMN FOR ENTIRE WALL DEPTH (UNO). BEAM ENDS THAT BUTT INTO ONE ANOTHER ARE TO EACH BEAR EQUAL LENGTHS (UNO).
- 8. FLITCH BEAMS SHALL BE BOLTED TOGETHER USING 1/2" DIAMETER BOLTS (ASTM A301) WITH WASHERS PLACED AT THREADED END OF BOLT. BOLTS SHALL BE SPACED AT 24" CENTERS (MAXIMUM), AND STAGGERED AT TOP AND BOTTOM OF BEAM (2" EDGE DISTANCE), WITH (2) BOLTS LOCATED AT 6" FROM EACH END (UNO).
- 9. ALL 1-JOIST OR TRUGS LAYOUTS ARE TO BE IN COMPLIANCE WITH THE OVERALL DESIGN SPECIFIED ON THE PLANS. ALL DEVIATIONS ARE TO BE BROUGHT TO THE ATTENTION OF THE ENGINEER OF RECORD PRIOR TO INSTALLATION.
- 10. BRACED WALL PANELS SHALL BE CONSTRUCTED ACCORDING TO THE NORTH CAROLINA RESIDENTIAL CODE 2018 EDITION WALL BRACING CRITERIA, THE AMOUNT, LENGTH, AND LOCATION OF BRACING SHALL COMPLY WITH ALL APPLICABLE TABLES IN SECTION R602.10.
- PROVIDE DOUBLE JOIST UNDER ALL WALLS PARALLEL TO FLOOR JOISTS. PROVIDE SUPPORT UNDER ALL WALLS PARALLEL TO FLOOR TRUSSES OR I-JOISTS PER MANUFACTURER'S SPECIFICATIONS. INSTALL BLOCKING BETWEEN JOISTS OR TRUSSES FOR POINT LOAD SUPPORT FOR ALL POINT LOADS ALONG OFFSET LOAD LINES.
- 12. FOR ALL HEADERS SUPPORTING BRICK VENEER THAT ARE LESS THAN 8'-Ø" IN LENGTH, REST A 6" x 4" x 5/16" STEEL ANGLE WITH 6" MINIMUM EMBEDMENT AT SIDES FOR BRICK SUPPORT (UN.O). FOR ALL HEADERS 8'-Ø" AND GREATER IN LENGTH, BOLT A 6" x 4" x 5/16" STEEL ANGLE TO HEADER WITH 1/2" LAG SCREWS AT 12" O.C. STAGGERED FOR BRICK SUPPORT. FOR ALL BRICK SUPPORT AT ROOF LINES, BOLT A 6" x 4" x 5/16" STEEL ANGLE TO (2) 2 x $|\emptyset|$ BLOCKING INSTALLED w/ (4) |2d| NAILS EA, PLY BETWEEN WALL STUDS WITH (2) ROWS OF |2d|" LAG SCREWS AT 12" O.C. STAGGERED AND IN ACCORDANCE WITH SECTION RT03.8.2.1 OF THE NCRC, 2018 EDITION.
- 13. FOR STICK FRAMED ROOFS: CIRCLES DENOTE (3) 2 x 4 POSTS FOR ROOF MEMBER SUPPORT. HIP SPLICES ARE TO BE SPACED A MINIMUM OF 8'-0". FASTEN MEMBERG WITH THREE ROWS OF 12d NAILS AT 16" O.C. FRAME DORMER WALLS ON TOP OF DOUBLE OR TRIPLE RAFTERS AS
- 14. FOR TRUSSED ROOFS: FRAME DORMER WALLS ON TOP OF 2 x 4 LADDER FRAMING AT 24" O.C. BETWEEN ADJACENT ROOF TRUSSES. STICK FRAME OVER-FRAMED ROOF SECTIONS WITH 2 x 8 RIDGES, 2 x 6 RAFTERS AT 16" O.C. AND FLAT 2 x 10 VALLEYS (UNO).
- 15. ALL 4 x 4 AND 6 x 6 POSTS TO BE INSTALLED WITH 100 LB CAPACITY UPLIFT CONNECTORS TOP AND BOTTOM (UNO.) POSTS MAY BE SECURED USING ONE SIMPSON H6 OR LTSI2 UPLIFT CONNECTOR FASTENED TO THE BAND AT THE BOTTOM AND THE BEAM AT THE TOP OF EACH POST. ONE 16" SECTION OF SIMPSON CS16 COIL STRAPPING WITH (8) 8d HDG NAILS AT EACH END MAY BE USED IN LIEU OF EACH TWIST STRAP IF DESIRED. FOR MASONRY OR CONCRETE FOUNDATION USE SIMPSON POST BASE.

SCALE NOTE: LARGE FORMAT PRINTS ARE TO SCALE AS NOTED. 11" x IT" PRINTS ARE ONE HALF THE NOTED SCALE

1/4/2023

This sealed page is to be used in

conjunction with a full plan set

engineered by J.S. Thompson

Engineering, Inc. only. Use of this

individual sealed page within

irchitectural pages or shop drawing

by others is a punishable offense

under N.C. Statute § 89C-23

OM RENIEN


0 A

ശ

S

D-4 STANDARE STRUCTURAL NOTES

RAWN BY: SOUTH DESIGN INEERED BY: IAG

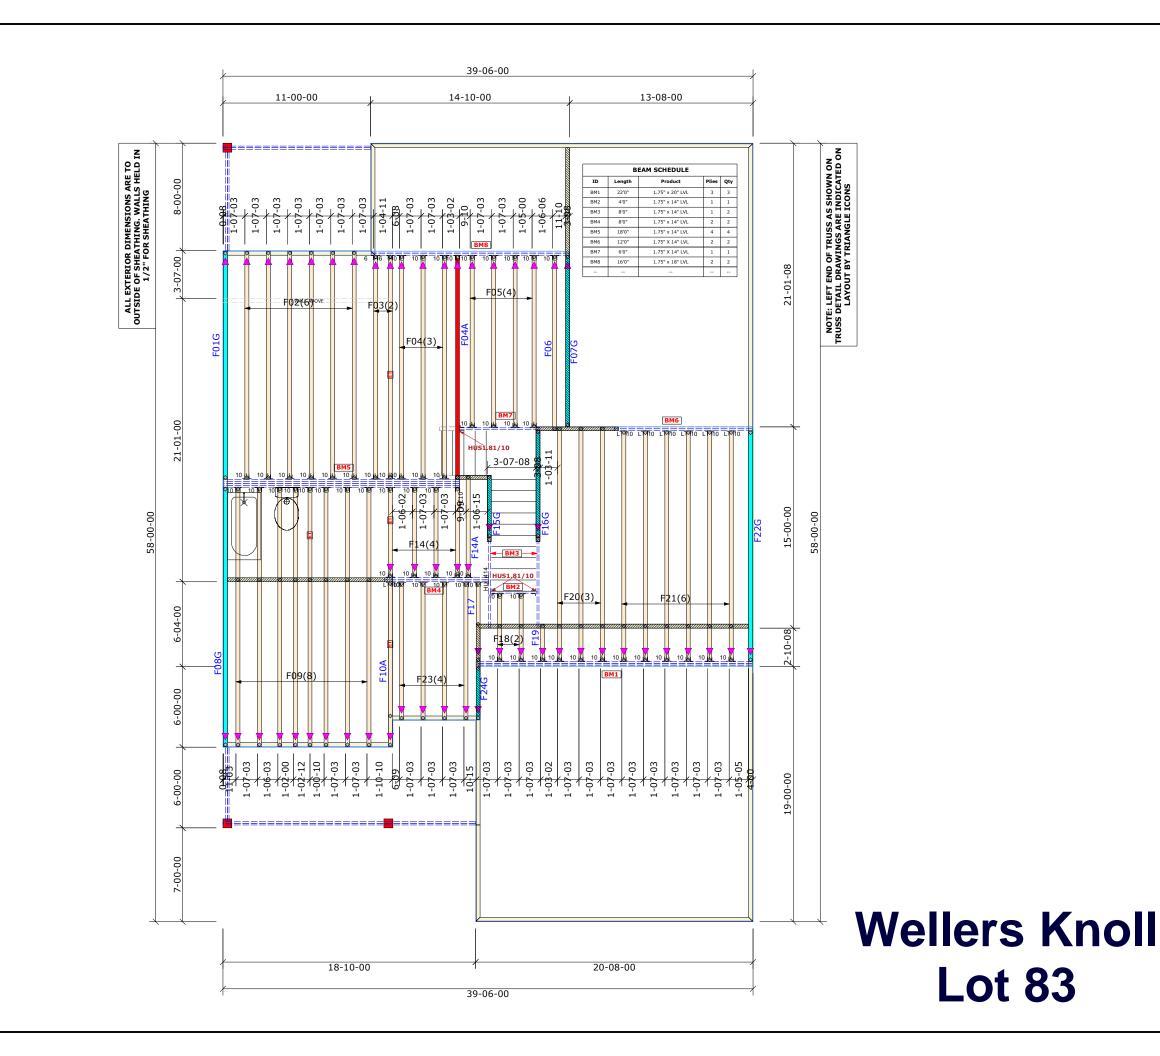



Builders First Source 23 Red Cedar Way Apex, NC 27523 Phone: (919) 363-4956 Fax: (919) 387-8565 https://www.bldr.com

General Notes:

- Per ANSI/TPI 1-2002 all " Truss to Wall" connections are the responsibility of the Building Designer, not the Truss Manufacturer.

- Dimensions are Feet-Inches- Sixteenths
- Trusses are to be 24" o.c. unless noted otherwise
- Trusses are not designed to support brick U.N.O. - Do not cut or modify trusses without first contacting Builders FirstSource.
- Immediately contact Builders FirstSource if

trusses are damaged.

- <u>Connection Notes:</u>
 All hangers are to be Simpson or equivalent U.N.O. - Use Manufacturer's specifications for all hanger
- connections U.N.O.

 Use 10d x 1 1/2" Nails in hanger connections to single ply roof girder trusses.


Floor notes:
- Shift truss as required to avoid plumbing traps. - Installation Contractor and/or Field Supervisor are to verify all dimensions, trap locations, and options prior to

Dimension Notes:

HANGER LIST

- Drawing not to scale. Do not scale dimensions


 $\triangle \triangleleft \nabla \triangleright$ LEFT END OF TRUSS AS SHOWN ON TRUSS DETAIL DRAWINGS ARE INDICATED BY TRIANGLE ICONS.

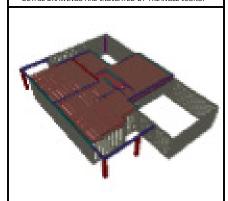

ALL TIE DOWNS H2.5A UNLESS NOT SPECIAL ITEMS LIST

-	по4		[H					
3	HUS1.		H) [10					
1	HUC	410						
				MISC MATERIAL				
Davidson Homes								
Ash				ELEV:		В		
Wellers Knoll/173 Old Fashioned Way								
Harnett NC				LOT:		83		
				<u> APPWRIGHT #</u>				
				4678077				
		•		CODE.	: [IRC 2015		
•				WIND:				
				M.P.H.		115 MPH		
DESIGNED BY: CFC				HATCH LEGEND				
LAY	OUT:	AB-F	-R	+ + + +	+ †	ATTIC ROOM		
L/O DATE: 6/3/2025			1	VOLUME CEILING				
					\overline{Z}	STICK FRAMING		
_			. —		_			

Summation of limited excerpts of the Code, ANSI/TPI 1-2014, and BCSI, and associated commentary, are provi ed within the truss submittal package in the Builders First-Source Component Truss Responsibility and Liability Dis-closure. These critical excerpts include, among other elements, critical safety information as well as specific Scope of-Work assignments (and limitations of the same) for the Owner, Contractor, Building Designer, Truss Designer, and Truss Manufacturer.It is essential that ALL parties to the design and use of the trusses review and become familian with the information provided in the Builders FirstSource component Truss Responsibility and Liability Disclosure, well as the referenced sources, prior to performing work of the associated project.

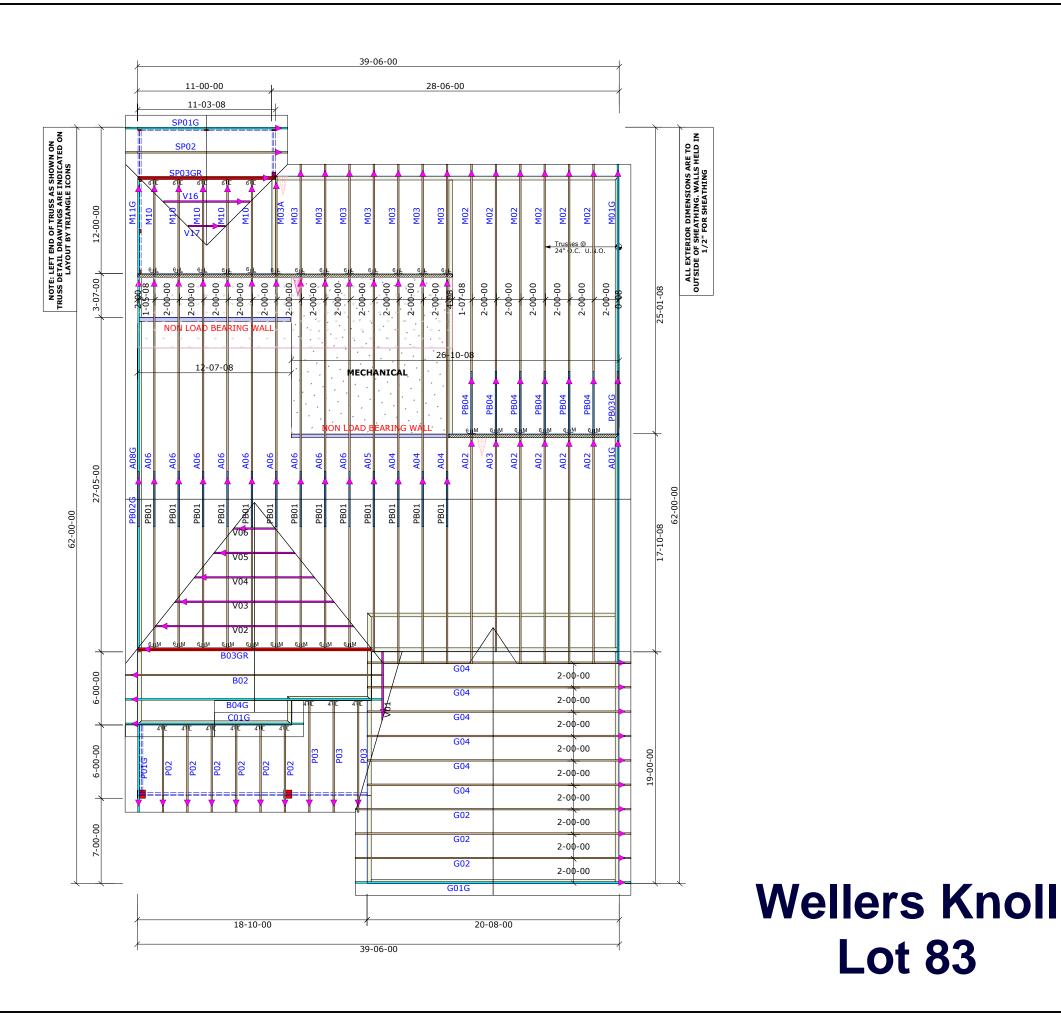

Builders First Source 23 Red Cedar Way Apex, NC 27523 Phone: (919) 363-4956 Fax: (919) 387-8565 https://www.bldr.com

General Notes:

- Per ANSI/TPI 1-2002 all " Truss to Wall" connections are the responsibility of the Building Designer, not the Truss Manufacturer.

- Dimensions are Feet-Inches- Sixteenths Trusses are to be 24" o.c. unless noted otherwise
- Trusses are not designed to support brick U.N.O. - Do not cut or modify trusses without first contacting Builders FirstSource.
- Immediately contact Builders FirstSource if

trusses are damaged.

- <u>Connection Notes:</u>
 All hangers are to be Simpson or equivalent U.N.O. - Use Manufacturer's specifications for all hanger
- connections U.N.O.

 Use 10d x 1 1/2" Nails in hanger connections to single ply roof girder trusses.

Floor notes:
- Shift truss as required to avoid plumbing traps. - Installation Contractor and/or Field Supervisor are to verify all dimensions, trap locations, and options prior to

Dimension Notes:

- Drawing not to scale. Do not scale dimensions

 \triangle \triangleleft ∇ \triangleright LEFT END OF TRUSS AS SHOWN ON TRUSS DETAIL DRAWINGS ARE INDICATED BY TRIANGLE ICONS.



	HANGEN			ALL TIE D	OWNED THE ISSUED THE TER	
9	LUS24	اكا	4	SPEC:	IAL ITEMS LIST	
18	LUS26	Lji	6			
15	HTU26	М	6			
				<u>MISC</u> <u>MATERIAL</u>		
		Davi	ds	on Home	es	
	Ash			ELEV:	В	
	Weller	s Knoll/	17	73 Old Fa	ashion Way	
	Harnett	NO	2	LOT:	83	
				<u> APPWRIGHT #</u>		
• E>	t. Covere		n	4678002		
	Porcl	1		CODE:	IRC 2015	
				<u>WIND:</u>		
	•			M.P.H.	120 MPH	
DESTGNED BY: CFC				HAT	CH LEGEND	

HANGER LIST ALL TIE DOWNS H2.5A UNLESS NOTED

Summation of limited excerpts of the Code, ANSI/TPI 1-2014, and BCSI, and associated commentary, are provided within the truss submittal package in the Builders First-Source Component Truss Responsibility and Liability Disclosure. These critical excerpts include, among other elements critical exterpts include, among other elements critical exterpts included and provided and the component of the component critical exterpts information as well as provided services. ments, critical safety information as well as specific Scope of-Work assignments (and limitations of the same) for the Owner, Contractor, Building Designer, Truss Designer, and Truss Manufacturer.lt is essential that ALL parties to the design and use of the trusses review and become familian with the information provided in the Builders FirstSource Component Truss Responsibility and Liability Disclosure, a well as the referenced sources, prior to performing work or the associated project.

L/O DATE: 6/3/2025

Lot 83

ATTIC ROOM