

The Garner Craftsman

Signature Series

Lot: 42 | Duncans Creek
757 Beacon Hill Road
Lillington, NC 27546



New Home Inc
1611 Jones Franklin,
Raleigh, NC, 27606

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Name	Number	OPTION SET	SELECTION	BUILDING CODES		
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		Pocket Office Door	Pocket Door			
		Secondary Walk-In Closet	Secondary WIC			
		Hall Bath Shower	Shower at Hall Bath			
		~Series	Signature			
		Smart Door Delivery Center	Smart Door Delivery Center			
		Family Room Fireplace Windows	Windows			
				TOTAL UNCONDITIONED AREA		778 SF
				Garage Area		406 SF
		Covered Patio Area		230 SF		
		Front Porch Area		142 SF		
		TOTAL AREA				
		TYPE		TOTAL AREA		
		TOTAL CONDITIONED AREA		3041 SF		
		TOTAL UNCONDITIONED AREA		778 SF		
		TOTAL UNDER ROOF		3,041 SF		

REV #

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DESCRIPTION

The Garner Craftsman at Cattail Preserve

Cover Sheet

DRAWN BY:

Drew DiMeo

HANDING:

LEFT

ISSUE DATE:

11/11/1111

SHEET

G-100

DATE							
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DESCRIPTION							
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REV.#	8						

The Garner Craftsman at Cattail Preserve

Cover Sheet

DRAWN BY:
Drew DiMeo

HANDING:
LEFT

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SHEET


G-100

<div>GENERAL NOTES AND SPECIFICATIONS:</div> <div>1 GENERAL DATA</div> <div>PROJECT DESCRIPTION:</div> <div>THIS PROJECT IS FOR THE CONSTRUCTION OF A NEW SINGLE-FAMILY RESIDENCE, AND ASSOCIATED SITE WORK.</div> <div>TYPICAL NOTES: ALL WORK TO BE COORDINATED AND SCHEDULED BY THE OWNER.</div> <div>ALL WORK, INCLUDING PLUMBING, HVAC AND ELECTRICAL WORK NOT DETAILED HEREIN, SHALL COMPLY WITH APPLICABLE STATE AND LOCAL BUILDING CODES AND THE BUILDING STANDARDS REFERENCED THEREIN.</div> <div>ALL WORK SHALL CONFORM TO THE HIGHEST LEVELS OF THE APPROPRIATE INDUSTRY STANDARDS FOR CUSTOM WORK.</div> <div>ALL ITEMS SPECIFIED HEREIN ARE TO BE USED WITHOUT SUBSTITUTION. IF THESE NOTES CONFLICT WITH THE OWNERS SCOPE OF WORK DOCUMENTS, THE NOTES HEREIN SHALL GOVERN AND TAKE PRECEDENT.</div> <div>THE STRUCTURE IS DESIGNED TO BE SELF-SUPPORTING AND STABLE AFTER THE BUILDING IS FULLY COMPLETE. IT IS SOLELY THE CONTRACTORS RESPONSIBILITY TO ENSURE THE SAFETY OF THE BUILDING AND ITS COMPONENT PARTS DURING ERECTION. THIS INCLUDES THE ADDITION OF TEMPORARY BRACING THAT MAY BE REQUIRED.</div> <div>IT IS SOLELY THE CONTRACTOR'S RESPONSIBILITY TO FOLLOW ALL APPLICABLE SAFETY CODES AND REGULATIONS DURING ALL PHASES OF CONSTRUCTION.</div> <div>PLAN DIMENSIONS ARE TO FACE OF ROUGH FRAMING OR MASONRY UNLESS NOTED OTHERWISE. DIMENSIONS TO EXTERIOR WALLS INCLUDE 7/16" OSB WALL SHEATHING WITH WATER-RESISTIVE BARRIER, ROUNDED TO THE NEAREST 1/4".</div> <div>FINISH FLOOR ELEVATION @ FIRST FLOOR LEVEL IS SET AT 0'-0". SEE SITE PLAN FOR ACTUAL FIRST FLOOR ELEVATION @ EACH BUILDING.</div> <div>ALL @ INTERIOR PARTITIONS SHALL BE 2x4 STUDS @ 16" O.C. WITH 1/2" DRYWALL EACH SIDE. PLAN DIMENSION IS ASSUMED TO BE 3 1/2" UNLESS NOTED OTHERWISE. PROVIDE SOLID LUMBER BLOCKING FOR ALL WALL MOUNTED ITEMS.</div> <div>SUBSTRATE (BACKER) FOR TILE IN SHOWERS/TUBS SHALL BE FIBER-CEMENT OR SIMILAR PER APPLICABLE CODE.</div> <div>ALL INTERIOR COLORS AND FINISHES, NOT SPECIFIED HEREIN, TO BE SELECTED BY THE OWNER.</div> <div>2 SITE CONSTRUCTION CONTRACTOR OR EXCAVATOR MUST CONTACT THE APPROPRIATE UTILITIES PROTECTION SERVICE AT LEAST 48 HOURS BUT NO MORE THAN 10 WORKING DAYS BEFORE BEGINNING ANY DIGGING PROJECT.</div> <div>SOILS BEARING PRESSURE AS INDICATED ON THE STRUCTURAL ENGINEERING PLANS BY OTHER.</div> <div>3 CONCRETE REFER TO STRUCTURAL ENGINEERING PLANS BY OTHER.</div> <div>SEE OWNER SCOPE OF WORK DOCUMENTS FOR ADDITIONAL REQUIREMENTS.</div> <div>4 MASONRY STONE /ENEER IF USED) TO BE MANUFACTURED STONE - REFER TO OWNERS SCOPE OF WORK DOCUMENT FOR MATERIAL SELECTION AND COLORS.</div> <div>BRICK ACCENTS (IF USED) TO BE FULL SIZE UNITS, CUT TO THICKNESS OR SHAPE REQUIRED FOR THE SPECIFIC USE. REFER TO THE OWNERS SCOPE OF WORK DOCUMENT FOR MATERIAL SELECTION AND COLORS.</div> <div>5 METALS REFER TO STRUCTURAL ENGINEERING PLANS BY OTHER.</div> <div>6 WOOD & PLASTICS PROVIDE SOLID BLOCKING FOR ALL WALL MOUNTED ITEMS INCLUDING: • CABINETS & SHELVES CLOSET RODS • MIRRORS AND BATH ACCESSORIES</div> <div>FRAMING LUMBER IN CONTACT WITH CONCRETE OR MASONRY OR EXPOSED TO THE EXTERIOR SHALL BE PRESERVATIVE PRESSURE TREATED. ANY WOOD, INCLUDING EXTERIOR SHEATHING, WITHIN 6" OF FINISHED GRADE SHALL BE PRESERVATIVE-PRESSURE TREATED.</div> <div>ANY WOOD, INCLUDING EXTERIOR WALL SHEATHING, LESS THAN 2" VERTICALLY FROM CONCRETE STEPS, PORCH SLABS, PATIO SLABS AND SIMILAR HARD HORIZONTAL SURFACES SHALL BE PRESERVATIVE PRESSURE TREATED.</div> <div>PROTECTION OF WOOD AND WOOD-BASED PRODUCTS AGAINST DECAY AS REQUIRED BY R317. PROTECTION AGAINST TERMITES AS REQUIRED BY R318.</div> <div>FIRE BLOCKING TO COMPLY WITH R302.11.</div> <div>REFER TO STRUCTURAL ENGINEERING PLANS BY OTHER.</div>		<div>CABINETS AND COUNTERTOPS REFER TO OWNERS SCOPE OF WORK DOCUMENTS FOR CABINET, COUNTERTOP AND HARDWARE SELECTIONS.</div> <div>INTERIOR TRIM OF REFER TO OWNERS SCOPE OF WORK DOCUMENTS FOR REQUIRED INTERIOR TRIM PROFILES.</div> <div>7 THERMAL & MOISTURE PROTECTION WATER BARRIER THE WATER BARRIER SYSTEM IS AN INTEGRAL PART OF THE WALL SHEATHING SYSTEM.</div> <div>THERMAL INSULATION • INSULATION TO HAVE THE FOLLOWING MINIMUM R-VALUES: • EXTERIOR WALLS R=15 MIN. • SLOPED CEILINGS (WITH ATTIC SPACE) R=38 OR R=30 WHEREVER THE FULL HEIGHT OF UNCOMPRESSED R=38 INSULATION EXTENDS OVER THE WALL TOP PLATE AT THE EAVES. • SLOPED CEILINGS (WITHOUT ATTIC SPACE) R=38 MIN., OR R=30 MIN. WHERE THERE IS NOT SUFFICIENT SPACE FOR REQ'D INSULATION. • FLAT CEILINGS (WITH ATTIC SPACE) R=38 OR R=30 WHEREVER THE FULL HEIGHT OF UNCOMPRESSED R=38 INSULATION EXTENDS OVER THE WALL TOP PLATE AT THE EAVES. • FLOORS R=19 MIN. • REFER TO OWNERS SCOPE OF WORK DOCUMENTS FOR INSULATION TYPES AND ADDITIONAL REQUIREMENTS.</div> <div>ARCHITECTURAL SHINGLE ROOFING - SHINGLE ROOFING SHALL BE DIMENSIONAL ASPHALT TYPE WITH DIMENSION FEATURES. SEE OWNERS SCOPE OF WORK DOCUMENTS FOR MANUFACTURER, STYLE, COLOR AND ADDITIONAL REQUIREMENTS FOR INSTALLATION AND ACCESSORIES. • SHINGLES SHALL BE TESTED IN ACCORDANCE WITH AST D 7185. • SHINGLES SHALL MEET THE CLASSIFICATION REQUIREMENTS FOR THE APPROPRIATE MAXIMUM BASIC WIND SPEED: MAXIMUM BASIC WIND SPEED CLASSIFICATION REQUIREMENT • REFER TO STRUCTURAL ENGINEERING PLANS BY OTHER. • ROOFING SHALL BE INSTALLED OVER ONE LAYER OF ASPHALT IMPREGNATED 15# ROOFING FELT. 2 LAYERS FOR ROOF PITCHES 2:12 - 4:12.</div> <div>VALLEY LININGS TO BE INSTALLED PER R905.2.8.2</div> <div>GUTTERS TO BE MINIMUM 5" ALUMINUM OGEE STYLE WITH 4" CORRUGATED RECTANGULAR ALUMINUM DOWNSPOUTS AT LOCATIONS AS INDICATED ON THE DRAWINGS.</div> <div>DOWNSPOUTS TO BE CONNECTED TO UNDERGROUND STORM PIPING AND ROUTED TO DISCHARGE LOCATIONS AS SPECIFIED BY THE GENERAL CONTRACTOR. 12" WIDE (2" THICKNESS) RIGID FOAM LOCATED AT TOP OF FOOTER, SLOPING AWAY FROM THE UNIT TO PREVENT CONCRETE OVERFLOW AND ALLOW PIPE TO TIGHTLY FIT TO STEM WALL.</div> <div>UNDERGROUND DRAINPIPES TO BE PROVIDED AT ALL COURTYARD SLAB CUTOUT LANDSCAPE AREAS TO PREVENT POOLING WATER.</div> <div>LAP SIDING - REFER TO OWNERS SCOPE OF WORK DOCUMENTS FOR MATERIAL, MANUFACTURER, STYLE, COLOR AND OTHER REQUIREMENTS.</div> <div>EXTERIOR TRIM & SOFFITS - REFER TO OWNERS SCOPE OF WORK DOCUMENTS FOR MATERIAL, MANUFACTURER, STYLE, COLOR AND OTHER REQUIREMENTS.</div> <div>PROVIDE EXTERIOR TRIM OF SIZES INDICATED ON THE DRAWINGS.</div> <div>8 DOORS & WINDOWS EXTERIOR PATIO DOORS AND SLIDING PATIO DOORS - REFER TO OWNERS SCOPE OF WORK DOCUMENTS FOR MANUFACTURER, STYLE COLOR AND HARDWARE SELECTIONS. • SIZES AS INDICATED ON THE DRAWINGS. • ALL DOORS TO HAVE LOW-E GLASS SAFETY GLAZING.</div> <div>INTERIOR DOORS - REFER TO OWNERS SCOPE OF WORK DOCUMENTS FOR DOOR TYPE, STYLE AND HARDWARE SELECTIONS. SIZES AS INDICATED ON THE DRAWINGS.</div> <div>WINDOWS - REFER TO OWNERS SCOPE OF WORK DOCUMENTS FOR WINDOW MANUFACTURER, STYLE, COLOR AND HARDWARE SELECTIONS. • SIZES AS INDICATED ON THE DRAWINGS. • ALL WINDOWS TO HAVE LOW-E INSULATING GLASS • WINDOW MANUFACTURER SHALL PROVIDE TEMPERED GLASS AS REQUIRED BY R308.4 AT ALL HAZARDOUS LOCATIONS. • WINDOW FALL PROTECTION AS REQUIRED BY R312.2. • WRITTEN INSTALLATION INSTRUCTIONS SHALL BE PROVIDED BY THE WINDOW MANUFACTURER FOR EACH WINDOW - SEE FULL INSTRUCTIONS FOR ALL ADDITIONAL REQUIREMENTS. • ALL BEDROOM WINDOWS TO MEET EMERGENCY RESCUE OPENING CODE REQUIREMENTS. • WINDOW TRIM TO BE OFFSET MIN. 1/4" WHERE WINDOW MEETS TRIM FOR CAULKING. COORDINATE WITH WINDOW SELECTION. PAD OUT THE TRIM IF NEEDED. • TRIM MATERIAL PER OWNERS SCOPE OF WORK DOCUMENTS. SIZES AS INDICATED ON THE DRAWINGS. • SEE CURRENT BUILDING CODE FOR ALL ADDITIONAL REQUIREMENTS.</div> <div>9 FINISHES DRYWALL WALLS AND CEILINGS- REFER TO OWNERS SCOPE OF WORK DOCUMENTS FOR REQUIRED DRYWALL FINISHES. • PROVIDE TYPE-X GYPSUM PANELS AT LOCATIONS INDICATED ON THE DRAWINGS FOR FIRE-RATED ASSEMBLIES. • ALL BATHROOMS TO HAVE MOISTURE-RESISTANT, PAPERLESS GYPSUM. • PROVIDE 1/2" TILE BACKER BOARD IN LIEU OF DRYWALL AT ALL WALL LOCATIONS REQUIRING A TILE FINISH.</div> <div>INTERIOR FINISHES - REFER TO OWNERS SCOPE OF WORK DOCUMENTS FOR ALL INTERIOR FLOOR, WALL AND CEILING FINISHES.</div>	<div>10 SPECIALTIES BATH ACCESSORIES - REFER TO OWNERS SCOPE OF WORK DOCUMENTS FOR REQUIRED BATH ACCESSORIES.</div> <div>FIREPLACE - REFER TO OWNERS SCOPE OF WORK DOCUMENTS FOR FIREPLACE REQUIREMENT AND SELECTIONS.</div> <div>CLOSET ROODS AND SHELVING - REFER TO OWNERS SCOPE OF WORK DOCUMENTS FOR REQUIREMENTS AND SELECTIONS.</div> <div>11 EQUIPMENT APPLIANCES - REFER TO OWNERS SCOPE OF WORK DOCUMENTS FOR APPLIANCE SELECTIONS.</div> <div>12 FURNISHINGS SECTION NOT USED</div> <div>13 SPECIAL CONSTRUCTION SECTION NOT USED</div> <div>14 CONVEYING SYSTEMS SECTION NOT USED</div> <div>22 PLUMBING REFER TO PLUMBING PLANS BY OTHERS.</div> <div>23 HVAC REFER TO HVAC PLANS BY OTHERS.</div> <div>26 ELECTRICAL REFER TO ELECTRICAL PLANS BY OTHERS.</div>	<div><div>NEW HOME INC.</div><div>New Home Inc 1611 Jones Franklin, Raleigh, NC, 27606</div></div> <table><tr><th rowspan="2">REV.#</th><th colspan="8">DESCRIPTION</th><th rowspan="2">DATE</th></tr><tr><th>1</th><th>2</th><th>3</th><th>4</th><th>5</th><th>6</th><th>7</th><th>8</th></tr><tr><td></td><td></td><td></td><td></td><td></td><td></td><td></td><td></td><td></td><td></td></tr><tr><td></td><td></td><td></td><td></td><td></td><td></td><td></td><td></td><td></td><td></td></tr><tr><td></td><td></td><td></td><td></td><td></td><td></td><td></td><td></td><td></td><td></td></tr><tr><td></td><td></td><td></td><td></td><td></td><td></td><td></td><td></td><td></td><td></td></tr><tr><td></td><td></td><td></td><td></td><td></td><td></td><td></td><td></td><td></td><td></td></tr><tr><td></td><td></td><td></td><td></td><td></td><td></td><td></td><td></td><td></td><td></td></tr><tr><td></td><td></td><td></td><td></td><td></td><td></td><td></td><td></td><td></td><td></td></tr><tr><td></td><td></td><td></td><td></td><td></td><td></td><td></td><td></td><td></td><td></td></tr></table>	REV.#	DESCRIPTION								DATE	1	2	3	4	5	6	7	8																																																																																
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GENERAL FLOOR PLAN NOTES:

General Floor Plan Notes shall apply unless noted otherwise on plan.

1. Wall Heights: Typically 9'-1 1/2" at first floor and second floor, and 9'-1 1/2" at attics U.N.O. All walls are constructed using a double top plate. Splices at Double Top Plate do not need to occur at Vertical Studs but must be at least 24" apart from Joint in other Top Plate layer. Special wall heights are noted on plans where they occur.
2. Wall Thickness is typically 3 1/2". 2x6 frame shall be used at walls that back up to plumbing fixtures. Walls greater than 10' high shall be framed with 2x6 framing or greater and will be noted as a special condition where it occurs on plan.
3. Typical header height shall be 7'-8" AFF at First Floor, and 7'-4" AFF at Second Floor U.N.O.
4. Jacks: Openings up to 3'-4" wide shall have (1) 2x4 jack stud SPF on each side. Openings greater than 3'-4" wide shall have (2) 2x4 jack studs SPF on each side.
5. Soffits, Coffered Ceilings, Trey Ceilings and other significant ceiling plan elements are shown on the floor plans and are denoted as single dashed lines. Unless specifically call out as included, Kitchens include soffits over wall cabinetry.
6. Door & Window Frames, where occurring near corners, shall be a minimum of 4 1/2" from corner. Except for walk-in closets with doors near a corner, doors at closets shall be centered on closet.
7. Windows: Shall have at least (1) window in each sleeping room, that meets egress. Shall be provided with tempered glass at hazardous glazing areas. False windows shall be installed with obscure glazing.
8. Closets for clothing or coat storage shall be equipped with 1 rod/shelf. Closets for linen shall have 4 open equal shelves. Closets for pantries shall have 4 equal wood shelves, painted.
9. Stair treads shall be a min of 9" deep, risers shall be a maximum of 8 1/4", unless noted otherwise, per the current North Carolina Residential Code.
10. Handrails and Guards at stairs shall be 34" above the finished surface of the ramp surface of the stair. Handrails at landings and overlooks of multilevel spaces shall be 36" above finished floor. Guards (pickets or balusters) shall be spaced with no more than 4" between guards.
11. Attic Access shall be provided at all attic area with a height greater than 30". Minimum clear attic access shall be 20" x 30". Pull down stairs and access doors in knee walls meeting minimum criteria are also acceptable.
12. Garage Door to Living Space shall be 2'-8" x 6'-8" minimum size and shall be 20 minute fire rated and weather sealed.
13. Garage Walls, as a minimum, shall be separated from living space by installing 1/2" gypsum board on the garage side of the wall. With habitable space above, the inside of all garage walls require 1/2" GWB supporting 5/8" type X GWB on ceiling.

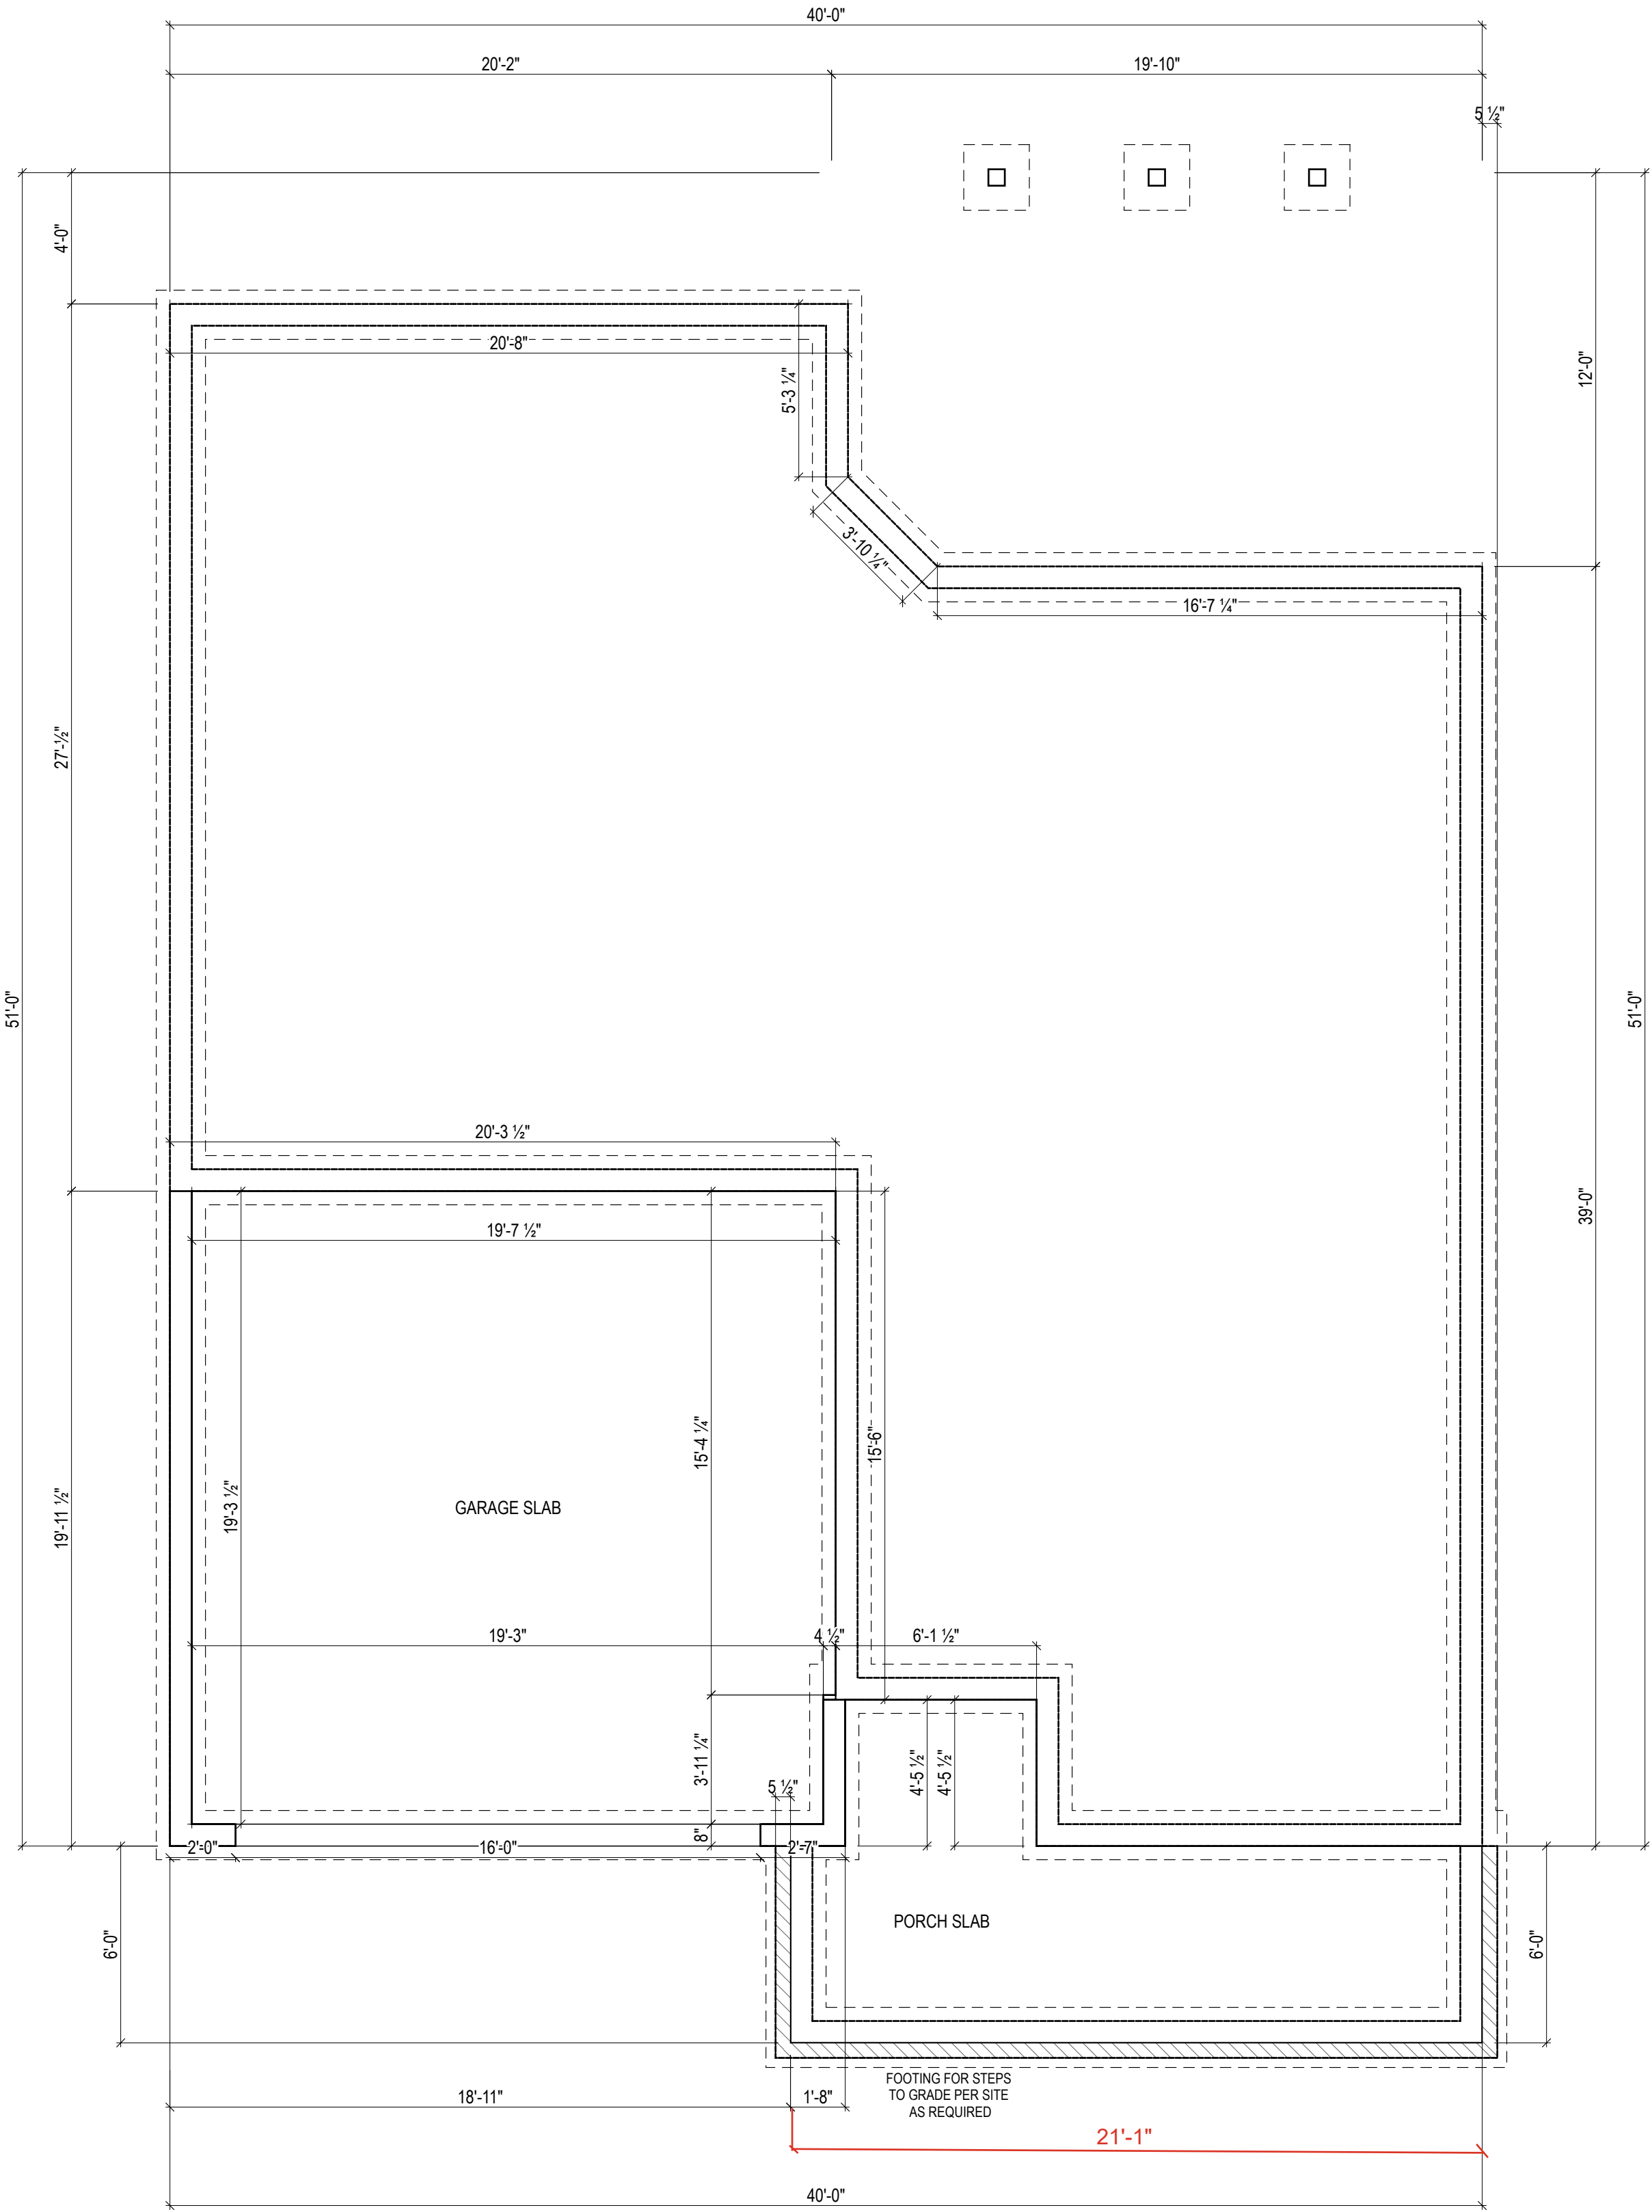

1 FOUNDATION PLAN - Crawlspace
1/4" = 1'-0" (WHEN PRINTED ON 22x34)
1/8" = 1'-0" (WHEN PRINTED ON 11x17)



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Raleigh, NC, 27606

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The Gamer Craftsman at Cattail Preserve

FOUNDATION PLAN


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HANDING: RIGHT
ISSUE DATE: 11/11/1111
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A-100

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1 First Floor Plan
1/4" = 1'-0" (WHEN PRINTED ON 22x34)
1/8" = 1'-0" (WHEN PRINTED ON 11x17)



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The Gamer Craftsman at Cattail Preserve

First Floor Plan

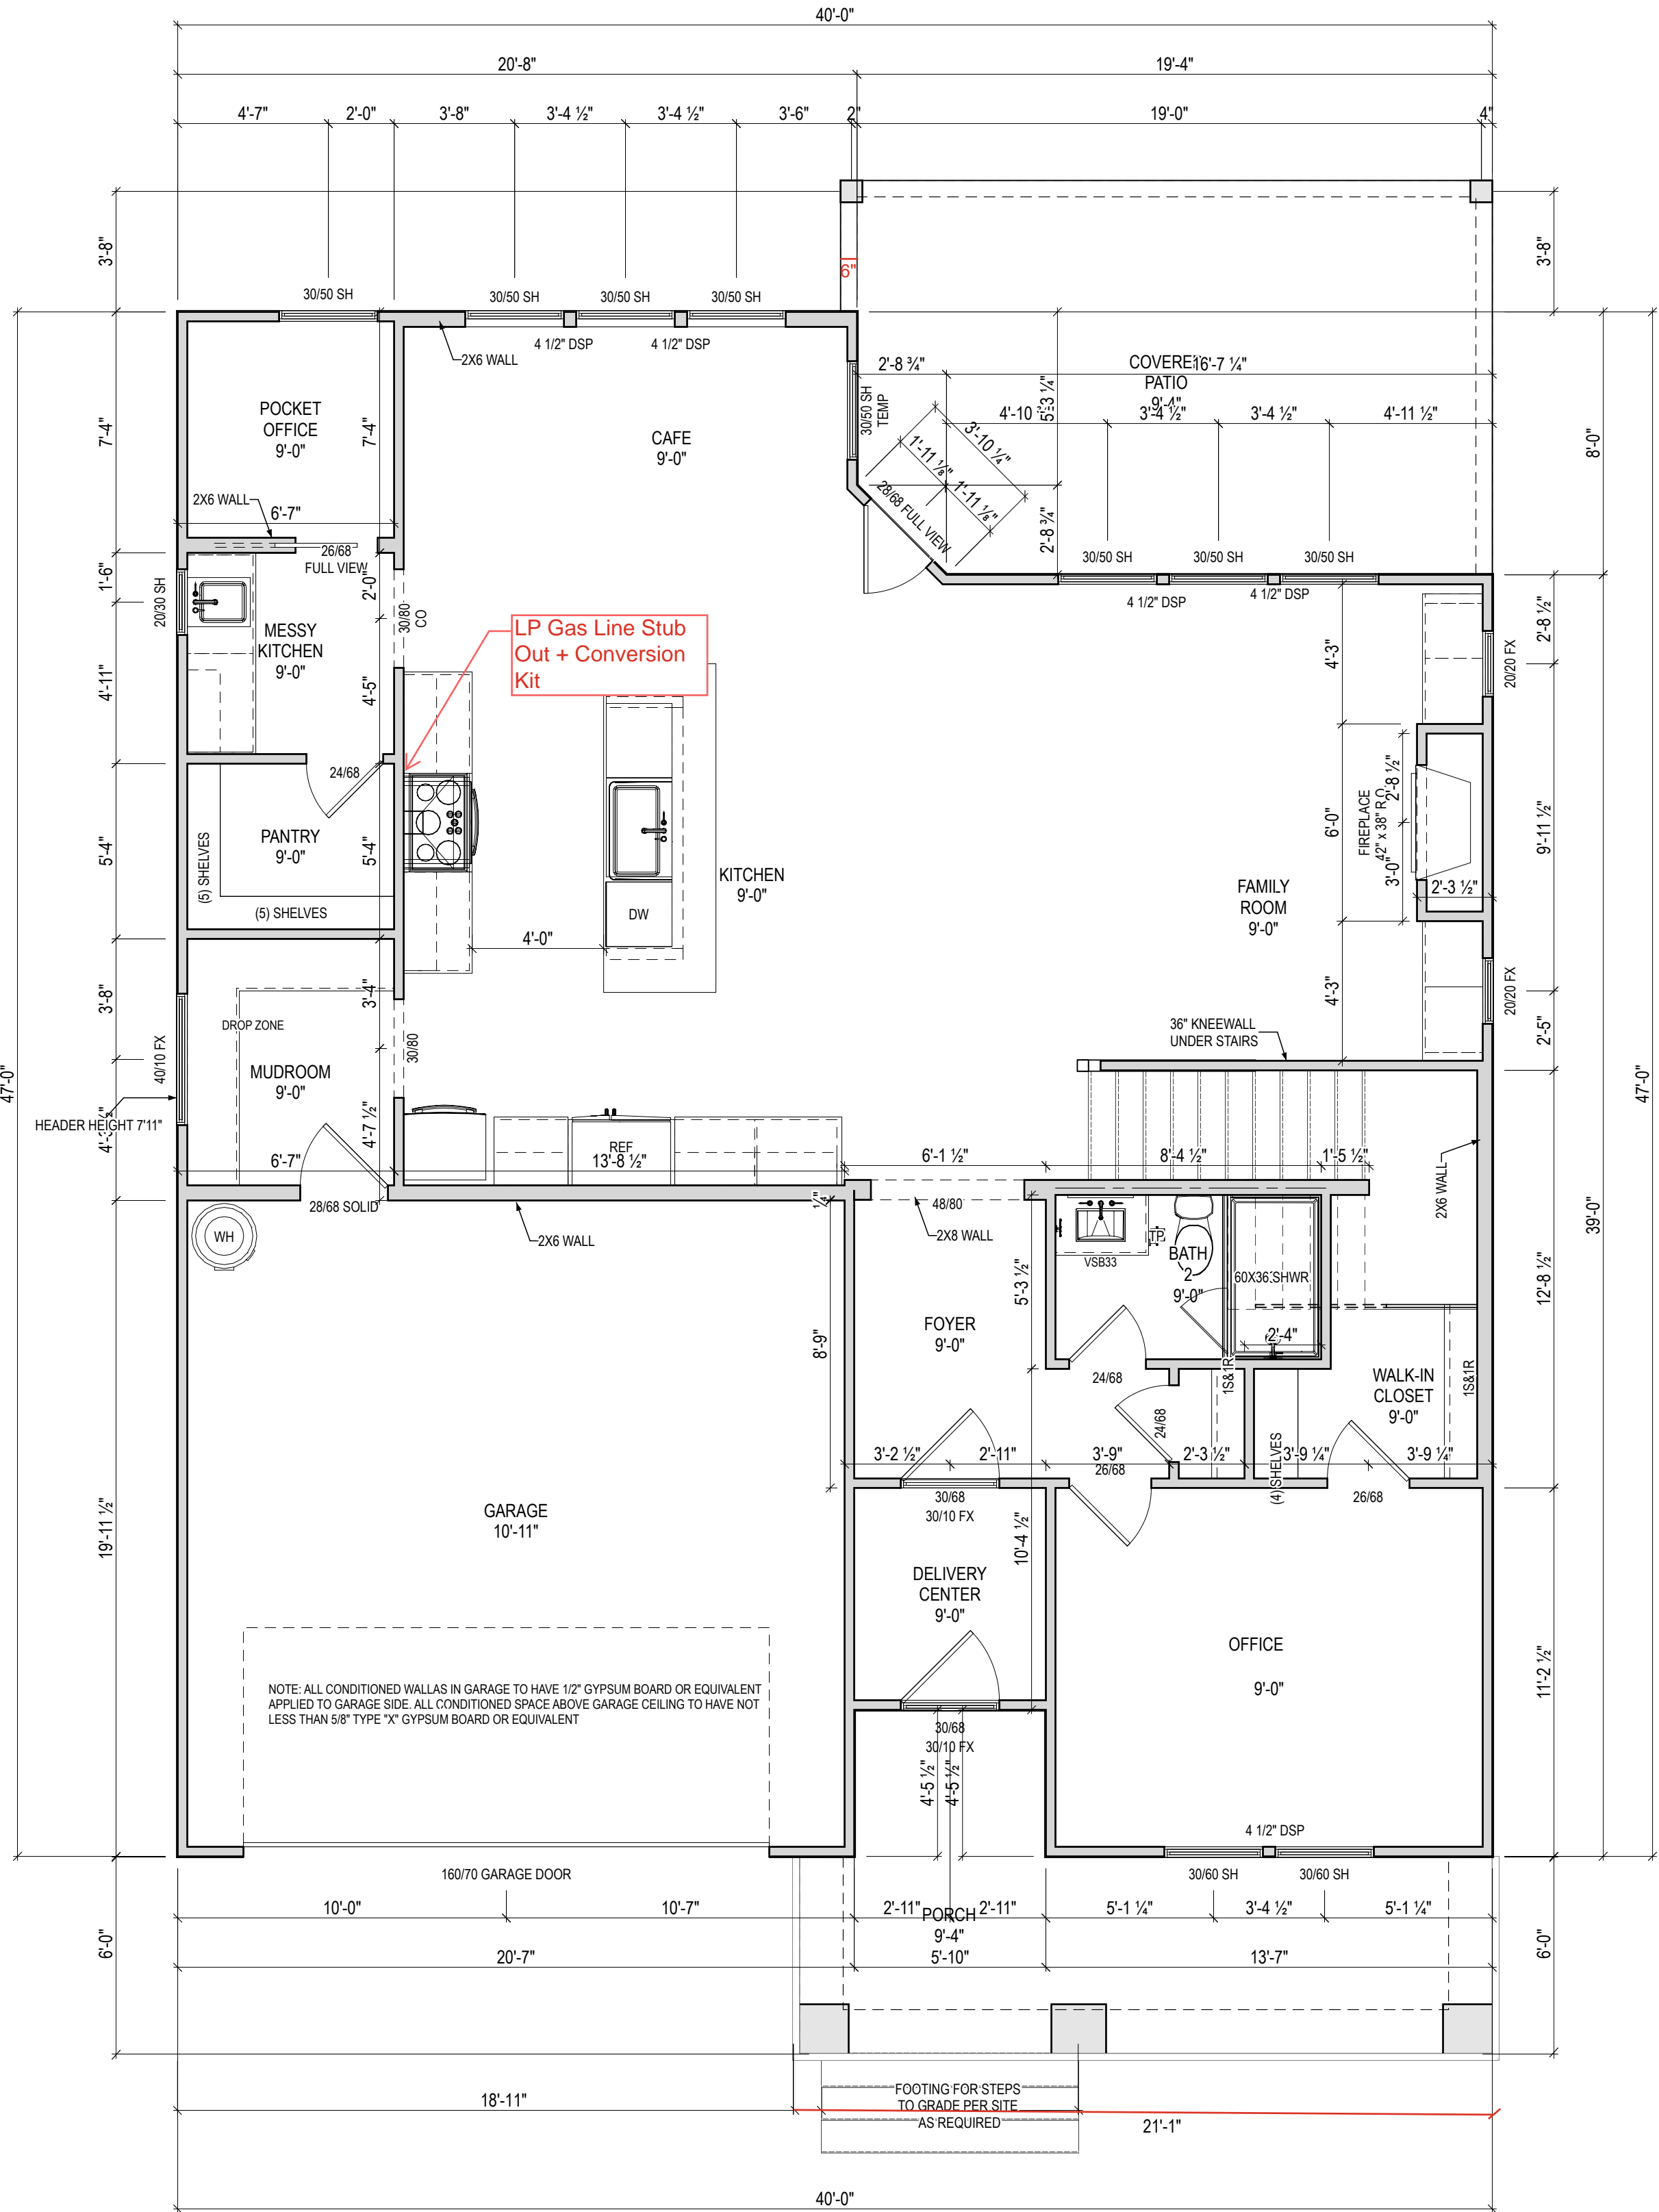DRAWN BY:
Drew DiMeo

HANDING:
RIGHT

ISSUE DATE:
11/11/1111

SHEET

A-110

GENERAL FLOOR PLAN NOTES:

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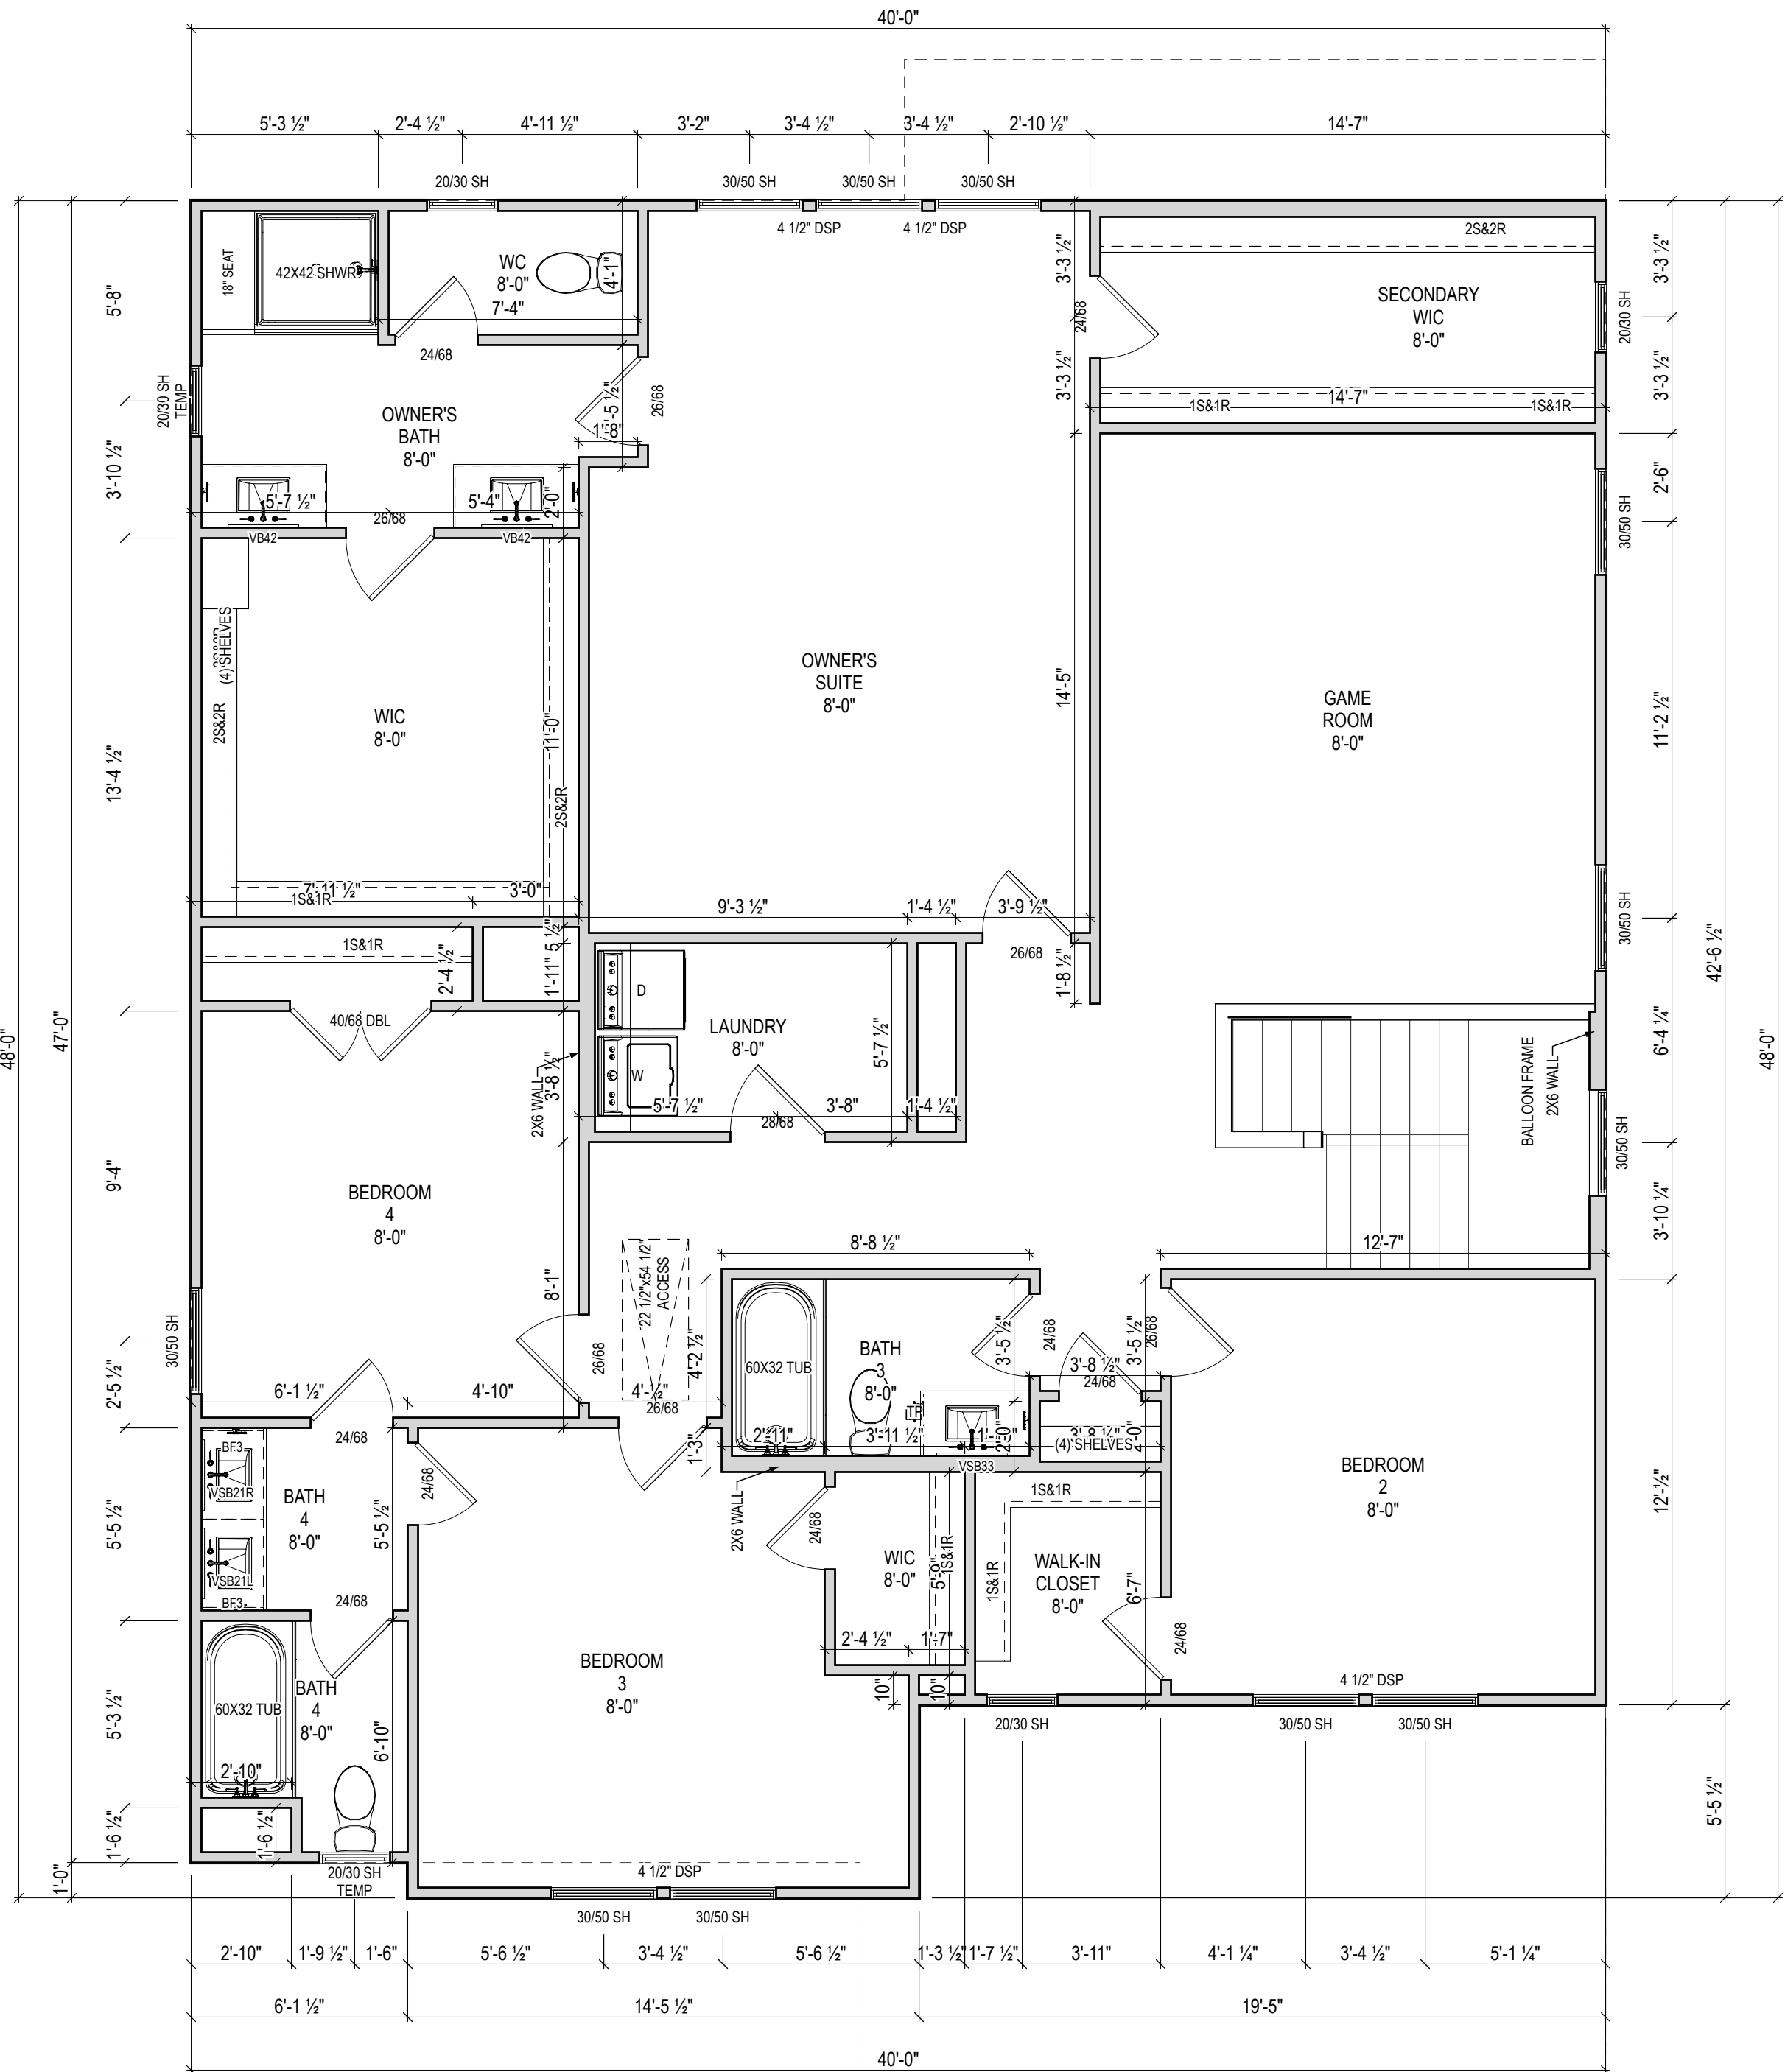
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1 Second Floor Plan

1/4" = 1'-0" (WHEN PRINTED ON 22x34)
1/8" = 1'-0" (WHEN PRINTED ON 11x17)



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The Gamer Craftsman at Cattail Preserve

Second Floor Plan

DRAWN BY:
Drew DiMeo

HANDING:
RIGHT


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GENERAL ROOF PLAN NOTES:

1. ALL ROOF OVERHANGS TO BE 1'-0" UNLESS NOTED OTHERWISE
2. ALL TRAY CEILING TRAY HEIGHTS TO BE 12' UNLESS NOTED OTHERWISE
3. THESE PLANS ARE NOT TO BE SCALED FOR CONSTRUCTION PURPOSES.
4. IT IS THE CONTRACTOR'S RESPONSIBILITY TO VERIFY THE ACCURACY OF ALL DETAILS AND DIMENSIONS.
5. 8×16' ATTIC STORAGE PLATFORM - PROVIDE 3/4" APA RATED PLYWOOD SUB-FLOORING OR OSB SHEATHING RATED FOR 20#/SF ON BOTTOM CHORD OF TRUSSES. TRUSS MANUFACTURER TO ACCOUNT FOR ADDITIONAL LOADS



1

Roof Plan

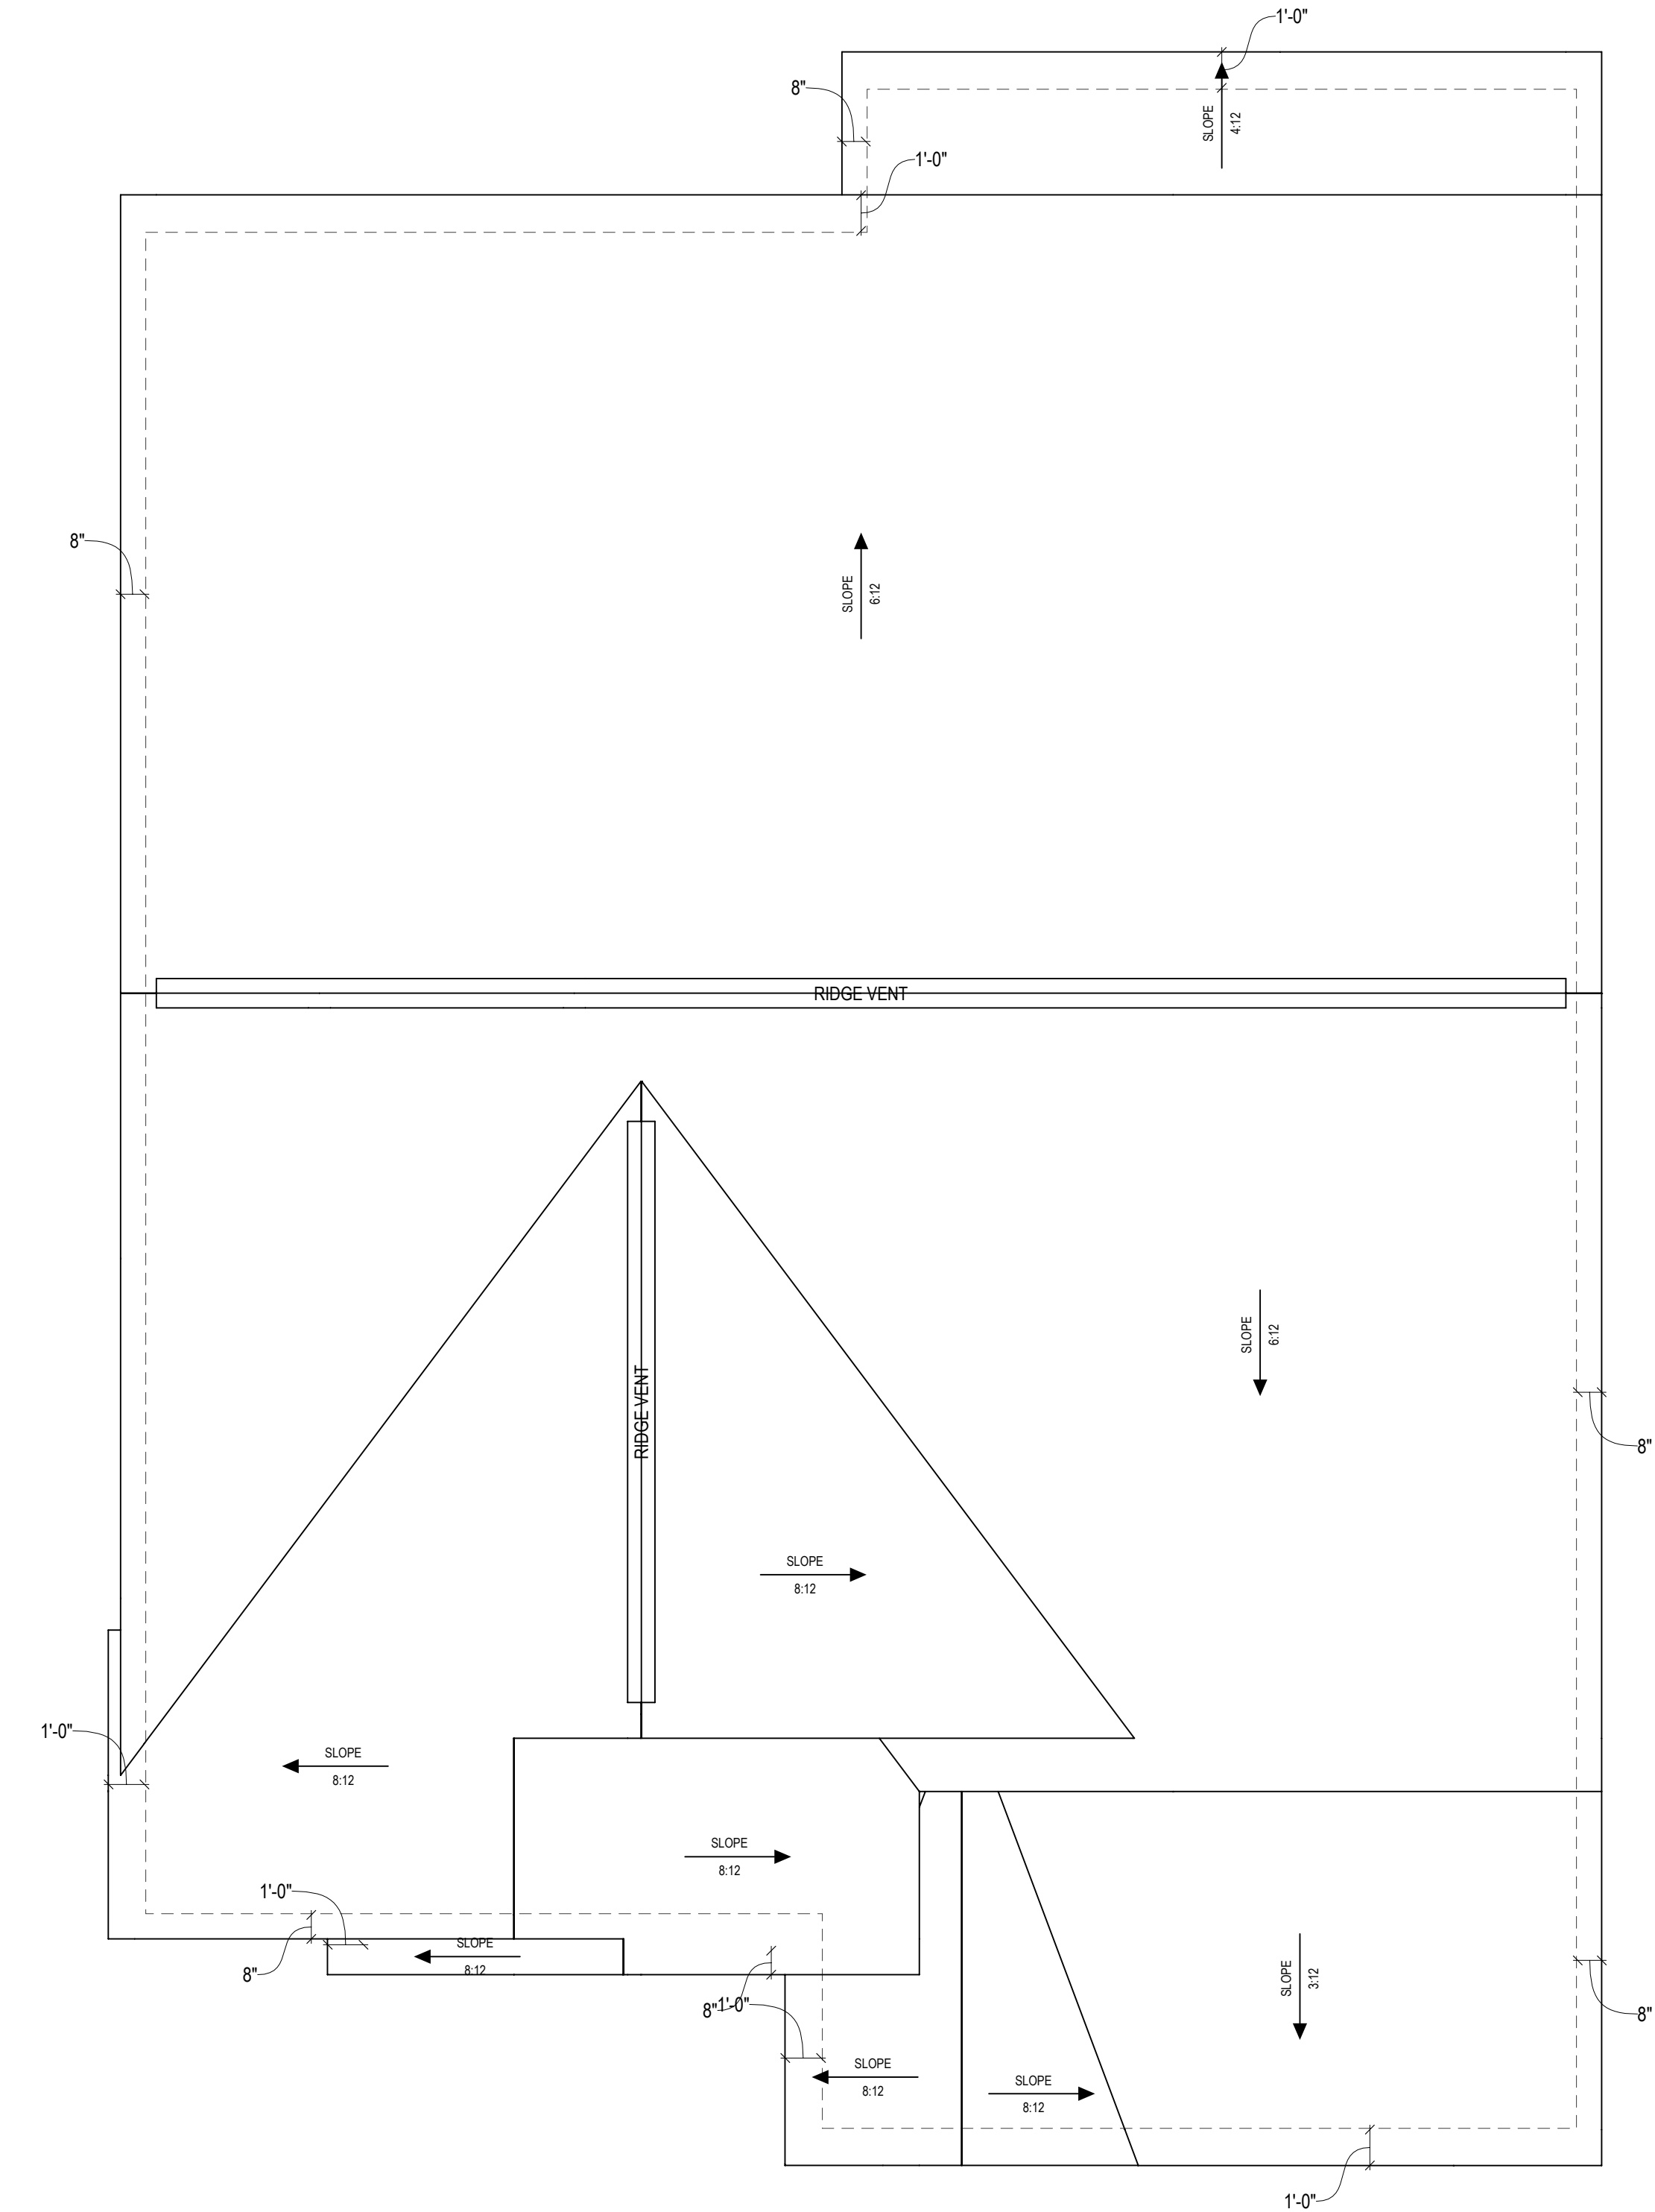1/4" = 1'-0" (WHEN PRINTED ON 22x34)
1/8" = 1'-0" (WHEN PRINTED ON 11x17)



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Roof Plan

DRAWN BY:
Drew DiMeo
HANDING:
RIGHT
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11/11/1111
SHEET

A-200

GENERAL ELEVATION NOTES:

General Elevation Notes shall apply unless noted otherwise on plan.

1. Roof shall be finished with architectural composition shingles with slopes as noted on plan.

2. Ridge Vent shall be provided and installed on all ridges greater than 6' in length per manufacturer's specifications.

3. Soffit Vent shall be continuous soffit vent.

4. House Wrap, "tyvek" or approved equal shall be installed over entire exterior wall per manufacturer's specifications and recommendations.


5. Flashing shall be provided above all door and window openings, above finish wall material changes and at wall surfaces where lower roof areas abut vertical wall surfaces.

6. Porch Railings shall be provided at all porch walking surfaces greater than 30" above adjacent finished grade. It shall be 36" high with guards spaced no more than 4" apart. Consult community specifications for material.

7. Finish Wall Material shall be as noted on elevation drawings.

8. Brick Veneer, if included on elevation shall be tied to wall surface with galvanized corrugated metal ties at a rate of 24" oc horizontally and 16" oc vertically so that no more than 2.67sf of brick is supported by (1) tie. Space between face of wall and back face of brick shall be limited to a maximum of 1". Flashing shall be provided behind brick above all wall openings and at base of brick wall. Flashing shall be a minimum of 6-mil poly or other corrosion resistant material and shall be installed so that it laps under the house wrap material a minimum of 2". Weepholes shall be provided at a rate of 48" oc and shall not be less than 3/16" in diameter and shall be located immediately above flashing.

9. Brick Veneer Support Lintels shall be provided if brick veneer is included on elevation. Lintels shall be provided as listed in the following schedule and shall have a minimum bearing length of 6". Masonry Lintels shall be provided so that deflection is limited to L/600.

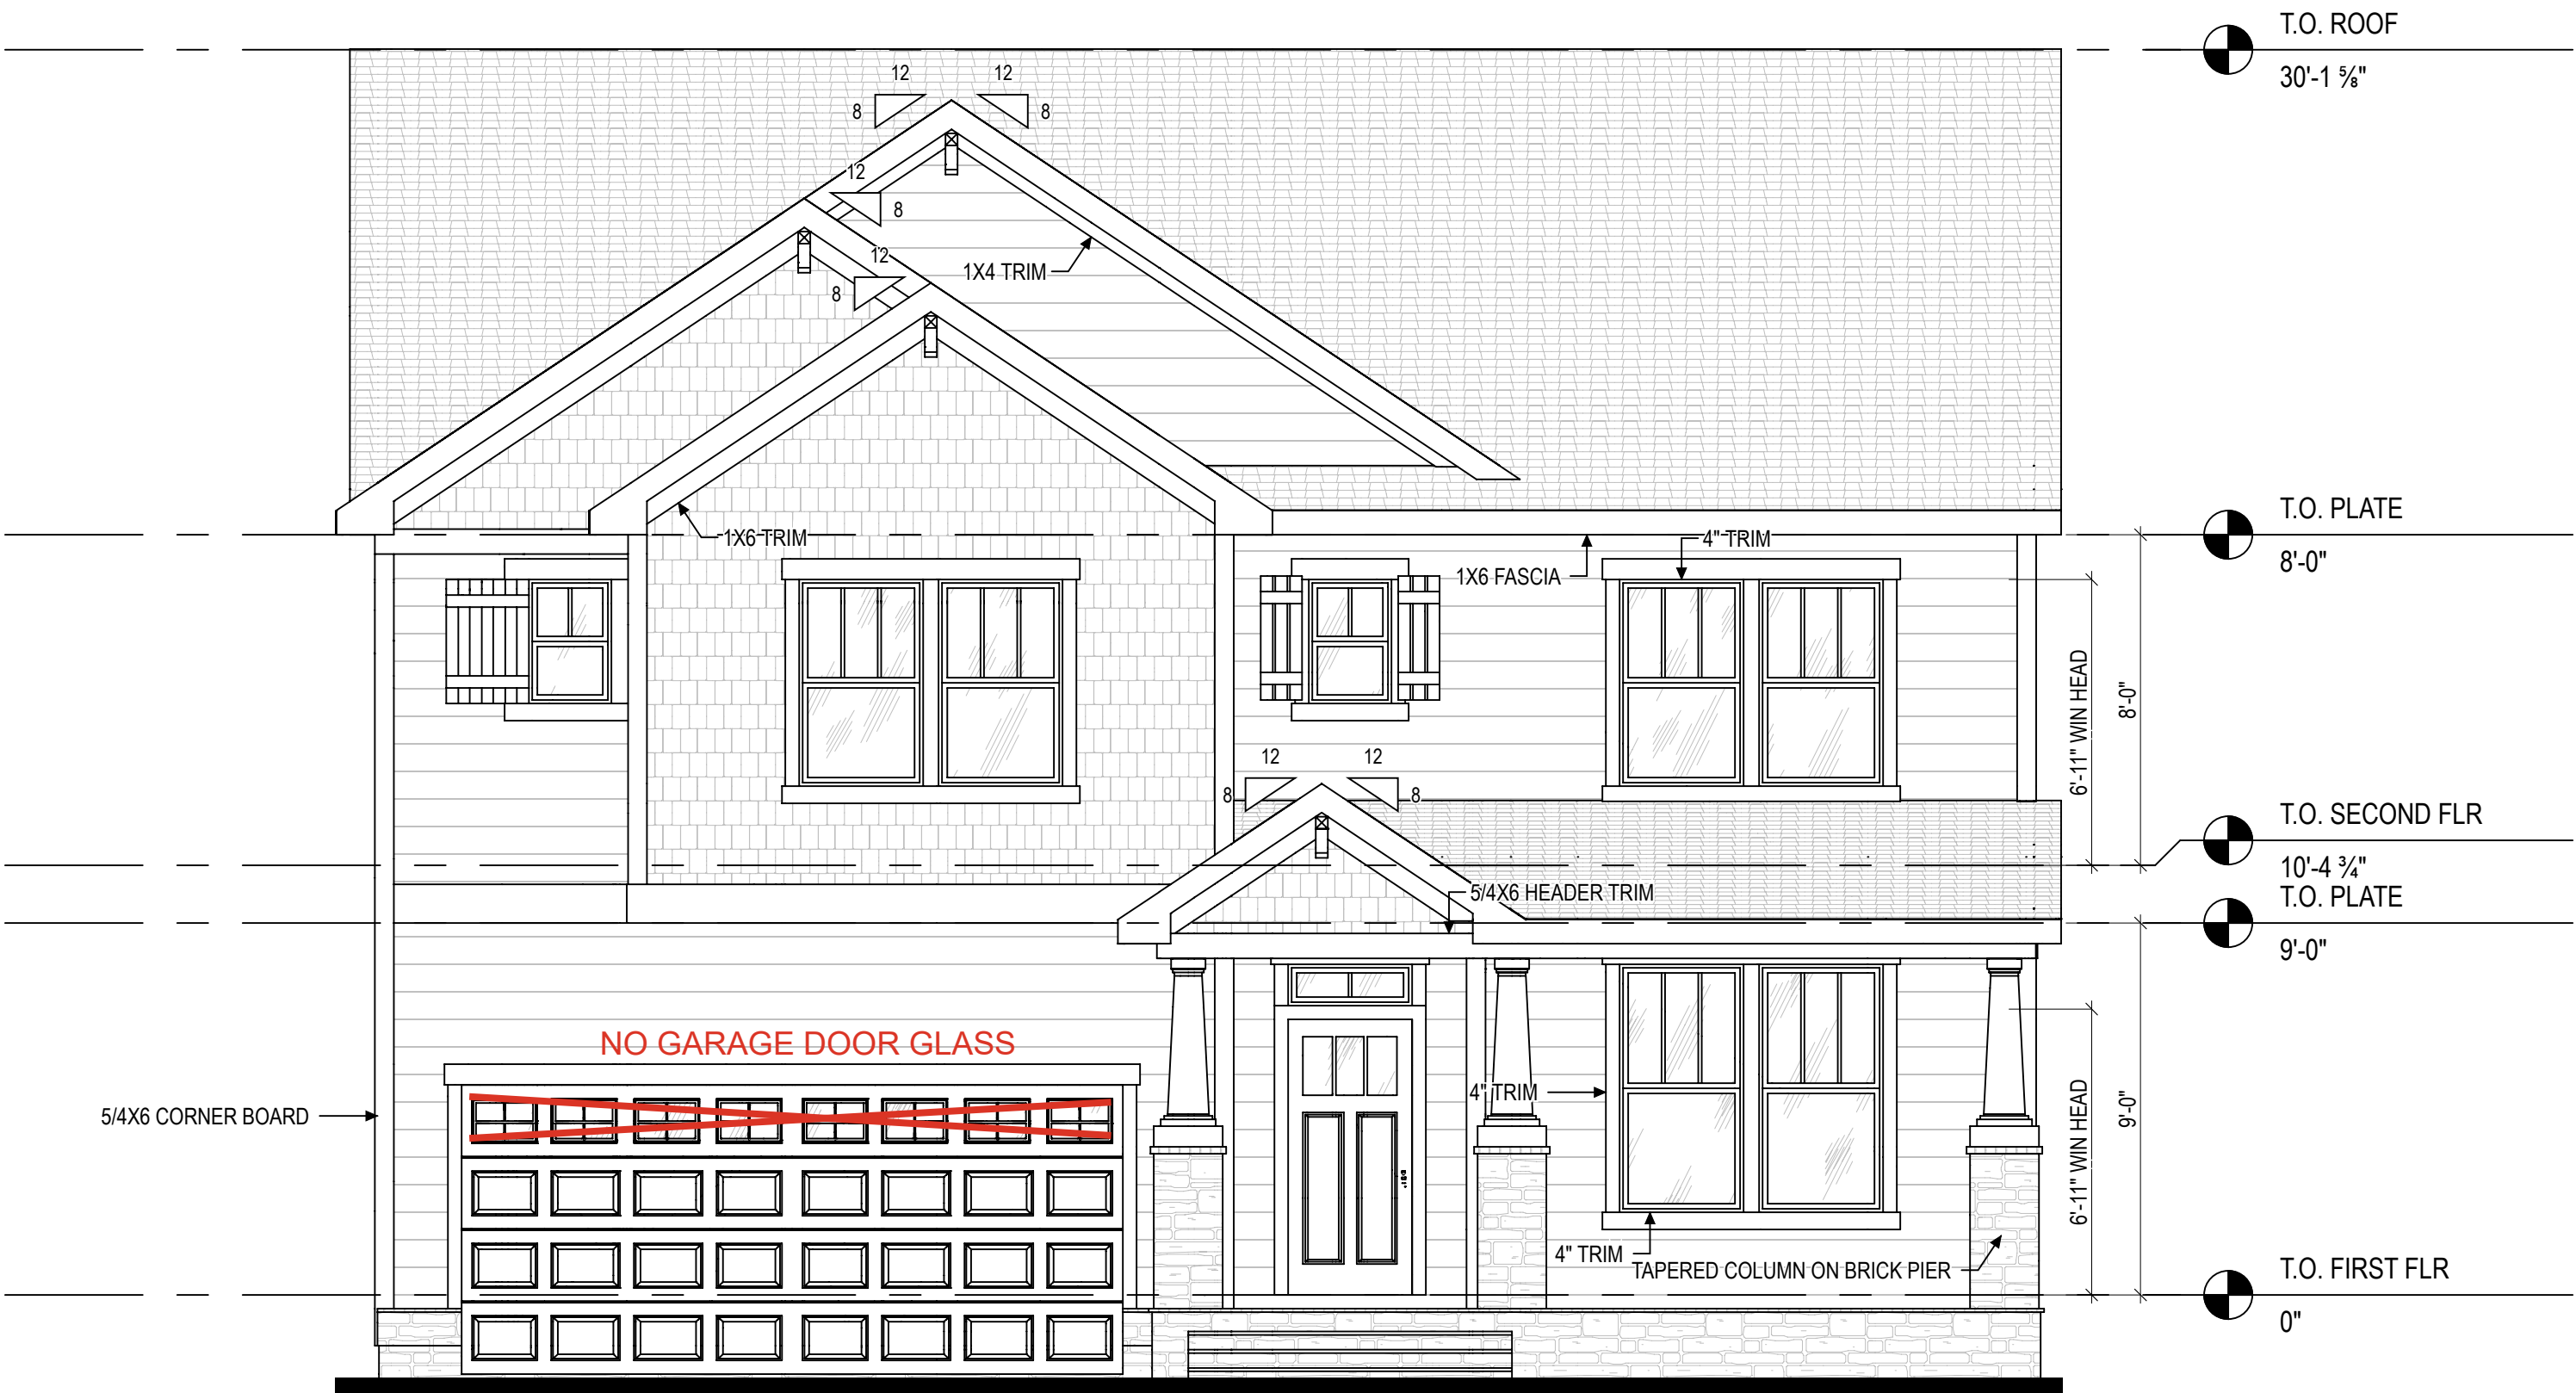

1 Front Elevation
1/4" = 1'-0" (WHEN PRINTED ON 22x34)
1/8" = 1'-0" (WHEN PRINTED ON 11x17)



2 Back Elevation
1/4" = 1'-0" (WHEN PRINTED ON 22x34)
1/8" = 1'-0" (WHEN PRINTED ON 11x17)



New Home Inc
1611 Jones Franklin,
Raleigh, NC, 27606

REV.#	DESCRIPTION		DATE	
1				
2				
3				
4				
5				
6				
7				
8				

The Selma Craftsman at {{ CommunityName }}

Elevations - Front and Back

DRAWN BY:

JJ

HANDING:

LEFT

ISSUE DATE:

11/11/1111

SHEET

A-310

GENERAL ELEVATION NOTES:

General Elevation Notes shall apply unless noted otherwise on plan.

1. Roof shall be finished with architectural composition shingles with slopes as noted on plan.

2. Ridge Vent shall be provided and installed on all ridges greater than 6' in length per manufacturer's specifications.

3. Soffit Vent shall be continuous soffit vent.

4. House Wrap, "tyvek" or approved equal shall be installed over entire exterior wall per manufacturer's specifications and recommendations.


5. Flashing shall be provided above all door and window openings, above finish wall material changes and at wall surfaces where lower roof areas abut vertical wall surfaces.

6. Porch Railings shall be provided at all porch walking surfaces greater than 30" above adjacent finished grade. It shall be 36" high with guards spaced no more than 4" apart. Consult community specifications for material.


7. Finish Wall Material shall be as noted on elevation drawings.

8. Brick Veneer, if included on elevation shall be tied to wall surface with galvanized corrugated metal ties at a rate of 24" oc horizontally and 16" oc vertically so that no more than 2.67sf of brick is supported by (1) tie. Space between face of wall and back face of brick shall be limited to a maximum of 1". Flashing shall be provided behind brick above all wall openings and at base of brick wall. Flashing shall be a minimum of 6-mil poly or other corrosion resistant material and shall be installed so that it laps under the house wrap material a minimum of 2". Weepholes shall be provided at a rate of 48" oc and shall not be less than 3/16" in diameter and shall be located immediately above flashing.

9. Brick Veneer Support Lintels shall be provided if brick veneer is included on elevation. Lintels shall be provided as listed in the following schedule and shall have a minimum bearing length of 6". Masonry Lintels shall be provided so that deflection is limited to L/600.

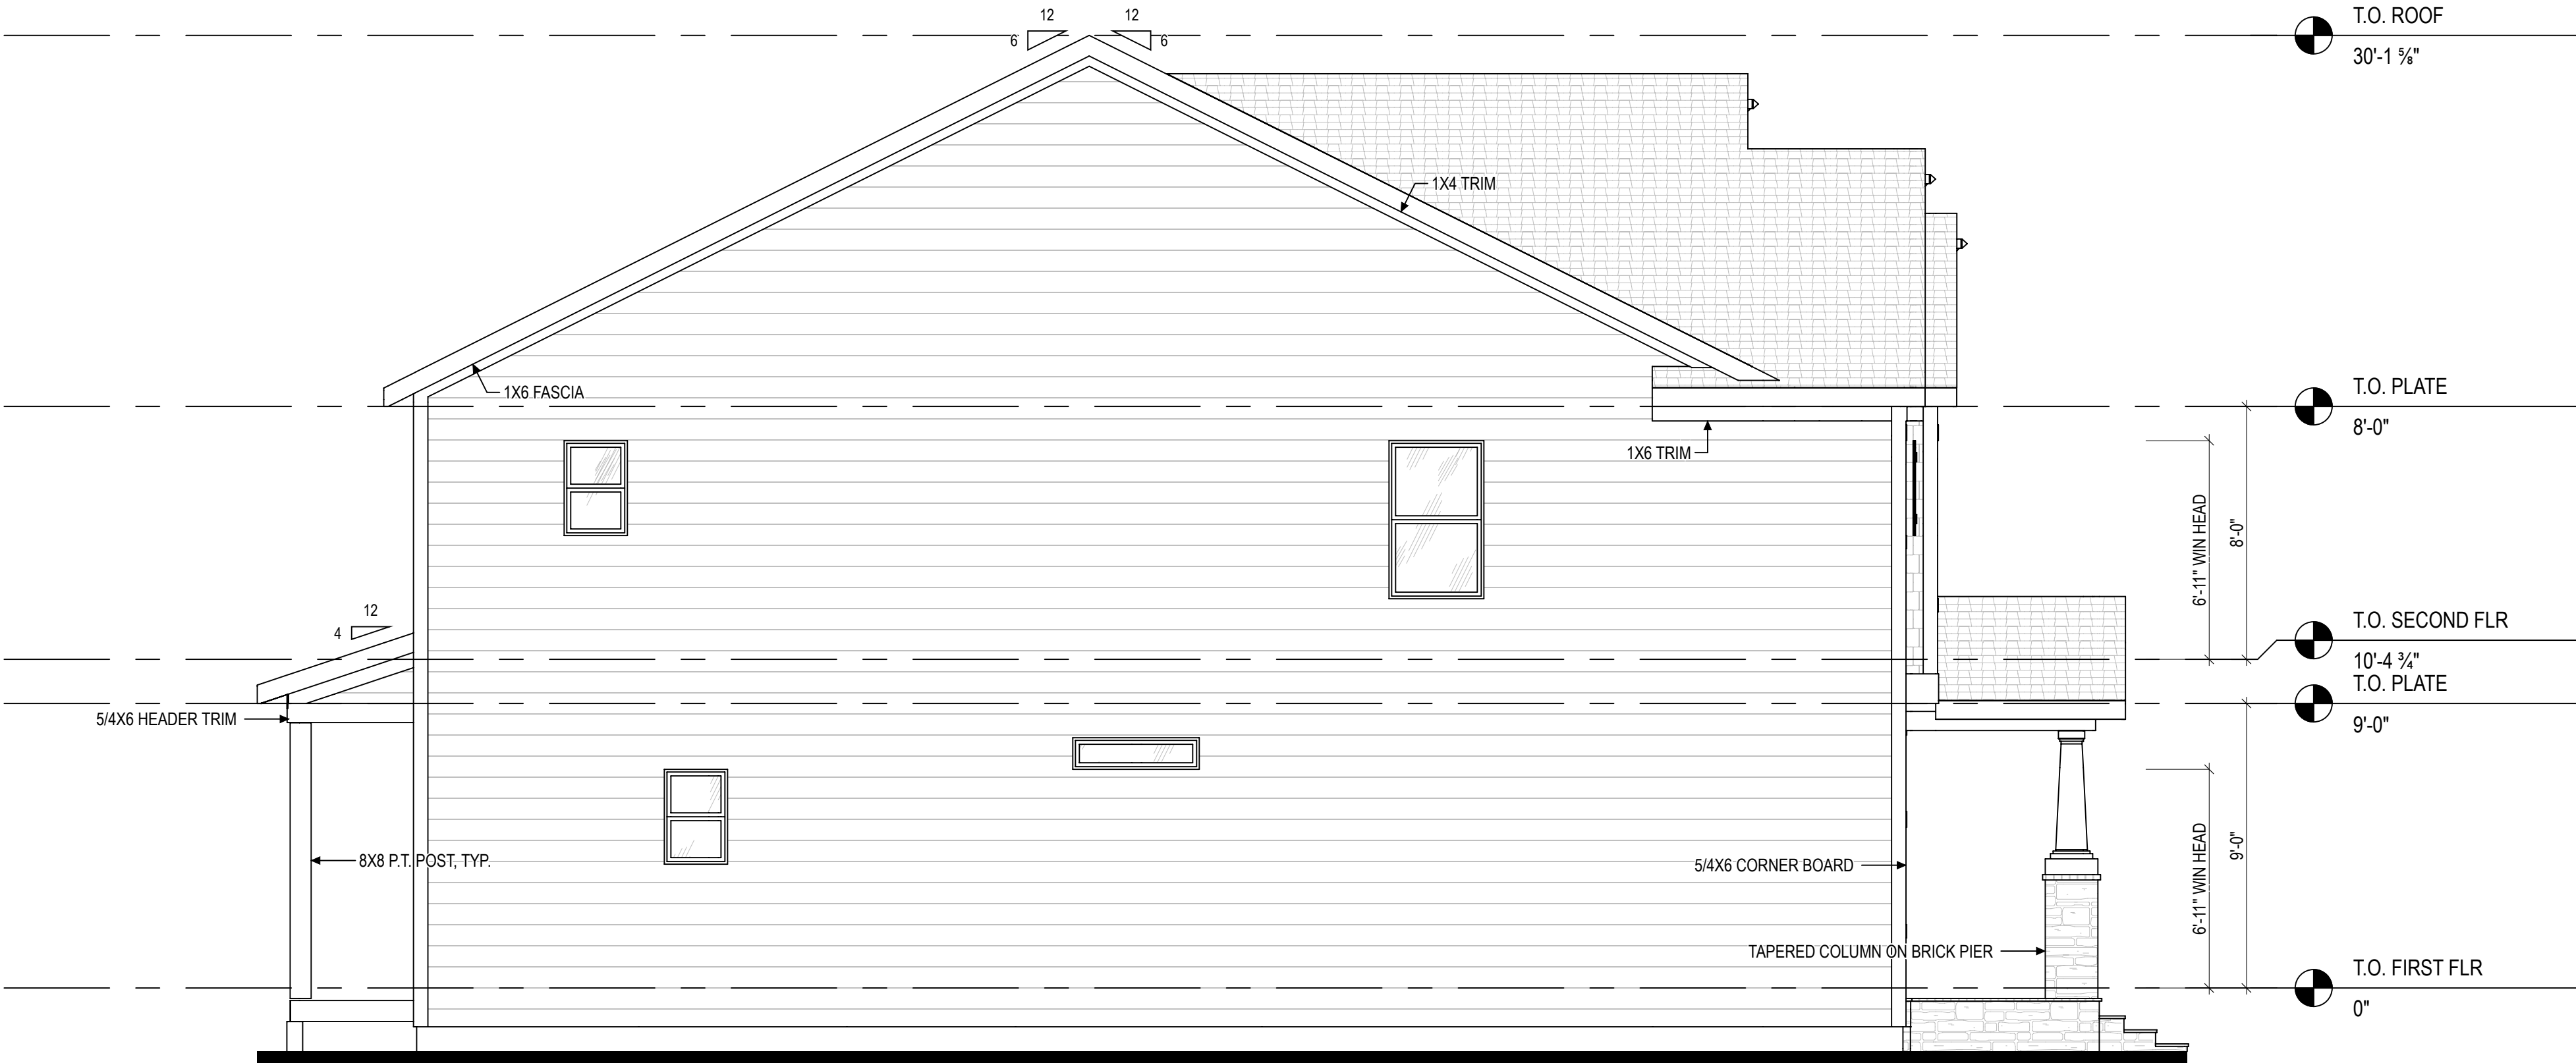

1 Left Elevation
1/4" = 1'-0" (WHEN PRINTED ON 22x34)
1/8" = 1'-0" (WHEN PRINTED ON 11x17)

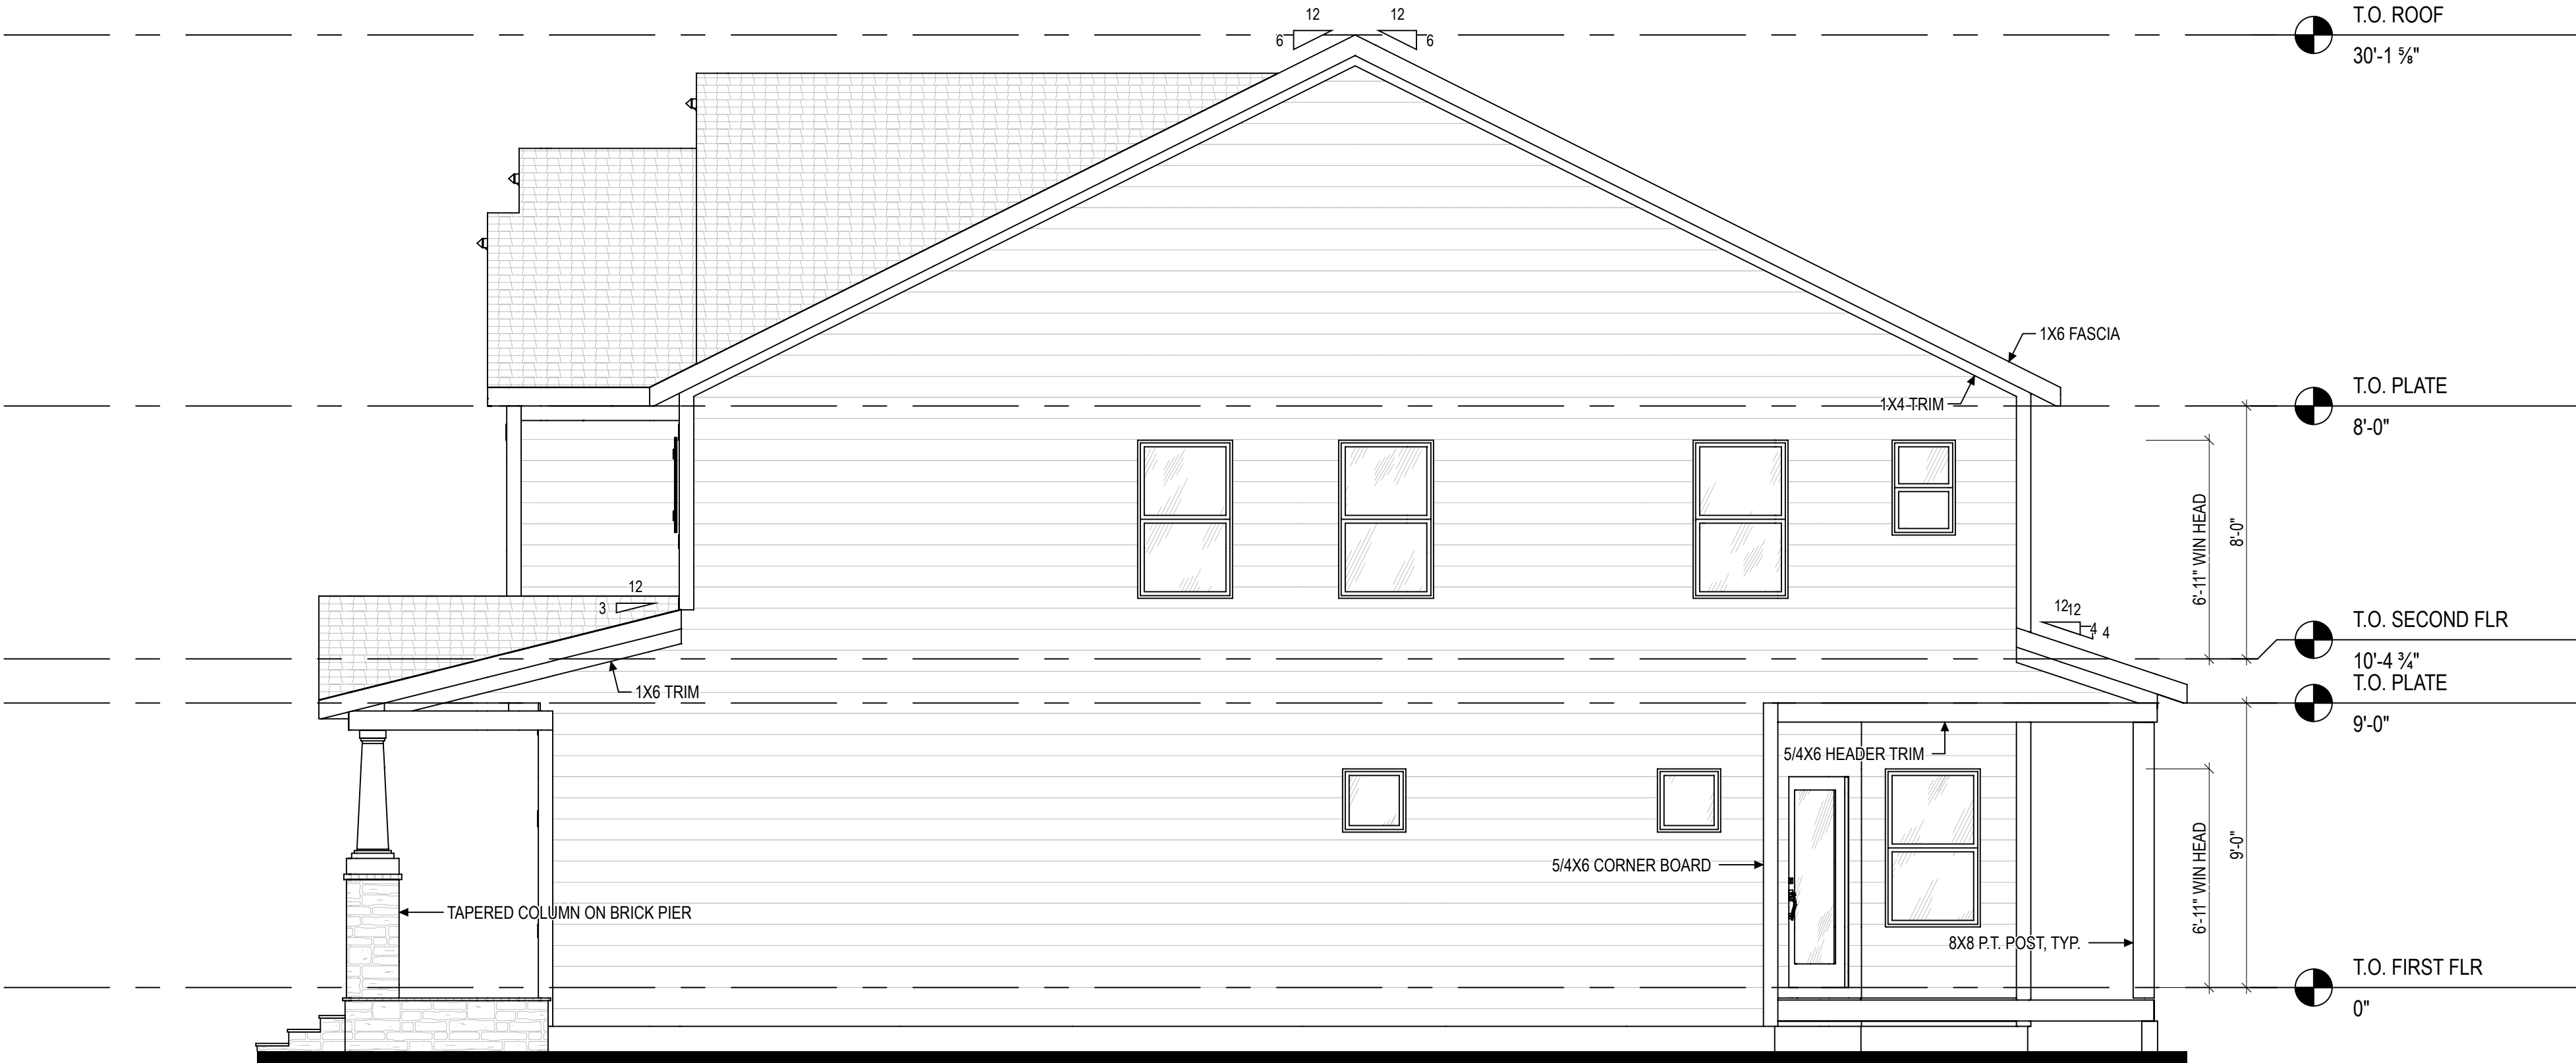

2 Right Elevation
1/4" = 1'-0" (WHEN PRINTED ON 22x34)
1/8" = 1'-0" (WHEN PRINTED ON 11x17)



New Home Inc
1611 Jones Franklin,
Raleigh, NC, 27606

REV.#	DESCRIPTION		DATE	
1				
2				
3				
4				
5				
6				
7				
8				

The Gamer Craftsman at Cattail Preserve

Elevations - Front and Back


DRAWN BY:
Drew DiMeo

HANDING:
LEFT

ISSUE DATE:
11/11/1111

SHEET

A-320

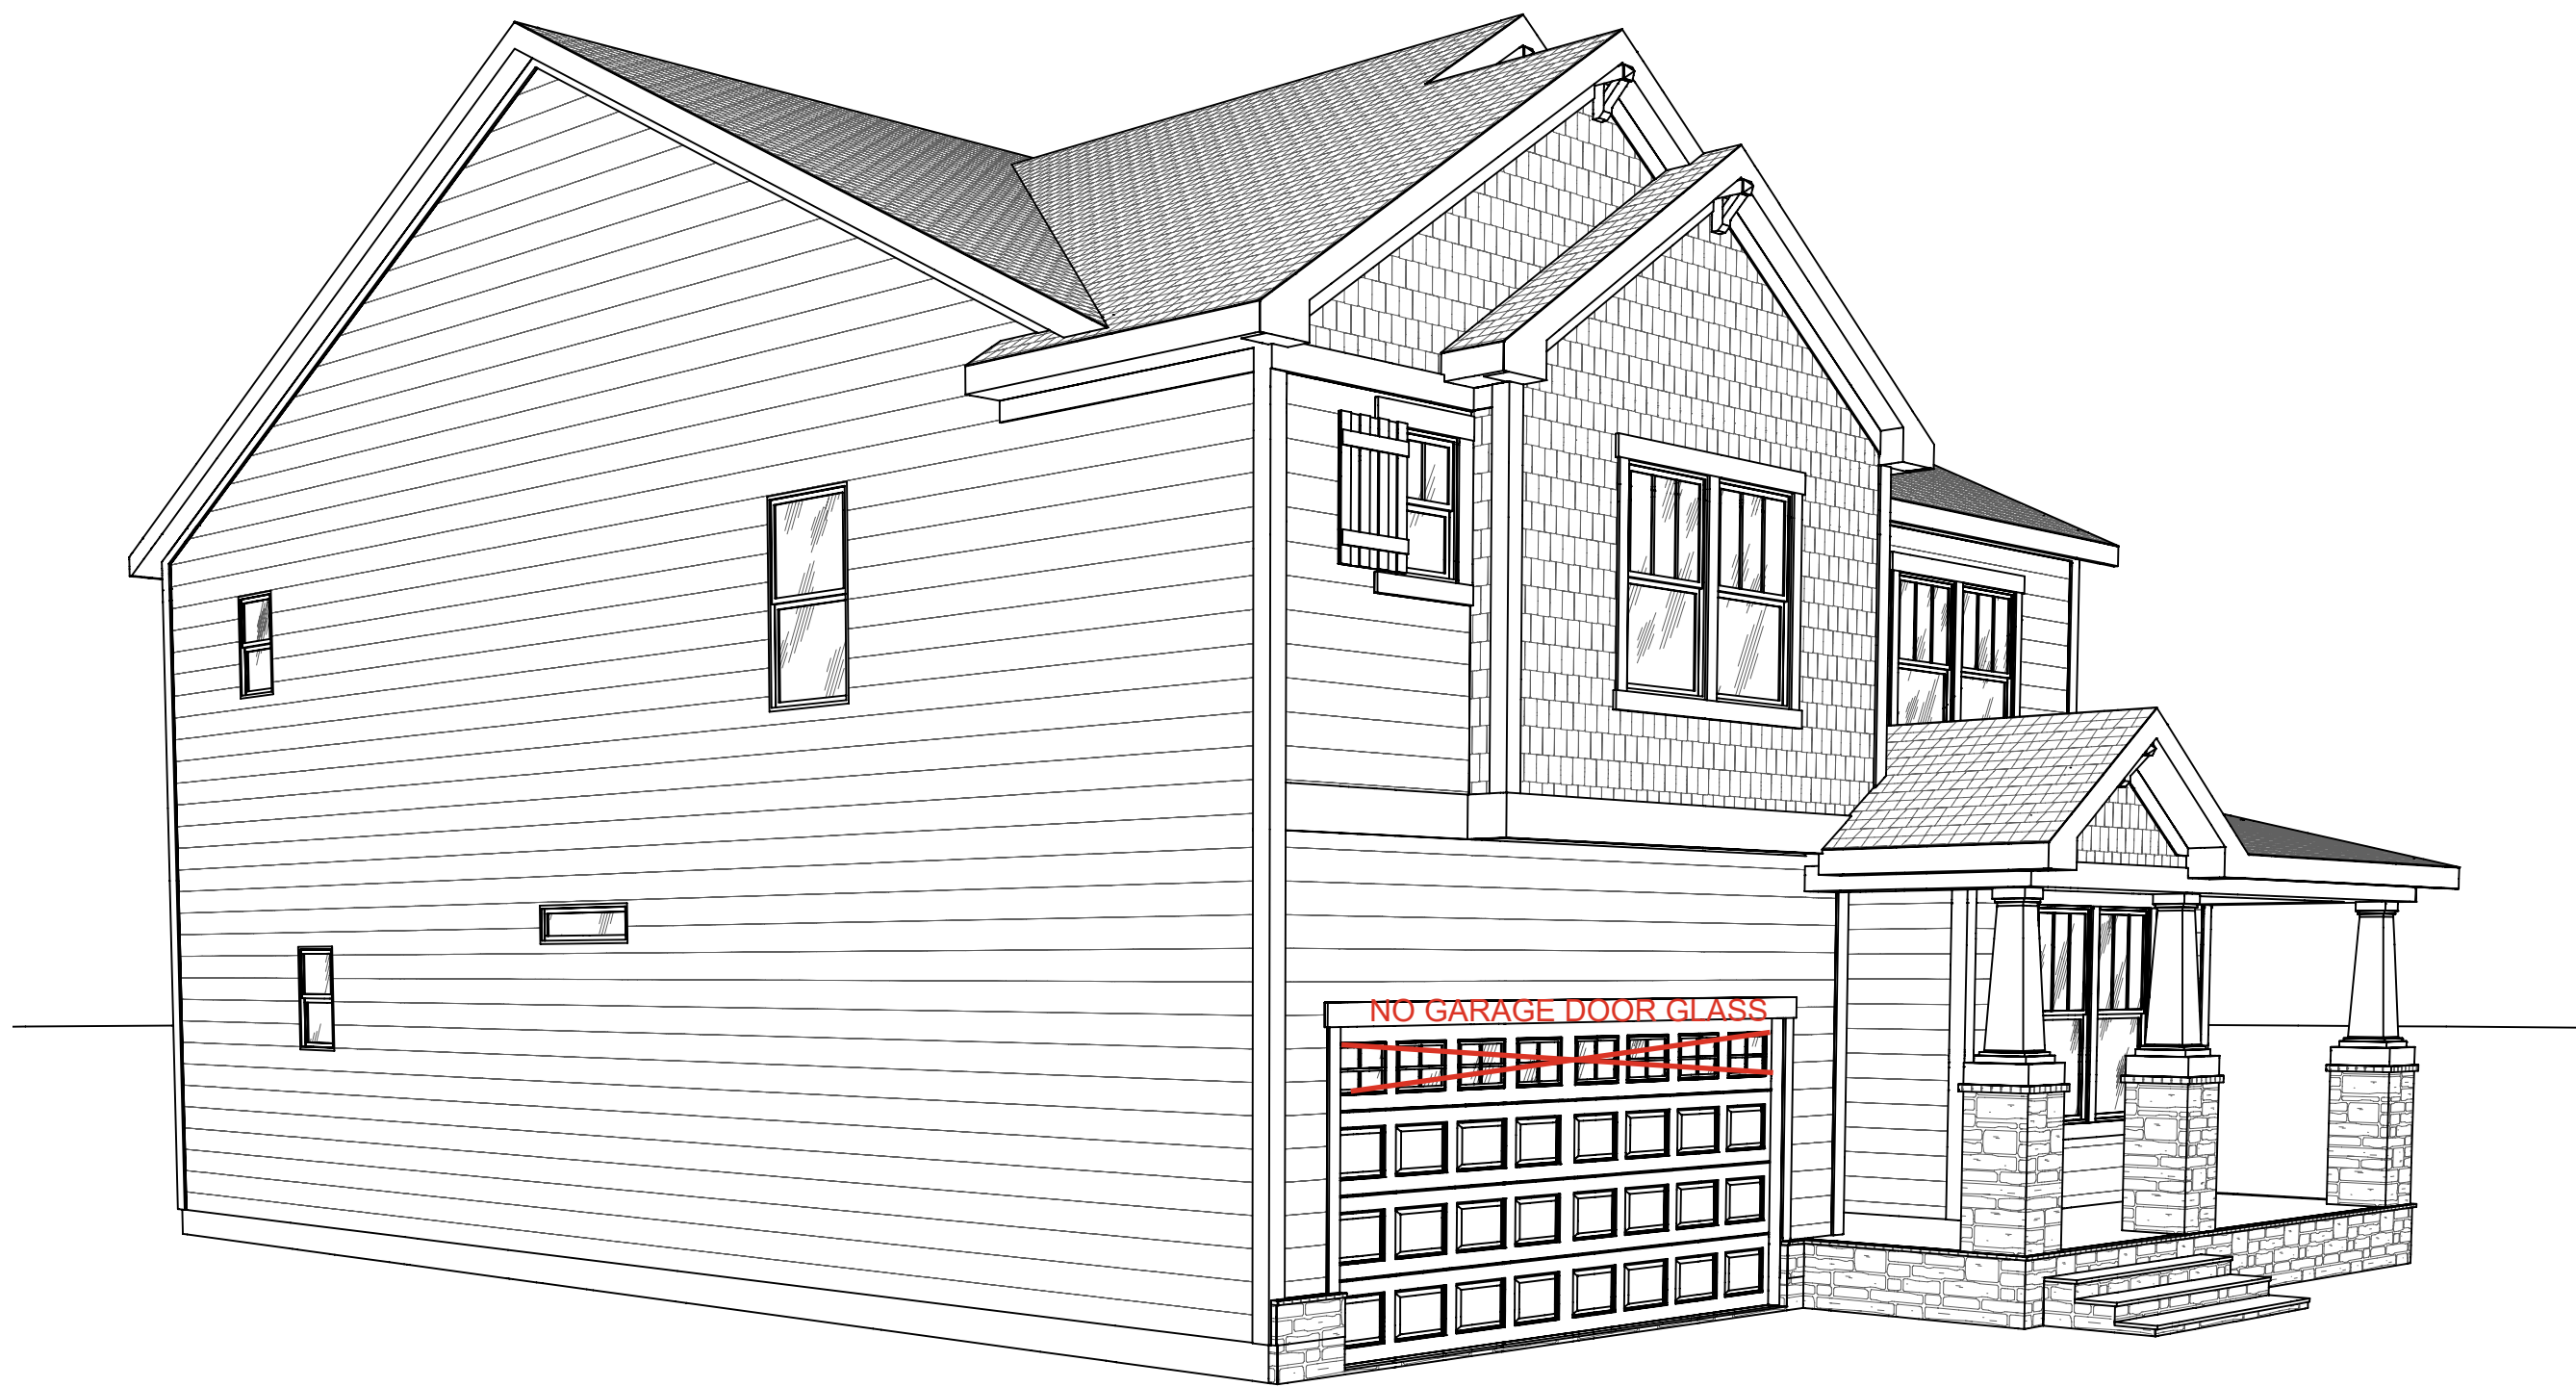


1 Front Left
NTS



1 Front Right
NTS



1 Back Left
NTS

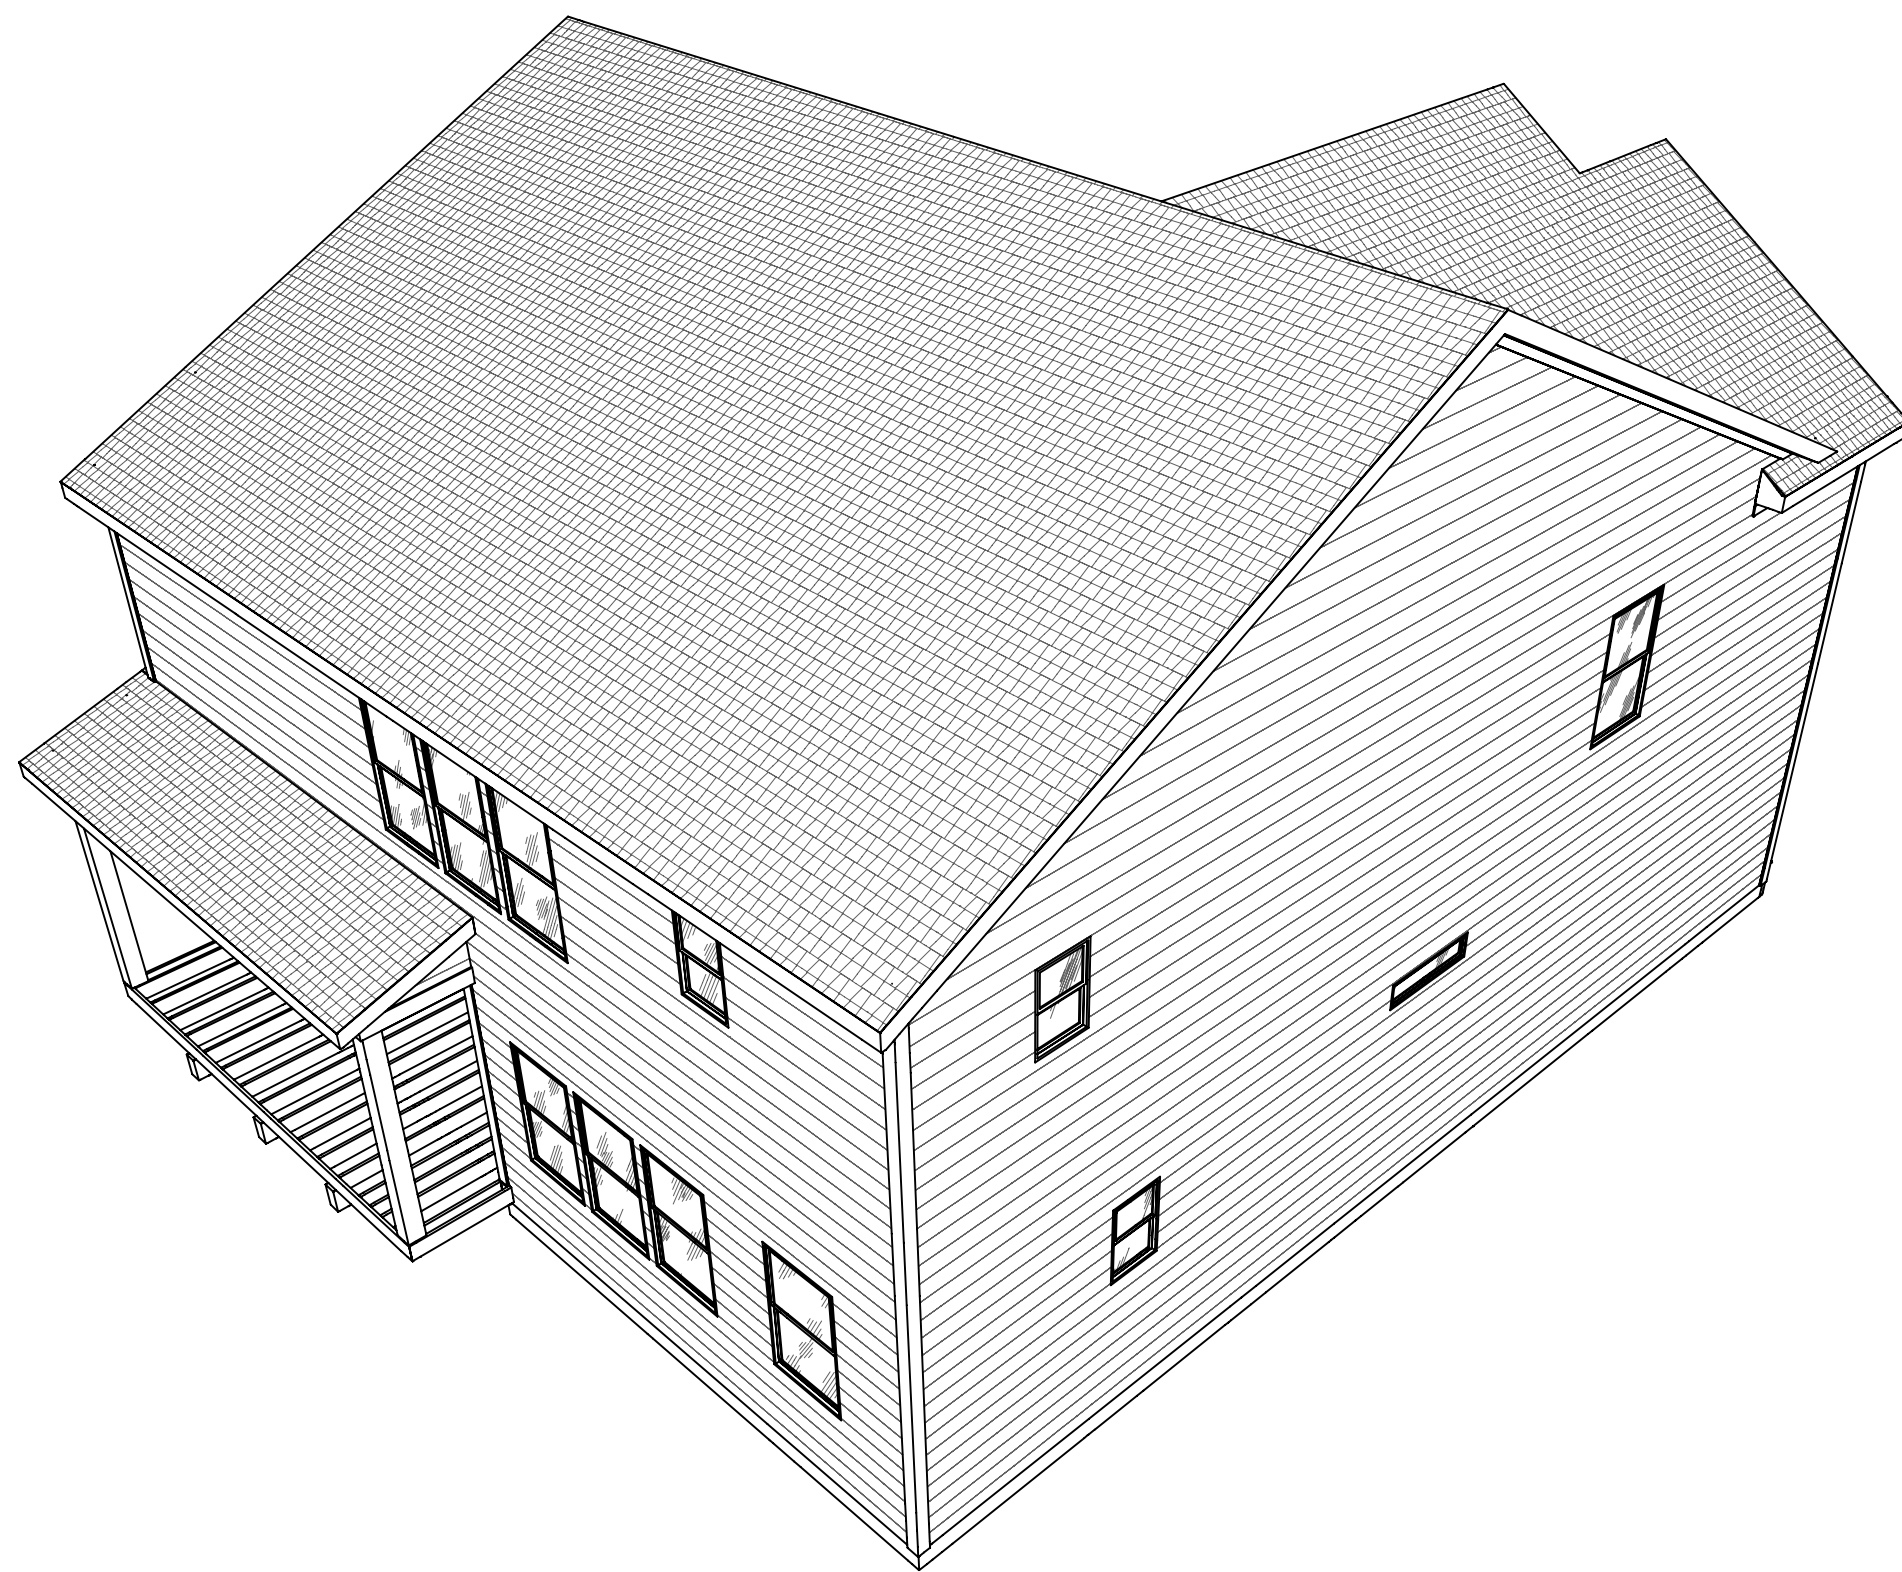

1 Back Right
NTS

REV.#	DESCRIPTION		DATE	
	1	2	3	4
1				
2				
3				
4				
5				
6				
7				
8				

The Selma Craftsman at {{ CommunityName }}

Perspectives

DRAWN BY:

JJ

HANDING:


RIGHT

ISSUE DATE:

11/11/1111

SHEET


P-100

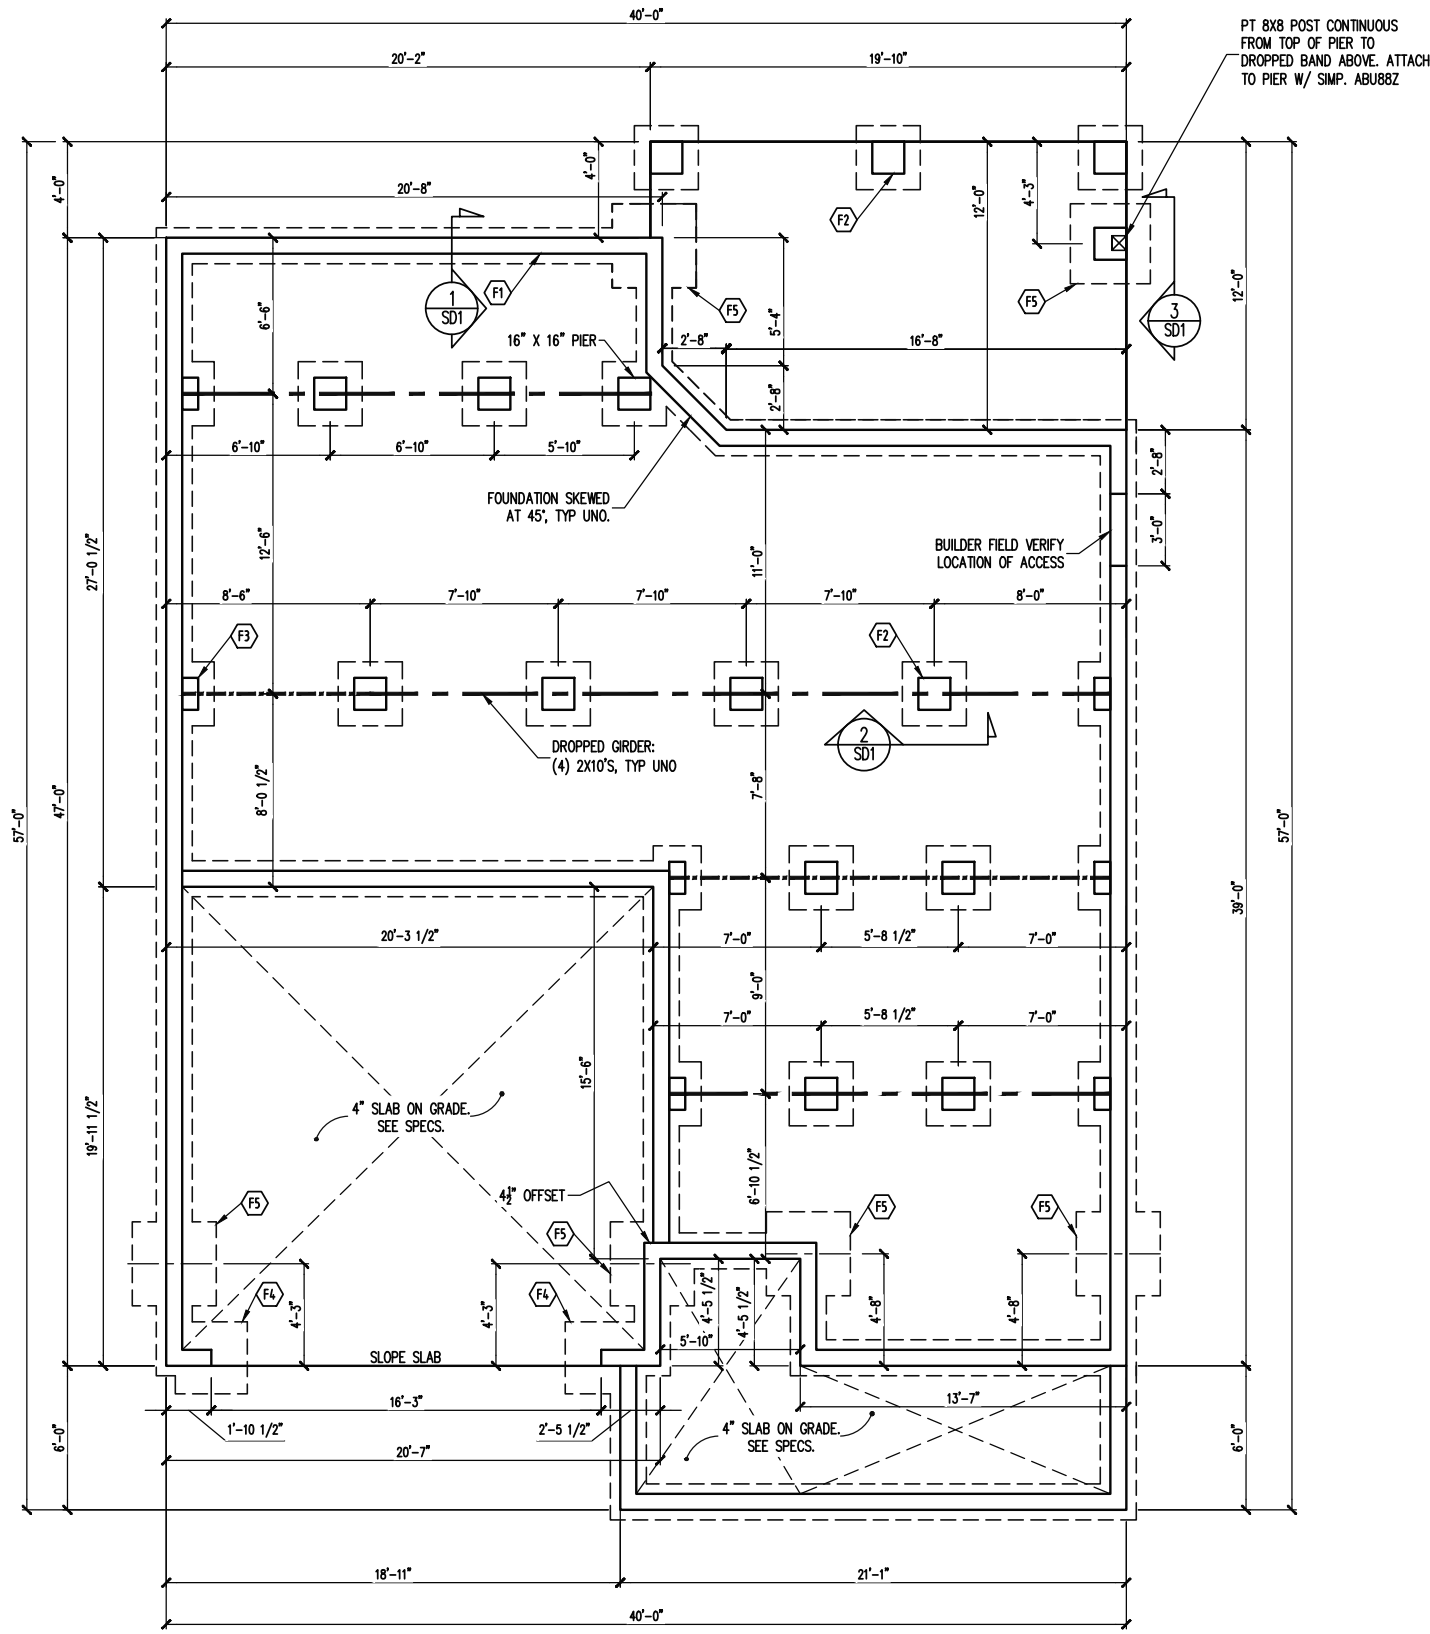

FOUNDATION SCHEDULE		
F1	8" THK MASONRY FND WALL ON A 18" X 8" THK CONT POUR CONC FTG, TYP UNO.	
	OPTION: (2) INTEGRATED 4" MASONRY WYTHES	
F2	16" SQ. MASONRY PIER ON A 32" SQ. X 10" THK CONC FTG TYP UNO.	
F3	8" X 16" CMU PILASTER, PROJECT FTG 8" X 8" THK, TYP UNO	
F4	ENLARGE FOOTING TO 36" SQ. X 12" THK. SOLID MASONRY ABOVE.	
F5	ENLARGE FOOTING TO 42" SQ. X 12" THK. SOLID MASONRY ABOVE.	
NOTES: -HEIGHT AND BACKFILL LIMITATIONS FOR FOUNDATION WALLS ARE TO BE GOVERNED BY THE NCSBC, LATEST EDITION. REINFORCEMENT AND GROUTING SHALL BE DETERMINED BY FINAL SITE CONDITIONS. -BUILDER TO FIELD LOCATE CRAWLSPACE ACCESS OPENING WITH MINIMUM DIMENSIONS OF 18X24. DO NOT LOCATE ACCESS OPENING BELOW POINT LOADS FROM ABOVE WITHOUT ENGINEER APPROVAL.		

FOUNDATION PLAN
1/8" = 1'-0"

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Tech

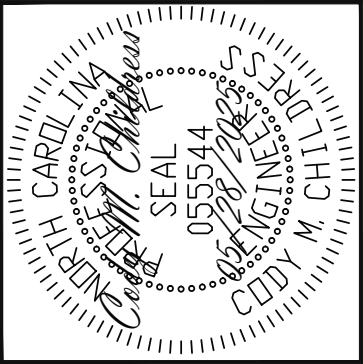ASSOCIATES, P.A.

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Raleigh, North Carolina 27609
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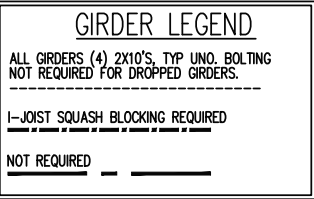
NEW HOME INC			
STRUCTURAL ADDENDUM			
SCOPE	REV #	REF PROJ #	DATE
LOC: 42 DUNCANS CREEK			

ENG: CMC/ZCH
DATE: 5/28/2025


GARNER
CRAFTSMAN


PROJECT NO.
25-65-176

SHEET NO.
S1
1 of 8



NORTH CAROLINA
SEAL OF THE STATE ENGINEER
055544
05/28/2023

		STRUCTURAL ENGINEERS License No. C-3870 318 W Millbrook Rd. Unit 201 Raleigh, North Carolina 27609 Phone (919) 844-1661 ASSOCIATES, P.A.																
NEW HOME INC.																		
SCOPE:		STRUCTURAL ADDENDUM																
LOC:		42 DUNCANS CREEK	<table border="1" style="width: 100%; border-collapse: collapse;"> <thead> <tr> <th style="width: 50%;">REV #</th> <th style="width: 50%;">REF PROJ #</th> <th style="width: 50%;">DATE</th> </tr> </thead> <tbody> <tr><td> </td><td> </td><td> </td></tr> <tr><td> </td><td> </td><td> </td></tr> <tr><td> </td><td> </td><td> </td></tr> <tr><td> </td><td> </td><td> </td></tr> </tbody> </table>	REV #	REF PROJ #	DATE												
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ENG: CMC/ZCH		DATE: 5/28/2025																
GARNER		CRAFTSMAN																
PROJECT NO.																		
25-65-176																		
SHEET NO.																		
S2																		
2 of 8																		

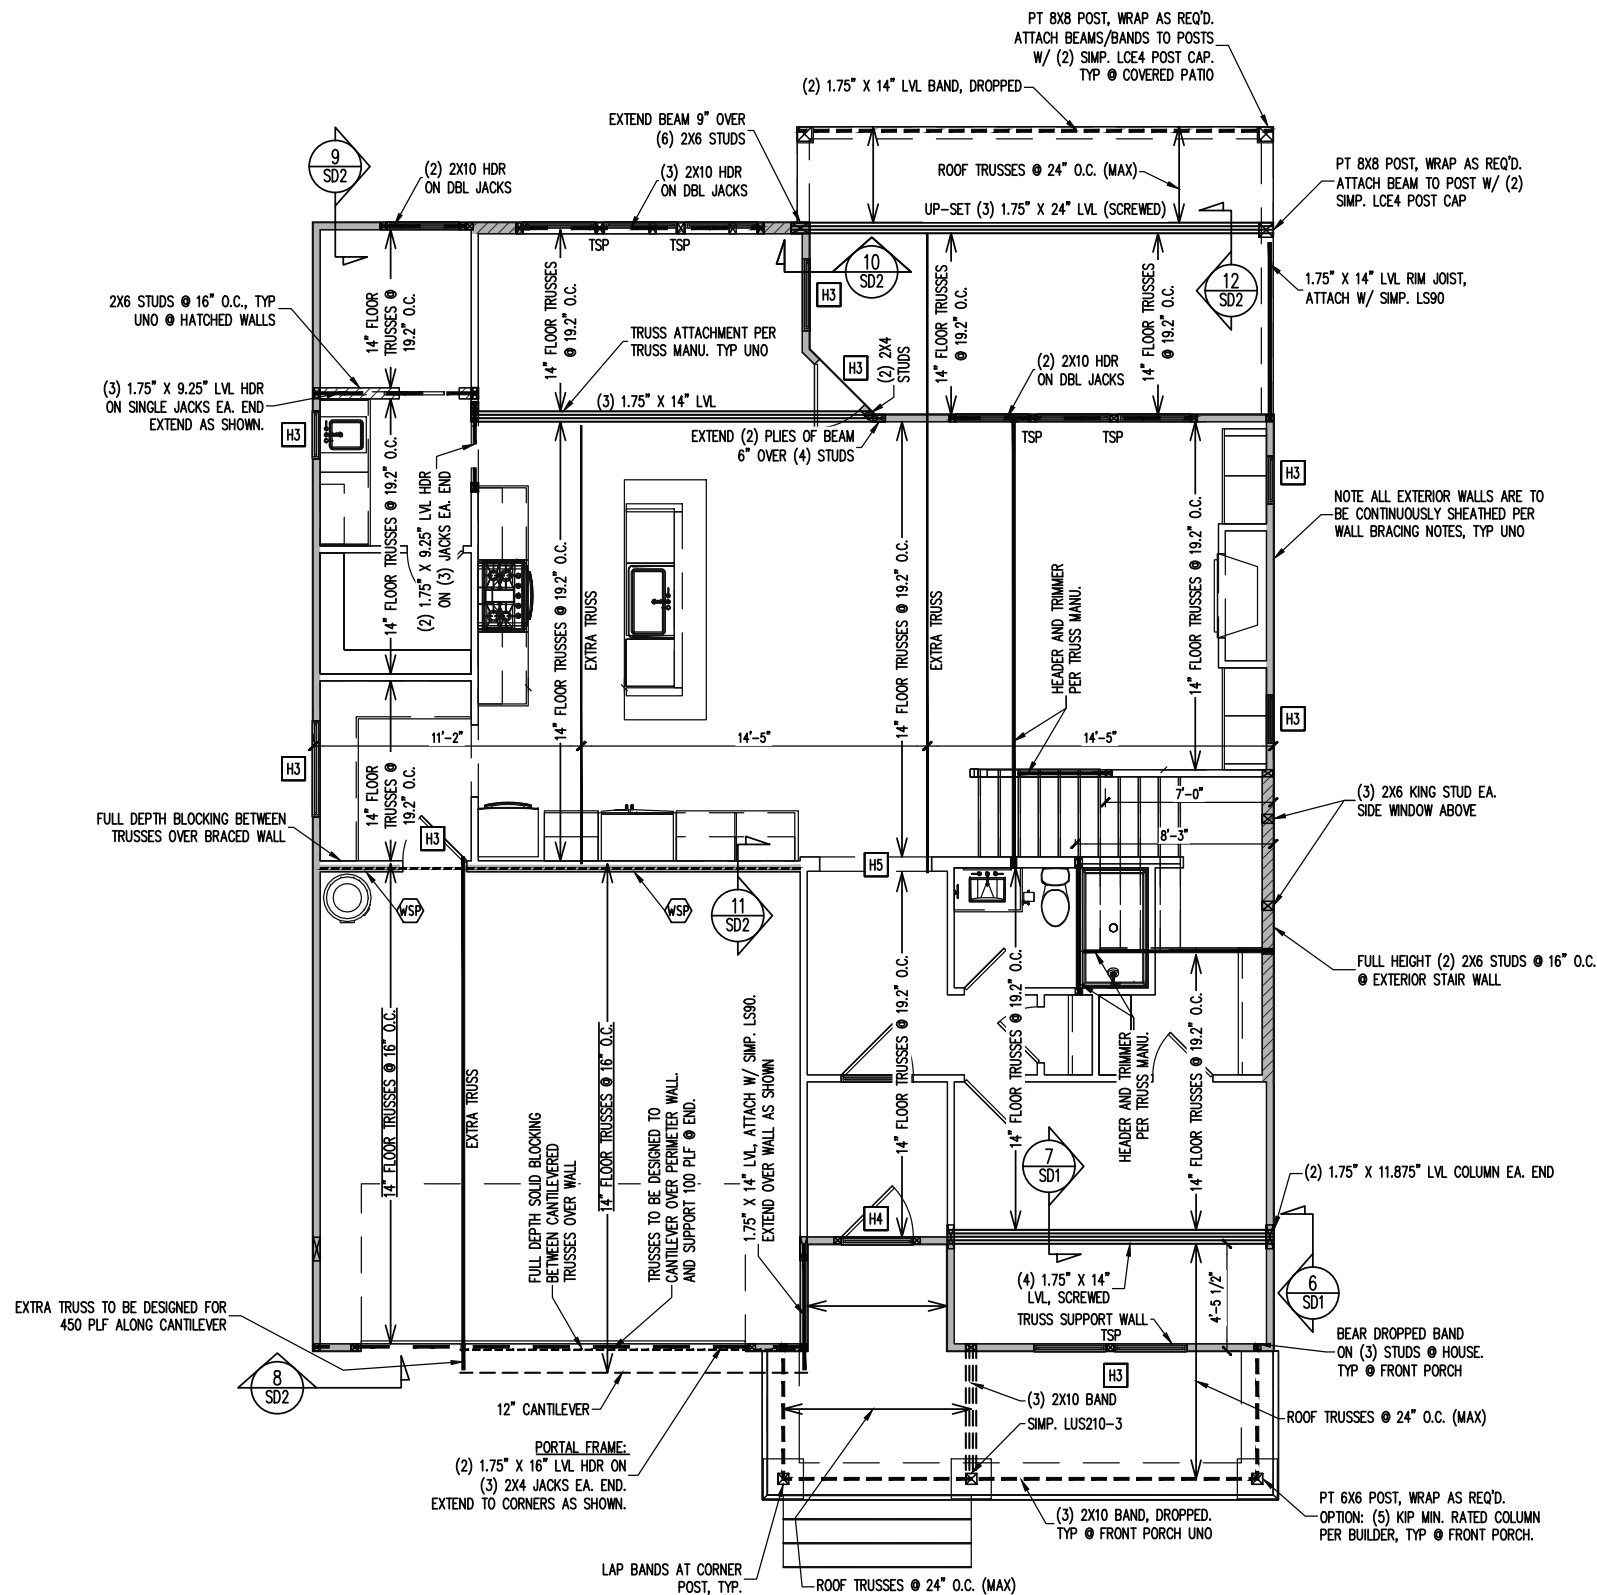

CONSTRUCTION SPECIFICATIONS
INSTANT REFERENCES

REFER TO THE CONSTRUCTION SPECIFICATIONS SECTIONS FOR THE FOLLOWING INFORMATION:

PART 1.01: CURRENT GOVERNING CODE

PART 14: STUD SUPPORT FOR BEAMS

PART 17: KING STUDS FOR EXTERIOR WALLS

SEE DETAIL / CONSTRUCTION SPECIFICATIONS SHEETS FOR I-JOISTS ALLOWABLE SUBSTITUTIONS

WALL BRACING

SHADED WALLS:

ALL EXTERIOR STUD WALLS, EXTERIOR SIDE, ARE TO BE CONTINUOUSLY SHEATHED WITH 7/16 APA RATED OSB NAILED TO STUDS WITH 8d NAILS @ 6" O.C. AT PANEL EDGES, 12" O.C. IN PANEL FIELD.

WSP - ONE SIDE OF INTERIOR WALL OR INSIDE OF EXTERIOR WALL WITH 3/8" MIN. THICKNESS WOOD STRUCTURAL PANELING. ATTACH WSP TO STUD WALL WITH 8d NAILS @ 6" O.C. AT PANEL EDGES, 12" O.C. IN PANEL FIELD.

NOTES:
PROVIDED CONTINUOUS SHEATHING = 180" MIN.

REFERENCE PART 16.02 OF CONSTRUCTION SPECIFICATIONS FOR GENERAL WIND BRACING INFORMATION.

HEADER SCHEDULE

H1 SINGLE 2X4 TURNED FLAT (A)

H2 (2) 2X4'S ON SINGLE JACKS (B)

H3 (2) 2X10'S ON SINGLE JACKS (C)

H4 (2) 1.75" X 9.25" LVL'S ON DBL JACKS

H5 (3) 2X10'S ON SINGLE JACKS

(A) TYPICAL FOR INTERIOR NON LOAD BEARING WALLS ONLY, ROUGH OPENING 38" MAX.


(B) TYPICAL FOR INTERIOR NON LOAD BEARING WALLS ONLY, ROUGH OPNG 38" TO 74" MAX.

(C) TYPICAL FOR ALL CONDITIONS NOT LISTED IN (A) OR (B) UNO.

NOTES:
-HEADERS IN NON LOAD BEARING INTERIOR WALLS ARE NOT LABELED.

1ST FLOOR FRAMING PLAN
WALLS AND CEILING 1/8" = 1'-0"

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Phone (919) 844-1661

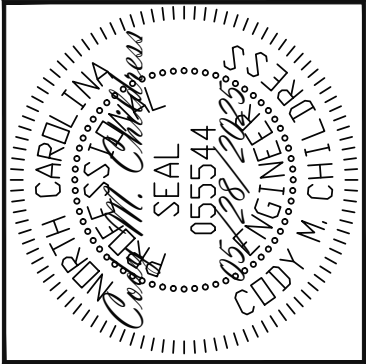NEW HOME INC.
STRUCTURAL ADDENDUM

SCOPE: 42 DUNCANS CREEK

LOC: 42 DUNCANS CREEK


ENG: CMC/ZCH
DATE: 5/28/2025

GARNER CRAFTSMAN

PROJECT NO. 25-65-176

SHEET NO. S3

3 of 8

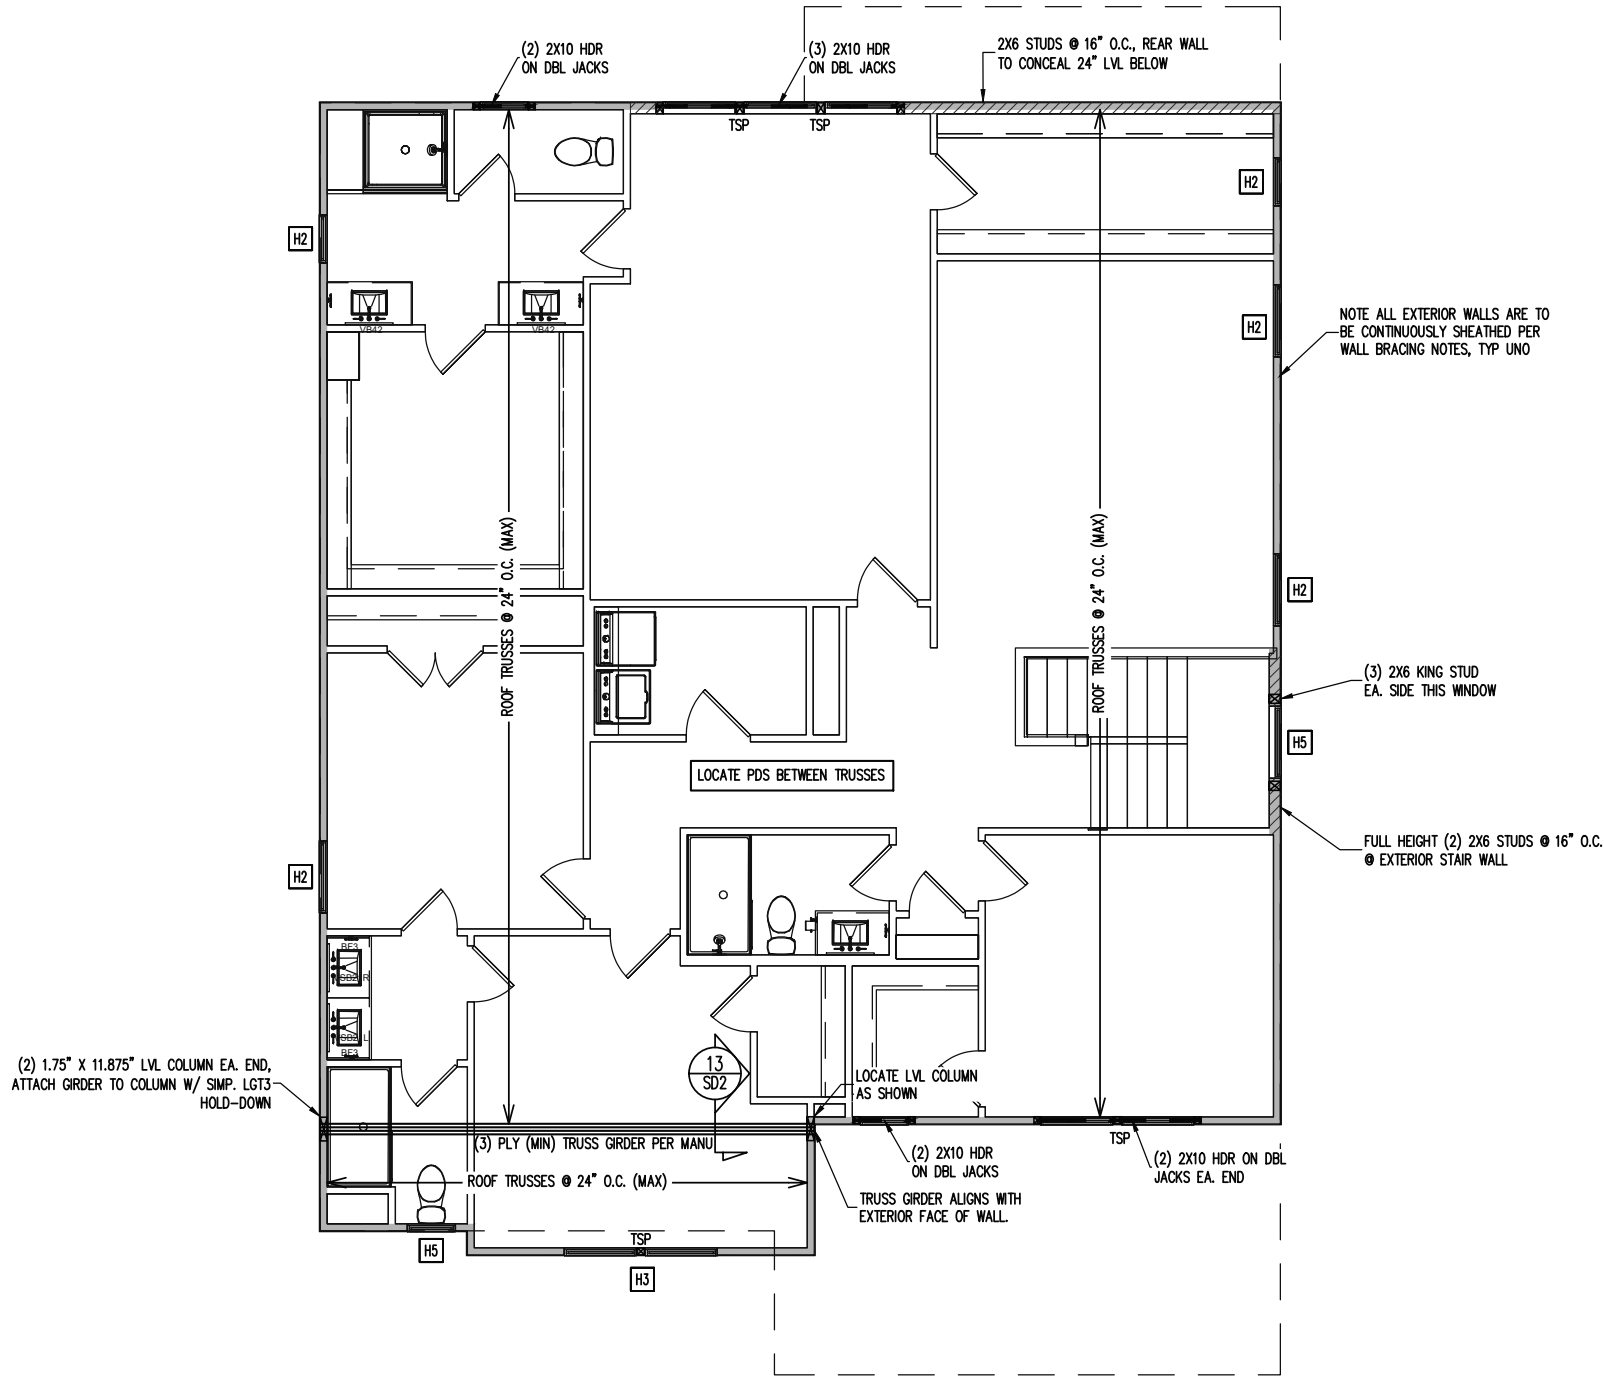

CONSTRUCTION SPECIFICATIONS
INSTANT REFERENCES

REFER TO THE CONSTRUCTION SPECIFICATIONS SECTIONS FOR THE FOLLOWING INFORMATION:

PART 1.01: CURRENT GOVERNING CODE

PART 14: STUD SUPPORT FOR BEAMS

PART 17: KING STUDS FOR EXTERIOR WALLS

SEE DETAIL / CONSTRUCTION SPECIFICATIONS SHEETS FOR I-JOISTS ALLOWABLE SUBSTITUTIONS

WALL BRACING

SHADED WALLS:

ALL EXTERIOR STUD WALLS, EXTERIOR SIDE, ARE TO BE CONTINUOUSLY SHEATHED WITH 7/16 APA RATED OSB NAILED TO STUDS WITH 8d NAILS @ 6" O.C. AT PANEL EDGES, 12" O.C. IN PANEL FIELD.

NOTES:
PROVIDED CONTINUOUS SHEATHING = 176" MIN.

REFERENCE PART 16.02 OF CONSTRUCTION SPECIFICATIONS FOR GENERAL WIND BRACING INFORMATION.

HEADER SCHEDULE


H1 SINGLE 2X4 TURNED FLAT (A)
H2 (2) 2X4'S ON SINGLE JACKS (B)
H3 (2) 2X10'S ON SINGLE JACKS (C)
H4 (2) 1.75" X 9.25" LVL'S ON DBL JACKS
H5 (3) 2X10'S ON SINGLE JACKS

(A) TYPICAL FOR INTERIOR NON LOAD BEARING WALLS ONLY, ROUGH OPENING 38" MAX.
(B) TYPICAL FOR INTERIOR NON LOAD BEARING WALLS ONLY, ROUGH OPNG 38" TO 74" MAX.
(C) TYPICAL FOR ALL CONDITIONS NOT LISTED IN (A) OR (B) UNO.

NOTES:
-HEADERS IN NON LOAD BEARING INTERIOR WALLS ARE NOT LABELED.

2ND FLOOR FRAMING PLAN
WALLS AND CEILING 1/8" = 1'-0"


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Phone (919) 844-1661

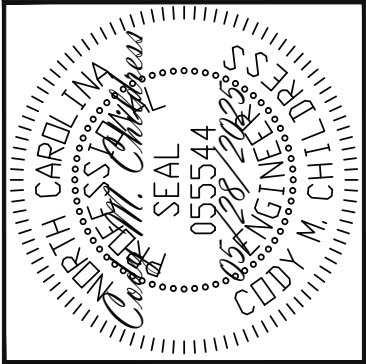NEW HOME INC.	STRUCTURAL ADDENDUM	REV #	REF PROJ #	DATE
SCOPE	LOC	42 DUNCANS CREEK		
ENG: CMC/ZCH	DATE: 5/28/2025	GARNER CRAFTSMAN		
PROJECT NO. 25-65-176		SHEET NO. S4		
		4 of 8		



FRAMING SCHEDULE

ROOF ONLY

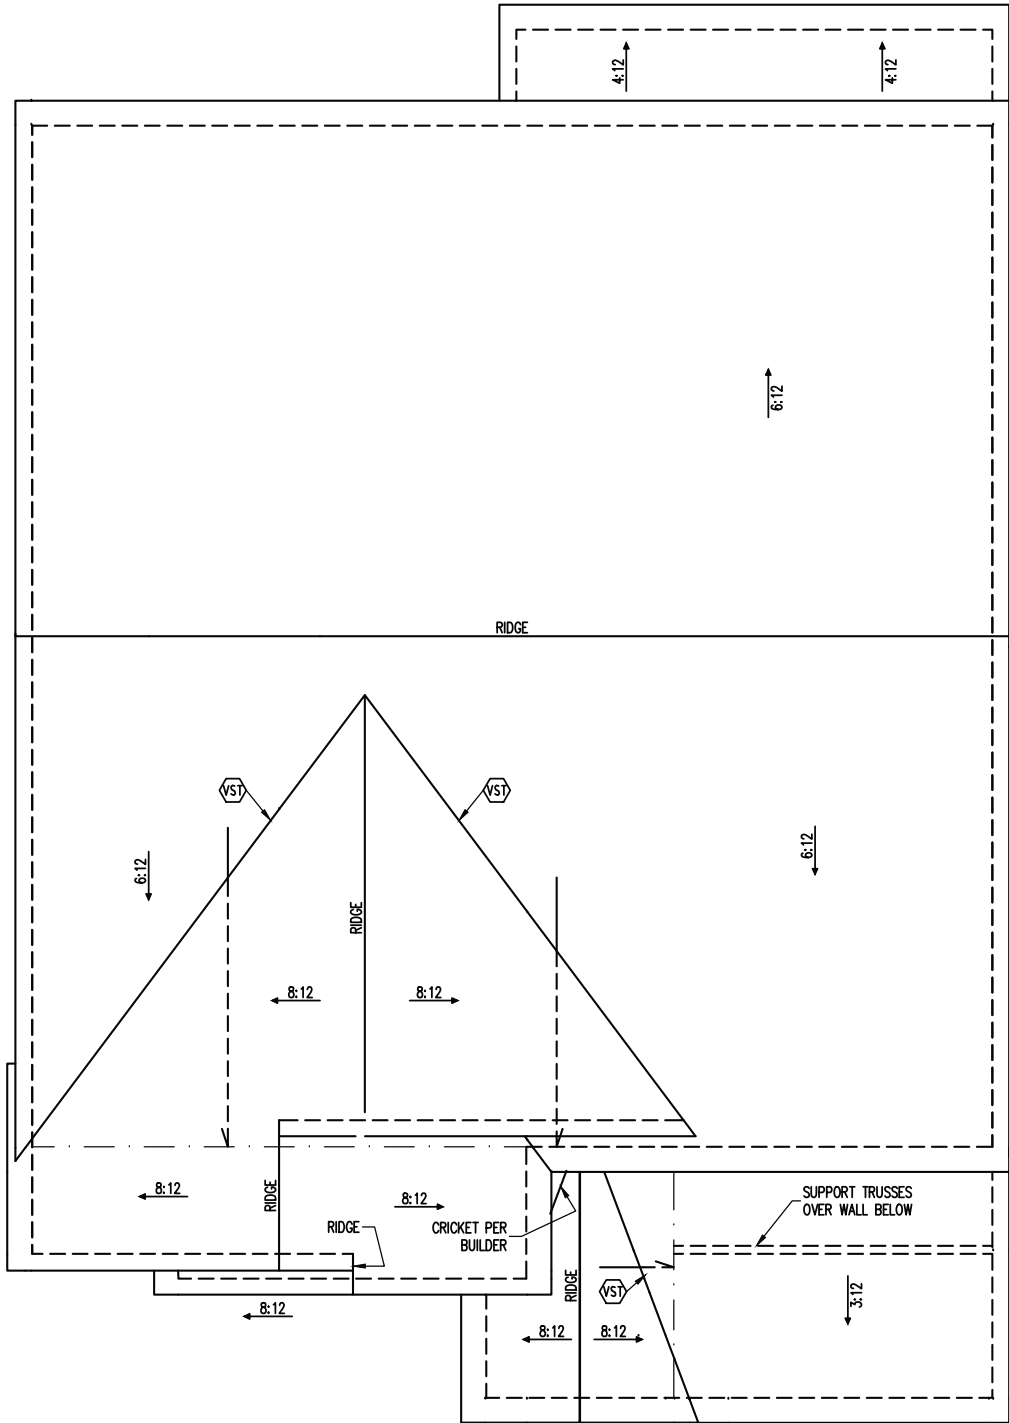VST VALLEY SET TRUSSES PER MANU

FRAMING NOTES

ROOF ONLY

-ROOF TRUSSES PER MANU. TYPICAL U.N.O.

-VERIFY ALL HEEL HEIGHTS, ROOF PITCHES, AND ARCHITECTURAL OVERHANGS PRIOR TO CONSTRUCTION

TRUSS UPLIFT CONNECTORS

EXPOSURE B, 120 MPH, ANY PITCH

24" O.C. MAX ROOF TRUSS SPACING

TRUSSES SHALL BE ATTACHED TO SUPPORT WALL FOR UPLIFT RESISTANCE. CONTINUOUS OSB WALL SHEATHING BELOW PROVIDES CONTINUOUS UPLIFT RESISTANCE TO FOUNDATION. ALL TRUSSES SUPPORTED BY INTERMEDIATE SUPPORT WALLS, KNEEWALLS OR BEAMS SHALL BE ATTACHED TO SUPPORTING MEMBER PER SCHEDULE BELOW.

ROOF SPAN UP TO 18'

CONNECTOR NAILING PER TABLE 602.3(1) NCRBC 2018 EDITION


OVER 18'

(1) SIMPSON H2.5A HURRICANE CLIP TO DBL TOP PLATE OR BEAM

ROOF FRAMING PLAN

1/8" = 1'-0"

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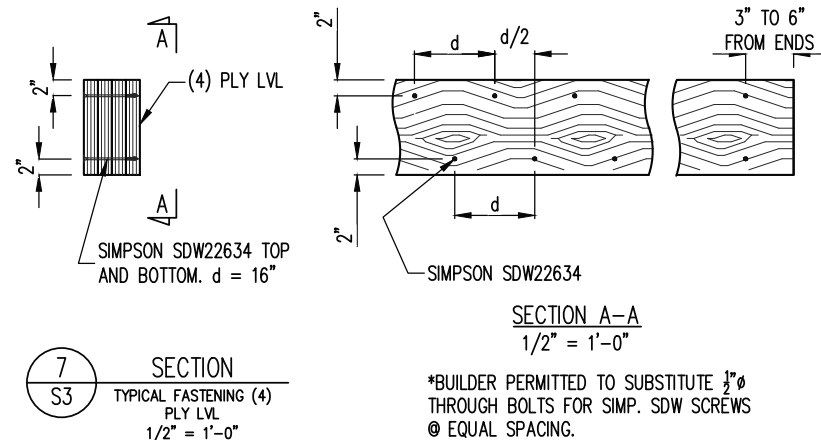
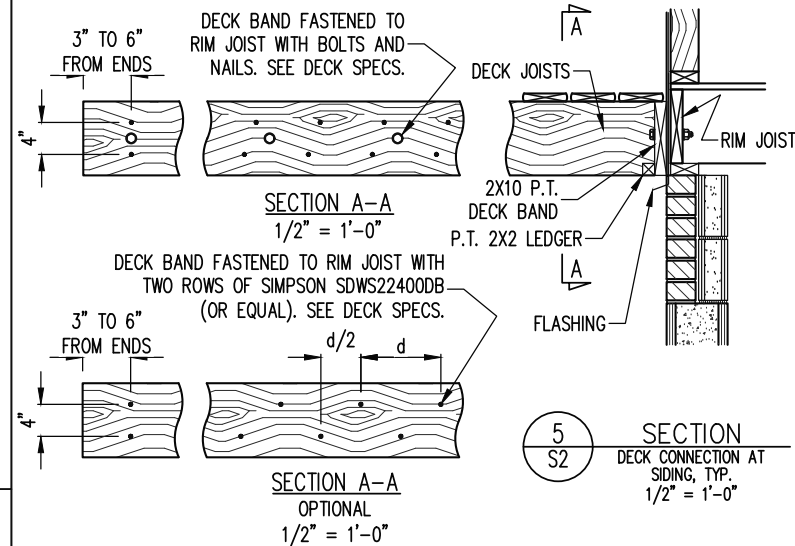
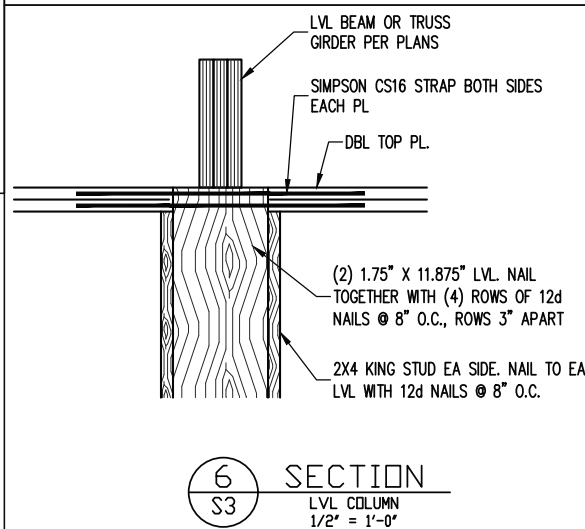
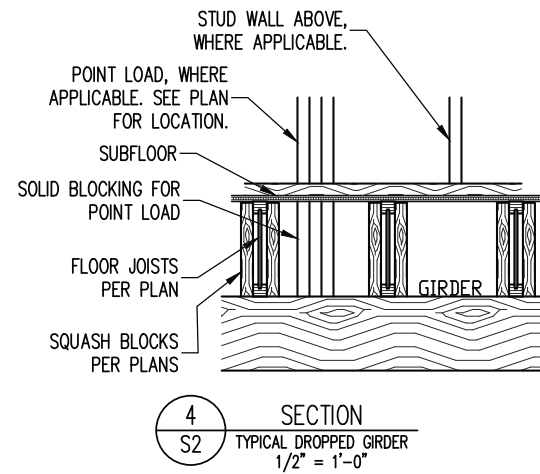
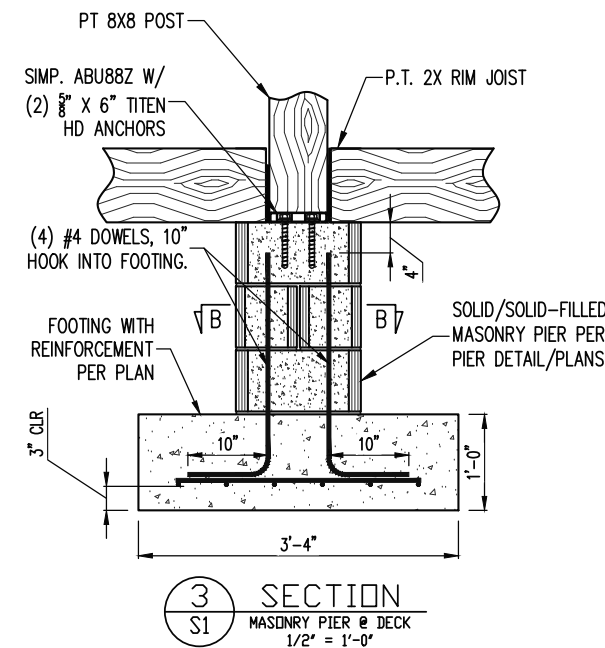
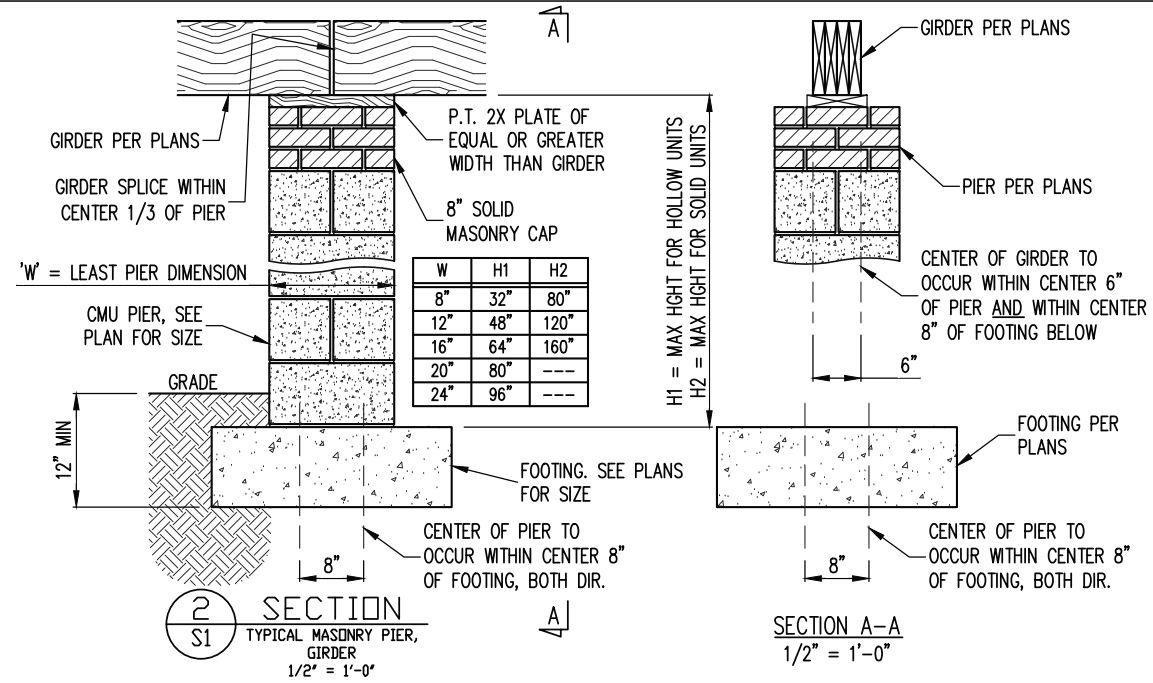
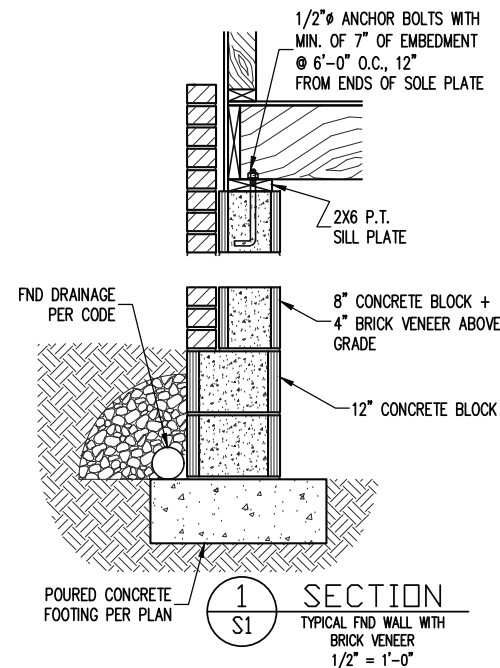
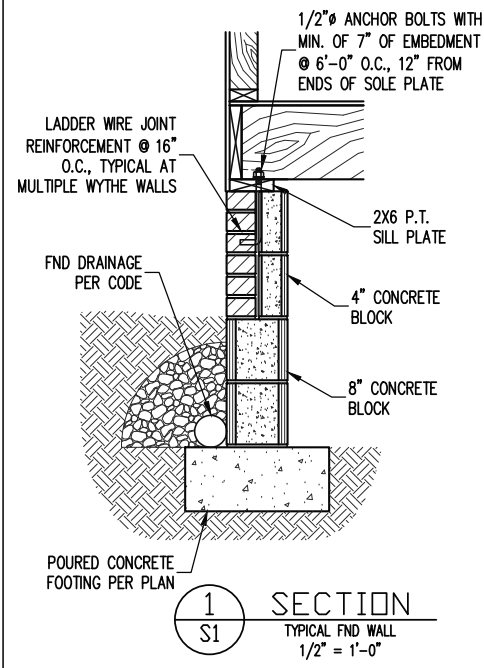
NEW HOME INC.			
STRUCTURAL ADDENDUM			
SCOPE	REV #	REF PROJ #	DATE
LOC: 42 DUNCANS CREEK			

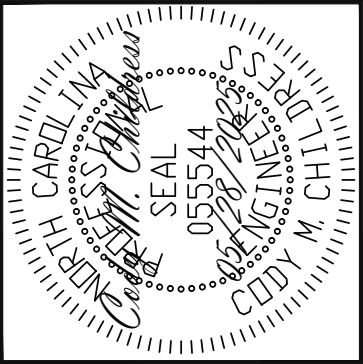ENG: CMC/ZCH
DATE: 5/28/2025


GARNER
CRAFTSMAN

PROJECT NO.
25-65-176

SHEET NO.
S5
5 of 8



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NEW HOME INC.		STRUCTURAL ADDENDUM		REV #	REF PROJ #	DATE
SCOPE	LOC	42 DUNCANS CREEK				

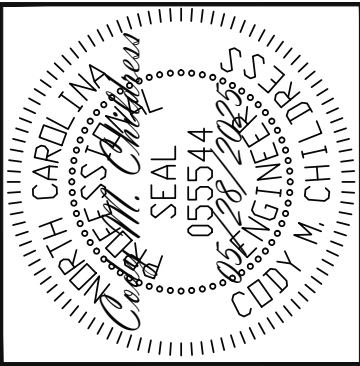ENG: CMC/ZCH
DATE: 5/28/2025

GARNER
CRAFTSMAN

PROJECT NO.
25-65-176

SHEET NO.
SD1
6 of 8

(2) CONT. 2X TOP PLATES, EXTEND EACH END INTO ADJACENT WALL. NAIL SPLICES WITH 8-16d NAILS PER SPLICE/LAP.

CONT. 2X PLATE WITH 10d NAILS AT 16" O.C. INTO HEADER/BEAM

7/16" O.S.B. OR 15/32" PLYWOOD EXTERIOR WALL SHEATHING AT UNSHADED AREAS (BEAM, INFILL WALL ABOVE BEAM, AND CENTER WALL). NAIL SHEATHING TO ALL SUPPORTS (STUDS, PLATES, BLOCKING, ETC.) WITH 8d NAILS AT 6" O.C. AT SHEET EDGES AND 12" O.C. IN THE FIELD.

WHERE FULL HEIGHT PANEL WIDTH EXCEEDS 16", PROVIDE ADDITIONAL STUDS AT 16" O.C. NAIL SHEATHING TO ALL STUDS WITH 8d NAILS AT 3" O.C.

FOR A PANEL SPLICE (IF NEEDED), PANEL EDGES SHALL OCCUR OVER AND BE NAILED TO COMMON BLOCKING AND OCCUR WITHIN MIDDLE 24" OF WALL HEIGHT. ONE ROW OF 3" O.C. NAILING IS REQUIRED IN EACH PANEL EDGE.

7/16" O.S.B. OR 15/32" PLYWOOD EXTERIOR WALL SHEATHING. AT SHADED AREAS NAIL SHEATHING TO ALL SUPPORTS (STUDS, PLATES, BLOCKING, ETC.) WITH 8d NAILS AT 3" O.C.

(2)2x STUD MIN. AT START AND END OF WALL SEGMENTS EACH SIDE OF OPENING. SEE PLANS FOR ADDITIONAL STUDS

2x4 P.T. PLATE WITH TWO 1/2" DIA x 7" EMBED ANCHOR BOLTS WITH A 3/16"x2"x2" PLATE WASHERS OR ADDITIONAL HOLDOWN PER PLANS. OPTION: (2) 5/8" DIA. THREADED RODS INSTALLED PER SECTION R602.10.4.3 OF THE NCRBC, LATEST EDITION.

MINIMUM 3"x11 1/4" CONTINUOUS BEAM FULL LENGTH OF FRAME, SEE PLANS FOR SIZE

NAIL THE SHEATHING IN SHADED AREA TO BEAM WITH 8d NAILS AT 3" O.C. EACH WAY

(2) ROWS 16d NAILS AT 3" O.C.

(2) SIMPSON CS16 x 48" LONG COIL STRAPS WITH 10d NAILS EACH HOLE ON INSIDE FACE OF WALL

8 SECTION
S3 PORTAL FRAME WALL
1/2" = 1'-0"

CONCRETE OR MASONRY FND WALL. MASONRY FND WALLS LESS THAN 48" WIDE SHALL BE REINFORCED PER SECTION R602.10.4.3 OF THE NCRBC, LATEST EDITION.

2X6 BLOCKING BETWEEN TRUSSES. ATTACH TO DBL TOP PLATE WITH 8d TOENAILS @ 6" O.C. ALONG BRACED WALL PANEL. TOENAIL BLOCKING TO TRUSS WITH (2) 8d NAILS, B.E.

CONTINUOUS ROOF SHEATHING

ENGINEERED ROOF TRUSS. SEE ARCHITECTURAL PLANS FOR OVERHANG DETAILS.

CONTINUOUS SHEATHING ATTACHED PER WALL BRACING NOTES.

BRACED WALL PANEL

(3) 16d NAILS @ 16" O.C. ALONG BRACED WALL PANEL

8d @ 6" O.C. ALONG BRACED WALL PANEL

9 SECTION
S3 TYPICAL BRACED WALL PANEL CONNECTION
1/2" = 1'-0"

SEE FOUNDATION DETAIL FOR ANCHORAGE

2" 1'-0" 2" LVL PER PLANS 2" 1'-0" 2" d d/2 3" TO 6" FROM ENDS

SIMPSON SCREWS PER TABLE TOP, BOTTOM AND CENTER. d = 16"

SECTION A-A
1/2" = 1'-0"

SCREW MODEL #	PER #	OF LVL PLIES
(2) PLY	SDW22338	
(3) PLY	SDW22500	
(4) PLY	SDW22634	

*BUILDER PERMITTED TO SUBSTITUTE 3/8" THROUGH BOLTS FOR SIMP. SDW SCREWS @ EQUAL SPACING.

12 SECTION
S3 TYPICAL FASTENING OF MULTI-PLY 24" LVL
1/2" = 1'-0"

LVL BEAM OR TRUSS GIRDER PER PLANS

(2) SIMPSON CS16 STRAPS

1'-0" MIN

DBL TOP PLATE

2X KING STUD. NAIL TO EA. LVL PLY WITH 12d NAILS @ 8" O.C.

(2) 1.75" X 11.875" LVL. NAIL TOGETHER WITH (4) ROWS OF 12d NAILS @ 8" O.C., ROWS 3" APART

SECTION A-A
1/2" = 1'-0"

LVL BEAM OR TRUSS GIRDER PER PLANS

DBL TOP PLATE

SIMP. DTT12 W/ 3/8" DIA X 5" LAG SCREW

2X KING STUD. NAIL TO LVL W/ 12d NAILS @ 8" O.C.

BOTTOM PLATE

2X4 RIBBON

DBL TOP PLATE

UP-SET LVL BEAM PER PLANS

FLOOR TRUSSES AND HANGERS PER TRUSS MANU.

10 SECTION
S3 UPSET LVL BEAM
1/2" = 1'-0"

BEAM EXTENTS

2X4 RIBBON

UP-SET LVL BEAM PER PLANS

FLOOR TRUSSES AND HANGERS PER TRUSS MANU.

SECTION A-A
1/2" = 1'-0"

ADDITIONAL FRAMING MEMBER DIRECTLY ABOVE BRACED WALL PANEL OR FULL HEIGHT BLOCKING CONT. ALONG BRACED WALL PANEL

JOIST PER PLAN

8d NAILS @ 6" O.C. ALONG BRACED WALL PANEL


BRACED WALL PANEL

(3) 16d NAILS @ 16" O.C. ALONG BRACED WALL PANEL

ADDITIONAL FRAMING MEMBER DIRECTLY BELOW BRACED WALL PANEL OR FULL HEIGHT BLOCKING CONT ALONG BRACED WALL PANEL

11 SECTION
S3 TYPICAL BRACED WALL PANEL CONNECTION AT INTERIOR WALL, JOISTS PERPENDICULAR OR PARALLEL
1/2" = 1'-0"

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Engineering Tech Associates, P.A.
STRUCTURAL ENGINEERS
License No. C-3870
318 W Millbrook Rd. Unit 201
Raleigh, North Carolina 27609
Phone (919) 844-1661

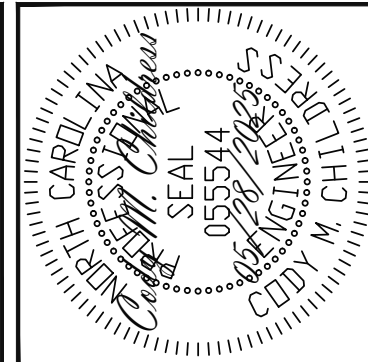SCOPE	NEW HOME INC.		
	STRUCTURAL ADDENDUM		
LOC	REV #	REF PROJ #	DATE
	42 DUNCANS CREEK		

ENG: CMC/ZCH
DATE: 5/28/2025

GARNER
CRAFTSMAN

PROJECT NO.
25-65-176

SHEET NO.
SD2
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