

The Garner Craftsman

Signature Series

Lot: 42 | Duncans Creek 757 Beacon Hill Road Lillington, NC 27546

HEET INDEX		OPTIONS		BUILDING CODES		1ST FLOOR AREA	
Name	Number	OPTION SET	SELECTION	BUILDING	G CODES	p=====================================	
Cover Sheet	G-100	Mudroom Bench	Bench at Mudroom				
General Notes & Specifications Instance	G-110	Elevation	Craftsman				Z
Foundation Plan	A-100	~Foundation Type	Crawlspace				
First Floor Plan	A-110	Rear Addition	Extended Covered Patio				DESCRIPTION
Second Floor Plan	A-120	Family Room Fireplace	Fireplace w/ Built- Ins				
Roof Plan	A-200	-					
Elevations - Front and Back	A-310	· -·					
Elevations - Left and Right	A-320	Kitchen Type	Gourmet Kitchen				
First Floor Electrical Plan	E-110	Messy Kitchen Sink	Messy Kitchen Sink				
Second Floor Electrical Plan	E-120	Messy Kitchen Window	Messy Kitchen Window	BUILDING INFO			(ECV.#
Perspectives	P-100	Mudroom Window	Mudroom Window				
		Optional Oven	Optional Wall Oven				
		Pocket Office Door	Pocket Door	CONDITIONED AREA			
		Secondary Walk-In Closet	Secondary WIC	TOTAL CONDITIONED AREA	3041 SF		
		Hall Bath Shower	Shower at Hall Bath	LEVEL 1	1297 SF		
		~Series	Signature	LEVEL 2	1744 SF		\ \ \ \ \ \ \ \ \ \ \ \ \ \ \ \ \ \ \
		Smart Door Delivery Center	Smart Door Delivery Center			<u> </u>	——————————————————————————————————————
		Family Room Fireplace Windows	Windows			2ND FLOOR AREA	
				UNCONDITIONED AREA			tta
				TOTAL UNCONDITIONED AREA	778 SF		t Ca
				Garage Area Covered Patio Area	406 SF 230 SF		an a
				Front Porch Area	142 SF		sme
					I.		rner Craft
				TOTAL AREA			Ö
				TYPE	TOTAL AREA		The
				TOTAL CONDITIONED AREA	3041 SF		
				TOTAL UNCONDITIONED AREA	778 SF		Drawn Drew [
				TOTAL UNDER ROOF	3,041 SF		HANDIN
							LEF ISSUE DA 11/11/
							G-1
							G-1

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New Home Inc

1611 Jones Franklin, Raleigh, NC, 27606 GENERAL NOTES AND SPECIFICATIONS:

1 GENERAL DATA

PROJECT DESCRIPTION:

THIS PROJECT IS FOR THE CONSTRUCTION OF A NEW SINGLE-FAMILY RESIDENCE, AND ASSOCIATED SITE WORK.

TYPICAL NOTES:

ALL WORK TO BE COORDINATED AND SCHEDULED BY THE OWNER.

ALL WORK, INCLUDING PLUMBING, HVAC AND ELECTRICAL WORK NOT DETAILED HEREIN, SHALL COMPLY WITH APPLICABLE STATE AND LOCAL BUILDING CODES AND THE BUILDING STANDARDS REFERENCED THEREIN.

ALL WORK SHALL CONFORM TO THE HIGHEST LEVELS OF THE APPROPRIATE INDUSTRY STANDARDS FOR CUSTOM WORK.

ALL ITEMS SPECIFIED HEREIN ARE TO BE USED WITHOUT SUBSTITUTION. IF THESE NOTES CONFLICT WITH THE OWNERS SCOPE OF WORK DOCUMENTS, THE NOTES HEREIN SHALL GOVERN AND TAKE PRECEDENT.

THE STRUCTURE IS DESIGNED TO BE SELF-SUPPORTING AND STABLE AFTER THE BUILDING IS FULLY COMPLETE. IT IS SOLELY THE CONTRACTORS RESPONSIBILITY TO ENSURE THE SAFETY OF THE BUILDING AND ITS COMPONENT PARTS DURING ERECTION. THIS INCLUDES THE ADDITION OF TEMPORARY BRACING THAT MAY BE REQUIRED.

IT IS SOLELY THE CONTRACTOR'S RESPONSIBILITY TO FOLLOW ALL APPLICABLE SAFETY CODES AND REGULATIONS DURING ALL PHASES OF CONSTRUCTION.

PLAN DIMENSIONS ARE TO FACE OF ROUGH FRAMING OR MASONRY UNLESS NOTED OTHERWISE. DIMENSIONS TO EXTERIOR WALLS INCLUDE 7/16" OSB WALL SHEATHING WITH WATER-RESISTIVE BARRIER, ROUNDED TO THE NEAREST 1/4".

FINISH FLOOR ELEVATION @ FIRST FLOOR LEVEL IS SET AT 0'-0". SEE SITE PLAN FOR ACTUAL FIRST FLOOR ELEVATION @ EACH BUILDING.

ALL @ INTERIOR PARTITIONS SHALL BE 2x4 STUDS @ 16" O.C. WITH 1/2" DRYWALL EACH SIDE. PLAN DIMENSION IS ASSUMED TO BE 3 1/2" UNLESS NOTED OTHERWISE. PROVIDE SOLID LUMBER BLOCKING FOR ALL WALL MOUNTED ITEMS.

SUBSTRATE (BACKER) FOR TILE IN SHOWERS/TUBS SHALL BE FIBER-CEMENT OR SIMILAR PER APPLICABLE CODE.

ALL INTERIOR COLORS AND FINISHES, NOT SPECIFIED HEREIN, TO BE SELECTED BY THE OWNER.

CONTRACTOR OR EXCAVATOR MUST CONTACT THE APPROPRIATE UTILITIES PROTECTION SERVICE AT LEAST 48 HOURS BUT NO MORE THAN 10 WORKING DAYS BEFORE BEGINNING ANY DIGGING PROJECT.

SOILS BEARING PRESSURE AS INDICATED ON THE STRUCTURAL ENGINEERING PLANS BY OTHER.

3 CONCRETE

REFER TO STRUCTURAL ENGINEERING PLANS BY OTHER.

SEE OWNER SCOPE OF WORK DOCUMENTS FOR ADDITIONAL REQUIREMENTS.

4 MASONRY

STONE /ENEER IF USED) TO BE MANUFACTURED STONE - REFER TO OWNERS SCOPE OF WORK DOCUMENT FOR MATERIAL SELECTION AND COLORS.

BRICK ACCENTS (IF USED) TO BE FULL SIZE UNITS, CUT TO THICKNESS OR SHAPE REQUIRED FOR THE SPECIFIC USE. REFER TO THE OWNERS SCOPE OF WORK DOCUMENT FOR MATERIAL SELECTION AND COLORS.

5 METALS

REFER TO STRUCTURAL ENGINEERING PLANS BY OTHER.

6 WOOD & PLASTICS

PROVIDE SOLID BLOCKING FOR ALL WALL MOUNTED ITEMS INCLUDING:

CABINETS & SHELVES

CLOSET RODS

• MIRRORS AND BATH ACCESSORIES

FRAMING LUMBER IN CONTACT WITH CONCRETE OR MASONRY OR EXPOSED TO THE EXTERIOR SHALL BE PRESERVATIVE PRESSURE TREATED. ANY WOOD, INCLUDING EXTERIOR SHEATHING. WITHIN 6" OF FINISHED GRADE SHALL BE PRESERVATIVE-PRESSURE TREATED.

ANY WOOD, INCLUDING EXTERIOR WALL SHEATHING, LESS THAN 2" VERTICALLY FROM CONCRETE STEPS, PORCH SLABS, PATIO SLABS AND SIMILAR HARD HORIZONTAL SURFACES SHALL BE PRESERVATIVE PRESSURE TREATED.

PROTECTION OF WOOD AND WOOD-BASED PRODUCTS AGAINST DECAY AS REQUIRED BY R317. PROTECTION AGAINST TERMITES AS REQUIRED BY R318.

FIRE BLOCKING TO COMPLY WITH R302.11.

REFER TO STRUCTURAL ENGINEERING PLANS BY OTHER.

CABINETS AND COUNTERTOPS

REFER TO OWNERS SCOPE OF WORK DOCUMENTS FOR CABINET, COUNTERTOP AND HARDWARE

INTERIOR TRIM

OF REFER TO OWNERS SCOPE OF WORK DOCUMENTS FOR REQUIRED INTERIOR TRIM PROFILES.

7 THERMAL & MOISTURE PROTECTION

WATER BARRIER THE WATER BARRIER SYSTEM IS AN INTEGRAL PART OF THE WALL SHEATHING

THERMAL INSULATION

REQUIREMENTS.

• INSULATION TO HAVE THE FOLLOWING MINIMUM R-VALUES:

• EXTERIOR WALLS R=15 MIN.

• SLOPED CEILINGS (WITH ATTIC SPACE) R=38 OR R=30 WHEREVER THE FULL HEIGHT OF UNCOMPRESSED R=38 INSULATION EXTENDS OVER THE WALL TOP PLATE AT THE EAVES. • SLOPED CEILINGS (WITHOUT ATTIC SPACE) R=38 MIN., OR R=30 MIN. WHERE THERE IS NOT SUFFICIENT SPACE FOR REQ'D INSULATION.

• FLAT CEILINGS (WITH ATTIC SPACE) R=38 OR R=30 WHEREVER THE FULL HEIGHT OF UNCOMPRESSED R=38 INSULATION EXTENDS OVER THE WALL TOP PLATE AT THE EAVES.

ARCHITECTURAL SHINGLE ROOFING - SHINGLE ROOFING SHALL BE DIMENSIONAL ASPHALT TYPE WITH DIMENSION FEATURES. SEE OWNERS SCOPE OF WORK DOCUMENTS FOR MANUFACTURER, STYLE, COLOR AND ADDITIONAL REQUIREMENTS FOR INSTALLATION AND ACCESSORIES.

• REFER TO OWNERS SCOPE OF WORK DOCUMENTS FOR INSULATION TYPES AND ADDITIONAL

• SHINGLES SHALL BE TESTED IN ACCORDANCE WITH AST D 7185. • SHINGLES SHALL MEET THE CLASSIFICATION REQUIREMENTS FOR THE APPROPRIATE MAXIMUM BASIC WIND SPEED:

MAXIMUM BASIC WIND SPEED CLASSIFICATION REQUIREMENT • REFER TO STRUCTURAL ENGINEERING PLANS BY OTHER.

 ROOFING SHALL BE INSTALLED OVER ONE LAYER OF ASPHALT IMPREGNATED 15# ROOFING FELT. 2 LAYERS FOR ROOF PITCHES 2:12 - 4:12.

VALLEY LININGS TO BE INSTALLED PER R905.2.8.2

GUTTERS TO BE MINIMUM 5" ALUMINUM OGEE STYLE WITH 4" CORRUGATED RECTANGULAR ALUMINUM DOWNSPOUTS AT LOCATIONS AS INDICATED ON THE DRAWINGS.

DOWNSPOUTS TO BE CONNECTED TO UNDERGROUND STORM PIPING AND ROUTED TO DISCHARGE LOCATIONS AS SPECIFIED BY THE GENERAL CONTRACTOR. 12" WIDE (2" THICKNESS) RIGID FOAM LOCATED AT TOP OF FOOTER, SLOPING AWAY FROM THE UNIT TO PREVENT CONCRETE OVERFLOW AND ALLOW PIPE TO TIGHTLY FIT TO STEM WALL.

UNDERGROUND DRAINPIPES TO BE PROVIDED AT ALL COURTYARD SLAB CUTOUT LANDSCAPE AREAS TO PREVENT POOLING WATER.

LAP SIDING - REFER TO OWNERS SCOPE OF WORK DOCUMENTS FOR MATERIAL, MANUFACTURER, STYLE, COLOR AND OTHER REQUIREMENTS.

EXTERIOR TRIM & SOFFITS - REFER TO OWNERS SCOPE OF WORK DOCUMENTS FOR MATERIAL, MANUFACTURER, STYLE, COLOR AND OTHER REQUIREMENTS.

PROVIDE EXTERIOR TRIM OF SIZES INDICATED ON THE DRAWINGS.

8 DOORS & WINDOWS

EXTERIOR PATIO DOORS AND SLIDING PATIO DOORS - REFER TO OWNERS SCOPE OF WORK DOCUMENTS FOR MANUFACTURER, STYLE COLOR AND HARDWARE SELECTIONS. SIZES AS INDICATED ON THE DRAWINGS

• ALL DOORS TO HAVE LOW-E GLASS SAFETY GLAZING.

INTERIOR DOORS - REFER TO OWNERS SCOPE OF WORK DOCUMENTS FOR DOOR TYPE, STYLE AND HARDWARE SELECTIONS.

SIZES AS INDICATED ON THE DRAWINGS.

WINDOWS - REFER TO OWNERS SCOPE OF WORK DOCUMENTS FOR WINDOW MANUFACTURER, STYLE, COLOR AND HARDWARE SELECTIONS.

SIZES AS INDICATED ON THE DRAWINGS.

• ALL WINDOWS TO HAVE LOW-E INSULATING GLASS

• WINDOW MANUFACTURER SHALL PROVIDE TEMPERED GLASS AS REQUIRED BY R308.4 AT ALL HAZARDOUS LOCATIONS.

• WINDOW FALL PROTECTION AS REQUIRED BY R312.2.

• WRITTEN INSTALLATION INSTRUCTIONS SHALL BE PROVIDED BY THE WINDOW MANUFACTURER

FOR EACH WINDOW - SEE FULL INSTRUCTIONS FOR ALL ADDITIONAL REQUIREMENTS. ALL BEDROOM WINDOWS TO MEET EMERGENCY RESCUE OPENING CODE REQUIREMENTS. • WINDOW TRIM TO BE OFFSET MIN. 1/4" WHERE WINDOW MEETS TRIM FOR CAULKING. COORDINATE

WITH WINDOW SELECTION, PAD OUT THE TRIM IF NEEDED. • TRIM MATERIAL PER OWNERS SCOPE OF WORK DOCUMENTS. SIZES AS INDICATED ON THE DRAWINGS.

• SEE CURRENT BUILDING CODE FOR ALL ADDITIONAL REQUIREMENTS.

9 FINISHES

DRYWALL WALLS AND CEILINGS- REFER TO OWNERS SCOPE OF WORK DOCUMENTS FOR REQUIRED DRYWALL FINISHES.

• PROVIDE TYPE-X GYPSUM PANELS AT LOCATIONS INDICATED ON THE DRAWINGS FOR FIRE-RATED ASSEMBLIES.

• ALL BATHROOMS TO HAVE MOISTURE-RESISTANT, PAPERLESS GYPSUM. • PROVIDE 1/2" TILE BACKER BOARD IN LIEU OF DRYWALL AT ALL WALL LOCATIONS REQUIRING A

TILE FINISH.

INTERIOR FINISHES - REFER TO OWNERS SCOPE OF WORK DOCUMENTS FOR ALL INTERIOR FLOOR, WALL AND CEILING FINISHES.

10 SPECIALTIES

BATH ACCESSORIES - REFER TO OWNERS SCOPE OF WORK DOCUMENTS FOR REQUIRED BATH

FIREPLACE - REFER TO OWNERS SCOPE OF WORK DOCUMENTS FOR FIREPLACE REQUIREMENT AND SELECTIONS.

CLOSET ROODS AND SHELVING - REFER TO OWNERS SCOPE OF WORK DOCUMENTS FOR REQUIREMENTS AND SELECTIONS.

11 EQUIPMENT

APPLIANCES - REFER TO OWNERS SCOPE OF WORK DOCUMENTS FOR APPLIANCE SELECTIONS.

12 FURNISHINGS SECTION NOT USED

13 SPECIAL CONSTRUCTION SECTION NOT USED

14 CONVEYING SYSTEMS

SECTION NOT USED

22 PLUMBING

REFER TO PLUMBING PLANS BY OTHERS.

REFER TO HVAC PLANS BY OTHERS.

26 ELECTRICAL

REFER TO ELECTRICAL PLANS BY OTHERS.

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New Home Inc 1611 Jones Franklin, Raleigh, NC, 27606

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> Drew DiMeo HANDING:

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GENERAL FLOOR PLAN NOTES:

General Floor Plan Notes shall apply unless noted otherwise on plan.

1. Wall Heights: Typically 9'-1 1/2" at first floor and second floor, and 9'-1 1/2" at attics U.N.O. All walls are constructed using a double top plate. Splices at Double Top Plate do not need to occur at Vertical Studs but must be at least 24" apart from Joint in other Top Plate layer. Special wall heights are noted on plans where they occur.

2. Wall Thickness is typically 3 1/2". 2x6 frame shall be used at walls that back up to plumbing fixtures. Walls greater than 10' high shall be framed with 2x6 framing or greater and will be noted as a special condition where it occurs on plan.

3. Typical header height shall be 7'-8" AFF at First Floor, and 7'-4" AFF at Second Floor U.N.O.

4. Jacks: Openings up to 3'-4" wide shall have (1) 2x4 jack stud SPF on each side. Openings greater than 3'-4" wide shall have (2) 2x4 jack studs SPF on each

5. Soffits, Coffered Ceilings, Trey Ceilings and other significant ceiling plan elements are shown on the floor plans and are denoted as single dashed lines. Unless specifically call out as included, Kitchens include soffits over wall cabinetry.

6. Door & Window Frames, where occurring near corners, shall be a minimum of 4 1/2" from corner. Except for walk-in closets with doors near a corner, doors at closets shall be centered on closet.

7. Windows: Shall have at least (1) window in each sleeping room, that meets egress. Shall be provided with tempered glass at hazardous glazing areas. False windows shall be installed with obscure glazing.

8. Closets for clothing or coat storage shall be equipped with 1 rod/shelf. Closets for linen shall have 4 open equal shelves. Closets for pantries shall have 4 equal wood shelves, painted.

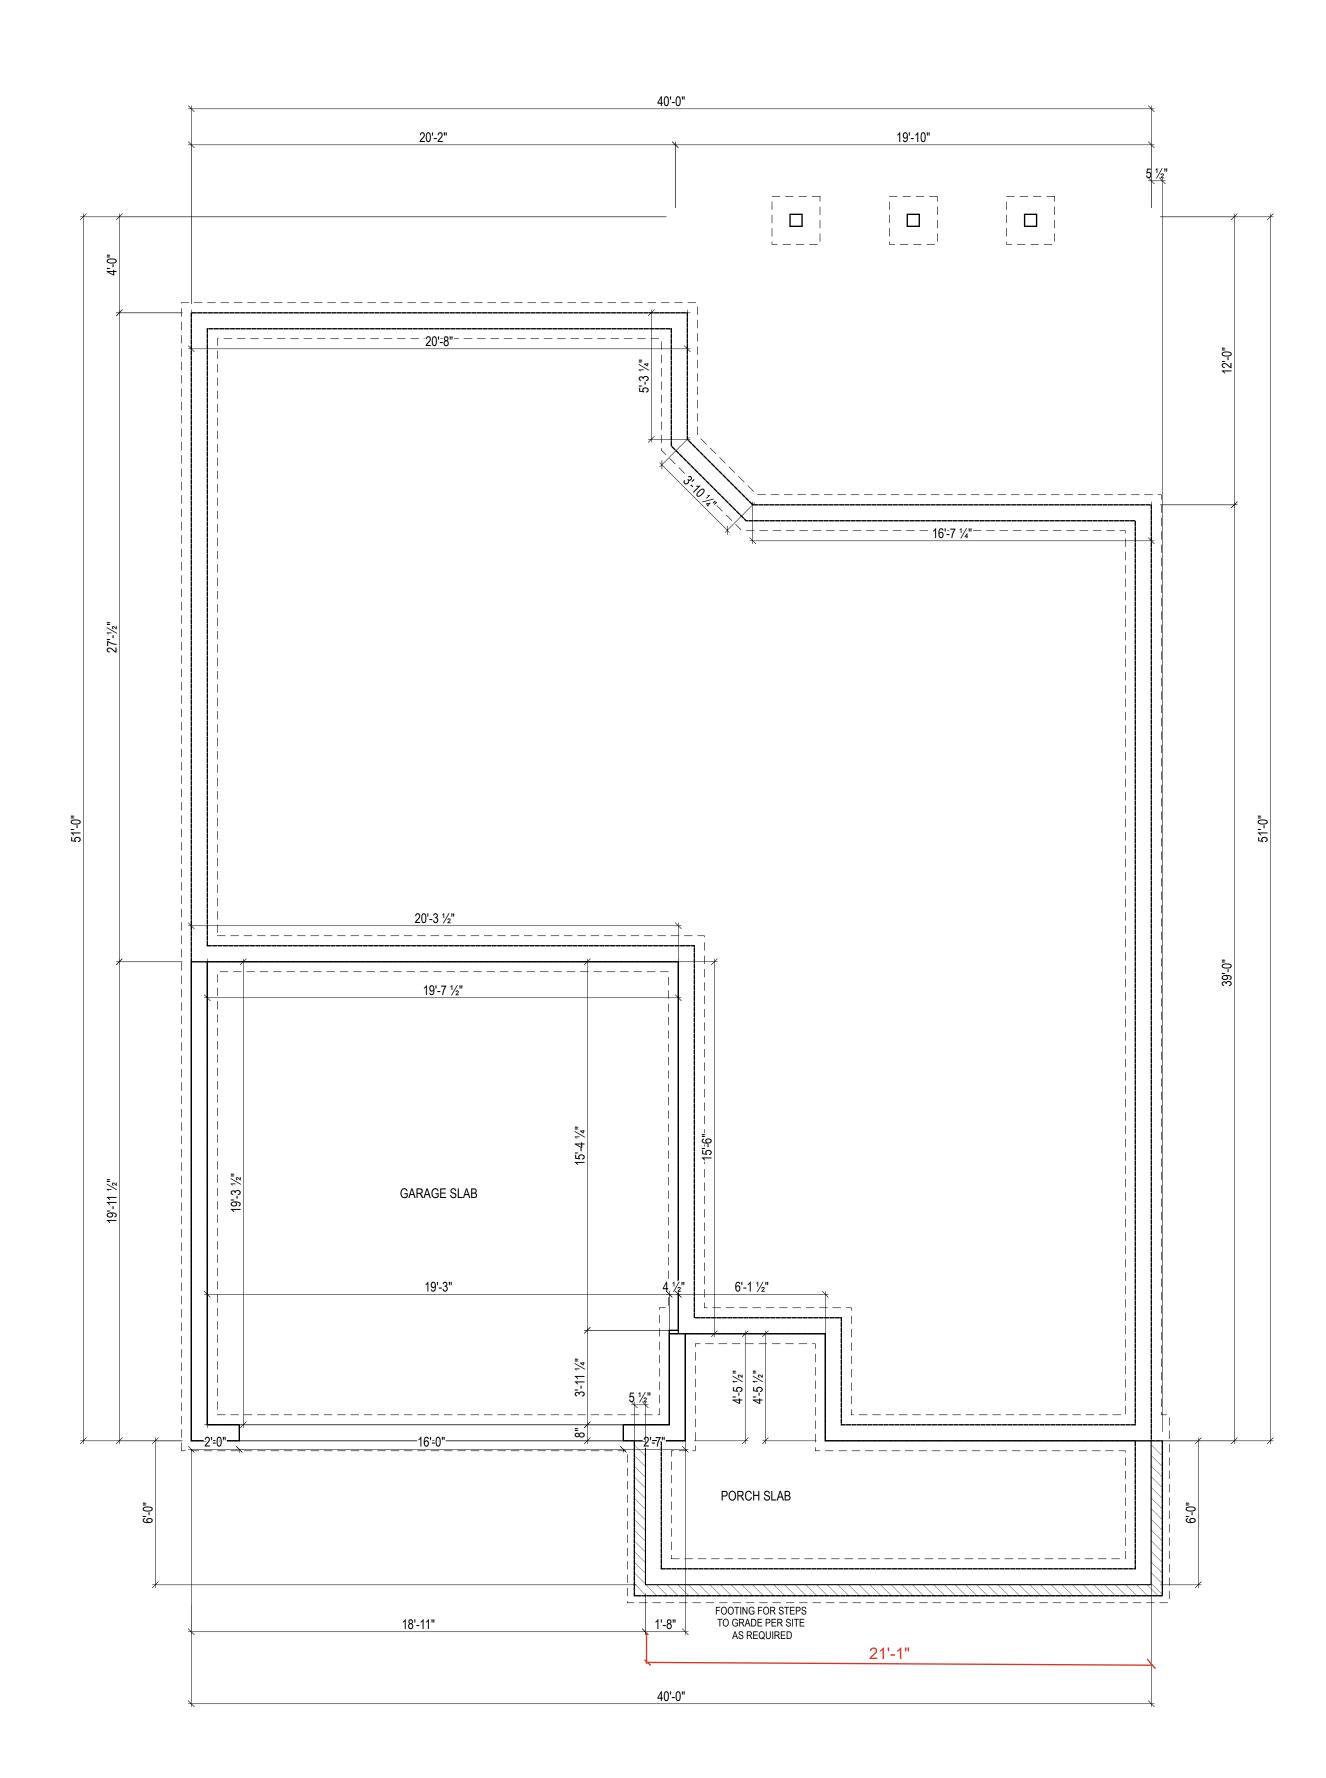
9. Stair treads shall be a min of 9" deep, risers shall be a maximum of 8 1/4", unless noted otherwise, per the current North Carolina Residential Code.

10. Handrails and Guards at stairs shall be 34" above the finished surface of the ramp surface of the stair. Handrails at landings and overlooks of multilevel spaces shall be 36" above finished floor. Guards (pickets or balusters) shall be spaced with no more than 4" between guards.

11. Attic Access shall be provided at all attic area with a height greater than 30". Minimum clear attic access shall be 20" x 30". Pull down stairs and access doors in knee walls meeting minimum criteria are also acceptable.

12. Garage Door to Living Space shall be 2'-8" x 6'-8" minimum size and shall be 20 minute fire rated and weather sealed.

13. Garage Walls, as a minimum, shall be separated from living space by installing 1/2" gypsum board on the garage side of the wall. With habitable space above, the inside of all garage walls require 1/2" GWB supporting 5/8" type X GWB on ceiling.



FOUNDATION PLAN - Crawlspace

1/4" = 1'-0" (WHEN PRINTED ON 22x34)

1/8" = 1'-0" (WHEN PRINTED ON 11x17)

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New Home Inc 1611 Jones Franklin, Raleigh, NC, 27606

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The Garner Craftsman at Cattail Pr FOUNDATION PLAN

DRAWN BY:
Drew DiMeo

HANDING:
RIGHT
ISSUE DATE:

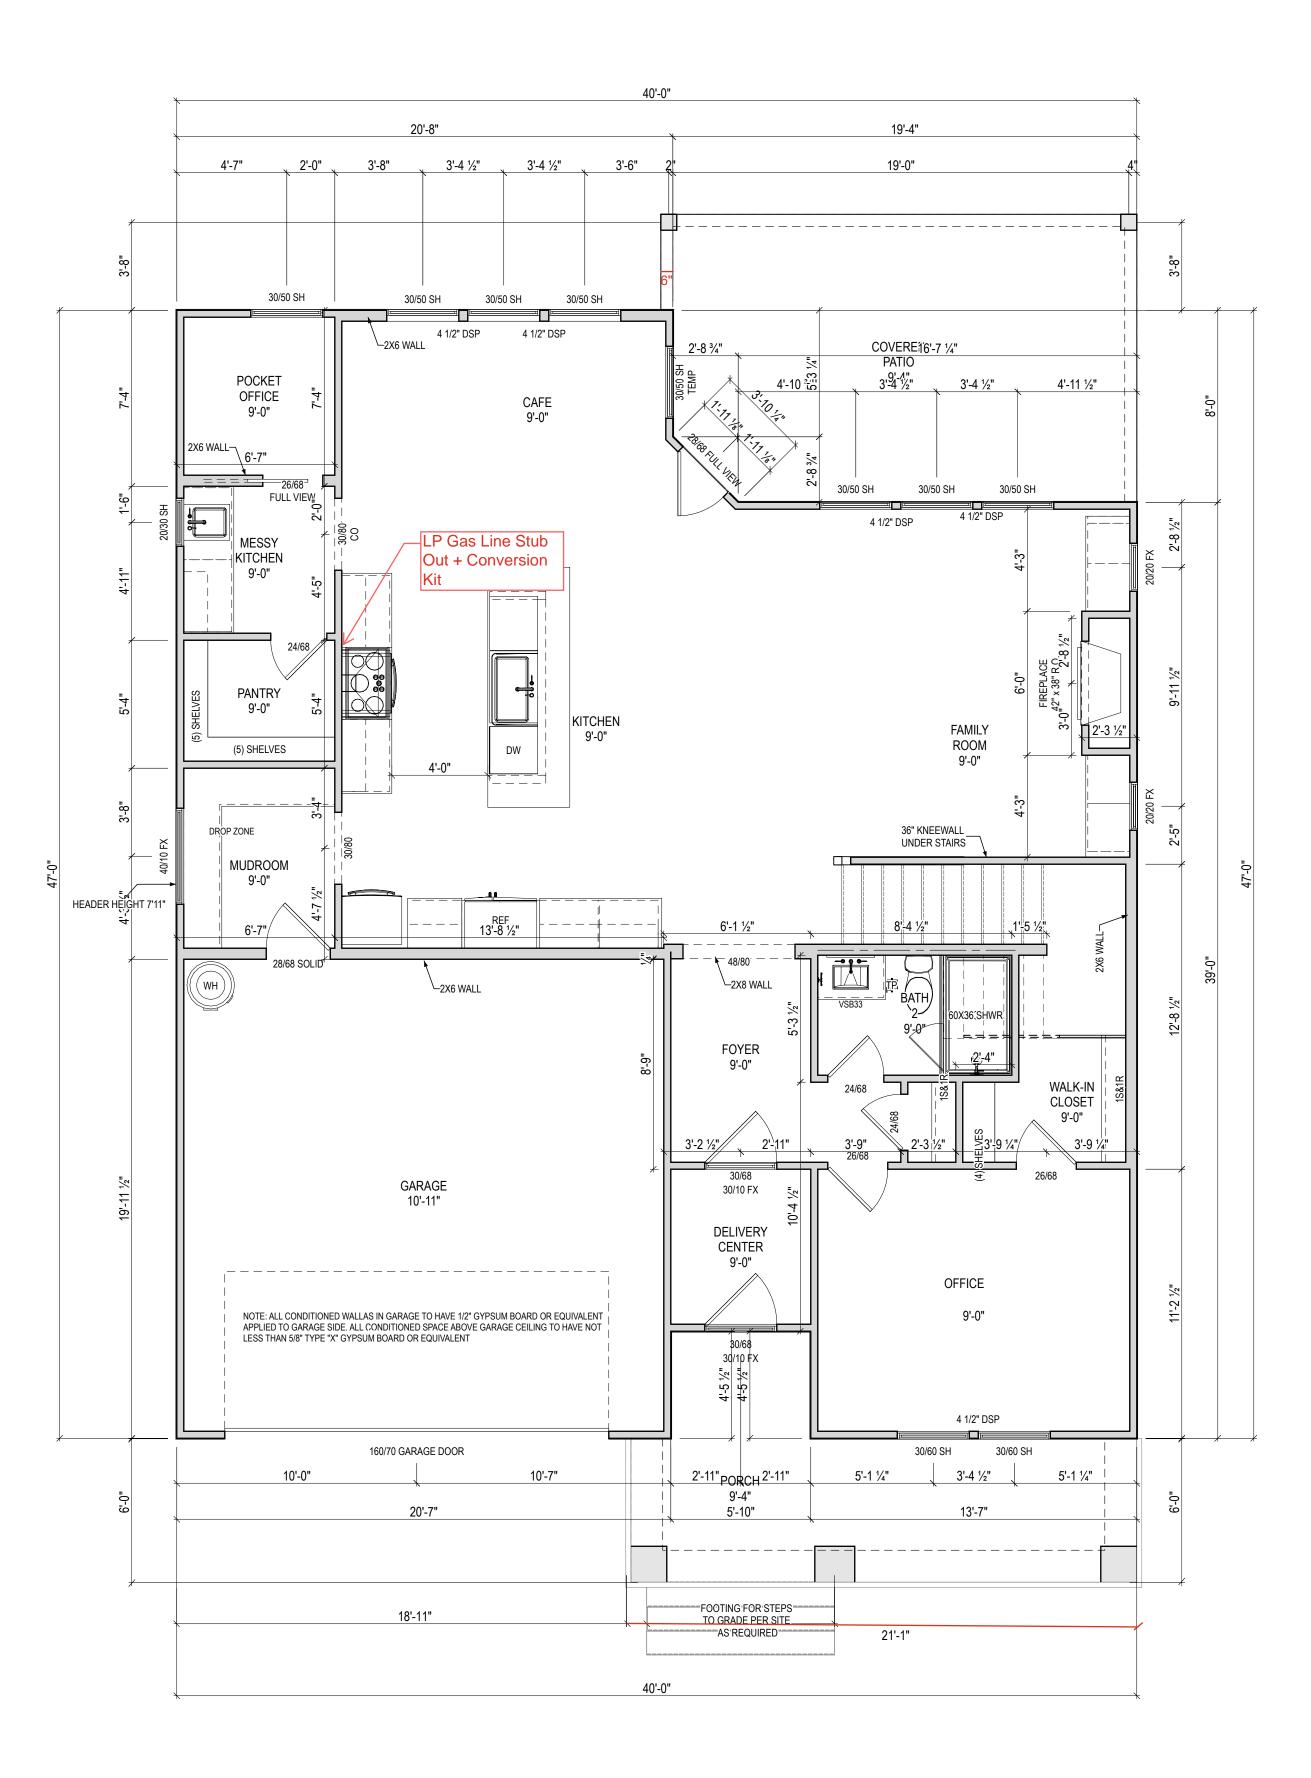
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A-100

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- 13. Garage Walls, as a minimum, shall be separated from living space by installing 1/2" gypsum board on the garage side of the wall. With habitable space above, the inside of all garage walls require 1/2" GWB supporting 5/8" type X GWB on ceiling.



First Floor Plan

1/4" = 1'-0" (WHEN PRINTED ON 22x34)

1/8" = 1'-0" (WHEN PRINTED ON 11x17)



New Home Inc 1611 Jones Franklin, Raleigh, NC, 27606

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Craftsman at Cattail Preserve

Drew DiMeo

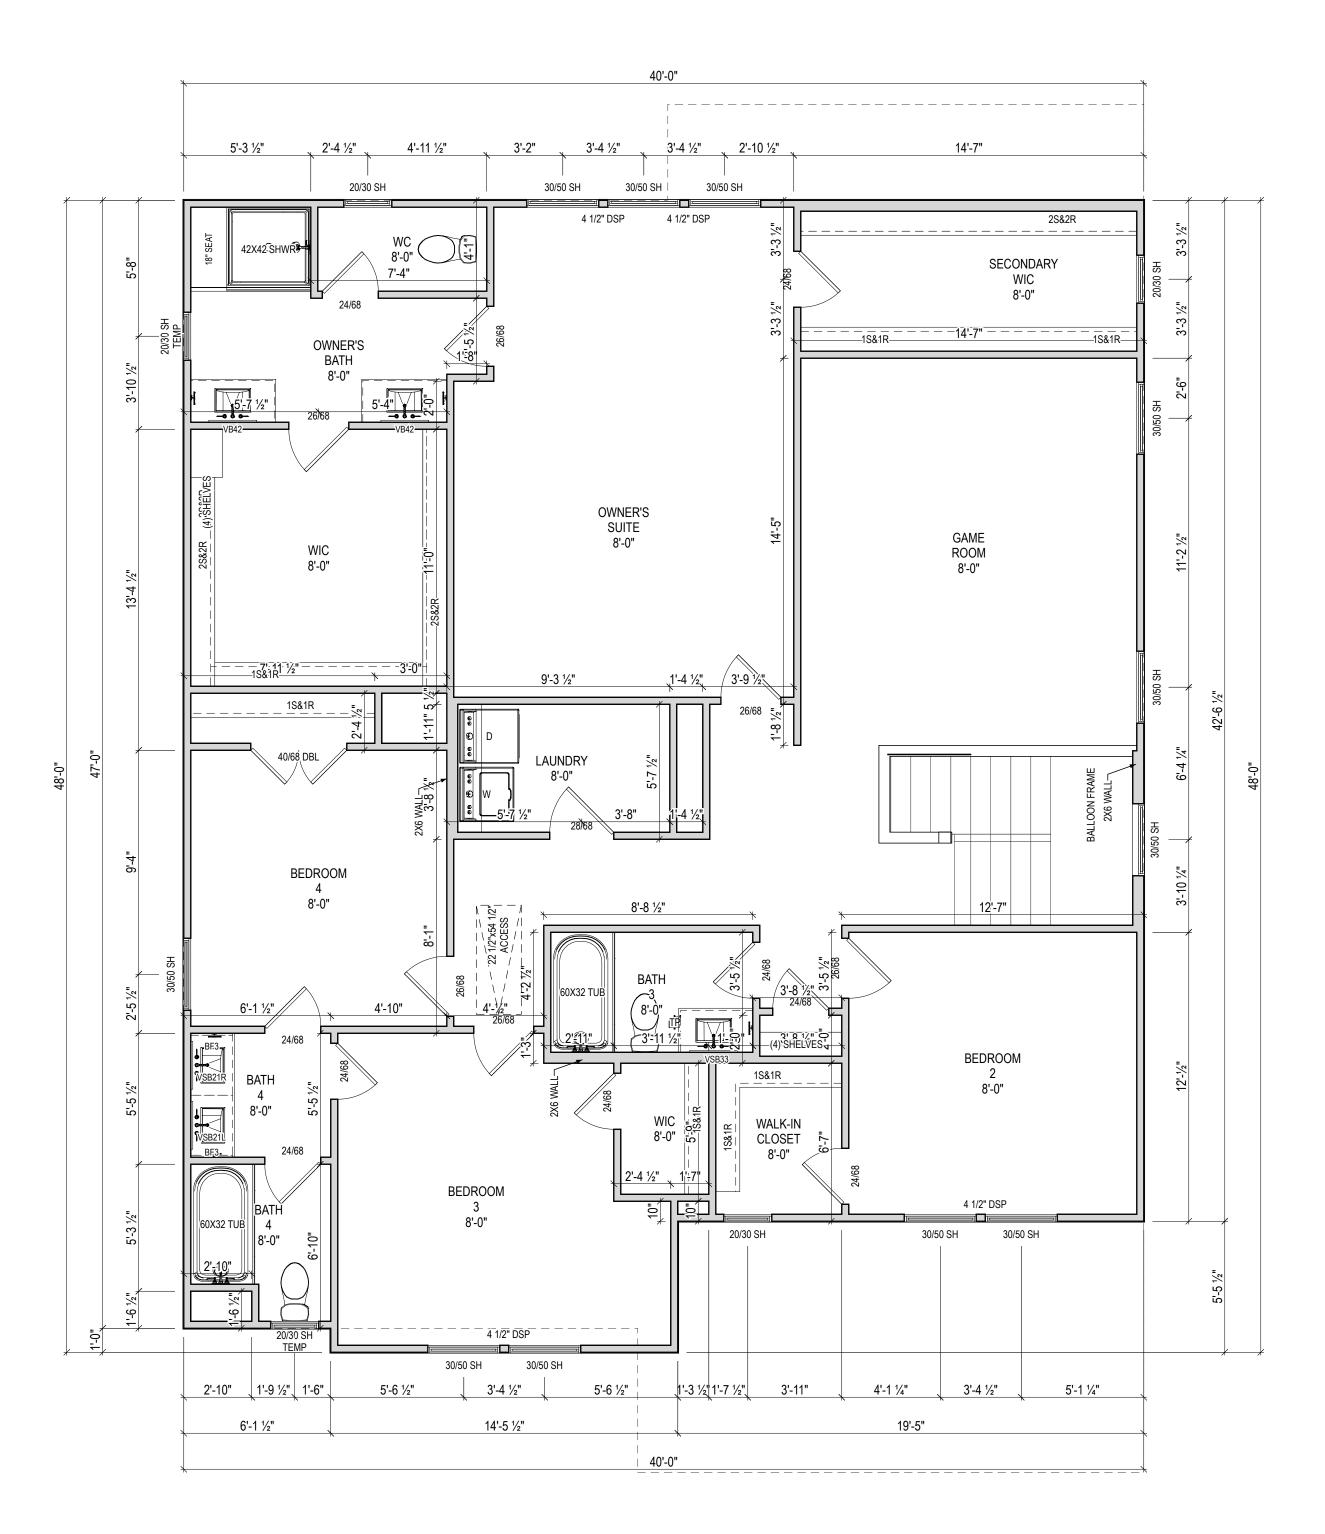
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Second Floor Plan

1/4" = 1'-0" (WHEN PRINTED ON 22x34) 1/8" = 1'-0" (WHEN PRINTED ON 11x17) A-120

Drawn BY:
Drew DiMeo

HANDING: RIGHT

11/11/1111

The Garner Craftsman at Cattail Preserve

New Home Inc

1611 Jones Franklin,

Raleigh, NC, 27606

Second Floor Plan

GENERAL ROOF PLAN NOTES:

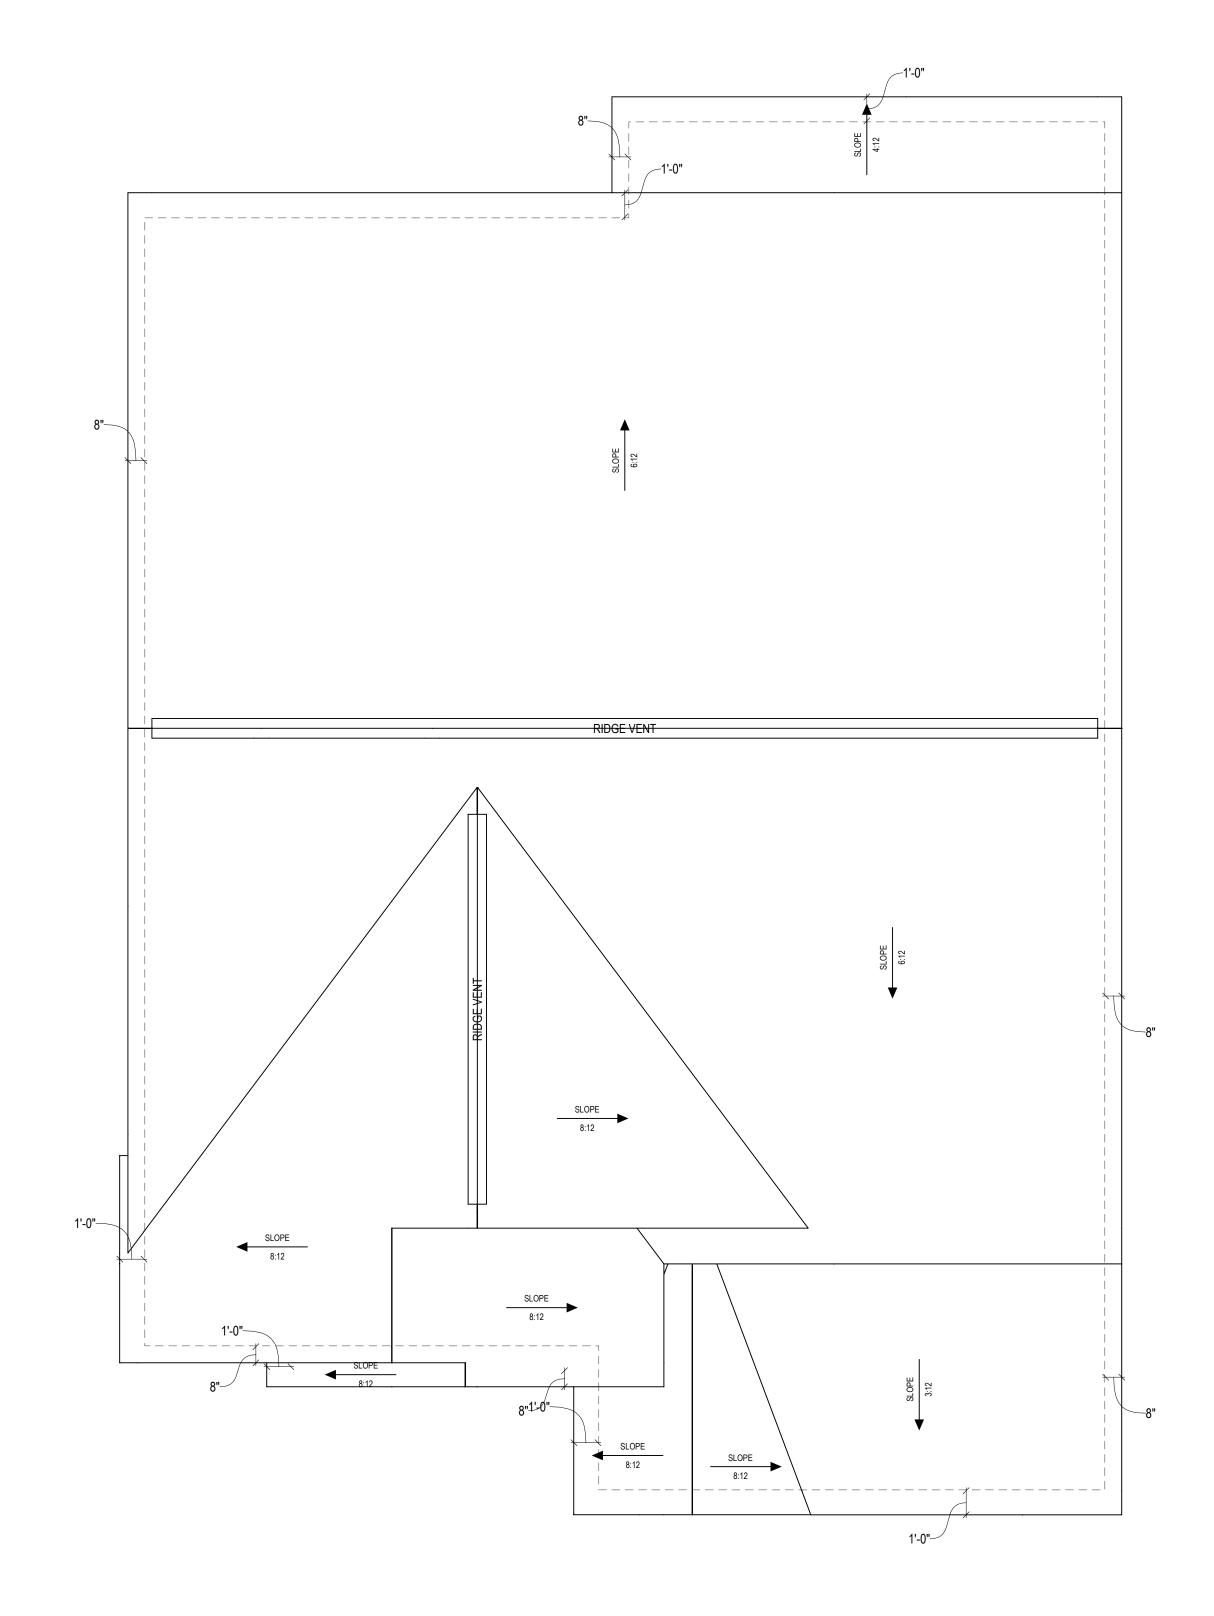
1. ALL ROOF OVERHANGS TO BE 1'-0" UNLESS NOTED OTHERWISE

2. ALL TRAY CEILING TRAY HEIGHTS TO BE 12" UNLESS NOTED OTHERWISE

3. THESE PLANS ARE NOT TO BE SCALED FOR CONSTRUCTION PURPOSES.

4. IT IS THE CONTRACTOR'S RESPONSIBILITY TO VERIFY THE ACCURACY OF ALL DETAILS AND DIMENSIONS.

5. 8'×16' ATTIC STORAGE PLATFORM - PROVIDE 3/4" APA RATED PLYWOOD SUB-FLOORING OR OSB SHEATHING RATED FOR 20#/SF ON BOTTOM CHORD OF TRUSSES. TRUSS MANUFACTURER TO ACCOUNT FOR ADDITIONAL LOADS



1/4" = 1'-0" (WHEN PRINTED ON 22x34) 1/8" = 1'-0" (WHEN PRINTED ON 11x17)



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The Garner Craftsman at Cattail Preserve

Drawn BY:
Drew DiMeo

HANDING: RIGHT

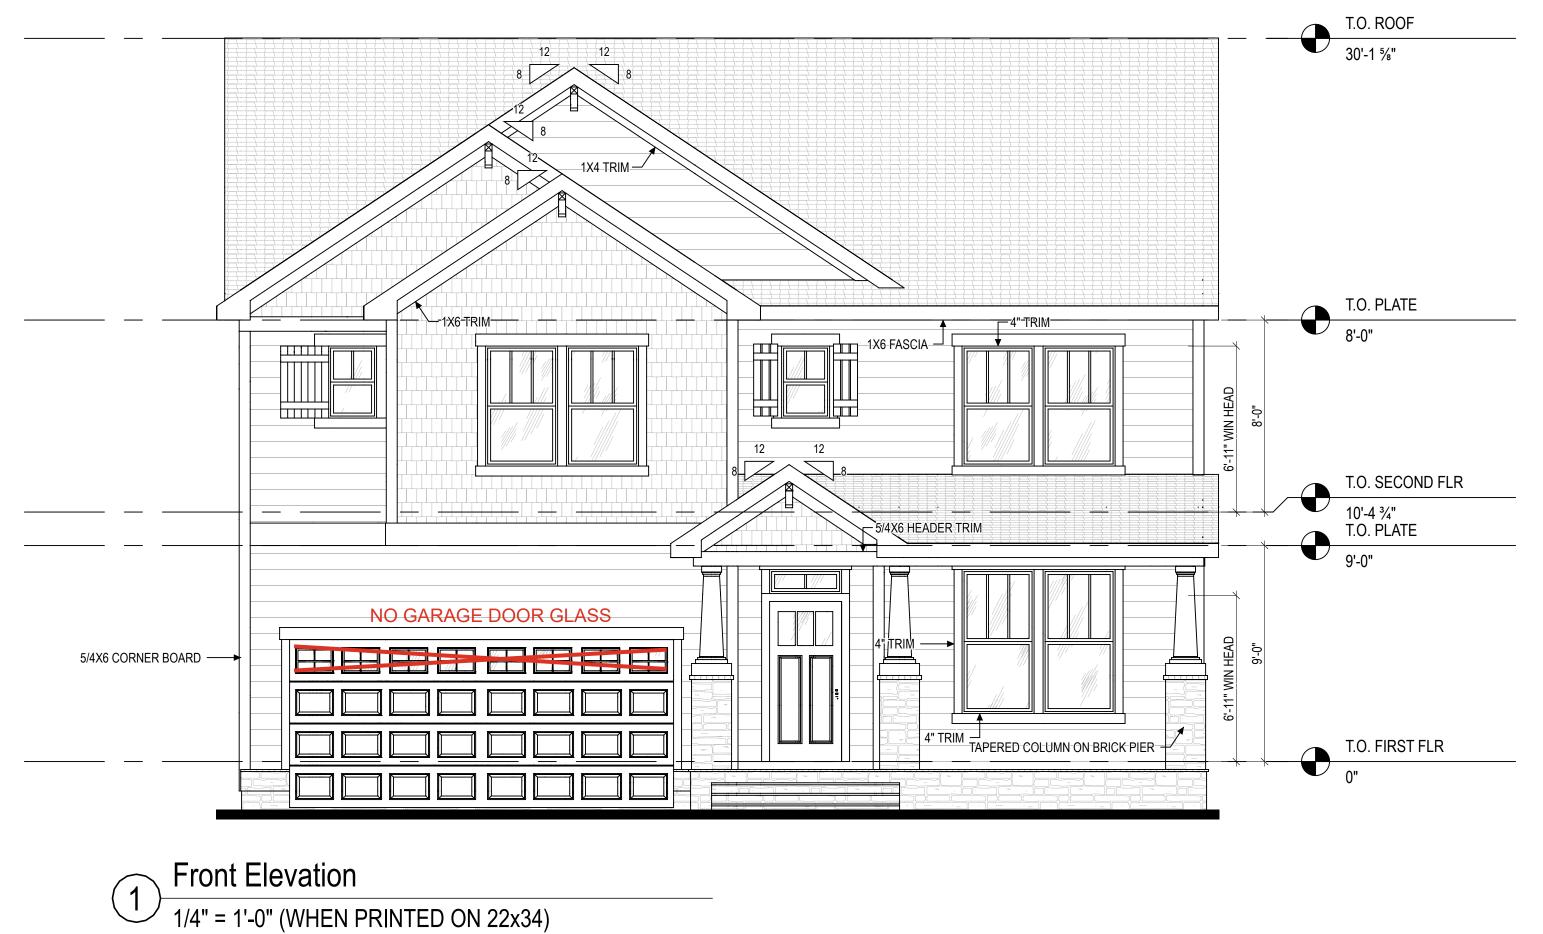
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GENERAL ELEVATION NOTES:

- General Elevation Notes shall apply unless noted otherwise on plan.
- 1. Roof shall be finished with architectural composition shingles with slopes as noted on plan.
- 2. Ridge Vent shall be provided and installed on all ridges greater than 6' in length per manufacturer's
- 3. Soffit Vent shall be continuous soffit vent.

specifications.

- 4. House Wrap, "tyvek" or approved equal shall be installed over entire exterior wall per manufacturer's specifications and recommendations.
- 5. Flashing shall be provided above all door and window openings, above finish wall material changes and at wall surfaces where lower roof areas abut vertical wall surfaces.
- 6. Porch Railings shall be provided at all porch walking surfaces greater than 30" above adjacent finished grade. It shall be 36" high with guards spaced no more than 4" apart. Consult community specifications for material.
- 7. Finish Wall Material shall be as noted on elevation
- 8. Brick Veneer, if included on elevation shall be tied to wall surface with galvanized corrugated metal ties at a rate of 24" oc horizontally and 16" oc vertically so that no more than 2.67sf of brick is supported by (1) tie. Space between face of wall and back face of brick shall be limited to a maximum of 1". Flashing shall be provided behind brick above all wall openings and at base of brick wall. Flashing shall be a minimum of 6-mil poly or other corrosion resistant material and shall be installed so that it laps under the house wrap material a minimum of 2". Weepholes shall be provided at a rate of 48" oc and shall not be less than 3/16" in diameter and shall be located immediately above flashing.
- 9. Brick Veneer Support Lintels shall be provided if brick veneer is included on elevation. Lintels shall be provided as listed in the following schedule and shall have a minimum bearing length of 6". Masonry Lintels shall be provided so that deflection is limited



 $^{\prime}$ 1/4" = 1'-0" (WHEN PRINTED ON 22x34) 1/8" = 1'-0" (WHEN PRINTED ON 11x17)



Back Elevation

1/4" = 1'-0" (WHEN PRINTED ON 22x34)

1/8" = 1'-0" (WHEN PRINTED ON 11x17)



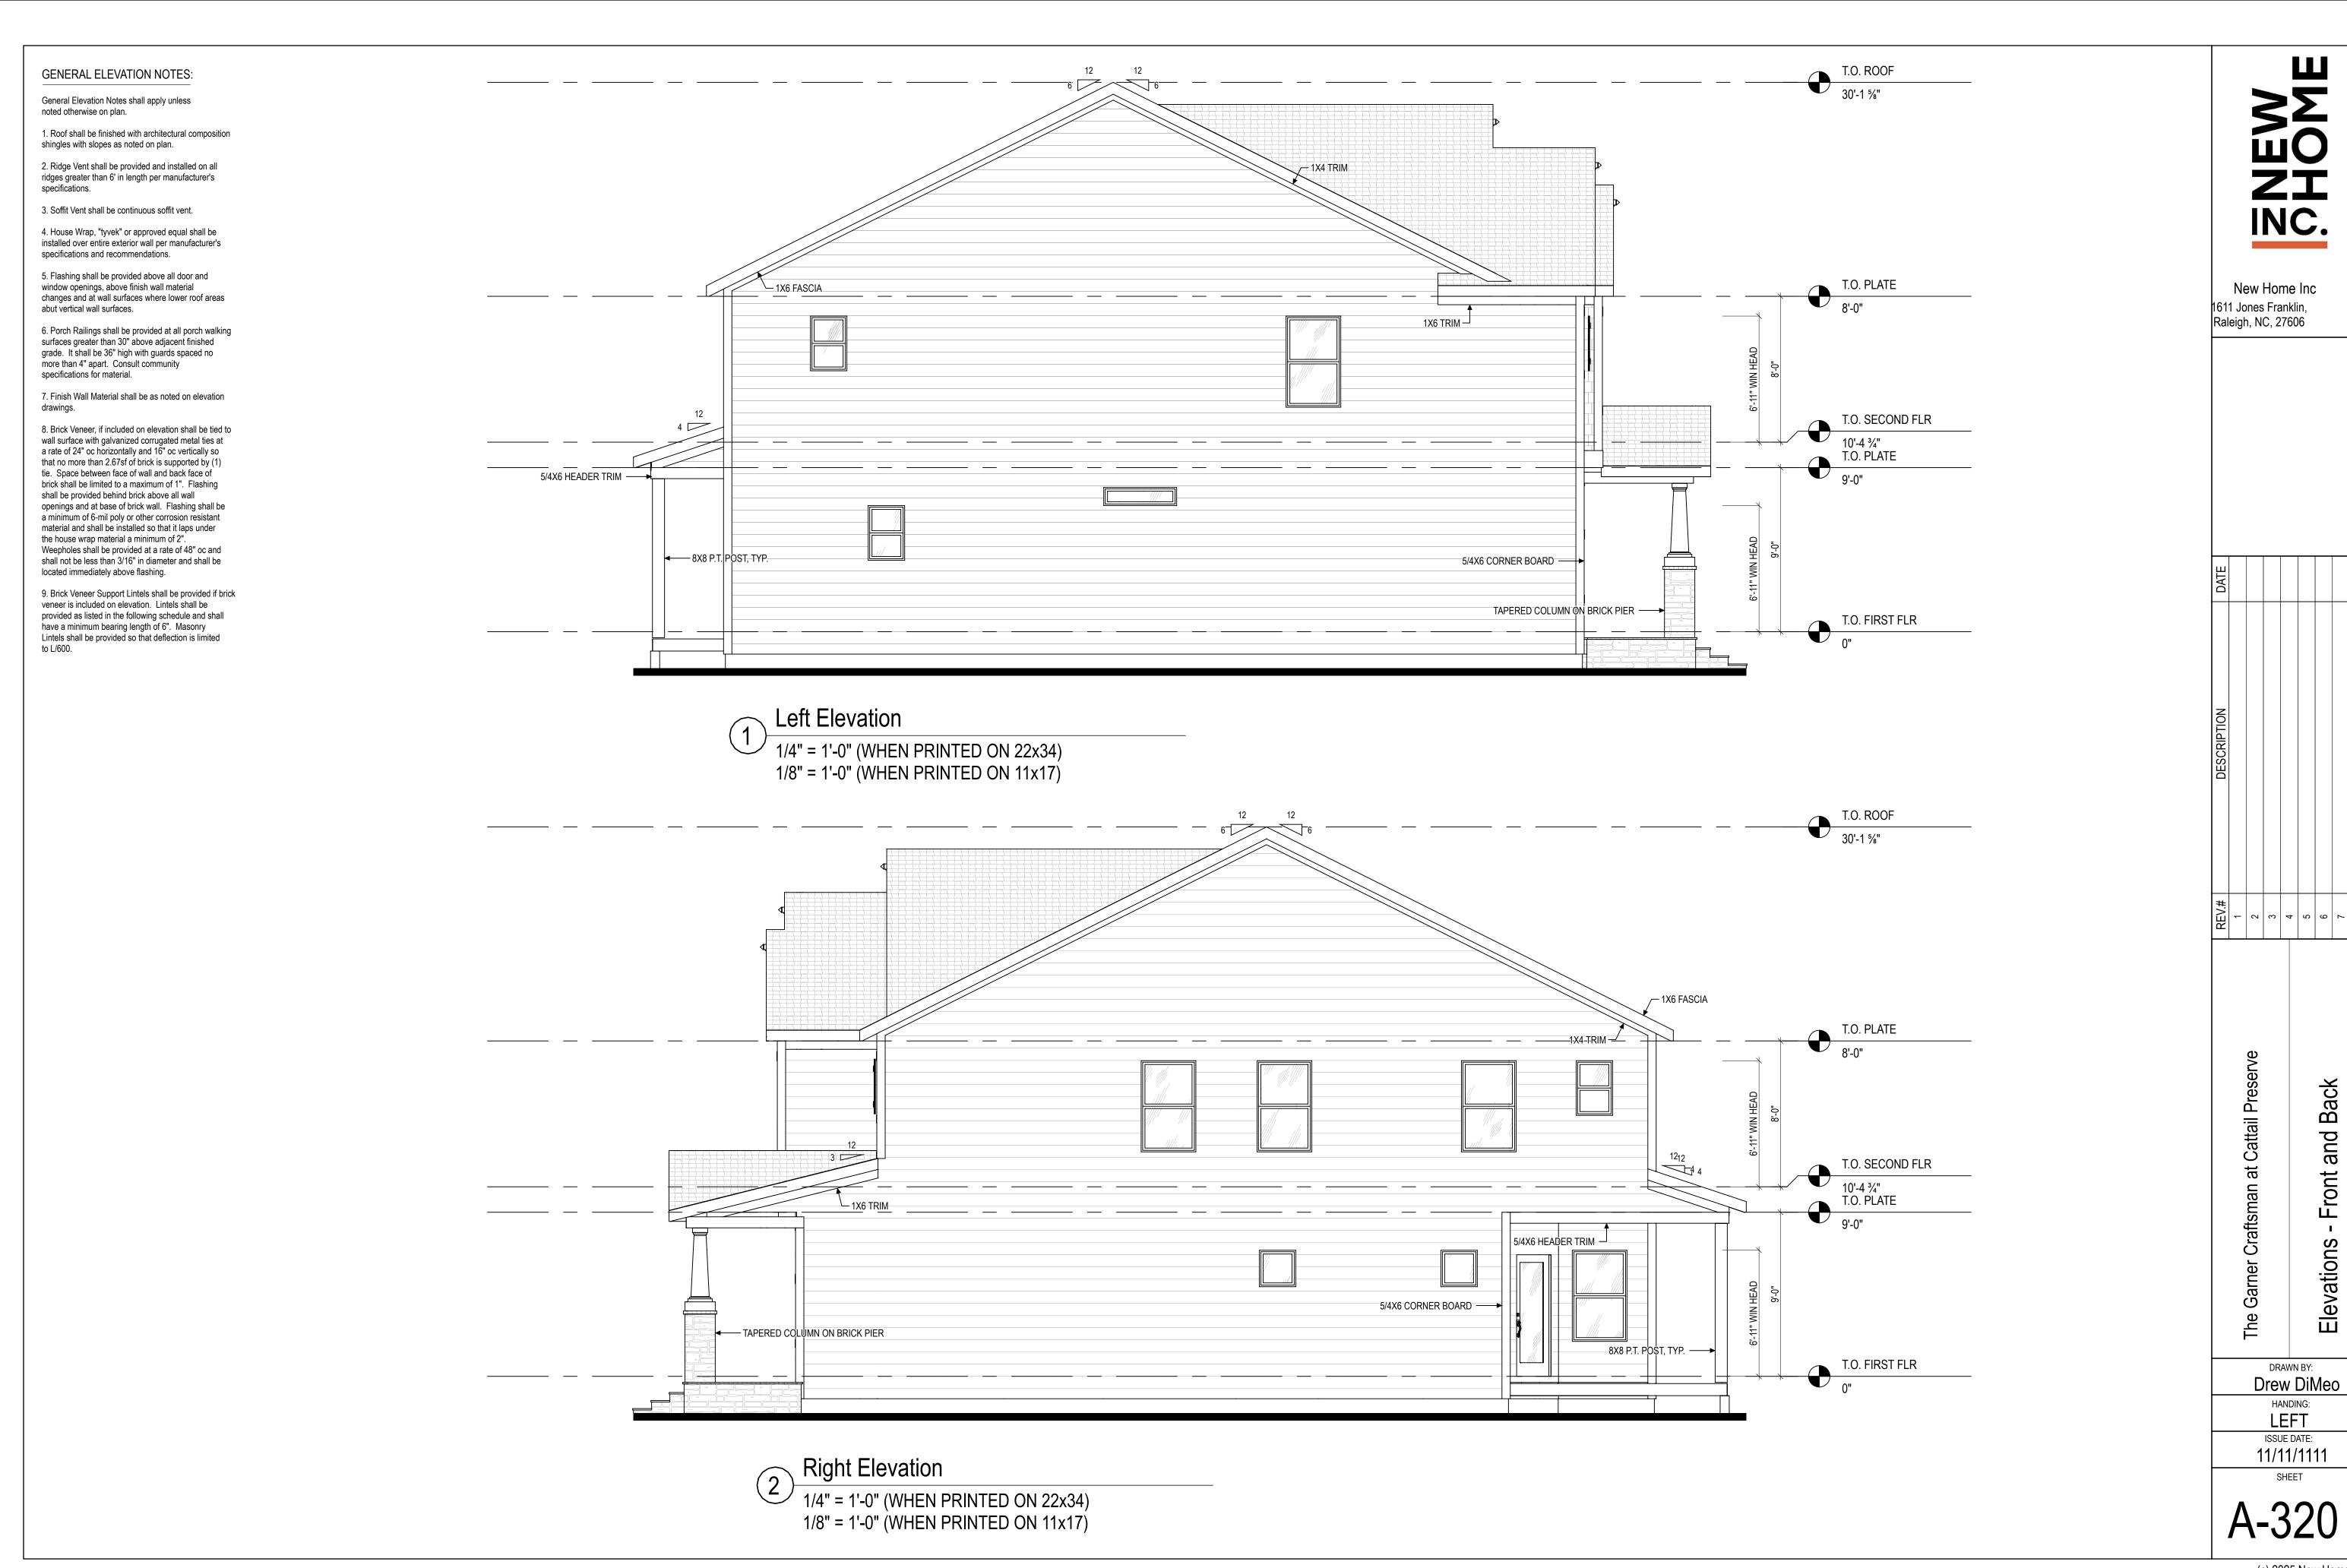
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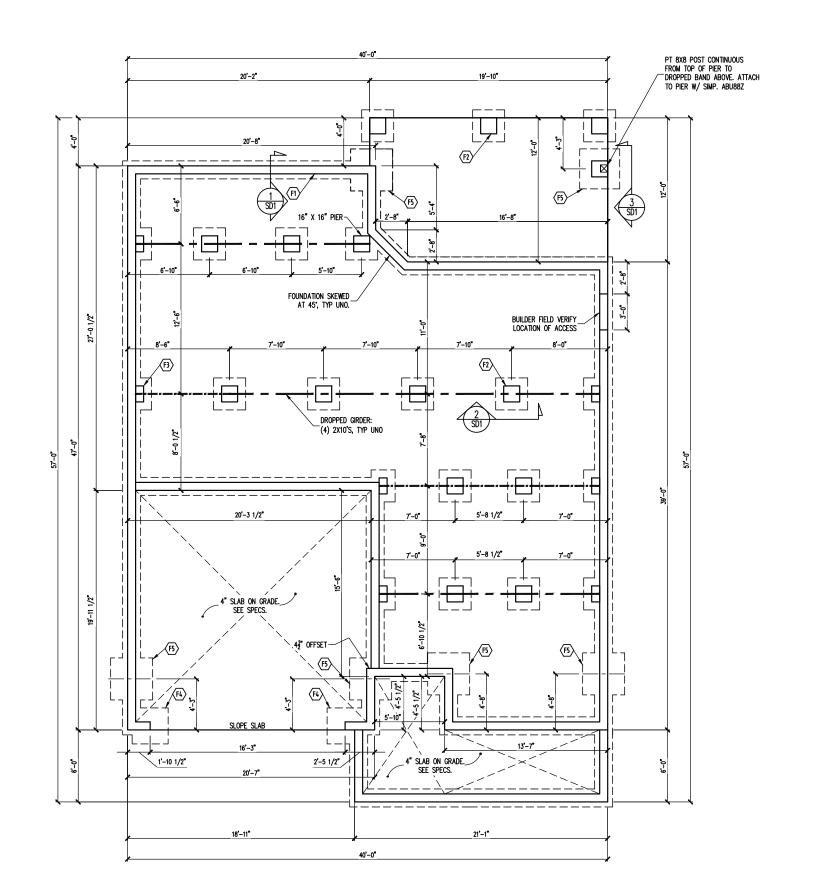
The Selma Craftsman at {{ CommunityName }} - Front and Back

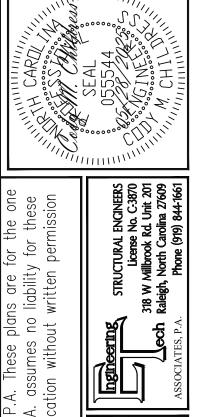
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NEW HOME INC STRUCTURAL ADDENDUM REV # REF PROJ #

DUNCANS CREEK

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ENG: CMC/ZCH

DATE: 5/28/2025

GARNER CRAFTSMAN

PROJECT NO. 25-65-176

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FOUNDATION SCHEDULE

OPTION:
(2) INTEGRATED 4" MASONRY WYTHES

16" SQ. MASONRY PIER ON A 32" SQ. X 10" THK CONC FTG TYP UNO.

8" X 16" CMU PILASTER, PROJECT FTG 8" X 8" THK, TYP UNO

ENLARGE FOOTING TO 36" SQ. X 12" THK. SOLID MASONRY ABOVE.

ENLARGE FOOTING TO 42" SQ. X 12" THK. SOLID MASONRY ABOVE.

NOTES:

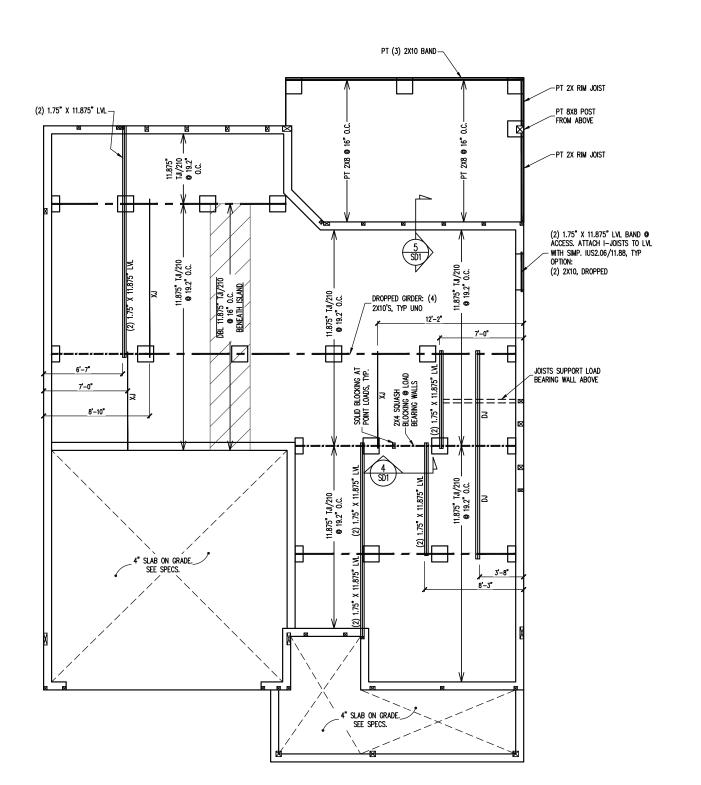
-HEIGHT AND BACKFILL LIMITATIONS FOR
FOUNDATION WALLS ARE TO BE GOVERNED
BY THE NCSBC, LATEST EDITION.
REINFORCEMENT AND GROUTING SHALL BE
DETERMINED BY FINAL SITE CONDITIONS.

-BUILDER TO FIELD LOCATE CRAWLSPACE ACCESS OPENING WITH MINIMUM DIMENSIONS OF 18X24. DO NOT LOCATE ACCESS OPENING BELOW POINT LOADS FROM ABOVE WITHOUT ENGINEER APPROVAL.

FOUNDATION PLAN

<u>1/8" = 1'-0"</u>

SHEET NO. **S1** 1 of 8



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GIRDER LEGEND

ALL GIRDERS (4) 2X10'S, TYP UNO. BOLTING NOT REQUIRED FOR DROPPED GIRDERS.

I-JOIST SQUASH BLOCKING REQUIRED

NOT REQUIRED

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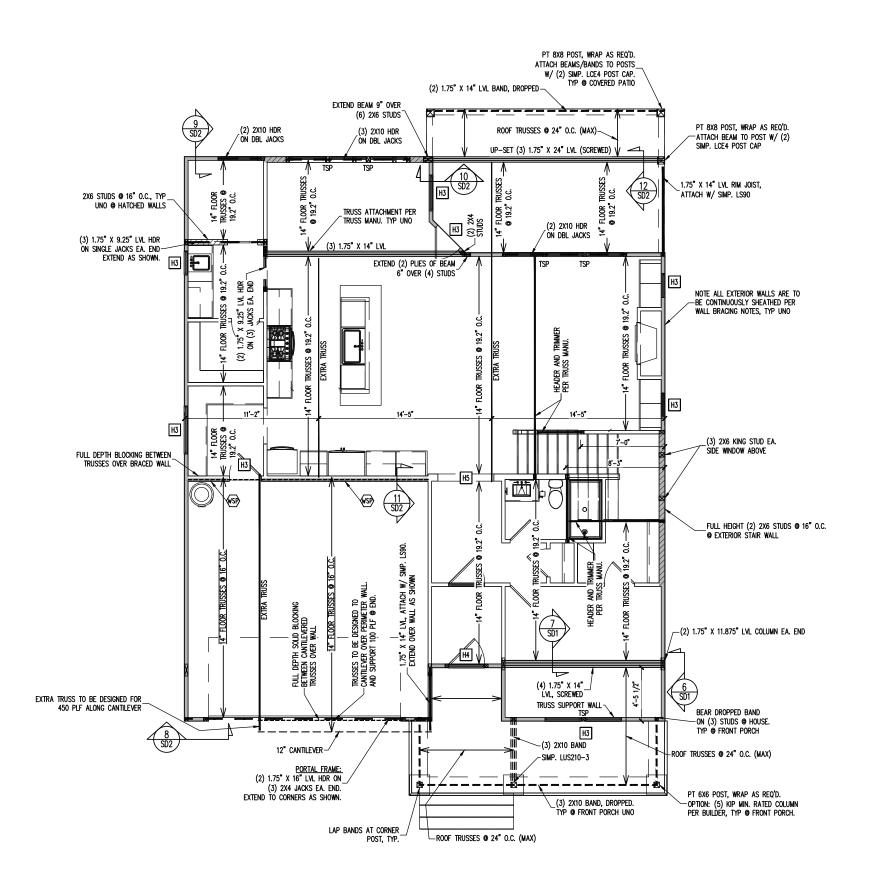
ENG: CMC/ZCH DATE: 5/28/2025 **GARNER**

CRAFTSMAN

PROJECT NO.

25-65-176

SHEET NO. **S2**



CONSTRUCTION SPECIFICATIONS INSTANT REFERENCES

REFER TO THE CONSTRUCTION SPECIFICATIONS SECTIONS FOR THE FOLLOWING INFORMATION:

PART 1.01: CURRENT GOVERNING CODE

PART 14: STUD SUPPORT FOR BEAMS

PART 17: KING STUDS FOR EXTERIOR WALLS

SEE DETAIL / CONSTRUCTION SPECIFICATIONS
SHEETS FOR I—JOISTS ALLOWABLE SUBSTITUTIONS

WALL BRACING

SHADED WALLS:

ALL EXTERIOR STUD WALLS, EXTERIOR SIDE, ARE TO BE CONTINUOUSLY SHEATHED WITH 7/16 APA RATED OSB NAILED TO STUDS WITH 8d NAILS @ 6" O.C. AT PANEL EDGES, 12" O.C. IN PANEL FIELD.

WSP - ONE SIDE OF INTERIOR WALL OR INSIDE OF EXTERIOR WALL WITH 3/8" MIN. THICKNESS WOOD STRUCTURAL PANELING. ATTACH WSP TO STUD WALL WITH 8d NAILS @ 6" O.C. AT PANEL EDGES, 12" O.C. IN PANEL FIELD.

PROVIDED CONTINUOUS SHEATHING = 180' MIN.

REFERENCE PART 16.02 OF CONSTRUCTION SPECIFICATIONS FOR GENERAL WIND BRACING INFORMATION.

HEADER SCHEDULE

- H1 SINGLE 2X4 TURNED FLAT (A)
- H2 (2) 2X4'S ON SINGLE JACKS (B)
- H3 (2) 2X10'S ON SINGLE JACKS (C)
- H4 (2) 1.75" X 9.25" LVL'S ON DBL JACKS
- H5 (3) 2X10'S ON SINGLE JACKS
- (A) TYPICAL FOR INTERIOR NON LOAD BEARING WALLS ONLY, ROUGH OPENING 38" MAX.
- (B) TYPICAL FOR INTERIOR NON LOAD BEARING WALLS ONLY, ROUGH OPNG 38" TO 74" MAX.
- (C) TYPICAL FOR ALL CONDITIONS NOT LISTED IN (A) OR (B) UNO.

-HEADERS IN NON LOAD BEARING INTERIOR
WALLS ARE NOT LABELED.

1ST FLOOR FRAMING PLAN

WALLS AND CEILING 1/8" = 1'-0"

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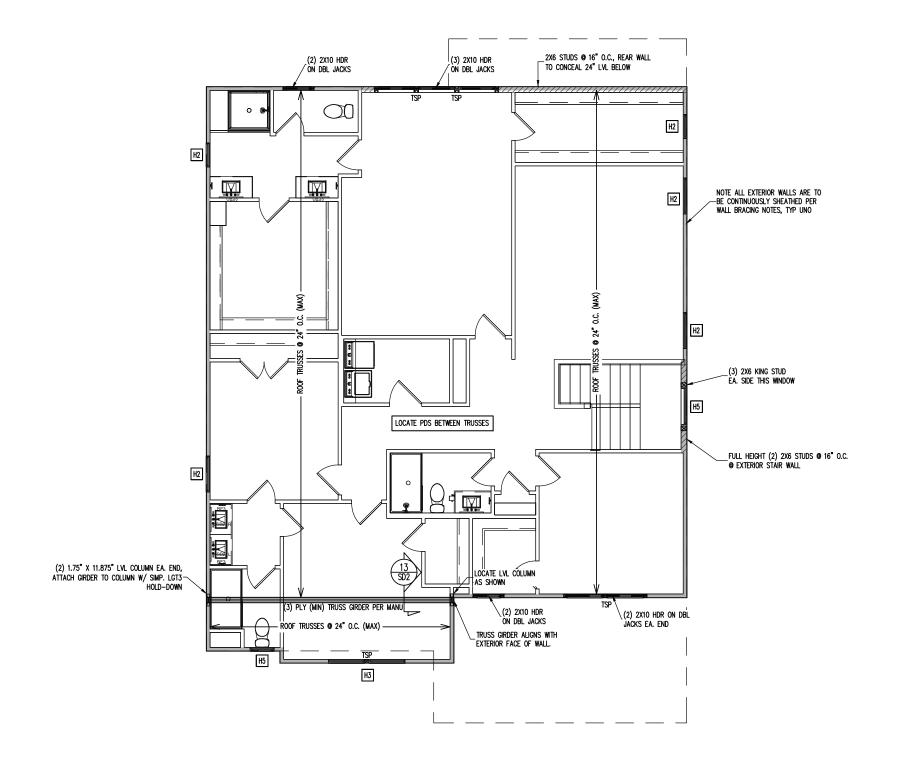
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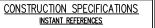
ENG: CMC/ZCH DATE: 5/28/2025 **GARNER**

CRAFTSMAN PROJECT NO. 25-65-176

SHEET NO.

S3 3 of 8





REFER TO THE CONSTRUCTION SPECIFICATIONS SECTIONS FOR THE FOLLOWING INFORMATION:

PART 1.01: CURRENT GOVERNING CODE

PART 14: STUD SUPPORT FOR BEAMS

PART 17: KING STUDS FOR EXTERIOR WALLS

SEE DETAIL / CONSTRUCTION SPECIFICATIONS SHEETS FOR I-JOISTS ALLOWABLE SUBSTITUTIONS

WALL BRACING

SHADED WALLS:

ALL EXTERIOR STUD WALLS, EXTERIOR SIDE, ARE TO BE CONTINUOUSLY SHEATHED WITH 7/16 APA RATED OSB NAILED TO STUDS WITH 8d NAILS © 6° O.C. AT PANEL EDGES, 12° O.C. IN PANEL FIELD.

PROVIDED CONTINUOUS SHEATHING = 176' MIN.

REFERENCE PART 16.02 OF CONSTRUCTION SPECIFICATIONS FOR GENERAL WIND BRACING INFORMATION.

HEADER SCHEDULE

- H1 SINGLE 2X4 TURNED FLAT (A)
- H2 (2) 2X4'S ON SINGLE JACKS (B)
- H3 (2) 2X10'S ON SINGLE JACKS (C)
- H4 (2) 1.75" X 9.25" LVL'S ON DBL JACKS
- H5 (3) 2X10'S ON SINGLE JACKS
- (A) TYPICAL FOR INTERIOR NON LOAD BEARING WALLS ONLY, ROUGH OPENING 38" MAX.
- (B) TYPICAL FOR INTERIOR NON LOAD BEARING
 WALLS ONLY, ROUGH OPNG 38" TO 74" MAX.
- (C) TYPICAL FOR ALL CONDITIONS NOT LISTED IN (A) OR (B) UNO.

-HEADERS IN NON LOAD BEARING INTERIOR WALLS ARE NOT LABELED.

2ND FLOOR FRAMING PLAN

WALLS AND CEILING 1/8" = 1'-0"

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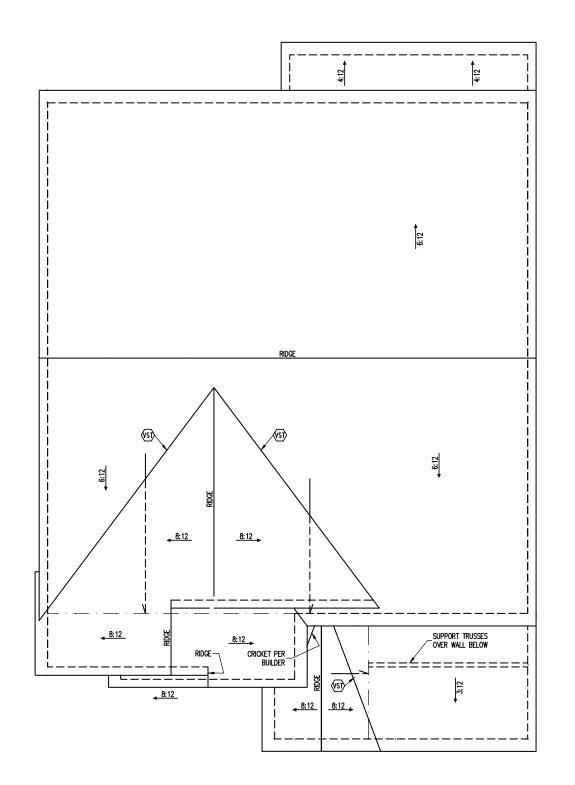
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CRAFTSMAN PROJECT NO.

> 25-65-176 SHEET NO.

S4 4 of 8





VALLEY SET TRUSSES PER MANU

FRAMING NOTES

ROOF ONLY -ROOF TRUSSES PER MANU. TYPICAL U.N.O. -VERIFY ALL HEEL HEIGHTS, ROOF PITCHES, AND ARCHITECTURAL OVERHANGS PRIOR TO CONSTRUCTION

TRUSS UPLIFT CONNECTORS EXPOSURE B. 120 MPH, ANY PITCH

EXPOSURE B. 120 MPH. ANY PITCH
24" O.C. MAX ROOF TRUSS SPACING
TRUSSES SHALL BE ATTACHED TO SUPPORT WALL
FOR UPUFT RESISTANCE. CONTINUOUS OSB WALL
SHEATHING BELOW PROVIDES CONTINUOUS UPLIFT
RESISTANCE TO FOUNDATION. ALL TRUSSES
SUPPORTED BY INTERMEDIATE SUPPORT WALLS,
KNEEWALLS OR BEAMS SHALL BE ATTACHED TO
SUPPORTING MEMBER PER SCHEDULE BELOW.

ROOF SPAN IS MEASURED HORIZONTALLY BETWEEN FURTHEST SUPPORT POINTS.

CONNECTOR NAILING PER TABLE 602.3(1) NCRBC 2018 EDITION

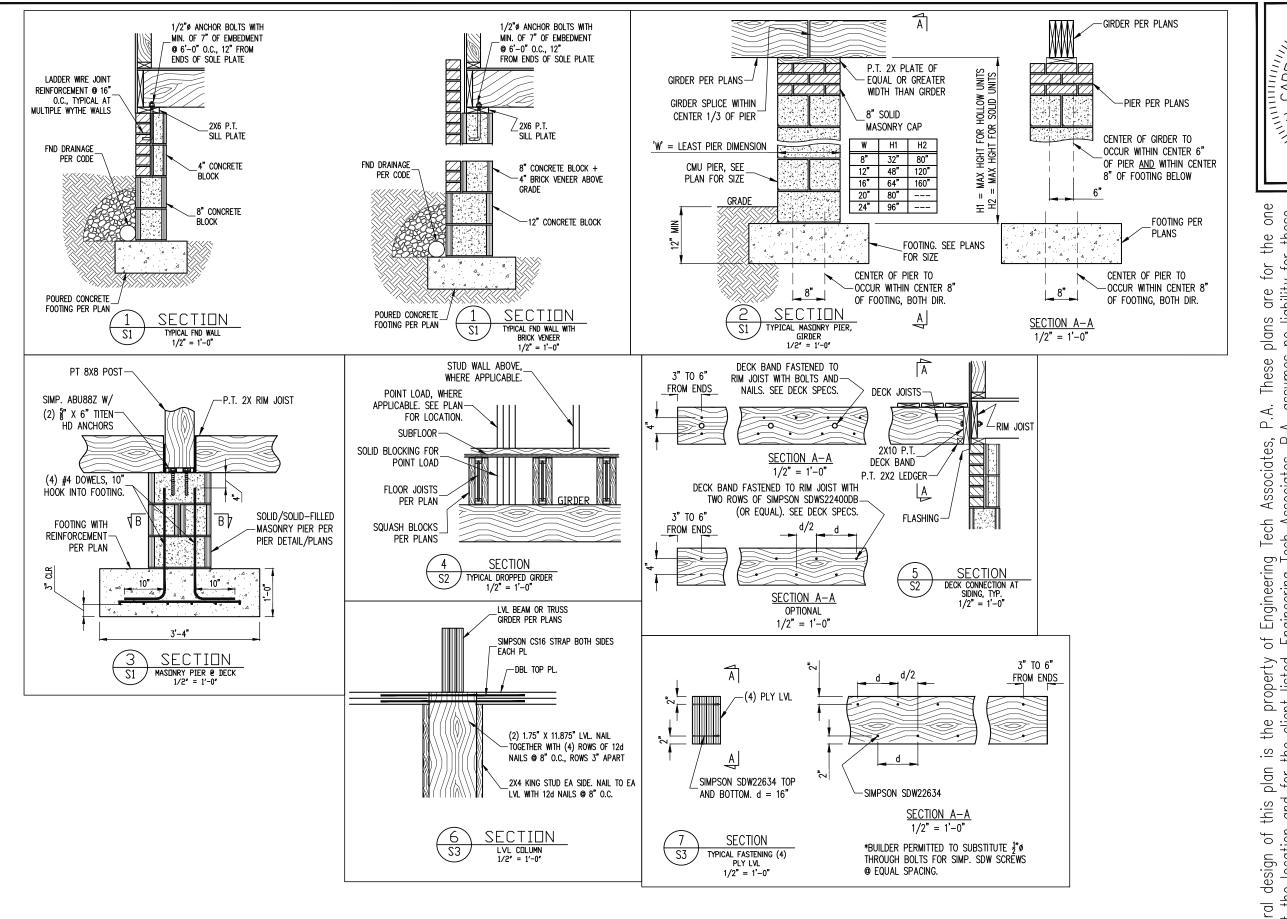
OVER 18'

(1) SIMPSON H2.5A HURRICANE CLIP TO DBL TOP PLATE OR BEAM

ROOF FRAMING PLAN

1/8" = 1'-0"

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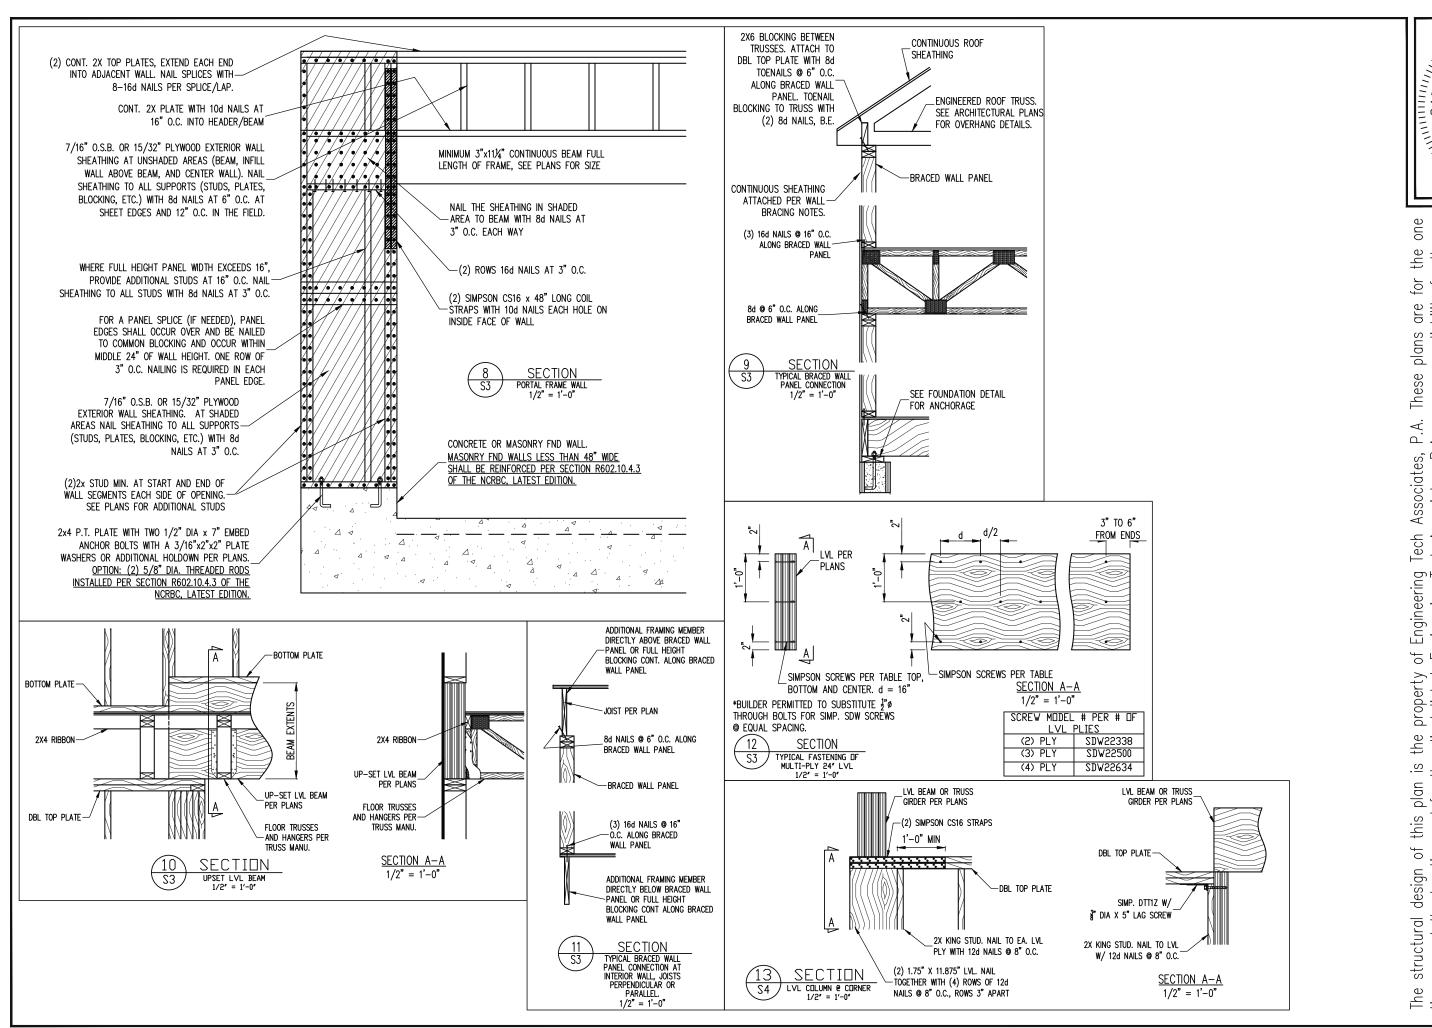
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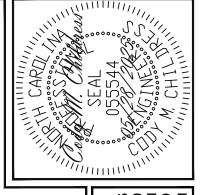
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PROJECT NO. 25-65-176

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DECKING 1" S4S 1" T&G 1 1/4" S4S one these permission the MAX POST HEIGHT for

Notes: 1) This table is based on No. 2 treated southern Pine Posts.
2) This table is based on a maximum tributary area of 128 sq. ft. 3) POST HEIGHT IS FROM TOP OF FOOTING TO BOTTOM OF GIRDER.

- DECKS SHALL BE BRACED TO PROVIDE LATERAL STABILITY BY ONE OF THE FOLLOWING METHODS:
- A. When the deck floor height is less than 4'-o" and the deck is attached to the structure in accordance with section 4, lateral bracing is not required.
- B. 4X4 WOOD KNEE BRACES MAY BE PROVIDED ON EACH COLUMN IN BOTH DIRECTIONS.
 THE KNEE BRACES SHALL ATTACH TO EACH POST AT A POINT NOT LESS THAN 1/30 FT THE POST LENGTH FROM THE TOP OF THE POST, AND THE BRACES SHALL BE ATTACHED AT BETMEEN 45° AND 60° FROM THE HORIZONTAL. KNEE BRACES SHALL BE ATTACHED AT
- C. FOR FREE STANDING DECKS WITHOUT KNEE BRACES OR DIAGONAL BRACING, LATERAL STABILITY MAY BE PROVIDED BY EMBEDDING THE POSTS IN CONCRETE IN ACCORDANCE WITH THE FOLLOWING:

st size	TRIBUT. AREA	POST HEIGHT	EMB. DEPTH	CONC. DIAM.
4X4 6X6	48 SQ. FT. 120 SQ. FT.	4'-0" 6'-0"	2'-6" 3'-6"	1'-0" 1'-8"

- D. 2X6 DIAGONAL VERTICAL CROSS BRACING SHALL BE PROVIDED IN TWO PERPENDICULAR DIRECTIONS FOR FREE STANDING DECKS OR PARALLEL TO THE STRUCTURE AT THE EXTERIOR COLUMN LINE FOR ATTACHED DECKS. THE BRACES SHALL BE ATTACHED TO THE POSTS WITH ONE -5/8 $^{\circ}$ Bolt at each end of the brace.
- Notes: 1) all nales and bolts are to be hot dipped galvanized.
 2) Minimum edge distance for Bolts is 2 1/2".
 3) Nales must penetrate the supporting structure band a minimum of 1 1/2".

REVIATION	۱S		ALLOWABLE I-JOIST SUBSTITUTION NOTE: MAINTAIN JOIST DEPTH, DIRECTION, AND SPACING SPECIFIED ON							
FOUNDATION FOOTING	TJ TYP	TRIPLE JOIST TYPICAL	NOTE: MAINTAIN PLANS.	JOIST DEPTI	H, DIRECTION	I, AND SPACING SF	PECIFIED ON			
HOT DIPPED GALVANIZED HANGER	TRPL TSP UNO	TRIPLE TRIPLE STUD POCKET UNLESS NOTED	MANUFACTURER	DEPTH	SERIES	SIMPSON FACE MOUNT HGR	SIMPSON TOP FLANGE HGR			
AMINATED VENEER LUMBER NOT TO SCALE	χJ	OTHERWISE EXTRA JOIST	BLUELINX BOISE CASCADE BOISE CASCADE			IUS2.56/11.88 IUS2.06/11.88 IUS2.37/11.88	ITS2.56/11.88 ITS2.06/11.88 ITS2.37/11.88			
ON CENTER PARALLEL STRAND LUMBER			INTERNATIONAL BEAMS	11.875*	IB 400	IUS2.56/11.88	ITS2.56/11.88			
PRESSURE TREATED			LP CORP	11.875"	LPI 20+	IUS2.56/11.88	ITS2.56/11.88			

roof and floor trusses to be designed by an engineer registered by the state. Fina truss drawing should be submitted to the EOR for review

JOISTS NOT LISTED IN THE ABOVE TABLE MAY BE USED PROVIDED THEY MEET OR EXCEED THE PROPERTIES OF THOSE LISTED. SUBSTITUTE USP BRAND HANGERS WITH EQUIVALENT VALUES AS DESIRED.

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