POPLAR RIDGE ABBREVIATIONS A A PRESSURE TREATED WD H.R. HALF ROUN HWD HARDWOOD (FL I.L.O. N LIEU OF ISUL NSULATED(TION INT NTERIOR ITC N THE CLEAR KIT KITCHEN R&M RANGE W/MICROWAV LIV LIVING LTL LINTEL LVR LOUVER MAX MAXIMUM DRY DRYER MACHINE TEMP TEMPERED (GLASS MISC MISCELLANE MULL MULLION(ED ELEC ELECTRIC(AL U.N.O. UNLESS NOTE OTHERWISE VB VANITY BASE EXTERIOR OA OVERALL F.F. FINISH FLOOR (LIN OBS OBSCURE (GLA O.H. OVERHANI OPNG OPENING WH WATER HEATER FLR FLOOR(ING FP FIREPLACE OPT OPTIONAL WIC WALK-IN CLOSE FURRED(ING) PEDESTAL (SINK) FUR W/W/O WITH or WITHOUT SULIND EVII TERPROOF(ING) CIRCUIT INTERRU **GENERAL NOTES** 1 - GENERAL BUILDING & DESIGN REQUIREMENTS 15 - MECHANICALS 1) THE ATTACHED PLANS & SPECIFICATIONS ARE THE SOLE PROPERTY OF TRI POINTE HOMES ANY UNAUTHORIZED USE OF THESE PLANS WITHOUT PRIOR WRITTEN CONSENT OF TRI POINTE HOMES IS STRICTLY) EXTERIOR AIR INTAKE FOR COMBUSTION AIR PER IRC SECTION AS REQUIRED BY LOCAL MUNICIPALITY TRI POINTE HOMES DESIGNS & BUILDS HOUSING AS SET FORTH BY THE FORMAT AND PROVISIONS OF TH INTERNATIONAL RESIDENTAL CODE (IRC), AND THE NATIONAL ELECTRIC CODE (NEC). ANY NON-CONFORMING DOCUMENTS DISCOVERED BY THE CONTRACTOR OR HIS AGENTS SHALL BE CALLED TO THE IMMEDIATE

RE SUBJECT TO MECHANICAL INSPECTION PER IRC SECTION R1002.1

16 - ELECTRICAL

ALL FLECTRICAL INSTALLATION SHALL MEET THE REQUIREMENTS OF THE NATIONAL ELECTRIC CODE (NEC). MATERIAL AND EQUIPMENT SHALL BEAR THE LABEL OF APPROVAL OF THE UNDERWRITERS ABORATORIES, INC.

) ELECTRICAL CONTRACTOR SHALL VERIFY SPACE REQUIRED FOR METER INSTALLATION BEFORE ONSTRUCTION AND SHALL NOTIFY GENERAL CONTRACTOR OF ANY DISCREPANCIES.

GROUND FAULT INTERRUPTS SHALL BE LOCATED PER THE NEC ALL SWITCHES SHALL BE INSTALLED AT 3'-6" ABOVE FINISHED FLOOR TO CENTERLINE OF SWITCH

VLESS NOTED OTHERWISE

INISHED FLOOR UNLESS NOTED OTHERWISE

ALL EXTERIOR WALL BRACKET FIXTURES SHALL BE INSTALLED AS NOTED ON PLANS.

APPROVED SMOKE DETECTORS SHALL BE LOCATED ON EVERY STORY OF THE DWELLING UNIT AS PER IRC ECTION R317 (SEE SHEET B1.1 FOR LOCATIONS). WHERE MORE THAN ONE DETECTOR IS REQUIRED THEY SHALL BE INTERCONNECTED. POWER SOURCE SHALL BE BUILDING POWER w/ BATTERY BACKUP.

BACK FILL SHALL BE FREE FROM VEGETATION AND CONSTRUCTION DEBRIS) BACK FILL SHALL BE PLACED IN LIFTS AND COMPACTED IN SUCH A MANNER AS BACKFILL TO NOT DAM.

CONSTRUCTION AND / OR FABRICATION OF THE WORK.

2 - SITE CONSTRUCTION

TTENTION OF TRI POINTE HOMES BY CALLING (469)329-0470.

THE FOUNDATION WALLS OR ANY WATERPROOFING/ DAMPPROOFING MATERIALS.

). THESE PLANS ARE SUBJECT TO MODIFICATIONS TO MEET CODE REQUIREMENTS AND/OR TO FACILITATE

MECHANICAL/ ELECTRICAL/ PLUMBING INSTALLATION AND/ OR TO IMPLEMENT DESIGN IMPROVEMENTS. ANY

PRODUCTS, INSTALLATIONS, OR FABRICATIONS IN THE FIELD PRIOR TO EXPEDITING THE CONSTRUCTION OF SUCH WORK. FIELD VERIFY ALL DIMENSIONS — DO NOT SCALE DRAWINGS!! CONTRACTOR IS RESPONSIBLE FOR SURVEYING THE PROJECT AND BECOMING FAMILIAR WITH THE EXISTING CONDITIONS AND SCOPE OF WORK

INCLUDING BUT NOT LIMITED TO SITE AND SOIL BEARING CONDITIONS.
5) ERRORS AND OMISSIONS WHICH MAY OCCUR IN THE CONTRACT DOCUMENTS SHALL BE BROUGHT TO THE

OF THE ARCHITECT, IN WRITING, AND WRITTEN INSTRUCTION SHALL BE OBTAINED FROM TO PROCEEDING WITH CONSTRUCTION. THE CONTRACTOR SHALL BE OBTAINED PRIOR TO PROCEEDING WITH CONSTRUCTION. THE CONTRACTOR SHALL BE HELD RESPONSIBLE FOR ANY ERRORS, DISCREPANCIES, OR OMISSIONS FOR WHICH THE CONTRACTOR FAILED TO NOTIFY THE ARCHITECT PRIOR TO

INTENTION TO MODIFY THESE PLANS MUST BE APPROVED IN WRITING BY TRI POINTE HOMES
4) CONTRACTOR SHALL BE RESPONSIBLE FOR VERIFYING ALL DIMENSIONS AFFECTING CONTRACTOR'S

1) SLOPE ON GARAGE SLAB SHALL BE 1/8" PER FOOT TOWARDS VEHICLE DOOR. SLOPE ON PORCH AND

4 - MASONRY

3 - CONCRETE

ALL EXTERIOR BRICK MUST MEET ASTM C-216 FOR "SW" CONDITIONS

2) MASONRY VENEER SHALL BE ATTACHED TO SUPPORTING WALLS W/ CORRUGATED METAL TIES IN ACCORDANCE WITH R703.7.4.1 - I.R.C. OR LOCAL CODE REQUIREMENTS

) WEEPHOLES SHALL BE PROVIDED ALONG THE OUTSIDE WYTHE OF EXTERIOR MASONRY WALLS AT 33" O.C. MAX, SHALL BE A MIN. OF 3/16" IN DIAMETER, AND LOCATED IMMEDIATELY ABOVE THE FLASHING PER 18703.7.6 – LR.C.

5 - METALS

6 - WOOD AND PLASTICS

7 - THERMAL & MOISTURE PROTECTION

) Fire stopping and/ or draft stopping shall meet the requirements of IRC R602.8. 2) Attic ventilation shall be provided at 1/300 th of the Area of the Space ventilated. Cross VANILATION WITH HALF OF THE VENTILATED AREA SHALL BE PROVIDED BY ROOF VENTS AND THE OTHER HALF BY SOFFIT VENTS. VENTS SHALL BE PLACED SO AS TO NOT ALLOW INFILTRATION OF RAIN OR SNOW. S) PROVIDE APPROVED TILE BACKER DRYWALL FOR ALL SHOWER AND BATH SPACE
B) PROVIDE ATTIC VENTILATION PER IRC-R806.1

8 - DOORS AND WINDOWS

-) REVIEW ALL WINDOW HDR HEIGHTS PER PLATE HT. AND VERIFY W/ ELEVATIONS AND CORNICE DETAILS TEMPERED GLASS SHALL BE USED IN HAZARDOUS AREAS AS DESCRIBED IN SECTION R308.4 - LR.C.
- FRONT DOOR WIDTH PER IRC-R311.3
- GARAGE DOOR PER IRC-R309.1

FMERGENCY EGRESS SHALL MEET REQUIREMENTS OF SECTION R310 - LR C 2018 - SLEEPING ROOMS HALL HAVE AT LEAST ONE EGRESS OPENING OF NOT LESS THAN 5.7 SF AND A CLEAR OPENING OF NOT LESS THAN 20" WIDE X 24" HIGH AND SHALL NOT BE MORE THAN 44" ABOVE THE FLOOR

WOOD BUILT CHIMNEYS AND FIREPLACES SHALL BE INSTALLED PER MANUFACTURER'S INSTRUCTIONS AND

VERIFY LOCATION OF ALL RECEPTACLES FOR APPLIANCES WITH MANUFACTURER SPECIFICATIONS.

) ALL CONVENIENCE OUTLETS SHALL BE INSTALLED W/ CENTERLINE OF OUTLET LOCATED 1'-3" ABOVE

ALL CONVENIENCE OUTLETS WITH SWITCHES TO BE SWITCH AT TOP ONLY.

)) CONDUCTORS SHALL BE OF COPPER.

GENERAL FRAMING SPECS AND CONSTRUCTION NOTES STAIRS:

1) THE MAXIMUM RISER HEIGHT SHALL BE 7 3/4 INCHES AND THE MINIMUM TREAD DEPTH SHALL BE 10 NCHES IN ACCORDANCE WITH SECTION I.R.C.

HANDRAILS HAVING MINIMUM AND MAXIMUM HEIGHTS OF 34 INCHES AND 38 INCHES SHALL BE OVIDED ON AT LEAST. ONE SIDE OF STAIRWAYS IN ACCORDANCE WITH SECTION R315.1 - I.R.C HANDRAIL AND BALUSTRADE (WHERE PRESENT) SHALL BE CONSTRUCTED ACCORDING TO IRC. ALL REQUIRED HAND RAILS SHALL BE CONTINUOUS THE FULL LENGTH OF THE STAIRS W/ 2 OR MORE SERS FROM A POINT ABOVE THE THE TOP RISER OF A FLIGHT TO A POINT ABOVE THE LÓWEST RISER OF THE FLIGHT. ENDS SHALL BE RETURNED OR SHALL TERMINATE AT NEWEL POSTS OR SAFETY TERMINALS. ANDRAILS ADJACENT TO A WALL SHALL HAVE A SPACE OF NOT LESS THAN 1.5" BETWEEN THE WALL

WALLS:

) ALL DIMENSIONS ARE FROM FACE OF STUD TO FACE OF STUD. ALL STUDS ARE 3 1/2" UNLESS NOTED. ALL DIMENSIONS PRESENTED HERE ARE FRAME DIMENSIONS ONLY.

I SEPARATION BETWEEN THE RESIDENCE AND THE GARAGE SHALL BE MAINTAINED BY INSTALLATION OF $rac{1}{2}^{n}$ GYPSUM BOARD ON ALL COMMON WALLS. 2-STORY HOMES REQUIRE 5/8" TYPE X GYPSUM BOARD AT CARAGE CEILINGS WHERE HABITABLE ROOMS ARE PRESENT ABOVE.

FLOORS:

STRUCTURAL FLOOR MEMBERS SHALL NOT BE CUT, BORED, OR NOTCHED IN EXCESS OF THE LIMITATIONS ECIFIED IN IRC

) THE ENDS OF EACH JOIST, BEAM, OR GIRDER SHALL HAVE NOT LESS THAN 1.5 INCHES OF BEARING ON WOOD OR METAL AND NOT LESS THAN 3 INCHES ON MASONRY OR CONCRETE OR AS OTHERWISE SPECIFIED

) ALL DIMENSIONAL FLOOR JOISTS TO BE PER ENGINEER STRUCTURAL PLANS.

FRAMING:

ALL FRAMING DIMENSIONS TO FACE OF MEMBER.

L BEARING HEADERS TO BE PER ENGINEERING PLANS. FIRE STOPPING AND / OR DRAFT STOPPING SHALL MEET THE REQUIREMENTS OF IRC R602.8.

ROOF

) HIP AND VALLEY RAFTERS SHALL BE SUPPORTED AT RIDGE DOWN TO BEARING PARTITION. CUT ENDS OF AFTERS SHALL BE FULLY SUPPORTED WALL AND RIDGE

) REQUIRED VENTILATION AREAS CALCULATED AT 1/300 RATIO.

SQUARE FOOTAGE

(Slab S.F.)	
Slab Area	Sq. Ft.
FIRST FLOOR	2527
2 BAY GARAGE	497
PORCH	73
COVERED OUTDOOR LIVING	215
Total Slab Area	3312

Elevation "C"

(Outside of Frame S.F.) Ion-A/C Area BAY GARAGE

OVERED OUTDOOR LIVING

(Inside of Frame S.F.)

NOTE: ALL OPTIONAL SQUARE FOOTAGES LISTED ARE INDEPENDENT OF AND IN ADDITION TO BASE SQUARE FOOTAGES.

OPTIONS	
KT. COV. OUTDOOR LIVING	+125
OFT	+763

UNDER 9,000

FIRE RATE **GARAGE SIDE**

BUILDING CODE COMPLIANCE

CONSTRUCTION PLANS DESIGNED TO MEET OR EXCEED MINIMUM CODE REQUIREMENTS OF 2018 LR (

ELECTRICAL PLANS DESIGNED TO MEET OR EXCEED MINIMUM

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SHEET LEGEND				
SHEET NO. TYPE OF SHEET/LAYOUT				
"G0.01"	COVER SHEET & GEN. NOTES			
"G0.11"	REVISIONS & SYMBOLS			
"S1.10C"	BASE FOUNDATION PLAN - ELEVATION 'C'			
"A1.10C"	FIRST FLOOR PLAN - ELEVATION 'C'			
"01.A10"	FLOOR PLAN OPTIONS			
"01.A20"	"01.A20" FLOOR PLAN OPTIONS			
"01.A30" 2ND FLOOR PLAN OPTION				
"A2.01C"	EXTERIOR ELEVATIONS - 'C'			
"A2.02C"	EXTERIOR ELEVATIONS — 'C'			
"A2.03C" EXTERIOR ELEVATIONS OPTIONS – 'C'				
"A2.04C" EXTERIOR ELEVATIONS OPTIONS – 'C'				
"A3.01C" ROOF PLAN - ELEVATION 'C'				
"A3.02C" ROOF PLAN - ELEVATION 'C' - EXTENDED COVERED OUTDOOR LIVING				
"A4.01" INTERIOR DETAIL SHEET				
"A4.02"	Interior detail sheet			
"E1.10C"	1ST FLR. ELECTRICAL PLAN — ELEVATION 'C'			
"E1.11C"	1ST FLR. ELECTRICAL PLAN UPGRADE OPTIONS — ELEVATION 'C'			
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"01.E20"	2ND FLR. ELECTRICAL PLAN OPTION			
"01.E21"	2ND FLR. ELECTRICAL PLAN UPGRADE OPTION			
	Let 074 5004 00 Floort's 0			

Lot 371 - 5921-09 - Elevation C

*12'x8' Multi Slide Door at Dining Room *Bath 2 Shower ILO Tub w/ Tile Walls

*Bath 3 Shower ILO Tub w/ Tile Walls

*Optional Primary Bath 3 w/ Zero Entry Pan

*Tray Ceiling Primary Bedroom

*Mahogany Front Door

*Heatilator Novus 36" Gas Fireplace

*Fully Insulated Garage

*Tray Ceiling at Great Room

*Optional 8' Interior Doors at First Floor

*Optional Prep Zone

*Gourmet Kitchen Layout w/ Cooktop & Appliance Hood

*Laundry Sink w/ Base Cabinets & Upper Cabinets

*Optional Outdoor Living Patio 1

*Optional Outdoor Fireplace

*Exterior Gas Stub Out

*Optional Finished 2nd Floor

*Open Rail w/ Curb Wall & Stained Stair Treads at 1st to 2nd Floor

*Recirculating Tankless Water Heater

SYMBOLS PLYWOOD ELEVATION KEY OR SECTION KEY TUB/SHOWER INSULATING SHEATHING CENTERI INF BATT INSULATION CEILING TRANSITION LINE LAVATORY RIGID HOSE BIB (FREEZE PROOF) 6 DBL SINK CONCRETE GAS LINE STUB TOWEL BAR SAND OR GRAVEL LAUNDRY SINK PAPER HOLDER STONE 2x FRAME TOWEL RING PEDESTAL SINK SHOWER HEAD BRICK VENEER WATER CLOSET SHOWER CONTROLS ++ STONE VENEER

DointeHOMES

Blvd Business Operation 5440 Wade Park Blv Suite 400 Raleigh, NC 27607

GENERAL ઝ

SHEETSUBDIVISION:

10-08-24 Issue Date: ACC

ADDRESS: LOT:

5921-09

POPLAR RIDGE

G0.01

REU J DESCRIPTION REU PLAN DESCRIPTION REV PLAN ADED ATTIC PLAL -DOWN, BENSED ROJ/SHEE IN PRIMARY MC, ADED OPTIONS - SCREENED COMERD OUTDOOR LUWN, COURNET WITCHED (1)/727/2025 WITCHEN, 1250 DINNY SHOWER AT PRIMARY BATH, ADDED TRAIL SERROLAMINON VENTS AT VARIOUS ELEVATIONS, REVISID BENCH LEFAIL, ADDED OPT, LANDROY CARRIETS, ADDED 120; 4-LED LURIS IN CARACE, REVISED BENCH LEFAIL, ADDED OPT, LANDROY CARRIETS, ADDED 120; 4-LED LURIS IN CARACE, REVISED BENCH LEFAIL, ADDED ORDER ADDESSNE SHOWER SHOWER SHOWN FOR SHOWER OF THE SHOW AND SHOWER SHOW AND ADDED ORDER TO PRIMARY BATH, ADDED CONTROL TO SHOWER, REVISED BENCH OF TO SHOWER, SHOWER OF THE SHOW AND ADDED ORDER TO PRIMARY BATH, ADDED CONTROL TO SHOWER SHOWER SHOWER SHOWER SHOWER OF THE SHOW AND ADDED ORDER TO PRIMARY BATH, ADDED CONTROL THOUGH PRIMARY BATH, ADDED COURNET KITCHEN INTERIOR, REVISED BENCH BENCH SHOW AND PRIMARY BATH. DESCRIPTION OF THE SHOWER OF THE SHOWED PRIMARY BATH ADDED COUNTROL THE SHOW AND PRIMARY BATH. DESCRIPTION OF THE SHOWER SHOWER SHOWED PRIMARY BATH. DESCRIPTION OF THE SHOWER	DRAWN BY ACC
5921-09 NEW PLAN 10/08/2024 ADDED ATTIC PULL-DOWN, REVISED ROD/SHELF IN PRIMARY W.C., ADDED OPTIONS - SCREENED COVERED OUTDOOR LIVING, GOURMET KITCHEN KITCHEN, ZERO ENTRY SHOWER AT PRIMARY BATH, ADDED TIMM SURROUNDING VENTS AT VARIOUS ELEVATIONS, REVISED BENCH DETAIL, ADDED DT. LAUNDRY CABINETS, ADDED C1/4 - LED LICHTS IN GARAGE, REVISED ELECT LICHTING AND SWITCHES IN PRIMARY BATH, ADDED DISHWASHER ACCESSIBLE DISCONNECT SWITCH AND COUNTER-TOP AIR SWITCH FOR DISPOSAL NOTES ADDED SHOWER NICHE NOTE, ADDED CURB TO SHOWERS, REVISED INT/EXT FIREPLACE DEPTHS, REVISED OPENING HEADER HEIGHTS THROUGHOUT, REVISED REAR EXTERIOR DOOR TO 3°, ADDED DOOR HEIGHTS TO MAIN FLOOR NOTES, ADDED BATH ACCESSORY HEIGHTS TO MAIN FLOOR NOTES, ADDED BATH ACCESSORY HEIGHTS TO MAIN FLOOR NOTES, ADDED DEPTHS, WORD PARTIAL SHOWER PRIMARY BATH 2 OPTION, ADDED OUTDOOR LUVINO PARTO POTON 1 & 2, ADDED PARTIAL SHOWER	ACC
ADDED SHOWER NICHE NOTE, ADDED CURB TO SHOWERS, REVISED INT/EXT FIREPLACE DEPTHS, REVISED OPENING HEADER HEIGHTS THROUGHOUT, REVISED REAR EXTERIOR DOOR TO 3', ADDED DOOR HEIGHTS TO MAIN FLOOR NOTES, ADDED BATH ACCESSORY HEIGHTS TO MAIN FLOOR NOTES, ADDED ZERO ENTRY SHOWER DETAIL, REMOVED PRIMARY BATH 2 OPTION, ADDED OUTDOOR LIVING PATIO OPTION 1 & 2, ADDED PARTIAL SHOWER	
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HOMES

S440 WADE PARK BLVD, SUITE 400, RALEIGH, NC 27607

Business Operations 5440 Wade Park Blvd Suite 400 Raleigh, NC 27607

REVISIONS & SYMBOLS
SUBDIVISION:
ADDRESS:
LOT:


Issue Date: 10-08-24

Drawn By: ACC

PLAN #: 5921-09

PLAN NAME:
POPLAR RIDGE

G0.11

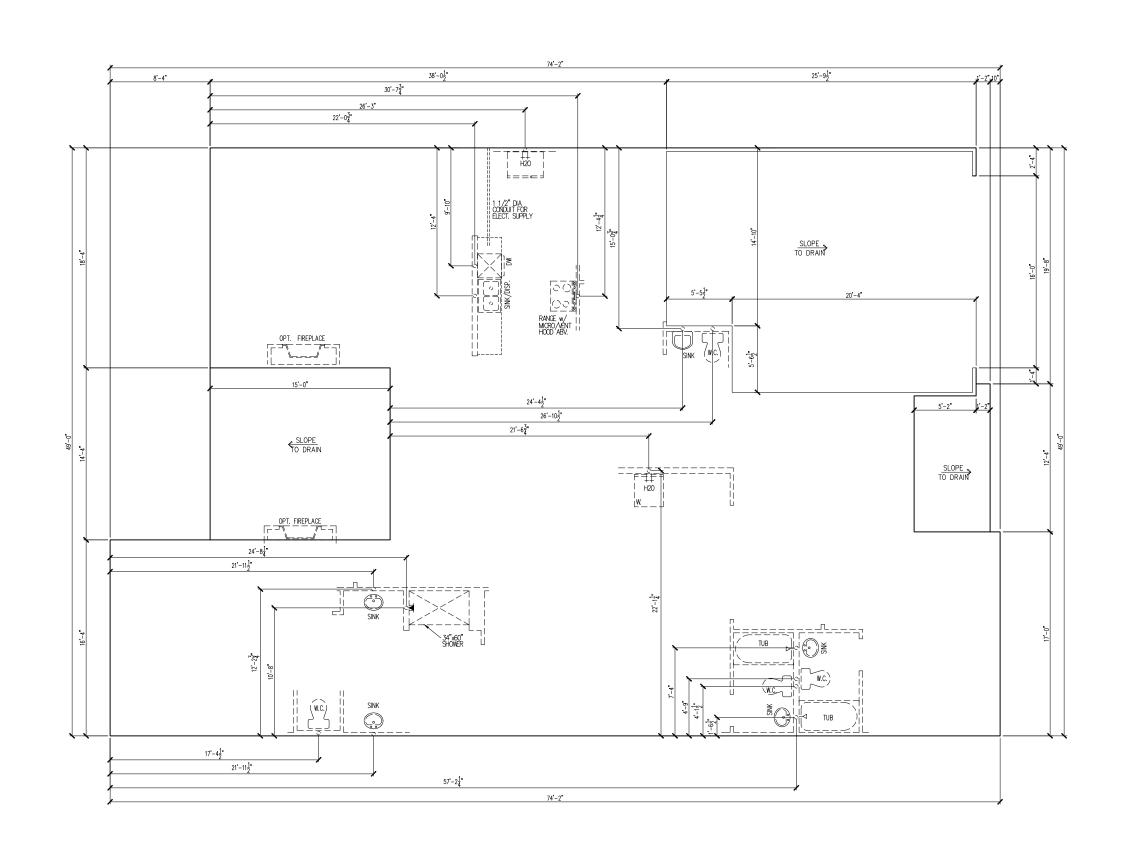

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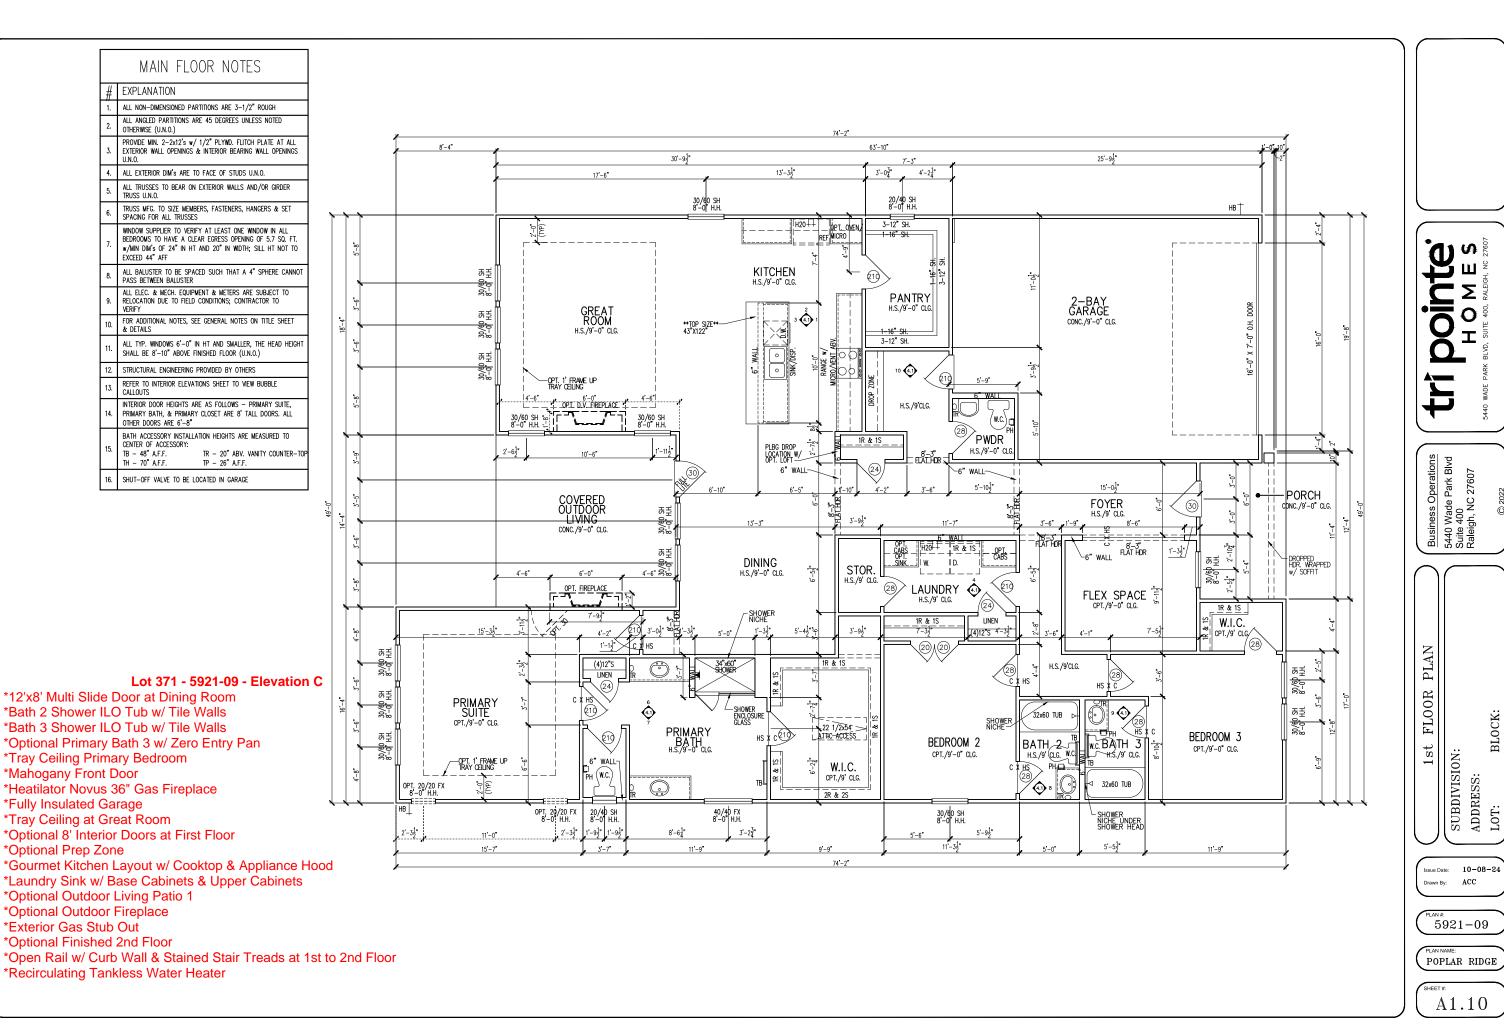
BASE FOUNDATION PLAN SUBDIVISION:
ADDRESS:
LOT:


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5921-09


PLAN NAME:
POPLAR RIDGE

SHEET #: S1.10C





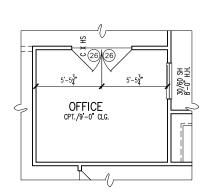

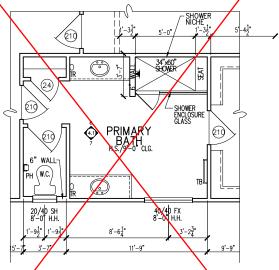





32x60 SHOWER


OPT. SHOWER ILO TUB AT BATH 2 -PARTIAL FLOOR PLAN


SHOWER NICHE UNDER SHOWER HEAD

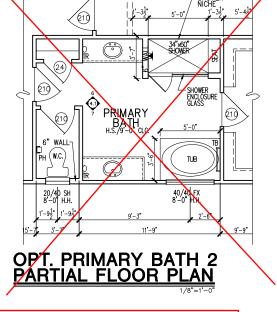

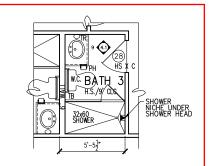


OPT. SHOWER ILO TUB AT BATH 3 -PARTIAL FLOOR PLAN

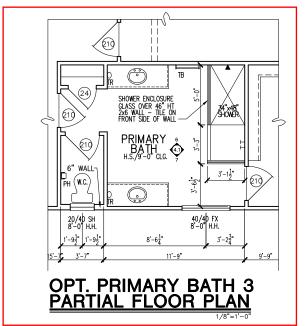

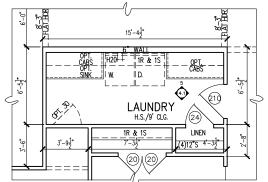



OPT. LAUNDRY PARTIAL FLOOR PLAN

NOT AVAILABLE WITH LOFT OPT.

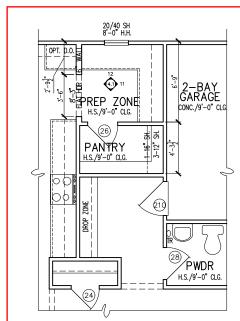




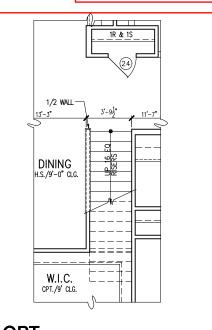

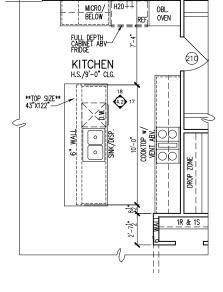



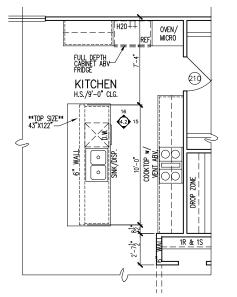

OPT. GOURMET KITCHEN 1 - PARTIAL PARTIAL FLOOR PLAN Business Operations 5440 Wade Park Blvd Suite 400 Raleigh, NC 27607

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OPTIONS PLAN FLOOR SUBDIVISION: ADDRESS: LOT:

10-08-24 Issue Date: ACC

5921-09

POPLAR RIDGE

01.A10

OTHERWISE (U.N.O.) PROVIDE MIN. 2-2x12's w/ 1/2" PLYWD. FLITCH PLATE AT ALL EXTERIOR WALL OPENINGS & INTERIOR BEARING WALL OPENINGS 4. ALL EXTERIOR DIM'S ARE TO FACE OF STUDS U.N.O. ALL TRUSSES TO BEAR ON EXTERIOR WALLS AND/OR GIRDER TRUSS U.N.O. TRUSS MFG. TO SIZE MEMBERS, FASTENERS, HANGERS & SET SPACING FOR ALL TRUSSES WINDOW SUPPLIER TO VERIFY AT LEAST ONE WINDOW IN ALL BEDROOMS TO HAVE A CLEAR EGRESS OPENING OF 5.7 SQ. FT. w/MIN DIM's OF 24" IN HT AND 20" IN WIDTH; SILL HT NOT TO ALL BALUSTER TO BE SPACED SUCH THAT A 4" SPHERE CANNO PASS BETWEEN BALUSTER ALL ELEC. & MECH. EQUIPMENT & METERS ARE SUBJECT TO RELOCATION DUE TO FIELD CONDITIONS; CONTRACTOR TO

MAIN FLOOR NOTES

ALL NON-DIMENSIONED PARTITIONS ARE 3-1/2" ROUGH

EXPLANATION

FOR ADDITIONAL NOTES, SEE GENERAL NOTES ON TITLE SHEET & DETAILS

ALL TYP. WINDOWS 6'-0" IN HT AND SMALLER. THE HEAD HEIGH SHALL BE 8'-10" ABOVE FINISHED FLOOR (U.N.O.)

12. STRUCTURAL ENGINEERING PROVIDED BY OTHERS


REFER TO INTERIOR ELEVATIONS SHEET TO VIEW BUBBLE CALLOUTS


INTERIOR DOOR HEIGHTS ARE AS FOLLOWS - PRIMARY SUITE, PRIMARY BATH, & PRIMARY CLOSET ARE 8' TALL DOORS. ALL OTHER DOORS ARE 6'-8"


BATH ACCESSORY INSTALLATION HEIGHTS ARE MEASURED TO CENTER OF ACCESSORY: TR - 20" ABV. VANITY COUNTER-TO TP - 26" A.F.F. TB - 48" A.F.F.

SHUT-OFF VALVE TO BE LOCATED IN GARAGE


OPT. SECOND FLOOR STAIR FLOOR PLAN

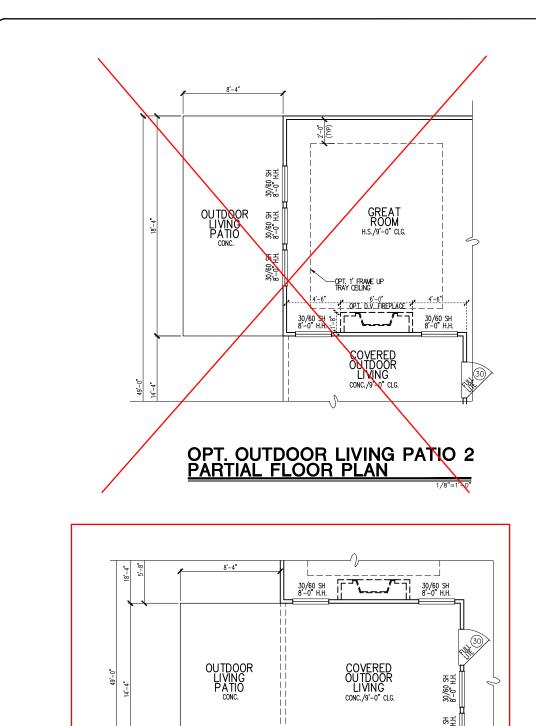

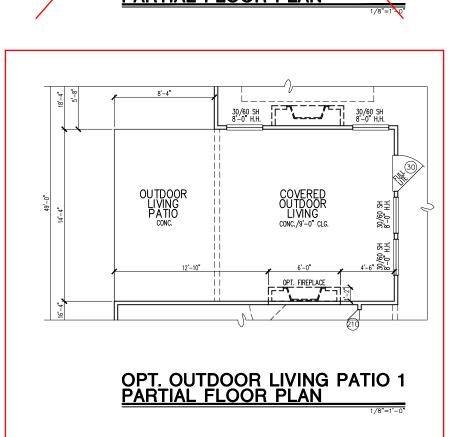


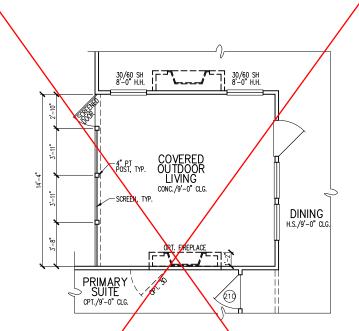




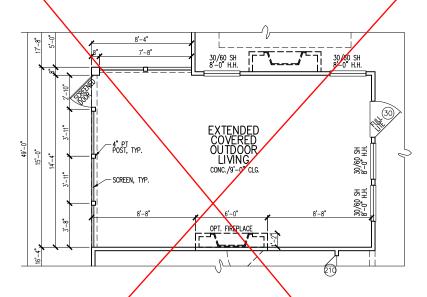

OPT. SCREENED EXTENDED COVERED OUTDOOR LIVING PARTIAL FLOOR PLAN

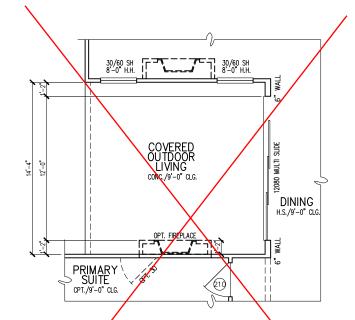

OPT. 12080 MULTI SLIDE DOOR AT DINING ROOM PARTIAL FLOOR PLAN

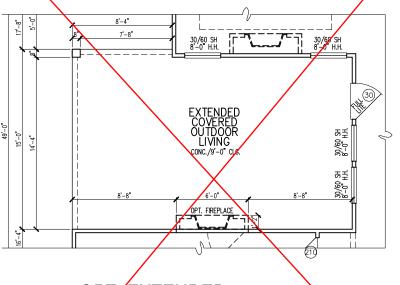

OPT EXTENDED
COVERED OUTDOOR LIVING
PARTIAL FLOOR PLAN

ACC

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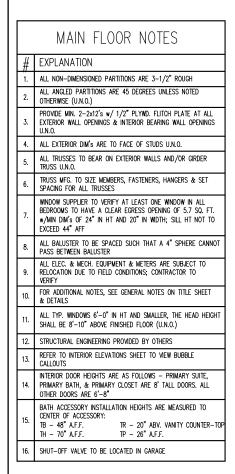
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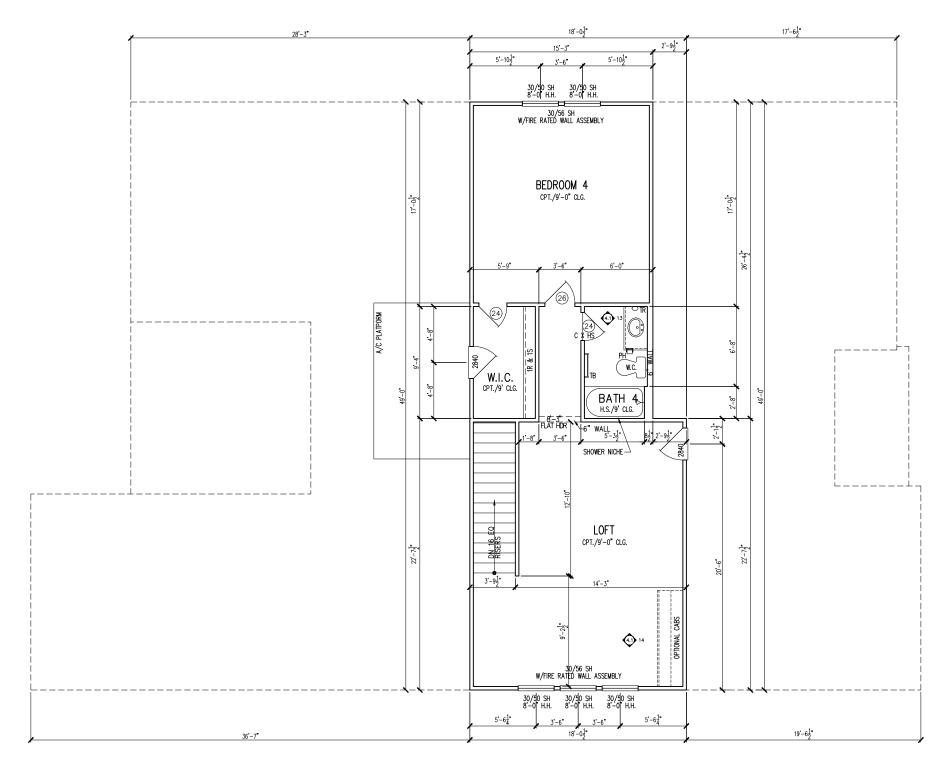
PLAN

FLOOR

POPLAR RIDGE

01.A20





OPT. SECOND FLOOR PLAN PARTIAL FLOOR PLAN tri pointe.
H O M E S
540 WADE PARK BLVD, SUITE 400, RALEIGH, NC 22807

Business Operations 5440 Wade Park Blvd Suite 400 Raleigh, NC 27607

OPTION Business | 5440 Wade |

SUBDIVISION:
ADDRESS:
LOT: BLOCK:


Issue Date: 10-08-24


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5921-09

POPLAR RIDGE

01.A30



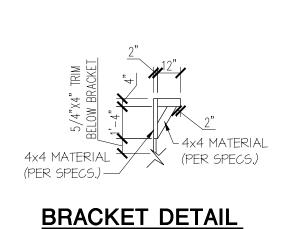


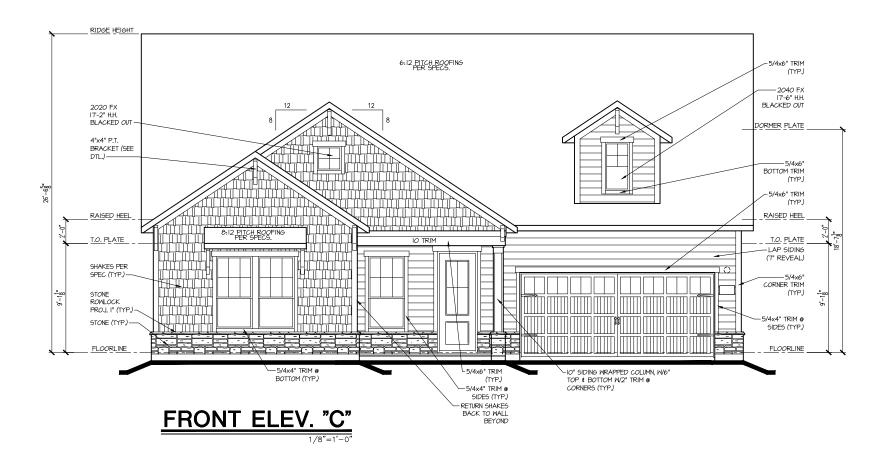6:12 PITCH ROOFING

6:12 PITCH ROOFING

5:4*XIO* TRIM (TYP)

OPT. 9'x8' SLIDING GLASS DOOR @ GREAT ROOM PARTIAL REAR ELEVATION

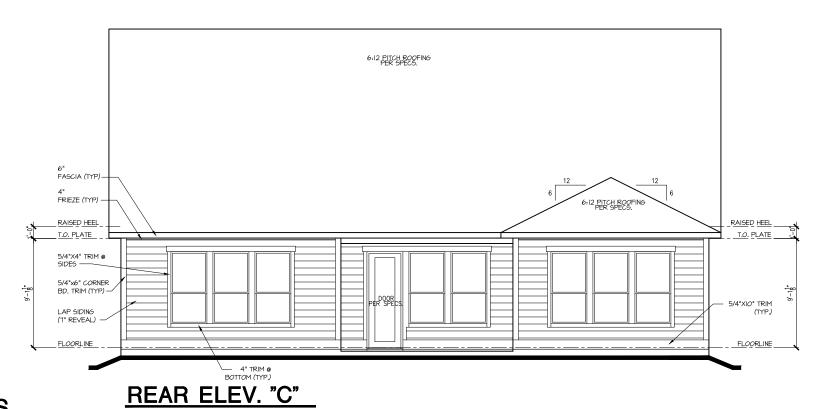

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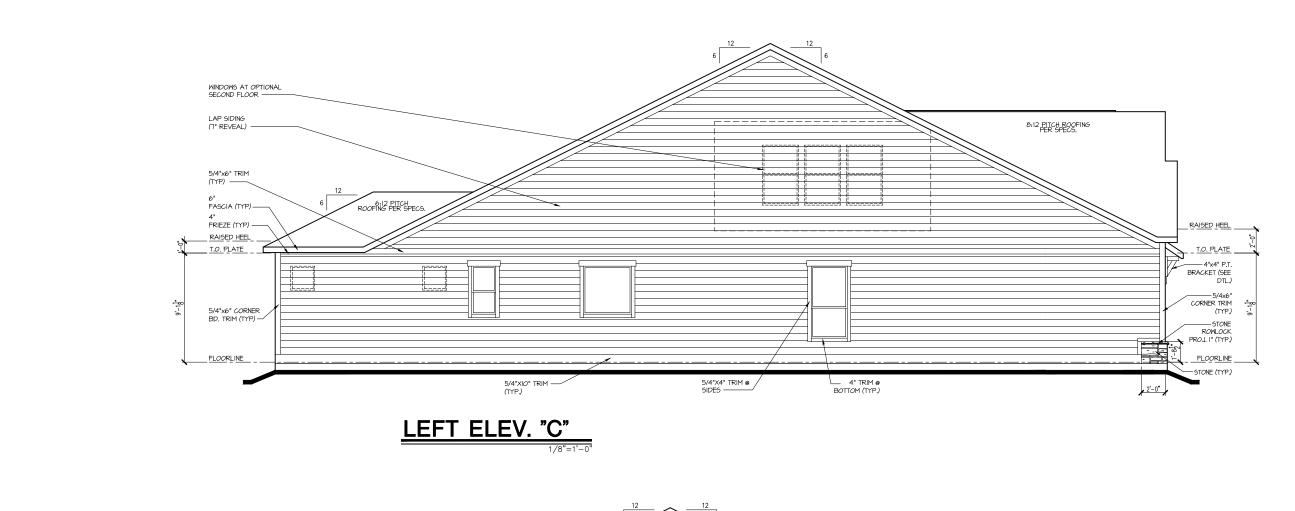
EXTERIOR ELEVATIONS
SUBDIVISION:
ADDRESS:
LOT: BLOCK:


Issue Date: 10-08-24
Drawn By: ACC

5921-09

POPLAR RIDGE

A2.01C



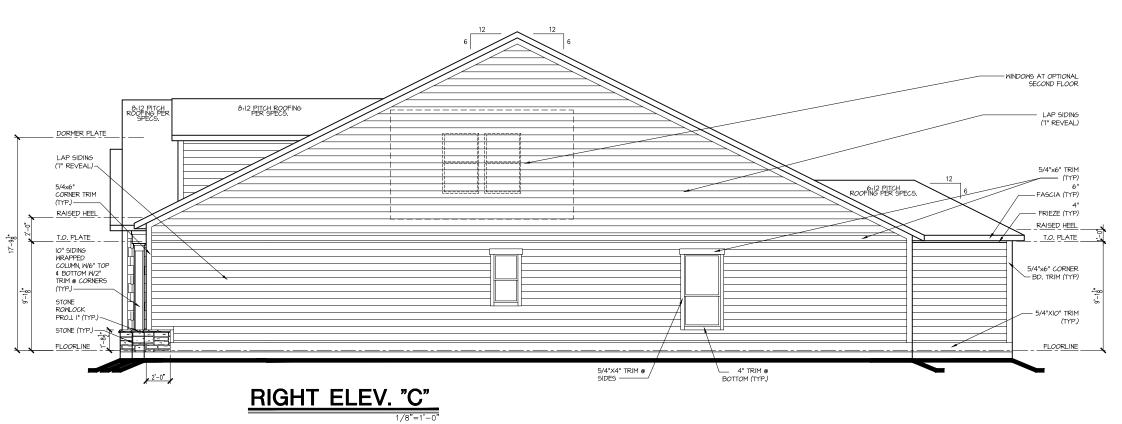

Dointe, HOMES

RR BLD. SUITE 400, RALEIGH, NG 27607 4

Business Operations 5440 Wade Park Blvd Suite 400 Raleigh, NC 27607

EXTERIOR ELEVATIONS SUBDIVISION:
ADDRESS:
LOT: BI


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Issue Date: 10-08-24 Drawn By: ACC


5921-09

POPLAR RIDGE

A2.02C

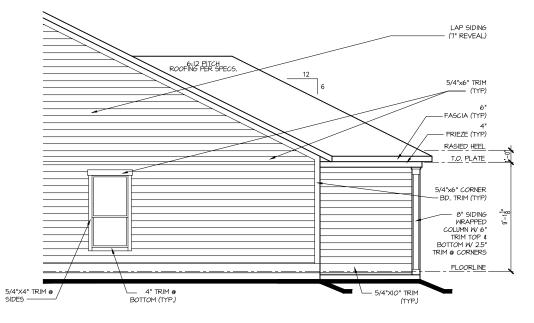

OPTIONAL EXTENDED COVERED OUTDOOR LIVING PARTIAL RIGHT ELEVATION

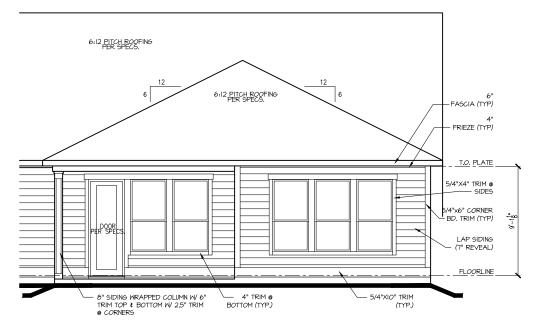

OPTIONAL EXTENDED COVERED OUTDOOR LIVING PARTIAL REAR ELEVATION

Dointe HOMES ** BLYD. SALEIGH, NG 27607

Business Operations 5440 Wade Park Blvd Suite 400 Raleigh, NC 27607

OPTION EXTERIOR ELEVATIONS

SUBDIVISION:
ADDRESS:
LOT: BI

Issue Date: 10-08-24 Drawn By: ACC

5921-09

POPLAR RIDGE

A2.03C

ROOFING PER SPECS. 12 6 5/4'x6' TRIM (TYP) FASCIA (TYP) RASIED HEEL 1.0, PLATE 1.0, PLATE SIDES 4' TRIM 0 BOTTOM (TYP) SOREEN, TYP SCREEN, TYP SCREEN, TYP-

OPTIONAL SCREENED EXTENDED COVERED OUTDOOR LIVING PARTIAL RIGHT ELEVATION

1/8"=1'-0"

1/8"=1'-0"

6 12 PITCH ROOFING

FASCIA (TYP)

4* FRIEZE (TYP)

5/4*X4* TRIM #

5/4*X4* TRIM #

5/4*X4* TRIM #

LAP SIDING

(T' REVEAL)


FLOORLINE

FLOORLINE

FLOORLINE

FLOORLINE

OPTIONAL SCREENED EXTENDED COVERED OUTDOOR LIVING PARTIAL REAR ELEVATION

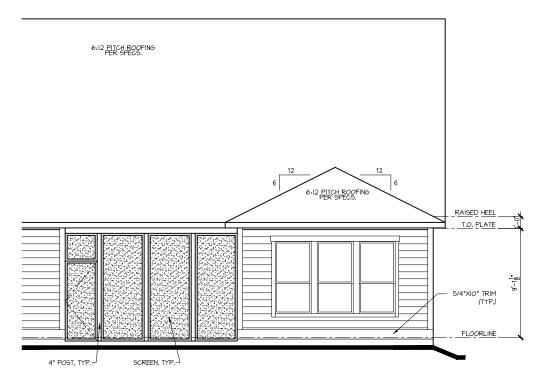

OPTIONAL SCREENED COVERED OUTDOOR LIVING PARTIAL REAR ELEVATION tribointe HOMES 540 WADE PARK BLVD, SUITE 400, RALEIGH, NG 27607

Business Operations 5440 Wade Park Blvd Suite 400 Raleigh, NC 27607


EXTERIOR ELEVATIONS – OPTION
SUBDIVISION:
ADDRESS:
LOT: BLOCK:

Issue Date: 10-08-24
Drawn By: ACC

5921-09

POPLAR RIDGE

A2.04C

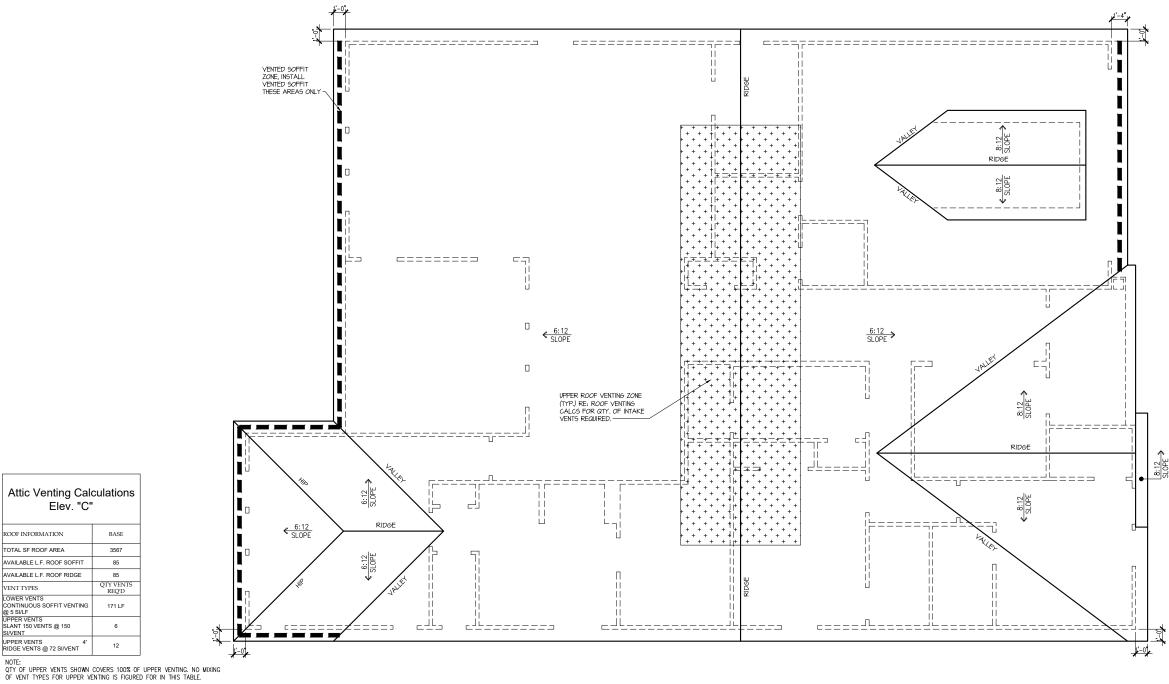

VENT TYPES
LOWER VENTS
CONTINUOUS SOFFIT VENTING
@ 5 SILF
UPPER VENTS
SLANT 150 VENTS @ 150
SIVENT
UPPER VENTS
RIDGE VENTS @ 72 SI/VENT

VENT TYPES

ROOF INFORMATION

TOTAL SF ROOF AREA AVAILABLE L.F. ROOF SOFFIT

AVAILABLE L.F. ROOF RIDGE

Elev. "C"



Dointe HOMES RR BLD, SUITE 400, RALEIGH, NG 27607

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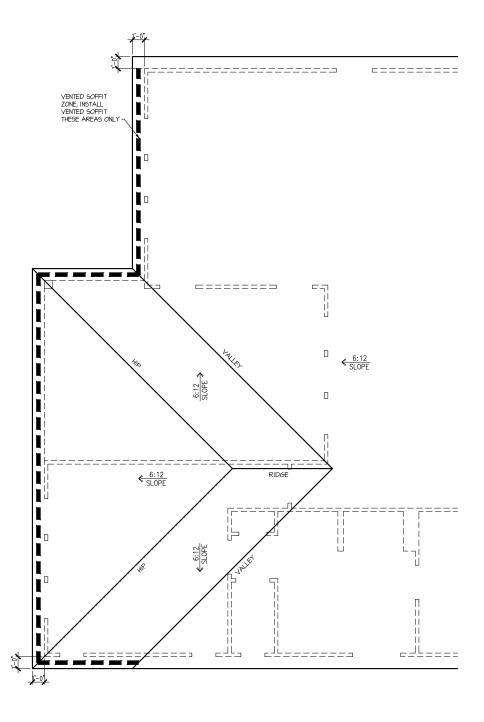
PLAN ROOF BLOCK: SUBDIVISION:
ADDRESS:
LOT: BI

Issue Date: 10-08-24 Drawn By: ACC

5921-09

POPLAR RIDGE

A3.01C



OPT. EXTENDED OUTDOOR LIVING ROOF PLAN

Dointe, HOMES

RELIA ON ES

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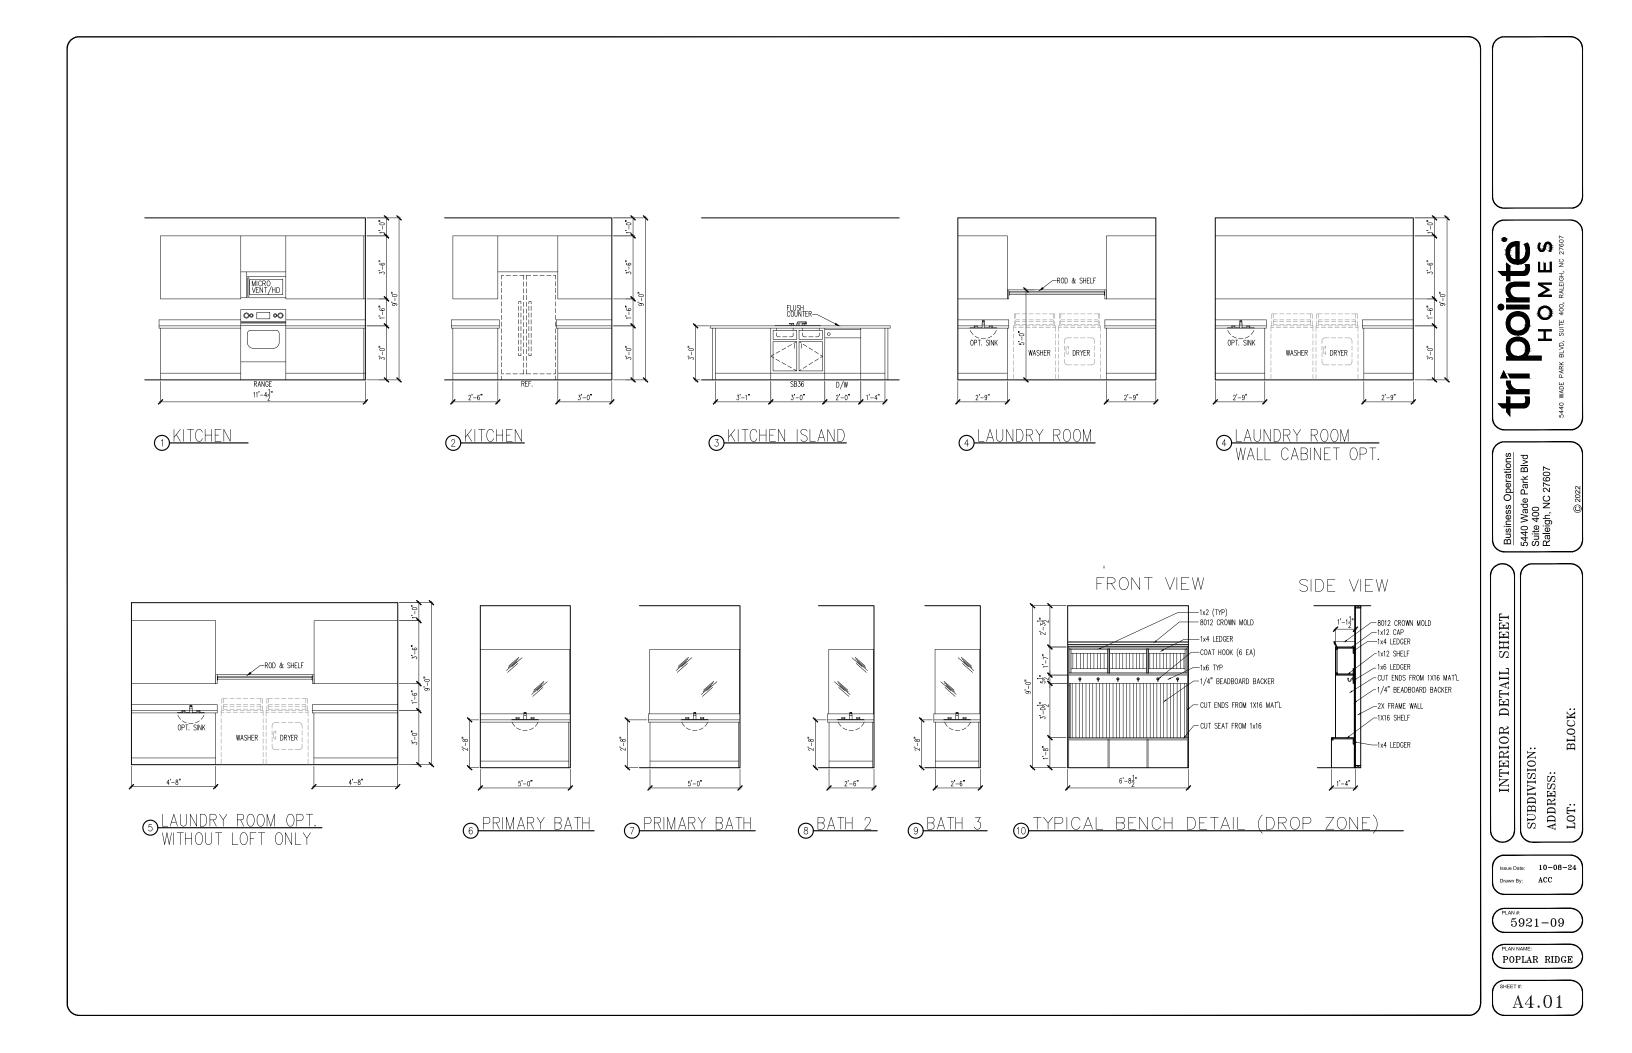
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ADDRESS:
LOT: BI


Issue Date: 10-08-24 Drawn By: ACC

5921-09

PLAN NAME:
POPLAR RIDGE

A3.02C



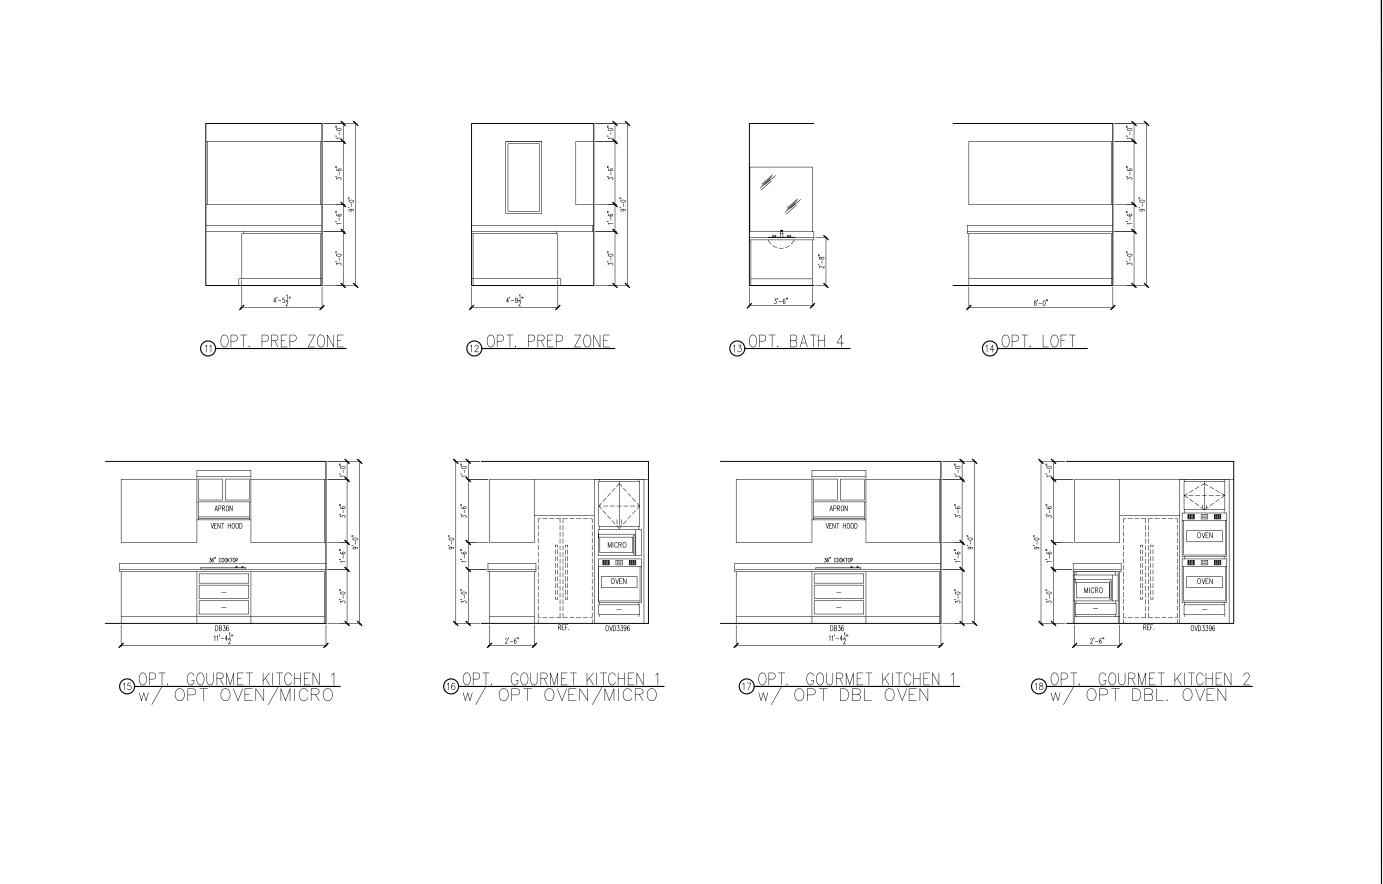

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H O M E S

5440 WADE PARK BLVD, SUITE 400, RALEIGH, NG 27607

Business Operations 5440 Wade Park Blvd Suite 400 Raleigh, NC 27607

INTERIOR DETAIL SHEET

SUBDIVISION:
ADDRESS:
LOT: BI

BLOCK:

Issue Date: 10-08-24

Drawn By: ACC

5921-09

PLAN NAME:
POPLAR RIDGE

A4.02


ELECTRICAL I SCHEDU	FIXTURE LE
DESCRIPTION	SYMBOL
110V OUTLET	ф
220V OUTLET	\$ 220
1/2 HOT OUTLET	
GFI OUTLET	∜ GFI
WP GFI OUTLET	₩P/GFI
GARAGE DOOR OPENER OUTLET	Ø GDO
SECURITY SYSTEM	∯SEC SYS
DISHWASHER	●DW
JUNCTION BOX	6
CEILING MOUNTED LIGHT	- - }-
CEILING FAN w/ LIGHT KIT	BRACING
RECESSED CEILING LIGHT	Ø
RECESSED WATER PROOF LIGHT	® WP
WALL MOUNTED LIGHT	Ф
WALL MOUNTED PUSH BUTTON	å PB
TWO WAY SWITCH	\$
THREE WAY SWITCH	* \$
FOUR WAY SWITCH	*\$
DIMMER SWITCH	\$ ^{DIM}
EXHAUST VENTS	OVENT TO EXT
LOW VOLTAGE PANEL	
PHONE OUTLET	⊕ PH
TV OUTLET	⊕ TV
DATA & RG6 COMBO BOX	
SMOKE DETECTOR	<u>©</u>
CARBON MONOXIDE SMOKE DETECTOR COMBO	⊚ CM/SD
DOOR CHIMES	CHIMES
ELECTRICAL PANEL	EP EP
SURFACE MOUNT LED	•
EXTERIOR WALL MOUNT UPLIGHT	83
SOFFIT MOUNT FLOOD LIGHT	₹
UNDER COUNTER LIGHTING	-co-UCL
SMURF TUBE	

ELECTRICAL NOTES:

- 1. PROVIDE AND INSTALL LOCALLY CERTIFIED SMOKE AND INSTALL LOCALLY CERTIFIED SMOKE AND CARBON MONOXIDE DETECTORS REQUIRED BY NATIONAL FIRE PROTECTION ASSOCIATION (NFPA) AND MEETING THE REQUIREMENTS OF ALL GOVERNING CODES
 2. PROVIDE AND INSTALL GROUND FAULT CIRCUIT—INTERRUPTERS (GFI) AS REQUIRED BY NATIONAL ELECTRIC CODE (NEC) AND MEETING THE REQUIREMENTS OF ALL GOVERNING CODES.
 3. ELECTRICAL CONTRACTOR TO PROVIDE REQUIRED DIRECT HOOK—UPS/CUTOFFS.
 4. HYAC CONTRACTOR TO VERIFY THERMOSTAT LOCATIONS.
 ALL ELECTRICAL AND MECHANICAL EQUIPMENT (I.E. FURNACES, A/C UNITS, ELECTRICAL PANELS, SANITARY SUMP PITS, DRAIN TILE SUMP, AND WATER HEATERS) ARE SUBJECT TO RELOCATION DIJE TO FIELD CONJUSTIONS

WATER HEATERS) ARE SUBJECT TO RELOCATION DUE TO FIELD CONDITIONS.	
ELECTRICAL DEVICES: ABOVE FINISHED FLOO	<u>R:</u>
SWITCHES OVER COUNTER	D. CL
WALL OUTLETS OVER COUNTER	
+42" TO BOTTOM OF HORIZONTAL OUTLET(TYP. @ COUNTER)	
REMAINING SWITCHES	O.CL
WALL OUTLETS) CL
BATH VANITY BRACKET OUTLET 1,2 (1" ABOVE TOP OF VANITY)	
WATER SOFTENER AND SUMP OUTLETS 48" TO) CL
EXTERIOR GFI OUTLETS	
GARAGE GFI (ABOVE GARAGE FLOOR) 48" TO	
FRONT DOOR COACH LIGHT	
GARAGE DOOR COACH LIGHT, (ABOVE GARAGE FLOOR)	O CL
THERMOSTAT) .CL
DOORBELL CHIMES	J CL
DOORBELL BUTTON	
KITCHEN HOOD FAN "WHIP"	
KITCHEN WALL HUNG MICROWAVE OUTLET 72" TO	
KITCHEN DISHWASHER RECEPTACLE JNDER	
KITCHEN RANGE	
KITCHEN REFRIGERATOR	
WASHER/DRYER OUTLET) CL

CL = CENTER LINE 1 = FIELD VERIFY 2 = MASTER BATH STANDARD 30" HIGH VANITY TO BE RAISED 4"

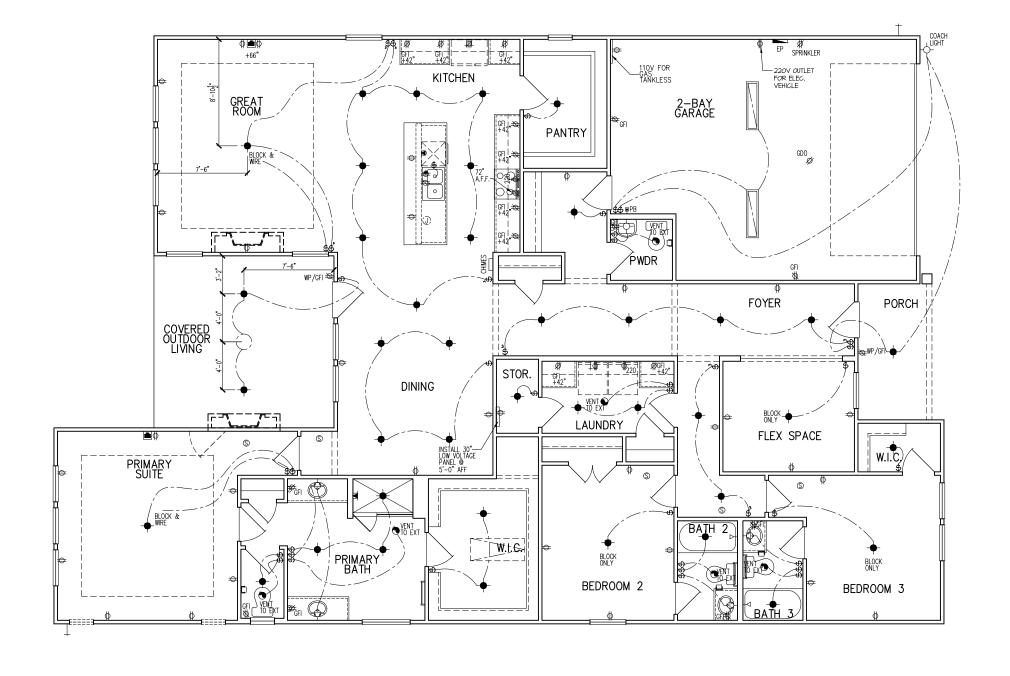

Dointe HOMES RR BLD. SUITE 400, RALEIGH, NC 27607

Business Operations 5440 Wade Park Blvd Suite 400 Raleigh, NC 27607

ELECTRICAL PLAN 1st FLOOR SUBDIVISION:
ADDRESS:
LOT:
BI

> Issue Date: 10-08-24 ACC

5921-09

POPLAR RIDGE

E1.10C

ELECTRICAL I SCHEDU	TIXTURE LE
DESCRIPTION	SYMBOL
110V OUTLET	ф
220V OUTLET	₩ Ф 220
1/2 HOT OUTLET	
GFI OUTLET	₩ GFI
WP GFI OUTLET	₩P/GFI
GARAGE DOOR OPENER OUTLET	Ø GDO
SECURITY SYSTEM	∯ SEC SYS
DISHWASHER	⊗ DW
JUNCTION BOX	①
CEILING MOUNTED LIGHT	\(\rightarrow \)
CEILING FAN w/ LIGHT KIT	BRAZINE
RECESSED CEILING LIGHT	Ø
RECESSED WATER PROOF LIGHT)®(WP
WALL MOUNTED LIGHT	9
WALL MOUNTED PUSH BUTTON	ы PB
TWO WAY SWITCH	\$
THREE WAY SWITCH	³\$
FOUR WAY SWITCH	⁴\$
DIMMER SWITCH	\$ ^{DIM}
EXHAUST VENTS	SVENT TO EXT
LOW VOLTAGE PANEL	<u> </u>
PHONE OUTLET	● PH
TV OUTLET	⊗ TV
DATA & RG6 COMBO BOX	₹
SMOKE DETECTOR	<u>(S)</u>
CARBON MONOXIDE SMOKE DETECTOR COMBO	⊚ CM/SD
DOOR CHIMES	CHIMES
ELECTRICAL PANEL	EP
SURFACE MOUNT LED	•
EXTERIOR WALL MOUNT UPLIGHT	8
SOFFIT MOUNT FLOOD LIGHT	4ys
UNDER COUNTER LIGHTING	ess- UCL
SMURF TUBE	

ELECTRICAL NOTES:

- 1. PROVIDE AND INSTALL LOCALLY CERTIFIED SMOKE AND CARBON MONOXIDE DETECTORS REQUIRED BY NATIONAL FIRE PROTECTION ASSOCIATION (NFPA) AND MEETING THE REQUIREMENTS OF ALL COVERNING CODES 2. PROVIDE AND INSTALL GROUND FAULT ORCULT—INTERRUPTERS (GF) AS REQUIRED BY NATIONAL ELECTRIC CODE (NEC) AND MEETING THE REQUIREMENTS OF ALL GOVERNING CODES.

 3. ELECTRICAL CONTRACTOR TO PROVIDE REQUIRED DIRECT HOOK—UPS/CUTOFFS.

 4. HYAC CONTRACTOR TO VERIFY THERMOSTAT LOCATIONS.


 5. ALL ELECTRICAL AND MECHANICAL EQUIPMENT (I.E. FURNACES, A/C UNITS, ELECTRICAL PANELS, SANITARY SUMP PITS, DRAIN TILE SUMP, AND WATER HEATERS) ARE SUBJECT TO RELOCATION DUE TO FIELD CONDITIONS.

DUE TO FIELD CONDITIONS.
ELECTRICAL DEVICES: ABOVE FINISHED FLOOR:
SWITCHES OVER COUNTER
WALL OUTLETS OVER COUNTER
+42" TO BOTTOM OF HORIZONTAL OUTLET(TYP. @ COUNTER)
REMAINING SWITCHES
WALL OUTLETS
BATH VANITY BRACKET OUTLET 1,2 (1" ABOVE TOP OF VANITY)
WATER SOFTENER AND SUMP OUTLETS 48" TO CL
EXTERIOR GFI OUTLETS
GARAGE GFI (ABOVE GARAGE FLOOR) 48" TO CL
FRONT DOOR COACH LIGHT
GARAGE DOOR COACH LIGHT, (ABOVE GARAGE FLOOR)84".TO CL
THERMOSTAT
DOORBELL CHIMES
DOORBELL BUTTON DR. HANDLE
KITCHEN HOOD FAN "WHIP"
KITCHEN WALL HUNG MICROWAVE OUTLET 72" TO CL
KITCHEN DISHWASHER RECEPTACLE JNDER SINK
KITCHEN RANGE
KITCHEN REFRIGERATOR
WASHER/DRYER OUTLET
CL = CENTER LINE

CL = CENTER LINE

1 = FIELD VERIFY

2 = MASTER BATH STANDARD 30" HIGH
VANITY TO BE RAISED 4"

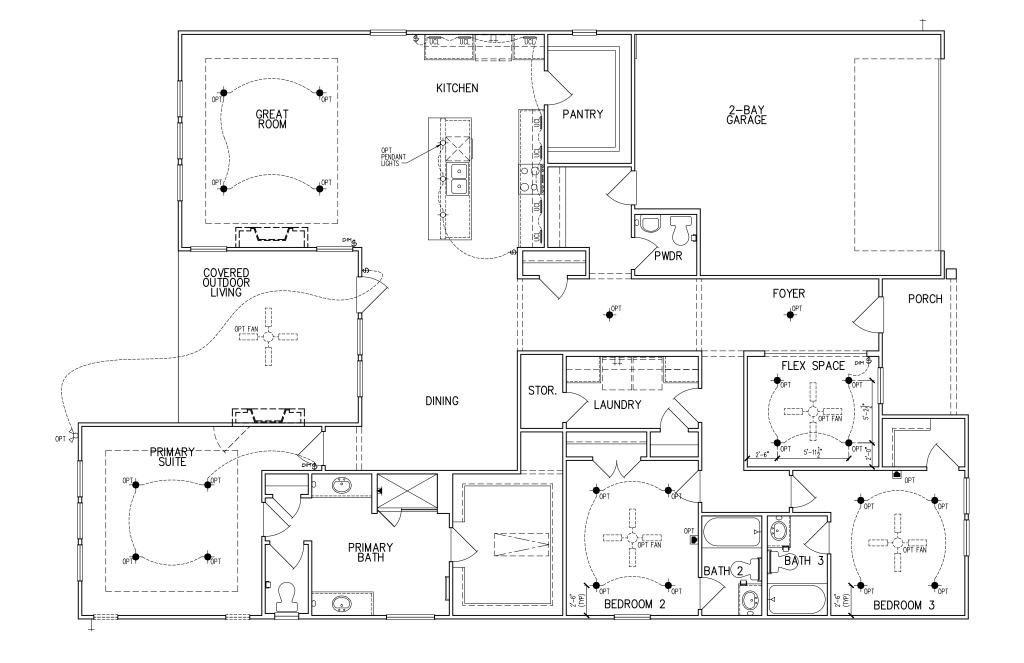

Dointe HOMES RR BLVD. SUITE 400. RALEGH, NC 27/607

Business Operations 5440 Wade Park Blvd Suite 400 Raleigh, NC 27607

OPITONS

PLAN 1st FLOOR ELEC. SUBDIVISION:
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LOT: BI


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Issue Date: 10-08-24 ACC


5921-09

POPLAR RIDGE


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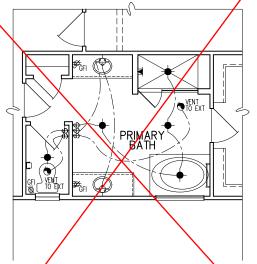
OPT. OFFICE ILO FLEX SPACE - PARTIAL **ELECTRICAL PLAN**

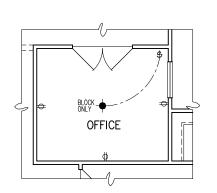


OPT. PRIMARY BATH 1 PARTIAL ELECTRICAL PLAN

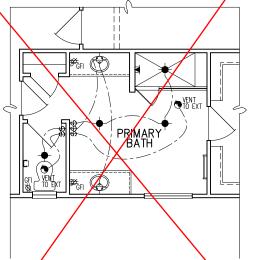


OPT. SHOWER ILO TUB AT BATH 2 - PARTIAL ELECTRICAL PLAN

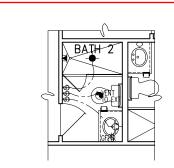


OPT. PRIMARY BATH 2 PARTIAL ELECTRICAL PLAN

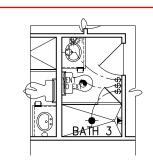

OPT. SHOWER ILO TUB AT BATH 3 - PARTIAL **ELECTRICAL PLAN**

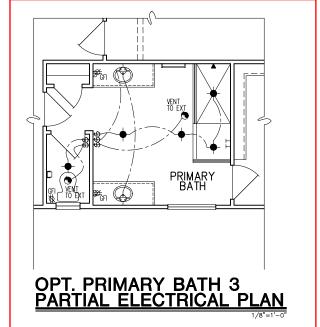

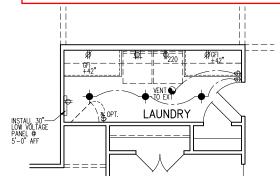

OPT. LAUNDRY ELECTRICAL PLAN



---- UCL

ELECTRICAL NOTES:

- PROVIDE AND INSTALL LOCALLY CERTIFIED SMOSE. AND CABRON MONOXIDE DETECTORS. A REQUIRED BY AND INSTALL LOCALLY CERTIFIED SMOSE. AND CABRON MONOXIDE DETECTORS. A REQUIRED BY AND INSTALL. SEQUENCE FOR CORES. PROVIDE AND INSTALL SEQUENCE FOR CORES. PROVIDE AND INSTALL SEQUENCE FOR CORES. PROVIDE AND INSTALL SEQUENCE BY METALE CONTROLLED STALL SOCIETATION OF THE REQUIREMENTS OF ALL GOVERNMON CODES. ELECTRICAL CONTRACTOR TO VERBY THERMOSTAT LOCATIONS.

 LOCATIONS. AND MECHANICAL COMPREST LOCATIONS. AND INSTALL SOCIETATION. AND INSTALL SOCIETATION.
- DUE TO FIELD CÓNDITIONS:
 ELECTRICAL, DEVICES:
 SMITCHES OVER COUNTER.
 48°. TO C.
 WALL OUILETS OVER COUNTER.
 48°. TO C.
 WALL OUILETS.
 48°. TO C.
 BADH VANNTY BRACKET OUILET.
 12°. TO C.
 BADH VANNTY BRACKET OUILET.
 18°. TO C.
 BADH VANNTY BRACKET OUILET.
 18°. 12°. TO C.
 BADH VANNTY BRACKET OUILET.
 18°.
- BATH VANITY BRACKET OUTLET. .. (1" ABOVE TOP OF VANITY)
 WATER SOFTENER AND SUMP OUTLETS.

 EXTERIOR GFI OUTLETS.

 GARAGE GFI (ABOVE GARAGE FLOOR).

 FRONT DOOR COACH LIGHT. GARAGE DOOR COACH LIGHT, (ABOVE GARAGE FLOOR).... 84 TO CL .54 TO CL .84 TO CL
- DOORBELL BUTTON.

 KITCHEN HOOD FAN "WHIP".


 KITCHEN WALL HUNG MICROWAYE OUTLET.


 KITCHEN DISHWASHER RECEPTACLE.


 KITCHEN RANGE. KITCHEN REFRIGERATOR. WASHER/DRYER OUTLET.

2 = MASTER BATH STANDARD 30" HIGH VANITY TO BE RAISED 4"




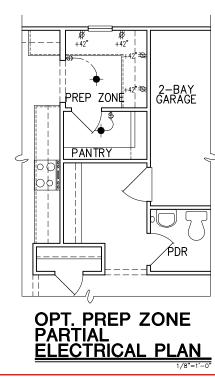

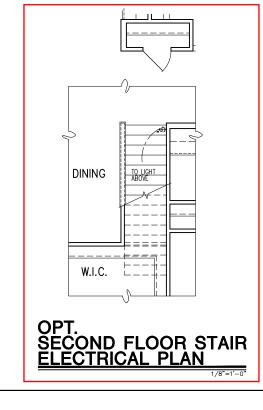

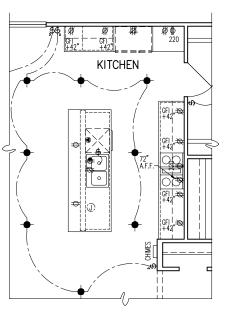

OPT. GOURMET KITCHEN 2 - PARTIAL ELECTRICAL PLAN

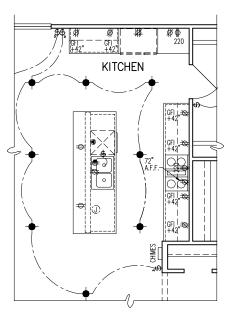

OPT. GOURMET KITCHEN 1 - PARTIAL ELECTRICAL PLAN

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Business Operations 5440 Wade Park Blvd Suite 400 Raleigh, NC 27607


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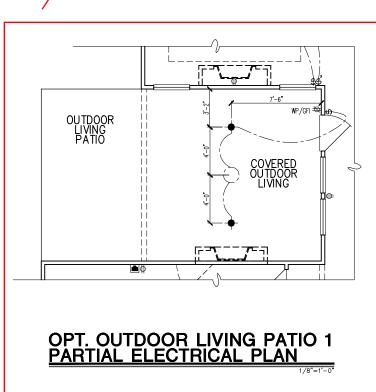
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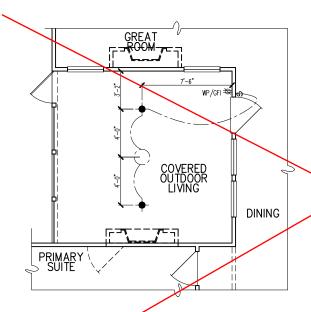
5921-09

POPLAR RIDGE


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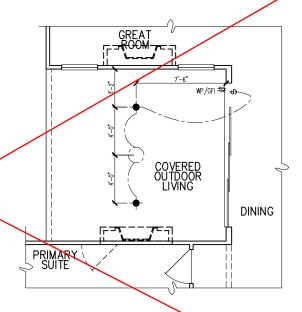





OPT. SCREENED COVERED OUTDOOR LIVING PARTIAL ELECTRICAL PLAN

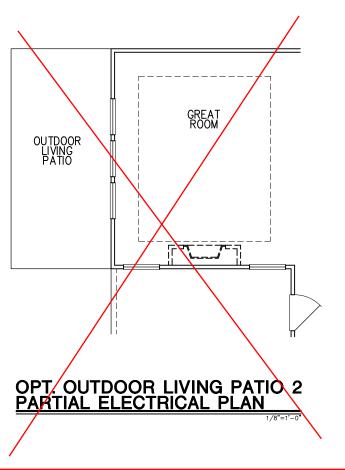

OPT. SCREENED EXTENDED COVERED OUTDOOR LIVING PARTIAL ELECTRICAL PLAN

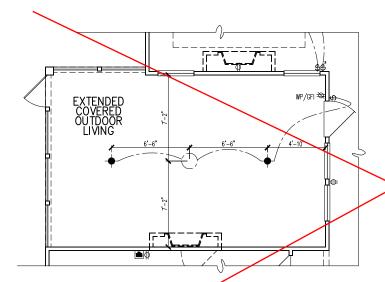

OPT. 12080 MULTI SLIDE DOOR AT DINING ROOM PARTIAL ELECTRICAL PLAN

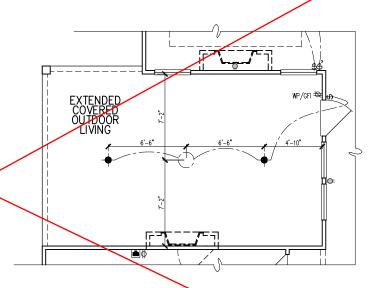

OPT. EXTENDED COVERED OUTDOOR LIVING PARTIAL ELECTRICAL PLAN

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HOMES

HOMES

5440 WADE PARK BLYD, SUITE 400, RALEGH, NC 27607

Business Operations 5440 Wade Park Blvd Suite 400 Raleigh, NC 27607

ELEC. PLAN – OPTIONS
SUBDIVISION:
ADDRESS:
LOT: BLOCK:


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Drawn By: ACC


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POPLAR RIDGE


01.E10




OPT. GOURMET KITCHEN 2 - PARTIAL ELECTRICAL PLAN

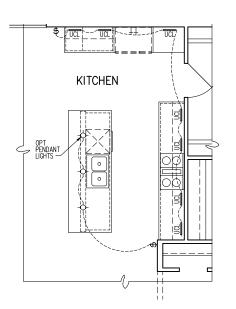


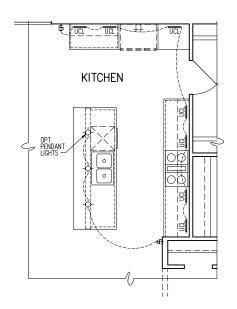OPT. GOURMET KITCHEN 1 - PARTIAL ELECTRICAL PLAN

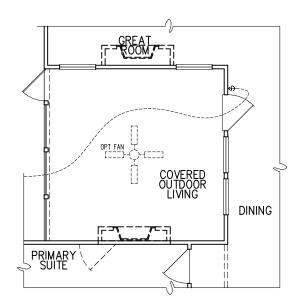



OPT. SCREENED COVERED OUTDOOR LIVING PARTIAL ELECTRICAL PLAN

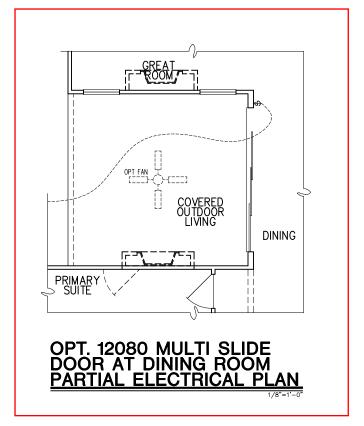

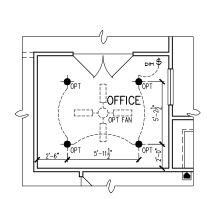


OPT. OFFICE ILO FLEX SPACE - PARTIAL ELECTRICAL PLAN

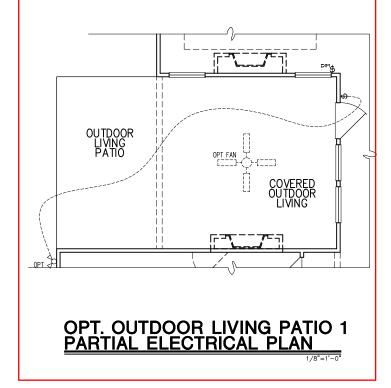

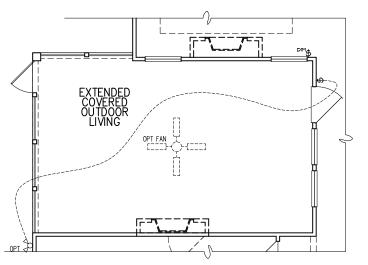

OPT. SCREENED EXTENDED COVERED OUTDOOR LIVING PARTIAL ELECTRICAL PLAN

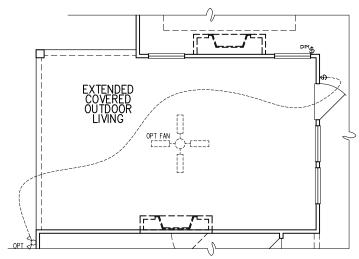

OPT. EXTENDED COVERED OUTDOOR LIVING PARTIAL ELECTRICAL PLAN

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HOMES

HOMES

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Business Operations 5440 Wade Park Blvd Suite 400 Raleigh, NC 27607

1st FLOOR ELEC. PLAN – OPTIONS
SUBDIVISION:
ADDRESS:
LOT: BLOCK:

Issue Date: 10-08-24
Drawn By: ACC

FLAN#: 5921-09

POPLAR RIDGE

(SHEET#: 01.E12

ELECTRICAL I SCHEDU	FIXTURE
SCHEDU	LE
DESCRIPTION	SYMBOL
52001111 11011	
110V OUTLET	ф
220V OUTLET	\$ 220
1/2 HOT OUTLET	
GFI OUTLET	∜ GFI
WP GFI OUTLET	₩P/GFI
GARAGE DOOR OPENER OUTLET	Ø GDO
SECURITY SYSTEM	∯SEC SYS
DISHWASHER	●DW
JUNCTION BOX	0
CEILING MOUNTED LIGHT	-
CEILING FAN w/ LIGHT KIT	PROVIDE
RECESSED CEILING LIGHT	R
RECESSED WATER PROOF LIGHT	™ MP
WALL MOUNTED LIGHT	9
WALL MOUNTED PUSH BUTTON	å PB
TWO WAY SWITCH	\$
THREE WAY SWITCH	³\$
FOUR WAY SWITCH	\$
DIMMER SWITCH	₽
EXHAUST VENTS	EVENT TO EXT
LOW VOLTAGE PANEL	
PHONE OUTLET	⊕ PH
TV OUTLET	● TV
DATA & RG6 COMBO BOX	₹
SMOKE DETECTOR	<u>(S</u>)
CARBON MONOXIDE SMOKE DETECTOR COMBO	⊚ CM/SD
DOOR CHIMES	CHIMES
ELECTRICAL PANEL	■ EP
SURFACE MOUNT LED	•
EXTERIOR WALL MOUNT UPLIGHT	8
SOFFIT MOUNT FLOOD LIGHT	₹\$
UNDER COUNTER LIGHTING	ess-UCL
SMURF TUBE	

ELECTRICAL NOTES:

PROVIDE AND INSTALL LOCALLY CERTIFIED

PROVIDE AND INSTALL LOCALLY CERTIFIED

SMOKE AND CARBON MONOXIDE DETECTORS

REQUIRED BY NATIONAL FIRE PROTECTION

ASSOCIATION (NFPA) AND MEETING THE

REQUIREMENTS OF ALL GOVERNING CODES

PROVIDE AND INSTALL GROUND FAULT

CIRCUIT—INTERRUPTERS (GFI) AS REQUIRED BY

NATIONAL ELECTRIC CODE (NEC) AND MEETING

THE REQUIREMENTS OF ALL GOVERNING CODES.

ELECTRICAL CONTRACTOR TO PROVIDE

REQUIRED DIRECT HOOK—UPS/CUTOFFS.

HVAC CONTRACTOR TO VERIFY THERMOSTAT

LOCATIONS.

ALL ELECTRICAL AND MECHANICAL EQUIPMENT

(I.E. FURNACES, A/C UNITS, ELECTRICAL PANELS,

SANITARY SUMP PITS, DRAIN TILE SUMP, AND

WATER HEATERS) ARE SUBJECT TO RELOCATION

DUE TO FIELD CONDITIONS.


ELECTRICAL DEVICES:

ABOVE FINISHED FLOOR: DUE TO FIELD CÓNDITIONS.

ELECTRICAL DEVICES: ABOVE FINISHED FLOOR:
SWITCHES OVER COUNTER. .48". TO. CL
WALL OUTLETS OVER COUNTER.
+42" TO BOTTOM OF HORIZONTAL OUTLET(TYP. © COUNTER)
REMAINING SWITCHES. .48". TO. CL
WALL OUTLETS. .12". TO CL
BATH VANITY BRACKET OUTLET. .1,2
(1" ABOVE TOP O'T VANITY)
WATER SOFTENER AND SUMP OUTLETS. .48" TO CL
EXTERIOR GFI OUTLETS. .12". TO. CL
CARAGE GFI (ABOVE CARAGE FLOOR). .48" TO CL
FRONT DOOR COACH LIGHT. .80". TO CL
CARAGE DOOR COACH LIGHT.

GARAGE DOOR COACH LIGHT, (ABOVE GARAGE FLOOR). . . DOORBELL CHIMES. .

CL = CENTER LINE 1 = FIELD VERIFY 2 = MASTER BATH STANDARD 30" HIGH VANITY TO BE RAISED 4"

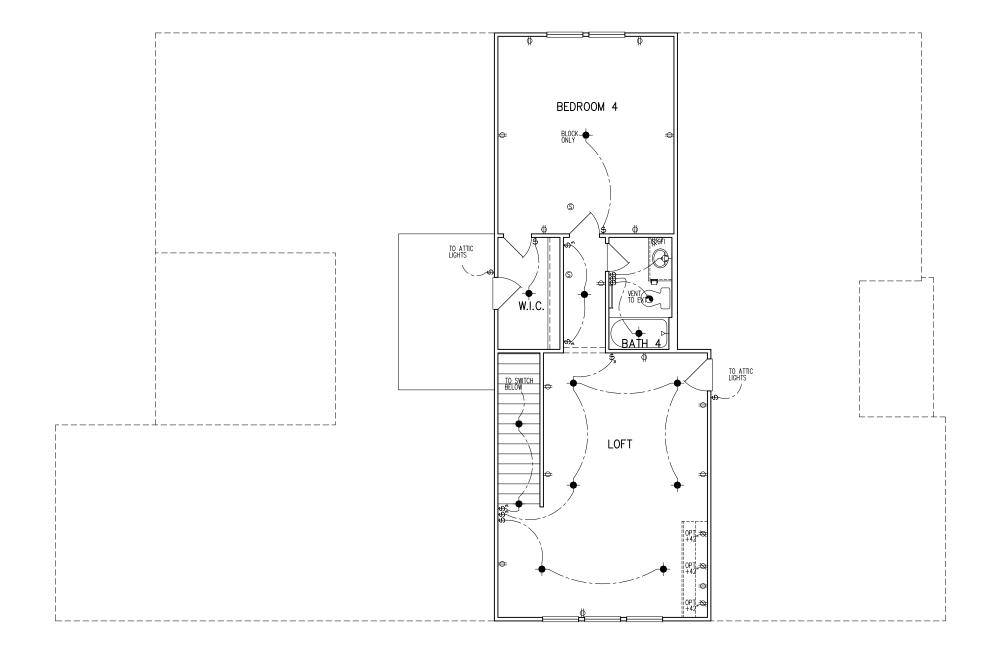

OPT. SECOND FLOOR PLAN PARTIAL ELECTRICAL PLAN

Dointe HOMES RR BLYD, SUITE 400, RALEIGH, NC 27607

Business Operations 5440 Wade Park Blvd Suite 400 Raleigh, NC 27607

OPTION 2ND FLR ELEC.


SUBDIVISION:
ADDRESS:
LOT: BI

Issue Date: 10-08-24 Drawn By: ACC

5921-09

POPLAR RIDGE

01.E20

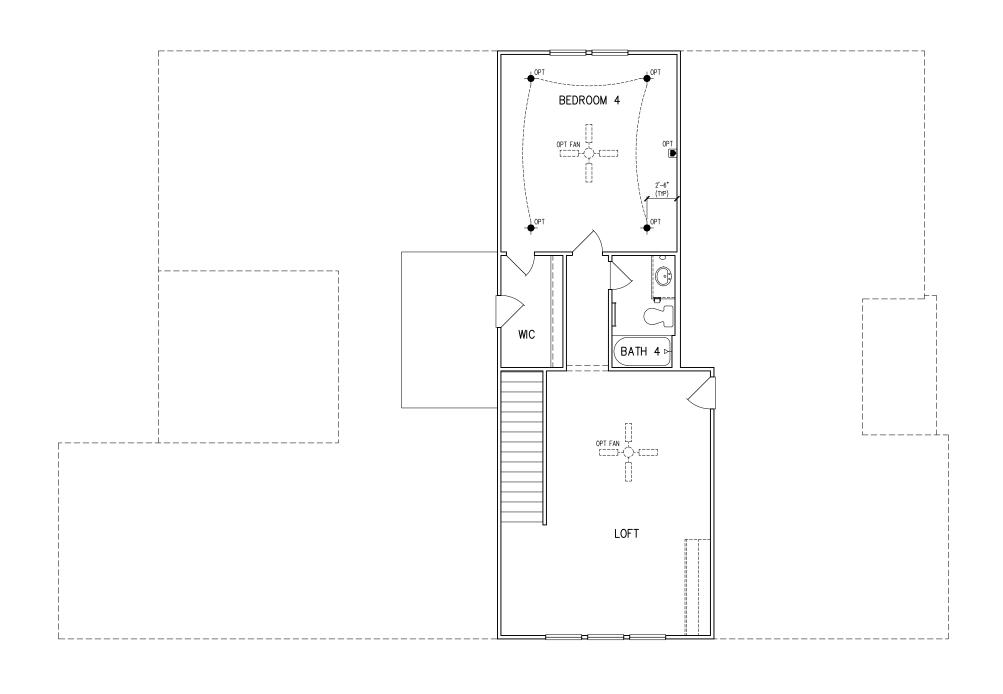

OPT. SECOND FLOOR PLAN PARTIAL ELECTRICAL PLAN 1/8°=1'-0'

OPTION SUBDIVISION:
ADDRESS:
LOT: BLOCK:

Issue Date: 10-08-24

Drawn By: ACC

5921-09

PLAN NAME:
POPLAR RIDGE

©1.E21

GENERAL STRUCTURAL NOTES

FLOOR FRAMING

- I IOISTS/TRUSSES SHALL BE DESIGNED BY MANUE TO MEET OR EXCEED L/480 LIVE LOAD DEFLECTION CRITERIA. (EXCLUDES STONE/MARBLE OR WET BED CONSTRUCTED FLOORS - CONTACT M&K FOR EXCLUDED FLOOR DESIGNS)
- PER THE GUIDELINES OF THE TILE COUNCIL OF NORTH AMERICA (TCNA HANDBOOK), IT SHALL BE THE FLOOR FINISH INSTALLER'S RESPONSIBILITY TO VERIEY THAT THE FINISHES TO BE INSTALLED. MATCH THE DESIGN CRITERIA NOTED ABOVE (UNDER "DESIGN
- FLOOR SYSTEMS & SHEATHING HAVE BEEN DESIGNED TO SUPPORT ADDITIONAL DEAD LOAD FROM CERAMIC TILE (EXCLUDING MARBLE OR STONE). HOWEVER, IT SHALL BE THE FLOOR FINISH INSTALLER'S RESPONSIBILITY TO PROVIDE PROPER UNDERLAYMENT, UNCOUPLING MEMBRANE AND MORTAR/GROUT PER THE ASSEMBLY DESIGNATIONS IN THE TONA HANDBOOK (TILE COUNCIL OF NORTH AMERICA).
- AT I-JOIST FLOORS, PROVIDE I 1/8" MIN. OSB RIM BOARD.
- METAL HANGERS SHALL BE SPECIFIED BY MANUFACTURER, U.N.O.
- I-JOIST/TRUSS SHOP DWGS. SHALL BE SUBMITTED TO ARCH. & ENG. FOR REVIEW AND APPROVAL PRIOR TO FABRICATION OR DELIVERY
- FLOOR SHEATHING SHALL BE 23/32" A.P.A. RATED 'STURD-I-FLOOR' 24" O.C. EXPOSURE I (OR APPROVED EQUAL) WITH TONGUE AND GROOVE EDGES. FASTEN TO FRAMING MEMBERS W GLUE AND
- 2 ½" × 0.131" NAILS @ 6"o.c. @ PANEL EDGES & @ 12"o.c. FIELD.
- 2 3" x 0.120" NAILS @ 4" O.C. @ PANEL EDGES & @ 8" O.C. FIELD. - 2 3 × 0.113" NAILS @ 3" O.C. @ PANEL EDGES \$ @ 6" O.C. IN FIELD

ROOF FRAMING

- ROOF SHEATHING SHALL BE 7/16" A.P.A. RATED SHEATHING 24/16 EXPOSURE I (OR APPROVED EQUAL). FASTEN TO FRAMING MEMBERS
- W/ 2 ½" × 0.131" NAILS @ 6"o.c. @ PANEL EDGES & @ 12" O.C. FIELD.
- · w/ 2 🖁 × 0.120" NAILS 🥑 4"o.c. 💇 PANEL EDGES 🕏 🗗 O.C. FIELD. - w/ 2 3 × 0.113" NAILS @ 3"o.c. @ PANEL EDGES & @ 6" O.C. FIELD.
- WITHIN 48" OF ALL ROOF FDGES RIDGES & HIPS FASTEN ROOF SHEATHING FIELDS PER EDGE NAILING SPEC
- EASTEN EACH ROOF TRUSS TO TOP PLATE W/ SIMPSON H25T CLIP (OR APPROVED EQUAL) @ ALL BEARING POINTS. PROVIDE (2) H2.51 CLIPS AT 2-PLY GIRDER TRUSSES, (3) H2.5T CLIPS AT 3-PLY GIRDER TRUSSES & ROOF BEAMS - AT ALL BEARING POINTS.
- METAL HANGERS SHALL BE SPECIFIED BY THE MANUFACTURER, U.N.O.
- ROOF TRUSS SHOP DWGS SHALL BE SUBMITTED TO ARCH & ENG. FOR REVIEW AND APPROVAL PRIOR TO FABRICATION OR DELIVERY
- ERECT AND INSTALL ROOF TRUSSES PER WTCA & TPI'S BCSI I "GUIDE TO GOOD PRACTICE FOR HANDLING, INSTALLING & BRACING OF METAL PLATE CONNECTED WOOD TRUSSES."
- SUPPORT SHORT SPAN ROOF TRUSSES W/2x4 LEDGER FASTENED TO

FRAMING w/(2) 3" x 0.120" NAILS @ 16" O.C. (UP TO 7' SPAN).

CONNECTION SPECIFICATIONS (TYP. U.N.O.)

DESCRIPTION OF BLDG. ELEMENT	3"x0.131" NAILS	3"x0.120" NAIL5	
JOIST TO SOLE PLATE	(3) TOENAILS	(3) TOENAILS*	
SOLE PL. TO JOIST/RIM OR BLK'G STUD TO PLATE	NAILS @ 4" o.c. (4) TOENAILS/ (3)END NAILS	NAILS @ 4" o.c.	
RIM TO TOP PLATE	TOENAILS @ 6" o.c.	(4) TOENAILS/ (4)END NAILS* TOENAILS @ 4" o.c.*	
BLK'G. BTWN. JOISTS TO TOP PL.	(3) TOENAILS EA. END	(3) TOENAILS EA. END*	
	***	NAILS @ 16" o.c.	
DOUBLE STUD DOUBLE TOP PLATE	NAILS @ 16" o.c. NAILS @ 12" o.c.	NAILS @ 8" O.C.	
DOUBLE TOP PLATE LAP SPLICE	(12) NAILS IN LAPPED AREA	(I5) NAILS IN LAPPED AREA	
DOUBLE FOR FLATE EAR SPEICE	(24" MIN.)	(15) NAILS IN LAPPED AREA (24" MIN.)	
TOP PLATE LAP @ CORNERS & INTERSECTING WALLS	(3) NAILS	(3) NAILS	
RAFTER/TRUSS TO TOP PLATE	(4) TOENAILS + (1) SIMPSON H2.5T	(4) TOENAILS + (1) SIMPSON H2.5T	
GAB. END TRUSS TO DBL. TOP PL.	TOENAILS @ 8" O.C.	TOENAILS @ 6" o.c.	
R.T. w/ HEEL HT. 9 1/4" TO 12"	2xIO BLK EVERY 3RD BAY FASTENED TO DBL. TOP PLATE W/ TOENAILS @ 6" O.C.	2xIO BLK EVERY 3RD BAY FASTENED TO DBL. TOP PLATE W/ TOENAILS @ 4" O.C.	
R.T. w/ HEEL HT. I2" TO I6"	2xI2 BLK EVERY 3RD BAY FASTENED TO DBL. TOP PLATE w/ TOENAILS @ 6" O.C.	2xI2 BLK EVERY 3RD BAY FASTENED TO DBL. TOP PLATE w/ TOENAILS @ 4" O.C.	
R.T. w/ HEEL HT. UP TO 24"	LAP WALL SHTG. W/ DBL. TOP PL. \$ INSTALL ON TRUSS VERT FASTEN W/ NAILS @ 6" O.C.	LAP WALL SHTG. W/ DBL. TOP PL. \$ INSTALL ON TRUSS VERT FASTEN W/ NAILS @ 6" O.C.*	
R.T. w/ HEEL HT. 24" TO 48"	LAP WALL SHTG. W/ DBL. TOP PL. & INSTALL ON TRUSS VERT FASTEN W/ NAILS @ 6" O.C. PROVIDE 2x BLK @ EA. BAY AT TOP OF HEEL	LAP WALL SHTG. W/ DBL. TOP PL. & INSTALL ON TRISS VERT FASTEN W/ NAILS @ 6" O.C. PROVIDE 2x BLK @ EA. BAY AT TOP OF HEEL*	
WALL TO FOUNDATION	WALL SHTG. LAP W/ SILL PL. \$ FASTENED PER SHEAR WALL FASTENING SPEC.		
* $2\!\!\!/_{\!$			

GENERAL STRUCTURAL NOTES

DESIGN LOADING

- DESIGN IS BASED ON 2018 NORTH CAROLINA STATE BUILDING CODE: RESIDENTIAL CODE.
- WOOD FRAME ENGINEERING IS BASED ON NDS, "NATIONAL DESIGN SPECIFICATION FOR WOOD CONSTRUCTION" - LATEST EDITION.
- DESIGN LOADS ROOF

SNOW = 15 PSF (12 PSF GROUND SNOW, TRUSSES) LIVE = 20 PSF (REDUCIBLE BASED ON ROOF PITCH) DEAD = 7 PSF T.C., IO PSF B.C. LOAD DURATION FACTOR = 1.25

LIVE = 40 PSE (30 PSE @ SLEEPING AREAS)

DEAD = 10 PSF (I-JOISTS), 15 PSF (FLOOR TRUSSES) ADD'L IO PSE @ CERAMIC TILE IN KITCHEN. SUNROOMS, BATHS, FOYER, LAUND. & MUDRMS

2,000 PSF ASSUMED ALLOWABLE BEARING PRESSURE (TO BE VERIFIED BY BUILDER)

115 MPH, EXPOSURE B

GENERAL FRAMING

- ALL TYP, NAIL FASTENER REQUIREMENTS ARE NOTED IN STANDARD CONNECTIONS TABLE (IRC TABLE R602.3(1)) OR ON PLANS. ALL NAILS SPECIFIED ARE MIN DIAMETER AND LENGTH REQUIRED FOR CONNECTION. ALL HANGER NAILS SHALL BE INSTALLED PER MANUFACTURER'S REQUIREMENTS FOR MAX CHARTED CAPACITY NOTE: HANGERS USE COMMON NAIL DIAMETERS NOT TYPICAL FRAMING GUN NAILS.
- EXT & INT BEARING WALLS SHALL BE 2x4 OR 2x6 (AS SHOWN ON PLANS) @ 16" O.C. SPF/SP #2 GRADE LUMBER, OR BETTER, U.N.O.. · WALLS OVER 12' TALL SHALL BE PER PLAN.
- ALL INTERIOR BEARING WALLS ARE ASSUMED TO BE SHEATHED W/ GYP WALL BOARD (ONE SIDE MIN.) OR PROVIDE MID HT. BLOCKING.
- ALL HEADERS, BEAMS & OTHER STRUCTURAL MEMBERS SHALL BE SPRUCE-PINE-FIR #2 (SPE) OR SOUTHERN PINE #2 (SP) LUMBER, OR BETTER, SUPPORT ALL HEADERS/ BEAMS W/ (1)2x JACK STUD & (1)2x KING STUD MINIMUM
- THE NUMBER OF STUDS SPECIFIED AT A SUPPORT INDICATES THE NUMBER OF JACK STUDS REQUIRED, U.N.O.,
- ALL NON-BEARING INTERIOR STUD WALLS SHALL BE CONSTRUCTED WITH 2x 'STUD' GRADE MEMBERS SPACED @ 24" O.C. (MAX., U.N.O.)

 • HEADERS IN NON-LOAD BEARING WALLS SHALL BE: (1)2x4/6 FLAT @ OPENINGS UP TO 4', (2)2x4/6 FLAT UP TO 8'.
- ALL FRAMING LUMBER SHALL BE DRIED TO 15% MC (KD-15).
- ENGINEERED LUMBER BEAMS TO MEET OR EXCEED THE FOLLOWING: • 'LVL' - Fb=2600 psi; Fv=285 psi; E=2.0x10^6 psi
- ENGINEERED LUMBER POSTS TO MEET OR EXCEED THE FOLLOWING 'LVL' - Fb=2400 psi; FcII=2500 psi; E=I.8xI0^6 psi
- FOR 2 & 3 PLY BEAMS OF EQUAL 134" MAX. WIDTH, FASTEN PLIES TOGETHER WITH 3 ROWS OF 3"X0.120" NAILS @ 8" O/C OR 2 ROWS 18"x3K" SIMPSON SDS SCREWS (OR 3K" TRUSSI OK SCREWS) @ 16" GREATER. APPLY EASTENING AT BOTH FACES FOR 3-PLY CONDITION. LOCATE TOP & BOTTOM NAILS/SCREWS 2" FROM EDGE. SOLID 31/3" OR 51/4" BEAMS ARE ACCEPTABLE, USE 2 ROWS OF NAILS FOR 2x6 \$ 2x8 MEMBERS
- FOR 4 PLY BEAMS OF EQUAL 13/4" MAX, WIDTH, FASTEN PLIES TOGETHER WITH 3 ROWS OF K"X6" SIMPSON SDS SCREWS (OR 6 3/1) TRUSSLOK SCREWS) @ 16" O/C. USE A MINIMUM OF 4 ROWS FOR BEAM DEPTHS OF 14" OR GREATER, APPLY FASTENING AT BOTH FACES (ONE SIDE ONLY FOR TRUSSLOK SCREWS). LOCATE TOP AND BOTTOM SCREWS 2" FROM EDGE, A SOLID 7" BEAM IS ACCEPTABLE.
- PROVIDE SOLID BLOCKING IN FLOOR SYSTEM UNDER ALL POSTS CONTINUOUS TO FND./BEARING. BLOCKING TO MATCH POST ABOVE.
- ALL EXTERIOR 4x4 WOOD POSTS SHALL HAVE SIMPSON BCS2-2/4
- CORROSION NOTES
- BUILDER RESPONSIBLE TO DETERMINE CORROSION-RESISTANCE REQUIREMENTS AND COMPATIBILITY OF HARDWARE FASTENERS AND CONNECTORS FOR ENVIRONMENTAL EXPOSURE AND IN CONTACT W/ PRESERVATIVE-TREATED WOOD OF ACTUAL FINAL CONDITIONS AND SOURCED MATERIALS. CONTACT LUMBER & HARDWARE SUPPLIERS TO COORD.

GENERAL STRUCTURAL NOTES

FOUNDATION

- DESIGN IS BASED ON 2018 NORTH CAROLINA STATE BUILDING CODE:
- FOOTING DESIGN 2,000 PSF ALLOWABLE SOIL BEARING PRESSURE IS ASSUMED. BUILDER/CONTRACTOR MUST VERIFY
- FASTEN 2x4/6 SILL PLATES TO CONC FND WITH A MINIMUM OF 2
- ANCHORS PER PLATE 12" MAX FROM PLATE ENDS UTILIZING: I/2" DIA. ANCHOR BOLTS 6'-0" O.C,7" MIN. EMBEDMENT I/2" DIA. x 6" LONG SIMPSON TITEN HD @ 6'-0" O.C.
- SIMPSON MASA ANCHOR STRAPS @ 6'-0" O.C. (CONCRETE)
- ALL LUMBER EXPOSED TO WEATHER OR IN CONTACT W/ PERIMETER FOUNDATION SHALL BE PRESERVATIVE TREATED SOUTHERN PINE #2.
- BUILDER TO VERIEY CORROSION-RESISTANCE COMPATIBILITY OF HARDWARE & FASTENERS IN CONTACT W/ PRESERVATIVE-TREATED WOOD CONTACT LIMBER & HARDWARE SUPPLIERS TO COORD
- FOOTINGS SHALL BE PLAIN CONCRETE, U.N.O.
- CONCRETE DESIGN BASED ON ACL 318, CONCRETE SHALL ATTAIN THE FOLLOWING MIN. COMPRESSIVE STRENGTHS IN 28 DAYS, U.N.O. f'c = 3,000 psi: FOOTINGS & INTERIOR SLABS ON GRADE 3,500 psi: GARAGE & EXTERIOR SLABS ON GRADE fu = 60.000 psi
- ALL CONCRETE EXPOSED TO THE WEATHER SHALL NOT HAVE LESS THAN 5% OR MORE THAN 7% AIR ENTRAINMENT
- ALL FOOTINGS SHALL BEAR BELOW FROST LINE (TYP.) OR 12" MIN I REGIONS WHERE CODE FROST DEPTH IS NOT APPLICABLE. CONSULT SOILS REPORT OR BUILDING DEPT. FOR MINIMUM DEPTH BELOW GRADE
- FOOTINGS AND SLABS ON GRADE SHALL BEAR ON VIRGIN SOIL OR
- PROVIDE CONTROL JOINTS AT ALL INSIDE CORNERS OF SLAB EDGES, AND OTHER LOCATIONS WHERE SLAB CRACKS ARE LIKELY TO DEVELOP
- JOINTS SHALL BE LOCATED @ 10'-0" O.C. (RECOMMENDED) OR 15'-0" O.C. (MAXIMUM)
- JOINT GRID PATTERN SHALL BE AS CLOSE TO SQUARES AS POSSIBLE (I:I RATIO), WITH A MAXIMUM OF I:I.5 RATIO
- · CONTROL JOINTS SHALL NOT BE INSTALLED IN STRUCTURAL
- DIMENSIONS BY OTHERS, BUILDER TO VERIFY.

DER 9,000

SIDE WALL

MEANS & METHODS NOTES

THE STRUCTURE IS DESIGNED TO BE SELF SUPPORTING AND STABLE AFTER THE BUILDING IS FINISHED AND ALL PLAN, DETAIL, AND NOTE SPECIFICATIONS HAVE BEEN COMPLETED. IT IS THE CONTRACTOR'S SOLE RESPONSIBILITY TO DETERMINE THE ERECTION PROCEDURES AND SEQUENCE TO THE SAFETY OF THE BUILDING AND ITS COMPONENTS DURING CONSTRUCTION. THIS INCLUDES BUT IS NOT LIMITED TO, THE ADDITION OF NECESSARY SHORING, SHEETING, TEMPORARY BRACING, GUYS, AND TIE-DOWNS. CONTRACTOR SHALL BE RESPONSIBLE FOR ALL SHORING AND BRACING REQUIRED TO STABILIZE AND PROTECT EXISTING AND ADJACENT STRUCTURES AND SYSTEMS DURING COURSE OF DEMOLITION AND CONSTRUCTION OF THE PROJECT

STRUCTURAL DESIGN AND SPECIFICATIONS ASSUME THAT ALL SUPPORTING AND NON-SUPPORTING ELEMENTS IN CONTACT WITH FLOOR FRAMING ARE LEVEL, INCLUDING, BUT NOT LIMITED TO: FOUNDATIONS SLABS ON GRADE, BEAMS, WALLS, AND NON-BEARING ELEMENTS. IT IS THE CONTRACTOR'S RESPONSIBILITY TO VERIEY LEVELNESS AND MAKE ADJUSTMENTS AS NECESSARY, INCLUDING CONSIDERATION OF THOSE AREAS THAT MAY BE WITHIN CONTRACTUAL, INDUSTRY OR WARRANTY TOLERANCES

VENEER LINTEL SCHEDULE

SPAN HEIGHT OF VENEER STEEL ANGLE (MAX) ABOVE LINTEL				
				STEEL ANGLE SIZE
		3'-0"	20 FT. MAX	L3"x3"x¼"
			3 FT. MAX	L3"x3"x¼"
		6'-0"	I2 FT. MAX	L4"x3"x¼"
			20 FT. MAX	L5"x3½"x%;"
		8'-0"	3 FT. MAX	L4"x4"x¼" *
	0-0	I2 FT. MAX	L5"x3½"x%;"	
			I6 FT. MAX	L6"x3½"x¾"
		9'-6"	I2 FT. MAX	L6"x3½"x%6"
		16'-0"	2 FT. MAX	L7"x4"x½" **
l			3 FT. MAX	L8"x4"x½" **

- ILLIMITES

 **SPALL SIPPORT 2 %* 3 ½" YIBEER W 40 PAI MAXIMM MEIGHT.

 **IG SHALL HAVE 4" MIN BEARING

 **IG SHALL HAVE 9" MIN BEARING

 **IG SHALL HAVE 9" MIN BEARING

 **IG SHALL BAT SET FASTIBED BACK TO ROOD HEADER IN MALL 446"02. W ½" DIA, x 3 ½"

 **LONG LAG SCREPG IN 2" LONG YERTICALLY SLOTTED HOLES,

 **MAX. YEBEER 11" APPLIES TO ANY FORTION OF PROCK OVER THE OPENING.

 **ALL INITIES SHALL BE LONG LEG VERTICAL.

 **LALL MITTES SHALL BE LONG LEG VERTICAL.

 **MAY BEC OT IN THE FELLO TO BE 3½" MIDE OVER THE BEARING LENGTH ONLY. THIS

 **SET STRUCTURAL PLANG FOR ANY LINTEL CONDITION NOT ENCOMPASSED BY THE

 ROOK GERN MENTERS.
- FOR QUEEN VENEER USE L4x3x/4". 'FOR 3½" VENEER ONLY, SEE PLAN FOR VENEER SUPPORT IF VENEER < 3½" THICK

ADDITIONAL NOTES FOR TRUSS \$ I-JOIST MANUFACTURER

ROOF TRUSS, FLOOR TRUSS AND ENGINEERED JOISTS SHALL BE DESIGNED TO MEET THE DEFLECTION CRITERIA BELOW, UNLESS NOTED OTHERWISE ON PLAN. MULHERN & KULP CANNOT BE HELD RESPONSIBLE FOR ANY STRUCTURAL ISSUES
RELATED TO ANY BUILDING COMPONENT IF COMPONENT SHOP DRAWINGS ARE NOT SUBMITTED O M&K FOR REVIEW PRIOR TO FABRICATION, DELIVERY, OR INSTALLATION.

TRUSSES/LIGISTS SHALL BE DESIGNED SO THAT DIFFERENTIAL DEFLECTION BETWEEN ADJACENT PARALLEL TRUSSES/JOISTS OR GIRDER TRUSSES/FLUS BEAMS DO NOT EXCEED THE FOLLOWING: A ROOF TRUSSES.

- 1/4" DEAD LOAD
- FLOOR TRUSSES, ATTIC TRUSSES, & I-JOISTS; I/8" DEAD LOAD

 ABSOLUTE DEAD LOAD DEFECTION OF FLOOR
- TRUSSES/ATTIC TRUSSES WHEN ADJACENT TO FLOOR FRAMING BY OTHERS SHALL BE LIMITED TO 3/16". (NO DIFFERENTIAL DEFLECTION,

FLOOR JOIST NOTES

- · ALL FLOOR JOISTS SHALL BE THE DEPTI SPECIFIED ON PLAN FLOOR JOISTS SERIES & SPACING IS PER THE
- FLOOR JOIST MANUF. SPACING SHALL NOT EXCEED 19.2" O.C. (MAX.)
- @ LOCATION OF TILE: SPACING SHALL NOT EXCEED 16" O.C. (MAX.)

LATERAL/WALL BRACING & WALL SHEATHING SPECIFICATIONS

THIS MODEL HAS BEEN DESIGNED TO RESIST LATERAL FORCES RESULTING FROM:

5 MPH WIND IN 2018 NCSBC:RC

(115 MPH WIND SPEED IN ASCE 7-10 WIND MAP, PER IRC R301,2,1,1) EXP. B, RISK CAT. 2 & SEISMIC CAT. A/B.

THE DESIGN WAS COMPLETED PER 2015 IBC (SECTION 1609) & ASCE 7-10, AS PERMITTED BY R301,1,3 OF THE 2018 NCSBC:RC, ACCORDINGLY, THIS MODEL, AS DOCUMENTED AND DETAILED HEREWITHIN, IS ADEQUATE TO RESIST THE CODE REQUIRED LATERAL FORCES.

DESIGN WIND UPLIET LOADS HAVE BEEN CALCULATED UTILIZING ASCE 7-10 (ACCEPTED ENGINEERING PRACTICE) AS ALLOWED PER 2018 NCSBC:RC SECTION R802.II.I.I. THIS MODEL HAS BEEN DETAILED WHERE REQUIRED & ENGINEERED TO RESIST THE WIND UPLIFT LOAD PATH PER SECTIONS R602.3.5& R802.II.

EXT. WALL SHEATHING SPECIFICATION

- 7/16" OSB OR 15/32" PLYWOOD: FASTEN SHEATHING W/ 2 3 XO.II3 NAILS @ 6" O.C. AT EDGES & @ 12" O.C. IN THE PANEL FIELD. (TYP, U.N.O.) ALL SHEATHING PANELS SHALL BE ORIENTED
- VERTICALLY (LONG DIRECTION PARALLEL TO STUDS) AND INSTALLED FULL HEIGHT OF SHEAR WALL OR -2x HORIZONTAL BLOCKING SHALL BE PROVIDED TO SUPPORT ALL UNSUPPORTED PANEL EDGES & EDGE
- <u>ALL EXT. WALLS SHALL BE CONTINUOUSLY SHEATHED</u> AND ARE CONSIDERED SHEAR WALLS.
- ALT. STAPLE CONNECTION SPEC: 1 3/4" 16 GA STAPLES (1/6" CROWN) @ 3" O.C. AT EDGES \$ @ 6" O.C IN FIELD.

<u>3" O.C. EDGE NAILING</u>

 AT DESIGNATED AREAS - FASTEN PANEL EDGES OF WOOD STRUCTURAL WALL SHEATHING TO FRAMING W 2 3" x 0.113" NAILS @ 3" O.C. AND 12" O.C. IN THE PANEL FIELD NO STAPLE ALTERNATIVE AVAILABLE AT THIS SPEC. ALL SHEATHING PANELS SHALL BE ORIENTED VERTICALLY (LONG DIRECTION PARALLEL TO STUD) AND INSTALLED FULL HEIGHT OF SHEAR WALL - OR - 2x HORIZONTAL BLOCKING SHALL BE PROVIDED TO SUPPORT UNSUPPORTED PANEL EDGES AND 3" O.C. EDGE FASTENING.

TYP. UNIT SEPARATION WALL SHEATHING SPECIFICATION

I/2" OR 5/8" GYPSUM WALL BOARD: FASTEN GWB SHEATHING TO FRAMING W/ I \$"X0.086" COOLER NAILS OR I 1/4" DRYWALL SCREWS @ 7" O.C. T PANEL EDGES & PANEL FIELD (INCLUDING T&B PLATES

- SEE CONNECTION SPECIFICATIONS CHART FOR STANDARD SHEAR TRANSFER DETAILING. IF ADDITIONAL CAPACITY IS REQUIRED BY DESIGN. WILL BE SPECIFICALLY NOTED ON PLAN.
- DESIGN ASSUMES 16" O.C MAX. STUD SPACING, U.N.O.
- · ALL STRUCTURAL PANELS ARE TO BE DIRECTLY APPLIED TO STUD FRAMING.
- PRE-MANUFACTURED PANELIZED WALLS: FASTEN TOGETHER END STUDS OF WALL PANELS SHFATHED W/ OSB OR PLYWOOD W/ 3" x 0.120" NAILS @ 4" O.C. (THRU ONE SIDE ONLY)

INDICATES EXTENT OF INT. OSB SHEARWALL, BLOCKED PANEL EDGES. AND/OR 3" O.C. EDGE NAILING

INDICATES HOLDOWN

MULHERN+KULP RESIDENTIAL STRUCTURAL ENGINEERING 3055 Buokside Parkway, Sale 250 - Alphanta, 6A 3002



lulhern+Kulp project numbe

243-2403

SMI KM ssue date: 08-16-2024

REVISIONS

I_08_202 UPDATED MODEL NAME, OPT. EXT. COVID. PORCH


pointe HOMES

NOTES MOD GENERAL

SERENITY MASTER SET RALEIGH, NC 60 5921

S0.0

Reference S3.1 for Elevation C Detail

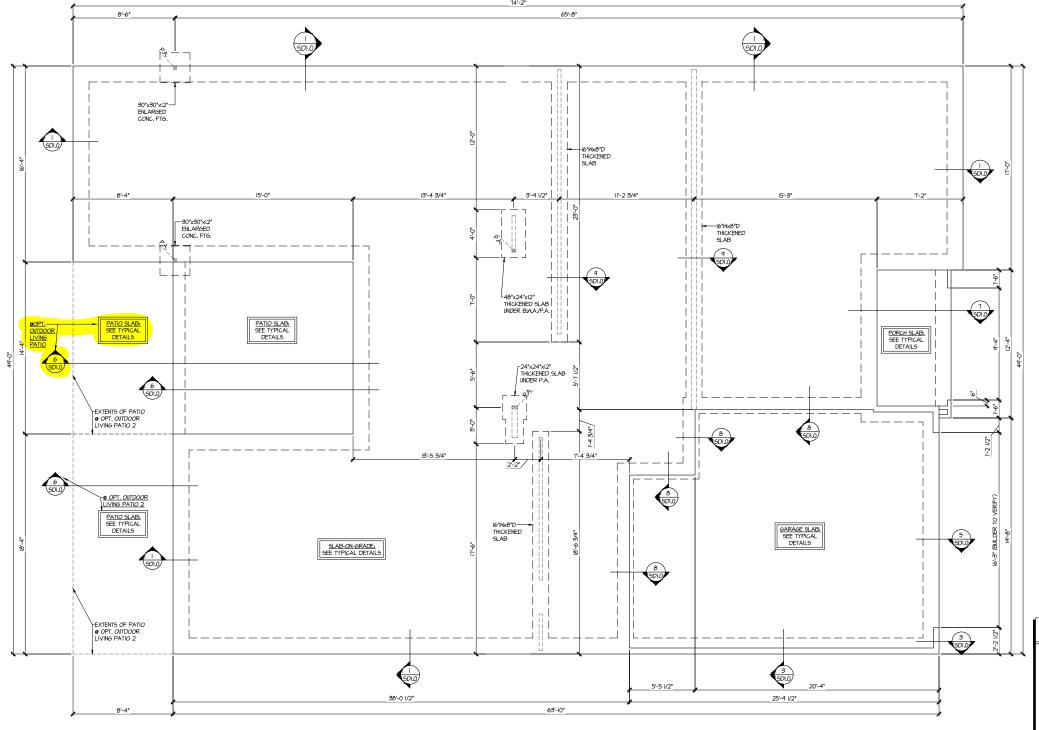

OPT. 2ND FLOOR SLAB FOUNDATION PLAN SCALE: 1/4"=1'-0" (22x24 SHEET)

1/8"=1'-0" (IIxI7 SHEET)

ELEV. A

MULHERN+KULP RESIDENTIAL STRUCTURAL ENGINERING



243-2403

issue date: 08-16-2024

UIII-08-2024 SMM
UPDATED MODEL NAME, OPT. EXT. COVID. PORCH
06-05-2025 JPP
UPDATED ARCH

tri pointe

LEGEND

- INTERIOR BEARING WALL
- ==== BEARING WALL ABOVE (B.W.A.)
- INDICATES EXTENT OF INT.

 OSB SHEARWALL AND/OR
 3" O.C. EDGE NAILING

- INDICATES HOLDOWN
- INDICATES POST ABOVE. PROVIDE SOLID BLOCKING UNDER POST OR JAMB ABOVE.

REFER TO SO.O FOR TYPICAL STRUCTURAL NOTES & SCHEDULES


STRUCTURAL OPTIONS

S3.0

5921-09 MODEI

SERENITY MASTER SET RALEIGH, NC

UNDER 9,000 SQFT FIRE RATE GARAGE SIDE WALL

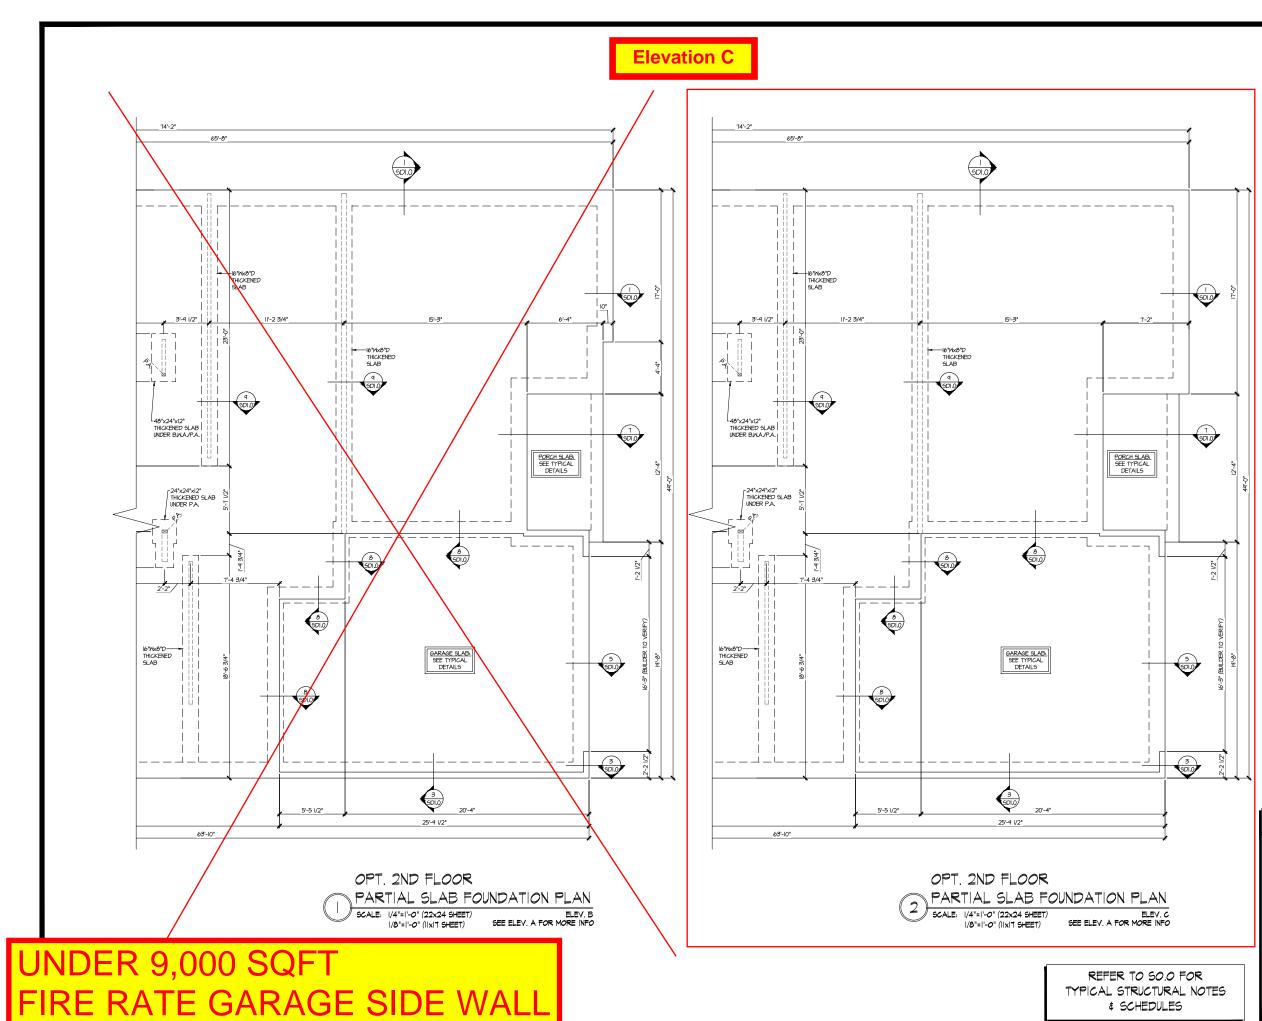

MULHERN+KULP RESIDENTIAL STRUCTORAL ENGINERING



243-2403

issue date: 08-16-2024

Gate: initial:

II-08-2024 SMM
IPPATED MODE, NAME, OPT, EXT, COVID, PORCH
06-05-2025 JPP
IPPATED ARCH

tri pointe

STRUCTURAL OPTIONS

LEGEND

- ===== BEARING WALL ABOVE (B.W.A.)
- INDICATES EXTENT OF INT.

 OSB SHEARWALL AND/OR
 3" O.C. EDGE NAILING
- EXTENT OF FLOOR SYSTEM TO BE DESIGNED FOR TILE
- NDICATES HOLDOWN

SCHEDULES

| INDICATES POST ABOVE. PROVIDE SOLID BLOCKING UNDER POST OR JAMB ABOVE.

INTERIOR BEARING WALL

EXTENT OF VALLEY TRUSS OVERFRAMING 24" O.C. (MAX.)

S3.1

5921-09 MODEI

SERENITY MASTER SET RALEIGH, NC

Reference S3.3 for Elevation C Detail

END JOIST

I4" I-JOISTS CANT'D (SERIES & SPACING PER MANUF.,

14" I-JOISTS CANT'D
(SERIES & SPACING PER MANUF,

ELEV. A

ROOF TRUSS END— VERTICALS TO SERVE AS BRG. WALL FOR HIGH TRUSSES

BMA-----(w=800 PLF)

2XIO LEDGER FASTENED TO— WALL STUDS ABOVE W (3)K,"X3½" SIMPSON SDS SCREWS @ 16" O.C. DO NOT HANG LEDGER FROM RIM



MULHERN+KULP RESIDENTIAL STRUCTORAL ENGINERING

243-2403

issue date: 08-16-2024

11-08-2024 SMM UPDATED MODEL NAME, OPT. EXT. COVID. PORCH 06-05-2025 JPP UPDATED ARCH

tri pointe

THIS LEVEL HAS BEEN DESIGNED FOR 9'-I" PLATE HEIGHT

LEGEND

- IIIII INTERIOR BEARING WALL
- ==== BEARING WALL ABOVE (B.W.A.)
- INDICATES EXTENT OF INT.

 OSB SHEARWALL AND/OR
 3" O.C. EDGE NAILING
- EXTENT OF VALLEY TRUSS OVERFRAMING
 O 24" O.C. (MAX.)
- EXTENT OF FLOOR SYSTEM TO BE DESIGNED FOR TILE
- ► INDICATES HOLDOWN
- NDICATES POST ABOVE. PROVIDE SOLID BLOCKING UNDER POST OR JAMB ABOVE.

REFER TO SO.O FOR TYPICAL STRUCTURAL NOTES & SCHEDULES

2XIO LEDGER FASTENED TO MALL STUDS ABOVE W (5)31/1x0.131" NAILS © 16" O.C. DO NOT HANG LEDGER FROM RIM

DORMER FRAMING: ROOF TRUSS OVERFRAMING B' MANUFACTURER

STEP CLG.

3 PT. BRG. ROOF TRUSSES @ 24" O.0

STEP CLG. CEILING

STEP CLG.

(2)2x6

UNDER 9,000 SQFT FIRE RATE GARAGE SIDE WALL OPT. 2ND FLOOR LOW ROOF FRAMING PLAN SCALE: 1/4"=1'-0" (22x24 SHEET) 1/8"=1'-0" (IIxI7 SHEET)


S3.2

5921-09 MODEI

SERENITY MASTER SET RALEIGH, NC

STRUCTURAL OPTIONS

Elevation C

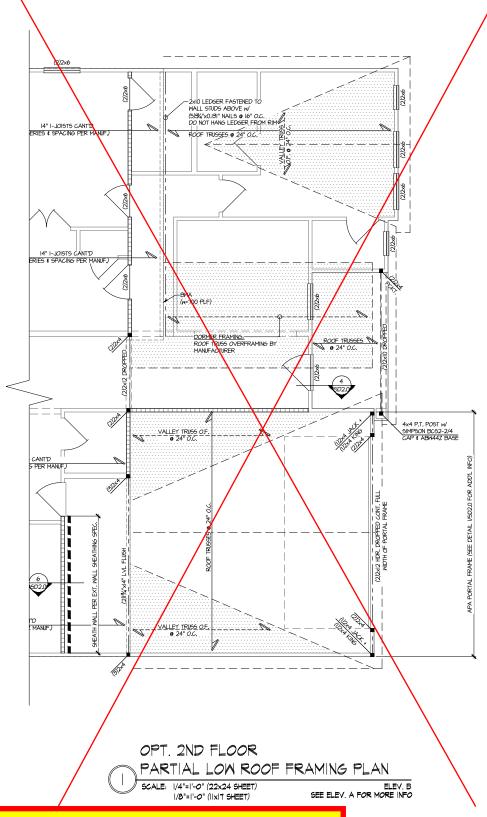

-2xi0 LEDGER FASTENED TO WALL STUDS ABOVE W (5)31/4'x0,131" NAILS @ 16" O.C. DO NOT HANG LEDGER FROM RIM 14" I-JOISTS CANT'D ERIES & SPACING PER MANUF, 4x4 P.T. POST w/ SIMPSON BC52-2/4 CAP & ABW44Z BASE ROOF TRUSSES @ 24" O.C ROOF TRUSSES @ 24" O.C OPT. 2ND FLOOR PARTIAL LOW ROOF FRAMING PLAN ELEV. C SEE ELEV. A FOR MORE INFO

SCALE: |/4"=|'-0" (22x24 SHEET) |/8"=|'-0" (||x|7 SHEET)

THIS LEVEL HAS BEEN DESIGNED FOR 9'-1" PLATE HEIGHT

REFER TO SO.O FOR TYPICAL STRUCTURAL NOTES # SCHEDULES

LEGEND

- INTERIOR BEARING WALL ===== BEARING WALL ABOVE (B.W.A.)

- INDICATES EXTENT OF INT.

 OSB SHEARWALL AND/OR
 3" O.C. EDGE NAILING
- EXTENT OF VALLEY TRUSS OVERFRAMING 24" O.C. (MAX.)
- EXTENT OF FLOOR SYSTEM TO BE DESIGNED FOR TILE
- NDICATES HOLDOWN
- * INDICATES POST ABOVE. PROVIDE SOLID BLOCKING UNDER POST OR JAMB ABOVE.

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STRUCTURAL OPTIONS 5921-09 MODEI

SERENITY MASTER SET RALEIGH, NC

S3.3

UNDER 9,000 SQFT FIRE RATE GARAGE SIDE WALL



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STRUCTURAL OPTIONS

5921-09 MODEL

S3.4

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THIS LEVEL HAS BEEN DESIGNED FOR 9'-1" PLATE HEIGHT

LEGEND

- IIIIIII INTERIOR BEARING WALL
- □===□ BEARING WALL ABOVE (B.W.A.)
- INDICATES EXTENT OF INT.

 OSB SHEARWALL AND/OR
 3" O.C. EDGE NAILING
- EXTENT OF VALLEY TRUSS OVERFRAMING
 24" O.C. (MAX.)

\$ SCHEDULES

EXTENT OF FLOOR SYSTEM TO BE DESIGNED FOR TILE

► INDICATES HOLDOWN

| INDICATES POST ABOVE. PROVIDE SOLID | BLOCKING UNDER POST OR JAMB ABOVE.


REFER TO SO.O FOR TYPICAL STRUCTURAL NOTES

UNDER 9,000 SQFT FIRE RATE GARAGE SIDE WALL OPT. 2ND FLOOR HIGH ROOF FRAMING PLAN

SCALE: 1/4"=1'-0" (22x24 SHEET) 1/8"=1'-0" (11x17 SHEET)

ELEV. A ALL ELEV. SIM.

ROOF TRUSSES • 24" O.C.

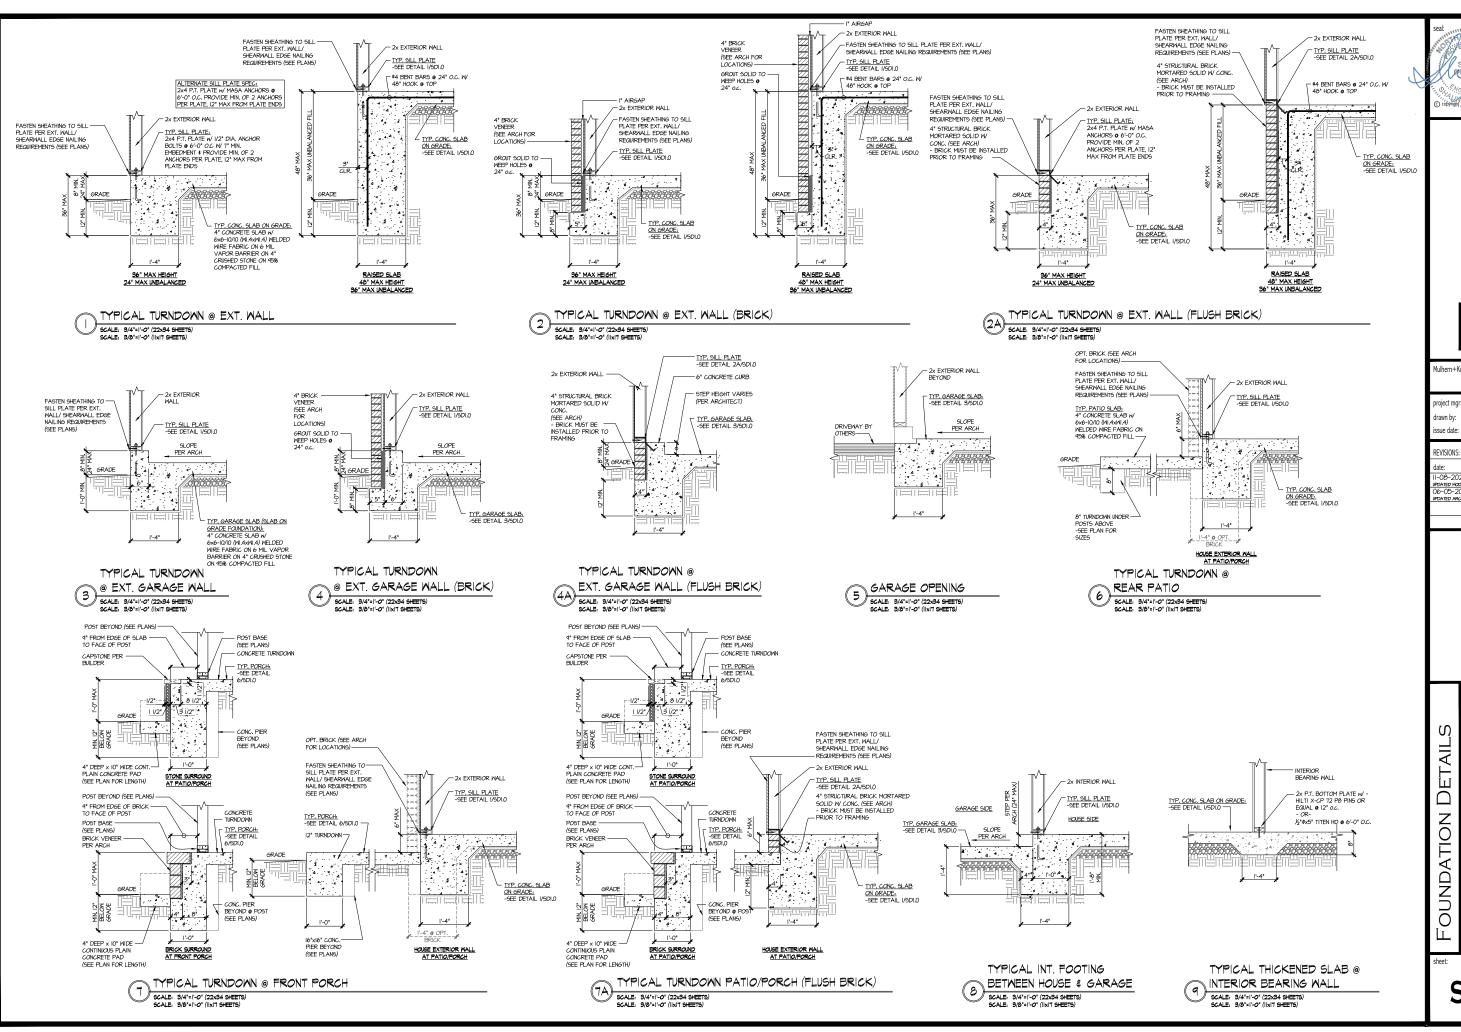

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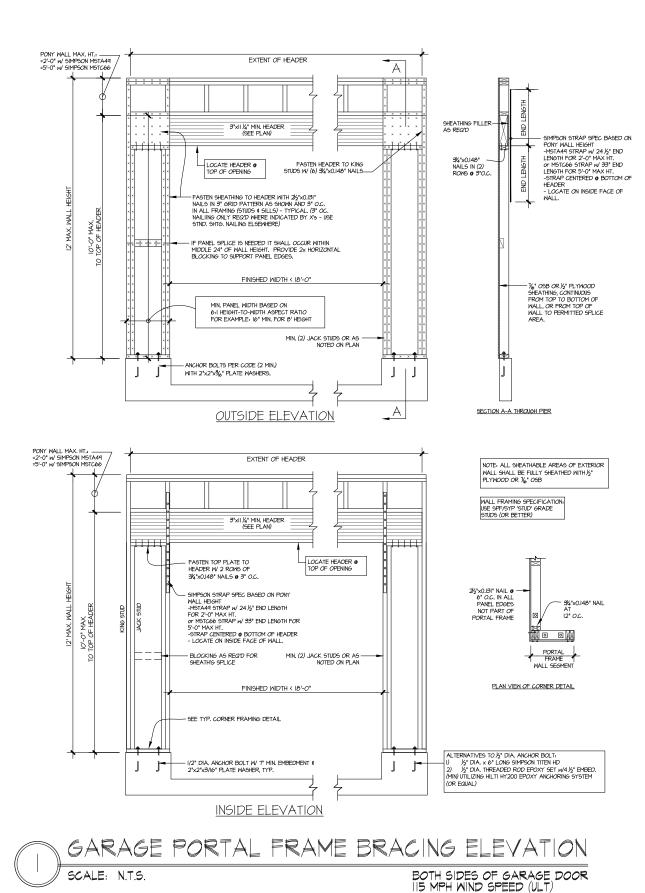
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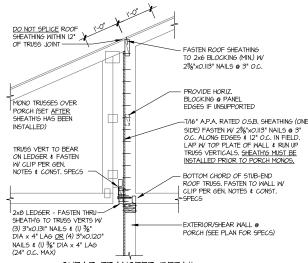
SERENITY MASTER SET RALEIGH, NC 5921-09

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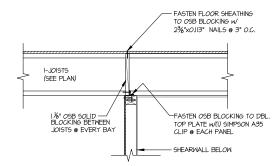


FASTEN ROOF SHEATHIN TO DRAG TRUSS W/ 2%"xO.II3" NAIL5 @ 3" DRAG TRUSS (SEE PLAN-FOR DESIGN SHEAR CAPACITY) - FASTEN BOTTOM CHORD OF DRAG TRUSS TO DBL. TOP PLATE W SIMPSON A35 CLIPS @


INTERIOR DRAG TRUSS DETAIL




SHEAR TRANSFER DETAIL @ BREAK IN TRUSSES OVER SHEAR WALL SCALE: 3/4"=1'-0" - 22x34 3/8"=1'-0" - IIxi7



SHEAR TRANSFER DETAIL @ INTERIOR SHEARWALL BELOW

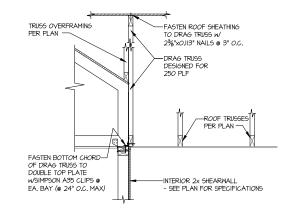

SHEAR TRANSFER DETAIL AT INTERIOR SHEARMALL BELOW

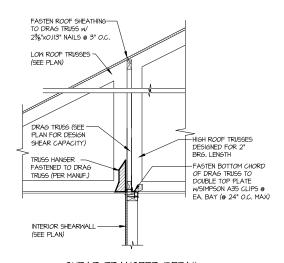

SHEAR TRANSFER DETAIL

AT INTERIOR SHEARWALL BELOW

SCALE: 3/4"=1"-0"



MULHERN+KULP
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243-2403

SMK frawn by: KΜ\ issue date: 08-16-2024

REVISIONS:


initial: UPDATED MODEL NAME, OPT. EXT. COVID. PORCH
06-05-2025
PDATED ARCH

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Ŋ DETAIL MODE FRAMING

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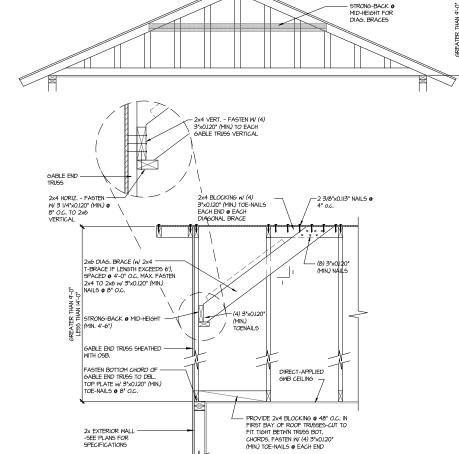
SD2.0



L' BRACES FASTENED TO — VERTICALS WHERE REQ'D BY TRUSS MANUFACTURER. FASTEN W 16d GUN NAILS (0.131 x 3 1/2*) @ 6* O.C.

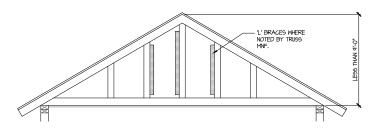GABLE END TRUSS SHEATHED-WITH OSB.

FASTEN BOTTOM CHORD OF — GABLE END TRUSS TO DBL. TOP PLATE w/ 3"x0.120" (MIN.) TOE-NAILS & 8" O.C.



TYPICAL GABLE END BRACING DETAIL SCALE: NOME REQUID 6 GABLE END TRUSS REQ'D @ GABLE END TRUSS HEIGHT UP TO 9'-0"

BRACE GABLE END TRUSSES PER ABOVE DETAIL WHEN GABLE HEIGHT IS LESS THAN 9-0". L' BRACES REQUIRED WHERE NOTED BY TRUSS MANUFACTURER.

DIRECT-APPLIED GWB CEILING —

- PROVIDE 2x4 BLOCKING ● 48" O.C. IN FIRST BAY OF ROOF TRUSSES-CUT TO FIT TIGHT BETWN TRUSS BOT. CHORDS, FASTEN W (3) 3 J V4"x0.120" (MIN.) TOE-NAILS @ EACH END

BRACE GABLE END TRUSSES PER ABOVE DETAIL WHEN GABLE HEIGHT EXCEEDS 9'-0'. 'L' BRACES NOT REQUIRED.

TYPICAL GABLE END BRACING DETAIL SCALE. NONE REQUIRE GABLE END TRUSS

REQ'D e GABLE END TRUSS HEIGHT BETWN 9'-0" TO 14'-0"

MULHERN+KULP

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NC Licence # C-36.25

Mulhern+Kulp project number:

243-24035

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UPDATED ARCH

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FRAMING DETAILS

5921-09 MODEL SERENITY MASTER SET RALEIGH, NC

SD2.1