OAK HAVEN **ABBREVIATIONS** A A PRESSURE TREATED WD HWD HARDWOOD (FL R&M RANGE W/MICROWAV LIV LIVING LTL LINTEL LVR LOUVER MAX MAXIMUM DRY DRYER MACHINE TEMP TEMPERED (GLASS U.N.O. UNLESS NOTE OTHERWISE VB VANITY BASE OA F.F. FINISH FLOOR (LIN OBS OBSCURE (GLA WH WATER HEATER FP FIREPLACE OPT OPTIONAL WIC WALK-IN CLOSE FURRED(ING) PEDESTAL (SINK) W/ W/O WITH or WITHOUT ROUND FAIL TERPROOF(ING)

GENERAL NOTES

1 - GENERAL BUILDING & DESIGN REQUIREMENTS

1) THE ATTACHED PLANS & SPECIFICATIONS ARE THE SOLE PROPERTY OF TRI POINTE HOMES ANY UNAUTHORIZED USE OF THESE PLANS WITHOUT PRIOR WRITTEN CONSENT OF TRI POINTE HOMES IS STRICTLY

- 2) TRI POINTE HOMES DESIGNS & BUILDS HOUSING AS SET FORTH BY THE FORMAT AND PROVISIONS OF TH INTERNATIONAL RESIDENTAL CODE (IRC), AND THE NATIONAL ELECTRIC CODE (NEC). ANY NON-CONFORMING DOCUMENTS DISCOVERED BY THE CONTRACTOR OR HIS AGENTS SHALL BE CALLED TO THE IMMEDIATE TTENTION OF TRI POINTE HOMES BY CALLING (469)329-0470.
-). THESE PLANS ARE SUBJECT TO MODIFICATIONS TO MEET CODE REQUIREMENTS AND/OR TO FACILITATE MECHANICAL/ ELECTRICAL/ PLUMBING INSTALLATION AND/ OR TO IMPLEMENT DESIGN IMPROVEMENTS. ANY
- INTENTION TO MODIFY THESE PLANS MUST BE APPROVED IN WRITING BY TRI POINTE HOMES
 4) CONTRACTOR SHALL BE RESPONSIBLE FOR VERIFYING ALL DIMENSIONS AFFECTING CONTRACTOR'S PRODUCTS, INSTALLATIONS, OR FABRICATIONS IN THE FIELD PRIOR TO EXPEDITING THE CONSTRUCTION OF SUCH WORK. FIELD VERIFY ALL DIMENSIONS — DO NOT SCALE DRAWINGS! CONTRACTOR IS RESPONSIBLE FOR SURVEYING THE PROJECT AND BECOMING FAMILIAR WITH THE EXISTING CONDITIONS AND SCOPE OF WORK INCLUDING BUT NOT LIMITED TO SITE AND SOIL BEARING CONDITIONS.
 5) ERRORS AND OMISSIONS WHICH MAY OCCUR IN THE CONTRACT DOCUMENTS SHALL BE BROUGHT TO THE
- OF THE ARCHITECT, IN WRITING, AND WRITTEN INSTRUCTION SHALL BE OBTAINED PRIOR TO PROCEEDING WITH CONSTRUCTION. THE CONTRACTOR SHALL BE OBTAINED PRIOR TO PROCEEDING WITH CONSTRUCTION. THE CONTRACTOR SHALL BE HELD RESPONSIBLE FOR ANY ERRORS, DISCREPANCIES, OR OMISSIONS FOR WHICH THE CONTRACTOR FAILED TO NOTIFY THE ARCHITECT PRIOR TO

2 - SITE CONSTRUCTION

BACK FILL SHALL BE FREE FROM VEGETATION AND CONSTRUCTION DEBRIS

) BACK FILL SHALL BE PLACED IN LIFTS AND COMPACTED IN SUCH A MANNER AS BACKFILL TO NOT DAM. THE FOUNDATION WALLS OR ANY WATERPROOFING/ DAMPPROOFING MATERIALS.

3 - CONCRETE

1) SLOPE ON GARAGE SLAB SHALL BE 1/8" PER FOOT TOWARDS VEHICLE DOOR. SLOPE ON PORCH AND

ALL EXTERIOR BRICK MUST MEET ASTM C-216 FOR "SW" CONDITIONS

) MASONRY VENEER SHALL BE ATTACHED TO SUPPORTING WALLS w/ CORRUGATED METAL TIES IN CCORDANCE WITH R703.7.4.1 - I.R.C. OR LOCAL CODE REQUIREMENTS

) WEEPHOLES SHALL BE PROVIDED ALONG THE OUTSIDE WYTHE OF EXTERIOR MASONRY WALLS AT 33" O.C. MAX, SHALL BE A MIN. OF 3/16" IN DIAMETER, AND LOCATED IMMEDIATELY ABOVE THE FLASHING PER 18703.7.6 – LR.C.

5 - METALS

6 - WOOD AND PLASTICS

7 - THERMAL & MOISTURE PROTECTION

) Fire stopping and/ or draft stopping shall meet the requirements of IRC R602.8. 2) Attic ventilation shall be provided at 1/300 th of the Area of the Space ventilated. Cross VANILATION WITH HALF OF THE VENTILATED AREA SHALL BE PROVIDED BY ROOF VENTS AND THE OTHER HALF BY SOFFIT VENTS. VENTS SHALL BE PLACED SO AS TO NOT ALLOW INFILTRATION OF RAIN OR SNOW.) PROVIDE APPROVED TILE BACKER DRYWALL FOR ALL SHOWER AND BATH SPACE PROVIDE ATTIC VENTILATION PER IRC-R806.1

8 - DOORS AND WINDOWS

-) REVIEW ALL WINDOW HDR HEIGHTS PER PLATE HT. AND VERIFY W/ ELEVATIONS AND CORNICE DETAILS TEMPERED GLASS SHALL BE USED IN HAZARDOUS AREAS AS DESCRIBED IN SECTION R308.4 - LR.C.
- FRONT DOOR WIDTH PER IRC-R311.3
- GARAGE DOOR PER IRC-R309.1

FMERGENCY EGRESS SHALL MEET REQUIREMENTS OF SECTION R310 - LR C 2018 - SLEEPING ROOMS HALL HAVE AT LEAST ONE EGRESS OPENING OF NOT LESS THAN 5.7 SF AND A CLEAR OPENING OF NOT IESS THAN 20" WIDE X 24" HIGH AND SHALL NOT BE MORE THAN 44" ABOVE THE FLOOR

15 - MECHANICALS

WOOD BUILT CHIMNEYS AND FIREPLACES SHALL BE INSTALLED PER MANUFACTURER'S INSTRUCTIONS AND) EXTERIOR AIR INTAKE FOR COMBUSTION AIR PER IRC SECTION AS REQUIRED BY LOCAL MUNICIPALITY

ALL FLECTRICAL INSTALLATION SHALL MEET THE REQUIREMENTS OF THE NATIONAL ELECTRIC CODE (NEC) MATERIAL AND EQUIPMENT SHALL BEAR THE LABEL OF APPROVAL OF THE UNDERWRITERS ABORATORIES, INC.

-) ELECTRICAL CONTRACTOR SHALL VERIFY SPACE REQUIRED FOR METER INSTALLATION BEFORE ONSTRUCTION AND SHALL NOTIFY GENERAL CONTRACTOR OF ANY DISCREPANCIES.
- VERIFY LOCATION OF ALL RECEPTACLES FOR APPLIANCES WITH MANUFACTURER SPECIFICATIONS. GROUND FAULT INTERRUPTS SHALL BE LOCATED PER THE NEC
- ALL SWITCHES SHALL BE INSTALLED AT 3'-6" ABOVE FINISHED FLOOR TO CENTERLINE OF SWITCH VLESS NOTED OTHERWISE
-) ALL CONVENIENCE OUTLETS SHALL BE INSTALLED W/ CENTERLINE OF OUTLET LOCATED 1'-3" ABOVE
- INISHED FLOOR UNLESS NOTED OTHERWISE ALL CONVENIENCE OUTLETS WITH SWITCHES TO BE SWITCH AT TOP ONLY.
- ALL EXTERIOR WALL BRACKET FIXTURES SHALL BE INSTALLED AS NOTED ON PLANS.

 APPROVED SMOKE DETECTORS SHALL BE LOCATED ON EVERY STORY OF THE DWELLING UNIT AS PER IRC
- CTION R317 (SEE SHEET B1.1 FOR LOCATIONS). WHERE MORE THAN ONE DETECTOR IS REQUIRED THEY SHALL BE INTERCONNECTED. POWER SOURCE SHALL BE BUILDING POWER w/ BATTERY BACKUP.)) CONDUCTORS SHALL BE OF COPPER

GENERAL FRAMING SPECS AND CONSTRUCTION NOTES STAIRS:

) THE MAXIMUM RISER HEIGHT SHALL BE 7 3/4 INCHES AND THE MINIMUM TREAD DEPTH SHALL BE 10

HANDRAILS HAVING MINIMUM AND MAXIMUM HEIGHTS OF 34 INCHES AND 38 INCHES SHALL BE OVIDED ON AT LEAST. ONE SIDE OF STAIRWAYS IN ACCORDANCE WITH SECTION R315.1 - I.R.C HANDRAIL AND BALUSTRADE (WHERE PRESENT) SHALL BE CONSTRUCTED ACCORDING TO IRC. ALL REQUIRED HAND RAILS SHALL BE CONTINUOUS THE FULL LENGTH OF THE STAIRS W/ 2 OR MORE SERS FROM A POINT ABOVE THE THE TOP RISER OF A FLIGHT TO A POINT ABOVE THE LÓWEST RISER OF THE FLIGHT. ENDS SHALL BE RETURNED OR SHALL TERMINATE AT NEWEL POSTS OR SAFETY TERMINALS. ANDRAILS ADJACENT TO A WALL SHALL HAVE A SPACE OF NOT LESS THAN 1.5" BETWEEN THE WALL

WALLS:

) ALL DIMENSIONS ARE FROM FACE OF STUD TO FACE OF STUD. ALL STUDS ARE 3 1/2" UNLESS NOTED. LL DIMENSIONS PRESENTED HERE ARE FRAME DIMENSIONS ONLY.

SEPARATION BETWEEN THE RESIDENCE AND THE GARAGE SHALL BE MAINTAINED BY INSTALLATION OF \sharp GYPSUM BOARD ON ALL COMMON WALLS. 2-STORY HOMES REQUIRE 5/8" TYPE X GYPSUM BOARD AT CARAGE CEILINGS WHERE HABITABLE ROOMS ARE PRESENT ABOVE.

FLOORS:

STRUCTURAL FLOOR MEMBERS SHALL NOT BE CUT, BORED, OR NOTCHED IN EXCESS OF THE LIMITATIONS

) THE ENDS OF EACH JOIST, BEAM, OR GIRDER SHALL HAVE NOT LESS THAN 1.5 INCHES OF BEARING ON WOOD OR METAL AND NOT LESS THAN 3 INCHES ON MASONRY OR CONCRETE OR AS OTHERWISE SPECIFIED

) ALL DIMENSIONAL FLOOR JOISTS TO BE PER ENGINEER STRUCTURAL PLANS.

FRAMING:

ALL FRAMING DIMENSIONS TO FACE OF MEMBER.

ALL BEARING HEADERS TO BE PER ENGINEERING PLANS. FIRE STOPPING AND / OR DRAFT STOPPING SHALL MEET THE REQUIREMENTS OF IRC R602.8

ROOF

) HIP AND VALLEY RAFTERS SHALL BE SUPPORTED AT RIDGE DOWN TO BEARING PARTITION. CUT ENDS OF AFTERS SHALL BE FULLY SUPPORTED WALL AND RIDGE

) REQUIRED VENTILATION AREAS CALCULATED AT 1/300 RATIO.

SQUARE FOOTAGE Elevation "C"

(Slab S.F.)	
Slab Area	Sq. Ft.
FIRST FLOOR	1674
2 BAY GARAGE	405
PORCH	33
COVERED OUTDOOR LIVING	276
Total Slab Area	2388

(Outside of Frame S.F.)		
A/C Area	Sq. Ft.	
FIRST FLOOR	1674	
Total A/C Area	1674	
Non-A/C Area	Sq. Ft.	
2 BAY GARAGE	405	
PORCH	33	
COVERED OUTDOOR LIVING	276	
Total Non-A/C Area	714	

(Inside of Frame S	S.F.)
C Area	Sq. Ft.
RST FLOOR	1625

NOTE: ALL OPTIONAL SQUARE FOOTAGES LISTED ARE INDEPENDENT OF AND IN ADDITION TO BASE SQUARE FOOTAGES.

OPTIONS IMARY SUITE TRAY CEILING PRIMARY BATH 1 EXTENDED OUTDOOR LIVING SCREENED EXT. OUTDOOR LIVING OUTDOOR LIVING FIREPLACE AUNDRY CABS AT LAUNDRY

NDER 9000


BUILDING CODE COMPLIANCE CONSTRUCTION PLANS DESIGNED TO MEET OR EXCEED ELECTRICAL PLANS DESIGNED TO MEET OR EXCEED MINIMUM

TABLE OF CONTENTS

	SHEET LEGEND
SHEET NO.	TYPE OF SHEET/LAYOUT
"G0.01"	COVER SHEET & GEN. NOTES
"G0.11"	REVISIONS & SYMBOLS
"S1.10C"	BASE FOUNDATION PLAN - ELEVATION 'C'
"A1.10C"	FIRST FLOOR PLAN - ELEVATION 'C'
"A2.01C"	EXTERIOR ELEVATIONS - 'C'
"A2.02C"	EXTERIOR ELEVATIONS - 'C'
"A3.01C"	ROOF PLAN — ELEVATION 'C'
"A4.01"	INTERIOR DETAIL SHEET
"E1.10C"	1ST FLR. ELECTRICAL PLAN — ELEVATION 'C'
"D1.1"	DETAILS

Lot 331 - 5919-03 - Elevation C

- *Fire-Rated Garage Side
- *Fire-Rated Non-Garage Side
- *Tile Walls at Bath 2 Tub
- *Optional Primary Bath 1 w/ Zero Entry Pan
- *Tray Ceiling Primary Bedroom
- *Optional 8' Interior Doors @ 1st Floor
- *Gourmet Kitchen w/ Cooktop & Appliance Hood
- *Laundry Sink w/ Base Cabinets & Upper Cabinets
- *Optional Outdoor Fireplace
- *Exterior Gas Stub Out
- *Optional Screened Extended Covered Outdoor Living
- *Optional Office ILO Flex Space
- *Recirculating Tankless Water Heater

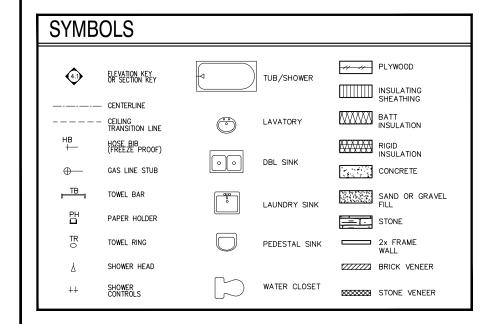

DointeHOMES

Blvd Business Operation 5440 Wade Park Blvc Suite 400 Raleigh, NC 27607

SERENITY GENERAL @ ALTIS ઝ SHEET

SUBDIVISION: ADDRESS:

10-01-24 Issue Date: ACC

5919-03

OAK HAVEN

G0.01

	REVISION INDEX		
REL. #	DESCRIPTION	DATE	DRAWN BY
5919-03	NFW PI AN	10/01/2024	ACC
	ADDED ATTIC PULL-DOWN, REVISED ROD/SHELF IN PRIMARY WIC, ADDED OPTIONS - SCREENED COVERED OUTDOOR LIVING, GOURMET KITCHEN KITCHEN, ZERO ENTRY SHOWER AT PRIMARY BATH, ADDED TRIM SURROUNDING VENTS AT VARIOUS ELEVATIONS, REVISED BENCH DETAIL, - ADDED OF LAUNDRY, CABINETS, ADDED OF LAUNDRY, CABINETS, ADDED OF LAUNDRY, CABINETS, ADDED OF LAUNDRY, CABINETS, ADDED DISHWASHER ACCESSIBLE DISCONNECT SWITCH AND COUNTER-TOP AIR SWITCH FOR DISPOSAL NOTES	01/19/2025	ACC
	ADDED SHOWER NICHE NOTE, ADDED CURB TO SHOWERS, REVISED INT/EXT FIREPLACE DEPTHS, REVISED OPENING HEADER HEIGHTS THROUGHOUT, REVISED REAR EXTERIOR DOOR TO 3', ADDED DOOR HEIGHTS TO MAIN FLOOR NOTES, ADDED BATH ACCESSORY HEIGHTS TO MAIN FLOOR NOTES, ADDED ZERO ENTRY SHOWER DETAIL, REMOVED PRIMARY BATH 2 OPTION, ADDED OUTDOOR LIVING PATIO OPTION, ADDED PARTIAL SHOWER NICHE DETAIL, ADDED COURNET KITCHEN INTERIOR, REVISED ELECTRICAL / ELECTRICAL OPTION AT GREAT ROOM AND PRIMARY BATH.	04/13/2025	ACC
	BEING, ABBUT GOOKMET NITHEN INTENDIT, RESED ELECTROAL / ELECTROAL OF HOW AT GREAT ROOM AND FRIMARY DATE.		

tri pointe Homes 5440 WADE PARK BLVD, SUITE 400, RALEIGH, NG 27607

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SUBDIVISIONS & SYMBOLS
SUBDIVISION: ALTIS ® SERENITY
ADDRESS: 244 STREAMSIDE TER
LOT: 331


Issue Date: 10-01-24

Drawn By: ACC

5919-03

OAK HAVEN

G0.11

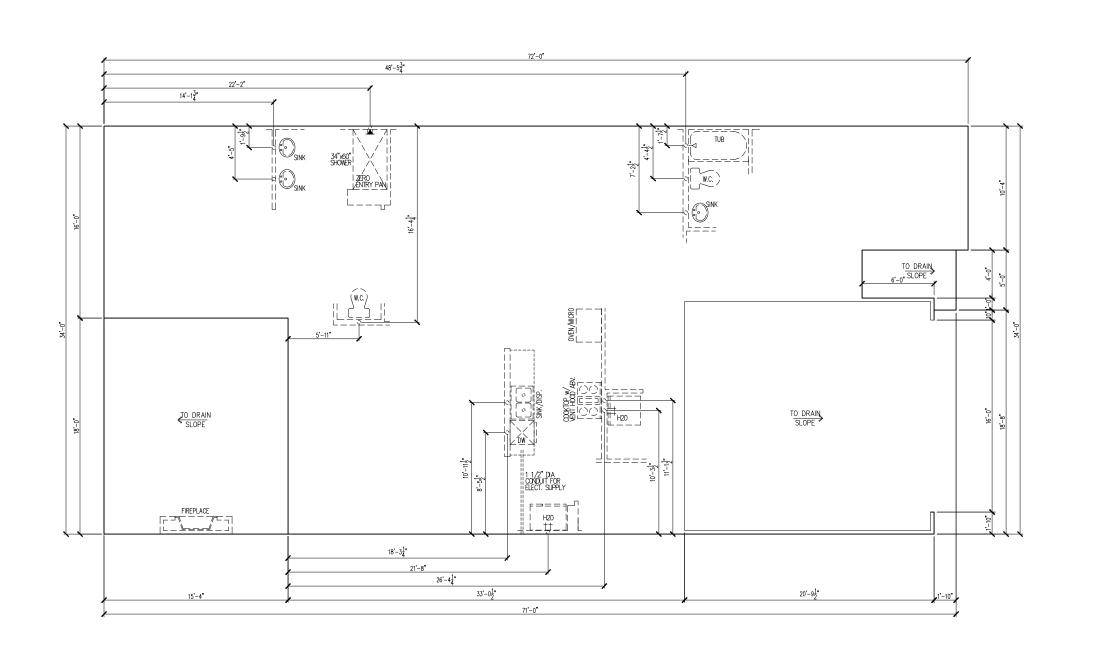

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HOMES

540 WADE PARK BLYD, SUITE 400, RALFIGH, NG 27807

Business Operations 5440 Wade Park Blvd Suite 400 Raleigh, NC 27607

SUBDIVISION: ALTIS ® SERENITY
ADDRESS: 244 STREAMSIDE TER
LOT: 331 BASE FOUNDATION PLAN


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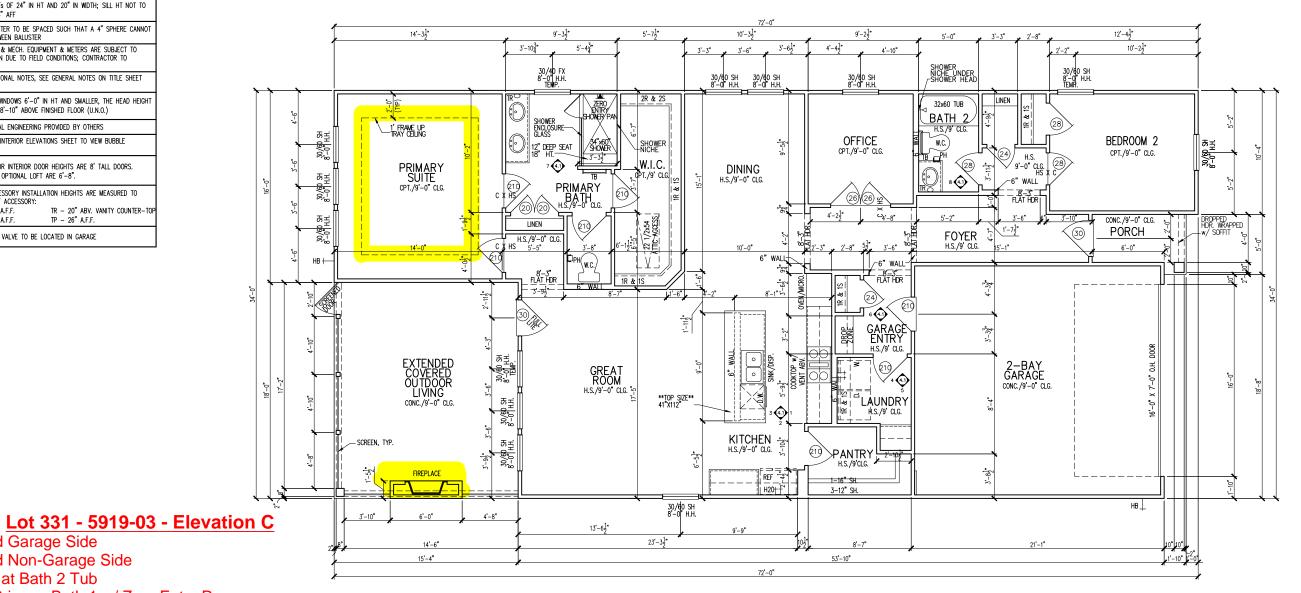
Drawn By: ACC

PLAN #: 5919-03

OAK HAVEN

S1.10C



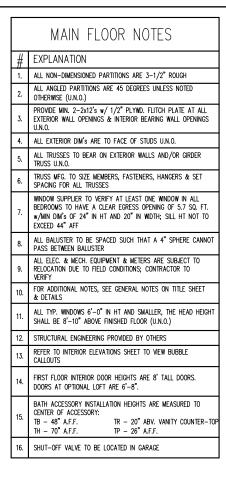

*Fire-Rated Garage Side

*Fire-Rated Non-Garage Side

*Tile Walls at Bath 2 Tub

*Optional Primary Bath 1 w/ Zero Entry Pan

*Tray Ceiling Primary Bedroom

*Optional 8' Interior Doors @ 1st Floor

*Gourmet Kitchen w/ Cooktop & Appliance Hood

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*Optional Outdoor Fireplace

*Exterior Gas Stub Out

*Optional Screened Extended Covered Outdoor Living

*Optional Office ILO Flex Space

*Recirculating Tankless Water Heater

Dointe S HOME S HOW, SUITE 400, RALEIGH, NC 27607

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ALTIS @ SERENITY STREAMSIDE TER FLOOR 1st


SUBDIVISION: ADDRESS: LOT: 331 10-01-24

Issue Date: ACC


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OAK HAVEN


A1.10

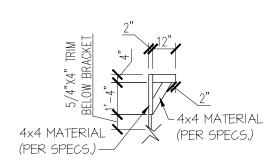


BRACKET DETAIL

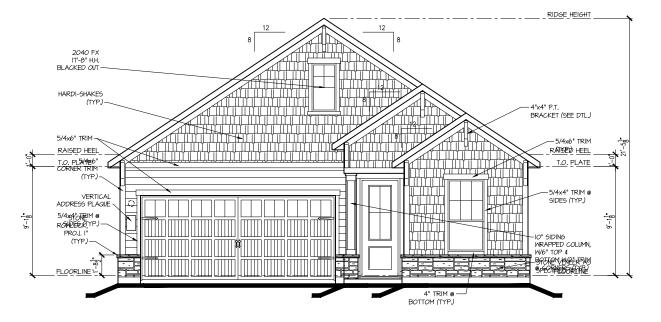

FRONT ELEV. "C"

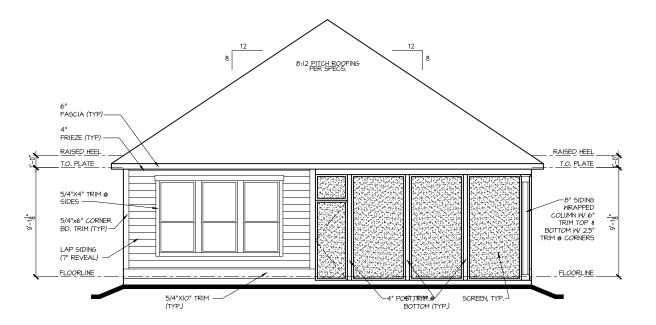

REAR ELEV. "C"

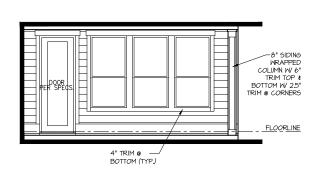

COVERED OUTDOOR LIVING ELEVATION

tribointe, HOMES HOW WAS BLYD, SUITE 400, RALEGH, NC 27607

Business Operations 540 Wade Park Blvd Suite 400 Raleigh, NC 27607

SUBDIVISION: ALTIS ® SERENITY
ADDRESS: 244 STREAMSIDE TER
LOT: 331

10-01-2-


Issue Date: 10-01-24


Drawn By: ACC

5919-03

OAK HAVEN

A2.01C

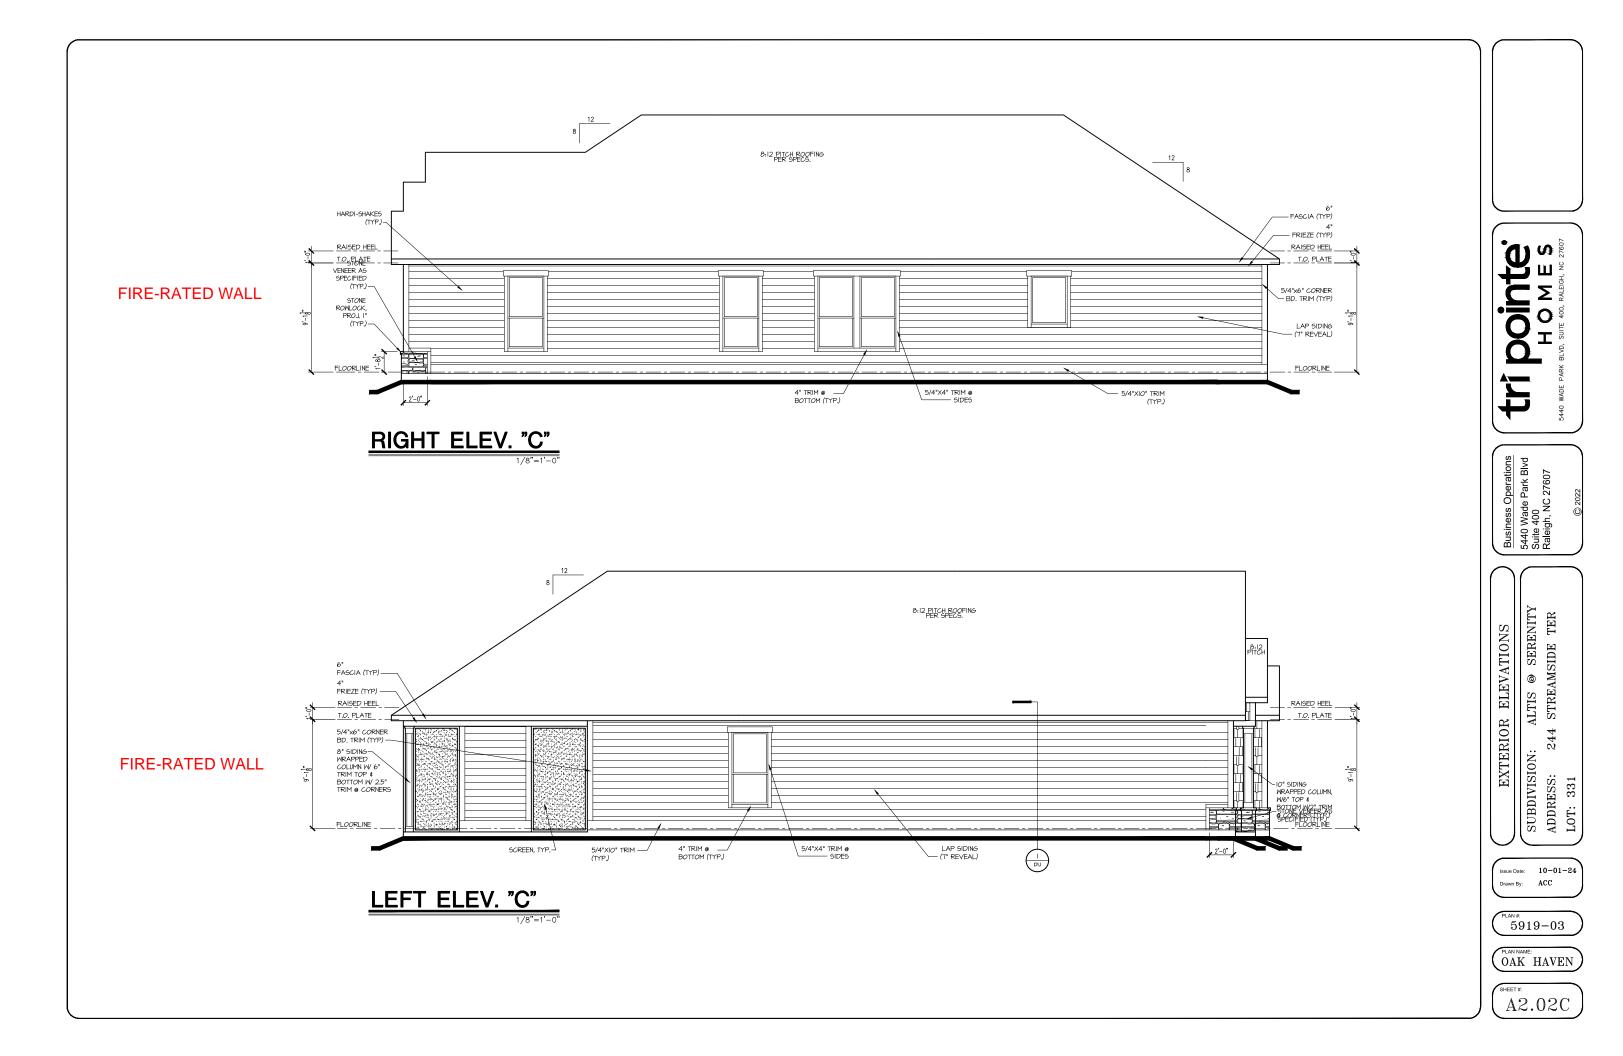

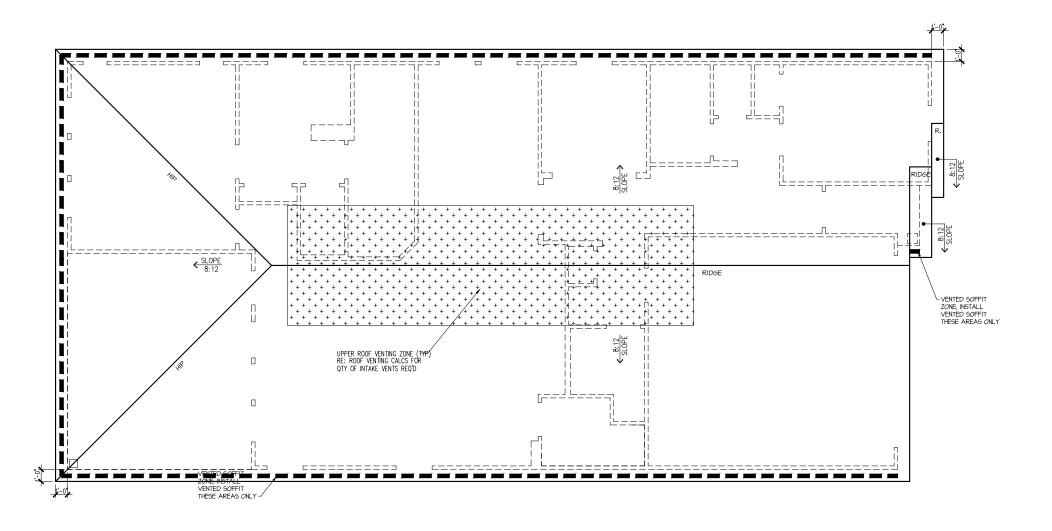

Attic Venting Calculations Elev. "C" ROOF INFORMATION BASE TOTAL SF ROOF AREA 2492 AVAILABLE L.F. ROOF SOFFIT 178 47 QTY VENTS REQ'D AVAILABLE L.F. ROOF RIDGE VENT TYPES
LOWER VENTS
CONTINUOUS SOFFIT VENTING
@ 5 SI/LF
UPPER VENTS
SLANT 150 VENTS @ 150
SI/VENT
UPPER VENTS
RIDGE VENTS @ 72 SI/VENT 120 LF

NOTE:
QTY OF UPPER VENTS SHOWN COVERS 100% OF UPPER VENTING. NO MIXING
OF VENT TYPES FOR UPPER VENTING IS FIGURED FOR IN THIS TABLE.

ROOF PLAN 'C'

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: ALTIS @ SERENITY 244 STREAMSIDE TER ROOF PLAN


SUBDIVISION:
ADDRESS: 2LOT: 331

Issue Date: 10-01-24 Drawn By: ACC

5919-03

OAK HAVEN

A3.01C

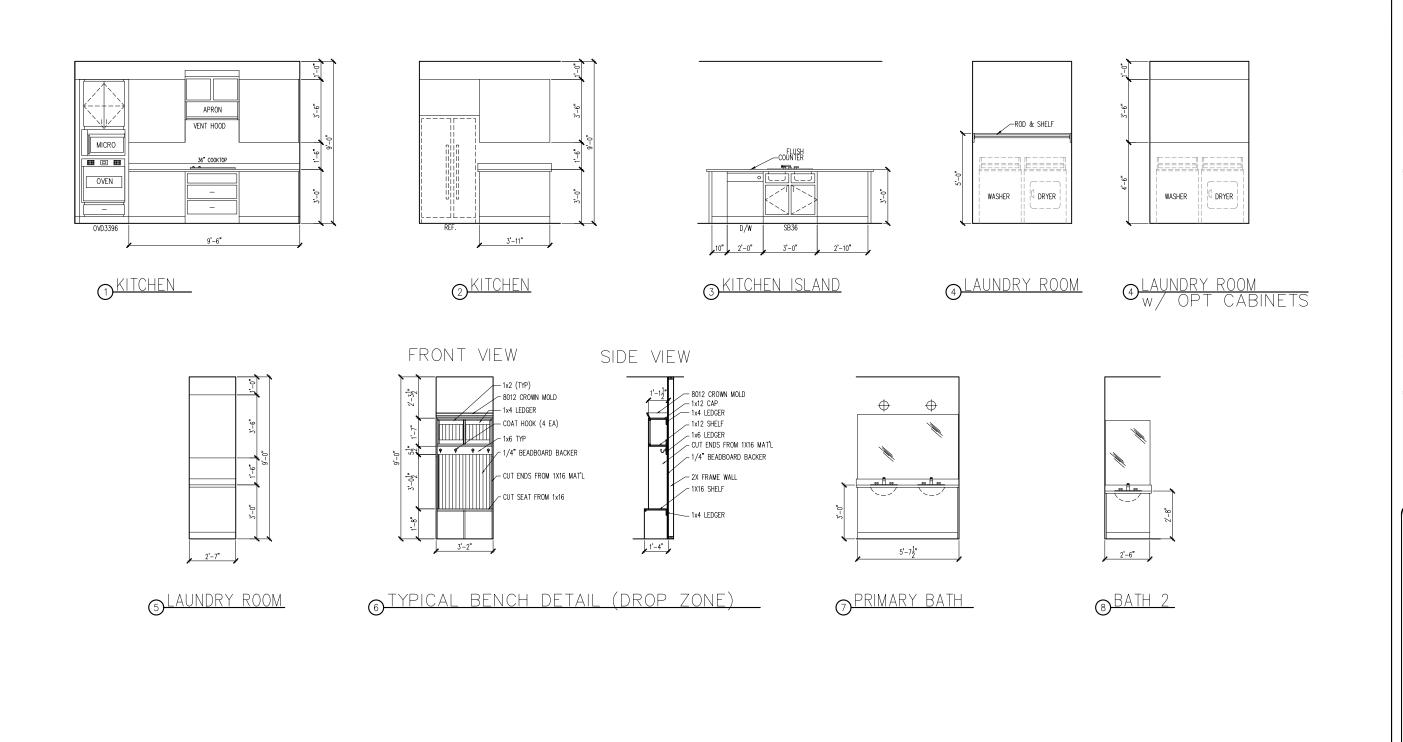

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INTERIOR DETAIL SHEET

SUBDIVISION: ALTIS ® SERENITY ADDRESS: 244 STREAMSIDE TER LOT: 331

Issue Date: 10-01-24 Drawn By: ACC

5919-03

OAK HAVEN

A4.01


ELECTRICAL I SCHEDU	FIXTURE LE
DESCRIPTION	SYMBOL
110V OUTLET	ф
220V OUTLET	\$ 220
1/2 HOT OUTLET	₩
GFI OUTLET	∜\$ GFI
WP GFI OUTLET	₩P/GFI
GARAGE DOOR OPENER OUTLET	Ø GDO
SECURITY SYSTEM	∯ SEC SYS
DISHWASHER	⊗ DW
JUNCTION BOX	9
CEILING MOUNTED LIGHT	ϕ
CEILING FAN w/ LIGHT KIT	BRAYING
RECESSED CEILING LIGHT	Ø
RECESSED WATER PROOF LIGHT)®(WP
WALL MOUNTED LIGHT	9
WALL MOUNTED PUSH BUTTON	å PB
TWO WAY SWITCH	\$
THREE WAY SWITCH	*\$
FOUR WAY SWITCH	⁴\$
DIMMER SWITCH	\$ ^{DIM}
EXHAUST VENTS	SVENT TO EXT
LOW VOLTAGE PANEL	
PHONE OUTLET	●PH
TV OUTLET	● TV
DATA & RG6 COMBO BOX	
SMOKE DETECTOR	<u> </u>
CARBON MONOXIDE SMOKE DETECTOR COMBO	⊚ CM/SD
DOOR CHIMES	CHIMES
ELECTRICAL PANEL	EP EP
SURFACE MOUNT LED	•
EXTERIOR WALL MOUNT UPLIGHT	88
SOFFIT MOUNT FLOOD LIGHT	442
UNDER COUNTER LIGHTING	ess-UCL
SMURF TUBE	

ELECTRICAL NOTES:

- 1. PROVIDE AND INSTALL LOCALLY CERTIFIED SMOKE AND CARBON MONOMOE DETECTIORS REQUIRED BY NATIONAL FIRE PROTECTION ASSOCIATION (NFPA) AND MEETING THE REQUIREMENTS OF ALL GOVERNING CODES
 2. PROVIDE AND INSTALL ORGUND FAULT CIRCUIT—INTERRUPTERS (OFF) AS REQUIRED BY NATIONAL ELECTRIC CODE (NEC) AND MEETING THE REQUIREMENTS OF ALL GOVERNING CODES.
 5. ELECTRICAL CONTRACTOR TO PROVIDE REQUIRED DIPECT HOOK—UPS/CUTOFFS.
 HVAC CONTRACTOR TO VERIFY THERMOSTAT LOCATIONS.
 ALL ELECTRICAL AND MECHANICAL EQUIPMENT (I.E. FURNACES, A/C UNITS, ELECTRICAL PANELS, SANITARY SUMP PIRS, DRAIN TILE SUMP, AND WATER HEATERS) ARE SUBJECT TO RELOCATION DUE TO FIELD CONDITIONS.

WATER HEATERS) ARE SUBJECT TO RELOCATION DUE TO FIELD CONDITIONS.
ELECTRICAL DEVICES: ABOVE FINISHED FLOOR:
SWITCHES OVER COUNTER
WALL OUTLETS OVER COUNTER
+42" TO BOTTOM OF HORIZONTAL OUTLET(TYP. @ COUNTER)
REMAINING SWITCHES
WALL OUTLETS
BATH VANITY BRACKET OUTLET 1,2 (1" ABOVE TOP OF VANITY)
WATER SOFTENER AND SUMP OUTLETS 48" TO CL
EXTERIOR GFI OUTLETS
GARAGE GFI (ABOVE GARAGE FLOOR) 48" TO CL
FRONT DOOR COACH LIGHT
GARAGE DOOR COACH LIGHT, (ABOVE GARAGE FLOOR)
THERMOSTAT
DOORBELL CHIMES
DOORBELL BUTTON DR HANDLE
KITCHEN HOOD FAN "WHIP"
KITCHEN WALL HUNG MICROWAVE OUTLET 72" TO CL
KITCHEN DISHWASHER RECEPTACLE UNDER SINK
KITCHEN RANGE
KITCHEN REFRIGERATOR
WASHER/DRYER OUTLET

CL = CENTER LINE 1 = FIELD VERIFY 2 = MASTER BATH STANDARD 30" HIGH VANITY TO BE RAISED 4"

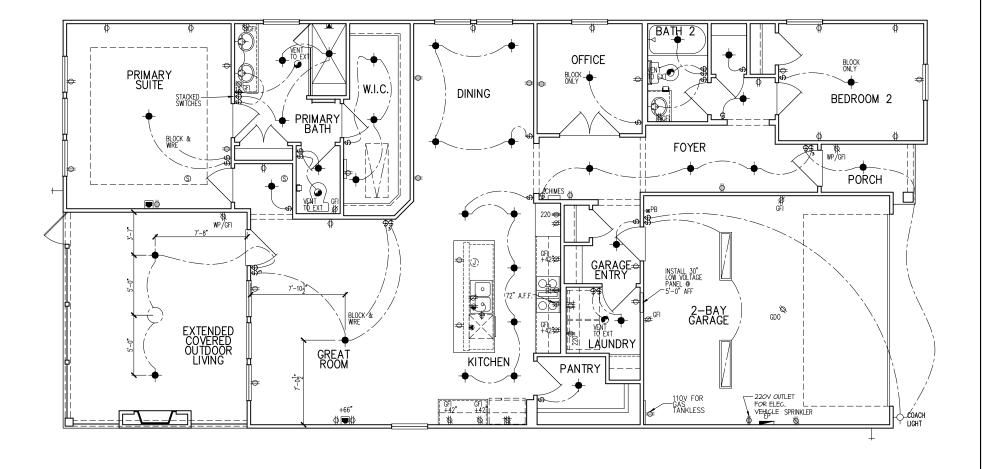

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Business Operations 5440 Wade Park Blvd Suite 400 Raleigh, NC 27607

ALTIS ® SERENITY 4 STREAMSIDE TER ELECTRICAL PLAN 244 1st FLOOR SUBDIVISION:
ADDRESS: 24
LOT: 331

Issue Date: 10-01-24 Drawn By: ACC

5919-03

OAK HAVEN

E1.10C

ELECTRICAL I SCHEDU	FIXTURE LE
DESCRIPTION	SYMBOL
110V OUTLET	ф
220V OUTLET	₩ 220
1/2 HOT OUTLET	(
GFI OUTLET	∜\$ GFI
WP GFI OUTLET	₩P/GFI
GARAGE DOOR OPENER OUTLET	Ø GDO
SECURITY SYSTEM	φsec sys
DISHWASHER	⊕DW
JUNCTION BOX	Ũ
CEILING MOUNTED LIGHT	

ELECTRICAL NOTES:


- 1. PROVIDE AND INSTALL LOCALLY CERTIFIED SMOKE AND CARBON MONOXIDE DETECTORS REQUIRED BY NATIONAL FIRE PROTECTION ASSOCIATION (NFPA) AND MEETING THE REQUIREMENTS OF ALL GOVERNING CODES.
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 3. ELECTRICAL CONTRACTOR TO PROVIDE REQUIRED DIRECT HOOK—UPS/CUTOFFS.
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DUE TO FIELD CONDITIONS.	
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THERMOSTAT	
DOORBELL CHIMES	
DOORBELL BUTTON DR .HANDLE	
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KITCHEN RANGE	
KITCHEN REFRIGERATOR	
WASHER/DRYER OUTLET	
CL = CENTER LINE	

CL = CENTER LINE

1 = FIELD VERIFY

2 = MASTER BATH STANDARD 30" HIGH
VANITY TO BE RAISED 4"

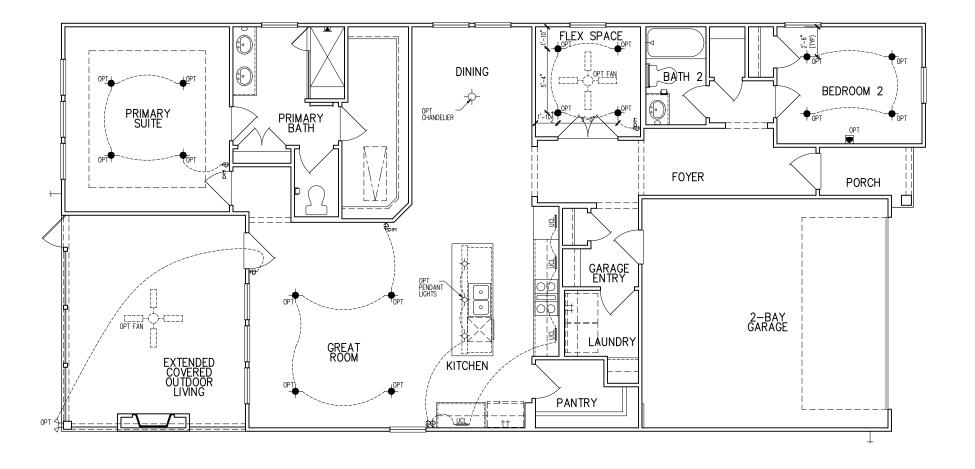

Dointe HOMES RELD. SUITE 400, RALEIGH, NG 27607

Business Operations 5440 Wade Park Blvd Suite 400 Raleigh, NC 27607

- OPITONS : ALTIS @ SERENITY 244 STREAMSIDE TER 1st FLOOR ELEC. PLAN SUBDIVISION:
ADDRESS: 24
LOT: 331

Issue Date: 10-01-24 ACC

5919-03

OAK HAVEN

E1.11C

NOTE:
I. FIREWALL COMPIES WITH UL DESIGN #U364 FOR I HR. FIREWALL ASSEMBLY
GLASS BLOCK IS NOT TO EXCEED 100 SQ. FT.
60 MIN. FIRE-RATED GLASS BLOCK ONLY

COMPOSITE ROOFING PER BUILDER
SPEC

ROOF SHEATHING
ROOFING UNDERLAYMENT

CONTINUOUS CK BEAD

MIL EDGE FLASHING
W/ DRIP

2x6 FASCIA,
VERIFY SIZE W/ BUILDER


(2) LAYERS APPROVED EXT.
RATED 5/8" TYPE "X" GYP. BD.

CEMENTITIOUS COMPOSITE
FRIEZE PER ELEVATION

LAP SIDING

EXTERIOR

INTERIOR

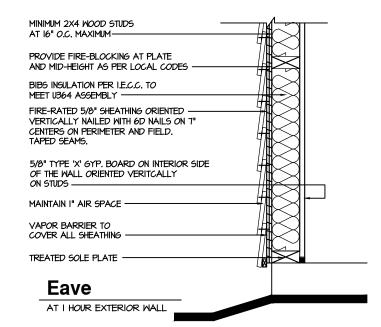





NOTE:


I. FIREMALL COMPIES WITH UL DESIGN #U364 FOR I HR. FIREMALL ASSEMBLY

GLASS BLOCK IS NOT TO EXCEED 100 SQ. FT.

60 MIN, FIRE-RATED GLASS BLOCK ONLY

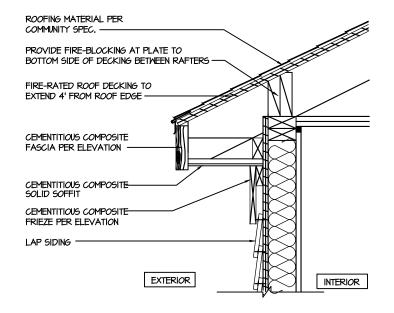

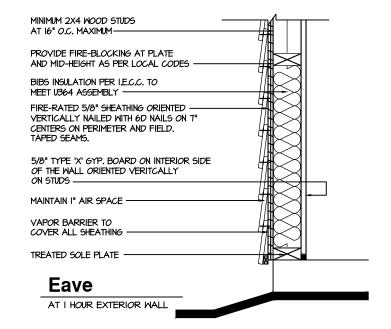

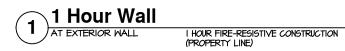

tri pointe Homes S440 WAE PARK BLYD. SUITE 400, RALEIGH, NO 27807

Business Operations 5440 Wade Park Blvd Suite 400 Raleigh, NC 27607

> : ALTIS ® SERENITY 244 STREAMSIDE TER

SUBDIVISION: ADDRESS: 244

Issue Date: 10-01-24

Drawn By: ACC

5919-03

OAK HAVEN

D1.1

GENERAL STRUCTURAL NOTES

FLOOR FRAMING

- I IOISTS/TRUSSES SHALL BE DESIGNED BY MANUE TO MEET OR EXCEED L/480 LIVE LOAD DEFLECTION CRITERIA. (EXCLUDES STONE/MARBLE OR WET BED CONSTRUCTED FLOORS - CONTACT M&K FOR EXCLUDED FLOOR DESIGNS)
- PER THE GUIDELINES OF THE TILE COUNCIL OF NORTH AMERICA (TCNA HANDBOOK), IT SHALL BE THE FLOOR FINISH INSTALLER'S RESPONSIBILITY TO VERIEY THAT THE FINISHES TO BE INSTALLED. MATCH THE DESIGN CRITERIA NOTED ABOVE (UNDER "DESIGN LOADS")
- FLOOR SYSTEMS & SHEATHING HAVE BEEN DESIGNED TO SUPPORT ADDITIONAL DEAD LOAD FROM CERAMIC TILE (EXCLUDING MARBLE OR STONE). HOWEVER, IT SHALL BE THE FLOOR FINISH INSTALLER'S RESPONSIBILITY TO PROVIDE PROPER UNDERLAYMENT, UNCOUPLING MEMBRANE AND MORTAR/GROUT PER THE ASSEMBLY DESIGNATIONS IN THE TONA HANDBOOK (TILE COUNCIL OF NORTH AMERICA).
- AT I-JOIST FLOORS, PROVIDE I 1/8" MIN. OSB RIM BOARD.
- METAL HANGERS SHALL BE SPECIFIED BY MANUFACTURER, U.N.O.
- I-JOIST/TRUSS SHOP DWGS. SHALL BE SUBMITTED TO ARCH. & ENG. FOR REVIEW AND APPROVAL PRIOR TO FABRICATION OR DELIVERY
- FLOOR SHEATHING SHALL BE 23/32" A.P.A. RATED 'STURD-I-FLOOR' 24" O.C. EXPOSURE I (OR APPROVED EQUAL) WITH TONGUE AND GROOVE EDGES. FASTEN TO FRAMING MEMBERS W GLUE AND
- 2 ½" × 0.131" NAILS @ 6"o.c. @ PANEL EDGES & @ 12"o.c. FIELD.
- 2 3 × 0.120 NAILS @ 4" O.C. @ PANEL EDGES \$ @ 8" O.C. FIELD. - 2 3" x 0.113" NAIL 5 @ 3" Q.C. @ PANEL EDGES & @ 6" Q.C. IN FIELD

ROOF FRAMING

- ROOF SHEATHING SHALL BE 1/16" A.P.A. RATED SHEATHING 24/16 EXPOSURE I (OR APPROVED EQUAL). FASTEN TO FRAMING MEMBERS
- W/ 2 ½" × 0.131" NAILS @ 6"o.c. @ PANEL EDGES & @ 12" O.C. FIELD.
- w/ 2 🖁 × 0.120" NAILS 🥑 4"o.c. 🧇 PANEL EDGES 🕻 💇 8" O.C. FIELD. - w/ 2 🐉 × 0.113" NAILS @ 3"o.c. @ PANEL EDGES & @ 6" O.C. FIELD
- WITHIN 48" OF ALL ROOF FDGES RIDGES & HIPS FASTEN ROOF SHEATHING FIELDS PER EDGE NAILING SPEC
- EASTEN EACH ROOF TRUSS TO TOP PLATE W/ SIMPSON H25T CLIP (OR APPROVED EQUAL) @ ALL BEARING POINTS. PROVIDE (2) H2.51 CLIPS AT 2-PLY GIRDER TRUSSES, (3) H2.5T CLIPS AT 3-PLY GIRDER TRUSSES & ROOF BEAMS - AT ALL BEARING POINTS.
- METAL HANGERS SHALL BE SPECIFIED BY THE MANUFACTURER, U.N.O.
- ROOF TRUSS SHOP DWGS SHALL BE SUBMITTED TO ARCH & ENG. FOR REVIEW AND APPROVAL PRIOR TO FABRICATION OR DELIVERY
- ERECT AND INSTALL ROOF TRUSSES PER WTCA & TPI'S BCSI I "GUIDE TO GOOD PRACTICE FOR HANDLING, INSTALLING & BRACING OF METAL PLATE CONNECTED WOOD TRUSSES."
- SUPPORT SHORT SPAN ROOF TRUSSES W/2x4 LEDGER FASTENED TO

FRAMING w/(2) 3" x 0.120" NAILS @ 16" O.C. (UP TO 7' SPAN).

CONNECTION SPECIFICATIONS (TYP. U.N.O.)

DESCRIPTION OF BLDG. ELEMENT	3"x0.131" NAILS	3"x0.120" NAILS
JOIST TO SOLE PLATE	(3) TOENAILS	(3) TOENAILS*
SOLE PL. TO JOIST/RIM OR BLK'G	NAILS @ 4" o.c.	NAILS @ 4" o.c.
STUD TO PLATE	(4) TOENAILS/ (3)END NAILS	(4) TOENAILS/ (4)END NAILS*
RIM TO TOP PLATE	TOENAILS @ 6" o.c.	TOENAILS @ 4" o.c.*
BLK'G. BTWN. JOISTS TO TOP PL.	(3) TOENAILS EA. END	(3) TOENAILS EA. END*
DOUBLE STUD	NAILS @ 16" o.c.	NAILS @ 16" o.c.
DOUBLE TOP PLATE	NAILS @ 12" o.c.	NAILS @ 8" o.c.
DOUBLE TOP PLATE LAP SPLICE	(12) NAILS IN LAPPED AREA (24" MIN.)	(15) NAILS IN LAPPED AREA (24" MIN.)
TOP PLATE LAP @ CORNERS & INTERSECTING WALLS	(3) NAILS	(3) NAILS
RAFTER/TRUSS TO TOP PLATE	(4) TOENAILS +	(4) TOENAILS +
	(I) SIMPSON H2.5T	(I) SIMPSON H2.5T
GAB. END TRUSS TO DBL. TOP PL.	TOENAILS @ 8" o.c.	TOENAILS @ 6" o.c.
R.T. w/ HEEL HT. 9 1/4" TO 12"	2xIO BLK EVERY 3RD BAY FASTENED TO DBL. TOP PLATE W/ TOENAILS @ 6" O.C.	2xIO BLK EVERY 3RD BAY FASTENED TO DBL. TOP PLATE W/ TOENAILS @ 4" O.C.
R.T. w/ HEEL HT. I2" TO I6"	2x12 BLK EVERY 3RD BAY FASTENED TO DBL. TOP PLATE w/ TOENAILS @ 6" O.C.	2xI2 BLK EVERY 3RD BAY FASTENED TO DBL. TOP PLATE W/ TOENAILS @ 4" O.C.
R.T. w/ HEEL HT. UP TO 24"	LAP WALL SHTG. W/ DBL. TOP PL. & INSTALL ON TRUSS VERT FASTEN W/ NAILS @ 6" O.C.	LAP WALL SHTG. W/ DBL. TOP PL. \$ INSTALL ON TRUSS VERT FASTEN W/ NAILS @ 6" O.C.*
R.T. w/ HEEL HT. 24" TO 48"	LAP WALL SHTG. W/ DBL. TOP PL. & INSTALL ON TRUSS VERT FASTEN W/ NAILS @ 6" O.C. PROVIDE 2x BLK @ EA. BAY AT TOP OF HEEL	LAP WALL SHTG, W DBL. TOP PL. \$ INSTALL ON TRUSS VERT FASTEN W NAILS @ 6" O.C. PROVIDE 2x BLK @ EA. BAY AT TOP OF HEEL*
WALL TO FOUNDATION	WALL SHTG. LAP W/ SILL PL. \$ FASTENED PER SHEAR WALL FASTENING SPEC.	
* $2/2$ "x0.113 IS AN ACCEPTABLE ALTERNATIVE TO A 3"x0.120", SAME SPACING OR NUMBER OF NAILS. (ONLY ACCEPTABLE WHERE * ARE SHOWN)		

GENERAL STRUCTURAL NOTES

DESIGN LOADING

- DESIGN IS BASED ON 2018 NORTH CAROLINA STATE BUILDING CODE RESIDENTIAL CODE.
- WOOD FRAME ENGINEERING IS BASED ON NDS, "NATIONAL DESIGN SPECIFICATION FOR WOOD CONSTRUCTION" - LATEST EDITION
- DESIGN LOADS ROOF

SNOW = 15 PSF (12 PSF GROUND SNOW, TRUSSES) LIVE = 20 PSF (REDUCIBLE BASED ON ROOF PITCH) DEAD = 7 PSF T.C., IO PSF B.C.

LOAD DURATION FACTOR = 125 LIVE = 40 PSE (30 PSE @ SLEEPING AREAS)

DEAD = 10 PSF (I-JOISTS), 15 PSF (FLOOR TRUSSES) ADD'L TO PSE @ CERAMIC TILE IN KITCHEN. JUNROOMS, BATHS, FOYER, LAUND. & MUDRM

2,000 PSF ASSUMED ALLOWABLE BEARING PRESSURE (TO BE VERIFIED BY BUILDER)

115 MPH, EXPOSURE B

GENERAL FRAMING

- ALL TYP, NAIL FASTENER REQUIREMENTS ARE NOTED IN STANDARD CONNECTIONS TABLE (IRC TABLE R602.3(1)) OR ON PLANS. ALL NAILS SPECIFIED ARE MIN DIAMETER AND LENGTH REQUIRED FOR CONNECTION. ALL HANGER NAILS SHALL BE INSTALLED PER MANUFACTURER'S REQUIREMENTS FOR MAX CHARTED CAPACITY NOTE: HANGERS USE COMMON NAIL DIAMETERS NOT TYPICAL FRAMING GUN NAILS.
- EXT & INT BEARING WALLS SHALL BE 2×4 OR 2×6 (AS SHOWN ON PLANS) @ 16" O.C. SPF/SP #2 GRADE LUMBER, OR BETTER, U.N.O.. · WALLS OVER 12' TALL SHALL BE PER PLAN.
- ALL INTERIOR BEARING WALLS ARE ASSUMED TO BE SHEATHED W/ GYP WALL BOARD (ONE SIDE MIN.) OR PROVIDE MID HT. BLOCKING
- ALL HEADERS, BEAMS & OTHER STRUCTURAL MEMBERS SHALL BE SPRICE-PINE-FIR #2 (SPE) OR SOUTHERN PINE #2 (SP) LIMBER OR BETTER, SUPPORT ALL HEADERS/ BEAMS W/ (1)2x JACK STUD & (1)2x KING STUD MINIMUM
- THE NUMBER OF STUDS SPECIFIED AT A SUPPORT INDICATES THE NUMBER OF JACK STUDS REQUIRED, U.N.O.,
- ALL NON-BEARING INTERIOR STUD WALLS SHALL BE CONSTRUCTED WITH 2x 'STUD' GRADE MEMBERS SPACED @ 24" O.C. (MAX., U.N.O.)

 • HEADERS IN NON-LOAD BEARING WALLS SHALL BE: (1)2x4/6 FLAT @ OPENINGS UP TO 4', (2)2x4/6 FLAT UP TO 8'.
- ALL FRAMING LUMBER SHALL BE DRIED TO 15% MC (KD-15).
- ENGINEERED LUMBER BEAMS TO MEET OR EXCEED THE FOLLOWING: • 'LVL' - Fb=2600 psi; Fv=285 psi; E=2.0x10^6 psi
- ENGINEERED LUMBER POSTS TO MEET OR EXCEED THE FOLLOWING 'LVL' - Fb=2400 psi; FcII=2500 psi; E=I.8xI0^6 psi
- FOR 2 & 3 PLY BEAMS OF EQUAL 134" MAX. WIDTH, FASTEN PLIES TOGETHER WITH 3 ROWS OF 3"X0.120" NAILS @ 8" O/C OR 2 ROWS 18"x3K" SIMPSON SDS SCREWS (OR 3K" TRUSSI OK SCREWS) @ 16" USE A MINIMUM OF 4 ROWS FOR BEAM DEPTHS OF 14" OR GREATER. APPLY FASTENING AT BOTH FACES FOR 3-PLY CONDITION. LOCATE TOP & BOTTOM NAILS/SCREWS 2" FROM EDGE. SOLID 3 1/2" OR 5 1/2" BEAMS ARE ACCEPTABLE USE 2 ROWS OF NAILS FOR 2x6 \$ 2x8 MEMBERS
- FOR 4 PLY BEAMS OF EQUAL 13/4" MAX, WIDTH, FASTEN PLIES TOGETHER WITH 3 ROWS OF K"X6" SIMPSON SDS SCREWS (OR 6 3/1) TRUSSLOK SCREWS) @ 16" O/C. USE A MINIMUM OF 4 ROWS FOR BEAM DEPTHS OF 14" OR GREATER, APPLY EASTENING AT BOTH FACES (ONE SIDE ONLY FOR TRUSSLOK SCREWS). LOCATE TOP ANI BOTTOM SCREWS 2" FROM EDGE A SOLID 7" BEAM IS ACCEPTABLE
- PROVIDE SOLID BLOCKING IN FLOOR SYSTEM UNDER ALL POSTS CONTINUOUS TO FND./BEARING. BLOCKING TO MATCH POST ABOVE.
- ALL EXTERIOR 4x4 WOOD POSTS SHALL HAVE SIMPSON BCS2-2/4
- CORROSION NOTES:
- BUILDER RESPONSIBLE TO DETERMINE CORROSION-RESISTANCE REQUIREMENTS AND COMPATIBILITY OF HARDWARE FASTENERS AND CONNECTORS FOR ENVIRONMENTAL EXPOSURE AND IN CONTACT W/ PRESERVATIVE-TREATED WOOD OF ACTUAL FINAL CONDITIONS AND SOURCED MATERIALS. CONTACT LUMBER & HARDWARE SUPPLIERS TO COORD.

GENERAL STRUCTURAL NOTES

FOUNDATION

- DESIGN IS BASED ON 2018 NORTH CAROLINA STATE BUILDING CODE: RESIDENTIAL CODE.
- FOOTING DESIGN 2,000 PSF ALLOWABLE SOIL BEARING PRESSURE IS ASSUMED. BUILDER/CONTRACTOR MUST VERIFY.
- FASTEN 2x4/6 SILL PLATES TO CONC FND WITH A MINIMUM OF 2
- ANCHORS PER PLATE 12" MAX FROM PLATE ENDS UTILIZING: I/2" DIA. ANCHOR BOLTS 6'-0" O.C,7" MIN. EMBEDMENT
- I/2" DIA. x 6" LONG SIMPSON TITEN HD @ 6'-0" O.C. SIMPSON MASA ANCHOR STRAPS @ 6'-0" O.C. (CONCRETE)
- ALL LUMBER EXPOSED TO WEATHER OR IN CONTACT W/ PERIMETER
- FOUNDATION SHALL BE PRESERVATIVE TREATED SOUTHERN PINE #2. BUILDER TO VERIEY CORROSION-RESISTANCE COMPATIBILITY OF
- HARDWARE & FASTENERS IN CONTACT W/ PRESERVATIVE-TREATED WOOD CONTACT LIMBER & HARDWARE SUPPLIERS TO COORD

• FOOTINGS SHALL BE PLAIN CONCRETE, U.N.O.

- CONCRETE DESIGN BASED ON ACL 318, CONCRETE SHALL ATTAIN THE FOLLOWING MIN. COMPRESSIVE STRENGTHS IN 28 DAYS, U.N.O. f'c = 3,000 psi: FOOTINGS & INTERIOR SLABS ON GRADE 3500 psi: GARAGE & EXTERIOR SLABS ON GRADE fu = 60000 psi
- ALL CONCRETE EXPOSED TO THE WEATHER SHALL NOT HAVE LESS THAN 5% OR MORE THAN 7% AIR ENTRAINMENT
- ALL FOOTINGS SHALL BEAR BELOW FROST LINE (TYP.) OR 12" MIN IN REGIONS WHERE CODE FROST DEPTH IS NOT APPLICABLE. CONSULT SOILS REPORT OR BUILDING DEPT. FOR MINIMUM DEPTH BELOW GRADE
- FOOTINGS AND SLABS ON GRADE SHALL BEAR ON VIRGIN SOIL OR
- PROVIDE CONTROL JOINTS AT ALL INSIDE CORNERS OF SLAB EDGES, AND OTHER LOCATIONS WHERE SLAB CRACKS ARE LIKELY
- . JOINTS SHALL BE LOCATED @ IO'-O" O.C. (RECOMMENDED) OR 15'-0" O.C. (MAXIMUM)
- JOINT GRID PATTERN SHALL BE AS CLOSE TO SQUARES AS POSSIBLE (I:I RATIO), WITH A MAXIMUM OF I:I.5 RATIO
- · CONTROL JOINTS SHALL NOT BE INSTALLED IN STRUCTURAL
- DIMENSIONS BY OTHERS, BUILDER TO VERIFY

HOLD-DOWN SCHEDULE

SYMBOL	SPECIFICATION
► HD-I	SIMPSON CSI6 STRAP TIE W/ 14" END LENGTH
► HD-2	SIMPSON MSTC66 STRAP TIE W 24" END LENGTH
▶ HD-3	SIMPSON HTT4 HOLD-DOWN *
► HD-4	SIMPSON HDU5-SDS2.5 HOLD-DOWN *
HD-5	SIMPSON STHDI4RJ HOLD-DOWN *

UTILIZE SIMPSON "SET-3G" EPOXY SYSTEM TO FASTEN 5/4" DIA THREADED ROD INTO CONCRETE FOUNDATION INSTALL PER MANUE RECOMMENDATIONS. DO NOT LOCATE ANCHORS WITHIN I 34" OF EDGE OF FOUNDATION

MEANS & METHODS NOTES

THE STRUCTURE IS DESIGNED TO BE SELF SUPPORTING AND STABLE AFTER THE BUILDING IS FINISHED AND ALL PLAN, DETAIL, AND NOTE SPECIFICATIONS HAVE BEEN COMPLETED. IT IS THE CONTRACTOR'S SOLE RESPONSIBILITY TO DETERMINE THE ERECTION PROCEDURES AND SEQUENCE TO THE SAFETY OF THE BUILDING AND ITS COMPONENTS DURING CONSTRUCTION. THIS INCLUDES BUT IS NOT LIMITED TO, THE ADDITION OF NECESSARY SHORING, SHEETING, TEMPORARY BRACING, GUYS, AND TIE-DOWNS. CONTRACTOR SHALL BE RESPONSIBLE FOR ALL SHORING AND BRACING REQUIRED TO STABILIZE AND PROTECT EXISTING AND ADJACENT STRUCTURES AND SYSTEMS DURING COURSE OF DEMOLITION AND CONSTRUCTION OF THE PROJECT

STRUCTURAL DESIGN AND SPECIFICATIONS ASSUME THAT ALL SUPPORTING AND NON-SUPPORTING ELEMENTS IN CONTACT WITH FLOOR FRAMING ARE LEVEL, INCLUDING, BUT NOT LIMITED TO: FOUNDATIONS. SLABS ON GRADE, BEAMS, WALLS, AND NON-BEARING ELEMENTS. IT IS THE CONTRACTOR'S RESPONSIBILITY TO VERIEY LEVELNESS AND MAKE ADJUSTMENTS AS NECESSARY, INCLUDING CONSIDERATION OF THOSE AREAS THAT MAY BE WITHIN CONTRACTUAL, INDUSTRY OR WARRANTY TOLERANCES

VENEER LINTEL SCHEDULE

SPAN (MAX)	HEIGHT OF VENEER ABOVE LINTEL	STEEL ANGLE SIZE
3'-0"	20 FT. MAX	L3"x3"x/4"
6'-0"	3 FT. MAX	L3"x3"x/4"
	I2 FT. MAX	L4"x3"x/4"
	20 FT. MAX	L5"x3½"x¾6"
8'-0"	3 FT. MAX	L4"x4"x½" *
	I2 FT. MAX	L5"x3½"x¾6"
	I6 FT. MAX	L6"x3½"x¾"
9'-6"	I2 FT. MAX	L6"x3½"x%6"
16'-0"	2 FT. MAX	LT"x4"x½" **
	3 ET MAY	1 @!U/!UK! **

- ILLIMITES

 **SPALL SIPPORT 2 %* 3 ½" YIBEER W 40 PAI MAXIMM MEIGHT.

 **IG SHALL HAVE 4" MIN BEARING

 **IG SHALL HAVE 9" MIN BEARING

 **IG SHALL HAVE 9" MIN BEARING

 **IG SHALL BAT SET FASTIBED BACK TO ROOD HEADER IN MALL 446"02. W ½" DIA, x 3 ½"

 **LONG LAG SCREPG IN 2" LONG YERTICALLY SLOTTED HOLES,

 **MAX. YEBEER IN TAPILES TO ANY FORTION OF PROCK OVER THE OPENING.

 **ALL INITIES SHALL BE LONG LEG VERTICAL.

 **LALL MITTES SHALL BE LONG LEG VERTICAL.

 **MAY BEC OT IN THE FELLO TO BE 3½" MIDE OVER THE BEARING LENGTH ONLY. THIS

 **SET STRUCTURAL PLANG FOR ANY LINTEL CONDITION NOT ENCOMPASSED BY THE

 BOOK BERAMETERS.

NBOVE FANORIE.LIST。 FOR QUEEN VENEER OILY, SEE PLAN FOR VENEER SUPPORT IF VENEER < 3½" THICK

I-JOIST MANUFACTURER

ADDITIONAL NOTES FOR TRUSS \$

ROOF TRUSS, FLOOR TRUSS AND ENGINEERED JOISTS SHALL BE DESIGNED TO MEET THE DEFLECTION CRITERIA BELOW, UNLESS NOTED OTHERWISE ON PLAN. MULHERN & KULP CANNOT BE HELD RESPONSIBLE FOR ANY STRUCTURAL ISSUES
RELATED TO ANY BUILDING COMPONENT IF COMPONENT SHOP DRAWINGS ARE NOT SUBMITTED TO M&K FOR REVIEW PRIOR TO FABRICATION,

DELIVERY OR INSTALLATION TRUSSES/LIGISTS SHALL BE DESIGNED SO THAT DIFFERENTIAL DEFLECTION BETWEEN ADJACENT PARALLEL TRUSSES/JOISTS OR GIRDER TRUSSES/FLUS BEAMS DO NOT EXCEED THE FOLLOWING: A ROOF TRUSSES.

1/4" DEAD LOAD

B. FLOOR TRUSSES, ATTIC TRUSSES, & I-JOISTS; I/8" DEAD LOAD

ABSOLUTE DEAD LOAD DEFECTION OF FLOOR

TRUSSES/ATTIC TRUSSES WHEN ADJACENT TO FLOOR FRAMING BY OTHERS SHALL BE LIMITED TO 3/16". (NO: DIFFERENTIAL DEFLECTION,

FLOOR JOIST NOTES

- ALL FLOOR JOISTS SHALL BE THE DEPTI SPECIFIED ON PLAN - FLOOR JOISTS SERIES & SPACING IS PER THE FLOOR JOIST MANUF.
- SPACING SHALL NOT EXCEED 19.2" O.C. (MAX.) @ LOCATION OF TILE: SPACING SHALL NOT EXCEED 16" O.C. (MAX.)

LATERAL/WALL BRACING & WALL SHEATHING SPECIFICATIONS

THIS MODEL HAS BEEN DESIGNED TO RESIST LATERAL FORCES RESULTING FROM:

MPH WIND IN 2018 NCSBC:RC (115 MPH WIND SPEED IN ASCE 7-10 WIND MAP, PER IRC R301,2,1,1) EXP. B, RISK CAT. 2 & SEISMIC CAT. A/B.

THE DESIGN WAS COMPLETED PER 2015 IBC (SECTION 1609) & ASCE 7-10, AS PERMITTED BY R301,1,3 OF THE 2018 NCSBC:RC, ACCORDINGLY, THIS MODEL, AS DOCUMENTED AND DETAILED HEREWITHIN, IS ADEQUATE TO RESIST THE CODE REQUIRED LATERAL FORCES.

DESIGN WIND UPLIET LOADS HAVE BEEN CALCULATED UTILIZING ASCE 7-10 (ACCEPTED ENGINEERING PRACTICE) AS ALLOWED PER 2018 NCSBC:RC SECTION R802.II.I.I. THIS MODEL HAS BEEN DETAILED WHERE REQUIRED & ENGINEERED TO RESIST THE WIND UPLIFT LOAD PATH PER SECTIONS R60235& R80211

EXT. WALL SHEATHING SPECIFICATION

- 7/16" OSB OR 15/32" PLYWOOD: FASTEN SHEATHING W/ 2 3 XO.II3 NAILS @ 6" O.C. AT EDGES & @ 12" O.C. IN THE PANEL FIELD. (TYP, U.N.O.) ALL SHEATHING PANELS SHALL BE ORIENTED
- VERTICALLY (LONG DIRECTION PARALLEL TO STUDS) AND INSTALLED FULL HEIGHT OF SHEAR WALL OR -2x HORIZONTAL BLOCKING SHALL BE PROVIDED TO SUPPORT ALL UNSUPPORTED PANEL EDGES & EDGE
- ALL EXT. WALLS SHALL BE CONTINUOUSLY SHEATHED AND ARE CONSIDERED SHEAR WALLS.
- ALT. STAPLE CONNECTION SPEC: 1 3/4" 16 GA STAPLES (1/6" CROWN) @ 3" O.C. AT EDGES \$ @ 6" O.C IN FIELD.


3" O.C. EDGE NAILING

AT DESIGNATED AREAS - FASTEN PANEL EDGES OF WOOD STRUCTURAL WALL SHEATHING TO FRAMING W 2 3" x 0.113" NAILS @ 3" O.C. AND 12" O.C. IN THE PANEL FIELD NO STAPLE ALTERNATIVE AVAILABLE AT THIS SPEC. ALL SHEATHING PANELS SHALL BE ORIENTED VERTICALLY (LONG DIRECTION PARALLEL TO STUD) AND INSTALLED FULL HEIGHT OF SHEAR WALL - OR - 2x HORIZONTAL BLOCKING SHALL BE PROVIDED TO SUPPORT UNSUPPORTED PANEL EDGES AND 3" O.C. EDGE FASTENING.

TYP. UNIT SEPARATION WALL SHEATHING SPECIFICATION

•1/2" OR 5/8" GYPSUM WALL BOARD: FASTEN GWB SHEATHING TO FRAMING W/ I \$"X0.086" COOLER NAILS OR I 1/4" DRYWALL SCREWS @ 7" O.C. T PANEL EDGES & PANEL FIELD (INCLUDING T&B PLATES

- SEE CONNECTION SPECIFICATIONS CHART FOR STANDARD SHEAR TRANSFER DETAILING. IF ADDITIONAL CAPACITY IS REQUIRED BY DESIGN. WILL BE SPECIFICALLY NOTED ON PLAN.
- DESIGN ASSUMES 16" O.C MAX. STUD SPACING, U.N.O.
- ALL STRUCTURAL PANELS ARE TO BE DIRECTLY APPLIED TO STUD FRAMING.
- PRE-MANUFACTURED PANELIZED WALLS: FASTEN TOGETHER END STUDS OF WALL PANELS SHEATHED W/ OSB OR PLYWOOD W/ 3" x 0,120" NAILS @ 4" O.C. (THRU ONE SIDE ONLY)

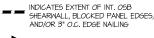

INDICATES HOLDOWN

MULHERN+KULP RESIDENTIAL STRUCTURAL ENGINEERING arkway, Suite 250 - 1



lulhern+Kulp project number 243-24029

SMI MF(ssue date: 08-14-2024

REVISIONS

initial: 1/06/202 SMM LAME, OPT. EXT. COVID. PORCH, MEM 12/16/2024 ER TO ELEV. D ADDED DORMER TO 5/15/2025 MISC. ARCH. UPDATE

pointe HOMES

NOTES MOD GENERAL 03

SERENITY MASTER SET RALEIGH, NC 5919

S0.0

BOTH SIDE WALLS MUST BE FIRE RATED Please see page S1.1 for Elevation C detail

Reference page S3.0 for Opt. Extended Covered Porch detail

MULHERN+KULP

RESIDENTIAL STRUCTURAL ENGINEERING

3665 Brokside Parkway, Saira 259 - Aphrecia, SA 3002

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NC License # C-3825



Mulhern+Kulp project number:

243-24029

MEG issue date: 08-14-2024

REVISIONS:


initial: II/06/2024 UPDATED MODEL OPT. OFFICE SMM NAME, OPT. EXT. COVID. PORCH, 12/16/2024 ADDED DORMER TO ELEV. D 5/15/2025 MISC. ARCH. UPDATE MEM

tri pointe

5919-03 MODEL SERENITY MASTER SET RALEIGH, NC

FOUNDATION PLAN

S1.0

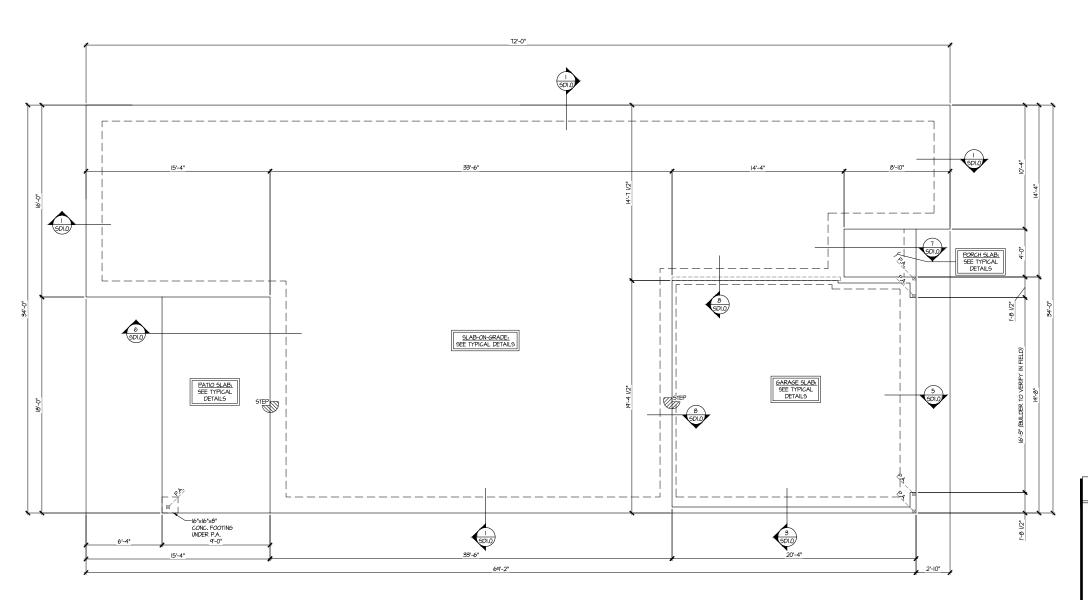

SLAB FOUNDATION PLAN SCALE: 1/4"=1'-0" (22x24 SHEET) ELEV. A 1/8"=1'-0" (IIxI7 SHEET)

LEGEND

- INTERIOR BEARING WALL
- ==== BEARING WALL ABOVE (B.W.A.)
- BEAM / HEADER
- INDICATES EXTENT OF INT.

 OSB SHEARWALL AND/OR
 3" O.C. EDGE NAILING
- EXTENT OF VALLEY TRUSS OVERFRAMING
- INDICATES HOLDOWN
- INDICATES POST ABOVE. PROVIDE SOLID BLOCKING UNDER POST OR JAMB ABOVE.

REFER TO SO.O FOR TYPICAL STRUCTURAL NOTES & SCHEDULES

BOTH SIDE WALLS MUST BE FIRE RATED

MULHERN+KULP
RESIDENTIAL STRUCTURAL ENGINEERING
3855 Broiside Parkway, Sale 250 - Aphwerta, SA 38022
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NC Licence # C-38255



Mulhern+Kulp project number: 243-24029

MEG

issue date: 08-14-2024 REVISIONS:


initial: 11/06/2024 SMM NAME, OPT. EXT. COVID. PORCH, 12/16/2024 ADDED DORMER TO ELEV. D 5/15/2025 MISC. ARCH. UPDATE MEM

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FOUNDATION PLAN

5919-03 MODEI SERENITY MASTER SET RALEIGH, NC


S1.1

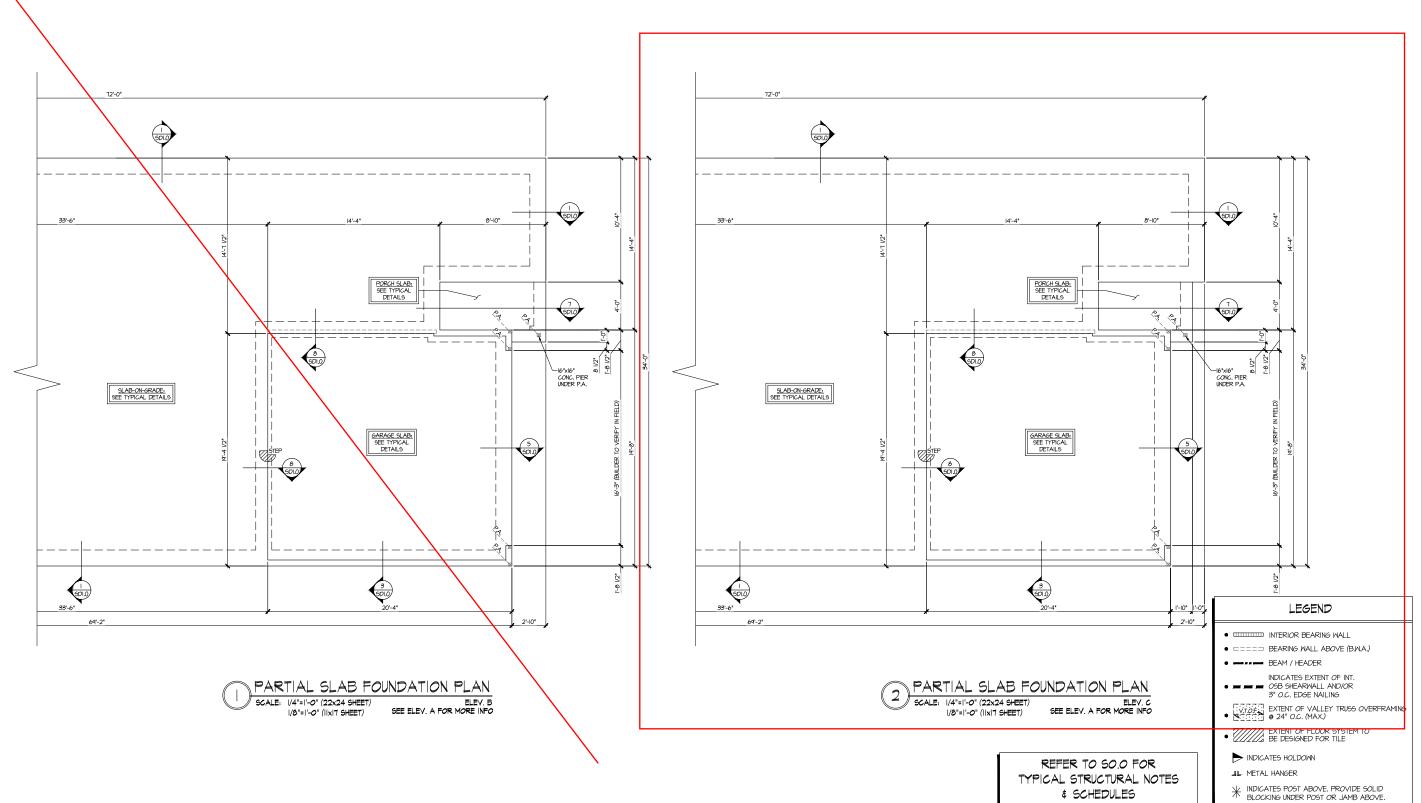

BOTH SIDE WALLS MUST BE FIRE RATED

Please see page S2.1 for Elevation C detail

Reference page \$3.0 for Opt. Extended Covered Porch detail

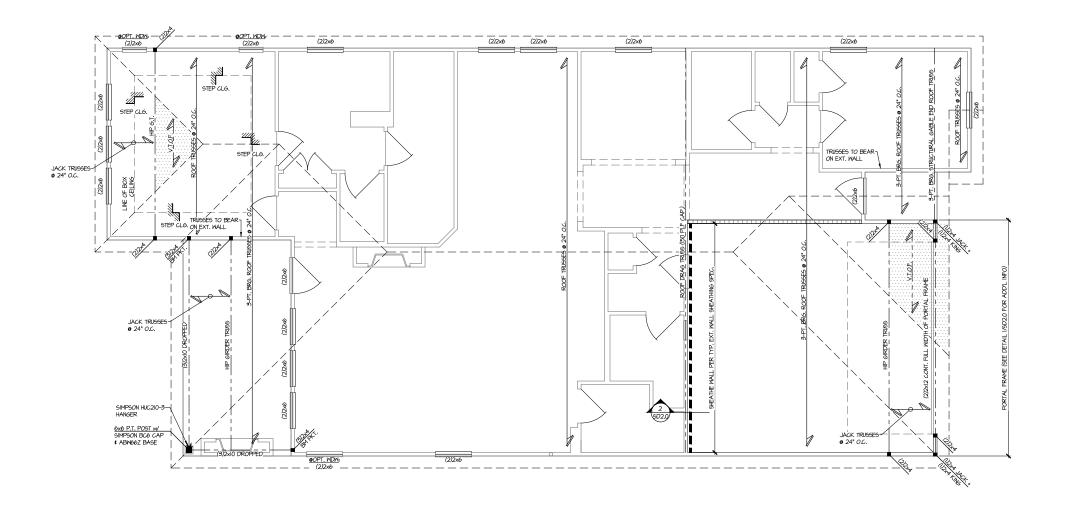

ROOF FRAMING PLAN SCALE: 1/4"=1'-0" (22x24 SHEET) ELEV. A 1/8"=1'-0" (IIxI7 SHEET)

MULHERN+KULP
RESIDENTIAL STRUCTURAL ENGINEERING
SEES Brookside Perkvey, Sales 250 - Aphresia, 6A 3002
p.778-777-0014 - multimalapsam
NC License # C-3925-



Mulhern+Kulp project number:

243-24029

MEG issue date: 08-14-2024

REVISIONS:

initial: GAILE:
II/06/2024
UPDATED MODEL NAME, OPT. EX
OPT. OFFICE
I2/16/2024
ADDED DORMER TO ELEV. D
5/15/2025
MISC. ARCH. UPDATE SMM NAME, OPT. EXT. COVID. PORCH, MEM

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THIS LEVEL HAS BEEN DESIGNED FOR 9'-I" PLATE HEIGHT

LEGEND

- INTERIOR BEARING WALL
- ==== BEARING WALL ABOVE (B.W.A.)
- BEAM / HEADER
- INDICATES EXTENT OF INT.

 OSB SHEARWALL AND/OR
 3" O.C. EDGE NAILING
- EXTENT OF VALLEY TRUSS OVERFRAMING
 24" O.C. (MAX.)
- NDICATES HOLDOWN
- JL METAL HANGER
- INDICATES POST ABOVE. PROVIDE SOLID BLOCKING UNDER POST OR JAMB ABOVE.


REFER TO SO.O FOR TYPICAL STRUCTURAL NOTES & SCHEDULES


ROOF FRAMING PLAN

5919-03 MODEL SERENITY MASTER SET RALEIGH, NC

S2.0

BOTH SIDE WALLS MUST BE FIRE RATED

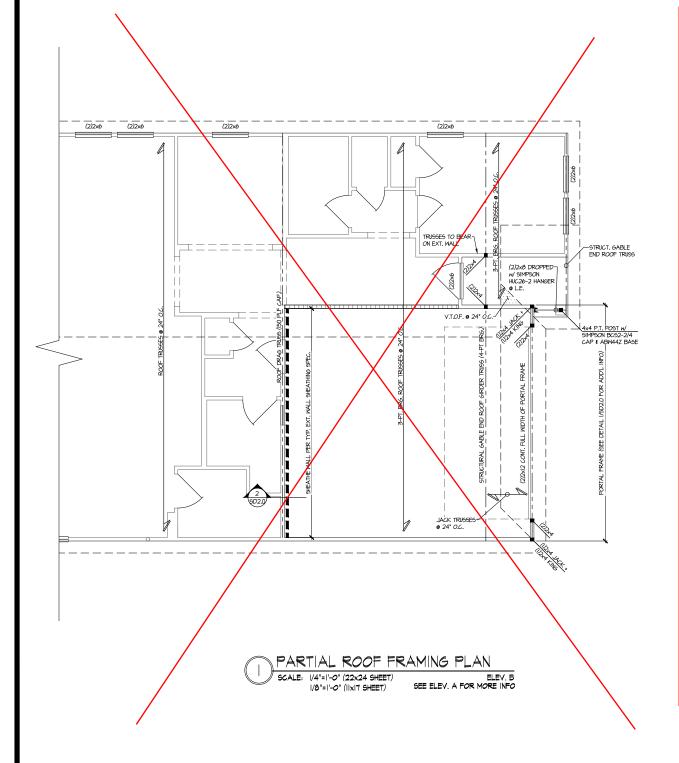

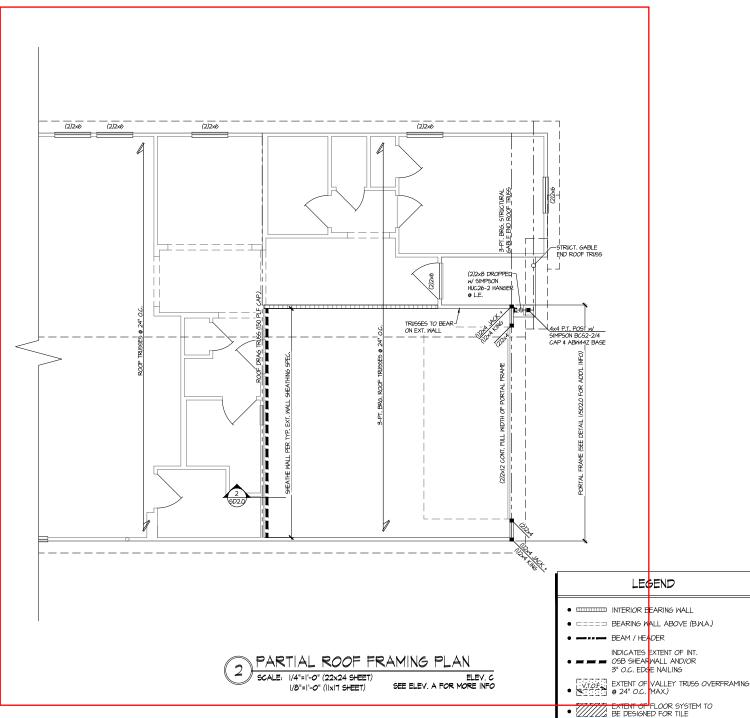

THIS LEVEL HAS BEEN DESIGNED

FOR 9'-1" PLATE HEIGHT

REFER TO SO.O FOR

TYPICAL STRUCTURAL NOTES

SCHEDULES

MULHERN+KULP
RESIDENTIAL STRUCTURAL ENGINEERING

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ROOF FRAMING PLAN 5919-03 MODEL


SERENITY MASTER SET RALEIGH, NC

S2.1

NDICATES HOLDOWN

M INDICATES POST ABOVE. PROVIDE SOLID BLOCKING UNDER POST OR JAMB ABOVE.

JL METAL HANGER

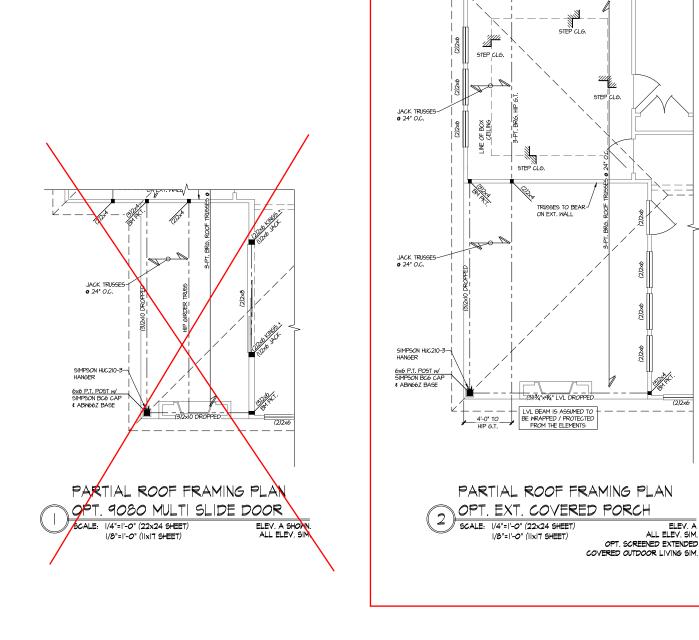

-DOPT, NDM: -- (1)

- — — — <u>•OPT. WDW</u>r -(2)2x6

(2)2x6

ELEV. A ALL ELEV. SIM.

PATIO SLAB: SEE TYPICAL DETAILS -16"x16"x8" CONC. FOOTING UNDER P.A. PARTIAL SLAB FOUNDATION PLAN OPT. EXT. COVERED PORCH SCALE: 1/4"=1'-0" (22x24 SHEET) ELEV. A ALL ELEV. SIM. 1/8"=1'-0" (11x17 SHEET)

6 SDI.0 PATIO SLAB: SEE TYPICAL DETAILS STEP

PARTIAL SLAB FOUNDATION PLAN

ELEV. A SHOWN. ALL ELEV. SIM.

OPT. OUTDOOR LIVING PATIO

SCALE: 1/4"=1'-0" (22x24 SHEET)

1/8"=1'-0" (IIxI7 SHEET)

UNDER 9000 SQFT

BOTH SIDE WALLS MUST BE FIRE RATED THIS LEVEL HAS BEEN DESIGNED FOR 9'-I" PLATE HEIGHT

LEGEND

- IIIII INTERIOR BEARING WALL
- ==== BEARING WALL ABOVE (B.W.A.)
- INDICATES EXTENT OF INT.

 OSB SHEARWALL AND/OR
 3" O.C. EDGE NAILING
- EXTENT OF VALLEY TRUSS OVERFRAMING
 O 24" O.C. (MAX.)
- EXTENT OF FLOOR SYSTEM TO BE DESIGNED FOR TILE
- ► INDICATES HOLDOWN
- INDICATES POST ABOVE. PROVIDE SOLID BLOCKING UNDER POST OR JAMB ABOVE.

REFER TO SO.O FOR TYPICAL STRUCTURAL NOTES & SCHEDULES

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243-24029

MEC issue date: 08-14-2024


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PLANS OPTION FRAMING MODE -03

SERENITY MASTER SET RALEIGH, NC 5919-

S3.0



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lulhern+Kulp project number 243-2402

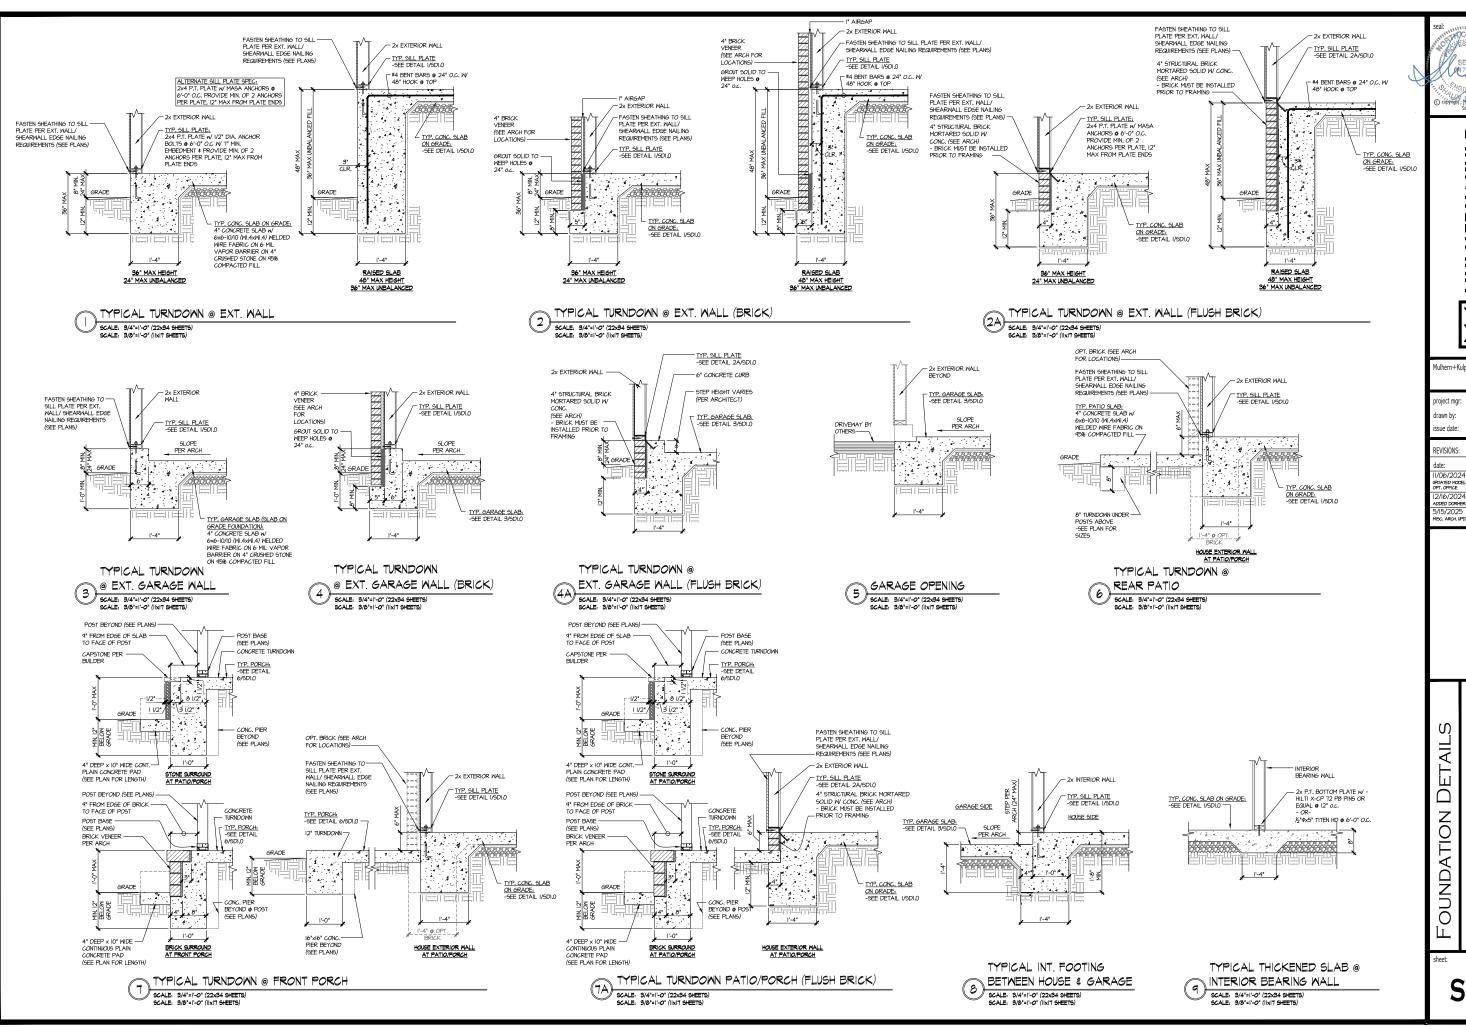SMK MEC issue date: 08-14-2024


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03

SERENITY MASTER SET RALEIGH, NC 5919

SD1.0



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243-24029
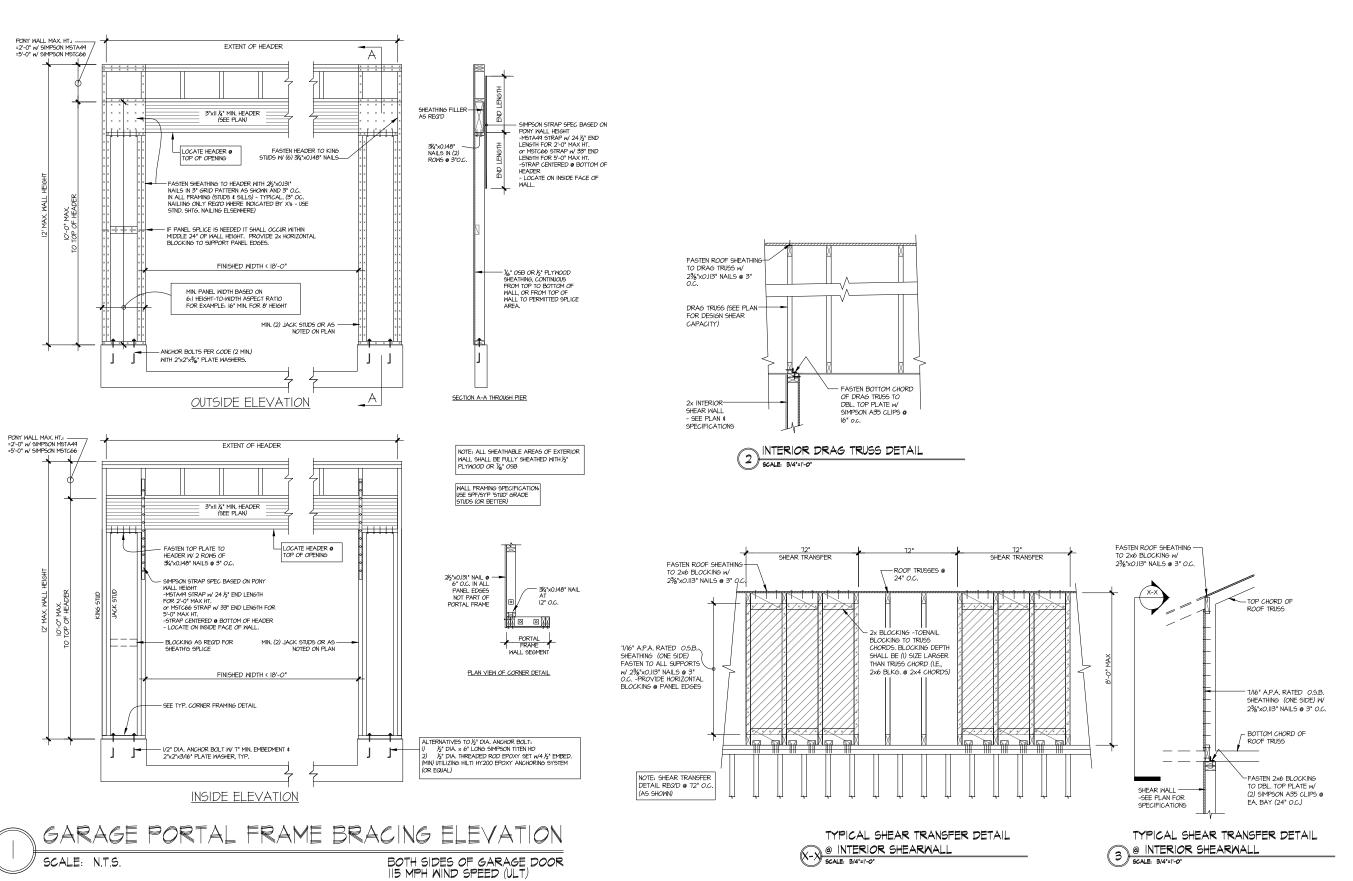
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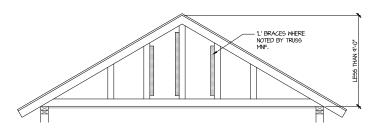
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FRAMING DETAILS MODEI

SERENITY MASTER SET RALEIGH, NC -03 5919-


SD2.0



'L' BRACES FASTENED TO VERTICALS MEERE RECO'D BY TRUSS MANUFACTURER, FASTEN W 16d GUN NAILS (0.131 x 3 1/2") @ 6" O.C.

GABLE END TRUSS SHEATHED-WITH OSB.

FASTEN BOTTOM CHORD OF — GABLE END TRUSS TO DBL. TOP PLATE w/ 3"x0.120" (MIN.) TOE-NAILS & 8" O.C.

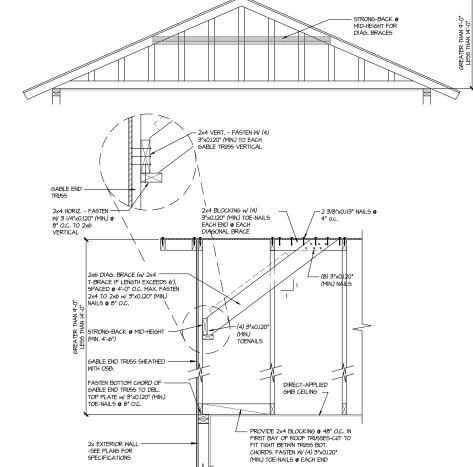

TYPICAL GABLE END BRACING DETAIL SCALE: NOME REQUIRED TRUSS REQ'D @ GABLE END TRUSS HEIGHT UP TO 9'-0'

DIRECT-APPLIED GWB CEILING —

- PROVIDE 2x4 BLOCKING ● 48" O.C. IN FIRST BAY OF ROOF TRUSSES-CUT TO FIT TIGHT BETWN TRUSS BOT. CHORDS, FASTEN W (3) 3 J V4"x0.120" (MIN.) TOE-NAILS @ EACH END

BRACE GABLE END TRUSSES PER ABOVE DETAIL WHEN GABLE HEIGHT IS LESS THAN 9"-0". "L" BRACES REQUIRED WHERE NOTED BY TRUSS MANUFACTURER.

BRACE GABLE END TRUSSES PER ABOVE DETAIL WHEN GABLE HEIGHT EXCEEDS 9'-0'. "L' BRACES NOT REQUIRED.

TYPICAL GABLE END BRACING DETAIL SCALE. NONE REQUIRE GABLE END TRUSS

REQ'D @ GABLE END TRUSS HEIGHT BETWN 9'-0" TO 14'-0"

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p.770-777-6074 - markemicaprosm
NC Licence # C-38.25

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FRAMING DETAILS 5919-03 MODEL SERENITY MASTER SET RALEIGH, NC

SD2.1