## SANDY LANE **ABBREVIATIONS** A A PRESSURE TREATED WD HWD HARDWOOD (FL R&M RANGE W/MICROWAV LIV LIVING LTL LINTEL LVR LOUVER MAX MAXIMUM DRY DRYER MACHINE TEMP TEMPERED (GLASS U.N.O. UNLLGGOTHERWISE 0A F.F. FINISH FLOOR (LINE OBS OBSCURE (GL) WH WATER HEATER FLR FLOOR(ING FP FIREPLACE OPT OPTIONAL WIC WALK-IN CLOSE FURRED(ING) PEDESTAL (SINK) W/W/O WITH or WITHOU ROHND FAIL ERPROOF(ING) **GENERAL NOTES** 1 - GENERAL BUILDING & DESIGN REQUIREMENTS 15 - MECHANICALS 1) THE ATTACHED PLANS & SPECIFICATIONS ARE THE SOLE PROPERTY OF TRI POINTE HOMES ANY UNAUTHORIZED USE OF THESE PLANS WITHOUT PRIOR WRITTEN CONSENT OF TRI POINTE HOMES IS STRICTLY EXTERIOR AIR INTAKE FOR COMBUSTION AIR PER IRC SECTION AS REQUIRED BY LOCAL MUNICIPALITY 2) TRI POINTE HOMES DESIGNS & BUILDS HOUSING AS SET FORTH BY THE FORMAT AND PROVISIONS OF TH TTENTION OF TRI POINTE HOMES BY CALLING (469)329-0470.

INTERNATIONAL RESIDENTIAL CODE (IRC), AND THE NATIONAL ELECTRIC CODE (NEC). ANY NON-CONFORMING DOCUMENTS DISCOVERED BY THE CONTRACTOR OR HIS AGENTS SHALL BE CALLED TO THE IMMEDIATE

). THESE PLANS ARE SUBJECT TO MODIFICATIONS TO MEET CODE REQUIREMENTS AND/OR TO FACILITATE MECHANICAL/ ELECTRICAL/ PLUMBING INSTALLATION AND/ OR TO IMPLEMENT DESIGN IMPROVEMENTS. ANY

INTENTION TO MODIFY THESE PLANS MUST BE APPROVED IN WRITING BY TRI POINTE HOMES
4) CONTRACTOR SHALL BE RESPONSIBLE FOR VERIFYING ALL DIMENSIONS AFFECTING CONTRACTOR'S PRODUCTS, INSTALLATIONS, OR FABRICATIONS IN THE FIELD PRIOR TO EXPEDITING THE CONSTRUCTION OF SUCH WORK. FIELD VERIFY ALL DIMENSIONS — DO NOT SCALE DRAWINGS!! CONTRACTOR IS RESPONSIBLE FOR SURVEYING THE PROJECT AND BECOMING FAMILIAR WITH THE EXISTING CONDITIONS AND SCOPE OF WORK INCLUDING BUT NOT LIMITED TO SITE AND SOIL BEARING CONDITIONS.
5) ERRORS AND OMISSIONS WHICH MAY OCCUR IN THE CONTRACT DOCUMENTS SHALL BE BROUGHT TO THE

ATTENTION OF THE ARCHITECT, IN WRITING, AND WRITTEN INSTRUCTION SHALL BE OBTAINED PRIOR TO PROCEEDING WITH CONSTRUCTION. THE CONTRACTOR SHALL BE HELD RESPONSIBLE FOR ANY ERRORS, DISCREPANCIES, OR OMISSIONS FOR WHICH THE CONTRACTOR FAILED TO NOTIFY THE ARCHITECT PRIOR TO

#### 2 - SITE CONSTRUCTION

BACK FILL SHALL BE FREE FROM VEGETATION AND CONSTRUCTION DEBRIS

) BACK FILL SHALL BE PLACED IN LIFTS AND COMPACTED IN SUCH A MANNER AS BACKFILL TO NOT DAM. THE FOUNDATION WALLS OR ANY WATERPROOFING/ DAMPPROOFING MATERIALS.

## 3 - CONCRETE

1) SLOPE ON GARAGE SLAB SHALL BE 1/8" PER FOOT TOWARDS VEHICLE DOOR. SLOPE ON PORCH AND

#### 4 - MASONRY

ALL EXTERIOR BRICK MUST MEET ASTM C-216 FOR "SW" CONDITIONS

) MASONRY VENEER SHALL BE ATTACHED TO SUPPORTING WALLS w/ CORRUGATED METAL TIES IN CCORDANCE WITH R703.7.4.1 - I.R.C. OR LOCAL CODE REQUIREMENTS

) WEEPHOLES SHALL BE PROVIDED ALONG THE OUTSIDE WYTHE OF EXTERIOR MASONRY WALLS AT 33" O.C. MAX, SHALL BE A MIN. OF 3/16" IN DIAMETER, AND LOCATED IMMEDIATELY ABOVE THE FLASHING PER R703.7.6 - I.R.C.

#### 5 - METALS

#### 6 - WOOD AND PLASTICS

#### 7 - THERMAL & MOISTURE PROTECTION

) Fire stopping and/ or draft stopping shall meet the requirements of IRC R602.8. 2) Attic ventilation shall be provided at 1/300 th of the Area of the Space ventilated. Cross VANILATION WITH HALF OF THE VENTILATED AREA SHALL BE PROVIDED BY ROOF VENTS AND THE OTHER HALF BY SOFFIT VENTS. VENTS SHALL BE PLACED SO AS TO NOT ALLOW INFILTRATION OF RAIN OR SNOW. ) PROVIDE APPROVED TILE BACKER DRYWALL FOR ALL SHOWER AND BATH SPACE ) PROVIDE ATTIC VENTILATION PER IRC-R806.1

#### 8 - DOORS AND WINDOWS

- ) REVIEW ALL WINDOW HDR HEIGHTS PER PLATE HT. AND VERIFY W/ ELEVATIONS AND CORNICE DETAILS TEMPERED GLASS SHALL BE USED IN HAZARDOUS AREAS AS DESCRIBED IN SECTION R308.4 - LR.C.
- FRONT DOOR WIDTH PER IRC-R311.3
- GARAGE DOOR PER IRC-R309.1

FMERGENCY EGRESS SHALL MEET REQUIREMENTS OF SECTION R310 - LR C 2018 - SLEEPING ROOMS HALL HAVE AT LEAST ONE EGRESS OPENING OF NOT LESS THAN 5.7 SF AND A CLEAR OPENING OF NOT IFSS THAN 20" WIDE X 24" HIGH AND SHALL NOT BE MORE THAN 44" ABOVE THE FLOOR

) WOOD BUILT CHIMNEYS AND FIREPLACES SHALL BE INSTALLED PER MANUFACTURER'S INSTRUCTIONS. AND

ALL FLECTRICAL INSTALLATION SHALL MEET THE REQUIREMENTS OF THE NATIONAL ELECTRIC CODE (NEC). MATERIAL AND EQUIPMENT SHALL BEAR THE LABEL OF APPROVAL OF THE UNDERWRITERS ABORATORIES, INC.

) ELECTRICAL CONTRACTOR SHALL VERIFY SPACE REQUIRED FOR METER INSTALLATION BEFORE ONSTRUCTION AND SHALL NOTIFY GENERAL CONTRACTOR OF ANY DISCREPANCIES.

VERIFY LOCATION OF ALL RECEPTACLES FOR APPLIANCES WITH MANUFACTURER SPECIFICATIONS.

GROUND FAULT INTERRUPTS SHALL BE LOCATED PER THE NEC ALL SWITCHES SHALL BE INSTALLED AT 3'-6" ABOVE FINISHED FLOOR TO CENTERLINE OF SWITCH

VLESS NOTED OTHERWISE ) ALL CONVENIENCE OUTLETS SHALL BE INSTALLED W/ CENTERLINE OF OUTLET LOCATED 1'-3" ABOVE

INISHED FLOOR UNLESS NOTED OTHERWISE

ALL CONVENIENCE OUTLETS WITH SWITCHES TO BE SWITCH AT TOP ONLY.

ALL EXTERIOR WALL BRACKET FIXTURES SHALL BE INSTALLED AS NOTED ON PLANS.

APPROVED SMOKE DETECTORS SHALL BE LOCATED ON EVERY STORY OF THE DWELLING UNIT AS PER IRC CTION R317 (SEE SHEET B1.1 FOR LOCATIONS). WHERE MORE THAN ONE DETECTOR IS REQUIRED THEY SHALL BE INTERCONNECTED. POWER SOURCE SHALL BE BUILDING POWER w/ BATTERY BACKUP. )) CONDUCTORS SHALL BE OF COPPER.

#### GENERAL FRAMING SPECS AND CONSTRUCTION NOTES STAIRS:

) THE MAXIMUM RISER HEIGHT SHALL BE 7 3/4 INCHES AND THE MINIMUM TREAD DEPTH SHALL BE 10

HANDRAILS HAVING MINIMUM AND MAXIMUM HEIGHTS OF 34 INCHES AND 38 INCHES SHALL BE OVIDED ON AT LEAST. ONE SIDE OF STAIRWAYS IN ACCORDANCE WITH SECTION R315.1 - I.R.( HANDRAIL AND BALUSTRADE (WHERE PRESENT) SHALL BE CONSTRUCTED. ACCORDING TO IRC. ALL REQUIRED HAND RAILS SHALL BE CONTINUOUS THE FULL LENGTH OF THE STAIRS W/ 2 OR MORE SERS FROM A POINT ABOVE THE THE TOP RISER OF A FLIGHT TO A POINT ABOVE THE LÓWEST RISER OF THE FLIGHT. ENDS SHALL BE RETURNED OR SHALL TERMINATE AT NEWEL POSTS OR SAFETY TERMINALS. ANDRAILS ADJACENT TO A WALL SHALL HAVE A SPACE OF NOT LESS THAN 1.5" BETWEEN THE WALL

#### WALLS:

) ALL DIMENSIONS ARE FROM FACE OF STUD TO FACE OF STUD. ALL STUDS ARE 3 1/2" UNLESS NOTED. LL DIMENSIONS PRESENTED HERE ARE FRAME DIMENSIONS ONLY.

I SEPARATION BETWEEN THE RESIDENCE AND THE GARAGE SHALL BE MAINTAINED BY INSTALLATION OF  $rac{1}{2}"$ GYPSUM BOARD ON ALL COMMON WALLS. 2-STORY HOMES REQUIRE 5/8" TYPE X GYPSUM BOARD AT CARAGE CEILINGS WHERE HABITABLE ROOMS ARE PRESENT ABOVE.

#### **FLOORS**:

STRUCTURAL FLOOR MEMBERS SHALL NOT BE CUT, BORED, OR NOTCHED IN EXCESS OF THE LIMITATIONS

) THE ENDS OF EACH JOIST, BEAM, OR GIRDER SHALL HAVE NOT LESS THAN 1.5 INCHES OF BEARING ON WOOD OR METAL AND NOT LESS THAN 3 INCHES ON MASONRY OR CONCRETE OR AS OTHERWISE SPECIFIED

) ALL DIMENSIONAL FLOOR JOISTS TO BE PER ENGINEER STRUCTURAL PLANS.

#### FRAMING:

ALL FRAMING DIMENSIONS TO FACE OF MEMBER.

L BEARING HEADERS TO BE PER ENGINEERING PLANS. FIRE STOPPING AND / OR DRAFT STOPPING SHALL MEET THE REQUIREMENTS OF IRC R602.8.

#### **ROOF**

HIP AND VALLEY RAFTERS SHALL BE SUPPORTED AT RIDGE DOWN TO BEARING PARTITION, CUT ENDS OF AFTERS SHALL BE FULLY SUPPORTED WALL AND RIDGE

REQUIRED VENTILATION AREAS CALCULATED AT 1/300 RATIO

## SQUARE FOOTAGE

## Elevation "A"

(Slab S.F.)	
Slab Area	Sq. Ft.
FIRST FLOOR	2075
2 BAY GARAGE	428
PORCH	153
COVERED OUTDOOR LIVING	156
Total Slab Area	2812

## (Outside of Frame S.F.) on-A/C Area BAY GARAGE OVERED OUTDOOR LIVING

(Inside of Frame S.F.)		
/C Area	Sq. Ft.	
IRST FLOOR 2012		
otal A/C Area 2012		

NOTE: ALL OPTIONAL SQUARE FOOTAGES
LISTED ARE INDEPENDENT OF AND IN
ADDITION TO BASE SQUARE FOOTAGES

OPTIONS	
LOFT	+633
EXTENDED OUTDOOR LIVING	+69

## **LOT 323 WILL BE GARAGE LEFT- REVERSE** OF ARCH PLANS

BUILDING CODE COMPLIANCE

LECTRICAL PLANS DESIGNED TO MEET OR EXCEED MINIMUM

CONSTRUCTION PLANS DESIGNED TO MEET OR EXCEED

#### "E1.10A" 1ST FLR. ELECTRICAL PLAN - ELEVATION 'A "E1.11A" 1ST FLR. ELECTRICAL PLAN UPGRADE OPTIONS - ELEVATION 'A' 1ST FLR. ELECTRICAL PLAN OPTIONS - ELEVATION 'A' "01 F11" 1ST FLR FLECTRICAL PLAN LIPGRADE OPTIONS "01 F12" 1ST FLR. ELECTRICAL PLAN OPTIONS - ELEVATION 'A

TABLE OF CONTENTS

"01.E21"

## Serenity - Lot 323 - 5920-06 (Sandy Lane) - Elevation A

1ST FLR. ELECTRICAL PLAN UPGRADE OPTIONS

2ND FLR. ELECTRICAL PLAN OPTION 2ND FLR. ELECTRICAL PLAN UPGRADE OPTION

\*Optional Gourmet Kitchen 1

\*Prep Zone

\*9080 Sliding Glass Door at Great Room

SHEET NO. TYPE OF SHEET/LAYOUT

REVISIONS & SYMBOLS

FLOOR PLAN OPTIONS

FLOOR PLAN OPTIONS

2ND FLOOR PLAN OPTION

FXTERIOR FLEVATIONS - 'A

EXTERIOR ELEVATIONS - 'A

ROOF PLAN - ELEVATION 'A

INTERIOR DETAIL SHEET

EXTERIOR ELEVATIONS OPTIONS -

EXTERIOR ELEVATIONS OPTIONS - 'A

EXTERIOR ELEVATIONS OPTIONS - 'A'

COVER SHEET & GEN. NOTES

BASE FOUNDATION PLAN - ELEVATION 'A'

FIRST FLOOR PLAN - ELEVATION 'A

"G0 01"

"G0.11"

"S1.10A"

"01 A10"

"01.A20"

"01.A30"

"A2 01A"

"A2.02A"

"A2.03A"

"A2.04A"

"A2.05A"

"A3.01A"

"A4 01"

"01.E13"

"01 F20"

\*Fireplace at Great Room

\*Bed 3 ILO Flex Space


\*Tub at Bath 2 w. Tile Walls

\*Primary Bath 1

\*Tray Ceiling at Primary Bed

\*Door from Primary WIC (No Optional Upper and Base Cabinets)

\*Screened Standard Covered Outdoor Living

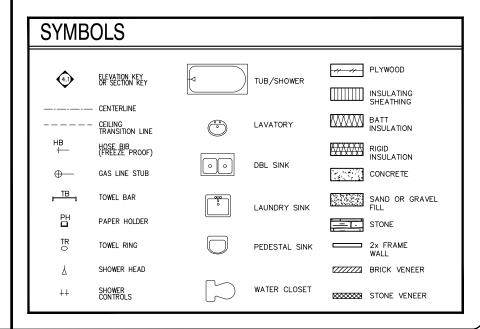

**Dointe**HOMES

BIvd Business Operation 5440 Wade Park Blv Suite 400 Raleigh, NC 27607

NERAL ha GE ઝ

SUBDIVISION: ADDRESS: LOT:

SHE

10-01-24 Issue Date: ACC

5920-06

SANDY LANE

G0.01

REVISION INDEX				
REL. #	DESCRIPTION	DATE	DRAWN BY	
5920-06	NEW PLAN	10/01/2024	ACC	
	ADDED ATTIC PULL-DOWN, REVISED ROD/SHELF IN PRIMARY W.C. ADDED OPTIONS - SCREENED COVERED OUTDOOR LIVING, GOURMET KITCHEN KITCHEN, ZERO ENTRY SHOWER AT PRIMARY BATH, ADDED TRIM SURROUNDING VENTS AT VARIOUS ELEVATIONS, REVISED BENCH DETAIL, ADDED DYT, LAUNDRY, CABINETS, ADDED (2) 4-LED LIGHTS IN GARAGE, REVISED LECT LIGHTING AND SWITCHES IN PRIMARY BATH, ADDED DISHWASHER ACCESSIBLE DISCONNECT SWITCH AND COUNTER-TOP AIR SWITCH FOR DISPOSAL NOTES	01/26/2025	ACC	
	ADDED SHOWER NICHE NOTE, ADDED CURB TO SHOWERS, REVISED INT/EXT FIREPLACE DEPTHS, REVISED OPENING HEADER HEIGHTS THROUGHOUT, REVISED REAR EXTERIOR DOOR TO 3', ADDED DOOR HEIGHTS TO MAIN FLOOR NOTES, ADDED BATH ACCESSORY HEIGHTS TO MAIN FLOOR NOTES, ADDED ZERO ENTRY SHOWER DETAIL, REMOYED PRIMARY BATH 2 OPTION, ADDED OUTDOOR LIVING PATIO OPTION 1 & 2, ADDED PARTIAL SHOWER NICHE DETAIL, ADDED GOURMET KITCHEN INTERIOR, REVISED ELECTRICAL / ELECTRICAL OPTION AT GREAT ROOM AND PRIMARY BATH.	05/14/2025	ACC	

		<b></b>	
		<b></b>	
		<b></b>	
		<b></b>	
		<b></b>	

tri pointe.

HOMES

540 WADE PARK BLVD, SUITE 400, RALEIGH, NG 27607

Business Operations 5440 Wade Park Blvd Suite 400 Raleigh, NC 27607

Lot 323 14 Shady creek Way Altis at Serenity SUBDIVISION: Lot 323
ADDRESS:


Issue Date: 10-01-24

Drawn By: ACC

5920-06

SANDY LANE

G0.11

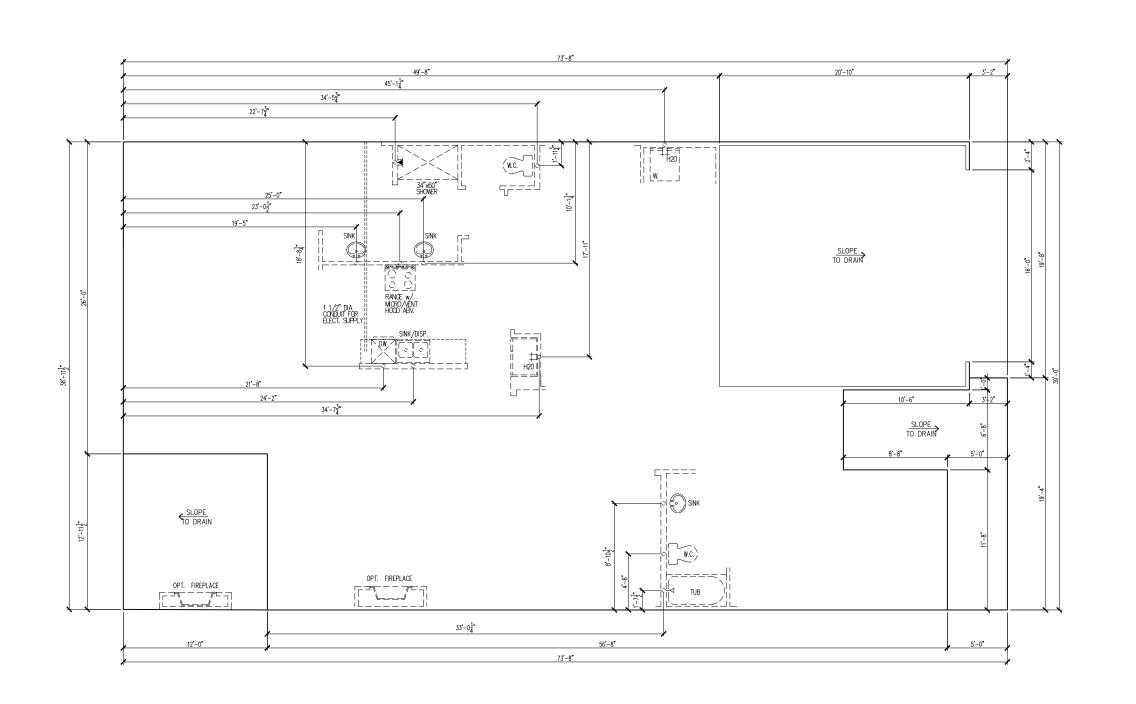

tri pointe HOMES 5440 WADE PARK BLVD. SUITE 400, RALEIGH, NG 27607

Business Operations 5440 Wade Park Blvd Suite 400 Raleigh, NC 27607

BASE FOUNDATION PLAN
IVISION: Lot 323
14 Shady creek Way


SUBDIVISION:
ADDRESS:
LOT:
BLOC

Issue Date: 10-01-24
Drawn By: ACC

5920-06

SANDY LANE

S1.10A

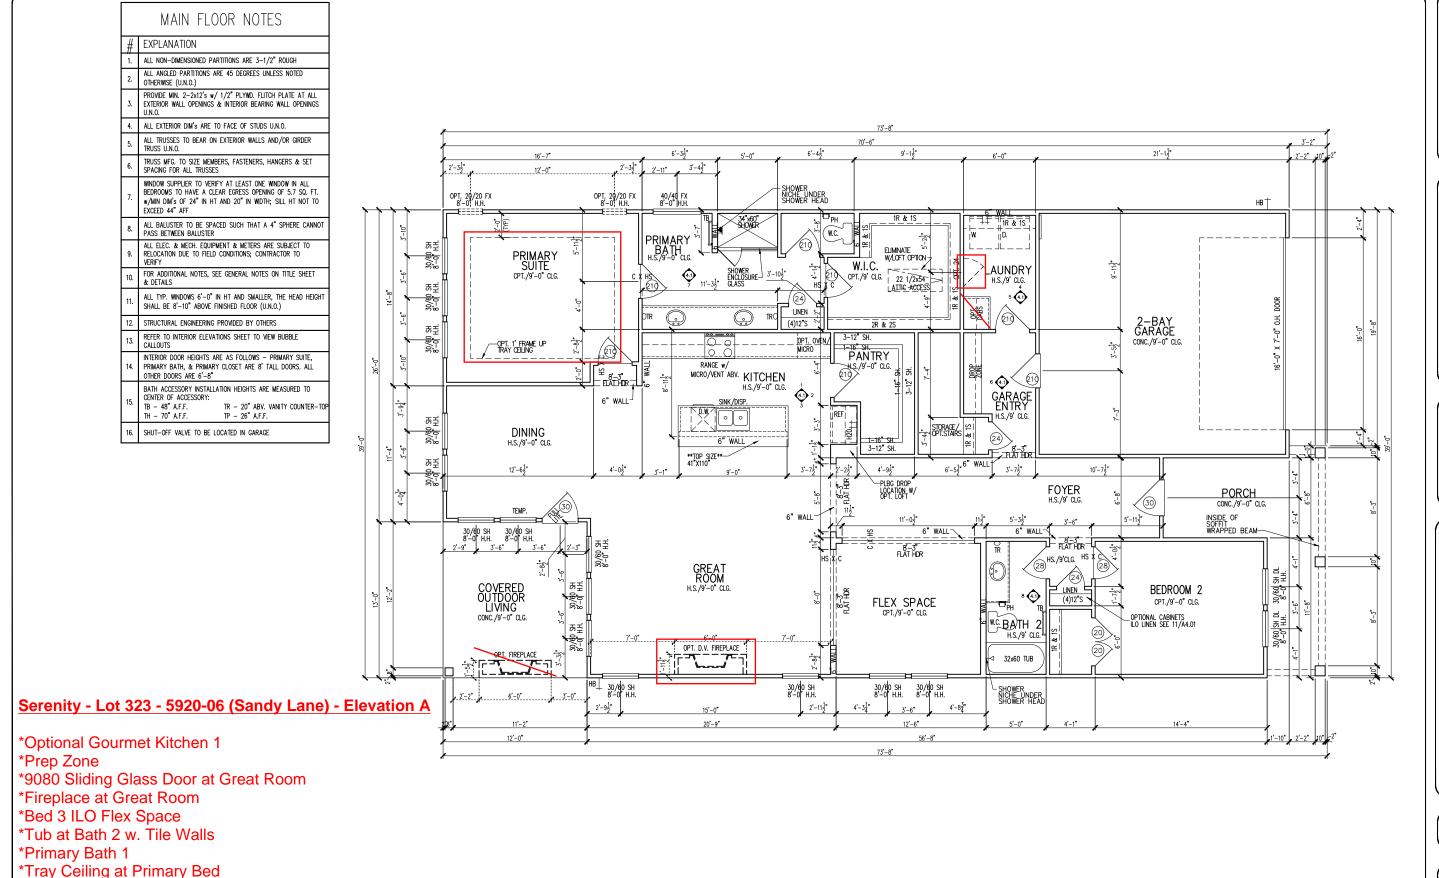

\*Door from Primary WIC (No Optional Upper and Base

\*Screened Standard Covered Outdoor Living

Cabinets)

tri pointe HOMES 40 WDE PARK BLVD. SUITE 400. RALEIGH, NG 27607

Business Operations 5440 Wade Park Blvd Suite 400 Raleigh, NC 27607

1st FLOOR PLAN

ON: Lot 323

14 Shady creek Way


SUBDIVISION:
ADDRESS:
LOT: BL


Issue Date: 10-01-24
Drawn By: ACC

5920-06


SANDY LANE

A1.10

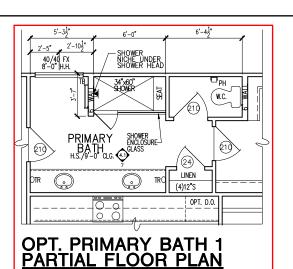


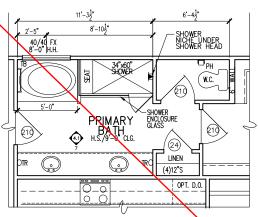


PARTIAL FLOOR PLAN

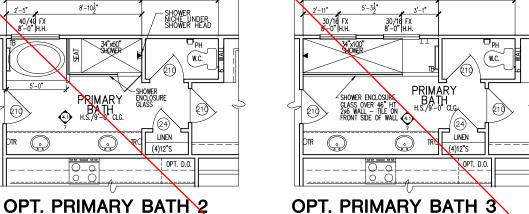

PARTIAL FLOOR PLAN

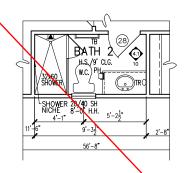

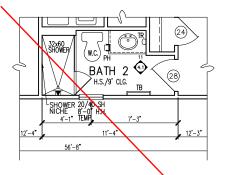


OPT. SHOWER ILO TUB AT BATH 2 (BED 3 OPT PARTIAL FLOOR PLAN

# OPT. SHOWER ILO TUB AT BATH 2 (PWDR OPT) PARTIAL FLOOR PLAN




OPT. SHOWER ILO TUB (BATH 2) PARTIAL FLOOR PLAN




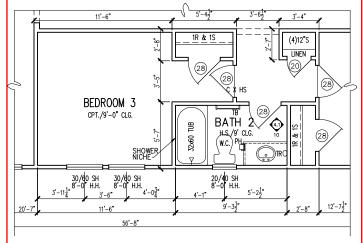



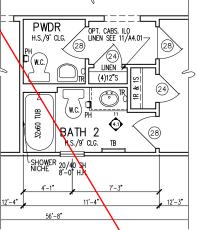



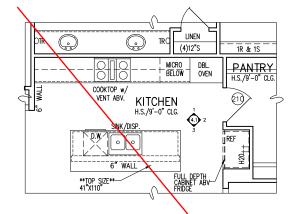


OPT. GOURMET 2 KITCHEN - PARTIAL PARTIAL FLOOR PLAN

## MAIN FLOOR NOTES


#### # EXPLANATION

- 1. ALL NON-DIMENSIONED PARTITIONS ARE 3-1/2" ROUGH ALL ANGLED PARTITIONS ARE 45 DEGREES UNLESS NOTED
- PROVIDE MIN. 2-2x12's w/ 1/2" PLYMD. FLITCH PLATE AT ALL EXTERIOR WALL OPENINGS & INTERIOR BEARING WALL OPENINGS
- ALL EXTERIOR DIM'S ARE TO FACE OF STUDS U.N.O.
- ALL TRUSSES TO BEAR ON EXTERIOR WALLS AND/OR GIRDER TRUSS U.N.O.
- TRUSS MFG. TO SIZE MEMBERS, FASTENERS, HANGERS & SET SPACING FOR ALL TRUSSES
- WINDOW SUPPLIER TO VERIFY AT LEAST ONE WINDOW IN ALL BEDROOMS TO HAVE A CLEAR EGRESS OPENING OF 5.7 SQ. FT. W/MIN DIM'S OF 24" IN HT AND 20" IN WIDTH; SILL HT NOT TO EXCEED 44" AFF
- ALL BALUSTER TO BE SPACED SUCH THAT A 4" SPHERE CANNOT PASS BETWEEN BALUSTER
- ALL ELEC. & MECH. EQUIPMENT & METERS ARE SUBJECT TO RELOCATION DUE TO FIELD CONDITIONS; CONTRACTOR TO
- FOR ADDITIONAL NOTES, SEE GENERAL NOTES ON TITLE SHEET & DETAILS
- ALL TYP. WINDOWS 6'-0" IN HT AND SMALLER, THE HEAD HEIGH SHALL BE 8'-10" ABOVE FINISHED FLOOR (U.N.O.)
- STRUCTURAL ENGINEERING PROVIDED BY OTHERS REFER TO INTERIOR ELEVATIONS SHEET TO VIEW BUBBLE
- PRIMARY BATH, & PRIMARY CLOSET ARE 8' TALL DOORS. ALL OTHER DOORS ARE 6'-8"
- BATH ACCESSORY INSTALLATION HEIGHTS ARE MEASURED TO CENTER OF ACCESSORY
- TH 70" A.F.F.
- SHUT-OFF VALVE TO BE LOCATED IN GARAGE

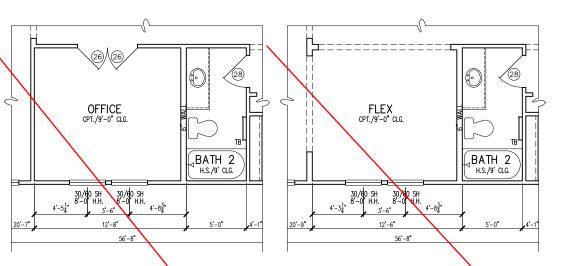


OPT. OFFICE ILO FLEX SPACE PARTIAL FLOOR PLAN

OPT. GLASS WALL AT FLEX SPACE -PARTIAL FLOOR PLAN

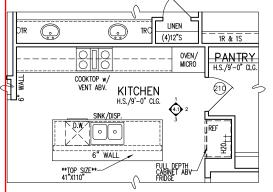

OPT. GOURMET 1 KITCHEN - PARTIAL PARTIAL FLOOR PLAN

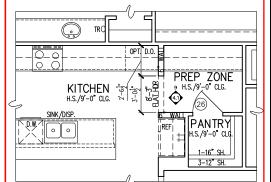

**OPT. PREP ZONE** PARTIAL FLOOR PLAN **Dointe**HOMES は

Business Operations 5440 Wade Park Blvd Suite 400 Raleigh, NC 27607

14 Shady creek \ Altis at Serenity OPTIONS PLAN

SUBDIVISION: ADDRESS: LOT:


FLOOR

10-01-24 Issue Date: ACC


5920-06


SANDY LANE


01.A10

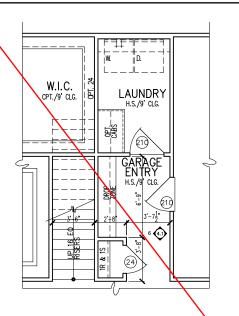

OPT. SECOND FLOOR STAIR 2 PARTIAL FLOOR PLAN

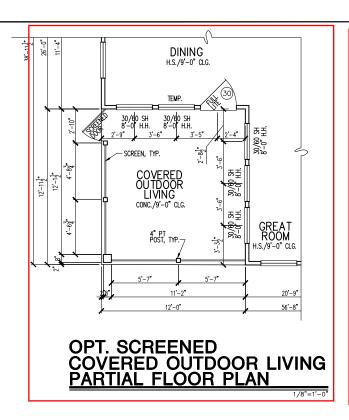

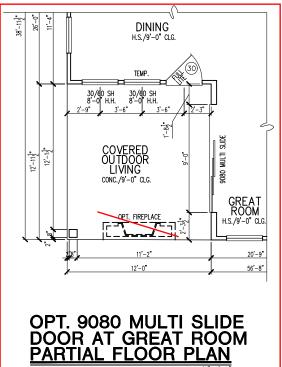

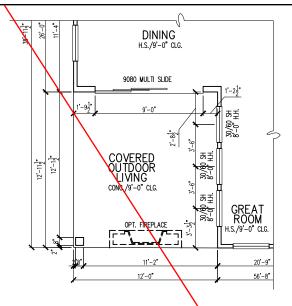

OPT. 9080 MULTI SLIDE DOOR AT DINING PARTIAL FLOOR PLAN

## MAIN FLOOR NOTES

# EXPLANATION

ALL NON-DIMENSIONED PARTITIONS ARE 3-1/2" ROUGH

ALL ANGLED PARTITIONS ARE 45 DEGREES UNLESS NOTED OTHERWISE (U.N.O.)

PROVIDE MIN. 2-2x12's w/ 1/2" PLYWD. FLITCH PLATE AT ALL EXTERIOR WALL OPENINGS & INTERIOR BEARING WALL OPENINGS

ALL EXTERIOR DIM'S ARE TO FACE OF STUDS U.N.O.

ALL TRUSSES TO BEAR ON EXTERIOR WALLS AND/OR GIRDER TRUSS U.N.O.

TRUSS MFG. TO SIZE MEMBERS, FASTENERS, HANGERS & SET SPACING FOR ALL TRUSSES

WINDOW SUPPLIER TO VERIFY AT LEAST ONE WINDOW IN ALL BEDROOMS TO HAVE A CLEAR EGRESS OPENING OF 5.7 SQ. FT. w/MIN DIM'S OF 24" IN HT AND 20" IN WIDTH; SILL HT NOT TO EXCEED 44" AFF

ALL BALUSTER TO BE SPACED SUCH THAT A 4" SPHERE CANNOT PASS BETWEEN BALUSTER

ALL ELEC. & MECH. EQUIPMENT & METERS ARE SUBJECT TO RELOCATION DUE TO FIELD CONDITIONS; CONTRACTOR TO

FOR ADDITIONAL NOTES, SEE GENERAL NOTES ON TITLE SHEET & DETAILS ALL TYP. WINDOWS 6'-0" IN HT AND SMALLER, THE HEAD HEIGHT SHALL BE 8'-10" ABOVE FINISHED FLOOR (U.N.O.)

STRUCTURAL ENGINEERING PROVIDED BY OTHERS


REFER TO INTERIOR ELEVATIONS SHEET TO VIEW BUBBLE

INTERIOR DOOR HEIGHTS ARE AS FOLLOWS - PRIMARY SUITE, PRIMARY BATH, & PRIMARY CLOSET ARE 8' TALL DOORS. ALL OTHER DOORS ARE 6'-8"

BATH ACCESSORY INSTALLATION HEIGHTS ARE MEASURED TO CENTER OF ACCESSORY: TB - 48" A.F.F. TH - 70" A.F.F.

TR - 20" ABV. VANITY COUNTER-TO

SHUT-OFF VALVE TO BE LOCATED IN GARAGE

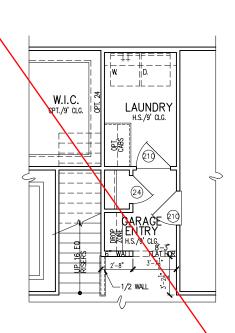

OPT. SECOND FLOOR STAIR 1 PARTIAL FLOOR PLAN

Business Operations 5440 Wade Park Blvd Suite 400 Raleigh, NC 27607

Dointe HOMES RR BLVD, SUITE 400, RALEIGH, NG 27607

14 Shady creek \ Altis at Serenity

OPTIONS

PLAN

FLOOR

SUBDIVISION: ADDRESS: LOT:

10-01-24 Issue Date: ACC

5920-06

(SANDY LANE

01.A20


## MAIN FLOOR NOTES # EXPLANATION ALL NON-DIMENSIONED PARTITIONS ARE 3-1/2" ROUGH ALL ANGLED PARTITIONS ARE 45 DEGREES UNLESS NOTED OTHERWISE (U.N.O.) PROVIDE MIN. 2-2x12's w/ 1/2" PLYWD. FLITCH PLATE AT ALL EXTERIOR WALL OPENINGS & INTERIOR BEARING WALL OPENINGS U.N.O. 4. ALL EXTERIOR DIM'S ARE TO FACE OF STUDS U.N.O. ALL TRUSSES TO BEAR ON EXTERIOR WALLS AND/OR GIRDER TRUSS U.N.O. TRUSS MFG. TO SIZE MEMBERS, FASTENERS, HANGERS & SET SPACING FOR ALL TRUSSES WINDOW SUPPLIER TO VERIFY AT LEAST ONE WINDOW IN ALL BEDROOMS TO HAVE A CLEAR ECRESS OPENING OF 5.7 SQ. FT. W/MIN DIM'S OF 24" IN HT AND 20" IN WIDTH; SILL HT NOT TO ALL BALUSTER TO BE SPACED SUCH THAT A 4" SPHERE CANNOT PASS BETWEEN BALUSTER ALL ELEC. & MECH. EQUIPMENT & METERS ARE SUBJECT TO RELOCATION DUE TO FIELD CONDITIONS; CONTRACTOR TO VERIFY FOR ADDITIONAL NOTES, SEE GENERAL NOTES ON TITLE SHEET & DETAILS ALL TYP. WINDOWS 6'-0" IN HT AND SMALLER, THE HEAD HEIGHT SHALL BE 8'-10" ABOVE FINISHED FLOOR (U.N.O.) STRUCTURAL ENGINEERING PROVIDED BY OTHERS REFER TO INTERIOR ELEVATIONS SHEET TO VIEW BUBBLE CALLOUTS INTERIOR DOOR HEIGHTS ARE AS FOLLOWS - PRIMARY SUITE, PRIMARY BATH, & PRIMARY CLOSET ARE 8' TALL DOORS. ALL OTHER DOORS ARE 6'-8"

BATH ACCESSORY INSTALLATION HEIGHTS ARE MEASURED TO CENTER OF ACCESSORY:

SHUT-OFF VALVE TO BE LOCATED IN GARAGE

TB - 48" A.F.F. TH - 70" A.F.F.

TR - 20" ABV. VANITY COUNTER-TOP TP - 26" A.F.F.

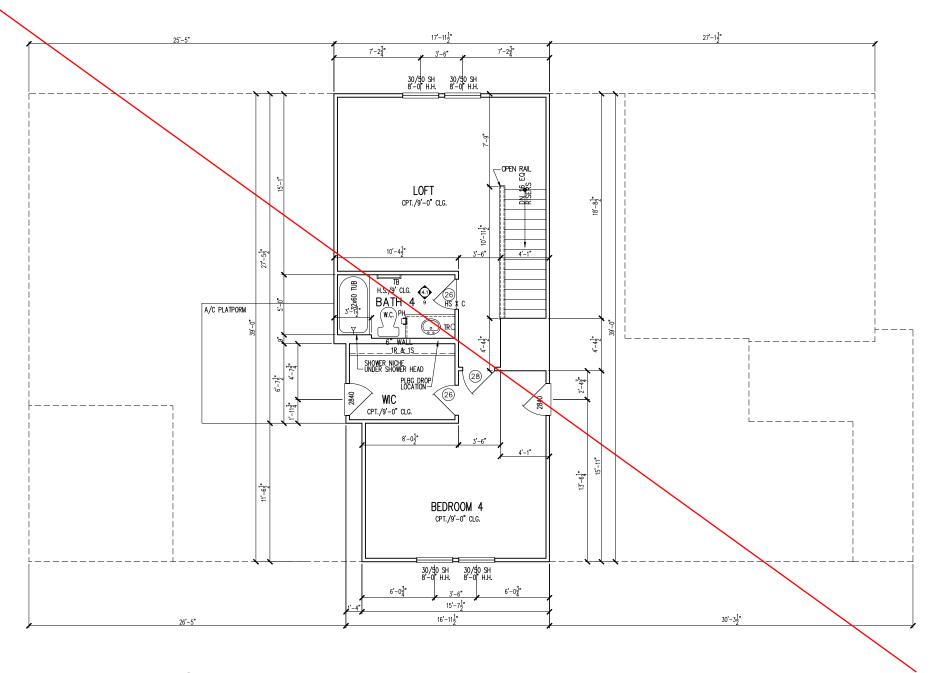

OPT. SECOND FLOOR PLAN PARTIAL FLOOR PLAN

Dointe HOMES RR BLVD. SUITE 400, RALEIGH, NC 27607

Business Operations 5440 Wade Park Blvd Suite 400 Raleigh, NC 27607

OPTION

 $\operatorname{PLAN}$ 

2ND FLOOR

SUBDIVISION:
ADDRESS:
LOT: BI


Issue Date: 10-01-24 Drawn By: ACC


5920-06

(SANDY LANE

01.A30



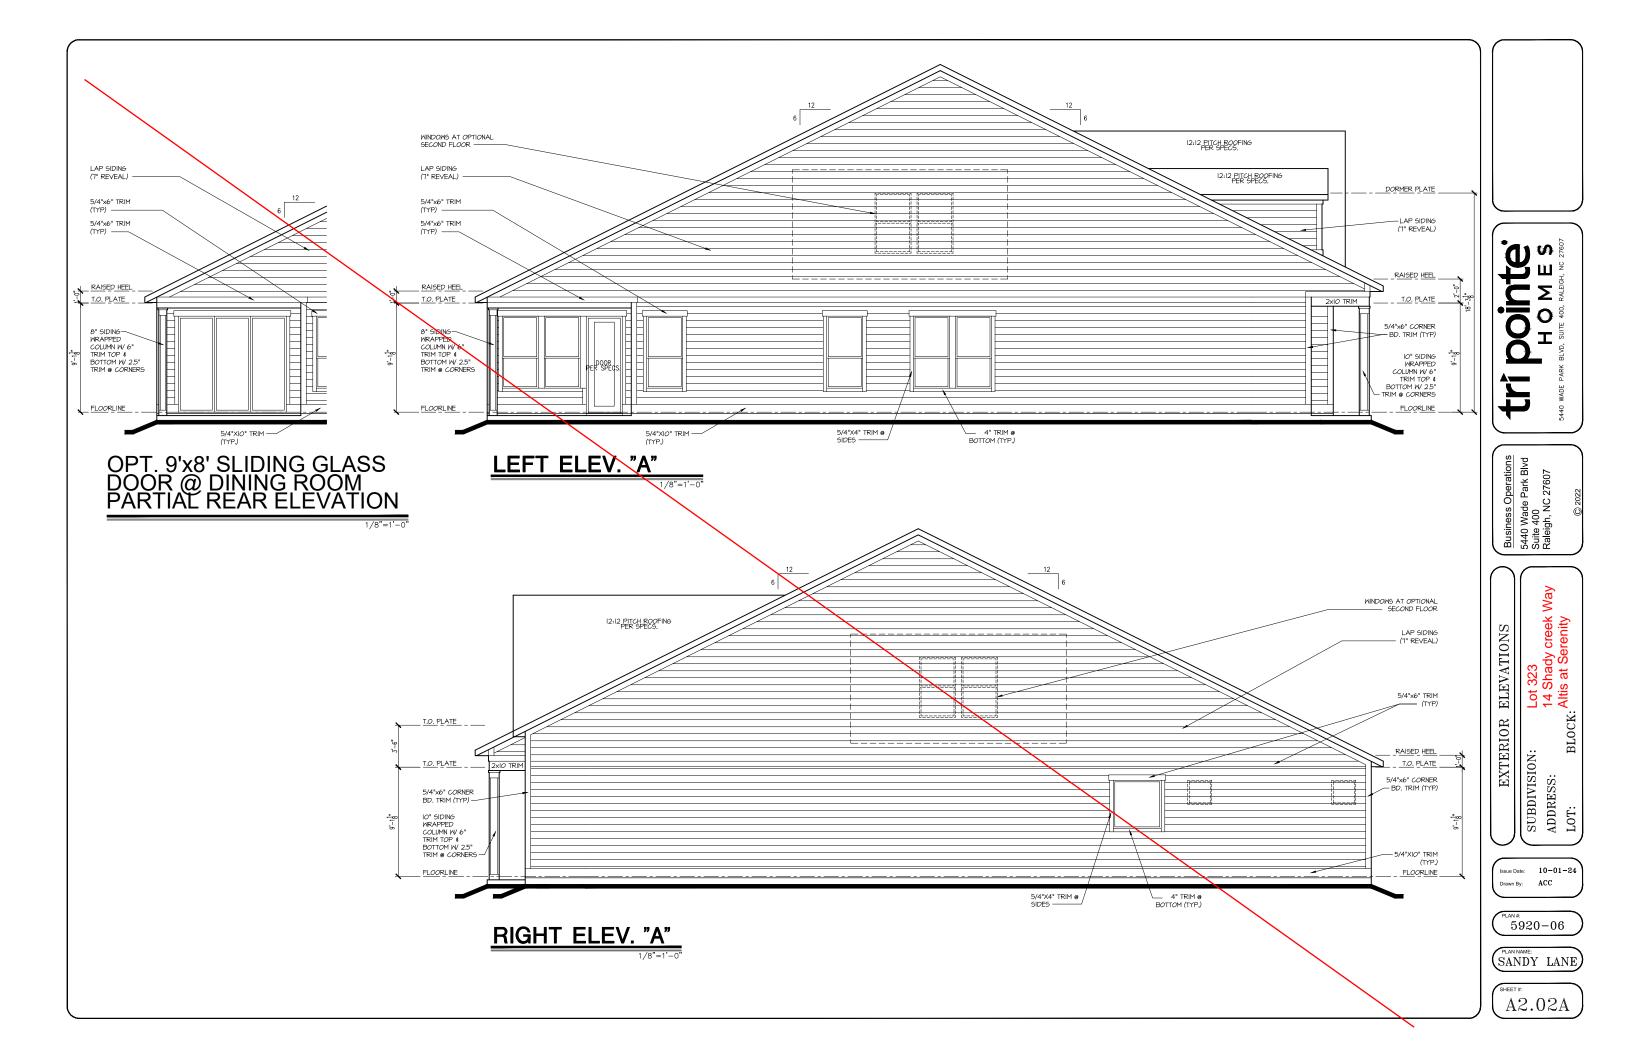

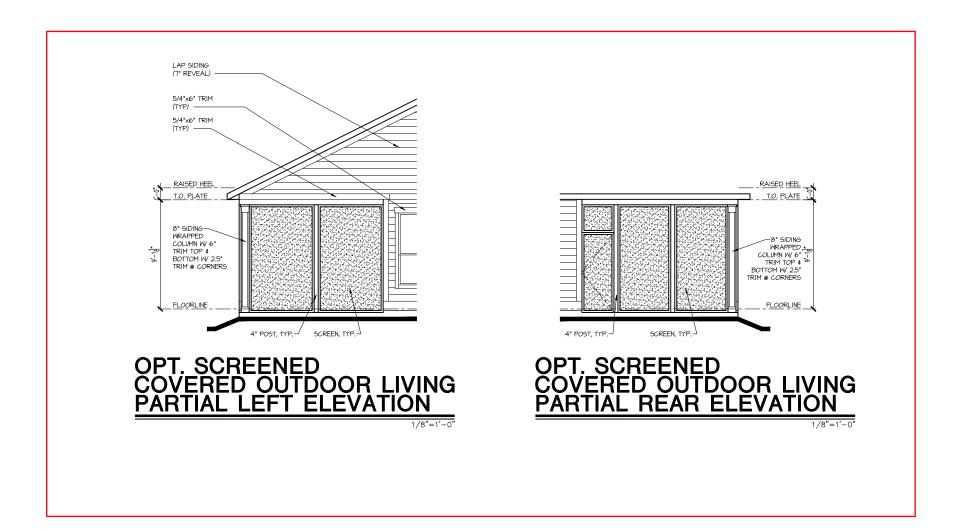

tri pointe.
HOMES
5440 WADE PARK BLVD, SUITE 400, RALEGG, NC 27607

Business Operations 5440 Wade Park Blvd Suite 400 Raleigh, NC 27607

VATIONS OPTIONS

Lot 323
14 Shady creek Way
Altis at Serenity


EXTERIOR ELEVATIONS
SUBDIVISION: Lot 323
ADDRESS: 14 Shady
LOT: BLOCK:


Issue Date: 10-01-24
Drawn By: ACC

59<u>20</u>-06

SANDY LANE

A2.03A

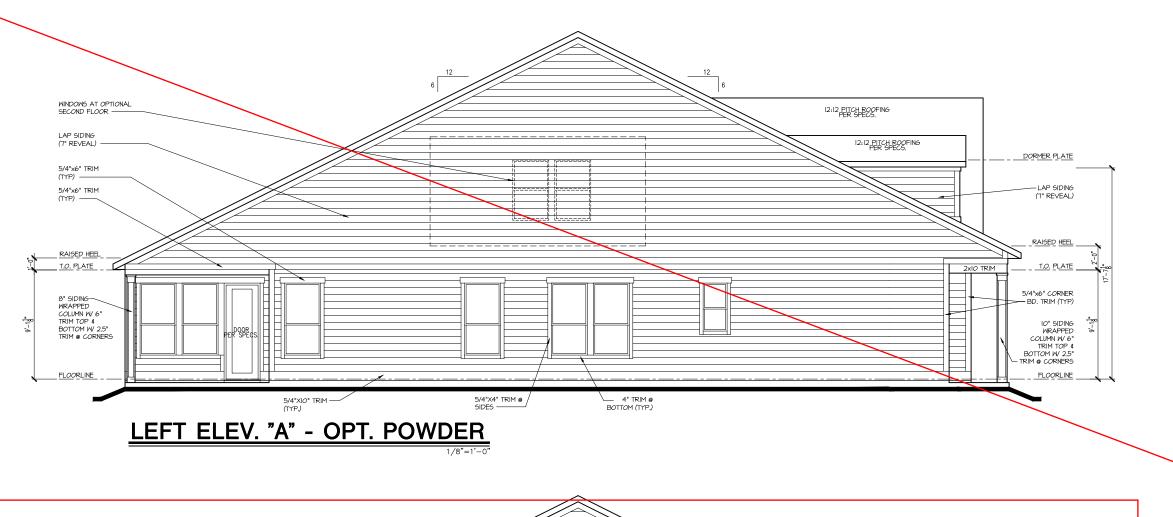

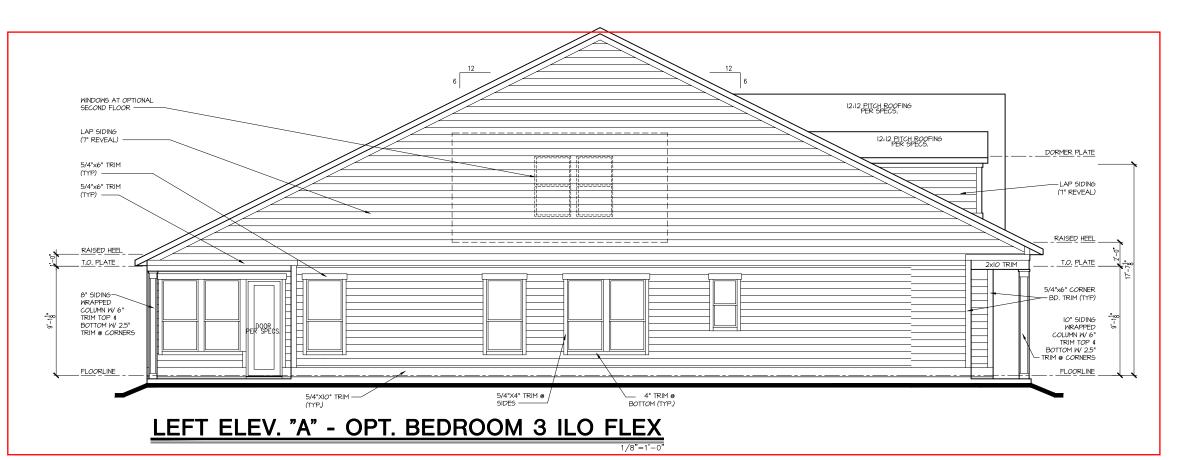

tri pointe.

HOMES

5440 WADE PARK BLVD, SUITE 400, RALEIGH, NC 27607

Business Operations 5440 Wade Park Blvd Suite 400 Raleigh, NC 27607

R ELEVATIONS OPTIONS

N: Lot 323
14 Shady creek Way

BLOCK: Altis at Serenity


EXTERIOR ELE
SUBDIVISION:
ADDRESS:
LOT: BLOCI

Issue Date: 10-01-24
Drawn By: ACC


5920-06

SANDY LANE

A2.04A

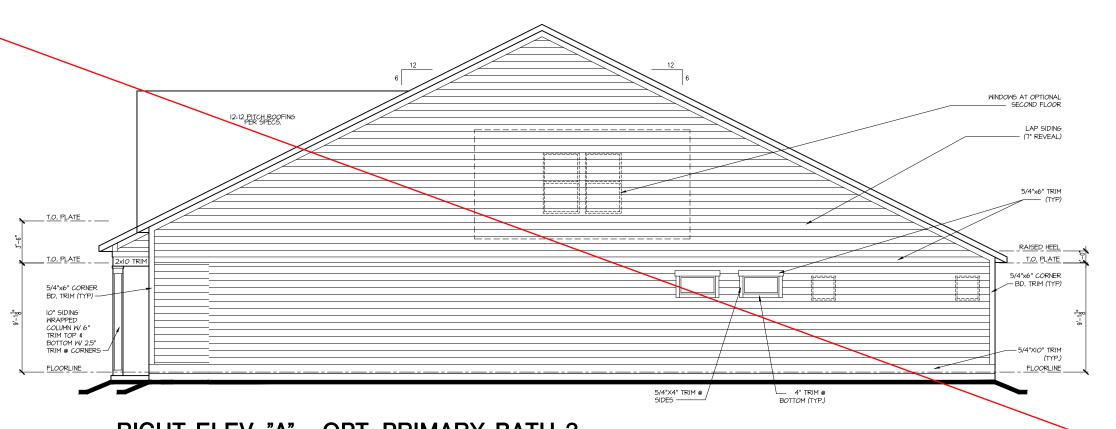

## RIGHT ELEV. "A" - OPT. PRIMARY BATH 3

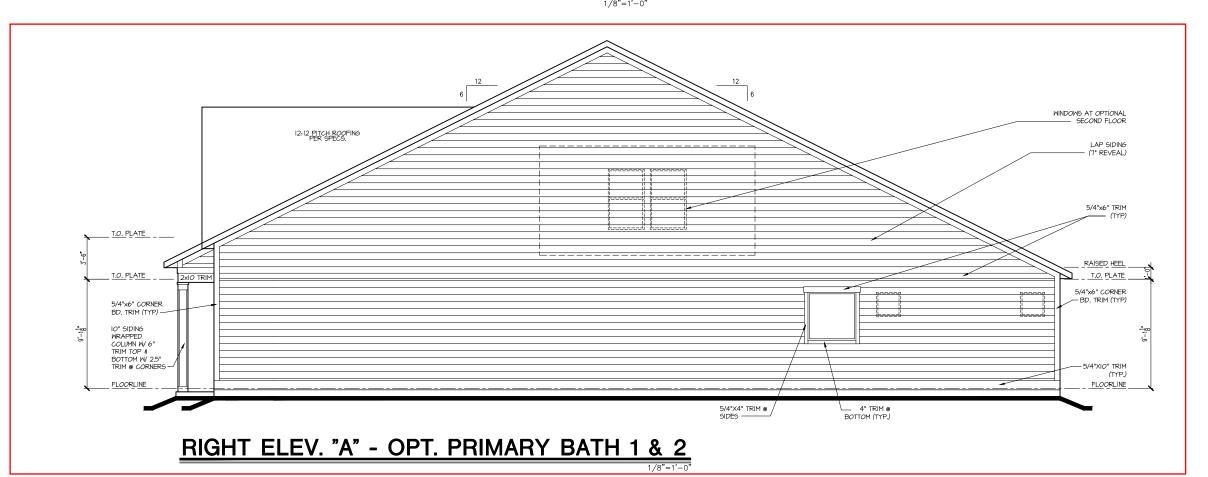

tripointe.

HOMES

S40 WADE PARK BLVD, SUITE 400, RALEIGH, NC 27607

Business Operations 5440 Wade Park Blvd Suite 400 Raleigh, NC 27607

ELEVATIONS OPTIONS
Lot 323
14 Shady creek Way

EXTERIOR ELE
SUBDIVISION:
ADDRESS:
LOT: BLOCI


Issue Date: 10-01-24

Drawn By: ACC

5920-06

SANDY LANE

A2.05A

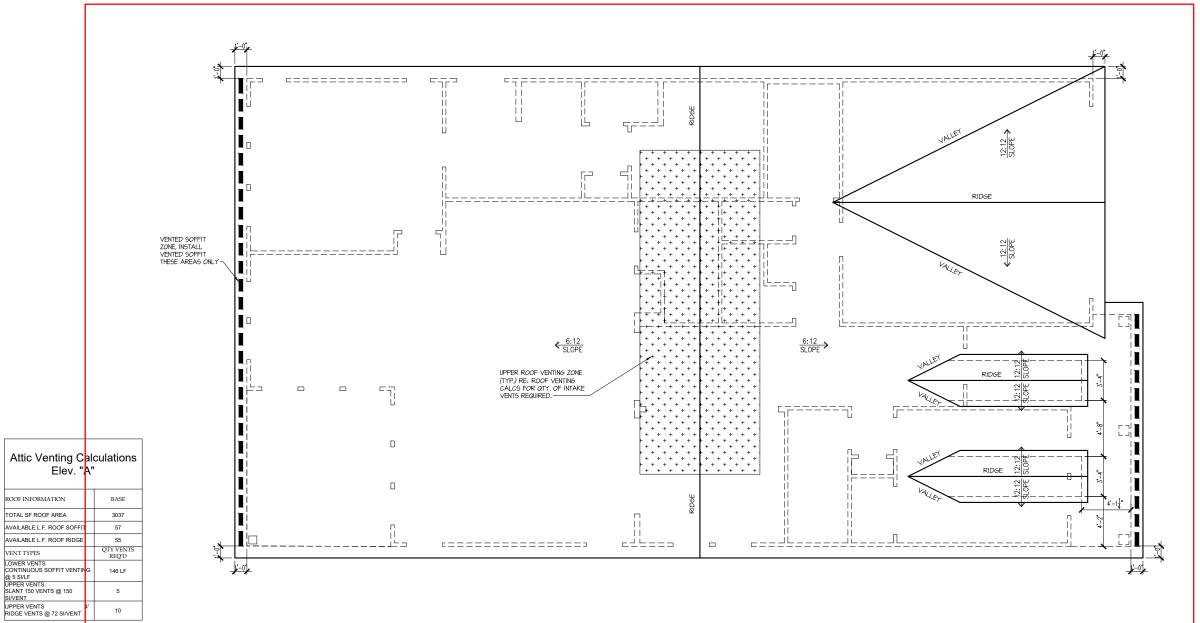

NOTE:
OTY OF UPPER VENTS SHOWN COVERS 100% OF UPPER VENTING. NO MIXING OF VENT TYPES FOR UPPER VENTING IS FIGURED FOR IN THIS TABLE.

ROOF PLAN 'A'

Dointe HOMES RR BLW, SUITE 400, RALEIGH, NG 27607

Business Operations 5440 Wade Park Blvd Suite 400 Raleigh, NC 27607

ROOF PLAN


SUBDIVISION:
ADDRESS:
LOT: BI

Issue Date: 10-01-24 Drawn By: ACC

5920-06

SANDY LANE

A3.01A

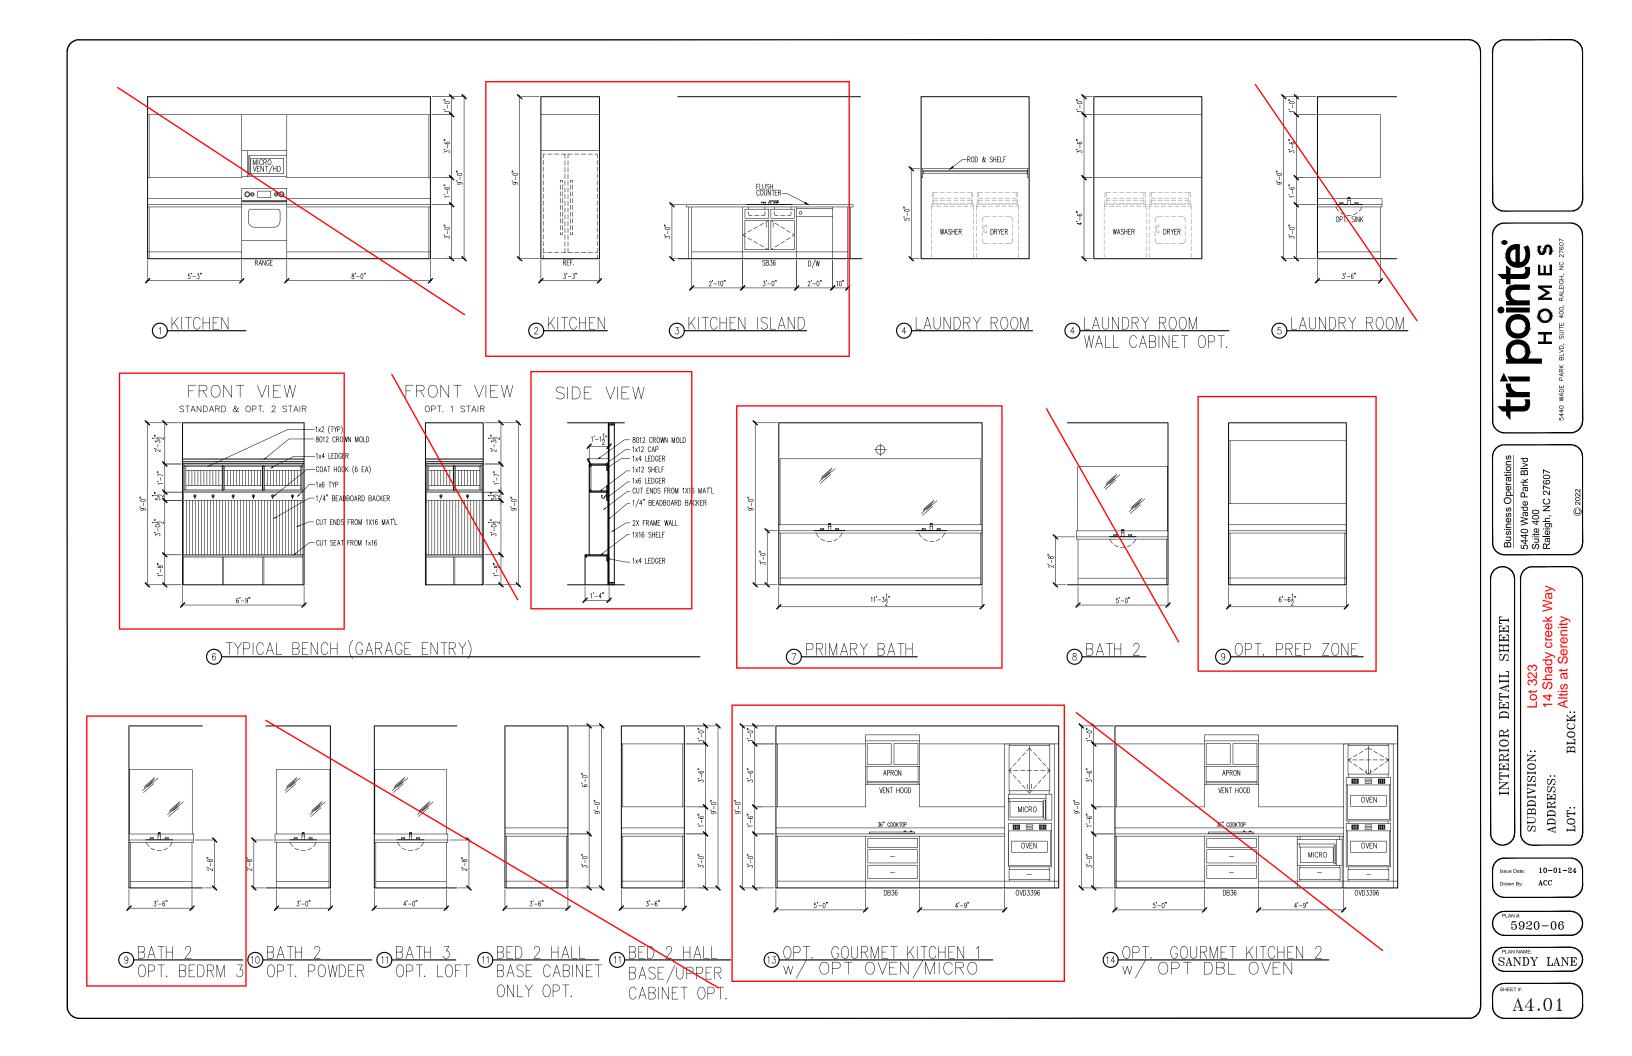

ELECTRICAL I SCHEDU	FIXTURE LE
DESCRIPTION	SYMBOL
110V OUTLET	Ф
220V OUTLET	<b></b>
1/2 HOT OUTLET	₩
GFI OUTLET	∜\$ GFI
WP GFI OUTLET	₩P/GFI
GARAGE DOOR OPENER OUTLET	Ø GDO
SECURITY SYSTEM	∯SEC SYS
DISHWASHER	<b>⊕</b> DW
JUNCTION BOX	٦
CEILING MOUNTED LIGHT	<b></b>
CEILING FAN w/ LIGHT KIT	BRACING
RECESSED CEILING LIGHT	Ø
RECESSED WATER PROOF LIGHT	<b>⊠</b> WP
WALL MOUNTED LIGHT	9
WALL MOUNTED PUSH BUTTON	<b>å</b> PB
TWO WAY SWITCH	\$
THREE WAY SWITCH	3\$
FOUR WAY SWITCH	⁴\$
DIMMER SWITCH	\$ <sup>DIM</sup>
EXHAUST VENTS	SVENT TO EXT
LOW VOLTAGE PANEL	
PHONE OUTLET	●PH
TV OUTLET	<b>●</b> TV
DATA & RG6 COMBO BOX	
SMOKE DETECTOR	<u>©</u>
CARBON MONOXIDE SMOKE DETECTOR COMBO	⊚ CM/SD
DOOR CHIMES	CHIMES
ELECTRICAL PANEL	EP EP
SURFACE MOUNT LED	•
EXTERIOR WALL MOUNT UPLIGHT	8
SOFFIT MOUNT FLOOD LIGHT	44
UNDER COUNTER LIGHTING	esse-UCL
SMURF TUBE	


## **ELECTRICAL NOTES:**

- PROVIDE AND INSTALL LOCALLY CERTIFIED PROVIDE AND INSTALL LOCALLY CERTIFIED SMOKE AND CARBON MONOXIDE DETECTORS REQUIRED BY NATIONAL FIRE PROTECTION ASSOCIATION (NFPA) AND MEETING THE REQUIREMENTS OF ALL GOVERNING CODES PROVIDE AND INSTALL GROUND FAULT CIRCUIT—INTERRUPTERS (GFI) AS REQUIRED BY NATIONAL ELECTRIC CODE (NEC) AND MEETING THE REQUIREMENTS OF ALL GOVERNING CODES. ELECTRICAL CONTRACTOR TO PROVIDE REQUIRED DIRECT HOOK—UPS/CUTOFFS. HYAC CONTRACTOR TO VERIEY THERMOSTAT

- REQUIRED DIRECT HOOK—UPS/CUIOFFS.
  HVAC CONTRACTOR TO VERIFY THERMOSTAT
  LOCATIONS.
  ALL ELECTRICAL AND MECHANICAL EQUIPMENT
  (I.E. FURNACES, A/C UNITS, ELECTRICAL PANELS,
  SANITARY SUMP PITS, DRAIN TILE SUMP, AND
  WATER HEATERS) ARE SUBJECT TO RELOCATION
  DUE TO FIELD CONDITIONS.

FRONT DOOR COACH LIGHT. GARAGE DOOR COACH LIGHT, (ABOVE GARAGE FLOOR). . . . 84" . TO CL THERMOSTAT. . .54" TO .CL . . .84" TO .CL DOORBELL CHIMES. . . . . . . . . . . . . . . . . . DR HANDLE .66". TQ CL KITCHEN WALL HUNG MICROWAVE OUTLET . . . 72" TO CL KITCHEN DISHWASHER RECEPTACLE. JUNDER SINK
KITCHEN RANGE. 24". TO. CL.
KITCHEN REFRIGERATOR. 48". TO. CL.
WASHER/DRYER OUTLET. 48". TO. CL.
CL. — CENTED DIST.

CL = CENTER LINE 1 = FIELD VERIFY 2 = MASTER BATH STANDARD 30" HIGH VANITY TO BE RAISED 4"

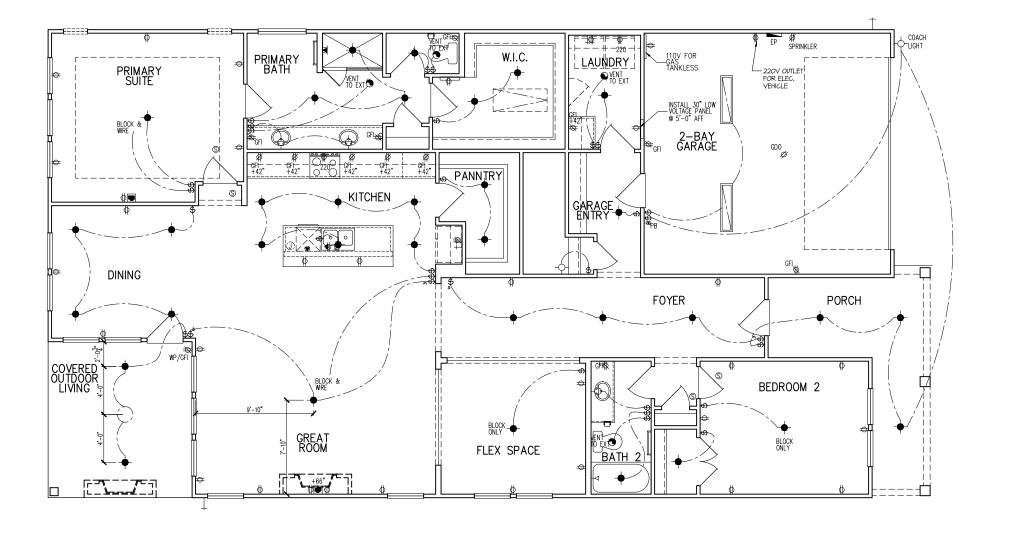

Dointe SALVO, SUITE 400, RALEIGH, NC 27607

Business Operations 5440 Wade Park Blvd Suite 400 Raleigh, NC 27607

 $\operatorname{PLAN}$ 

14 Shady creek \Altis at Serenity ELECTRICAL 1st FLOOR

SUBDIVISION:
ADDRESS:
LOT: BI

Issue Date: 10-01-24 ACC

5920-06

SANDY LANE

E1.10A


ELECTRICAL I SCHEDU	FIXTURE LE
DESCRIPTION	SYMBOL
110V OUTLET	Ф
220V OUTLET	<b>Ф</b> 220
1/2 HOT OUTLET	•
GFI OUTLET	<b>∜</b> GFI
WP GFI OUTLET	₩P/GFI
GARAGE DOOR OPENER OUTLET	Ø GDO
SECURITY SYSTEM	♦ SEC SYS
DISHWASHER	●DW
JUNCTION BOX	Ū
CEILING MOUNTED LIGHT	<b></b>
CEILING FAN w/ LIGHT KIT	PROVIDE
RECESSED CEILING LIGHT	Ø
RECESSED WATER PROOF LIGHT	)⊠(WP
WALL MOUNTED LIGHT	φ
WALL MOUNTED PUSH BUTTON	e PB
TWO WAY SWITCH	\$
THREE WAY SWITCH	³\$
FOUR WAY SWITCH	<b>⁴</b> \$
DIMMER SWITCH	\$ <sup>DIM</sup>
EXHAUST VENTS	<b>S</b> VENT TO EXT
LOW VOLTAGE PANEL	
PHONE OUTLET	<b>●</b> PH
TV OUTLET	<b>⊗</b> TV
DATA & RG6 COMBO BOX	
SMOKE DETECTOR	<u>(S)</u>
CARBON MONOXIDE SMOKE DETECTOR COMBO	⊚ CM/SD
DOOR CHIMES	CHIMES
ELECTRICAL PANEL	EP EP
SURFACE MOUNT LED	
EXTERIOR WALL MOUNT UPLIGHT	8
SOFFIT MOUNT FLOOD LIGHT	448
UNDER COUNTER LIGHTING	-coc- UCL
SMURF TUBE	

## **ELECTRICAL NOTES:**

- 1. PROVIDE AND INSTALL LOCALLY CERTIFIED SMOKE AND CARBON MONOXIDE DETECTORS AS REQUIRED BY NATIONAL FIRE PROTECTION ASSOCIATION (NPA) AND MEETING THE REQUIREMENTS OF ALL COVERNING CODES
  2. PROVIDE AND INSTALL GROUND FAULT CIRCUIT—INTERRUPTERS (GF) AS REQUIRED BY NATIONAL ELECTRIC CODE (NEC) AND MEETING THE REQUIREMENTS OF ALL GOVERNING CODES.
  3. ELECTRICAL CONTRACTOR TO PROVIDE REQUIRED DIRECT HOOK—UPS/CUTOFFS.
  4. HVAC CONTRACTOR TO VERIFY THERMOSTAT LOCATIONS.
  5. ALL ELECTRICAL AND MECHANICAL EQUIPMENT (LE, FURNACES, A/C UNITS, ELECTRICAL PANELS, SANITARY SUMP PITS, DRAIN TILE SUMP, AND MATERIAL ELECTRICAL TO BELOCATION.

SANITARY SUMP PITS, DRAIN TILE SUMP, AND WATER HEATERS) ARE SUBJECT TO RELOCATION DUE TO FIELD CONDITIONS.	
ELECTRICAL DEVICES: ABOVE FINISHED FLOOR:	
SWITCHES OVER COUNTER	
WALL OUTLETS OVER COUNTER	
+42" TO BOTTOM OF HORIZONTAL OUTLET(TYP. @ COUNTER)	
REMAINING SWITCHES	
WALL OUTLETS	
BATH VANITY BRACKET OUTLET	
WATER SOFTENER AND SUMP OUTLETS 48" TO CL	
EXTERIOR GFI OUTLETS	
GARAGE GFI (ABOVE GARAGE FLOOR) 48" TO CL	
FRONT DOOR COACH LIGHT 80". TO CL	
GARAGE DOOR COACH LIGHT, (ABOVE GARAGE FLOOR) 84". TO CL	
THERMOSTAT	
DOORBELL CHIMES	
DOORBELL BUTTON	Ξ
KITCHEN HOOD FAN "WHIP"	
KITCHEN WALL HUNG MICROWAVE OUTLET 72" TO CL	
KITCHEN DISHWASHER RECEPTACLE UNDER SIN	
KITCHEN RANGE	
KITCHEN REFRIGERATOR	
WASHER/DRYER OUTLET	

CL = CENTER LINE 1 = FIELD VERIFY 2 = MASTER BATH STANDARD 30" HIGH VANITY TO BE RAISED 4"

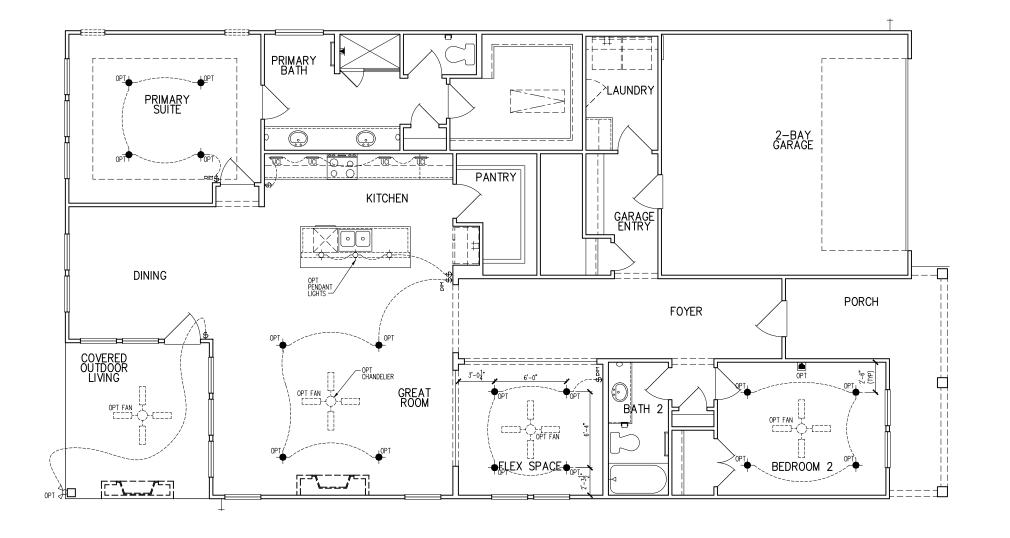

Dointe HOMES RR BLVD. SUITE 400. RALEGH, NG 27607

Business Operations 5440 Wade Park Blvd Suite 400 Raleigh, NC 27607

OPITONS

Lot 323 14 Shady creek \ Altis at Serenity 1st FLOOR ELEC. PLAN


SUBDIVISION:
ADDRESS:
LOT: BI


Issue Date: 10-01-24 Drawn By: ACC

PLAN#: 5920-06


(SANDY LANE)


E1.11A

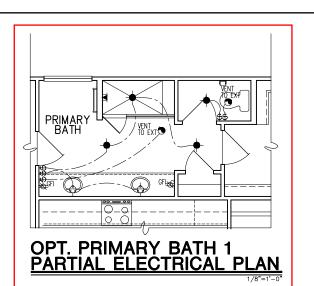


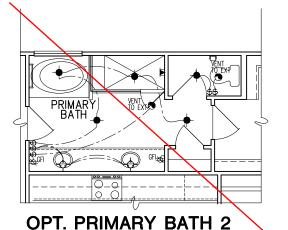

PARTIAL ELECTRICAL PLAN

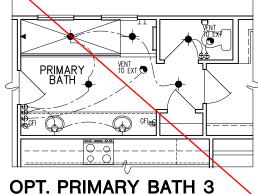

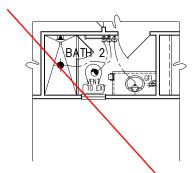


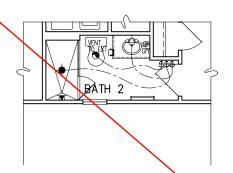


PARTIAL ELECTRICAL PLAN


OPT. SHOWER ILO TUB AT BATH 2 (PWDR OPT) PARTIAL ELECT PLAN



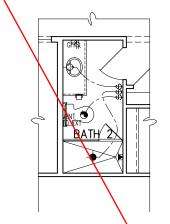


OPT. SHOWER ILO TUB (BATH 2) PARTIAL ELECTRICAL PLAN

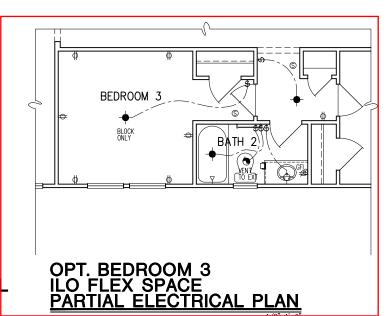

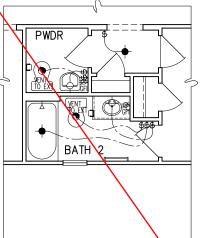

**OPT. POWDER** PARTIAL **ELECTRICAL PLAN** 

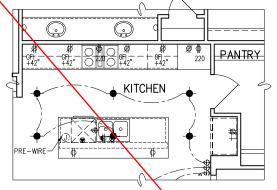

OPT. GOURMET 2 KITCHEN - PARTIAL **ELECTRICAL PLAN** 



## **ELECTRICAL NOTES:**

- PROVIDE AND INSTALL LOCALLY CERTIFIED SIMCKE AND CARBON MORNOWING DETECTORS REQUIRED BY ANDIONAL FIRE PROTECTION AND ANDIONAL FIRE PROPERTIES OF THE PROVIDE AND INSTALL GROUND FALL FROM THE PROVIDE AND INSTALL GROUND FALL FROM THE REQUIREMENTS OF ALL COVERNING CODES. THE REQUIREMENTS OF ALL COVERNING CODES.
- HVAC CONTRACTOR TO VERIFY THEMMOSTAL LOCATIONS.
  ALL ELECTRICAL AND MECHANICAL EQUIPMENT (I.E. FURNACES, A/C UNITS, ELECTRICAL PANELS, SANITARY SUMP PIRS, DRAIN TILE SUMP, AND WATER HEATERS) ARE SUBJECT TO RELOCATION DUE TO FIELD CONDITIONS.
- DUE, TO FIELD CONDITIONS.


  ELECTRICAL DEVICES: ABOVE FINISHED FLOOR:
  SINTIOHS OVER COUNTER. 48°, TO, CL
  WALL CUTLETS OVER COUNTER.
  +12° TO BOTTOM OF HOROZOTAL CUTLET(TIP. © COUNTER)
  REMAINING SWITCHES. 48°, TO, CL
  WALL CUTLETS.

  12°, TO, CL
  WALL CUTLETS. BATH VANITY BRACKET OUTLET. (1" ABOVE TOP OF VANITY) WATER SOFTENER AND SUMP OUTLETS. . . . . 48" TO CL 84" TO CL .54" TO CL .84" TO CL THERMOSTAT. . . . . . DOORBELL CHIMES. . PEAFFANR DOORBELL BUTTON. . . . . . . KITCHEN HOOD FAN "WHIP".
  - CL = CENTER LINE


    1 = FIELD VERIFY

    2 = MASTER BATH STANDARD 30" HIGH VANITY TO BE RAISED 4"


KITCHEN WALL HUNG MICROWAVE OUTLET .

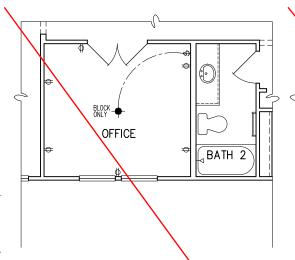


OPT. OFFICE ILO FLEX SPACE - PARTIAL **ELECTRICAL PLAN** 

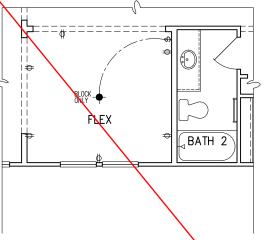

OPT. GLASS WALL AT FLEX SPACE - PARTIAL ELECTRICAL PLAN

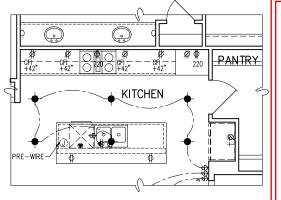

OPT. GOURMET 1 KITCHEN - PARTIAL **ELECTRICAL PLAN** 

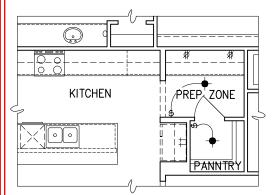

**OPT. PREP ZONE** PARTIAL ELECTRICAL PLAN **Dointe**HOMES は

Business Operations 5440 Wade Park Blvd Suite 400 Raleigh, NC 27607

14 Shady creek \ Altis at Serenity OPTIONS PLAN ELEC.


SUBDIVISION: ADDRESS: LOT:


10-01-24 Issue Date: ACC


5920-06


SANDY LANE

01.E10

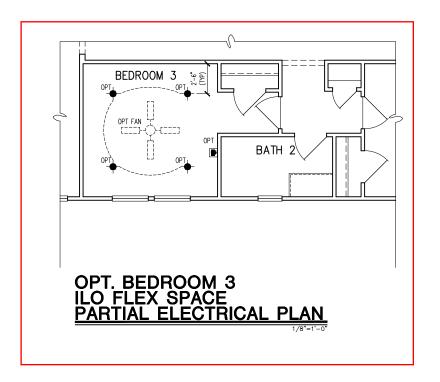

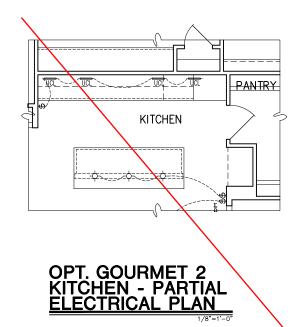

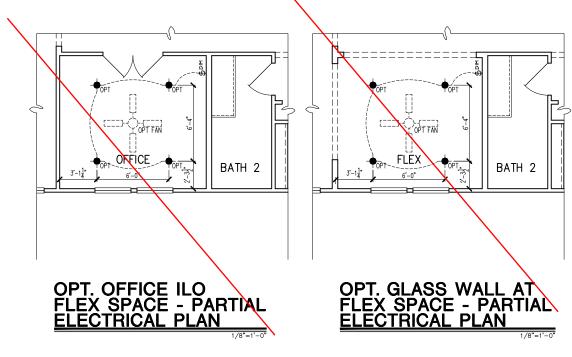

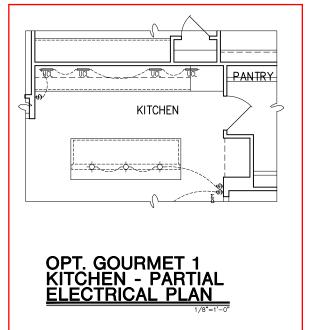

Dointe AMES ARK BLVD, SUITE 400, RALEIGH, NG 27607

Business Operations 5440 Wade Park Blvd Suite 400 Raleigh, NC 27607

OPTIONS 14 Shady creek \ Altis at Serenity 1st FLOOR ELEC. PLAN


SUBDIVISION:
ADDRESS:
LOT: BI

Issue Date: 10-01-24 Drawn By: ACC


5920-06


(SANDY LANE)


01.E11

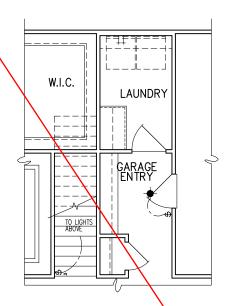

OPT. SECOND FLOOR STAIR 2 - PARTIAL ELECTRICAL PLAN

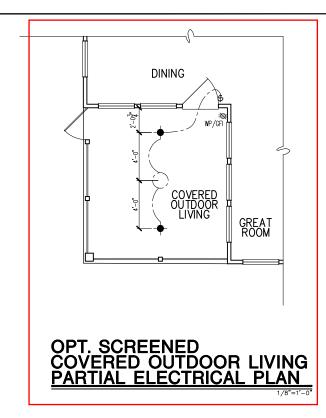

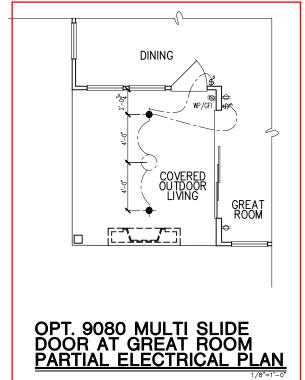

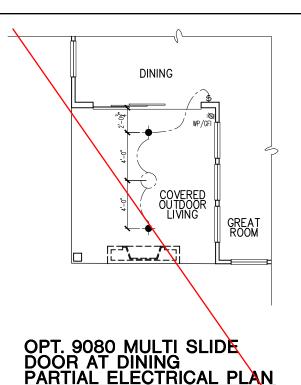

Dointe HOMES RR BLVD. SUITE 400, RALEIGH, NC 27607

Business Operations 5440 Wade Park Blvd Suite 400 Raleigh, NC 27607

14 Shady creek \ Altis at Serenity OPTIONS

PLAN

ELEC.


SUBDIVISION:
ADDRESS:
LOT: BI

Issue Date: 10-01-24 ACC


5920-06

SANDY LANE

01.E12

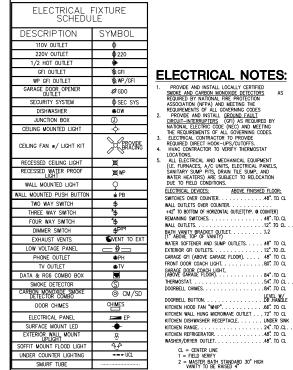


UNDER COUNTER LIGHTING SMURF TUBE

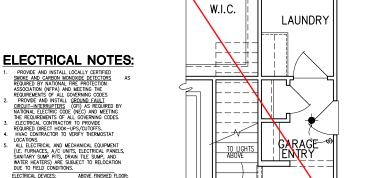



. 84" TO CL . .54" TO CL . .84" TO CL

DR HANDLE

OPT. SECOND FLOOR STAIR 1 - PARTIAL **ELECTRICAL PLAN** 

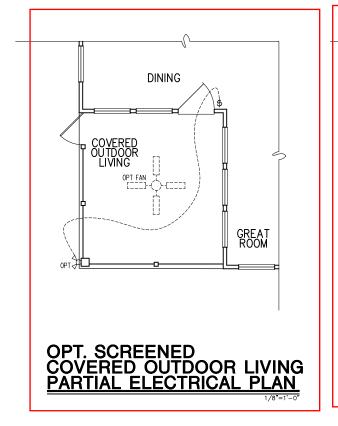

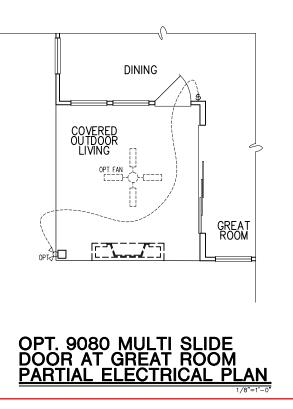

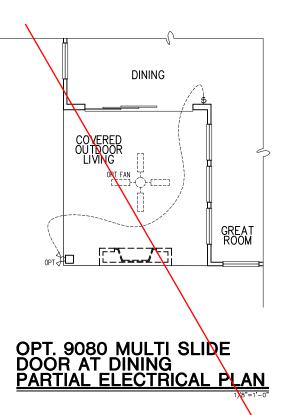

tribointe Homes 5440 WADE PARK BLVD, SUITE 400, RALEIGH, NO 27607

Business Operations 5440 Wade Park Blvd Suite 400 Raleigh, NC 27607

OPTIONS 1st FLOOR ELEC. PLAN

14 Shady creek Way Altis at Serenity

SUBDIVISION:
ADDRESS:
LOT: BI

Issue Date: 10-01-24 Drawn By: ACC

5920-06

SANDY LANE

01.E13

ELEOTDIO AL	ELVELIDE	
ELECTRICAL FIXTURE SCHEDULE		
DESCRIPTION	SYMBOL	
110V OUTLET	ф	
220V OUTLET	<b>Ф</b> 220	
1/2 HOT OUTLET	•	
GFI OUTLET	XN GFI	
WP GFI OUTLET	₩P/GFI	
GARAGE DOOR OPENER OUTLET	Ø GDO	
SECURITY SYSTEM	∯SEC SYS	
DISHWASHER	⊕DW	
JUNCTION BOX	0	
CEILING MOUNTED LIGHT	- <del>-</del>	
CEILING FAN w/ LIGHT KIT	BRAZING	
RECESSED CEILING LIGHT	Ø	
RECESSED WATER PROOF LIGHT	<b>™</b> MP	
WALL MOUNTED LIGHT	9	
WALL MOUNTED PUSH BUTTON	₫ PB	
TWO WAY SWITCH	\$	
THREE WAY SWITCH	<b>*</b> \$	
FOUR WAY SWITCH	<b>⁴</b> \$	
DIMMER SWITCH	\$ <sup>DIM</sup>	
EXHAUST VENTS	<b>O</b> VENT TO EXT	
LOW VOLTAGE PANEL		
PHONE OUTLET	<b>●</b> PH	
TV OUTLET	<b>⊗</b> TV	
DATA & RG6 COMBO BOX	•	
SMOKE DETECTOR	ⓒ	
CARBON MONOXIDE SMOKE DETECTOR COMBO	⊚ CM/SD	
DOOR CHIMES	CHIMES	
ELECTRICAL PANEL	EP EP	
SURFACE MOUNT LED	•	
EXTERIOR WALL MOUNT UPLIGHT	8	
SOFFIT MOUNT FLOOD LIGHT	44	
UNDER COUNTER LIGHTING	UCL	
SMURF TUBE		

## **ELECTRICAL NOTES:**

PROVIDE AND INSTALL LOCALLY CERTIFIED SMOKE AND CARBON MONOXIDE DETECTORS A REQUIRED BY NATIONAL FIRE PROTECTION ASSOCIATION (NFPA) AND MEETING THE REQUIREMENTS OF ALL GOVERNING CODES PROVIDE AND INSTALL GROUND FAULT (IRCUIT-INTERRUPTERS (GF)) AS REQUIRED BY NATIONAL ELECTRIC CODE (NEC) AND MEETING THE REQUIREMENTS OF ALL GOVERNING CODES.


ELECTRICAL CONTRACTOR TO PROVIDE REQUIRED DIRECT HOOK—UPS/CUTOFFS.

HVAC CONTRACTOR TO VERIFY THERMOSTAT LOCATIONS.

ALL ELECTRICAL AND MECHANICAL EQUIPMENT (I.E. FURNACES, A/C UNITS, ELECTRICAL PANELS, SANITARY SUMP PIRS, DRAIN TIME SUMP, AND WATER HEATERS) ARE SUBJECT TO RELOCATION DUE TO FIELD CONDITIONS.

ELECTRICAL DEVICES: ABOVE FINISHED FLOOR. WALL OULETS BACKET OUTLET. 1,2
[1" ABOVE TOP OF VANITY]
WATER SOFTENER AND SUMP OUTLETS. 48" TO CL
EXTERIOR GFI OUTLETS. 12" TO .CL
GARAGE GFI (ABOVE GARAGE FLOOR). 48" TO CL GARAGE DOOR COACH LIGHT, (ABOVE GARAGE FLOOR). . . . LEVEL W/ DR HANDLE DOORBELL BUTTON. . . . . . . KITCHEN HOOD FAN "WHIP". . KITCHEN DISHWASHER RECEPTACLE. . . . . . JUNDER SINK 

CL = CENTER LINE 1 = FIELD VERIFY 2 = MASTER BATH STANDARD 30" HIGH VANITY TO BE RAISED 4"

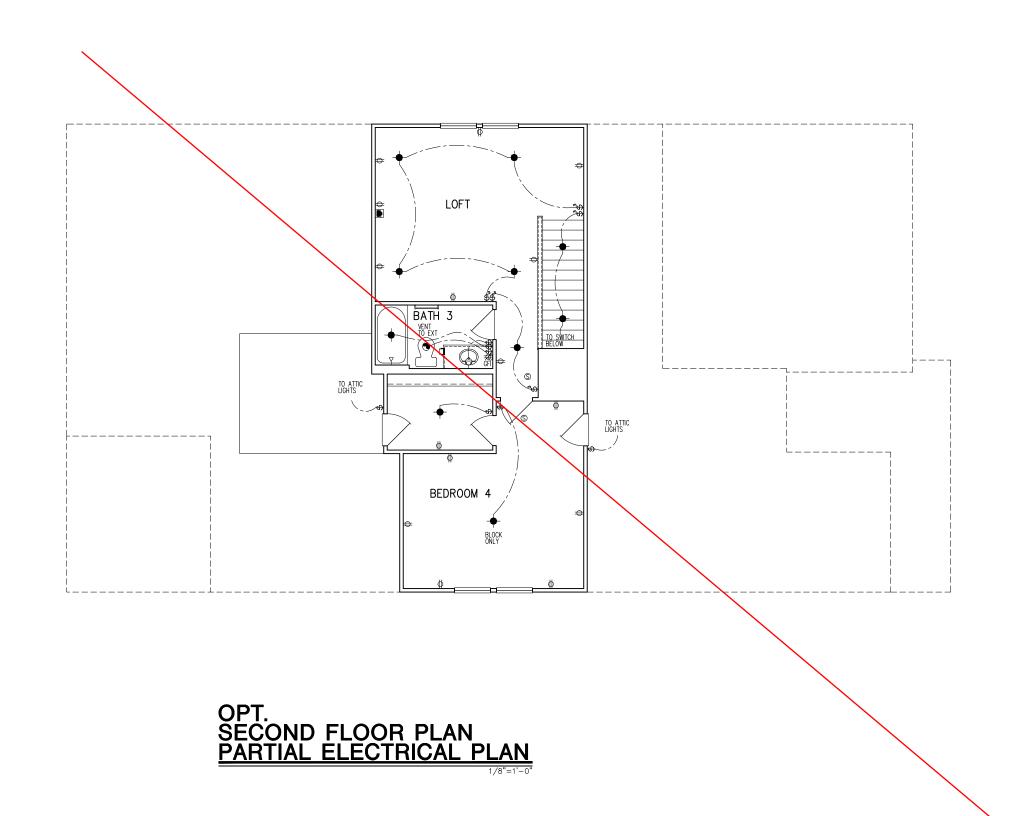

Dointe HOMES RR BLVD. SUITE 400, FALEIGH, NG 27607

Business Operations 5440 Wade Park Blvd Suite 400 Raleigh, NC 27607

OPTION Lot 323 14 Shady creek \ Altis at Serenity 2nd FLR ELEC.

SUBDIVISION:
ADDRESS:
LOT: BI


Issue Date: 10-01-24

ACC

5920-06

(SANDY LANE)

01.E20

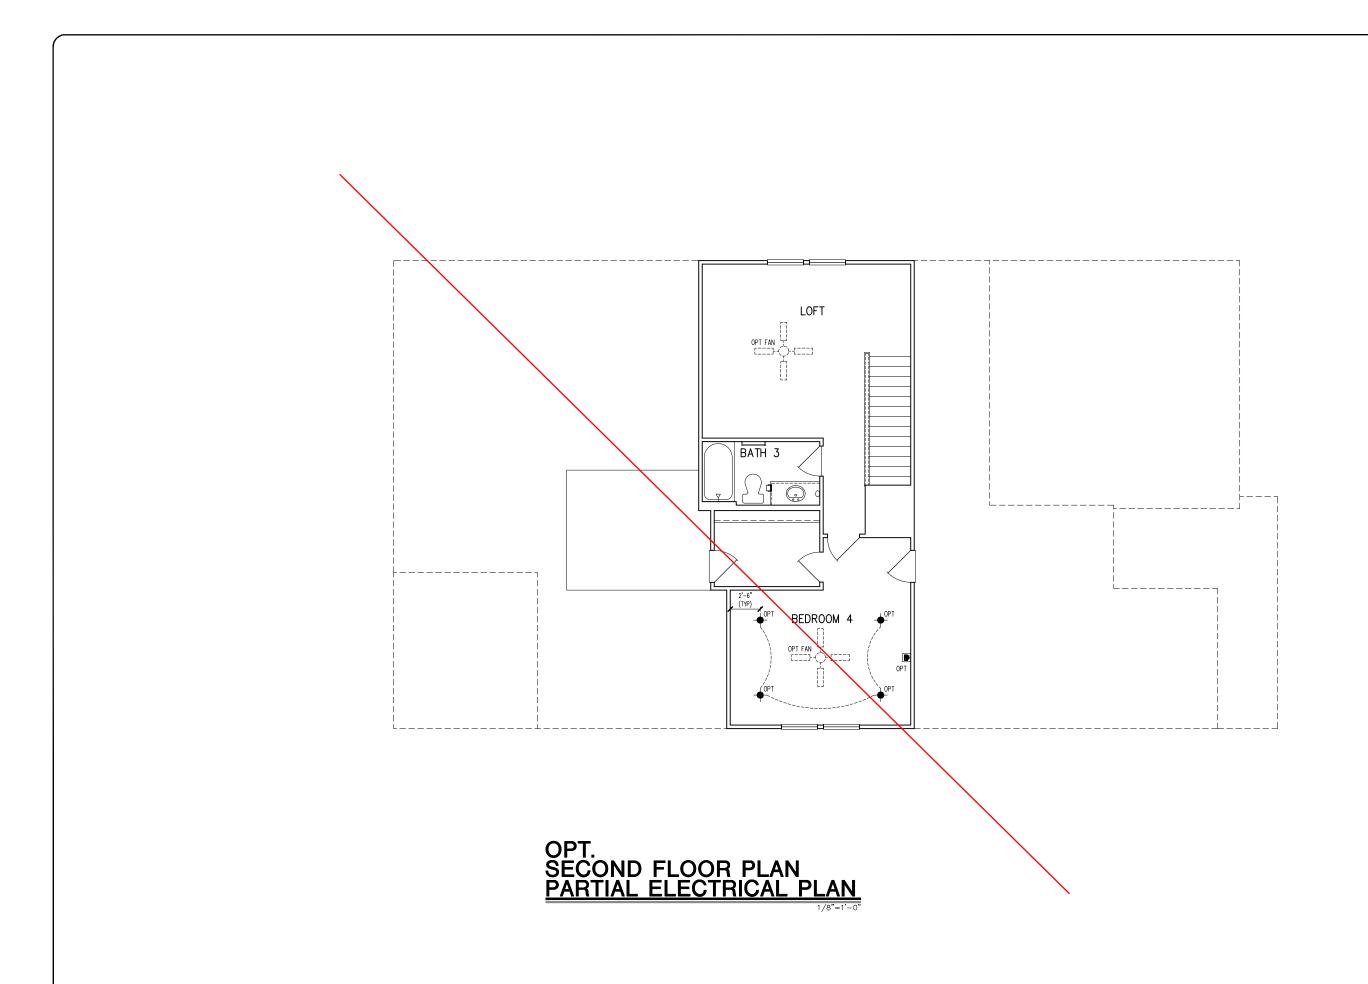

tri pointe.

HOME \$
5440 WADE PARK BLVD, SUITE 400, RALEIGH, NO 27607

Business Operations 5440 Wade Park Blvd Suite 400 Raleigh, NC 27607

OPTION 2nd FLOOR ELEC. PLAN

SUBDIVISION:
ADDRESS:
LOT: BI

Issue Date: 10-01-24

Drawn By: ACC

5920-06

SANDY LANE

©1.E21

#### GENERAL STRUCTURAL NOTES

#### FLOOR FRAMING

- I IOISTS/TRUSSES SHALL BE DESIGNED BY MANUE TO MEET OR EXCEED L/480 LIVE LOAD DEFLECTION CRITERIA. (EXCLUDES STONE/MARBLE OR WET BED CONSTRUCTED FLOORS - CONTACT M&K FOR EXCLUDED FLOOR DESIGNS)
- PER THE GUIDELINES OF THE TILE COUNCIL OF NORTH AMERICA (TCNA HANDBOOK), IT SHALL BE THE FLOOR FINISH INSTALLER'S RESPONSIBILITY TO VERIEY THAT THE FINISHES TO BE INSTALLED. MATCH THE DESIGN CRITERIA NOTED ABOVE (UNDER "DESIGN LOADS")
- FLOOR SYSTEMS & SHEATHING HAVE BEEN DESIGNED TO SUPPORT ADDITIONAL DEAD LOAD FROM CERAMIC TILE (EXCLUDING MARBLE OR STONE). HOWEVER, IT SHALL BE THE FLOOR FINISH INSTALLER'S RESPONSIBILITY TO PROVIDE PROPER UNDERLAYMENT, UNCOUPLING MEMBRANE AND MORTAR/GROUT PER THE ASSEMBLY DESIGNATIONS IN THE TONA HANDBOOK (TILE COUNCIL OF NORTH AMERICA).
- AT I-JOIST FLOORS, PROVIDE I 1/8" MIN. OSB RIM BOARD.
- METAL HANGERS SHALL BE SPECIFIED BY MANUFACTURER, U.N.O.
- I-JOIST/TRUSS SHOP DWGS. SHALL BE SUBMITTED TO ARCH. & ENG. FOR REVIEW AND APPROVAL PRIOR TO FABRICATION OR DELIVERY
- FLOOR SHEATHING SHALL BE 23/32" A.P.A. RATED 'STURD-I-FLOOR' 24" O.C. EXPOSURE I (OR APPROVED EQUAL) WITH TONGUE AND GROOVE EDGES. FASTEN TO FRAMING MEMBERS W GLUE AND
- 2 ½" × 0.131" NAILS @ 6"o.c. @ PANEL EDGES & @ 12"o.c. FIELD.
- 2 3 × 0.120 NAILS @ 4" O.C. @ PANEL EDGES \$ @ 8" O.C. FIELD. - 2 3" x 0.113" NAIL 5 @ 3" Q.C. @ PANEL EDGES & @ 6" Q.C. IN FIELD

#### ROOF FRAMING

- ROOF SHEATHING SHALL BE 1/16" A.P.A. RATED SHEATHING 24/16 EXPOSURE I (OR APPROVED EQUAL). FASTEN TO FRAMING MEMBERS
- W/ 2 ½" × 0.131" NAILS @ 6"o.c. @ PANEL EDGES & @ 12" O.C. FIELD.
- · w/ 2 🖁 × 0.120" NAILS 🥑 4"o.c. 💇 PANEL EDGES 🕏 🗗 O.C. FIELD. - w/ 2 🐉 × 0.113" NAILS @ 3"o.c. @ PANEL EDGES & @ 6" O.C. FIELD
- WITHIN 48" OF ALL ROOF FDGES RIDGES & HIPS FASTEN ROOF SHEATHING FIELDS PER EDGE NAILING SPEC
- EASTEN EACH ROOF TRUSS TO TOP PLATE W/ SIMPSON H25T CLIP (OR APPROVED EQUAL) @ ALL BEARING POINTS. PROVIDE (2) H2.51 CLIPS AT 2-PLY GIRDER TRUSSES, (3) H2.5T CLIPS AT 3-PLY GIRDER TRUSSES & ROOF BEAMS - AT ALL BEARING POINTS.
- METAL HANGERS SHALL BE SPECIFIED BY THE MANUFACTURER, U.N.O.
- ROOF TRUSS SHOP DWGS SHALL BE SUBMITTED TO ARCH & ENG. FOR REVIEW AND APPROVAL PRIOR TO FABRICATION OR DELIVERY
- ERECT AND INSTALL ROOF TRUSSES PER WTCA & TPI'S BCSI I "GUIDE TO GOOD PRACTICE FOR HANDLING, INSTALLING & BRACING
- OF METAL PLATE CONNECTED WOOD TRUSSES." SUPPORT SHORT SPAN ROOF TRUSSES W/2x4 LEDGER FASTENED TO

FRAMING w/(2) 3" x 0.120" NAILS @ 16" O.C. (UP TO 7' SPAN).

#### CONNECTION SPECIFICATIONS (TYP. U.N.O.)

DESCRIPTION OF BLDG. ELEMENT	3"x0.l3l" NAILS	3"x0.120" NAILS
JOIST TO SOLE PLATE	(3) TOENAILS	(3) TOENAILS*
SOLE PL. TO JOIST/RIM OR BLK'G	NAILS @ 4" o.c.	NAILS @ 4" o.c.
STUD TO PLATE	(4) TOENAILS/ (3)END NAILS	(4) TOENAILS/ (4)END NAILS*
RIM TO TOP PLATE	TOENAILS @ 6" o.c.	TOENAILS @ 4" o.c.*
BLK'G. BTWN. JOISTS TO TOP PL.	(3) TOENAILS EA. END	(3) TOENAILS EA. END*
DOUBLE STUD	NAILS @ 16" o.c.	NAILS @ 16" O.C.
DOUBLE TOP PLATE	NAILS @ 12" o.c.	NAILS @ 8" o.c.
DOUBLE TOP PLATE LAP SPLICE	(12) NAILS IN LAPPED AREA (24" MIN.)	(15) NAILS IN LAPPED AREA (24" MIN.)
TOP PLATE LAP @ CORNERS & INTERSECTING WALLS	(3) NAILS	(3) NAILS
RAFTER/TRUSS TO TOP PLATE	(4) TOENAILS +	(4) TOENAILS +
	(I) SIMPSON H2.5T	(I) SIMPSON H2.5T
GAB. END TRUSS TO DBL. TOP PL.	TOENAILS @ 8" o.c.	TOENAILS @ 6" o.c.
R.T. w/ HEEL HT. 9 1/4" TO 12"	2xIO BLK EVERY 3RD BAY FASTENED TO DBL. TOP PLATE W/ TOENAILS @ 6" O.C.	2xIO BLK EVERY 3RD BAY FASTENED TO DBL. TOP PLATE W/ TOENAILS @ 4" O.C.
R.T. w/ HEEL HT. 12" TO 16"	2x12 BLK EVERY 3RD BAY FASTENED TO DBL. TOP PLATE W/ TOENAILS @ 6" O.C.	2xI2 BLK EVERY 3RD BAY FASTENED TO DBL. TOP PLATE W/ TOENAILS @ 4" O.C.
R.T. w/ HEEL HT. UP TO 24"	LAP WALL SHTG. W/ DBL. TOP PL. & INGTALL ON TRUSS VERT FASTEN W/ NAILS @ 6" O.C.	LAP WALL SHTG. W/ DBL. TOP PL. \$ INGTALL ON TRUSS VERT FASTEN W/ NAILS @ 6" O.C.*
R.T. w/ HEEL HT. 24" TO 48"	LAP WALL SHTG. W/ DBL. TOP PL. & INSTALL ON TRUSS VERT FASTEN W/ NAILS @ 6" O.C. PROVIDE 2x BLK @ EA. BAY AT TOP OF HEEL	LAP WALL SHTG. W/ DBL. TOP PL. & INSTALL ON TRUSS VERT FASTEN W/ NAILS @ 6" O.C. PROVIDE 2x BLK @ EA. BAY AT TOP OF HEEL*
WALL TO FOUNDATION	WALL SHTG. LAP W/ SILL PL. \$ FASTENED PER SHEAR WALL FASTENING SPEC.	
* $2\frac{1}{2}$ X0.113 IS AN ACCEPTABLE ALTERNATIVE TO A 3"X0.120", SAME SPACING OR NUMBER OF NAILS. (ONLY ACCEPTABLE WHERE * ARE SHOWN)		

#### GENERAL STRUCTURAL NOTES

#### DESIGN LOADING

- DESIGN IS BASED ON 2018 NORTH CAROLINA STATE BUILDING CODE RESIDENTIAL CODE.
- WOOD FRAME ENGINEERING IS BASED ON NDS, "NATIONAL DESIGN SPECIFICATION FOR WOOD CONSTRUCTION" - LATEST EDITION
- DESIGN LOADS ROOF

SNOW = 15 PSF (12 PSF GROUND SNOW, TRUSSES) LIVE = 20 PSF (REDUCIBLE BASED ON ROOF PITCH) DEAD = 7 PSF T.C., IO PSF B.C. LOAD DURATION FACTOR = 125

LIVE = 40 PSE (30 PSE @ SLEEPING AREAS)

DEAD = 10 PSF (I-JOISTS), 15 PSF (FLOOR TRUSSES) ADD'L TO PSE @ CERAMIC TILE IN KITCHEN. JUNROOMS, BATHS, FOYER, LAUND. & MUDRM

2,000 PSF ASSUMED ALLOWABLE BEARING PRESSURE (TO BE VERIFIED BY BUILDER)

115 MPH, EXPOSURE B

#### GENERAL FRAMING

- ALL TYP, NAIL FASTENER REQUIREMENTS ARE NOTED IN STANDARD CONNECTIONS TABLE (IRC TABLE R602.3(1)) OR ON PLANS. ALL NAILS SPECIFIED ARE MIN DIAMETER AND LENGTH REQUIRED FOR CONNECTION. ALL HANGER NAILS SHALL BE INSTALLED PER MANUFACTURER'S REQUIREMENTS FOR MAX CHARTED CAPACITY NOTE: HANGERS USE COMMON NAIL DIAMETERS NOT TYPICAL FRAMING GUN NAILS.
- EXT & INT BEARING WALLS SHALL BE 2×4 OR 2×6 (AS SHOWN ON PLANS) @ 16" O.C. SPF/SP #2 GRADE LUMBER, OR BETTER, U.N.O.. · WALLS OVER 12' TALL SHALL BE PER PLAN.
- ALL INTERIOR BEARING WALLS ARE ASSUMED TO BE SHEATHED W/ GYP WALL BOARD (ONE SIDE MIN.) OR PROVIDE MID HT. BLOCKING
- ALL HEADERS, BEAMS & OTHER STRUCTURAL MEMBERS SHALL BE SPRIKE-PINE-FIR #2 (SPE) OR SOUTHERN PINE #2 (SP) LIMBER OR BETTER, SUPPORT ALL HEADERS/ BEAMS W/ (1)2x JACK STUD & (1)2x KING STUD MINIMUM
- THE NUMBER OF STUDS SPECIFIED AT A SUPPORT INDICATES THE NUMBER OF JACK STUDS REQUIRED, U.N.O.,
- ALL NON-BEARING INTERIOR STUD WALLS SHALL BE CONSTRUCTED WITH 2x 'STUD' GRADE MEMBERS SPACED @ 24" O.C. (MAX., U.N.O.)

  • HEADERS IN NON-LOAD BEARING WALLS SHALL BE: (1)2x4/6 FLAT @ OPENINGS UP TO 4', (2)2x4/6 FLAT UP TO 8'.
- ALL FRAMING LUMBER SHALL BE DRIED TO 15% MC (KD-15).
- ENGINEERED LUMBER BEAMS TO MEET OR EXCEED THE FOLLOWING: • 'LVL' - Fb=2600 psi; Fv=285 psi; E=2.0x10^6 psi
- ENGINEERED LUMBER POSTS TO MEET OR EXCEED THE FOLLOWING 'LVL' - Fb=2400 psi; FcII=2500 psi; E=I.8xI0^6 psi
- FOR 2 & 3 PLY BEAMS OF EQUAL 134" MAX. WIDTH, FASTEN PLIES TOGETHER WITH 3 ROWS OF 3"X0.120" NAILS @ 8" O/C OR 2 ROWS 18"x3K" SIMPSON SDS SCREWS (OR 3K" TRUSSI OK SCREWS) @ 16" USE A MINIMUM OF 4 ROWS FOR BEAM DEPTHS OF 14" OR GREATER. APPLY FASTENING AT BOTH FACES FOR 3-PLY CONDITION. LOCATE TOP & BOTTOM NAILS/SCREWS 2" FROM EDGE. SOLID 3 1/3" OR 5 1/4" BEAMS ARE ACCEPTABLE. USE 2 ROWS OF NAILS FOR 2x6 \$ 2x8 MEMBERS
- FOR 4 PLY BEAMS OF EQUAL 13/4" MAX, WIDTH, FASTEN PLIES TOGETHER WITH 3 ROWS OF K"X6" SIMPSON SDS SCREWS (OR 6 3/1 TRUSSLOK SCREWS) @ 16" O/C. USE A MINIMUM OF 4 ROWS FOR BEAM DEPTHS OF 14" OR GREATER, APPLY FASTENING AT BOTH FACES (ONE SIDE ONLY FOR TRUSSLOK SCREWS). LOCATE TOP ANI BOTTOM SCREWS 2" FROM EDGE A SOLID 7" BEAM IS ACCEPTABLE
- PROVIDE SOLID BLOCKING IN FLOOR SYSTEM UNDER ALL POSTS CONTINUOUS TO FND./BEARING. BLOCKING TO MATCH POST ABOVE.
- ALL EXTERIOR 4x4 WOOD POSTS SHALL HAVE SIMPSON BCS2-2/4
- CORROSION NOTES:
- BUILDER RESPONSIBLE TO DETERMINE CORROSION-RESISTANCE REQUIREMENTS AND COMPATIBILITY OF HARDWARE FASTENERS AND CONNECTORS FOR ENVIRONMENTAL EXPOSURE AND IN CONTACT W/ PRESERVATIVE-TREATED WOOD OF ACTUAL FINAL CONDITIONS AND SOURCED MATERIALS. CONTACT LUMBER & HARDWARE SUPPLIERS TO COORD.

#### GENERAL STRUCTURAL NOTES

#### **FOUNDATION**

- DESIGN IS BASED ON 2018 NORTH CAROLINA STATE BUILDING CODE: RESIDENTIAL CODE.
- FOOTING DESIGN 2,000 PSF ALLOWABLE SOIL BEARING PRESSURE IS ASSUMED. BUILDER/CONTRACTOR MUST VERIFY.
- FASTEN 2x4/6 SILL PLATES TO CONC FND WITH A MINIMUM OF 2
- ANCHORS PER PLATE 12" MAX FROM PLATE ENDS UTILIZING: I/2" DIA. ANCHOR BOLTS 6'-0" O.C,7" MIN. EMBEDMENT
  - I/2" DIA. x 6" LONG SIMPSON TITEN HD @ 6'-0" O.C.
  - SIMPSON MASA ANCHOR STRAPS @ 6'-0" O.C. (CONCRETE)
- ALL LUMBER EXPOSED TO WEATHER OR IN CONTACT W/ PERIMETER FOUNDATION SHALL BE PRESERVATIVE TREATED SOUTHERN PINE #2.
- BUILDER TO VERIEY CORROSION-RESISTANCE COMPATIBILITY OF HARDWARE & FASTENERS IN CONTACT W/ PRESERVATIVE-TREATED WOOD CONTACT LIMBER & HARDWARE SUPPLIERS TO COORD
- FOOTINGS SHALL BE PLAIN CONCRETE, U.N.O.
- CONCRETE DESIGN BASED ON ACL 318, CONCRETE SHALL ATTAIN THE FOLLOWING MIN. COMPRESSIVE STRENGTHS IN 28 DAYS, U.N.O. f'c = 3,000 psi: ...... FOOTINGS & INTERIOR SLABS ON GRADE 3500 psi: ...... GARAGE & EXTERIOR SLABS ON GRADE fu = 60000 psi
- ALL CONCRETE EXPOSED TO THE WEATHER SHALL NOT HAVE LESS THAN 5% OR MORE THAN 7% AIR ENTRAINMENT
- ALL FOOTINGS SHALL BEAR BELOW FROST LINE (TYP.) OR 12" MIN IN REGIONS WHERE CODE FROST DEPTH IS NOT APPLICABLE. CONSULT SOILS REPORT OR BUILDING DEPT. FOR MINIMUM DEPTH BELOW GRADE
- FOOTINGS AND SLABS ON GRADE SHALL BEAR ON VIRGIN SOIL OR
- PROVIDE CONTROL JOINTS AT ALL INSIDE CORNERS OF SLAB EDGES, AND OTHER LOCATIONS WHERE SLAB CRACKS ARE LIKELY
- JOINTS SHALL BE LOCATED @ IO'-O" O.C. (RECOMMENDED) OR 15'-0" O.C. (MAXIMUM)
- JOINT GRID PATTERN SHALL BE AS CLOSE TO SQUARES AS POSSIBLE (I:I RATIO), WITH A MAXIMUM OF I:I.5 RATIO
- · CONTROL JOINTS SHALL NOT BE INSTALLED IN STRUCTURAL
- DIMENSIONS BY OTHERS, BUILDER TO VERIFY.

#### HOLD-DOWN SCHEDULE

- '	025 507 11 001 125 522
SYMBOL	SPECIFICATION
► HD-I	SIMPSON CSI6 STRAP TIE W/ 14" END LENGTH
► HD-2	SIMPSON MSTC66 STRAP TIE w/ 24" END LENGTH
<b>▶</b> HD-3	SIMPSON HTT4 HOLD-DOWN *
► HD-4	SIMPSON HDU5-SDS2.5 HOLD-DOWN *
► HD-5	SIMPSON STHDI4RJ HOLD-DOWN *

UTILIZE SIMPSON "SET-3G" EPOXY SYSTEM TO FASTEN " DIA THREADED ROD INTO CONCRETE FOUNDATION ROVIDE 12" MIN. EMBEDMENT INTO CONCRETE. INSTALL PER MANUE RECOMMENDATIONS. DO NOT LOCATE ANCHORS WITHIN I 34" OF EDGE OF FOUNDATION

#### MEANS & METHODS NOTES

THE STRUCTURE IS DESIGNED TO BE SELF SUPPORTING AND STABLE AFTER THE BUILDING IS FINISHED AND ALL PLAN, DETAIL, AND NOTE SPECIFICATIONS HAVE BEEN COMPLETED. IT IS THE CONTRACTOR'S SOLE RESPONSIBILITY TO DETERMINE THE ERECTION PROCEDURES AND SEQUENCE TO THE SAFETY OF THE BUILDING AND ITS COMPONENTS DURING CONSTRUCTION. THIS INCLUDES BUT IS NOT LIMITED TO, THE ADDITION OF NECESSARY SHORING, SHEETING, TEMPORARY BRACING, GUYS, AND TIE-DOWNS. CONTRACTOR SHALL BE RESPONSIBLE FOR ALL SHORING AND BRACING REQUIRED TO STABILIZE AND PROTECT EXISTING AND ADJACENT STRUCTURES AND SYSTEMS DURING COURSE OF DEMOLITION AND CONSTRUCTION OF THE PROJECT

STRUCTURAL DESIGN AND SPECIFICATIONS ASSUME THAT ALL SUPPORTING AND NON-SUPPORTING ELEMENTS IN CONTACT WITH FLOOR FRAMING ARE LEVEL, INCLUDING, BUT NOT LIMITED TO: FOUNDATIONS. SLABS ON GRADE, BEAMS, WALLS, AND NON-BEARING ELEMENTS. IT IS THE CONTRACTOR'S RESPONSIBILITY TO VERIEY LEVELNESS AND MAKE ADJUSTMENTS AS NECESSARY, INCLUDING CONSIDERATION OF THOSE AREAS THAT MAY BE WITHIN CONTRACTUAL, INDUSTRY OR WARRANTY TOLERANCES

#### VENEER LINTEL SCHEDULE

SPAN (MAX)	HEIGHT OF VENEER ABOVE LINTEL	STEEL ANGLE SIZE
3'-0"	20 FT. MAX	L3"x3"x¼"
	3 FT. MAX	L3"x3"x¼"
6'-0"	I2 FT. MAX	L4"x3"x¼"
	20 FT. MAX	L5"x3½"x¾"
8'-0"	3 FT. MAX	L4"x4"x¼" *
0-0	I2 FT. MAX	L5"x3½"x¾"
	I6 FT. MAX	L6"x3½"x¾"
9'-6"	I2 FT. MAX	L6"x3½"x¾6"
16'-0"	2 FT. MAX	L7"x4"x½" **
	3 ET MAY	1 8"U/I"UK" **

- ALL LINTELS

  \*\*SHALL SHRORT 2 %\* 3 ½\* VENERR w/ 40 ps/ MAXIMM MEIGHT.

  \*\*(16 SHALL HAVE 4\* NN. BEARING

  \*\*(16 SHALL HAVE 4\* NN. BEARING

  \*\*(16 SHALL HAVE 6\* NN. BEARING

  \*\*(16 SHALL HAVE 16\* SHR. BEARING

  \*\*(16 SHALL HAVE 16\* SHR. BEARING

  \*\*(16 SHALL HAVE 16\* SHR. BEARING

  \*\*LONG LAG SCREWG IN 2\* LONG VERTICALLY 5LOTTED HOLES.

  \*\*LONG LAG SCREWG IN 2\* LONG VERTICALLY 5LOTTED HOLES.

  \*\*LAL LINTELS SHALL BE LONG LEG VERTICAL.\*

  \*\*ALL LINTELS SHALL BE LONG LEG VERTICAL.\*

  \*\*ALL LINTELS SHALL BE LONG LEG VERTICAL.\*

  \*\*HALL SHROW SHEER (\*\*) HOUSE HE EXTERIOR TOE OF THE HORIZONTAL LEG MAY BE OUT IN THE PIELD TO BE 3½\* NIEC OVER THE BEARING LINGTH ONLY. THIS SEES STRUCTURE, IL AND FOR ANY LINTEL CONDITION NOT ENCOMPASSED BY THE ABOVE PRARMSTERS.

\*\*POR QUEEN VENEER USE L4x3が。\*\* \*\*FOR QUEEN VENEER ONLY, SEE PLAN FOR VENEER SUPPORT IF VENEER < 3½\* THICK

I-JOIST MANUFACTURER

## ADDITIONAL NOTES FOR TRUSS \$

ROOF TRUSS, FLOOR TRUSS AND ENGINEERED JOISTS SHALL BE DESIGNED TO MEET THE DEFLECTION CRITERIA BELOW, UNLESS NOTED OTHERWISE ON PLAN. MULHERN & KULP CANNOT BE HELD RESPONSIBLE FOR ANY STRUCTURAL ISSUES
RELATED TO ANY BUILDING COMPONENT IF COMPONENT SHOP DRAWINGS ARE NOT SUBMITTED TO M&K FOR REVIEW PRIOR TO FABRICATION, DELIVERY, OR INSTALLATION.

TRUSSES/LIGISTS SHALL BE DESIGNED SO THAT DIFFERENTIAL DEFLECTION BETWEEN ADJACENT PARALLEL TRUSSES/JOISTS OR GIRDER TRUSSES/FLUS BEAMS DO NOT EXCEED THE FOLLOWING: A ROOF TRUSSES.

1/4" DEAD LOAD

B. FLOOR TRUSSES, ATTIC TRUSSES, & I-JOISTS; I/8" DEAD LOAD

ABSOLUTE DEAD LOAD DEFECTION OF FLOOR

TRUSSES/ATTIC TRUSSES WHEN ADJACENT TO FLOOR FRAMING BY OTHERS SHALL BE LIMITED TO 3/16". (NO: DIFFERENTIAL DEFLECTION

#### FLOOR JOIST NOTES

- ALL FLOOR JOISTS SHALL BE THE DEPTI SPECIFIED ON PLAN - FLOOR JOISTS SERIES & SPACING IS PER THE FLOOR JOIST MANUF.
  - SPACING SHALL NOT EXCEED 19.2" O.C. (MAX.) @ LOCATION OF TILE: SPACING SHALL NOT
  - EXCEED 16" O.C. (MAX.)

#### LATERAL/WALL BRACING & WALL SHEATHING SPECIFICATIONS

THIS MODEL HAS BEEN DESIGNED TO RESIST LATERAL FORCES RESULTING FROM:

## MPH WIND IN 2018 NCSBC:RC

(115 MPH WIND SPEED IN ASCE 7-10 WIND MAP, PER IRC R301,2.1.1) EXP. B, RISK CAT. 2 & SEISMIC CAT. A/B.

THE DESIGN WAS COMPLETED PER 2015 IBC (SECTION 1609) & ASCE 7-10, AS PERMITTED BY R301,1,3 OF THE 2018 NCSBC:RC, ACCORDINGLY, THIS MODEL, AS DOCUMENTED AND DETAILED HEREWITHIN, IS ADEQUATE TO RESIST THE CODE REQUIRED LATERAL FORCES.

DESIGN WIND UPLIET LOADS HAVE BEEN CALCULATED UTILIZING ASCE 7-10 (ACCEPTED ENGINEERING PRACTICE) AS ALLOWED PER 2018 NCSBC:RC SECTION R802.II.I.I. THIS MODEL HAS BEEN DETAILED WHERE REQUIRED & ENGINEERED TO RESIST THE WIND UPLIFT LOAD PATH PER SECTIONS R60235& R80211

#### EXT. WALL SHEATHING SPECIFICATION

- 7/16" OSB OR 15/32" PLYWOOD: FASTEN SHEATHING W/ 2 3 XO.II3 NAILS @ 6" O.C. AT EDGES & @ 12" O.C. IN THE PANEL FIELD. (TYP, U.N.O.) ALL SHEATHING PANELS SHALL BE ORIENTED
- VERTICALLY (LONG DIRECTION PARALLEL TO STUDS) AND INSTALLED FULL HEIGHT OF SHEAR WALL OR -2x HORIZONTAL BLOCKING SHALL BE PROVIDED TO SUPPORT ALL UNSUPPORTED PANEL EDGES & EDGE
- ALL EXT. WALLS SHALL BE CONTINUOUSLY SHEATHED AND ARE CONSIDERED SHEAR WALLS.
- ALT. STAPLE CONNECTION SPEC: 1 3/4" 16 GA STAPLES (1/6" CROWN) @ 3" O.C. AT EDGES \$ @ 6" O.C IN FIELD.


#### 3" O.C. EDGE NAILING

AT DESIGNATED AREAS - FASTEN PANEL EDGES OF WOOD STRUCTURAL WALL SHEATHING TO FRAMING W 2 3" x 0.113" NAILS @ 3" O.C. AND 12" O.C. IN THE PANEL FIELD NO STAPLE ALTERNATIVE AVAILABLE AT THIS SPEC. ALL SHEATHING PANELS SHALL BE ORIENTED VERTICALLY (LONG DIRECTION PARALLEL TO STUD) AND INSTALLED FULL HEIGHT OF SHEAR WALL - OR - 2x HORIZONTAL BLOCKING SHALL BE PROVIDED TO SUPPORT UNSUPPORTED PANEL EDGES AND 3" O.C. EDGE FASTENING.

#### TYP. UNIT SEPARATION WALL SHEATHING SPECIFICATION

•1/2" OR 5/8" GYPSUM WALL BOARD: FASTEN GWB SHEATHING TO FRAMING W/ I \$"X0.086" COOLER NAILS OR I 1/4" DRYWALL SCREWS @ 7" O.C. T PANEL EDGES & PANEL FIELD (INCLUDING T&B PLATES

- SEE CONNECTION SPECIFICATIONS CHART FOR STANDARD SHEAR TRANSFER DETAILING. IF ADDITIONAL CAPACITY IS REQUIRED BY DESIGN. WILL BE SPECIFICALLY NOTED ON PLAN.
- DESIGN ASSUMES 16" O.C MAX. STUD SPACING, U.N.O.
- · ALL STRUCTURAL PANELS ARE TO BE DIRECTLY APPLIED TO STUD FRAMING.
- PRE-MANUFACTURED PANELIZED WALLS: FASTEN TOGETHER END STUDS OF WALL PANELS SHEATHED W/ OSB OR PLYWOOD W/ 3" x 0,120" NAILS @ 4" O.C. (THRU ONE SIDE ONLY)

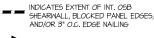

INDICATES HOLDOWN

MULHERN+KULP RESIDENTIAL STRUCTURAL ENGINEERING arkwey, Seite 250 ►. -mulbernkeip.com



lulhern+Kulp project number

243-2403

SMI NGC ssue date: 08-16-2024

REVISIONS

initial: 1-07-202 SMM 1-14-2025 ARCH UPDATE 06-05-2025 . IPP


pointe HOMES

NOTES MOD

90-SERENITY MASTER SET RALEIGH, NC 5920-

GENERAL

**S0.0** 

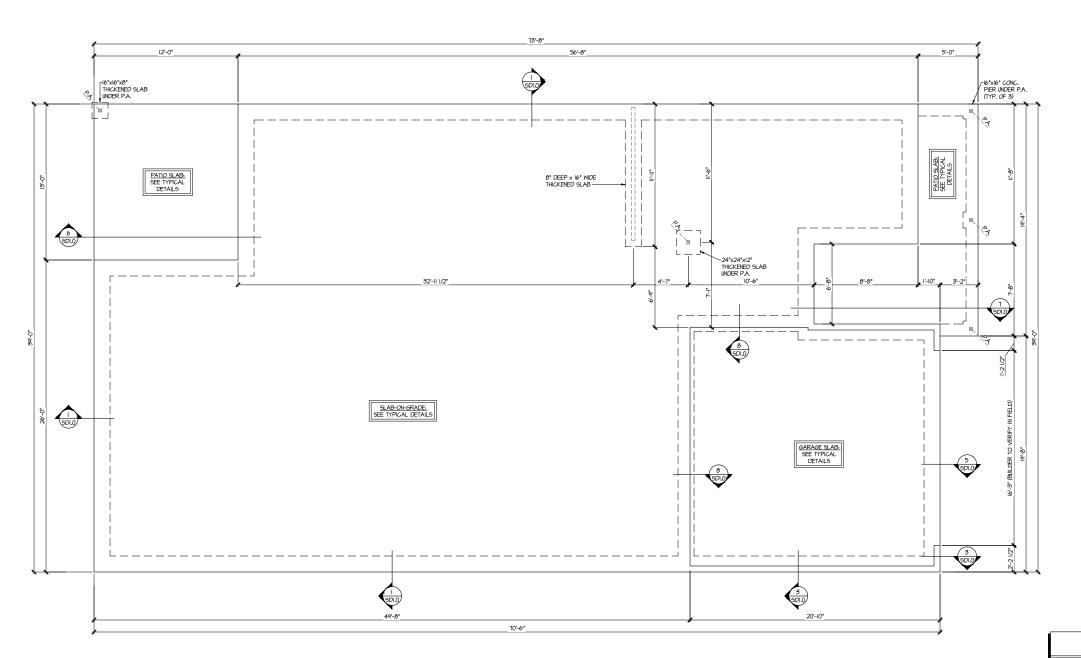

SLAB FOUNDATION PLAN

SCALE: 1/4"=1"-0" (22x24 SHEET)
1/6"=1"-0" (11x17 SHEET) ELEV. A LEGEND

- INTERIOR BEARING WALL
- ==== BEARING WALL ABOVE (B.W.A.)
- --- BEAM / HEADER
- INDICATES EXTENT OF INT.

  OSB SHEARWALL AND/OR
  3" O.C. EDGE NAILING
- EXTENT OF VALLEY TRUGS OVERFRAMING
  24" O.C. (MAX.)
- EXTENT OF FLOOR SYSTEM TO BE DESIGNED FOR TILE
- NDICATES HOLDOWN
- \* INDICATES POST ABOVE. PROVIDE SOLID BLOCKING UNDER POST OR JAMB ABOVE.

REFER TO SO.O FOR TYPICAL STRUCTURAL NOTES # SCHEDULES

MULHERN+KULP
RESIBENTIAL STRUCTURAL ENGINEERING
3005 Broliside Parkway, Saire 250 - Aphaerin, 9A, 2002
9.770-777-6974 - malformicajacom
NC Licence # C-30.25

Mulhern+Kulp project number:

243-24032 SMK NGG

issue date: 08-16-2024 REVISIONS: initial: SMM

Udite.

11-07-2024
ARCH UPDATE

01-14-2025
ARCH UPDATE


06-05-2025
ARCH UPDATE SMM JPP

tri pointe

FOUNDATION PLAN

5920-06 MODEL SERENITY MASTER SET RALEIGH, NC

**S1.0** 

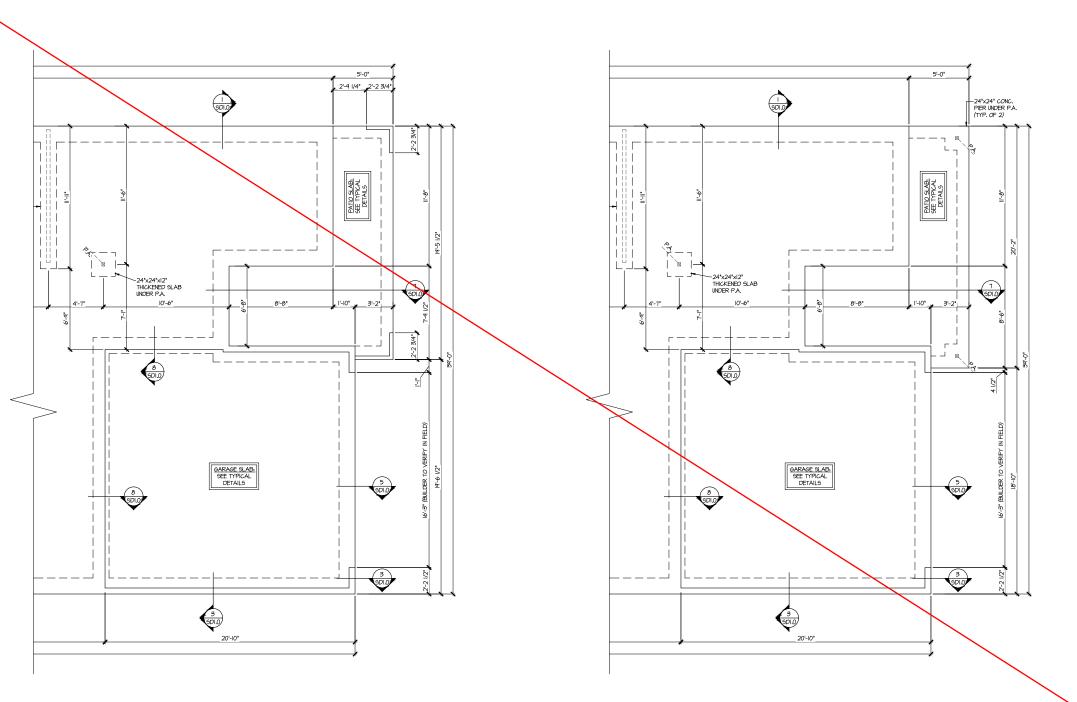

PARTIAL SLAB FOUNDATION PLAN

ELEV. B SEE ELEV. A FOR MORE INFO

SCALE: |/4"=|'-0" (22x24 SHEET) |/8"=|'-0" (||x|7 SHEET)

PARTIAL SLAB FOUNDATION PLAN SCALE: 1/4"=1'-0" (22x24 SHEET) 1/8"=1'-0" (1|x|T SHEET) ELEV. C SEE ELEV. A FOR MORE INFO

> REFER TO SO.O FOR TYPICAL STRUCTURAL NOTES # SCHEDULES

#### LEGEND

- INTERIOR BEARING WALL
- ==== BEARING WALL ABOVE (B.W.A.)
- BEAM / HEADER
- INDICATES EXTENT OF INT.

  OSB SHEARWALL AND/OR
  3" O.C. EDGE NAILING
- EXTENT OF VALLEY TRUSS OVERFRAMING
- EXTENT OF FLOOR SYSTEM TO BE DESIGNED FOR TILE
- NDICATES HOLDOWN
- JL METAL HANGER
- \* INDICATES POST ABOVE. PROVIDE SOLID BLOCKING UNDER POST OR JAMB ABOVE.

FOUNDATION PLAN 5920-06 MODEL

SERENITY MASTER SET RALEIGH, NC

MULHERN+KULP

RESIDENTIAL STRUCTURAL ENGINEERING
3005 Broiside Parkway, Saire 250 - Aphaenta, GA 30022
p.778-777-6974 - medhamicupcom
NC License # C-3925

Mulhern+Kulp project number:

REVISIONS:

UALE: 11-07-2024 ARCH UPDATE 01-14-2025 ARCH UPDATE 06-05-2025 ARCH UPDATE

243-24032

issue date: 08-16-2024

tri pointe

SMK NGG

initial:

SMM SMM JPP

**S1.1** 



MULHERN+KULP

RESIDENTIAL STRUCTURAL ENGINEERING

3865 Projector Parkvay, Sales 250 - Aphaema, 9A, 3002

p.776-777-9974 - mediamicajacam

NC. Licence # C-3925



Mulhern+Kulp project number:

243-24032

SMK NGG issue date: 08-16-2024

REVISIONS: II-07-2024 ARCH UPDATE 01-14-2025 ARCH UPDATE 06-05-2025 ARCH UPDATE SMM SMM JPP

tri pointe

THIS LEVEL HAS BEEN DESIGNED FOR 9'-I" PLATE HEIGHT

- IIIII INTERIOR BEARING WALL
- ==== BEARING WALL ABOVE (B.W.A.)
- INDICATES EXTENT OF INT.

  OSB SHEARWALL AND/OR
  3" O.C. EDGE NAILING
- EXTENT OF VALLEY TRUSS OVERFRAMING
  24" O.C. (MAX.)
- EXTENT OF FLOOR SYSTEM TO BE DESIGNED FOR TILE
- NDICATES HOLDOWN
- | INDICATES POST ABOVE. PROVIDE SOLID BLOCKING UNDER POST OR JAMB ABOVE.

REFER TO SO.O FOR TYPICAL STRUCTURAL NOTES # SCHEDULES


LEGEND

ROOF FRAMING PLAN

5920-06 MODEI


**S2.0** 

SERENITY MASTER SET RALEIGH, NC

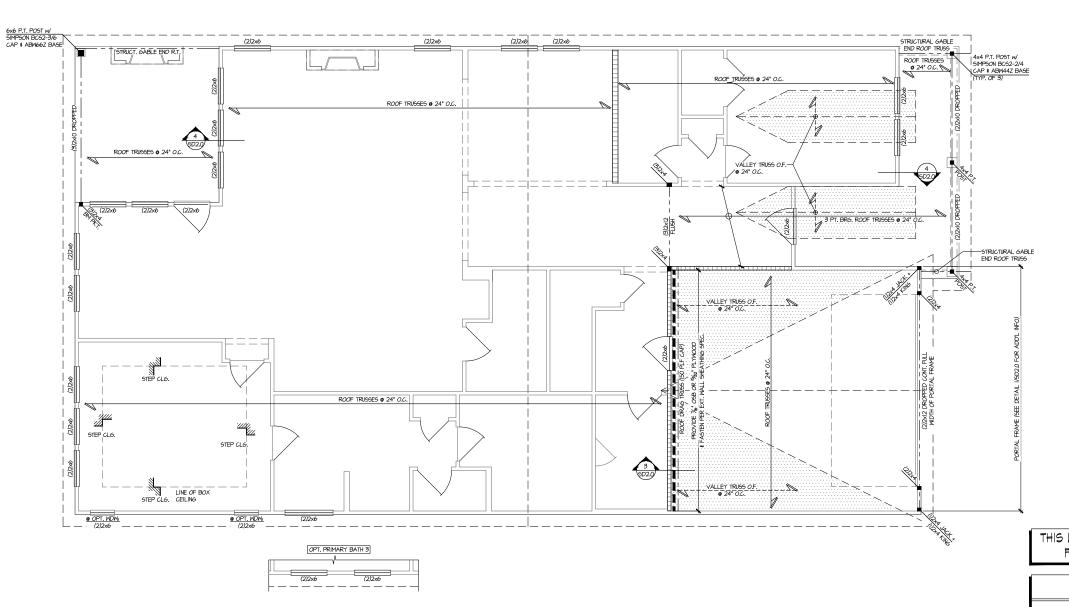

ROOF FRAMING PLAN SCALE: 1/4"=1'-0" (22x24 SHEET) 1/8"=1'-0" (11x17 SHEET)

ELEV. A

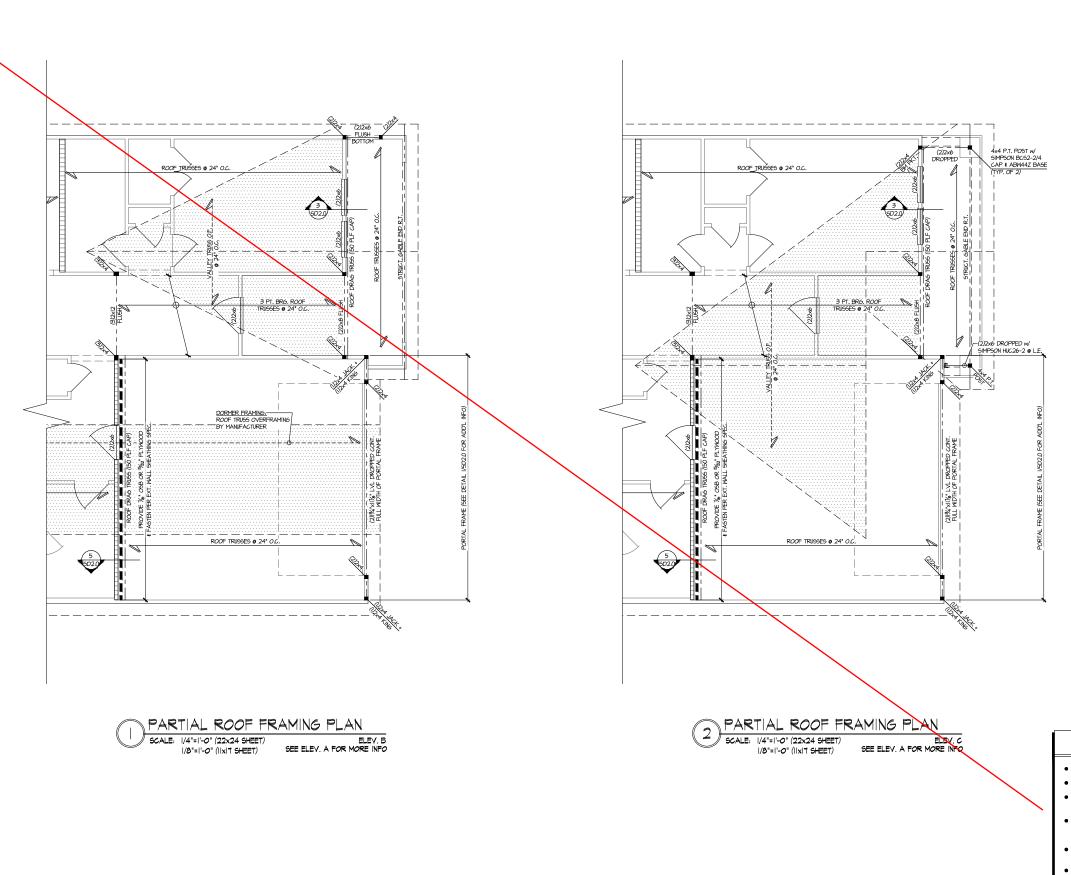

MULHERN+KULP

RESIDENTIAL STRUCTURAL ENGINEERING
3005 Broiside Parkway, Saire 250 - Aphaenta, GA 30022
p.778-777-6974 - medhamicupcom
NC License # C-3925

Mulhern+Kulp project number:

243-24032

SMK NGG issue date: 08-16-2024

REVISIONS: initial: II-07-2024 ARCH UPDATE 01-14-2025 ARCH UPDATE 06-05-2025 ARCH UPDATE SMM SMM JPP

tri pointe

5920-06 MODEI SERENITY MASTER SET RALEIGH, NC

ROOF FRAMING PLAN

**S2.1** 

LEGEND

INTERIOR BEARING WALL • ==== BEARING WALL ABOVE (B.W.A.)

BEAM / HEADER

INDICATES EXTENT OF INT.

OSB SHEARWALL AND/OR
3" O.C. EDGE NAILING

EXTENT OF VALLEY TRUSS OVERFRAMING • 24" O.C. (MAX.)

EXTENT OF FLOOR SYSTEM TO BE DESIGNED FOR TILE

NDICATES HOLDOWN

REFER TO SO.O FOR

TYPICAL STRUCTURAL NOTES


# SCHEDULES

THIS LEVEL HAS BEEN DESIGNED

FOR 9'-1" PLATE HEIGHT

JL METAL HANGER

\* INDICATES POST ABOVE. PROVIDE SOLID BLOCKING UNDER POST OR JAMB ABOVE.

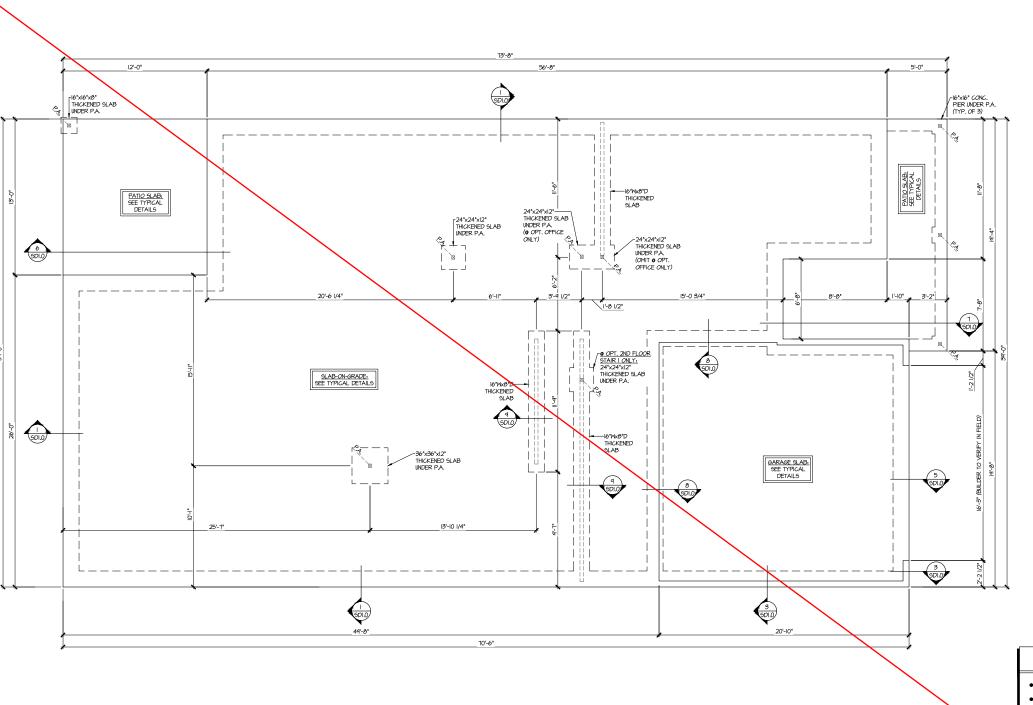

OPT. 2ND FLOOR SLAB FOUNDATION PLAN

| SCALE: |/4"=|'-0" (22x24 SHEET) |/8"=|'-0" (||x|7 SHEET)

ELEV. A

MULHERN+KULP
RESIBENTIAL STRUCTURAL ENGINEERING
3005 Broliside Parkway, Saire 250 - Aphaerin, 9A, 2002
9.770-777-6974 - malformicajacom
NC Licence # C-39.25

Mulhern+Kulp project number:

243-24032

SMK NGG issue date: 08-16-2024

REVISIONS: initial: UALE: 11-07-2024 ARCH UPDATE 01-14-2025 ARCH UPDATE 06-05-2025 ARCH UPDATE SMM SMM JPP

tri pointe

STRUCTURAL OPTIONS

5920-06 MODEI SERENITY MASTER SET RALEIGH, NC

**S3.0** 

LEGEND

• IIIIII INTERIOR BEARING WALL

• ==== BEARING WALL ABOVE (B.W.A.)

BEAM / HEADER

INDICATES EXTENT OF INT.

OSB SHEARWALL AND/OR
3" O.C. EDGE NAILING


EXTENT OF VALLEY TRUSS OVERFRAMING

EXTENT OF FLOOR SYSTEM TO BE DESIGNED FOR TILE

NDICATES HOLDOWN

HINDICATES POST ABOVE. PROVIDE SOLID BLOCKING UNDER POST OR JAMB ABOVE.

REFER TO SO.O FOR TYPICAL STRUCTURAL NOTES # SCHEDULES

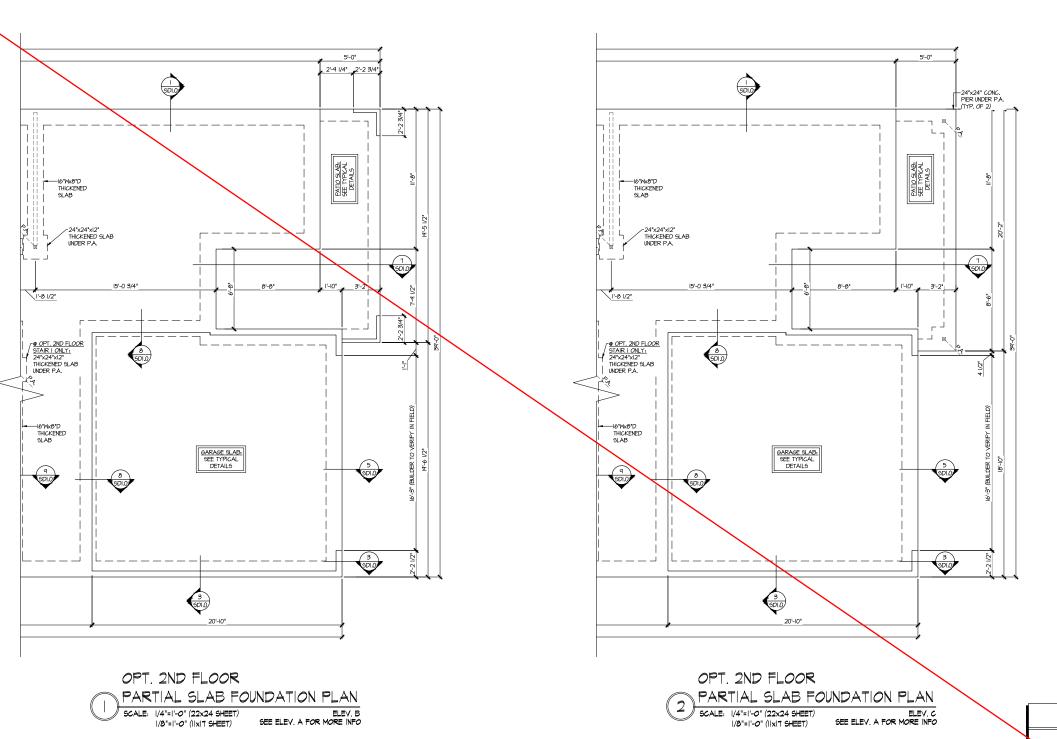

REFER TO SO.O FOR TYPICAL STRUCTURAL NOTES # SCHEDULES

#### LEGEND

- INTERIOR BEARING WALL
- ==== BEARING WALL ABOVE (B.W.A.)
- ---- BEAM / HEADER
- INDICATES EXTENT OF INT.

  OSB SHEARWALL AND/OR

  3" O.C. EDGE NAILING
- EXTENT OF VALLEY TRUSS OVERFRAMING

  2 24" O.C. (MAX.)
- EXTENT OF FLOOR SYSTEM TO BE DESIGNED FOR TILE
- NDICATES HOLDOWN
- JL METAL HANGER
- \* INDICATES POST ABOVE. PROVIDE SOLID BLOCKING UNDER POST OR JAMB ABOVE.

MULHERN+KULP
RESIBENTIAL STRUCTURAL ENGINEERING
3005 Broliside Parkway, Saire 250 - Aphaerin, 9A, 2002
9.770-777-6974 - malformicajacom
NC Licence # C-39.25



Mulhern+Kulp project number:

243-24032

SMK NGG issue date: 08-16-2024


REVISIONS: initial: UALE: 11-07-2024 ARCH UPDATE 01-14-2025 ARCH UPDATE 06-05-2025 ARCH UPDATE SMM SMM JPP

tri pointe

STRUCTURAL OPTIONS 5920-06 MODEL

SERENITY MASTER SET RALEIGH, NC

**S3.1** 

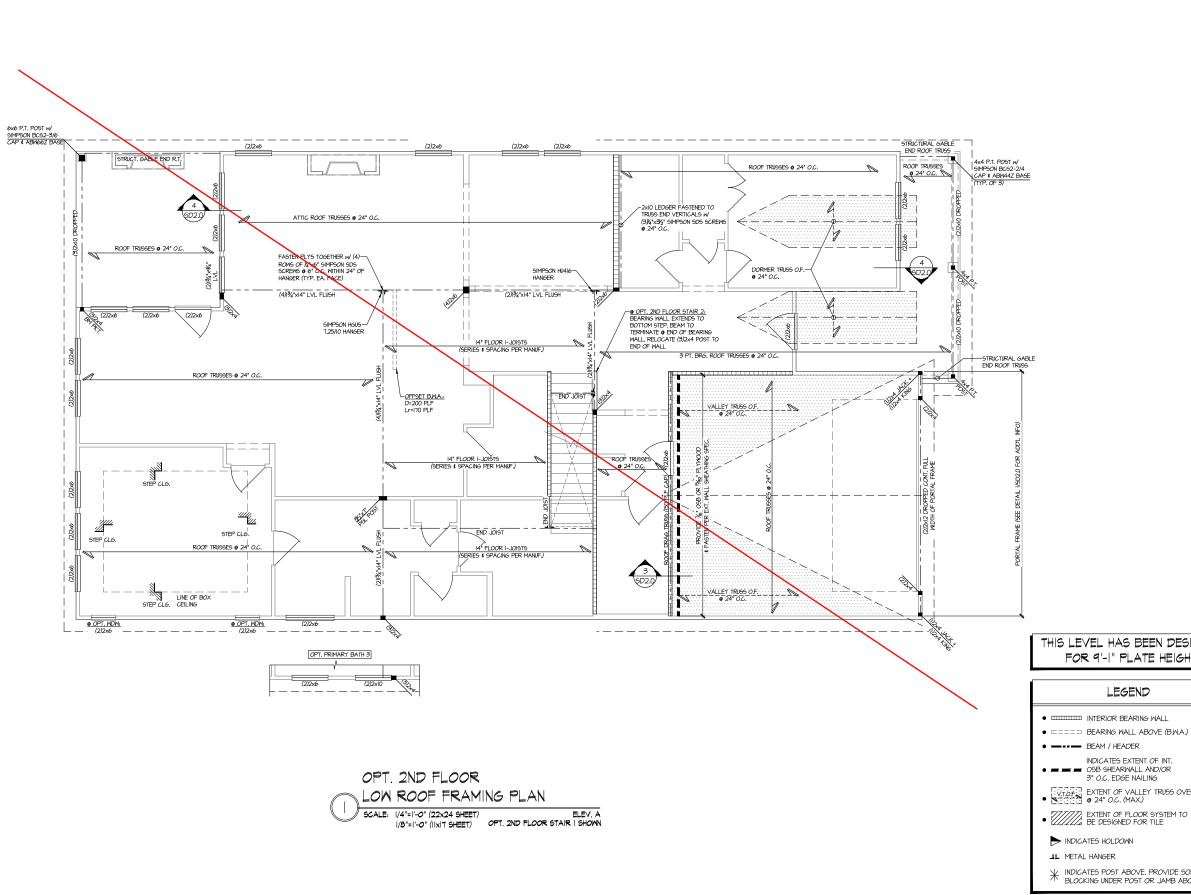

MULHERN+KULP
RESIBENTIAL STRUCTURAL ENGINEERING
3005 Broliside Parkway, Saire 250 - Aphaerin, 9A, 2002
9.770-777-6974 - malformicajacom
NC Licence # C-39.25



Mulhern+Kulp project number:

243-24032

SMK NGG issue date: 08-16-2024

REVISIONS: II-07-2024 ARCH UPDATE 01-14-2025 ARCH UPDATE 06-05-2025 ARCH UPDATE SMM SMM JPP

tri pointe

THIS LEVEL HAS BEEN DESIGNED FOR 9'-1" PLATE HEIGHT

#### LEGEND

- IIIII INTERIOR BEARING WALL
- ==== BEARING WALL ABOVE (B.W.A.)
- INDICATES EXTENT OF INT.

  OSB SHEARWALL AND/OR
  3" O.C. EDGE NAILING
- EXTENT OF VALLEY TRUSS OVERFRAMING
  24" O.C. (MAX.)

- | INDICATES POST ABOVE. PROVIDE SOLID BLOCKING UNDER POST OR JAMB ABOVE.


REFER TO SO.O FOR TYPICAL STRUCTURAL NOTES \$ SCHEDULES

STRUCTURAL OPTIONS

**S3.2** 

5920-06 MODEI

SERENITY MASTER SET RALEIGH, NC

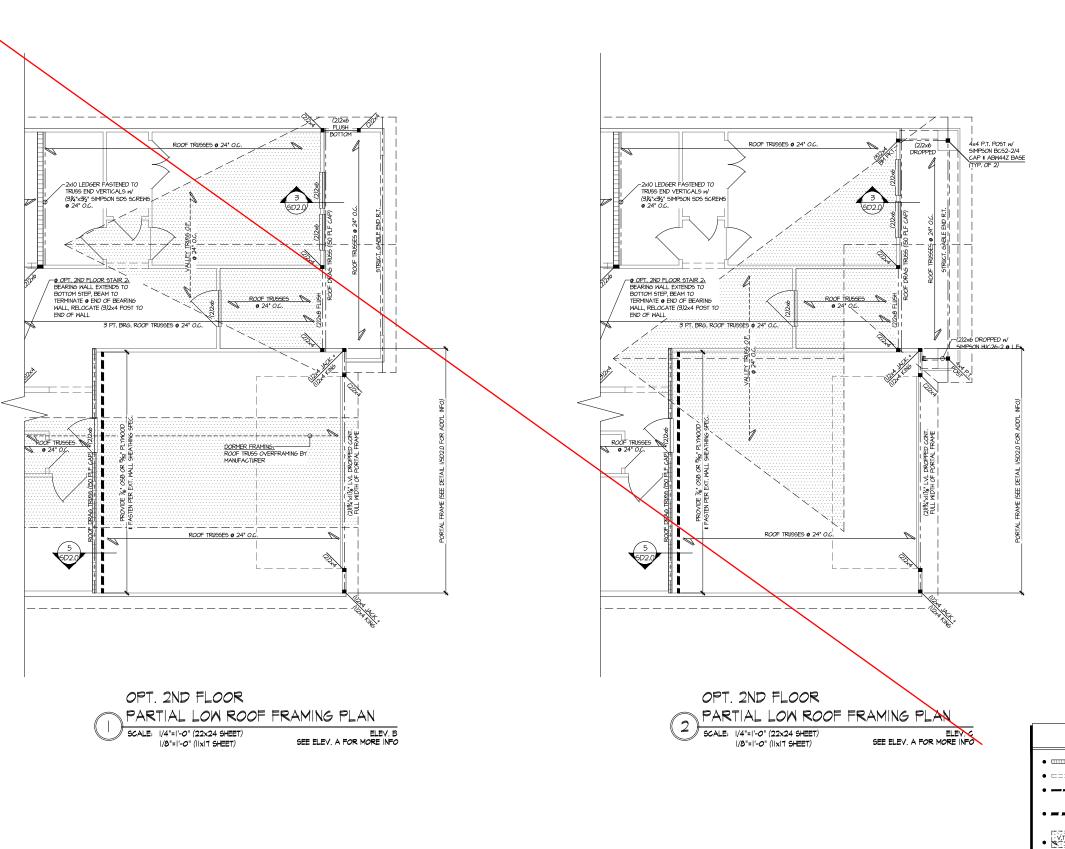

• IIIIII INTERIOR BEARING WALL

□□□□□ BEARING WALL ABOVE (B.W.A.)

BEAM / HEADER

EXTENT OF VALLEY TRUSS OVERFRAMING

• 24" O.C. (MAX.)

EXTENT OF FLOOR SYSTEM TO BE DESIGNED FOR TILE

NDICATES HOLDOWN

REFER TO SO.O FOR TYPICAL STRUCTURAL NOTES

# SCHEDULES

THIS LEVEL HAS BEEN DESIGNED

FOR 9'-1" PLATE HEIGHT

| INDICATES POST ABOVE. PROVIDE SOLID BLOCKING UNDER POST OR JAMB ABOVE.

LEGEND

INDICATES EXTENT OF INT.

OSB SHEARWALL AND/OR
3" O.C. EDGE NAILING

**S3.3** 

Mulhern+Kulp project number: 243-24032 SMK NGG issue date: 08-16-2024 REVISIONS: II-07-2024 ARCH UPDATE 01-14-2025 ARCH UPDATE 06-05-2025 ARCH UPDATE SMM SMM JPP

tri pointe

MULHERN+KULP
RESIDENTIAL STRUCTURAL ENGINEERING
3855 Broiside Parkvay, Suite 250 - Authoreto, 9A 2002
p.776-777-6974 - maufomicajocom
NC. Licence # C-3625

STRUCTURAL OPTIONS

5920-06 MODEI

SERENITY MASTER SET RALEIGH, NC



MULHERN+KULP

RESIDENTIAL STRUCTURAL ENSINEERING
3005 Broiside Parkvay, Saire 250 - Aphaenta, 6A 2002
p.776-777-4974 - medhamicalpacam
NC License # C-2825



Mulhern+Kulp project number:

243-24032

SMK drawn by: NGC issue date: 08-16-2024

REVISIONS: Udite.

11-07-2024
ARCH UPDATE

01-14-2025
ARCH UPDATE

06-05-2025
ARCH UPDATE SMM SMM JPP

tri pointe

THIS LEVEL HAS BEEN DESIGNED FOR 9'-I" PLATE HEIGHT

## LEGEND

- IIIIII INTERIOR BEARING WALL
- ==== BEARING WALL ABOVE (B.W.A.)
- EXTENT OF FLOOR SYSTEM TO BE DESIGNED FOR TILE
- NDICATES HOLDOWN

TYPICAL STRUCTURAL NOTES # SCHEDULES

INDICATES EXTENT OF INT.

OSB SHEARWALL AND/OR
3" O.C. EDGE NAILING

EXTENT OF VALLEY TRUSS OVERFRAMING
24" O.C. (MAX.)

| INDICATES POST ABOVE. PROVIDE SOLID BLOCKING UNDER POST OR JAMB ABOVE.


REFER TO SO.O FOR

STRUCTURAL OPTIONS

**S3.4** 

5920-06 MODEL


SERENITY MASTER SET RALEIGH, NC

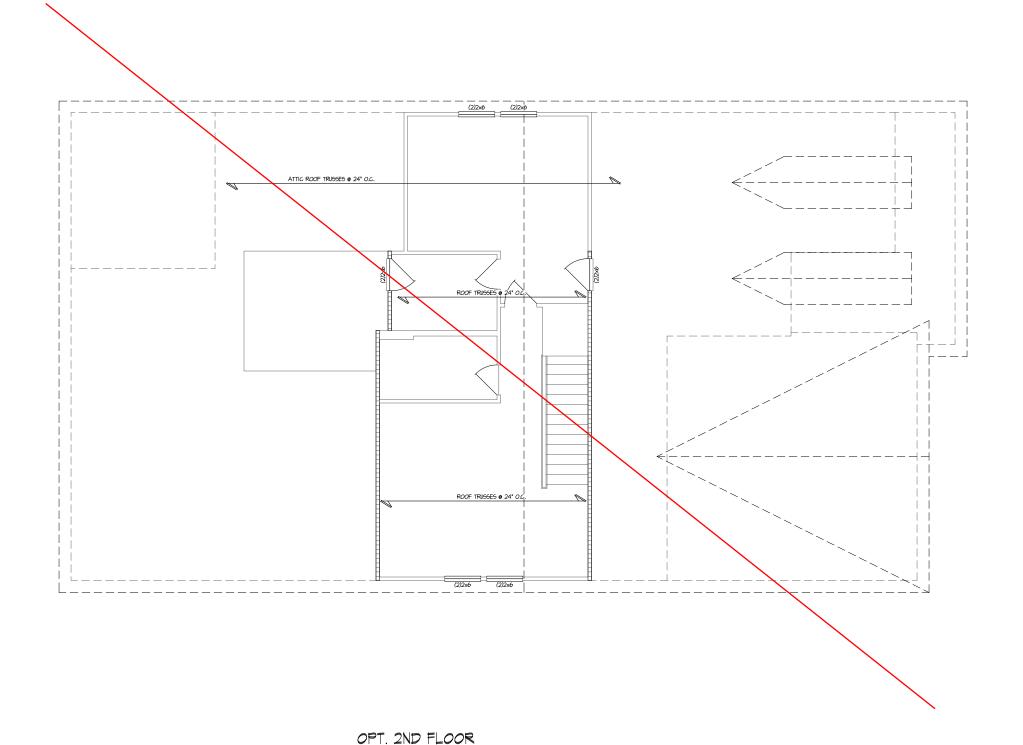



HIGH ROOF FRAMING PLAN

ELEV. A ALL ELEV. SIM.

SCALE: 1/4"=1'-0" (22x24 SHEET) 1/8"=1'-0" (11x17 SHEET)

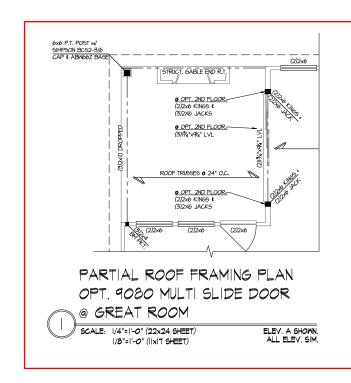

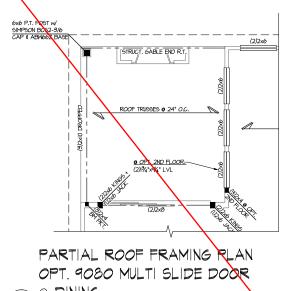

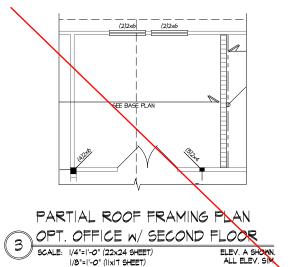

1/8"=1'-0" (IIxIT SHEET)

@ DINING

SCALE: I/4"=1'-0" (22x24 SHEET)
I/8"=1'-0" (IIxIT SHEET)

ELEV. A SHOWN. ALL ELEV. SM.

II-07-2024 ARCH UPDATE 01-14-2025 ARCH UPDATE 06-05-2025

tri pointe

Mulhern+Kulp project number:

REVISIONS:

243-24032

issue date: 08-16-2024

SMK

NGG

initial:

SMM SMM

JPP

MULHERN+KULP

RESIDENTIAL STRUCTURAL ENGINEERING

3005 Broiside Parkway, Saire 250 - Aptaenta, 6A 30022

p.778-777-6974 - mulbemicapecom

NC. Licence # C-36225

THIS LEVEL HAS BEEN DESIGNED FOR 9'-I" PLATE HEIGHT

#### LEGEND

- IIIIII INTERIOR BEARING WALL
- □□□□□ BEARING WALL ABOVE (B.W.A.)
- BEAM / HEADER
- INDICATES EXTENT OF INT.

  OSB SHEARWALL AND/OR
  3" O.C. EDGE NAILING
- EXTENT OF VALLEY TRUSS OVERFRAMING
  24" O.C. (MAX.)
- EXTENT OF FLOOR SYSTEM TO BE DESIGNED FOR TILE
- NDICATES HOLDOWN
- | INDICATES POST ABOVE. PROVIDE SOLID | BLOCKING UNDER POST OR JAMB ABOVE.

REFER TO SO.O FOR TYPICAL STRUCTURAL NOTES & SCHEDULES

STRUCTURAL OPTIONS

5920-06 MODEI SERENITY MASTER SET RALEIGH, NC

SO1.0

MULHERN+KULP
RESIBENTIAL STRUCTURAL ENGINEERING
3005 Broliside Parkway, Saire 250 - Aphaerin, 9A, 2002
9.770-777-6974 - malformicajacom
NC Licence # C-39.25



Mulhern+Kulp project number:

243-24032 SMK

NGG issue date: 08-16-2024

REVISIONS: initial: 11-07-2024 ARCH UPDATE 01-14-2025 SMM SMM ARCH UPDATE 06-05-2025 JPP

tri pointe

THIS LEVEL HAS BEEN DESIGNED FOR 9'-1" PLATE HEIGHT


#### LEGEND


- IIIIII INTERIOR BEARING WALL
- □□□□□ BEARING WALL ABOVE (B.W.A.)
- — BEAM / HEADER
- INDICATES EXTENT OF INT.

  OSB SHEARWALL AND/OR
  3" O.C. EDGE NAILING
- EXTENT OF VALLEY TRUSS OVERFRAMING
  24" O.C. (MAX.)
- EXTENT OF FLOOR SYSTEM TO BE DESIGNED FOR TILE
- ► INDICATES HOLDOWN

- | INDICATES POST ABOVE. PROVIDE SOLID | BLOCKING UNDER POST OR JAMB ABOVE.

REFER TO SO.O FOR TYPICAL STRUCTURAL NOTES \$ SCHEDULES

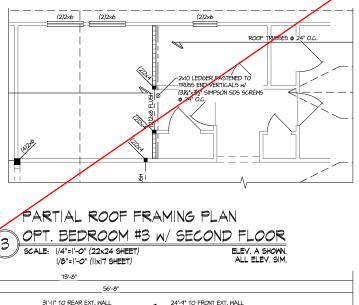

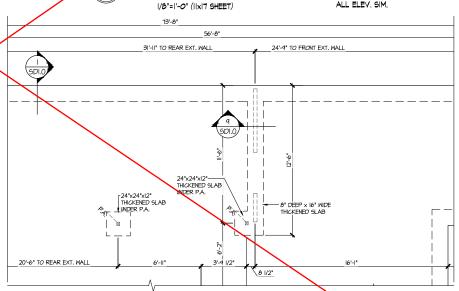

OPT. BEDROOM #3 W/ SECOND FLOOR

1/8"=1'-0" (11x17 SHEET)

SCALE: 1/4"=1'-0" (22x24 SHEET)

ROOF TRUSSES @ 24

OPT. BEDROOM #3

1/8"=1'-0" (IIxI7 SHEET)

56'-8"

PDI.0

PARTIAL SLAB FOUNDATION PLAN

8" DEEP x 16" WIDE THICKENED SLAB —

OPT. BEDROOM #3

1/8"=1'-0" (IIxI7 SHEET)

SCALE: 1/4"=1'-0" (22x24 SHEET)

SCALE: 1/4"=1'-0" (22x24 SHEET)

\_31'-11" TO REAR EXT. WALL

SDI.0

31'-II" TO REAR EXT. WALL

PARTIAL ROOF FRAMING PLAN

ELEY, A SHOWN, ALL ELEY, SIM,

-24"x24"x12" THICKENED SLAB UNDER P.A.

ELEV. A SHOWN. ALL ELEV. SIM.


\_\_\_\_24'-9" TO FRONT EXT. WALL

PARTIAL SLAB FOUNDATION PLAN ELEV. A SHOWN. ALL ELEV. SIM.

STRUCTURAL OPTIONS 5920-06 MODEI

SERENITY MASTER SET RALEIGH, NC

SO1.1

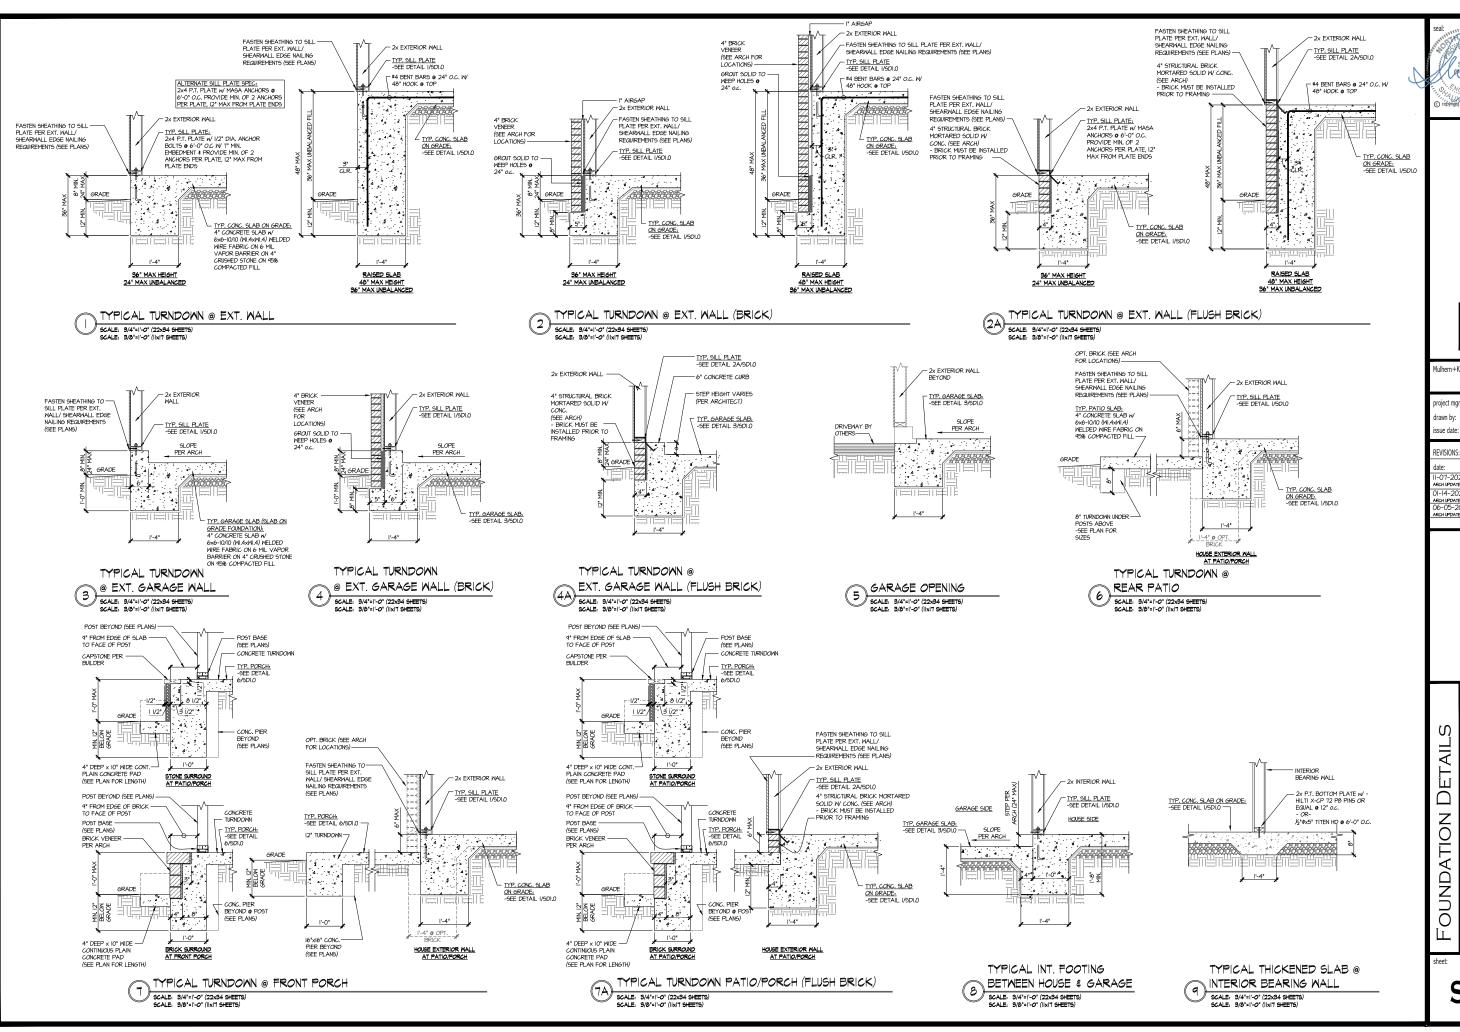

SEAL SEAL STATE OF THE STATE OF

MULHERN+KULP RESIDENTIAL STRUCTURAL ENGINEERING WEST BROOKS STRUCTURE OF A STRUCTURE OF STRUCTUR

**y** 

Mulhern+Kulp project number: 243-2403

project mgr: SMH drawn by: NGC issue date: 08-16-2024

REVISIONS:


date: initial:
II-07-2024 SMM
ARCH UPDATE
OI-14-2025 SMM
ARCH UPDATE
O6-05-2025 JPP

IT pointe


FOUNDATION DETAIL 5920-06 MODEL

SERENITY
MASTER SET
RALEIGH, NC


SD1.0

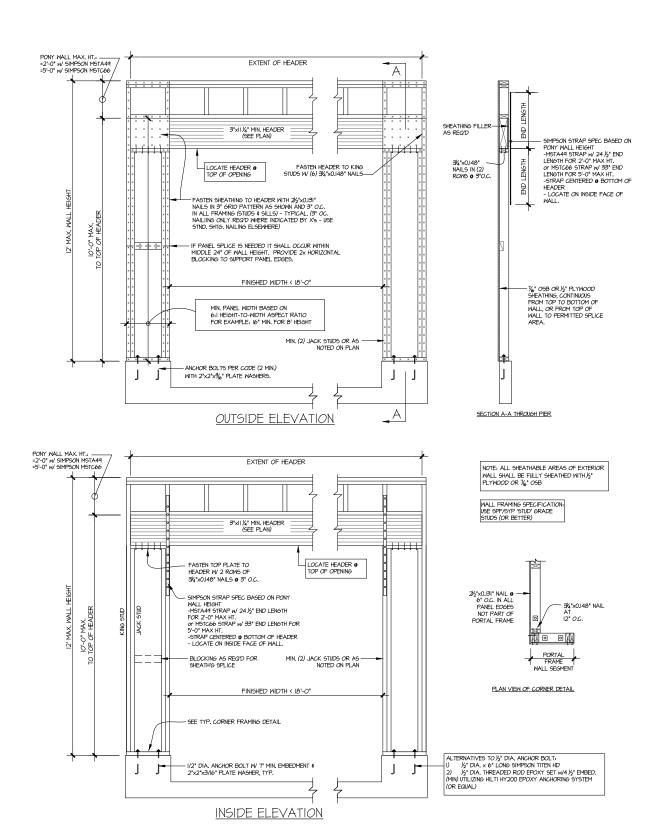


GARAGE PORTAL FRAME BRACING ELEVATION BOTH SIDES OF GARAGE DOOR 115 MPH WIND SPEED (ULT) SCALE: N.T.S.

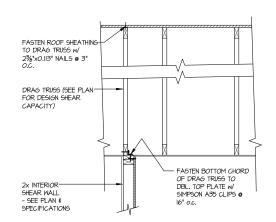


## INTERIOR DRAG TRUSS DETAIL

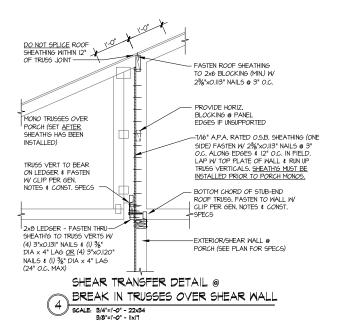

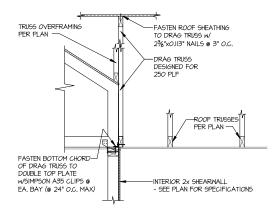

## SHEAR TRANSFER DETAIL AT SHEARWALL BELOW

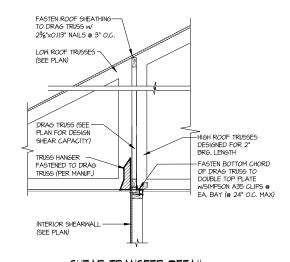

SHEAR TRANSFER DETAIL 5 AT INTERIOR SHEARWALL BELOW 5 SCALE: 9/4':1'-0'



MULHERN+KULP
RESIDENTIAL STRUCTURAL ENGINEERING
3855 Brootside Parkwey, Suite 250 - Aghareta, 9A 30022
p.770-777-0074 - malbroside porm
NC License # C-3025

Aulhern+Kulp project number

243-2403

SMK frawn by: NGC issue date: 08-16-2024


REVISIONS: initial: SMM 01-14-2025 SMM ARCH UPDATE 06-05-2025 JPP


pointe HOMES

Ŋ DETAIL MODE FRAMING 5920-06


SERENITY MASTER SET RALEIGH, NC

**SD2.0** 

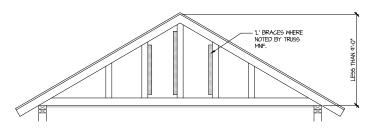

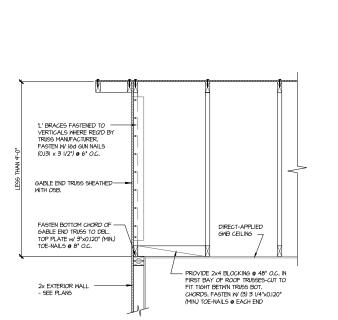

TYPICAL GABLE END BRACING DETAIL SCALE: NOME REQUIRED TRUSS REQ'D @ GABLE END TRUSS HEIGHT UP TO 9'-0' BRACE GABLE END TRUSSES PER ABOVE DETAIL WHEN GABLE HEIGHT IS LESS THAN 9"-0". "L" BRACES REQUIRED WHERE NOTED BY TRUSS MANUFACTURER.

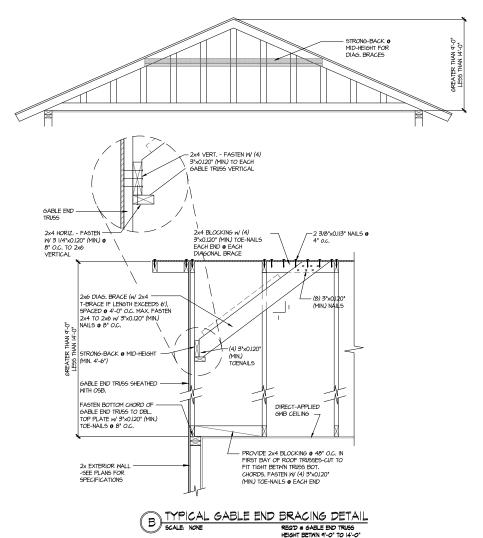

BRACE GABLE END TRUSSES PER ABOVE DETAIL WHEN GABLE HEIGHT EXCEEDS 9'-0'. "L' BRACES NOT REQUIRED.

MULHERN+KULP

RESIDENTIAL STRUCTURAL ENGINEERING

3005 Broiside Parkway, Sale 250 - Alphaenta, 6A 2002

p.770-777-6074 - markemizipicom

NC Licence # C-38.25

Mulhern+Kulp project number:

243-24032

SMK drawn by: NGG issue date: 08-16-2024

REVISIONS: initial: II-07-2024 ARCH UPDATE 01-14-2025 ARCH UPDATE 06-05-2025 ARCH UPDATE SMM SMM JPP

tri pointe

FRAMING DETAILS 5920-06 MODEL

SERENITY MASTER SET RALEIGH, NC

**SD2.1**