FOXTAIL MANOR ABBREVIATIONS A A PRESSURE TREATED WD H.R. HALF ROUN HWD HARDWOOD (FL R&M RANGE W/MICROWAY LIV LIVING LTL LINTEL LVR LOUVER MAX MAXIMUM DRY DRYER MACHINE TEMP TEMPERED (GLASS U.N.O. UNLLGG OTHERWISE OA OVERALL F.F. FINISH FLOOR (LINE OBS OBSCURE (GLA WH WATER HEATER FLR FLOOR(ING FP FIREPLACE OPT OPTIONAL WIC WALK-IN CLOSE FURRED(ING) PEDESTAL (SINK) W/ W/O WITH or WITHOUT ROHND FAIL TERPROOF(ING) CIRCUIT INTERRU **GENERAL NOTES** 1 - GENERAL BUILDING & DESIGN REQUIREMENTS 15 - MECHANICALS 1) THE ATTACHED PLANS & SPECIFICATIONS ARE THE SOLE PROPERTY OF TRI POINTE HOMES ANY UNAUTHORIZED USE OF THESE PLANS WITHOUT PRIOR WRITTEN CONSENT OF TRI POINTE HOMES IS STRICTLY) EXTERIOR AIR INTAKE FOR COMBUSTION AIR PER IRC SECTION AS REQUIRED BY LOCAL MUNICIPALITY 2) TRI POINTE HOMES DESIGNS & BUILDS HOUSING AS SET FORTH BY THE FORMAT AND PROVISIONS OF TH INTERNATIONAL RESIDENTIAL CODE (IRC), AND THE NATIONAL ELECTRIC CODE (NEC). ANY NON-CONFORMING DOCUMENTS DISCOVERED BY THE CONTRACTOR OR HIS AGENTS SHALL BE CALLED TO THE IMMEDIATE ATTENTION OF TRI POINTE HOMES BY CALLING (469)329-0470.). THESE PLANS ARE SUBJECT TO MODIFICATIONS TO MEET CODE REQUIREMENTS AND/OR TO FACILITATE MECHANICAL/ ELECTRICAL/ PLUMBING INSTALLATION AND/ OR TO IMPLEMENT DESIGN IMPROVEMENTS. ANY ABORATORIES, INC. INTENTION TO MODIFY THESE PLANS MUST BE APPROVED IN WRITING BY TRI POINTE HOMES 4) CONTRACTOR SHALL BE RESPONSIBLE FOR VERIFYING ALL DIMENSIONS AFFECTING CONTRACTOR'S

WOOD BUILT CHIMNEYS AND FIREPLACES SHALL BE INSTALLED PER MANUFACTURER'S INSTRUCTIONS AND RE SUBJECT TO MECHANICAL INSPECTION PER IRC SECTION R1002.1

ALL ELECTRICAL INSTALLATION SHALL MEET THE REQUIREMENTS OF THE NATIONAL ELECTRIC CODE (NEC). . MATERIAL AND EQUIPMENT SHALL BEAR THE LABEL OF APPROVAL OF THE UNDERWRITERS

-) ELECTRICAL CONTRACTOR SHALL VERIFY SPACE REQUIRED FOR METER INSTALLATION BEFORE ONSTRUCTION AND SHALL NOTIFY GENERAL CONTRACTOR OF ANY DISCREPANCIES.
- VERIFY LOCATION OF ALL RECEPTACLES FOR APPLIANCES WITH MANUFACTURER SPECIFICATIONS.
- GROUND FAULT INTERRUPTS SHALL BE LOCATED PER THE NEC
- ALL SWITCHES SHALL BE INSTALLED AT 3'-6" ABOVE FINISHED FLOOR TO CENTERLINE OF SWITCH VLESS NOTED OTHERWISE) ALL CONVENIENCE OUTLETS SHALL BE INSTALLED W/ CENTERLINE OF OUTLET LOCATED 1'-3" ABOVE
- INISHED FLOOR UNLESS NOTED OTHERWISE
- ALL CONVENIENCE OUTLETS WITH SWITCHES TO BE SWITCH AT TOP ONLY.
- ALL EXTERIOR WALL BRACKET FIXTURES SHALL BE INSTALLED AS NOTED ON PLANS.

 APPROVED SMOKE DETECTORS SHALL BE LOCATED ON EVERY STORY OF THE DWELLING UNIT AS PER IRC
- CTION R317 (SEE SHEET B1.1 FOR LOCATIONS). WHERE MORE THAN ONE DETECTOR IS REQUIRED THEY SHALL BE INTERCONNECTED. POWER SOURCE SHALL BE BUILDING POWER w/ BATTERY BACKUP.)) CONDUCTORS SHALL BE OF COPPER.

THE FOUNDATION WALLS OR ANY WATERPROOFING/ DAMPPROOFING MATERIALS. 3 - CONCRETE

2 - SITE CONSTRUCTION

1) SLOPE ON GARAGE SLAB SHALL BE 1/8" PER FOOT TOWARDS VEHICLE DOOR. SLOPE ON PORCH AND

) BACK FILL SHALL BE PLACED IN LIFTS AND COMPACTED IN SUCH A MANNER AS BACKFILL TO NOT DAMA

PRODUCTS, INSTALLATIONS, OR FABRICATIONS IN THE FIELD PRIOR TO EXPEDITING THE CONSTRUCTION OF SUCH WORK. FIELD VERIFY ALL DIMENSIONS — DO NOT SCALE DRAWINGS! CONTRACTOR IS RESPONSIBLE FOR SURVEYING THE PROJECT AND BECOMING FAMILIAR WITH THE EXISTING CONDITIONS AND SCOPE OF WORK

INCLUDING BUT NOT LIMITED TO SITE AND SOIL BEARING CONDITIONS.
5) ERRORS AND OMISSIONS WHICH MAY OCCUR IN THE CONTRACT DOCUMENTS SHALL BE BROUGHT TO THE

DISCREPANCIES, OR OMISSIONS FOR WHICH THE CONTRACTOR FAILED TO NOTIFY THE ARCHITECT PRIOR TO

ATTENTION OF THE ARCHITECT, IN WRITING, AND WRITTEN INSTRUCTION SHALL BE OBTAINED PRIOR TO PROCEEDING WITH CONSTRUCTION. THE CONTRACTOR SHALL BE HELD RESPONSIBLE FOR ANY ERRORS,

4 - MASONRY

ALL EXTERIOR BRICK MUST MEET ASTM C-216 FOR "SW" CONDITIONS

BACK FILL SHALL BE FREE FROM VEGETATION AND CONSTRUCTION DEBRIS

2) MASONRY VENEER SHALL BE ATTACHED TO SUPPORTING WALLS w/ CORRUGATED METAL TIES IN ACCORDANCE WITH R703.7.4.1 - I.R.C. OR LOCAL CODE REQUIREMENTS

) WEEPHOLES SHALL BE PROVIDED ALONG THE OUTSIDE WYTHE OF EXTERIOR MASONRY WALLS AT 33" O.C. MAX, SHALL BE A MIN. OF 3/16" IN DIAMETER, AND LOCATED IMMEDIATELY ABOVE THE FLASHING PER 18703.7.6 – LR.C.

5 - METALS

6 - WOOD AND PLASTICS

7 - THERMAL & MOISTURE PROTECTION

) Fire stopping and/ or draft stopping shall meet the requirements of IRC R602.8. 2) Attic ventilation shall be provided at 1/300 th of the Area of the Space ventilated. Cross VANILATION WITH HALF OF THE VENTILATED AREA SHALL BE PROVIDED BY ROOF VENTS AND THE OTHER HALF BY SOFFIT VENTS. VENTS SHALL BE PLACED SO AS TO NOT ALLOW INFILTRATION OF RAIN OR SNOW.) PROVIDE APPROVED TILE BACKER DRYWALL FOR ALL SHOWER AND BATH SPACE PROVIDE ATTIC VENTILATION PER IRC-R806.1

8 - DOORS AND WINDOWS

-) REVIEW ALL WINDOW HDR HEIGHTS PER PLATE HT. AND VERIFY W/ ELEVATIONS AND CORNICE DETAILS TEMPERED GLASS SHALL BE USED IN HAZARDOUS AREAS AS DESCRIBED IN SECTION R308.4 - LR.C.
- FRONT DOOR WIDTH PER IRC-R311.3
- GARAGE DOOR PER IRC-R309.1

FMERGENCY EGRESS SHALL MEET REQUIREMENTS OF SECTION R310 - LR C 2018 - SLEEPING ROOMS HALL HAVE AT LEAST ONE EGRESS OPENING OF NOT LESS THAN 5.7 SF AND A CLEAR OPENING OF NOT IFSS THAN 20" WIDE X 24" HIGH AND SHALL NOT BE MORE THAN 44" ABOVE THE FLOOR

GENERAL FRAMING SPECS AND CONSTRUCTION NOTES STAIRS:

1) THE MAXIMUM RISER HEIGHT SHALL BE 7 3/4 INCHES AND THE MINIMUM TREAD DEPTH SHALL BE 10 CHES IN ACCORDANCE WITH SECTION I.R.C.

HANDRAILS HAVING MINIMUM AND MAXIMUM HEIGHTS OF 34 INCHES AND 38 INCHES SHALL BE OVIDED ON AT LEAST. ONE SIDE OF STAIRWAYS IN ACCORDANCE WITH SECTION R315.1 - I.R.(HANDRAIL AND BALUSTRADE (WHERE PRESENT) SHALL BE CONSTRUCTED. ACCORDING TO IRC. ALL REQUIRED HAND RAILS SHALL BE CONTINUOUS THE FULL LENGTH OF THE STAIRS W/ 2 OR MORE SERS FROM A POINT ABOVE THE THE TOP RISER OF A FLIGHT TO A POINT ABOVE THE LÓWEST RISER OF THE FLIGHT. ENDS SHALL BE RETURNED OR SHALL TERMINATE AT NEWEL POSTS OR SAFETY TERMINALS. ANDRAILS ADJACENT TO A WALL SHALL HAVE A SPACE OF NOT LESS THAN 1.5" BETWEEN THE WALL

WALLS:

) ALL DIMENSIONS ARE FROM FACE OF STUD TO FACE OF STUD. ALL STUDS ARE 3 1/2" UNLESS NOTED. LL DIMENSIONS PRESENTED HERE ARE FRAME DIMENSIONS ONLY.

I SEPARATION BETWEEN THE RESIDENCE AND THE GARAGE SHALL BE MAINTAINED BY INSTALLATION OF $rac{1}{2}"$ GYPSUM BOARD ON ALL COMMON WALLS. 2-STORY HOMES REQUIRE 5/8" TYPE X GYPSUM BOARD AT CARAGE CEILINGS WHERE HABITABLE ROOMS ARE PRESENT ABOVE.

FLOORS:

STRUCTURAL FLOOR MEMBERS SHALL NOT BE CUT, BORED, OR NOTCHED IN EXCESS OF THE LIMITATIONS ECIFIED IN IRC

) THE ENDS OF EACH JOIST, BEAM, OR GIRDER SHALL HAVE NOT LESS THAN 1.5 INCHES OF BEARING ON WOOD OR METAL AND NOT LESS THAN 3 INCHES ON MASONRY OR CONCRETE OR AS OTHERWISE SPECIFIED

) ALL DIMENSIONAL FLOOR JOISTS TO BE PER ENGINEER STRUCTURAL PLANS.

FRAMING:

ALL FRAMING DIMENSIONS TO FACE OF MEMBER. ALL BEARING HEADERS TO BE PER ENGINEERING PLANS.

FIRE STOPPING AND / OR DRAFT STOPPING SHALL MEET THE REQUIREMENTS OF IRC R602.8.

ROOF

HIP AND VALLEY RAFTERS SHALL BE SUPPORTED AT RIDGE DOWN TO BEARING PARTITION. CUT ENDS OF RAFTERS SHALL BE FULLY SUPPORTED WALL AND RIDGE

REQUIRED VENTILATION AREAS CALCULATED AT 1/300 RATIO

SQUARE FOOTAGE Elevation "B"

(Slab S.F.)	
Slab Area	Sq. Ft
FIRST FLOOR	2278
2 BAY GARAGE	516
PORCH	III
COVERED OUTDOOR LIVING	227
Total Slab Area	3132

(Outside of Frame S.F.)		
A/C Area	Sq. Ft.	
FIRST FLOOR	2278	
Total A/C Area	2278	
Non-A/C Area	Sq. Ft.	
2 BAY GARAGE	516	
PORCH	III	
COVERED OUTDOOR LIVING	227	
Total Non-A/C Area	854	

(Inside of Frame S.F.)		
/C Area	Sq. Ft.	
IRST FLOOR	2204	
otal A/C Area	2204	

OPTIONS	
EXT. COV. OUTDOOR LIVING	+14
LOFT	+65

LOT 335 WILL BE **GARAGE LEFT- REVERSE** OF ARCH PLANS

BUILDING CODE COMPLIANCE

CONSTRUCTION PLANS DESIGNED TO MEET OR EXCEED MINIMUM CODE REQUIREMENTS OF 2018 LR (

ELECTRICAL PLANS DESIGNED TO MEET OR EXCEED MINIMUM

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SHEET LEGEND				
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"G0.11"	REVISIONS & SYMBOLS			
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"A1.10B"	10B" FIRST FLOOR PLAN — ELEVATION 'B'			
"01.A10"	10" FLOOR PLAN OPTIONS			
"01.A20"	FLOOR PLAN OPTIONS			
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"A2.01B"	EXTERIOR ELEVATIONS — 'B'			
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"E1.11B"	1ST FLR. ELECTRICAL PLAN UPGRADE OPTIONS — ELEVATION 'B'			
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"01.E21"	2ND FLR. ELECTRICAL PLAN UPGRADE OPTION			

Altis at Serenity - Lot 335 - 5921-08 (Foxtail Manor) -**Elevation B**

- *Gourmet Kitchen 2
- *Fireplace at Great Room
- *12080 Sliding Glass Door at Great Room
- *Office ILO Flex Space
- *Shower ILO Tub at Bath 2 w. Tile Walls
- *Primary Bath 3
- *Tray Ceiling at Primary Bath
- *Laundry Cabs w. Sink
- *Door from Primary Walk in Closet
- *Outdoor Living Fireplace
- *Extended Covered Outdoor Living
- *Optional Loft
- *Tile Walls at Bath 4
- *Open Rail at Loft Stairs
- *Cabs at Dropzone

SYMBOLS PLYWOOD ELEVATION KEY OR SECTION KEY TUB/SHOWER INSULATING SHEATHING CENTERI INF BATT INSULATION CEILING TRANSITION LINE LAVATOR' HOSE BIB (FREEZE PROOF) DBL SINK GAS LINE STUB CONCRETE TOWEL BAR SAND OR GRAVEL LAUNDRY SINK PAPER HOLDER STONE TOWEL RING 2x FRAME PEDESTAL SINK SHOWER HEAD BRICK VENEER WATER CLOSET ++SHOWER CONTROLS STONE VENEER

DointeHOMES

BIvd Business Operation 5440 Wade Park Blv Suite 400 Raleigh, NC 27607

GENERAL irefly L at Ser ઝ

SHEET

SUBDIVISION: ADDRESS: LOT:

10-01-24 Issue Date: ACC

5921-08

(FOXTAIL MANOR

G0.01

REVISION INDEX				
REL. #	DESCRIPTION	DATE	DRAWN BY	
5921-08	NEW PLAN	10/01/2024	ACC	
	ADDED ATTIC PULL-DOWN, REVISED ROD/SHELF IN PRIMARY WIC, ADDED OPTIONS — SCREENED COVERED OUTDOOR LIVING, GOURMET KITCHEN KITCHEN, ZERO ENTRY SHOWER AT PRIMARY BATH, ADDED TRIM SURROUNDING VENTS AT VARIOUS ELEVATIONS, REVISED BENCH DETAIL, ADDED OPT. LAUNDRY CABINETS, ADDED (2) 4-LED LIGHTS IN GARAGE, REVISED ELECT LIGHTING AND SWITCHES IN PRIMARY BATH, ADDED DISHWASHER ACCESSIBLE DISCONNECT SWITCH AND COUNTER-TOP AIR SWITCH FOR DISPOSAL NOTES	01/26/2025	ACC	
	ADDED SHOWER NICHE NOTE, ADDED CURB TO SHOWERS, REVISED INT/EXT FIREPLACE DEPTHS, REVISED OPENING HEADER HEIGHTS THROUGHOUT, REVISED REAR EXTERIOR DOOR TO 3, ADDED DOOR HEIGHTS TO MAIN FLOOR NOTES, ADDED BATH ACCESSORY HEIGHTS TO MAIN FLOOR NOTES, ADDED ZERO ENTRY SHOWER DETAIL, REMOVED PRIMARY BATH 2 OPTION, ADDED OUTDOOR LUNNO PAIN OFTION 1 & 2, ADDED PARTIAL SHOWER NICHE DETAIL, ADDED GOURMET KITCHEN INTERIOR, REVISED ELECTRICAL / ELECTRICAL OPTION AT GREAT ROOM AND PRIMARY BATH.	04/24/2025	ACC	
		-		

tri pointe.

HOMES

5440 WADE PARK BLVD, SUITE 400, RALEIGH, NG 27607

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SUBDIVISION: Lot 335
ADDRESS:
LOT: Lot 335 67 Firefly Ln Altis at Serenity


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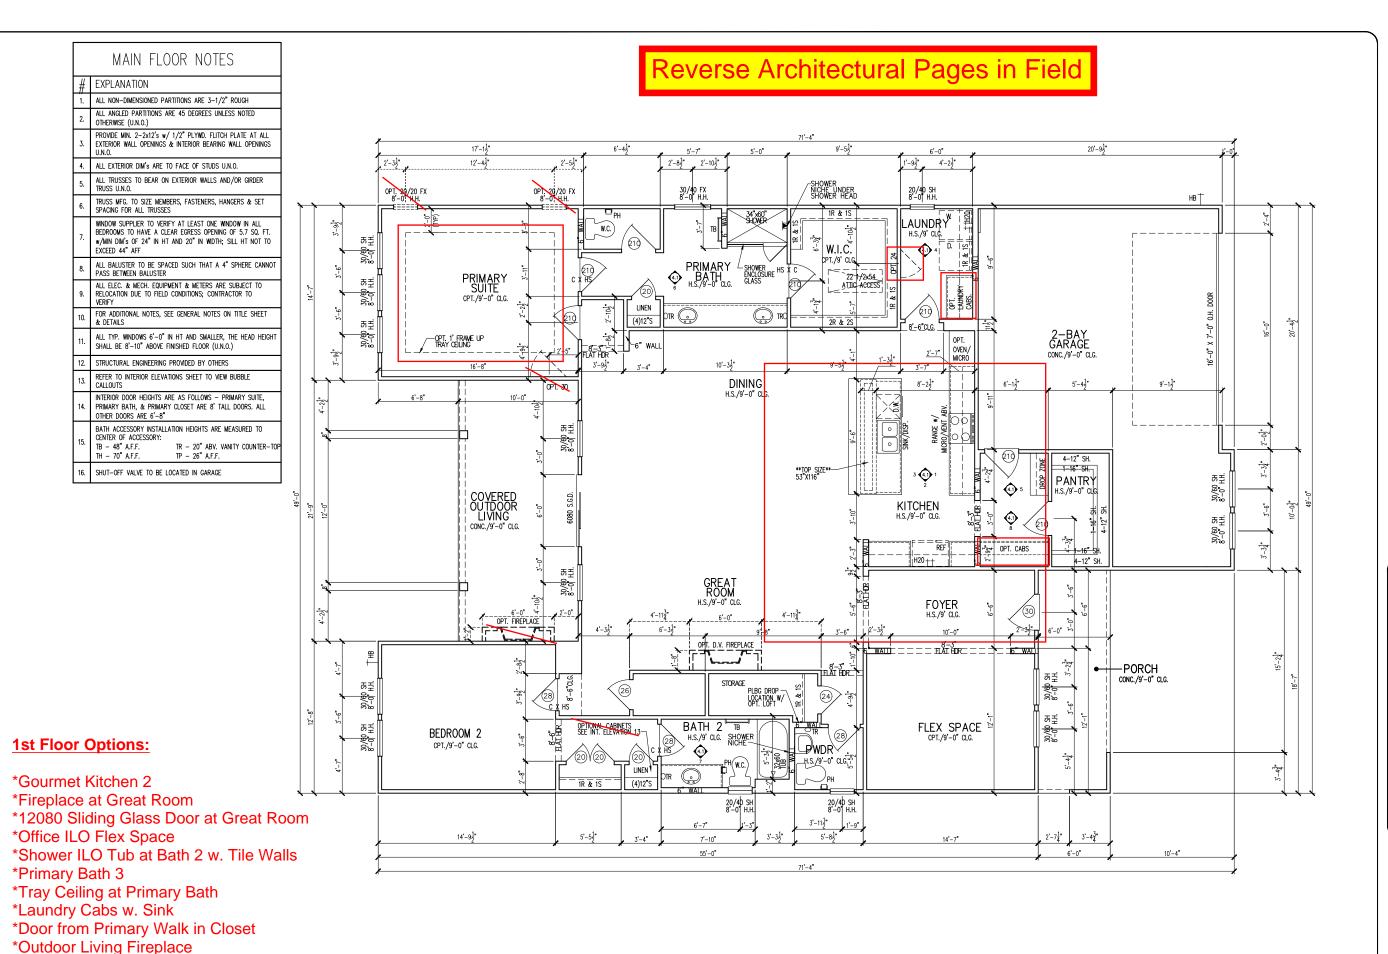
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*Extended Covered Outdoor Living

*Cabs at Dropzone

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1st FLOOR PLAN

No. Lot 335
67 Firefly Ln
Altis at Serenity

SUBDIVISION:
ADDRESS:
LOT:

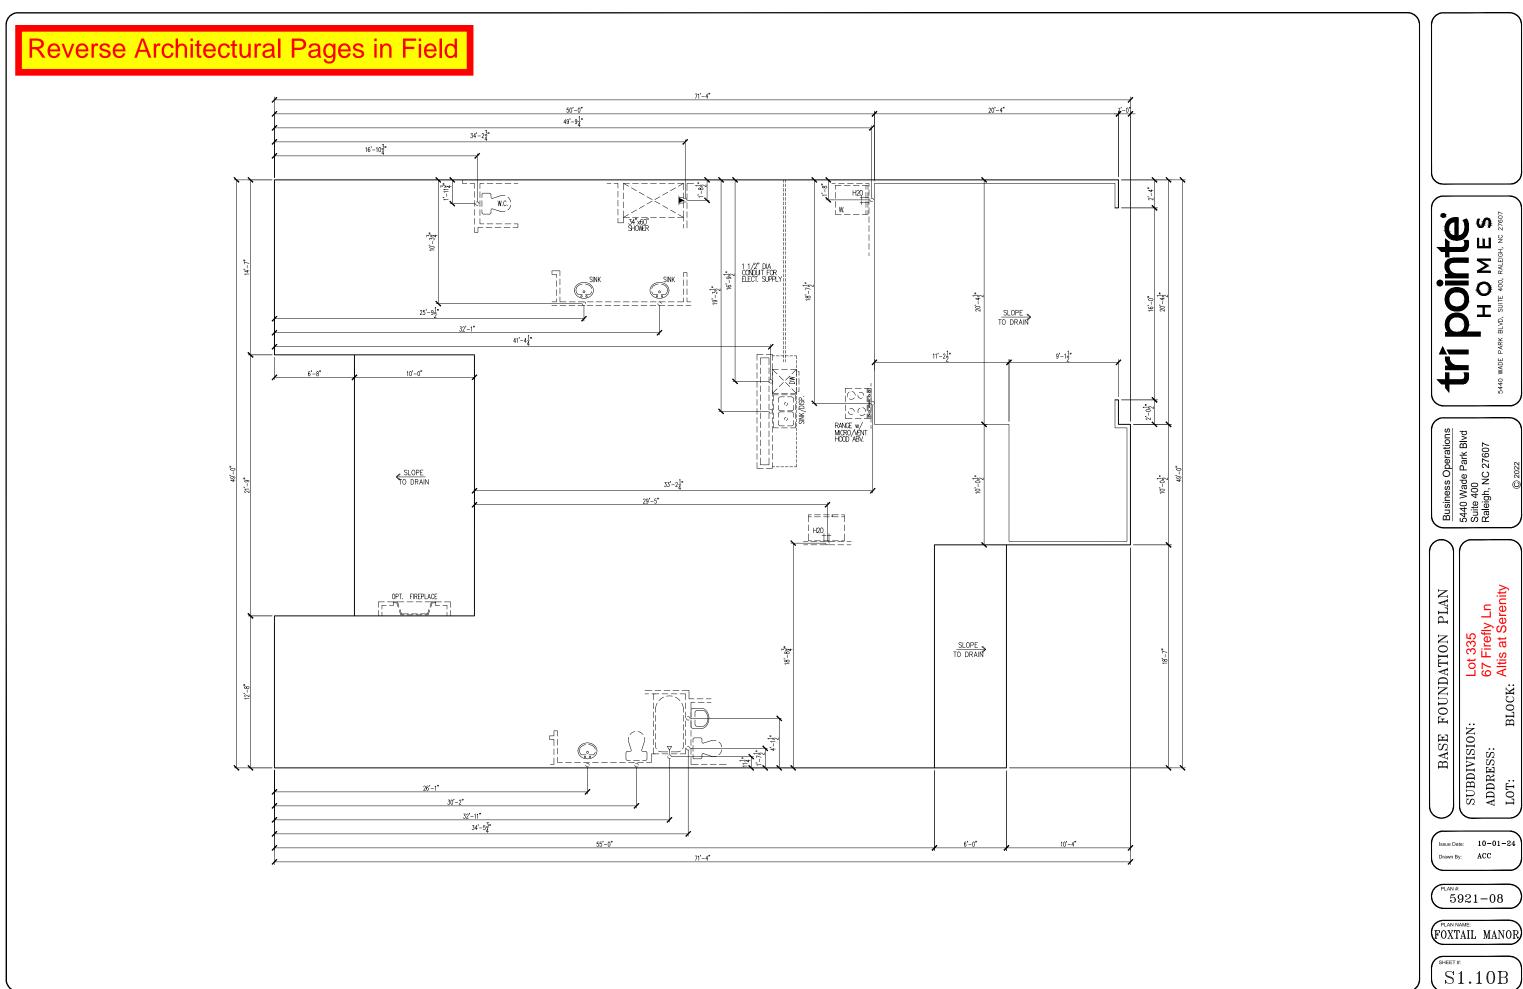
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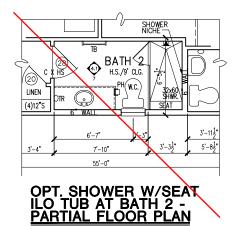
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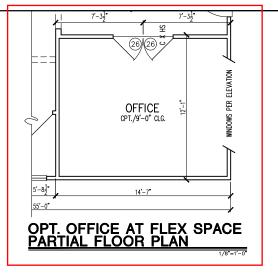
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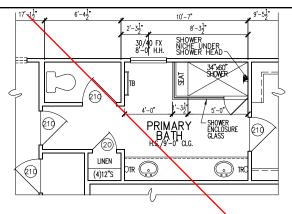
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OPT. PRIMARY BATH T PARTIAL FLOOR PLAN

Reverse Architectural Pages in Field

MAIN FLOOR NOTES

1. ALL NON-DIMENSIONED PARTITIONS ARE 3-1/2" ROUGH

4. ALL EXTERIOR DIM'S ARE TO FACE OF STUDS U.N.O.

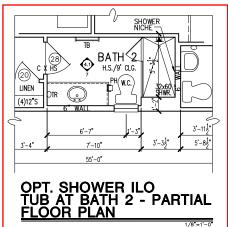5. ALL TRUSSES TO BEAR ON EXTERIOR WALLS AND/OR GIRDER

TRUSS MFG. TO SIZE MEMBERS, FASTENERS, HANGERS & SET

WINDOW SUPPLIER TO VERIFY AT LEAST ONE WINDOW IN ALL

ALL ELEC. & MECH. EQUIPMENT & METERS ARE SUBJECT TO

RELOCATION DUE TO FIELD CONDITIONS: CONTRACTOR TO

10. FOR ADDITIONAL NOTES, SEE GENERAL NOTES ON TITLE SHEET & DETAILS

SHALL BE 8'-10" ABOVE FINISHED FLOOR (U.N.O.)

STRUCTURAL ENGINEERING PROVIDED BY OTHERS 13. REFER TO INTERIOR ELEVATIONS SHEET TO VIEW BUBBLE

SHUT-OFF VALVE TO BE LOCATED IN GARAGE

ALL TYP. WINDOWS 6'-0" IN HT AND SMALLER, THE HEAD HEIGHT

PRIMARY BATH, & PRIMARY CLOSET ARE 8' TALL DOORS. ALL

BATH ACCESSORY INSTALLATION HEIGHTS ARE MEASURED TO

TR - 20" ABV. VANITY COUNTER-TO

w/MIN DIM's OF 24" IN HT AND 20" IN WIDTH; SILL HT NOT TO

2. ALL ANGLED PARTITIONS ARE 45 DEGREES UNLESS NOTED

PROVIDE MIN. 2-2x12's w/ 1/2" PLYWD. FLITCH PLATE AT ALL EXTERIOR WALL OPENINGS & INTERIOR BEARING WALL OPENINGS

EXPLANATION

OTHERWISE (U.N.O.)

SPACING FOR ALL TRUSSES


PASS BETWEEN BALUSTER

OTHER DOORS ARE 6'-8"


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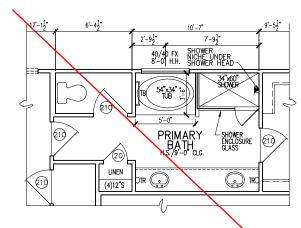
TH - 70" AFF

CALLOUTS




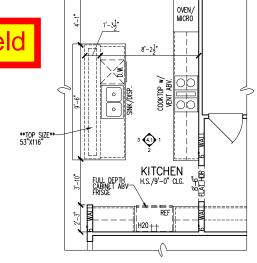





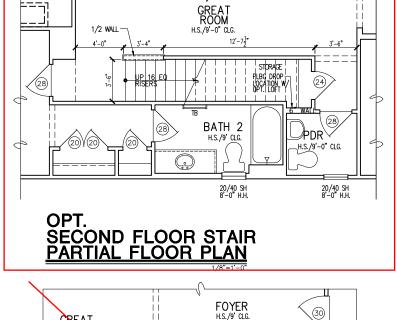



OPT. PRIMARY BATH 2 PARTIAL FLOOR PLAN

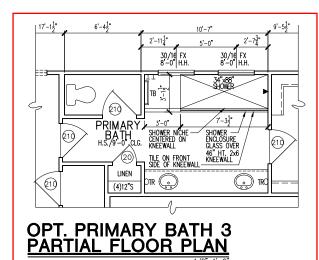

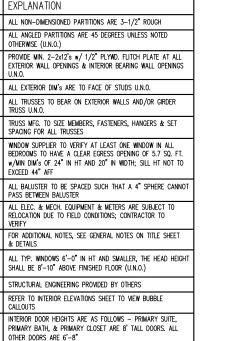

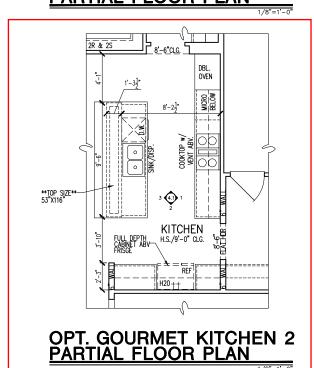

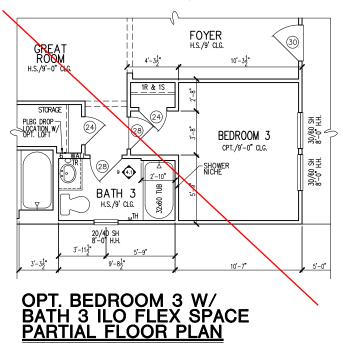

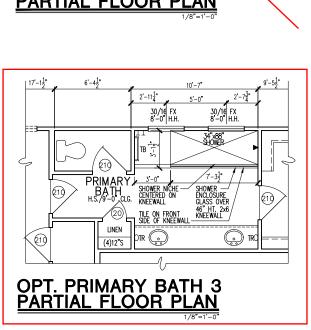

Dointe HOMES WRUD, SUITE 400, RALEGH, NO 27607

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Lot 335 67 Firefly Ln Altis at Serenity OPTIONS PLAN

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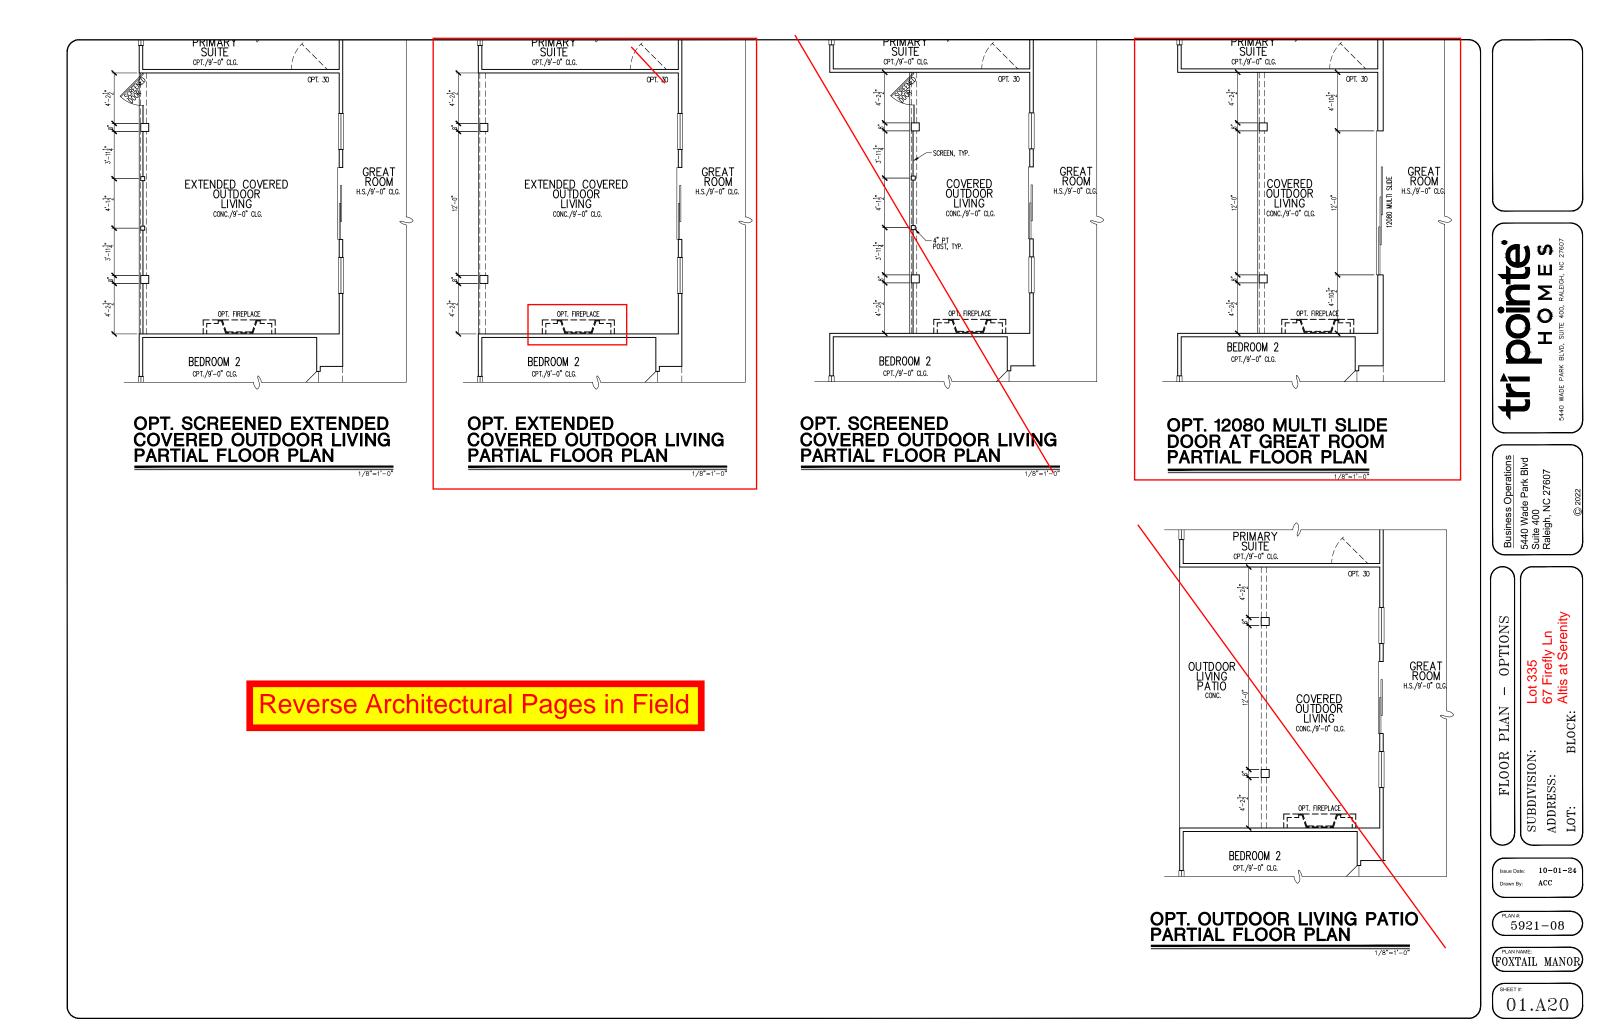
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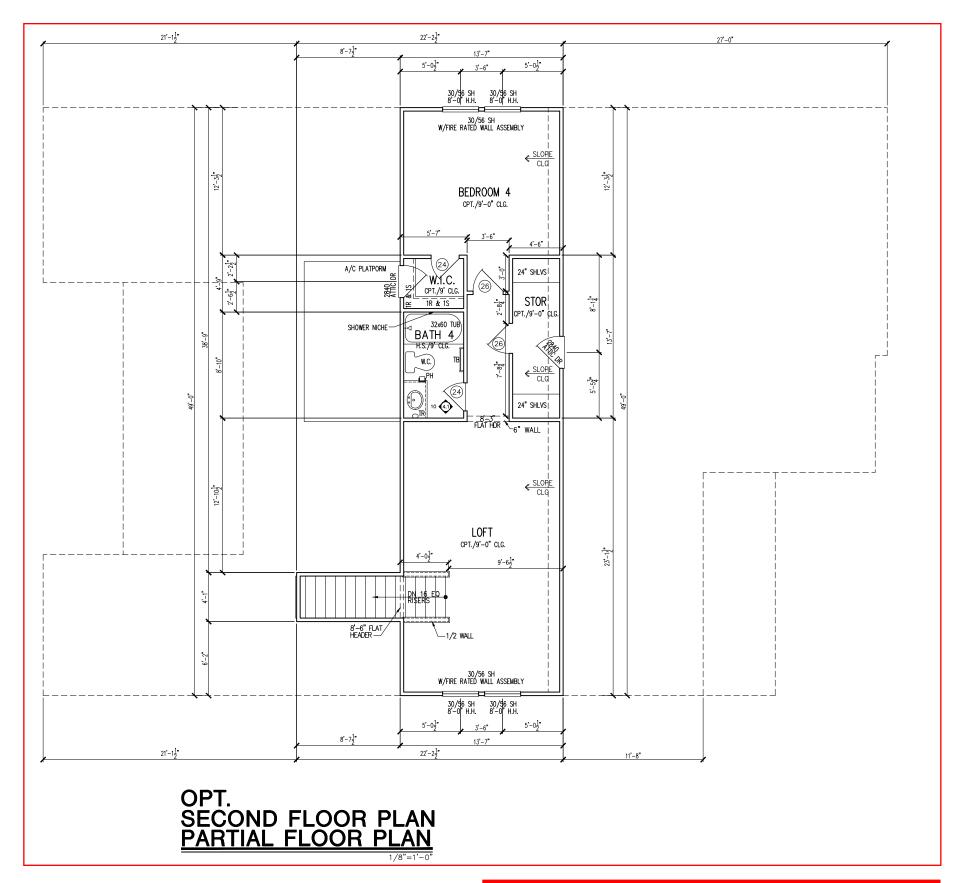
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MAIN FLOOR NOTES # EXPLANATION ALL NON-DIMENSIONED PARTITIONS ARE 3-1/2" ROUGH ALL ANGLED PARTITIONS ARE 45 DEGREES UNLESS NOTED OTHERWISE (U.N.O.) PROVIDE MIN. 2-2x12's w/ 1/2" PLYWD. FLITCH PLATE AT ALL EXTERIOR WALL OPENINGS & INTERIOR BEARING WALL OPENINGS 4. ALL EXTERIOR DIM'S ARE TO FACE OF STUDS U.N.O. ALL TRUSSES TO BEAR ON EXTERIOR WALLS AND/OR GIRDER TRUSS U.N.O. TRUSS MFG. TO SIZE MEMBERS, FASTENERS, HANGERS & SET SPACING FOR ALL TRUSSES WINDOW SUPPLIER TO VERIFY AT LEAST ONE WINDOW IN ALL BEDROOMS TO HAVE A CLEAR EGRESS OPENING OF 5.7 SQ. FT. w/MIN DIM'S OF 24" IN HT AND 20" IN WIDTH; SILL HT NOT TO ALL BALUSTER TO BE SPACED SUCH THAT A 4" SPHERE CANNOT PASS BETWEEN BALUSTER ALL ELEC. & MECH. EQUIPMENT & METERS ARE SUBJECT TO RELOCATION DUE TO FIELD CONDITIONS; CONTRACTOR TO FOR ADDITIONAL NOTES, SEE GENERAL NOTES ON TITLE SHEET & DETAILS ALL TYP. WINDOWS 6'-0" IN HT AND SMALLER, THE HEAD HEIGHT 12. STRUCTURAL ENGINEERING PROVIDED BY OTHERS REFER TO INTERIOR ELEVATIONS SHEET TO VIEW BUBBLE CALLOUTS INTERIOR DOOR HEIGHTS ARE AS FOLLOWS - PRIMARY SUITE, PRIMARY BATH, & PRIMARY CLOSET ARE 8' TALL DOORS. ALL OTHER DOORS ARE 6'-8" BATH ACCESSORY INSTALLATION HEIGHTS ARE MEASURED TO TR - 20" ABV. VANITY COUNTER-TOP TP - 26" A.F.F. TB - 48" A.F.F. TH - 70" A.F.F. SHUT-OFF VALVE TO BE LOCATED IN GARAGE

2nd Floor Options:

*Optional Loft *Tile Walls at Bath 4 *Open Rail at Loft Stairs



Reverse Architectural Pages in Field

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OPTION

FLOOR

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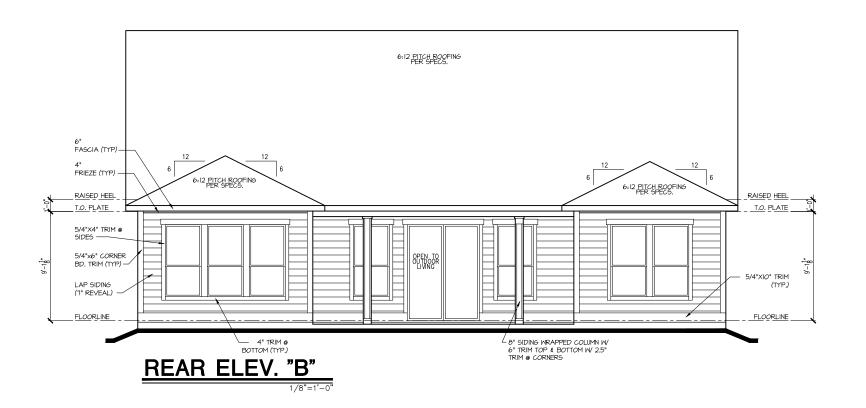
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EXTERIOR ELEVATIONS
TISION: Lot 335
67 Firefly Ln


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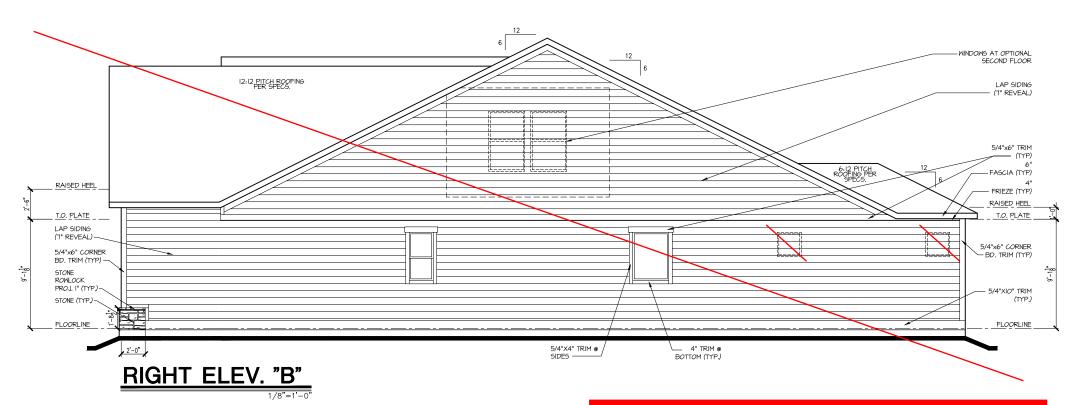
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tri pointe H O M E S 5400 WADE PARK BLYD, SUITE 400, RALEIGH, NC 22607

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EXTERIOR ELEVATIONS
TISION: Lot 335
67 Firefly Ln
RLOCK: Altis at Serenity


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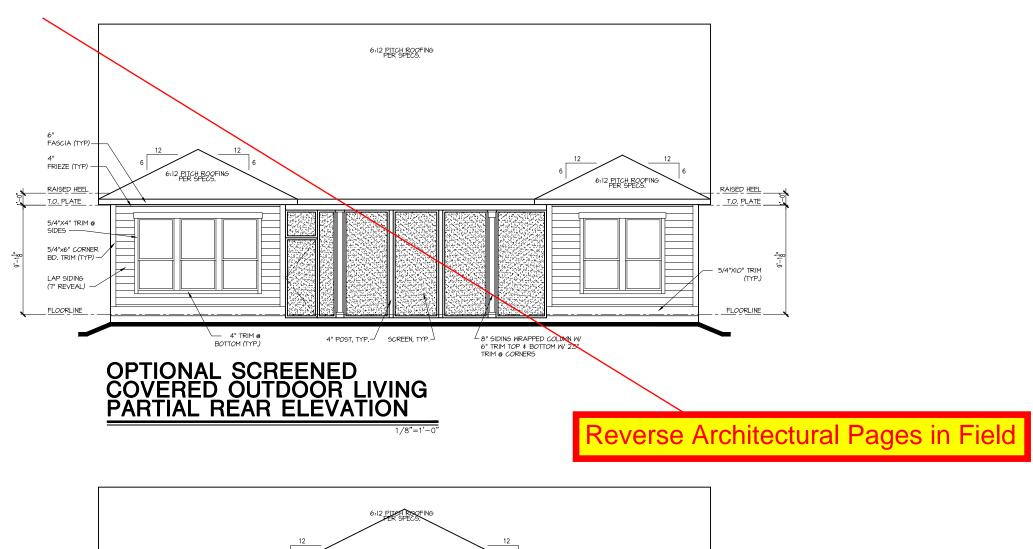
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1/8"=1'-0"

Issue Date: 10-01-24
Drawn By: ACC

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LOT: BI

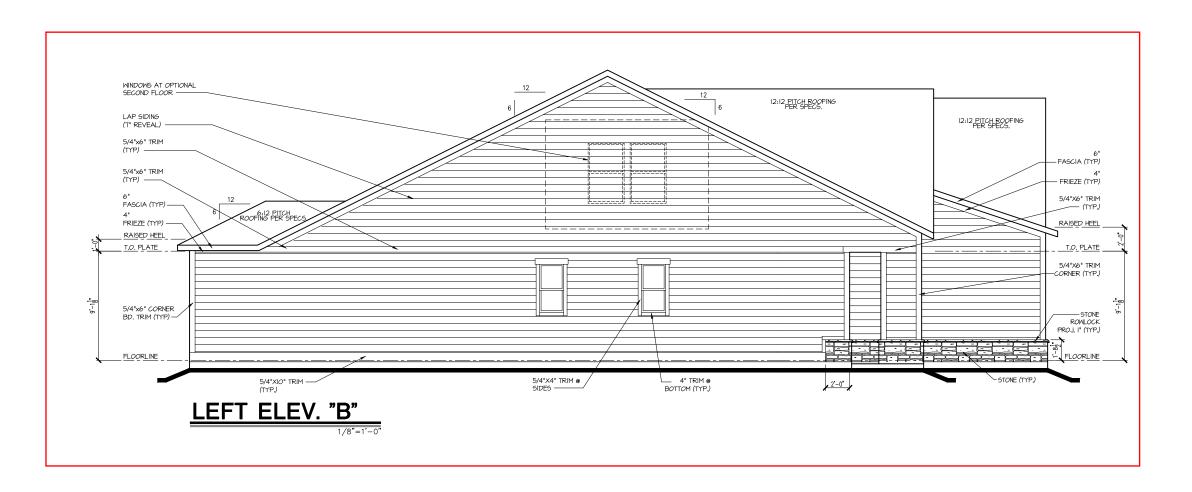Dointe HOMES RR BLVD. SUITE 400, FALEIGH, NG 27607

Business Operations 5440 Wade Park Blvd Suite 400 Raleigh, NC 27607

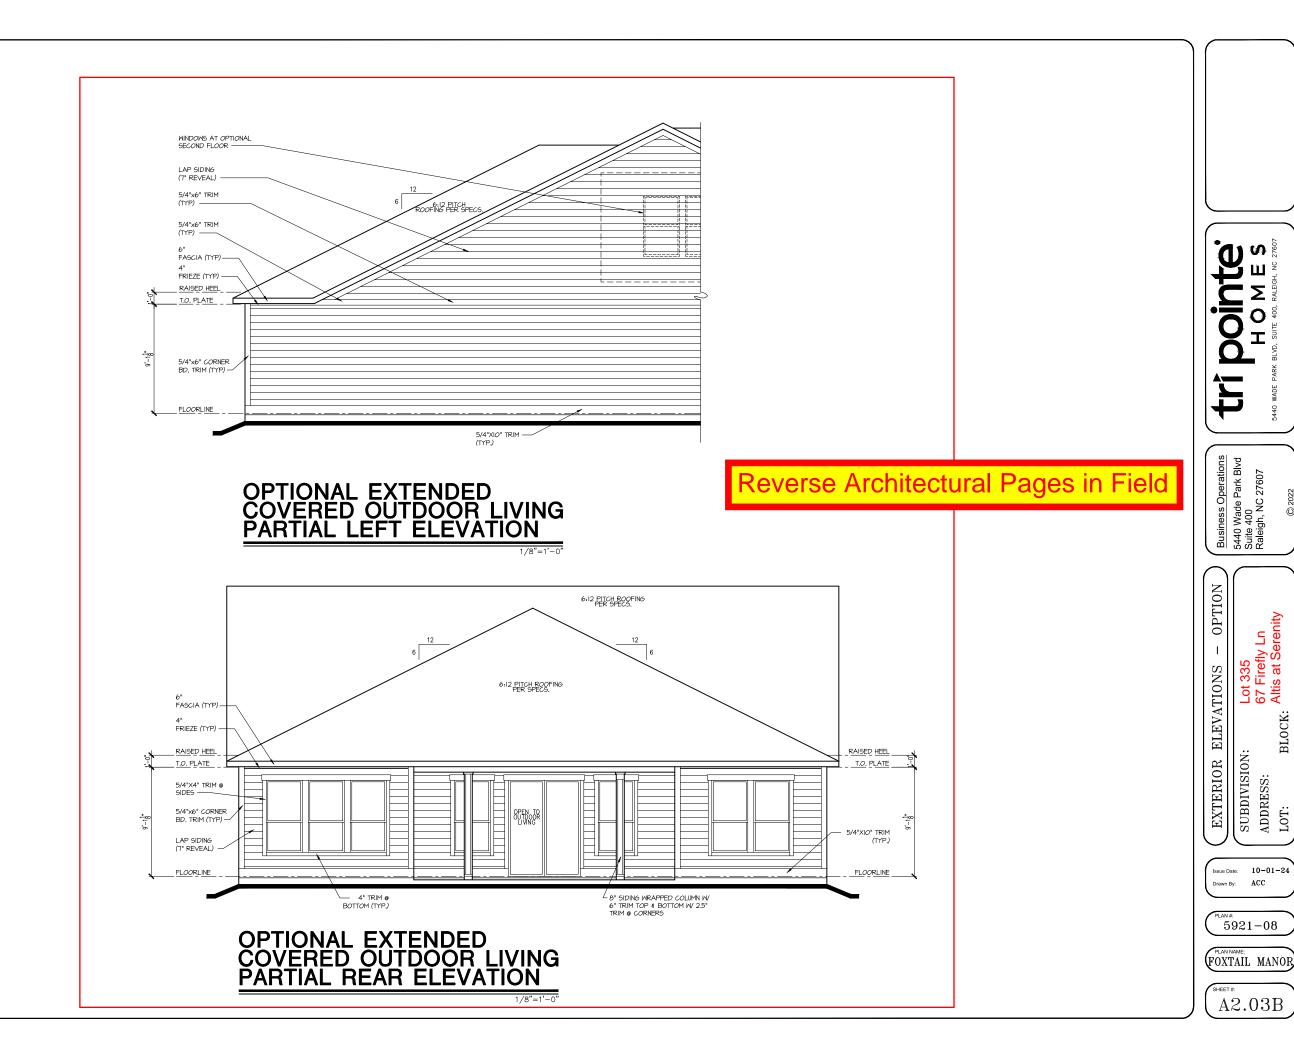
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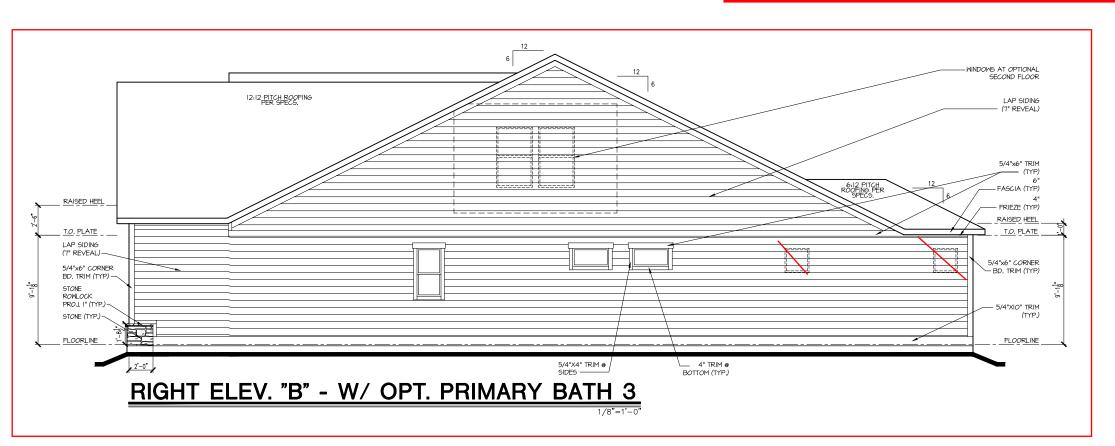
EXTERIOR ELEVATIONS

5921-08

FOXTAIL MANOR

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OPTION

EXTERIOR ELEVATIONS

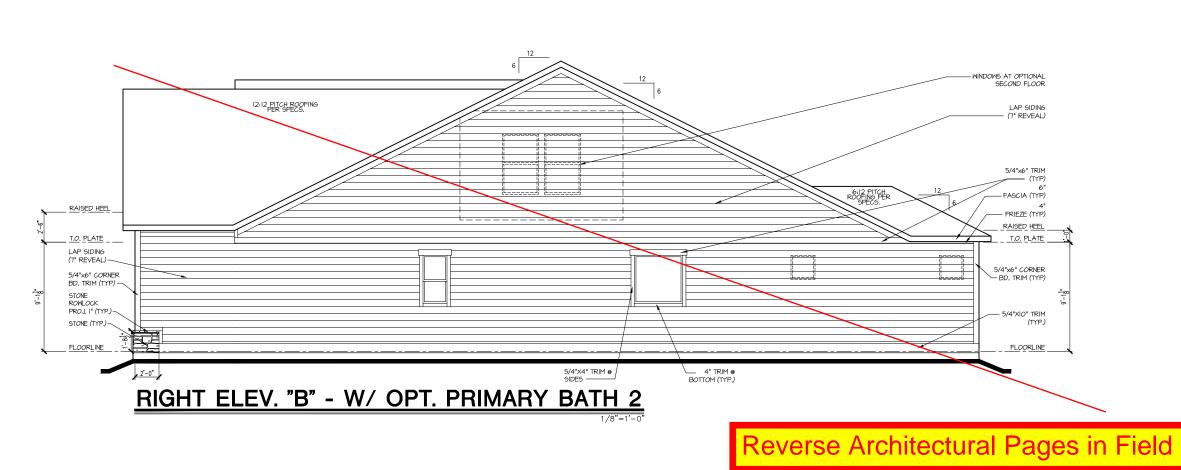
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LOT: BI

Issue Date: 10-01-24 Drawn By: ACC

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FOXTAIL MANOR

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NOTE:
OTY OF UPPER VENTS SHOWN COVERS 100% OF UPPER VENTING. NO MIXING OF VENT TYPES FOR UPPER VENTING IS FIGURED FOR IN THIS TABLE.

ROOF PLAN 'B'

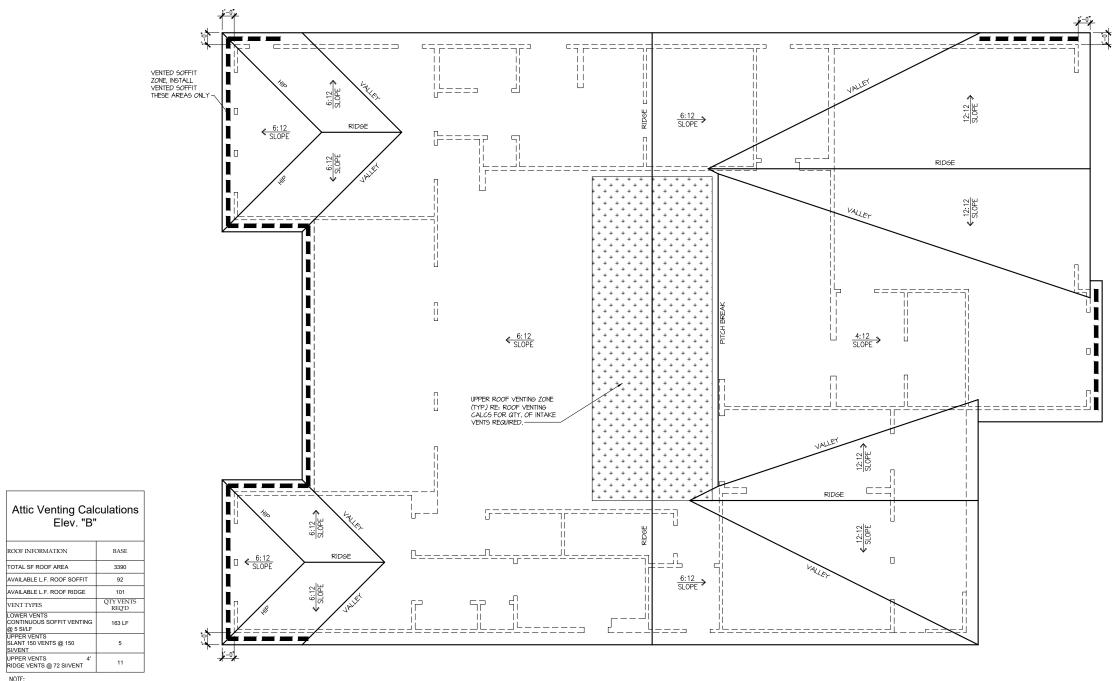Reverse Architectural Pages in Field

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Business Operations 5440 Wade Park Blvd Suite 400 Raleigh, NC 27607

PLAN ROOF


SUBDIVISION: ADDRESS: LOT: BI

Issue Date: 10-01-24 Drawn By: ACC

5921-08

FOXTAIL MANOR

A3.01B

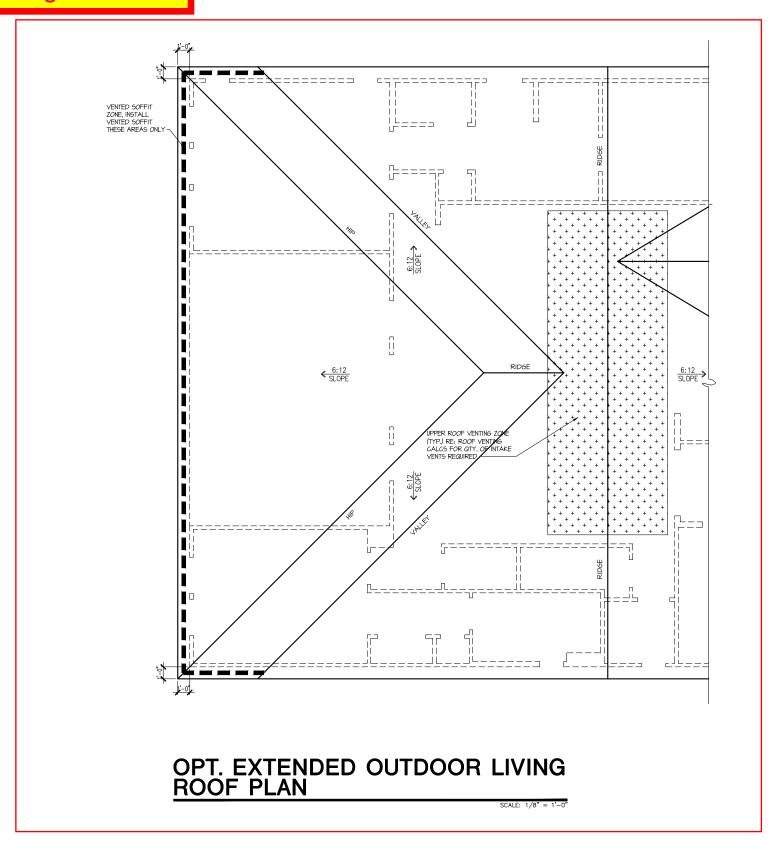

tribointe, BLD, SUIE 400, FALEIGH, NC 27807

Business Operations 5440 Wade Park Blvd Suite 400 Raleigh, NC 27607

IN – OPTION Lot 335 67 Firefly Ln

SUBDIVISION:
ADDRESS:
LOT: BLOCI

ROOF


Issue Date: 10-01-24


Drawn By: ACC


5921-08

FOXTAIL MANOR


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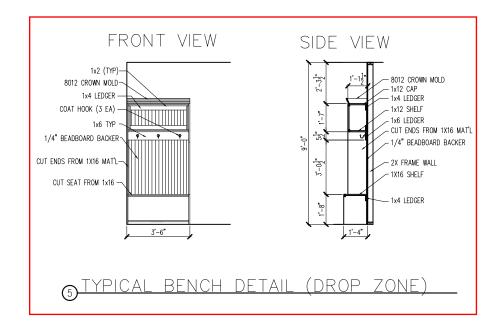


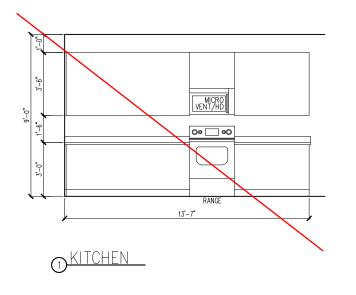


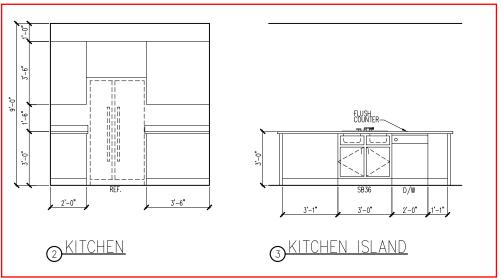
4 LAUNDRY ROOM

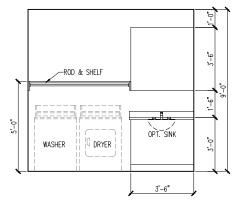



4 LAUNDRY ROOM WALL CABINET OPT.

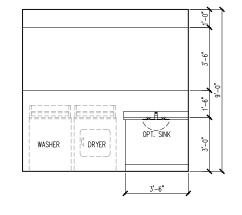


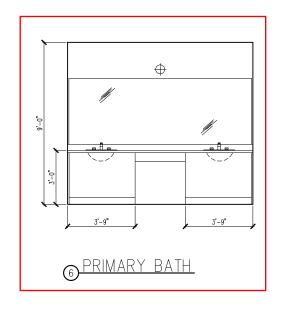


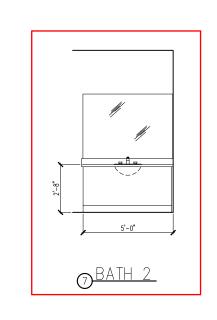


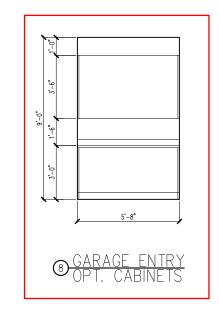


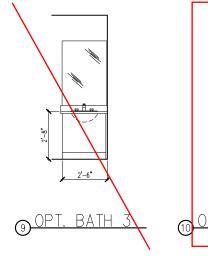

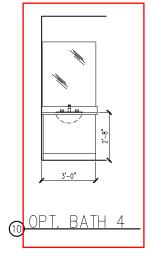

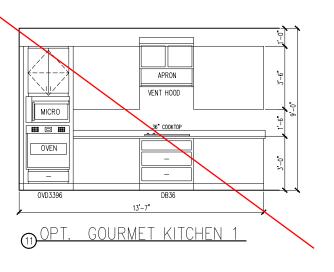

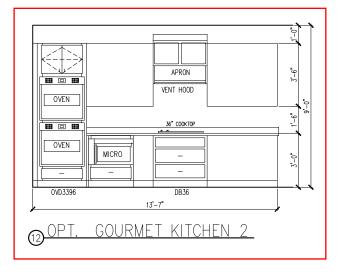

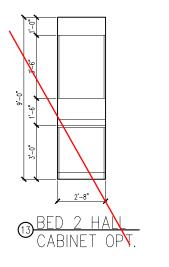

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HOMES

540 WADE PARK BLVD, SUITE 400, RALEIGH, NG 27607

Business Operations 5440 Wade Park Blvd Suite 400 Raleigh, NC 27607

Lot 335 67 Firefly Ln Altis at Serenity INTERIOR DETAIL SHEET

SUBDIVISION:
ADDRESS:
LOT: BI

Issue Date: 10-01-24 Drawn By: ACC

5921-08

FOXTAIL MANOR

A4.01

ELECTRICAL FIXTURE SCHEDULE		
DESCRIPTION	SYMBOL	
110V OUTLET	ф	
220V OUTLET	\$ 220	
1/2 HOT OUTLET	₩	
GFI OUTLET	∜\$ GFI	
WP GFI OUTLET	₩P/GFI	
GARAGE DOOR OPENER OUTLET	Ø GDO	
SECURITY SYSTEM	∯SEC SYS	
DISHWASHER	⊕DW	
JUNCTION BOX	9	
CEILING MOUNTED LIGHT		
CEILING FAN w/ LIGHT KIT	PROVIDE	
RECESSED CEILING LIGHT	Ø	
RECESSED WATER PROOF LIGHT	⊠ WP	
WALL MOUNTED LIGHT	φ	
WALL MOUNTED PUSH BUTTON	₫ PB	
TWO WAY SWITCH	\$	
THREE WAY SWITCH	³\$	
FOUR WAY SWITCH	* \$	
DIMMER SWITCH	\$ ^{DIM}	
EXHAUST VENTS	S VENT TO EXT	
LOW VOLTAGE PANEL	—	
PHONE OUTLET	●PH	
TV OUTLET	⊕ TV	
DATA & RG6 COMBO BOX		
SMOKE DETECTOR	9	
CARBON MONOXIDE SMOKE DETECTOR COMBO	⊚ CM/SD	
DOOR CHIMES	CHIMES	
ELECTRICAL PANEL	EP EP	
SURFACE MOUNT LED	•	
EXTERIOR WALL MOUNT UPLIGHT	88	
SOFFIT MOUNT FLOOD LIGHT	442	
UNDER COUNTER LIGHTING	ess-UCL	
SMURF TUBE		

ELECTRICAL NOTES:


- PROVIDE AND INSTALL LOCALLY CERTIFIED PROVIDE AND INSTALL LOCALLY CERTIFIED SMOKE AND CARBON MONOXIDE DETECTORS REQUIRED BY NATIONAL FIRE PROTECTION ASSOCIATION (NFPA) AND MEETING THE REQUIREMENTS OF ALL GOVERNING CODES PROVIDE AND INSTALL GROUD FAULT CIRCUIT—INTERRUPTERS (GF) AS REQUIRED BY NATIONAL ELECTRIC CODE (NEC) AND MEETING THE REQUIREMENTS OF ALL GOVERNING CODES. ELECTRICAL CONTRACTOR TO PROVIDE REQUIRED DIRECT HOOK-UPS/CUITOFS.
- REQUIRED DIRECT HOOK-UPS/CUTOFFS.
- REQUIRED DIRECT HOOK—UPS/CUIOFFS.
 HVAC CONTRACTOR TO VERIFY THERMOSTAT
 LOCATIONS.
 ALL ELECTRICAL AND MECHANICAL EQUIPMENT
 (I.E. FURNACES, A/C UNITS, ELECTRICAL PANELS,
 SANITARY SUMP PITS, DRAIN TILE SUMP, AND
 WATER HEATERS) ARE SUBJECT TO RELOCATION
 DUE TO FIELD CONDITIONS.

ELECTRICAL DEVICES: ABOVE FINISHED FLOOR: WATER SOFTENER AND SUMP OUTLETS. 48" TO CL FRONT DOOR COACH LIGHT. GARAGE DOOR COACH LIGHT, (ABOVE GARAGE FLOOR). . . . 84" . TO CL THERMOSTAT. . .54" TO .CL . . .84" TO .CL DOORBELL CHIMES. DR HANDLE KITCHEN WALL HUNG MICROWAVE OUTLET . . . 72" TO CL KITCHEN DISHWASHER RECEPTACLE. UNDER SINK . 24".TD.CL. . . .48". TO CL

KITCHEN REFRIGERATOR.

CL = CENTER LINE 1 = FIELD VERIFY 2 = MASTER BATH STANDARD 30" HIGH VANITY TO BE RAISED 4"

Reverse Architectural Pages in Field

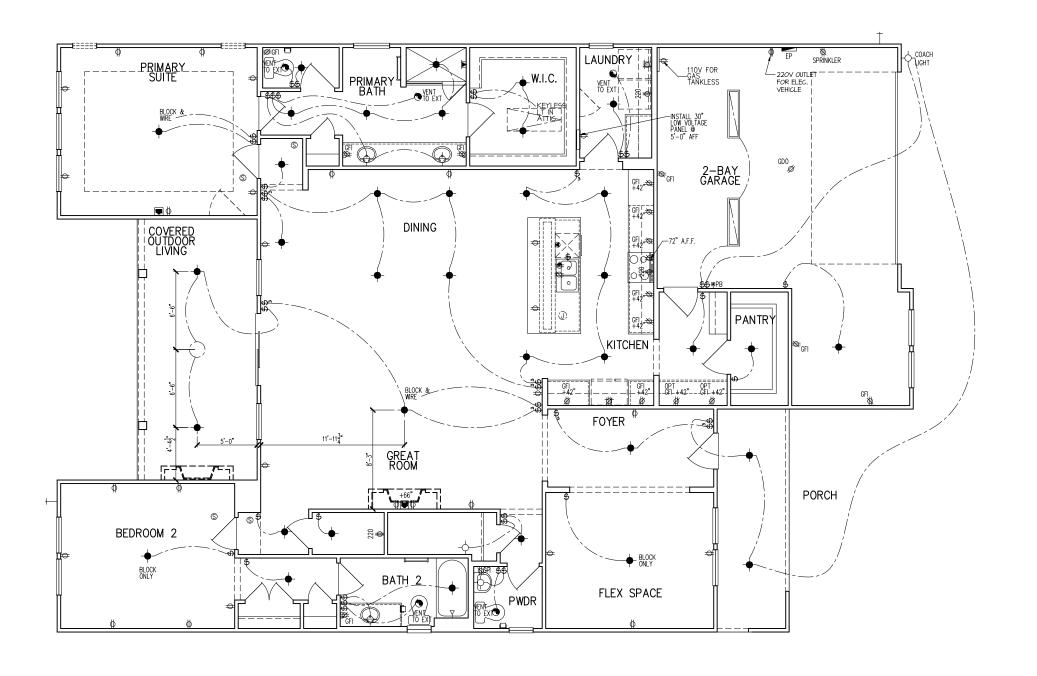

Dointe Sulte 100, RALEGA, NC 27607

Business Operations 5440 Wade Park Blvd Suite 400 Raleigh, NC 27607

ELECTRICAL PLAN 67 Firefly Ln Altis at Serenity

FLOOR SUBDIVISION:
ADDRESS:
LOT: BI 1st

Issue Date: 10-01-24 ACC

5921-08

FOXTAIL MANOR

E1.10B

ELECTRICAL FIXTURE SCHEDULE		
DESCRIPTION	SYMBOL	
110V OUTLET	ф	
220V OUTLET	Q 220	
1/2 HOT OUTLET	₩	
GFI OUTLET	∜ GFI	
WP GFI OUTLET	₩P/GFI	
GARAGE DOOR OPENER OUTLET	Ø GDO	
SECURITY SYSTEM	∯SEC SYS	
DISHWASHER	⊛DW	
JUNCTION BOX	①	
CEILING MOUNTED LIGHT		
CEILING FAN w/ LIGHT KIT	BROVIDE	
RECESSED CEILING LIGHT	Ø	
RECESSED WATER PROOF LIGHT	⊠ WP	
WALL MOUNTED LIGHT	9	
WALL MOUNTED PUSH BUTTON	d i PB	
TWO WAY SWITCH	\$	
THREE WAY SWITCH	³\$	
FOUR WAY SWITCH	* \$	
DIMMER SWITCH	\$ ^{DIM}	
EXHAUST VENTS	O VENT TO EXT	
LOW VOLTAGE PANEL	∳	
PHONE OUTLET	● PH	
TV OUTLET	▲ TV	
DATA & RG6 COMBO BOX		
SMOKE DETECTOR	Ŝ	
CARBON MONOXIDE SMOKE DETECTOR COMBO	⊚ CM/SD	
DOOR CHIMES	CHIMES	
ELECTRICAL PANEL	EP EP	
SURFACE MOUNT LED	•	
EXTERIOR WALL MOUNT UPLIGHT	용	
SOFFIT MOUNT FLOOD LIGHT	445	
UNDER COUNTER LIGHTING	eco- UCL	
SMURF TUBE		

ELECTRICAL NOTES:

- 1. PROVIDE AND INSTALL LOCALLY CERTIFIED SMOKE AND CARBON MONOXIDE DETECTORS REQUIRED BY NATIONAL FIRE PROTECTION ASSOCIATION (NFPA) AND MEETING THE REQUIREMENTS OF ALL GOVERNING CODES
 2. PROVIDE AND INSTALL GROUND FAULT (IRCUIT—INTERRUPTERS (GF) AS REQUIRED BY NATIONAL ELECTRIC CODE (NEC) AND MEETING THE REQUIREMENTS OF ALL GOVERNING CODES.
 3. ELECTRICAL CONTRACTOR TO PROVIDE REQUIRED DIRECT HOOK—UPS/CUTOFFS.
 4. HVAC CONTRACTOR TO VERIFY THERMOSTAT LOCATIONS.
 5. ALL ELECTRICAL AND MECHANICAL EQUIPMENT (I.E. FURNACES, A/C UNITS, ELECTRICAL PANELS, SANITARY SUMP PITS, DRAIN TILE SUMP, AND WATER HEATERS) ARE SUBJECT TO RELOCATION DIE TO FIELD CONDITIONS.
 ELECTRICAL DEVICES: ABOVE FINISHED FLOORS:


- ABOVE FINISHED FLOOR: ELECTRICAL DEVICES:

ABOVE TINISHED TEOOR.
SWITCHES OVER COUNTER
WALL OUTLETS OVER COUNTER
+42" TO BOTTOM OF HORIZONTAL OUTLET(TYP. @ COUNTER)
REMAINING SWITCHES
WALL OUTLETS
BATH VANITY BRACKET OUTLET 1,2 (1" ABOVE TOP OF VANITY)
WATER SOFTENER AND SUMP OUTLETS 48" TO CL
EXTERIOR GFI OUTLETS
GARAGE GFI (ABOVE GARAGE FLOOR) 48" TO CL
FRONT DOOR COACH LIGHT 80". TO CL
GARAGE DOOR COACH LIGHT, (ABOVE GARAGE FLOOR)
THERMOSTAT
DOORBELL CHIMES
DOORBELL BUTTON
KITCHEN HOOD FAN "WHIP"
KITCHEN WALL HUNG MICROWAVE OUTLET 72" TO CL
KITCHEN DISHWASHER RECEPTACLE JNDER SINK
KITCHEN RANGE
KITCHEN REFRIGERATOR
WARRIED FOR SUPER

CL = CENTER LINE 1 = FIELD VERIFY

2 = MASTER BATH STANDARD 30" HIGH VANITY TO BE RAISED 4"

Reverse Architectural Pages in Field

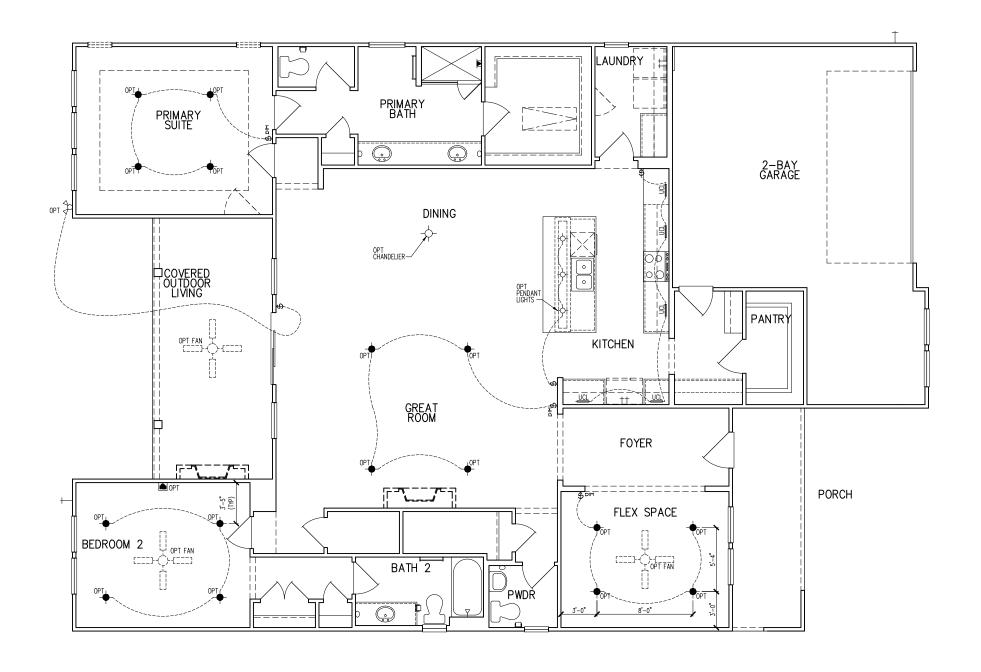

Dointe HOMES RR BLD. SUITE 400, FALEIGH, NG 27607

Business Operations 5440 Wade Park Blvd Suite 400 Raleigh, NC 27607

OPITONS Lot 335 67 Firefly Ln Altis at Serenity PLAN

1st FLOOR ELEC. SUBDIVISION:
ADDRESS:
LOT:
BI

Issue Date: 10-01-24 ACC


5921-08

FOXTAIL MANOR


E1.11B






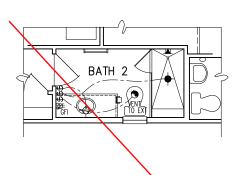

OPT. SHOWER W/SEAT ILO TUB AT BATH 2 PARTIAL ELECT. PLAN

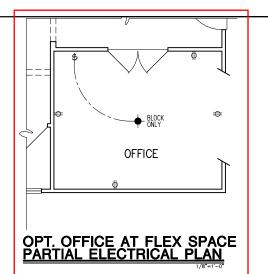

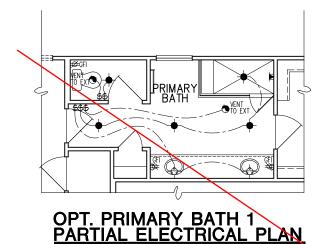

PRIMARY BATH

PRIMARY BATH

OPT. PRIMARY BATH 2
PARTIAL ELECTRICAL PLAN

OPT. PRIMARY BATH 3
PARTIAL ELECTRICAL PLAN

Dointe K B M E S K BLYD, SUITE 400, RALEGH, NC 27607

Business Operations 5440 Wade Park Blvd Suite 400 Raleigh, NC 27607

Lot 335 67 Firefly Ln Altis at Serenity OPTIONS

PLAN

ELEC.

SUBDIVISION: ADDRESS: LOT:


10-01-24 Issue Date: ACC

5921-08

FOXTAIL MANOR

01.E10

Reverse Architectural Pages in Field

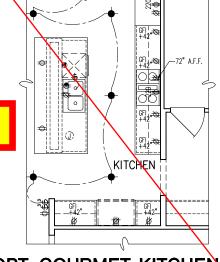

OPT. GOURMET KITCHEN 1
PARTIAL ELECTRICAL PLAN


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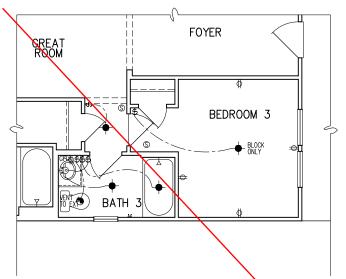
220

KITCHEN

OPT. GOURMET KITCHEN 2 PARTIAL ELECTRICAL PLAN


GFI ... +42... | #




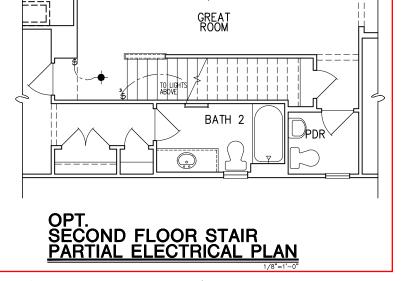


ELECTRICAL FIXTURE SCHEDULE SYMBOL GFI OUTLET ₩P/GFI **ELECTRICAL NOTES:** WP GFI OUTLE GARAGE DOOR OPENER OUTLET Ø GDO ∳SEC SYS ●DW JUNCTION BOX BRACING CEILING FAN w/ LIGHT KIT)g(WP WALL MOUNTED LIGHT WALL MOUNTED PUSH BUTTO TWO WAY SWITCH THREE WAY SWITCH FOUR WAY SWITCH BATH VANITY BRACKET OUTLET. .. (1" ABOVE TOP OF VANITY) EXHAUST VENTS PHONE OUTLE GARAGE GFI (ABOVE GARAGE FLOOR). . FRONT DOOR COACH LIGHT. DATA & RG6 COMBO GARAGE DOOR COACH LIGHT, (ABOVE GARAGE FLOOR).... 84" TO CL .54" TO CL .84" TO CL CARBON MONOXIDE SI DETECTOR COMBO PEAFFAIRFE DOORBELL BUTTON. KITCHEN HOOD FAN "WHIP". KITCHEN WALL HUNG MICROWAVE OUTLET KITCHEN DISHWASHER RECEPTACLE. KITCHEN RANGE. DOOR CHIMES CHIMES ELECTRICAL PANE **□** EP SURFACE MOUNT LED EXTERIOR WALL MOUNT UPLIGHT SOFFIT MOUNT FLOOD LIGH



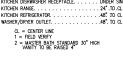


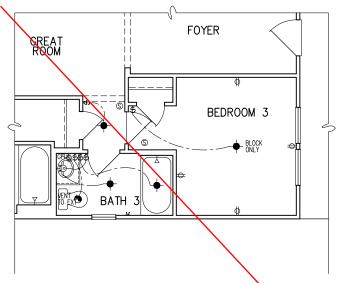


OPT. BEDROOM 3 W/ BATH 3 ILO FLEX SPACE PARTIAL ELECTRICAL PLAN

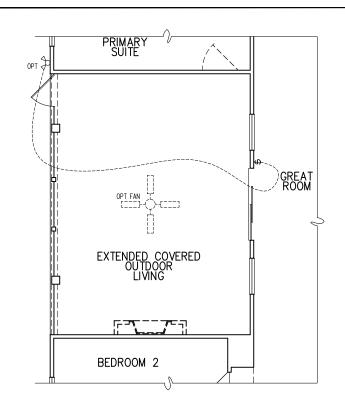





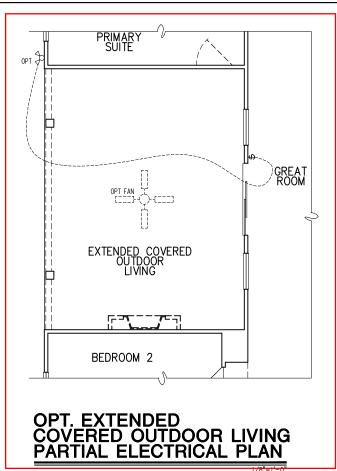

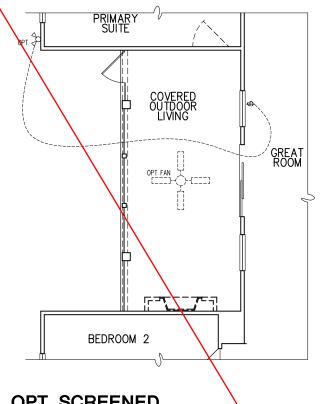


OPT. SCREENED COVERED OUTDOOR LIVING PARTIAL ELECTRICAL PLAN

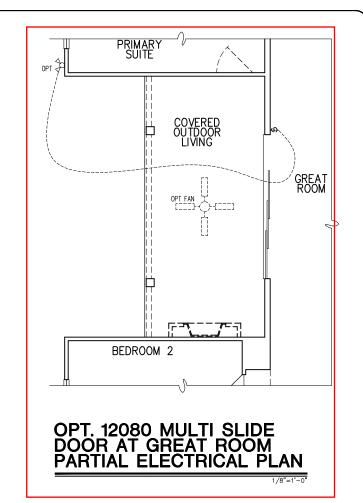

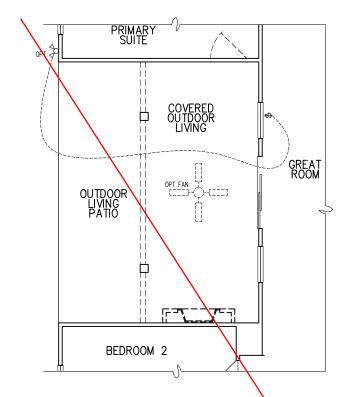

OPT. OUTDOOR LIVING PATIO PARTIAL ELECTRICAL PLAN

Reverse Architectural Pages in Field

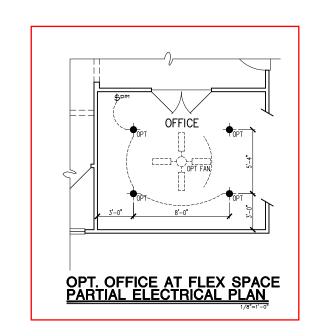



Business Operations 5440 Wade Park Blvd Suite 400 Raleigh, NC 27607

OPTIONS Lot 335 67 Firefly Ln Altis at Serenity PLAN 1st FLOOR ELEC.

SUBDIVISION:
ADDRESS:
LOT: BI

10-01-24 Drawn By:

5921-08

(FOXTAIL MANOR

01.E11

ELECTRICAL FIXTURE SCHEDULE		
DESCRIPTION	SYMBOL	
110V OUTLET	ф	
220V OUTLET	\$ 220	
1/2 HOT OUTLET		
GFI OUTLET	∜\$ GFI	
WP GFI OUTLET	₩P/GFI	
GARAGE DOOR OPENER OUTLET	Ø GDO	
SECURITY SYSTEM	ΦSEC SYS	
DISHWASHER	⊕DW	
JUNCTION BOX	①	
CEILING MOUNTED LIGHT	-	
CEILING FAN w/ LIGHT KIT	PROVIDE	
RECESSED CEILING LIGHT	Ø	
RECESSED WATER PROOF LIGHT	ì⊠WP	
WALL MOUNTED LIGHT	9	
WALL MOUNTED PUSH BUTTON	å PB	
TWO WAY SWITCH	\$	
THREE WAY SWITCH	* \$	
FOUR WAY SWITCH	⁴\$	
DIMMER SWITCH	\$ ^{DIM}	
EXHAUST VENTS	S VENT TO EXT	
LOW VOLTAGE PANEL	<u> </u>	
PHONE OUTLET	● PH	
TV OUTLET	⊗ TV	
DATA & RG6 COMBO BOX		
SMOKE DETECTOR	<u>©</u>	
CARBON MONOXIDE SMOKE DETECTOR COMBO	⊚ CM/SD	
DOOR CHIMES	CHIMES	
ELECTRICAL PANEL	EP EP	
SURFACE MOUNT LED	-	
EXTERIOR WALL MOUNT UPLIGHT	8	
SOFFIT MOUNT FLOOD LIGHT	442	
UNDER COUNTER LIGHTING	UCL	
SMURF TUBE		


ELECTRICAL NOTES:

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PROVIDE AND INSTALL LOCALLY CERTIFIED SMOKE AND CARBON MONOXIDE DETECTORS A REQUIRED BY NATIONAL FIRE PROTECTION ASSOCIATION (NFPA) AND MEETING THE REQUIREMENTS OF ALL GOVERNING CODES PROVIDE AND INSTALL GROUND FAULT (IRCUIT-INTERRUPTERS (GFI) AS REQUIRED BY NATIONAL ELECTRIC CODE (NEC) AND MEETING THE REQUIREMENTS OF ALL GOVERNING CODES. ELECTRICAL CONTRACTOR TO PROVIDE REQUIRED DIRECT HOOK—UPS/CUTOFFS.

HVAC CONTRACTOR TO VERIFY THERMOSTAT LOCATIONS.
ALL ELECTRICAL AND MECHANICAL EQUIPMENT (I.E. FURNACES, A/C UNITS, ELECTRICAL PANELS, SANITARY SUMP PITS, DRAIN TILE SUMP, AND WATER HEATERS) ARE SUBJECT TO RELOCATION DUE TO FIELD CONDITIONS.

ELECTRICAL DEVICES. ABOVE FINISHED FLOOR.
 +42" TO BOTTOM OF HORIZONTAL OUTLET(TYP. @ COUNTER)
REMAINING SWITCHES. 48". T.D. CL
WALL OUTLETS. 12". TO CL
BATH VANITY BRACKET OUTLET. 1,2
CL
BATH SODE TOP OF VANITY)
KITCHEN RANGE. 24". TO CL.
KITCHEN REFRIGERATOR. 48". TO CL
  CL = CENTER LINE
1 = FIELD VERIFY
```

2 = MASTER BATH STANDARD 30" HIGH VANITY TO BE RAISED 4"

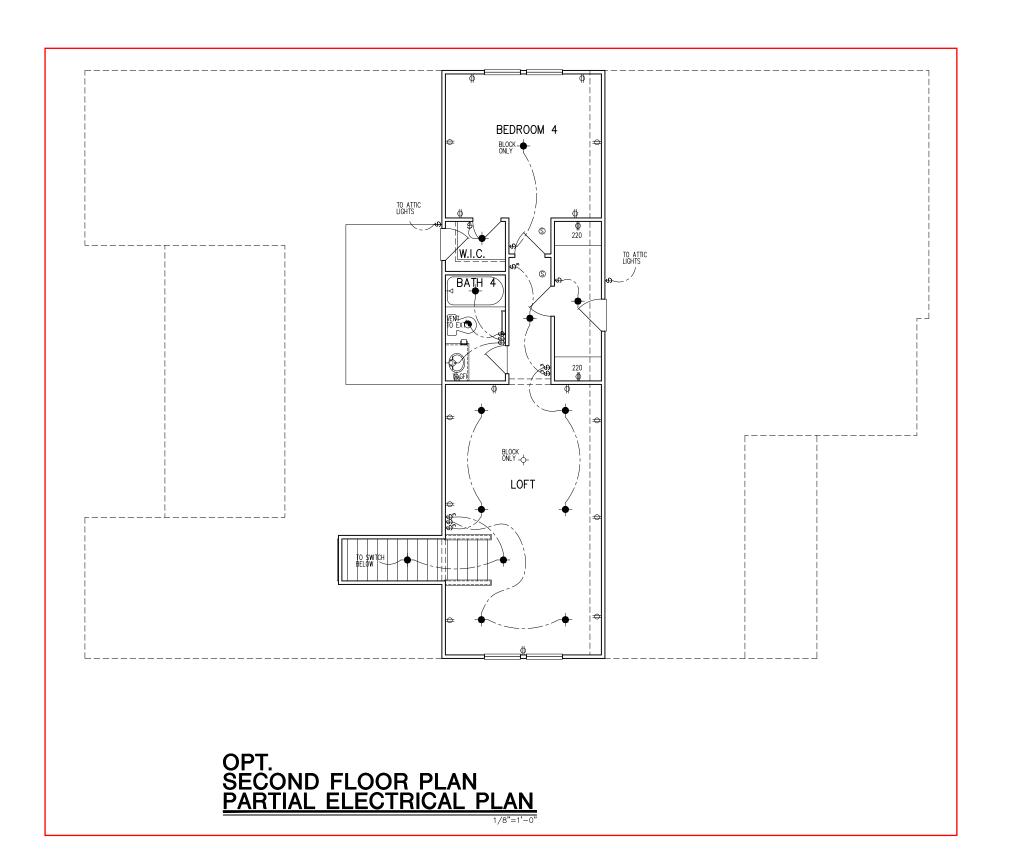

Dointe HOMES RR BLVD, SUITE 400, RALEIGH, NC 27607

Business Operations 5440 Wade Park Blvd Suite 400 Raleigh, NC 27607

OPTION Lot 335 67 Firefly Ln Altis at Serenity PLAN


FLR ELEC. SUBDIVISION: ADDRESS: 2ND

10-01-24 ACC Drawn By:

5921-08

(FOXTAIL MANOR

01.E20

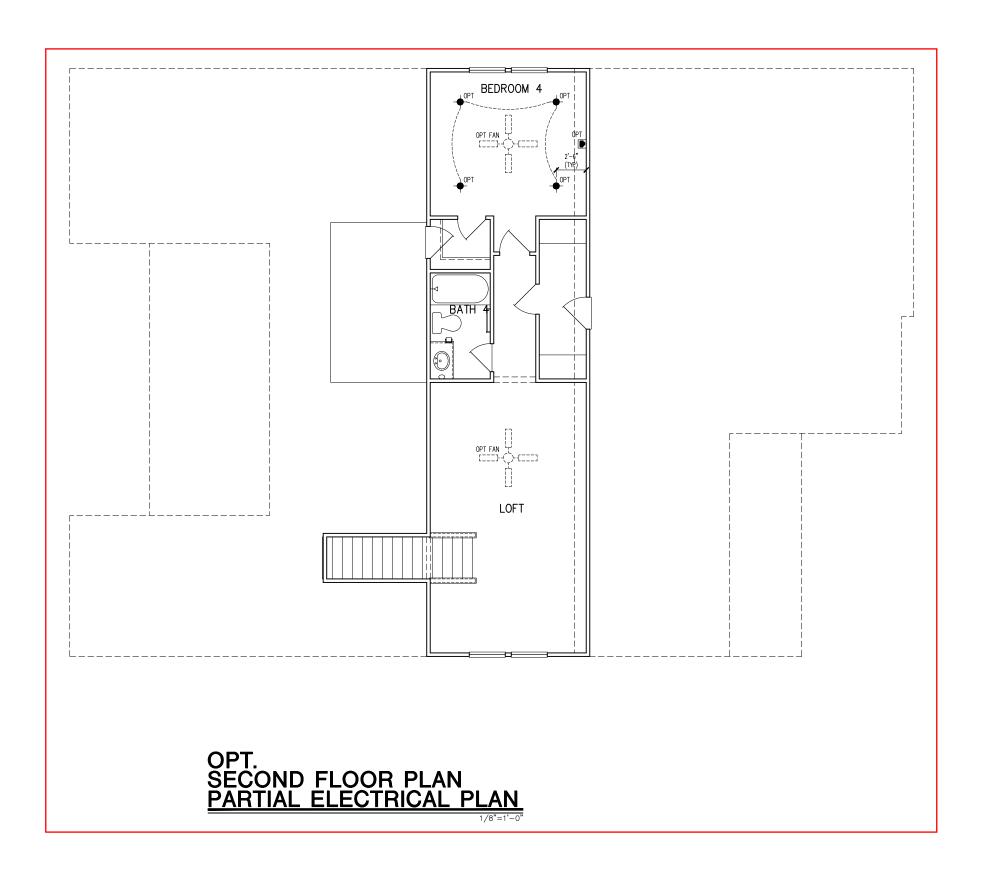

tri pointe, HOMES HOW WAS BUILT 400, RALEGY, NC 27607

Business Operations 5440 Wade Park Blvd Suite 400 Raleigh, NC 27607

2ND FLOOR ELEC. PLAN

SUBDIVISION:
ADDRESS:
LOT: BI

Drawn By: ACC

5921-08

FOXTAIL MANOR

SHEET#: 01.Е21

GENERAL STRUCTURAL NOTES

FLOOR FRAMING

- I IOISTS/TRUSSES SHALL BE DESIGNED BY MANUE TO MEET OR EXCEED L/480 LIVE LOAD DEFLECTION CRITERIA. (EXCLUDES STONE/MARBLE OR WET BED CONSTRUCTED FLOORS - CONTACT M&K FOR EXCLUDED FLOOR DESIGNS)
- PER THE GUIDELINES OF THE TILE COUNCIL OF NORTH AMERICA (TCNA HANDBOOK), IT SHALL BE THE FLOOR FINISH INSTALLER'S RESPONSIBILITY TO VERIEY THAT THE FINISHES TO BE INSTALLED. MATCH THE DESIGN CRITERIA NOTED ABOVE (UNDER "DESIGN
- FLOOR SYSTEMS & SHEATHING HAVE BEEN DESIGNED TO SUPPORT ADDITIONAL DEAD LOAD FROM CERAMIC TILE (EXCLUDING MARBLE OR STONE). HOWEVER, IT SHALL BE THE FLOOR FINISH INSTALLER'S RESPONSIBILITY TO PROVIDE PROPER UNDERLAYMENT, UNCOUPLING MEMBRANE AND MORTAR/GROUT PER THE ASSEMBLY DESIGNATIONS IN THE TONA HANDBOOK (TILE COUNCIL OF NORTH AMERICA).
- AT I-JOIST FLOORS, PROVIDE I 1/8" MIN. OSB RIM BOARD.
- METAL HANGERS SHALL BE SPECIFIED BY MANUFACTURER, U.N.O.
- I-JOIST/TRUSS SHOP DWGS. SHALL BE SUBMITTED TO ARCH. & ENG. FOR REVIEW AND APPROVAL PRIOR TO FABRICATION OR DELIVERY
- FLOOR SHEATHING SHALL BE 23/32" A.P.A. RATED 'STURD-I-FLOOR' 24" O.C. EXPOSURE I (OR APPROVED EQUAL) WITH TONGUE AND GROOVE EDGES. FASTEN TO FRAMING MEMBERS W GLUE AND
- 2 ½" × 0.131" NAILS @ 6"o.c. @ PANEL EDGES & @ 12"o.c. FIELD.
- 2 3" x 0.120" NAILS @ 4" O.C. @ PANEL EDGES & @ 8" O.C. FIELD. - 2 3 × 0.113" NAILS @ 3" O.C. @ PANEL EDGES \$ @ 6" O.C. IN FIELD

ROOF FRAMING

- ROOF SHEATHING SHALL BE 7/16" A.P.A. RATED SHEATHING 24/16 EXPOSURE I (OR APPROVED EQUAL). FASTEN TO FRAMING MEMBERS
- W/ 2 ½" x 0.131" NAILS @ 6"o.c. @ PANEL EDGES \$ @ 12" O.C. FIELD.
- · w/ 2 🖁 × 0.120" NAILS 🥑 4"o.c. 💇 PANEL EDGES 🕏 🗗 O.C. FIELD. - w/ 2 3 × 0.113" NAILS @ 3"o.c. @ PANEL EDGES & @ 6" O.C. FIELD.
- WITHIN 48" OF ALL ROOF FDGES RIDGES & HIPS FASTEN ROOF SHEATHING FIELDS PER EDGE NAILING SPEC.
- EASTEN EACH ROOF TRUSS TO TOP PLATE W/ SIMPSON H25T CLIP (OR APPROVED EQUAL) • ALL BEARING POINTS. PROVIDE (2) H2.51 CLIPS AT 2-PLY GIRDER TRUSSES, (3) H2.5T CLIPS AT 3-PLY GIRDER TRUSSES & ROOF BEAMS - AT ALL BEARING POINTS.
- METAL HANGERS SHALL BE SPECIFIED BY THE MANUFACTURER, U.N.O.
- ROOF TRUSS SHOP DWGS SHALL BE SUBMITTED TO ARCH & ENG. FOR REVIEW AND APPROVAL PRIOR TO FABRICATION OR DELIVERY
- ERECT AND INSTALL ROOF TRUSSES PER WTCA & TPI'S BCSI I "GUIDE TO GOOD PRACTICE FOR HANDLING, INSTALLING & BRACING
- OF METAL PLATE CONNECTED WOOD TRUSSES." SUPPORT SHORT SPAN ROOF TRUSSES W/2x4 LEDGER FASTENED TO

FRAMING w/(2) 3" x 0.120" NAILS @ 16" O.C. (UP TO 7' SPAN).

CONNECTION SPECIFICATIONS (TYP. U.N.O.)

DESCRIPTION OF BLDG. ELEMENT	3"x0.131" NAILS	3"x0.120" NAIL5	
JOIST TO SOLE PLATE	(3) TOENAILS	(3) TOENAILS*	
SOLE PL. TO JOIST/RIM OR BLK'G	NAILS @ 4" o.c.	NAILS @ 4" o.c.	
STVD TO PLATE	(4) TOENAILS/ (3)END NAILS	(4) TOENAILS/ (4)END NAILS*	
RIM TO TOP PLATE	TOENAILS @ 6" o.c.	TOENAILS @ 4" o.c.*	
BLK'G. BTWN. JOISTS TO TOP PL.	(3) TOENAILS EA. END	(3) TOENAILS EA. END*	
DOUBLE STUD	NAILS @ 16" o.c.	NAILS @ 16" O.C.	
DOUBLE TOP PLATE	NAILS @ 12" o.c.	NAILS @ 8" o.c.	
DOUBLE TOP PLATE LAP SPLICE	(12) NAILS IN LAPPED AREA (24" MIN.)	(15) NAILS IN LAPPED AREA (24" MIN.)	
TOP PLATE LAP @ CORNERS \$ INTERSECTING WALLS	(3) NAILS	(3) NAILS	
RAFTER/TRUSS TO TOP PLATE	(4) TOENAILS +	(4) TOENAILS +	
	(I) SIMPSON H2.5T	(I) SIMPSON H2.5T	
GAB. END TRUSS TO DBL. TOP PL.	TOENAILS @ 8" o.c.	TOENAILS @ 6" O.C.	
R.T. w/ HEEL HT. 9 ¼" TO 12"	2xIO BLK EVERY 3RD BAY FASTENED TO DBL. TOP PLATE w/ TOENAILS @ 6" O.C.	2XIO BLK EVERY 3RD BAY FASTENED TO DBL. TOP PLATE w/ TOENAILS @ 4" O.C.	
R.T. w/ HEEL HT. 12" TO 16"	2XI2 BLK EVERY 3RD BAY FASTENED TO DBL. TOP PLATE w/ TOENAILS @ 6" O.C.	2xI2 BLK EVERY 3RD BAY FASTENED TO DBL. TOP PLATE w/ TOENAILS @ 4" O.C.	
R.T. w/ HEEL HT. UP TO 24"	LAP WALL SHTG. W/ DBL. TOP PL. & INSTALL ON TRUSS VERT FASTEN W/ NAILS @ 6" O.C.	LAP WALL SHTG. W/ DBL. TOP PL. \$ INSTALL ON TRUSS VERT FASTEN W/ NAILS @ 6" O.C.*	
R.T. w/ HEEL HT. 24" TO 48"	LAP WALL SHTG. W/ DBL. TOP PL. & INSTALL ON TRUSS VERT FASTEN W/ NAILS @ 6" O.C. PROVIDE 2x BLK @ EA. BAY AT TOP OF HEEL	LAP WALL SHTG. W/ DBL. TOP PL. & INSTALL ON TRUSS VERT FASTEN W/ NAILS @ 6" O.C. PROVIDE 2x BLK @ EA. BAY AT TOP OF HEEL*	
WALL TO FOUNDATION	WALL SHTG. LAP W/ SILL PL. & FASTENED PER SHEAR WALL FASTENING SPEC.		
2½"x0.113 IS AN ACCEPTABLE ALTERNATIVE TO A 3"x0.120", SAME SPACING OR NUMBER OF NAILS. (ONLY ACCEPTABLE WHERE * ARE SHOWN)			

GENERAL STRUCTURAL NOTES

DESIGN LOADING

- DESIGN IS BASED ON 2018 NORTH CAROLINA STATE BUILDING CODE: RESIDENTIAL CODE.
- WOOD FRAME ENGINEERING IS BASED ON NDS, "NATIONAL DESIGN SPECIFICATION FOR WOOD CONSTRUCTION" - LATEST EDITION.
- DESIGN LOADS ROOF

SNOW = 15 PSF (12 PSF GROUND SNOW, TRUSSES) LIVE = 20 PSF (REDUCIBLE BASED ON ROOF PITCH) DEAD = 7 PSF T.C., IO PSF B.C.

LOAD DURATION FACTOR = 1.25

LIVE = 40 PSE (30 PSE @ SLEEPING AREAS) DEAD = 10 PSF (I-JOISTS), 15 PSF (FLOOR TRUSSES) ADD'L IO PSE @ CERAMIC TILE IN KITCHEN. SUNROOMS, BATHS, FOYER, LAUND, & MUDRIN

2,000 PSF ASSUMED ALLOWABLE BEARING PRESSURE (TO BE VERIFIED BY BUILDER)

115 MPH, EXPOSURE B

GENERAL FRAMING

- ALL TYP, NAIL FASTENER REQUIREMENTS ARE NOTED IN STANDARD CONNECTIONS TABLE (IRC TABLE R602.3(1)) OR ON PLANS. ALL NAILS SPECIFIED ARE MIN DIAMETER AND LENGTH REQUIRED FOR CONNECTION. ALL HANGER NAILS SHALL BE INSTALLED PER MANUFACTURER'S REQUIREMENTS FOR MAX CHARTED CAPACITY NOTE: HANGERS USE COMMON NAIL DIAMETERS NOT TYPICAL FRAMING GUN NAILS.
- EXT & INT BEARING WALLS SHALL BE 2x4 OR 2x6 (AS SHOWN ON PLANS) @ 16" O.C. SPF/SP #2 GRADE LUMBER, OR BETTER, U.N.O.. · WALLS OVER 12' TALL SHALL BE PER PLAN.
- ALL INTERIOR BEARING WALLS ARE ASSUMED TO BE SHEATHED W/ GYP WALL BOARD (ONE SIDE MIN.) OR PROVIDE MID HT. BLOCKING.
- ALL HEADERS, BEAMS & OTHER STRUCTURAL MEMBERS SHALL BE SPRUCE-PINE-FIR #2 (SPE) OR SOUTHERN PINE #2 (SP) LUMBER, OR BETTER, SUPPORT ALL HEADERS/ BEAMS W/ (1)2x JACK STUD & (1)2x KING STUD MINIMUM
- THE NUMBER OF STUDS SPECIFIED AT A SUPPORT INDICATES THE NUMBER OF JACK STUDS REQUIRED, U.N.O.,
- ALL NON-BEARING INTERIOR STUD WALLS SHALL BE CONSTRUCTED WITH 2x 'STUD' GRADE MEMBERS SPACED @ 24" O.C. (MAX., U.N.O.)

 • HEADERS IN NON-LOAD BEARING WALLS SHALL BE: (I)2x4/6 FLAT @ OPENINGS UP TO 4', (2)2x4/6 FLAT UP TO 8'.
- ALL FRAMING LUMBER SHALL BE DRIED TO 15% MC (KD-15)
- ENGINEERED LUMBER BEAMS TO MEET OR EXCEED THE FOLLOWING: • 'LVL' - Fb=2600 psi; Fv=285 psi; E=2.0x10^6 psi
- ENGINEERED LUMBER POSTS TO MEET OR EXCEED THE FOLLOWING 'LVL' - Fb=2400 psi; FcII=2500 psi; E=I.8xI0^6 psi
- FOR 2 & 3 PLY BEAMS OF EQUAL 134" MAX. WIDTH, FASTEN PLIES TOGETHER WITH 3 ROWS OF 3"X0.120" NAILS @ 8" O/C OR 2 ROWS 18"x3K" SIMPSON SDS SCREWS (OR 3K" TRUSSI OK SCREWS) @ 16" GREATER. APPLY EASTENING AT BOTH FACES FOR 3-PLY CONDITION. LOCATE TOP & BOTTOM NAILS/SCREWS 2" FROM EDGE. SOLID 31/3" OR 51/4" BEAMS ARE ACCEPTABLE, USE 2 ROWS OF NAILS FOR 2x6 \$ 2x8 MEMBERS
- TOGETHER WITH 3 ROWS OF 1/2"x6" SIMPSON SDS SCREWS (OR 6 3/4" TRUSSLOK SCREWS) @ 16" O/C. USE A MINIMUM OF 4 ROWS FOR BEAM DEPTHS OF 14" OR GREATER, APPLY FASTENING AT BOTH FACES (ONE SIDE ONLY FOR TRUSSLOK SCREWS). LOCATE TOP ANI BOTTOM SCREWS 2" FROM EDGE. A SOLID 7" BEAM IS ACCEPTABLE
- PROVIDE SOLID BLOCKING IN FLOOR SYSTEM UNDER ALL POSTS CONTINUOUS TO FND./BEARING. BLOCKING TO MATCH POST ABOVE.
- ALL EXTERIOR 4x4 WOOD POSTS SHALL HAVE SIMPSON BCS2-2/4 CAP & ABW44 BASE, U.N.O.
- CORROSION NOTES
- BUILDER RESPONSIBLE TO DETERMINE CORROSION-RESISTANCE REQUIREMENTS AND COMPATIBILITY OF HARDWARE FASTENERS AND CONNECTORS FOR ENVIRONMENTAL EXPOSURE AND IN CONTACT W/ PRESERVATIVE-TREATED WOOD OF ACTUAL FINAL CONDITIONS AND SOURCED MATERIALS. CONTACT LUMBER & HARDWARE SUPPLIERS TO COORD.

Lot 335

Plan 5921-08 Elevation B- Garage Left

FOXTAIL MANOR

Opt Extended Covered Outdoor Living

GENERAL STRUCTURAL NOTES

FOUNDATION

- DESIGN IS BASED ON 2018 NORTH CAROLINA STATE BUILDING CODE
- FOOTING DESIGN 2,000 PSF ALLOWABLE SOIL BEARING PRESSURE IS ASSUMED. BUILDER/CONTRACTOR MUST VERIFY.
- FASTEN 2x4/6 SILL PLATES TO CONC FND WITH A MINIMUM OF 2 ANCHORS PER PLATE 12" MAX FROM PLATE ENDS - UTILIZING:
- I/2" DIA. ANCHOR BOLTS 6'-0" O.C,7" MIN. EMBEDMENT I/2" DIA. x 6" LONG SIMPSON TITEN HD @ 6'-0" O.C.
- SIMPSON MASA ANCHOR STRAPS @ 6'-0" O.C. (CONCRETE)
- ALL LUMBER EXPOSED TO WEATHER OR IN CONTACT W/ PERIMETER
- FOUNDATION SHALL BE PRESERVATIVE TREATED SOUTHERN PINE #2. BUILDER TO VERIEY CORROSION-RESISTANCE COMPATIBILITY OF HARDWARE & FASTENERS IN CONTACT W/ PRESERVATIVE-TREATED
- WOOD CONTACT LIMBER & HARDWARE SUPPLIERS TO COORD • FOOTINGS SHALL BE PLAIN CONCRETE, U.N.O.
- CONCRETE DESIGN BASED ON ACL 318, CONCRETE SHALL ATTAIN THE FOLLOWING MIN. COMPRESSIVE STRENGTHS IN 28 DAYS, U.N.O. f'c = 3,000 psi: FOOTINGS & INTERIOR SLABS ON GRADE 3500 psi: GARAGE & EXTERIOR SLABS ON GRADE fu = 60.000 psi
- ALL CONCRETE EXPOSED TO THE WEATHER SHALL NOT HAVE LESS THAN 5% OR MORE THAN 7% AIR ENTRAINMENT
- ALL FOOTINGS SHALL BEAR BELOW FROST LINE (TYP.) OR 12" MIN I REGIONS WHERE CODE FROST DEPTH IS NOT APPLICABLE. CONSULT SOILS REPORT OR BUILDING DEPT. FOR MINIMUM DEPTH BELOW GRADE
- FOOTINGS AND SLABS ON GRADE SHALL BEAR ON VIRGIN SOIL OR
- PROVIDE CONTROL JOINTS AT ALL INSIDE CORNERS OF SLAB EDGES, AND OTHER LOCATIONS WHERE SLAB CRACKS ARE LIKELY
- JOINTS SHALL BE LOCATED @ 10'-0" O.C. (RECOMMENDED) OR 15'-0" O.C. (MAXIMUM)
- JOINT GRID PATTERN SHALL BE AS CLOSE TO SQUARES AS POSSIBLE (I:I RATIO), WITH A MAXIMUM OF I:1.5 RATIO
- · CONTROL JOINTS SHALL NOT BE INSTALLED IN STRUCTURAL
- DIMENSIONS BY OTHERS, BUILDER TO VERIFY

HOLD-DOWN SCHEDULE

1025 507 11 50125522		
SYMBOL	SPECIFICATION	
► HD-I	SIMPSON CSI6 STRAP TIE W/ 14" END LENGTH	
► HD-2	SIMPSON MSTC66 STRAP TIE W 24" END LENGTH	
► HD-3	SIMPSON HTT4 HOLD-DOWN *	
► HD-4	SIMPSON HDU5-SDS2.5 HOLD-DOWN *	
HD-5	SIMPSON STHDI4RJ HOLD-DOWN *	

UTILIZE SIMPSON "SET-3G" EPOXY SYSTEM TO FASTEN 5%" DIA. THREADED ROD INTO CONCRETE FOUNDATION. PROVIDE 12" MIN. EMBEDMENT INTO CONCRETE. INSTALL PER MANUE RECOMMENDATIONS. DO NOT LOCATE ANCHORS WITHIN I 34" OF EDGE OF FOUNDATION

MEANS & METHODS NOTES

THE STRUCTURE IS DESIGNED TO BE SELF SUPPORTING AND STABLE AFTER THE BUILDING IS FINISHED AND ALL PLAN, DETAIL, AND NOTE SPECIFICATIONS HAVE BEEN COMPLETED. IT IS THE CONTRACTOR'S SOLE RESPONSIBILITY TO DETERMINE THE ERECTION PROCEDURES AND SEQUENCE TO THE SAFETY OF THE BUILDING AND ITS COMPONENTS DURING CONSTRUCTION. THIS INCLUDES BUT IS NOT LIMITED TO, THE ADDITION OF NECESSARY SHORING, SHEETING, TEMPORARY BRACING, GUYS, AND TIE-DOWNS. CONTRACTOR SHALL BE RESPONSIBLE FOR ALL SHORING AND BRACING REQUIRED TO STABILIZE AND PROTECT EXISTING AND ADJACENT STRUCTURES AND SYSTEMS DURING COURSE OF DEMOLITION AND CONSTRUCTION

STRUCTURAL DESIGN AND SPECIFICATIONS ASSUME THAT ALL SUPPORTING AND NON-SUPPORTING ELEMENTS IN CONTACT WITH FLOOR FRAMING ARE LEVEL, INCLUDING, BUT NOT LIMITED TO: FOUNDATIONS SLABS ON GRADE, BEAMS, WALLS, AND NON-BEARING ELEMENTS. IT IS THE CONTRACTOR'S RESPONSIBILITY TO VERIEY LEVELNESS AND MAKE ADJUSTMENTS AS NECESSARY, INCLUDING CONSIDERATION OF THOSE AREAS THAT MAY BE WITHIN CONTRACTUAL, INDUSTRY OR WARRANTY TOLERANCES

VENEER LINTEL SCHEDULE

SPAN (MAX)	HEIGHT OF VENEER ABOVE LINTEL	STEEL ANGLE SIZE	
3'-0"	20 FT. MAX	L3"x3"x¼"	
	3 FT. MAX	L3"x3"x¼"	
6'-0"	I2 FT. MAX	L4"x3"x¼"	
	20 FT. MAX	L5"x3½"x¾"	
8'-0"	3 FT. MAX	L4"x4"x¼" *	
8-0	I2 FT. MAX	L5"x3½"x¾"	
	I6 FT. MAX	L6"x3½"x¾"	
9'-6"	I2 FT. MAX	L6"x3½"x¾"	
16'-0"	2 FT. MAX	L7"x4"x½" **	
	3 FT MAX	1.8"x4"x/6" **	

- ALL LINTELS

 **SHALL SHOPE 7.2 %* 3 ½* VENEER w/ 40 psi MAXIMM MEIGHT.

 (16 SHALL HAVE 4" NIN, EEARNIG

 (16 SHALL HAVE 4" NIN, EEARNIG

 (16 SHALL HAVE 5" NIN, EEARNIG

 **(16 SHALL HAVE 16 SHIDED PACK TO HEADER IN WALL 446"02. w/ ½* DIA x 3 ½*

 LONG LAG SCREPES IN 2" LONG VERTICALLY SLOTTED HOLES.

 **MALL ER FORSTEDE PACK TO ROCKIT HE GET HOLES.

 **ALL LINTELS SHALL BE LONG LEG VERTICALLY SLOTTED HOLES.

 **ALL LINTELS SHALL BE LONG LEG VERTICAL.*

 **ALL LINTELS SHALL BE LONG LEG VERTICAL.*

 **HALL SHAPPLIST TO SHE 3 ½* WILE OVER THE BEARNIG LENGTH ONLY. THIS

 **SHE'S SHAPPLIST HAS TOR ANY LINTEL CADITION NOT ENCOMPASSED BY THE ABOVE PRAVAMETERS.

* FOR QUEEN VENEER USE L4x3%;". ** FOR 3½" VENEER ONLY, SEE PLAN FOR VENEER SUPPORT IF VENEER < 3½" THICK

I-JOIST MANUFACTURER

ADDITIONAL NOTES FOR TRUSS \$

ROOF TRUSS, FLOOR TRUSS AND ENGINEERED JOISTS SHALL BE DESIGNED TO MEET THE DEFLECTION CRITERIA BELOW, UNLESS NOTED OTHERWISE ON PLAN. MULHERN & KULP CANNOT BE HELD RESPONSIBLE FOR ANY STRUCTURAL ISSUES
RELATED TO ANY BUILDING COMPONENT IF COMPONENT SHOP DRAWINGS ARE NOT SUBMITTED TO M&K FOR REVIEW PRIOR TO FABRICATION, DELIVERY, OR INSTALLATION.

TRUSSES/LIGISTS SHALL BE DESIGNED SO THAT DIFFERENTIAL DEFLECTION BETWEEN ADJACENT PARALLEL TRUSSES/JOISTS OR GIRDER TRUSSES/FLUS BEAMS DO NOT EXCEED THE FOLLOWING: A ROOF TRUSSES.

1/4" DEAD LOAD

B. FLOOR TRUSSES, ATTIC TRUSSES, & I-JOISTS; I/8" DEAD LOAD ABSOLUTE DEAD LOAD DEFECTION OF FLOOR

TRUSSES/ATTIC TRUSSES WHEN ADJACENT TO FLOOR FRAMING BY OTHERS SHALL BE LIMITED TO 3/16". (NO DIFFERENTIAL DEFLECTION,

FLOOR JOIST NOTES

- ALL FLOOR JOISTS SHALL BE THE DEPTI SPECIFIED ON PLAN FLOOR JOISTS SERIES & SPACING IS PER THE FLOOR JOIST MANUF.
- SPACING SHALL NOT EXCEED 19.2" O.C. (MAX.) @ LOCATION OF TILE: SPACING SHALL NOT EXCEED 16" O.C. (MAX.)

LATERAL/WALL BRACING & WALL SHEATHING SPECIFICATIONS

THIS MODEL HAS BEEN DESIGNED TO RESIST LATERAL FORCES RESULTING FROM:

5 MPH WIND IN 2018 NCSBC:RC

(115 MPH WIND SPEED IN ASCE 7-10 WIND MAP, PER IRC R301,2,1,1) EXP. B, RISK CAT. 2 & SEISMIC CAT. A/B.

THE DESIGN WAS COMPLETED PER 2015 IBC (SECTION 1609) & ASCE 7-10, AS PERMITTED BY R301.1.3 OF THE 2018 NCSBC:RC, ACCORDINGLY THIS MODEL, AS DOCUMENTED AND DETAILED HEREWITHIN, IS ADEQUATE TO RESIST THE CODE REQUIRED LATERAL FORCES.

DESIGN WIND UPLIET LOADS HAVE BEEN CALCULATED UTILIZING ASCE 7-10 (ACCEPTED ENGINEERING PRACTICE) AS ALLOWED PER 2018 NCSBC:RC SECTION R802.II.I.I. THIS MODEL HAS BEEN DETAILED WHERE REQUIRED & ENGINEERED TO RESIST THE WIND UPLIFT LOAD PATH PER SECTIONS R602.3.5& R802.II.

EXT. WALL SHEATHING SPECIFICATION

- 7/16" OSB OR 15/32" PLYWOOD: FASTEN SHEATHING W/ 2 ₹x0.113 NAILS @ 6" O.C. AT EDGES & @ 12" O.C. IN THE PANEL FIELD. (TYP, U.N.O.) ALL SHEATHING PANELS SHALL BE ORIENTED
- VERTICALLY (LONG DIRECTION PARALLEL TO STUDS) AND INSTALLED FULL HEIGHT OF SHEAR WALL - OR 2x HORIZONTAL BLOCKING SHALL BE PROVIDED TO SUPPORT ALL UNSUPPORTED PANEL EDGES & EDGE
- ALL EXT. WALLS SHALL BE CONTINUOUSLY SHEATHED AND ARE CONSIDERED SHEAR WALLS.
- ALT. STAPLE CONNECTION SPEC: 1 3/4" 16 GA STAPLES (1/6" CROWN) @ 3" O.C. AT EDGES \$ @ 6" O.C IN FIELD.


<u>3" O.C. EDGE NAILING</u>

 AT DESIGNATED AREAS - FASTEN PANEL EDGES OF WOOD STRUCTURAL WALL SHEATHING TO FRAMING W 2 3" x 0.113" NAILS @ 3" O.C. AND 12" O.C. IN THE PANEL FIELD NO STAPLE ALTERNATIVE AVAILABLE AT THIS SPEC. ALL SHEATHING PANELS SHALL BE ORIENTED VERTICALLY (LONG DIRECTION PARALLEL TO STUD) AND INSTALLED FULL HEIGHT OF SHEAR WALL - OR - 2x HORIZONTAL BLOCKING SHALL BE PROVIDED TO SUPPORT UNSUPPORTED PANEL EDGES AND 3" O.C. EDGE FASTENING.

TYP. UNIT SEPARATION WALL SHEATHING SPECIFICATION

•1/2" OR 5/8" GYPSUM WALL BOARD: FASTEN GWB SHEATHING TO FRAMING W/ I \$"X0.086" COOLER NAILS OR I 1/4" DRYWALL SCREWS @ 7" O.C. " PANEL EDGES & PANEL FIELD (INCLUDING T&B PLATES

- SEE CONNECTION SPECIFICATIONS CHART FOR STANDARD SHEAR TRANSFER DETAILING. IF ADDITIONAL CAPACITY IS REQUIRED BY DESIGN. FWILL BE SPECIFICALLY NOTED ON PLAN.
- DESIGN ASSUMES 16" O.C MAX. STUD SPACING, U.N.O.
- · ALL STRUCTURAL PANELS ARE TO BE DIRECTLY APPLIED TO STUD FRAMING.
- PRE-MANUFACTURED PANELIZED WALLS: FASTEN TOGETHER END STUDS OF WALL PANELS SHFATHED W/ OSB OR PLYWOOD W/ 3" x 0.120" NAILS @ 4" O.C. (THRU ONE SIDE ONLY)

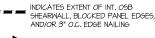

INDICATES HOLDOWN

MULHERN+KULP
RESIDENTIAL STRUCTURAL ENGINEBRING



lulhern+Kulp project numbe 243-2403

SMI SMM/F0 frawn by: ssue date: 11-07-2024

REVISIONS

)5/15/2025 JPP


NOTES MODE

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SERENITY MASTER SET RALEIGH, NC 5921

GENERAL

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NC Licence # C-30.25

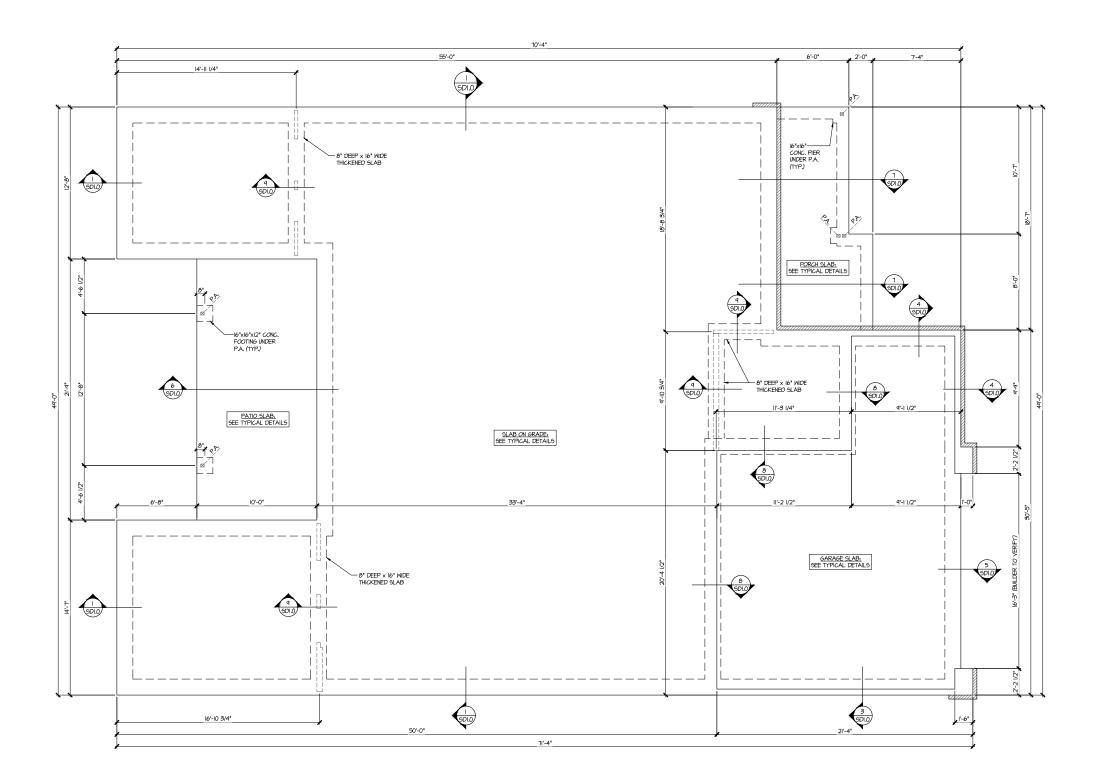

Mulhern+Kulp project number:

243-24034

SMK drawn by: SMM/FC issue date: 11-07-2024

REVISIONS:

date: 05/15/2025 MISC. ARCH UPDAT initial: JPP

tri pointe

LEGEND

- IIIIII INTERIOR BEARING WALL
- ==== BEARING WALL ABOVE (B.W.A.)
- --- BEAM / HEADER
- INDICATES EXTENT OF INT.

 OSB SHEARWALL AND/OR
 3" O.C. EDGE NAILING
- EXTENT OF VALLEY TRUGS OVERFRAMING
 24" O.C. (MAX.)
- EXTENT OF FLOOR SYSTEM TO BE DESIGNED FOR TILE
- NDICATES HOLDOWN

- * INDICATES POST ABOVE. PROVIDE SOLID BLOCKING UNDER POST OR JAMB ABOVE.


REFER TO SO.O FOR TYPICAL STRUCTURAL NOTES # SCHEDULES


FOUNDATION PLAN

5921-08 MODEI SERENITY MASTER SET RALEIGH, NC

S1.0M

SLAB FOUNDATION PLAN SCALE: 1/4"=1'-0" (22x24 SHEET) ELEV. A 1/8"=1'-0" (IIxIT SHEET)

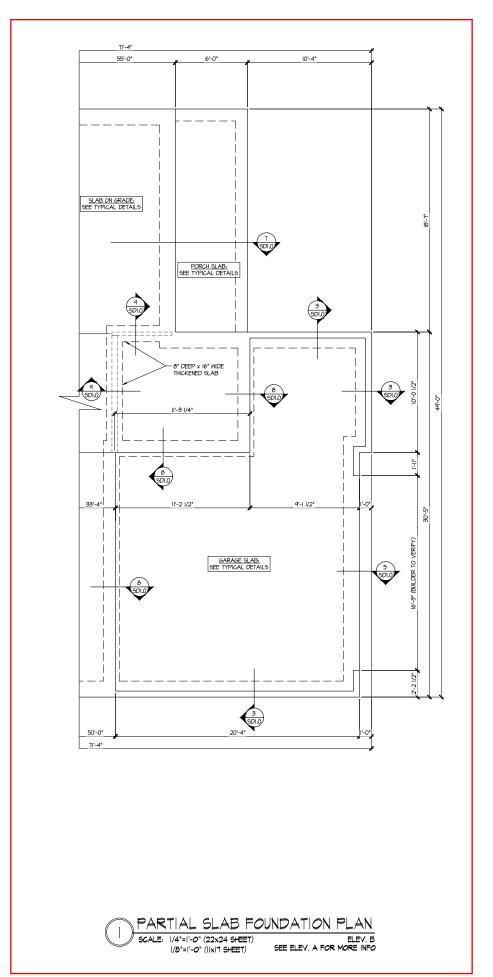

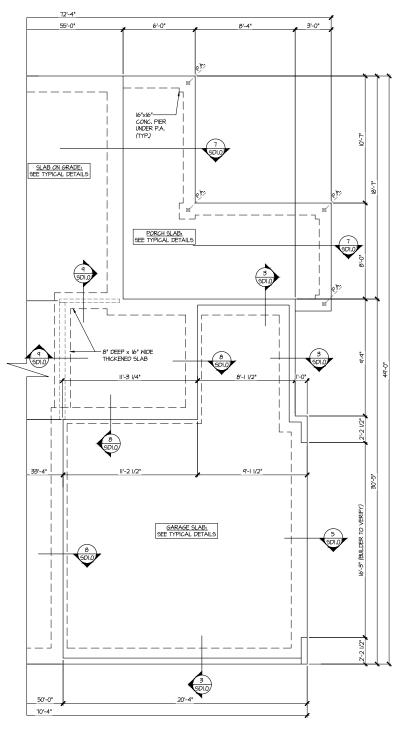

PARTIAL SLAB FOUNDATION PLAN ELEV. C SEE ELEV. A FOR MORE INFO SCALE: 1/4"=1'-0" (22x24 SHEET) 1/8"=1'-0" (IIxI7 SHEET)

REFER TO SO.O FOR TYPICAL STRUCTURAL NOTES # SCHEDULES

LEGEND

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 3" O.C. EDGE NAILING
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 24" O.C. (MAX.)

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- NDICATES HOLDOWN
- JL METAL HANGER
- * INDICATES POST ABOVE. PROVIDE SOLID BLOCKING UNDER POST OR JAMB ABOVE.

MULHERN+KULP

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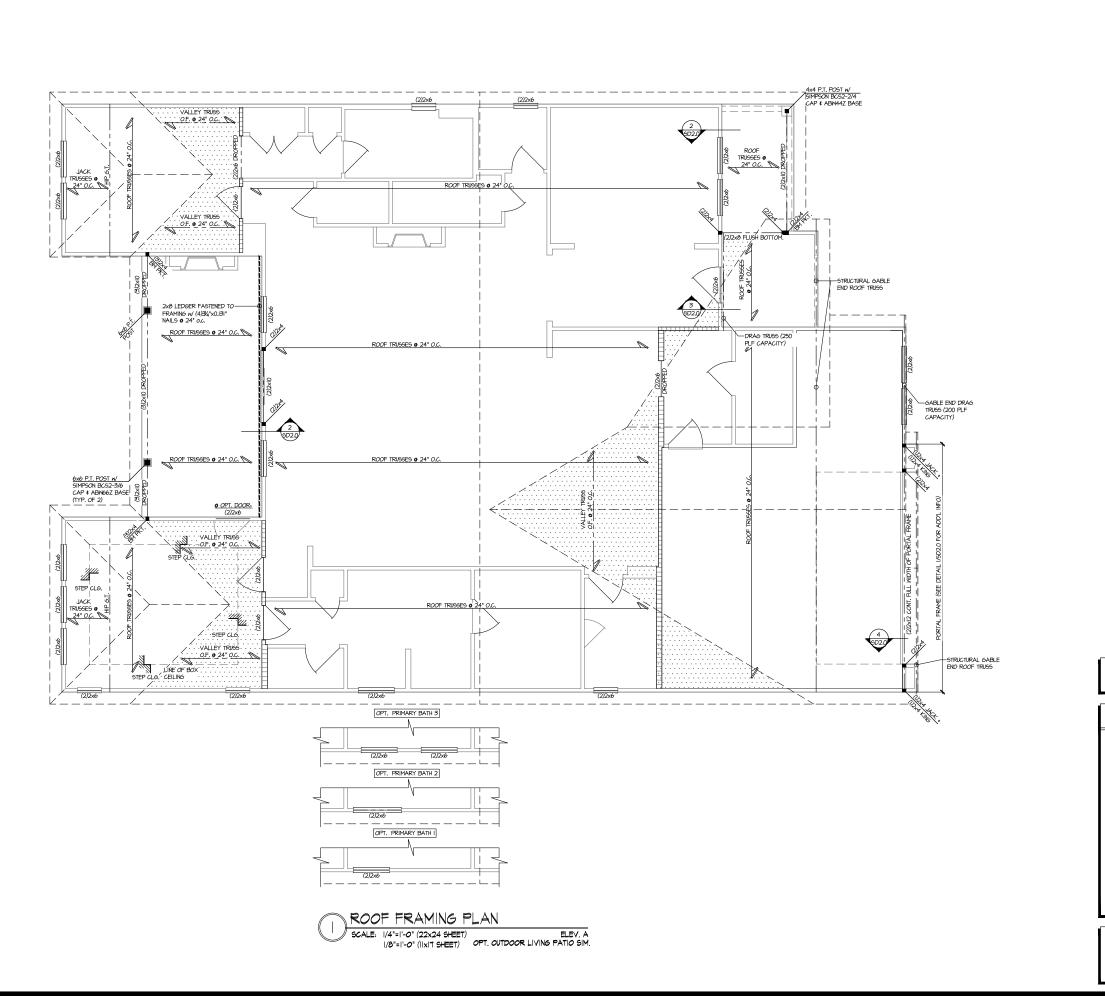
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FOUNDATION PLAN 5921-08 MODEI SERENITY MASTER SET RALEIGH, NC

S1.1M



Seal: 5/19/25

CAROLINE SEAL

OR 7622

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MULHERNAH STRUCTURAL ENGINEERING 3655 Broutside Parkway, Suite 250 - Algherette, GA 30022 p.778-777-6874 - markemichpasm NC Licence # C-38.25



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drawn by: SMM/FC issue date: 11-07-2024

REVISIONS:

date: initial:
05/15/2025 JPP
MSC. ARCH UPDATES

tri pointe

THIS LEVEL HAS BEEN DESIGNED FOR 9'-1" PLATE HEIGHT

LEGEND

- INTERIOR BEARING WALL
- ==== BEARING WALL ABOVE (B.W.A.)
- --- BEAM / HEADER
- INDICATES EXTENT OF INT.


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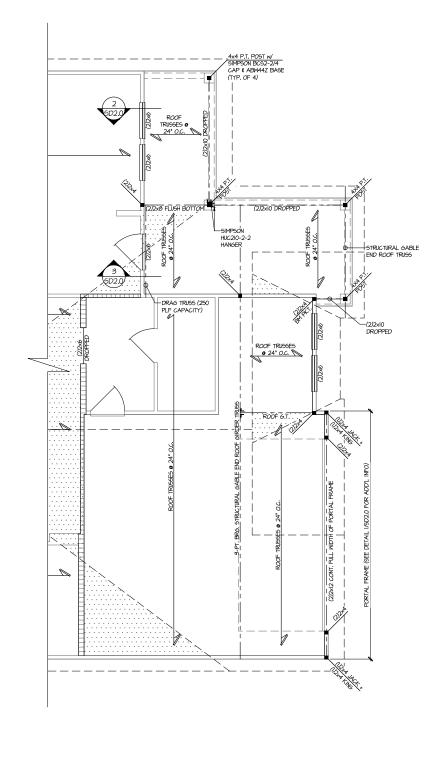
REFER TO SO.O FOR
TYPICAL STRUCTURAL NOTES
\$ SCHEDULES

ROOF FRAMING PLAN 5921-08 MODEL

S2.0M

SERENITY MASTER SET RALEIGH, NC



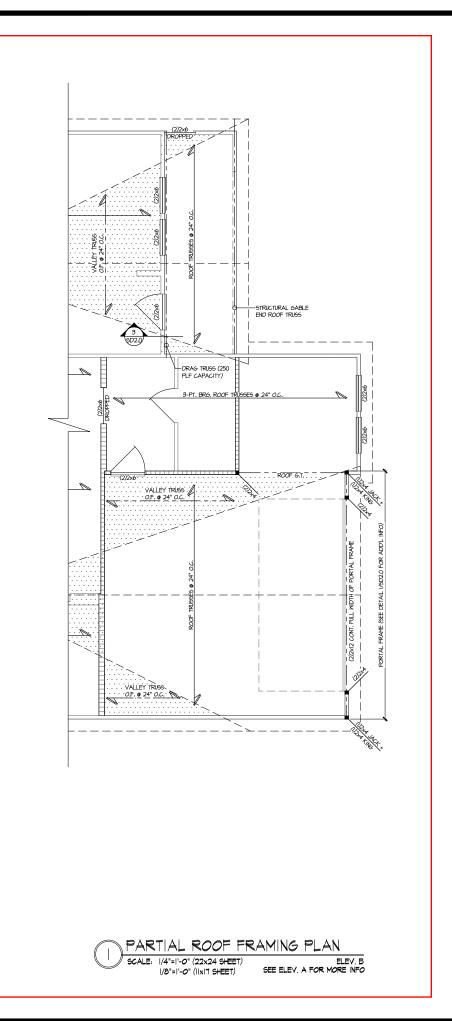

PARTIAL ROOF FRAMING PLAN ELEV. C SEE ELEV. A FOR MORE INFO SCALE: 1/4"=1'-0" (22x24 SHEET) 1/8"=1'-0" (IIxIT SHEET)

FOR 9'-I" PLATE HEIGHT

REFER TO SO.O FOR TYPICAL STRUCTURAL NOTES # SCHEDULES

THIS LEVEL HAS BEEN DESIGNED

LEGEND

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- □===□ BEARING WALL ABOVE (B.W.A.)
- ---- BEAM / HEADER
- INDICATES EXTENT OF INT.

 OSB SHEARWALL AND/OR
 3" O.C. EDGE NAILING
- EXTENT OF VALLEY TRUSS OVERFRAMING 24" O.C. (MAX.)
- EXTENT OF FLOOR SYSTEM TO BE DESIGNED FOR TILE
- NDICATES HOLDOWN
- JL METAL HANGER
- * INDICATES POST ABOVE. PROVIDE SOLID BLOCKING UNDER POST OR JAMB ABOVE.

MULHERN+KULP

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NC. Licence # C-3925



Mulhern+Kulp project number:

243-24034

SMK drawn by: SMM/FC issue date: 11-07-2024

REVISIONS:

initial: 05/15/2025 MISG. ARCH UPDA JPP

tri pointe

ROOF FRAMING PLAN

5921-08 MODEI

SERENITY MASTER SET RALEIGH, NC

S2.1M



MULHERN + KULP

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NC Licence # C-38.25



Mulhern+Kulp project number:

243-24034

project mgr: SMK drawn by: SMM/FC issue date: 11-07-2024

REVISIONS:

date: initial: 05/15/2025 JPP MSC. ARCH UPDATES

tri pointe

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- | INDICATES POST ABOVE. PROVIDE SOLID BLOCKING UNDER POST OR JAMB ABOVE.

REFER TO SO.O FOR
TYPICAL STRUCTURAL NOTES

\$ SCHEDULES


LOWER ROOF FRAMING PLAN

5921-08 MODEI

SERENITY MASTER SET RALEIGH, NC

sheet:

S3.0M

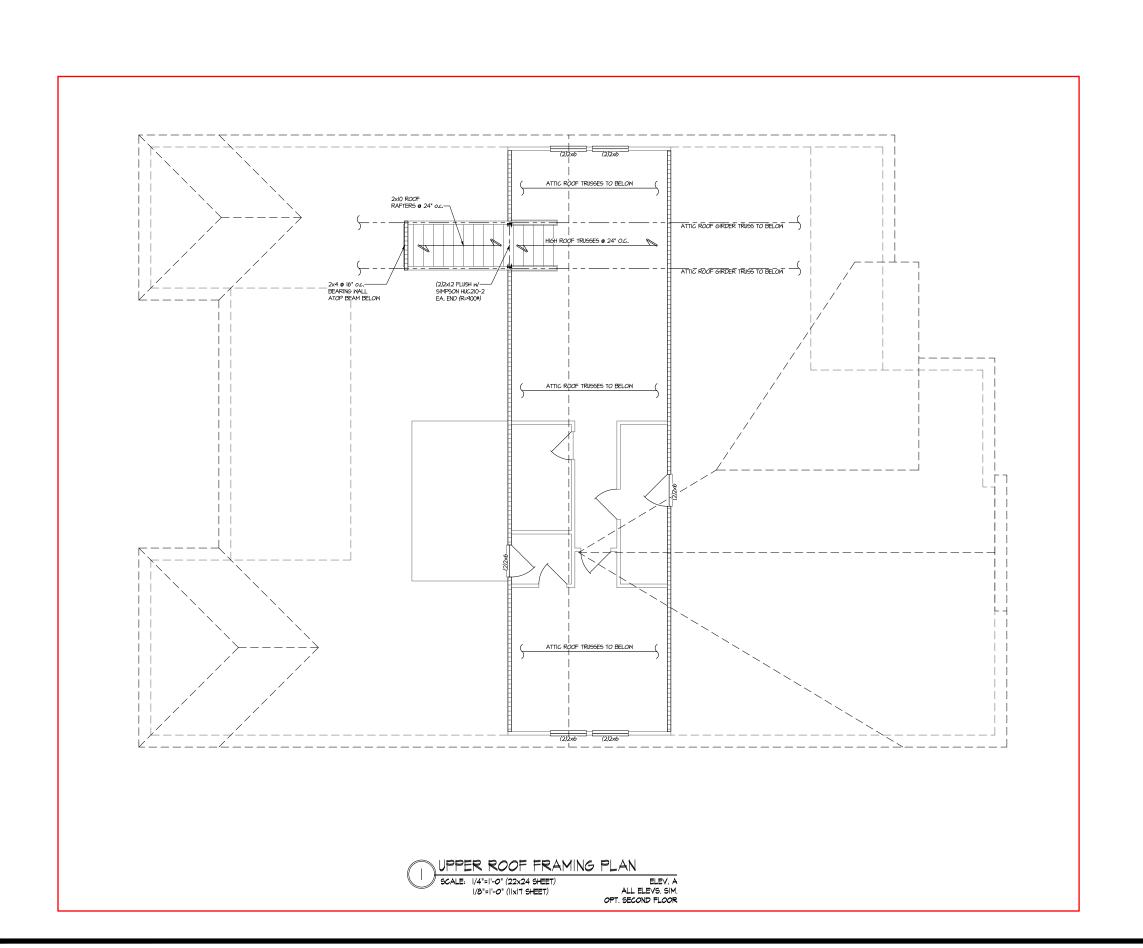



MULHERN + KULP

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Mulhern+Kulp project number:

243-24034

project mgr: SMK drawn by: SMM/FC issue date: 11-07-2024

REVISIONS:

date: in 05/15/2025

date: initial: O5/15/2025 JPP

tri pointe

LEGEND

- INTERIOR BEARING WALL
- ==== BEARING WALL ABOVE (B.W.A.)
- BEAM / HEADER
- BEAM / HEADE
- INDICATES EXTENT OF INT.

 OSB SHEARWALL AND/OR
 3" O.C. EDGE NAILING
- EXTENT OF VALLEY TRUSS OVERFRAMING
 24" O.C. (MAX.)
- EXTENT OF FLOOR SYSTEM TO BE DESIGNED FOR TILE
- ► INDICATES HOLDOWN
- ▲ METAL HANGER
- | INDICATES POST ABOVE. PROVIDE SOLID BLOCKING UNDER POST OR JAMB ABOVE.


REFER TO SO.O FOR
TYPICAL STRUCTURAL NOTES
\$ SCHEDULES

UPPER ROOF FRAMING PLAN 5921–08 MODEL

neet:

S4.0M

SERENITY MASTER SET RALEIGH, NC

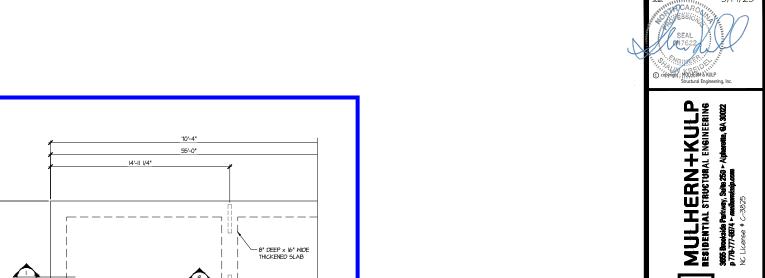

6x6 P.T. POST w/ SIMPSON BC52-3/6 CAP & ABM66Z BASE (TYP. OF 2) 2xi2 LEDGER— FASTENED TO FRAMING w/ (6)3½"x0.131" NAILS @ 24" o.c. 2x8 LEDGER FASTENED TO FRAMING W/ (4)31/4"x0.131" NAILS @ 24" o.c. ROOF TRUSSES @ 24" O.C ROOF TRUSSES @ 24" O.C @ OPT. DOÓR: (2)2x6 STEP CLG.

PARTIAL ROOF FRAMING PLAN OPT. 12080 MULTI SLIDE DOOR SCALE: 1/4"=1'-0" (22x24 SHEET) ELEV. A SHOWN. ALL ELEV. SIM. 1/8"=1'-0" (11x17 SHEET)

> PARTIAL ROOF FRAMING PLAN OPT. EXT. COVERED PORCH SCALE: 1/4"=1'-0" (22x24 SHEET)


LINE OF BOX.

1/8"=1'-0" (IIxIT SHEET)

ELEV. A ALL ELEV. SIM.

NOTE: OMIT (I)2x4 TOP PLATE TO FIT HEADER

ROOF TRUSSES 24" O.C.

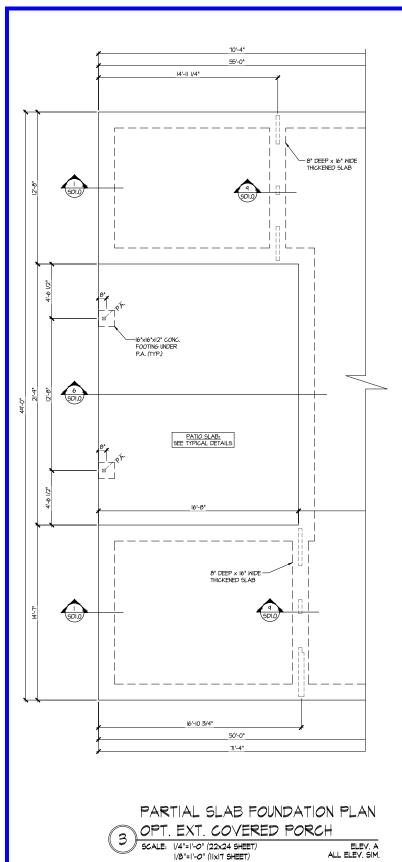

issue date: 11-07-2024

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THIS LEVEL HAS BEEN DESIGNED

LEGEND

- IIIIII INTERIOR BEARING WALL
- □□□□□ BEARING WALL ABOVE (B.W.A.)
- — BEAM / HEADER
- EXTENT OF VALLEY TRUSS OVERFRAMING
 24" O.C. (MAX.)
- ► INDICATES HOLDOWN

REFER TO SO.O FOR TYPICAL STRUCTURAL NOTES & SCHEDULES

FOR 9'-1" PLATE HEIGHT


- INDICATES EXTENT OF INT.

 OSB SHEARWALL AND/OR
 3" O.C. EDGE NAILING
- EXTENT OF FLOOR SYSTEM TO BE DESIGNED FOR TILE

- | INDICATES POST ABOVE. PROVIDE SOLID | BLOCKING UNDER POST OR JAMB ABOVE.

STRUCTURAL OPTIONS 5921-08 MODEI SERENITY MASTER SET RALEIGH, NC

S5.0M

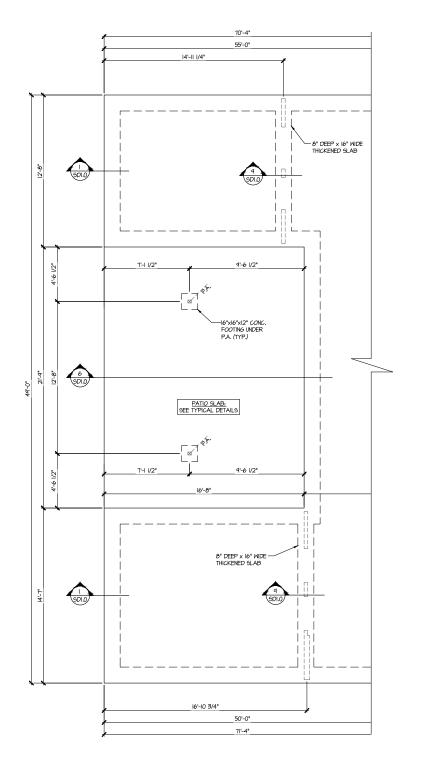

PARTIAL SLAB FOUNDATION PLAN OPT. OUTDOOR LIVING PATIO SCALE: 1/4"=1'-0" (22x24 SHEET) 1/8"=1'-0" (11x17 SHEET)

ELEV. A ALL ELEV. SIM.

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243-24034

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THIS LEVEL HAS BEEN DESIGNED FOR 9'-I" PLATE HEIGHT

LEGEND

- IIIII INTERIOR BEARING WALL
- ==== BEARING WALL ABOVE (B.W.A.)
- --- BEAM / HEADER
- INDICATES EXTENT OF INT.

 OSB SHEARWALL AND/OR
 3" O.C. EDGE NAILING
- EXTENT OF VALLEY TRUSS OVERFRAMING
 24" O.C. (MAX.)
- EXTENT OF FLOOR SYSTEM TO BE DESIGNED FOR TILE
- NDICATES HOLDOWN
- | INDICATES POST ABOVE. PROVIDE SOLID BLOCKING UNDER POST OR JAMB ABOVE.


REFER TO SO.O FOR TYPICAL STRUCTURAL NOTES # SCHEDULES

STRUCTURAL OPTIONS

S5.1M

5921-08 MODEL

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lulhern+Kulp project number 243-2403

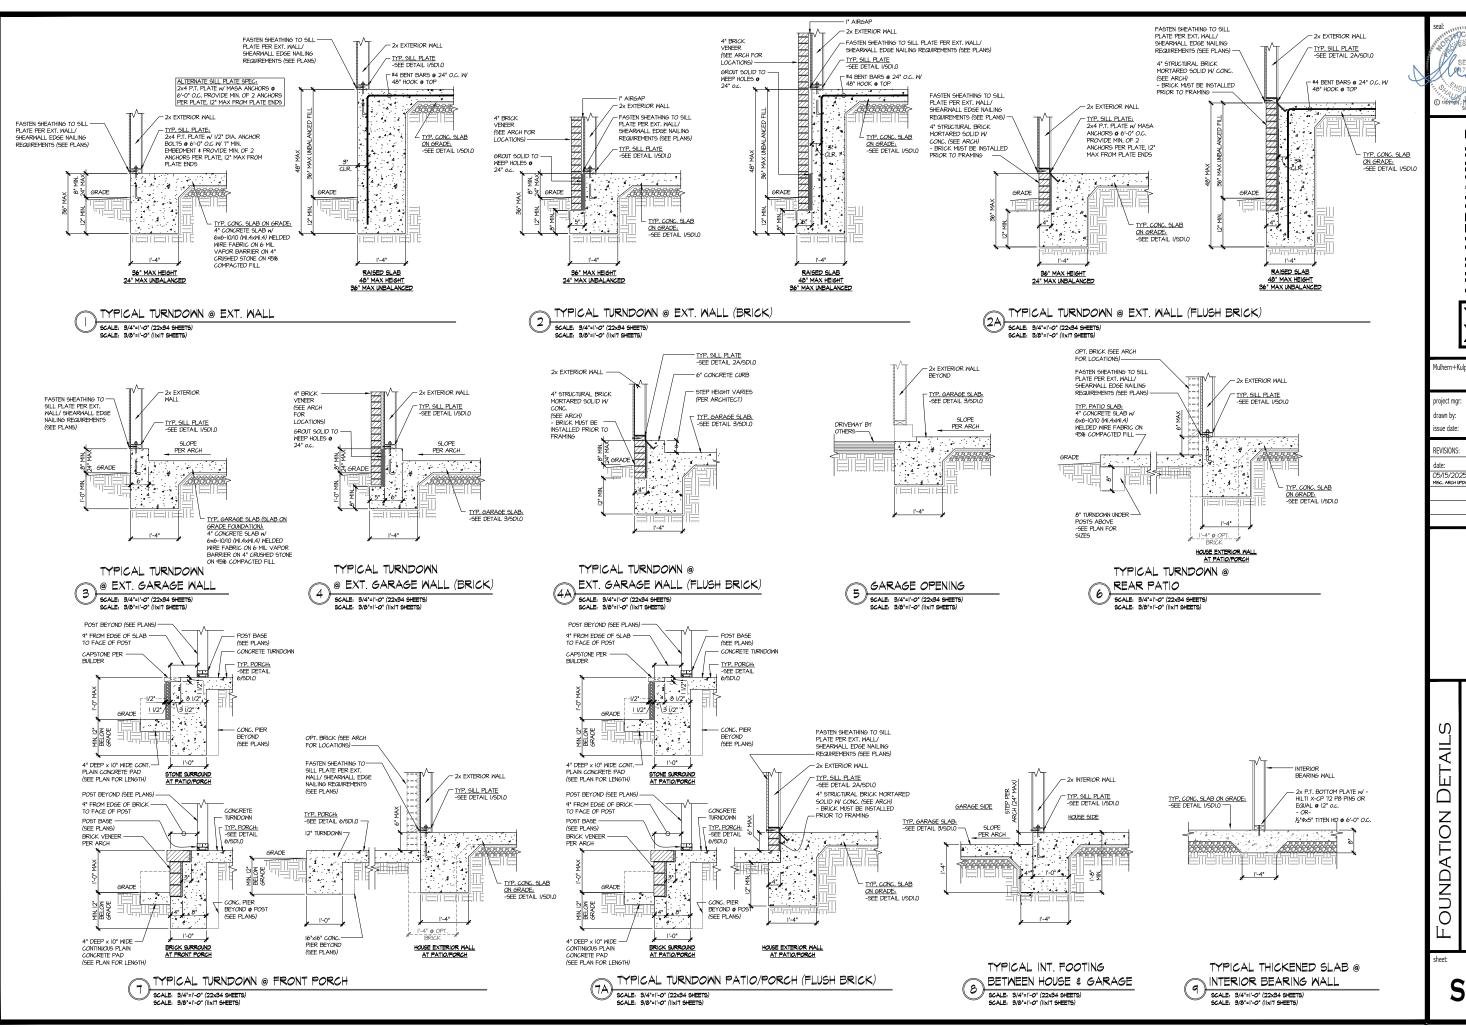SMŁ SMM/F0 issue date: 11-07-2024


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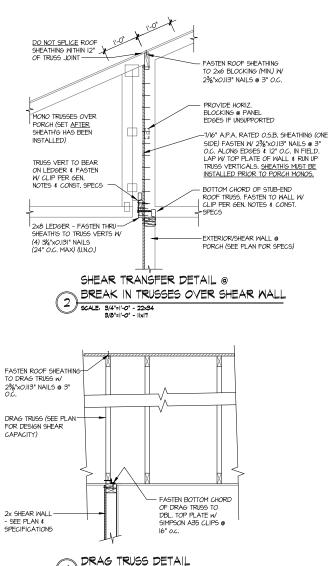
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MOD $\overset{\infty}{\circ}$ 5921-0


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SD1.0





DRAG 1 KL

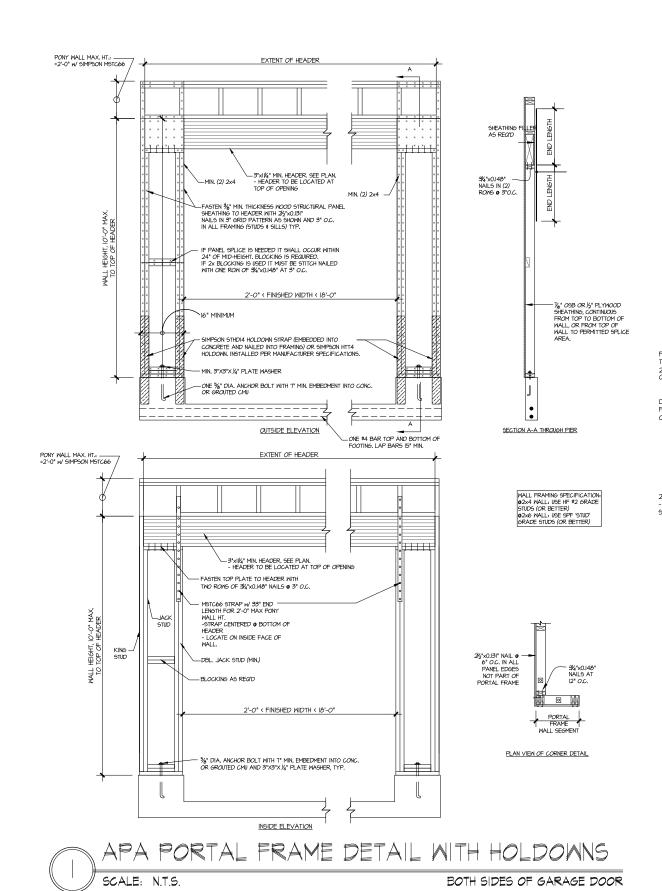

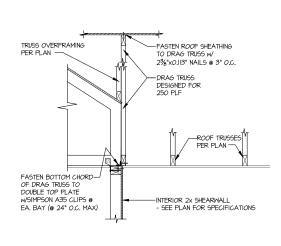SHEAR TRANSFER DETAIL AT INTERIOR SHEARWALL BELOW MULHERN+KULP
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NC LICENSE # C-3025

Aulhern+Kulp project number

243-2403

SMK drawn by: SMM/FC issue date: 11-07-2024


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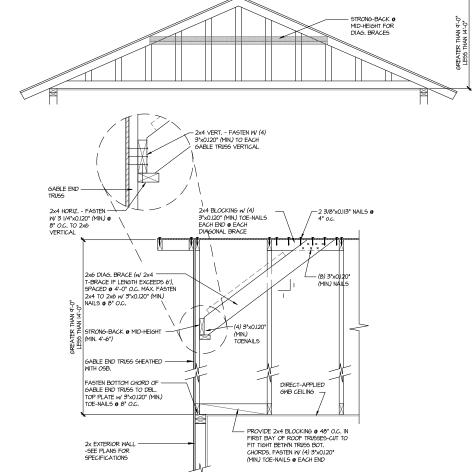
initial: 05/15/2025 JPP

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FRAMING DETAILS 5921-08 MODEI SERENITY MASTER SET RALEIGH, NC

SD2.0



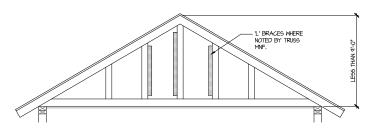

FASTEN BOTTOM CHORD OF — GABLE END TRUSS TO DBL. TOP PLATE w/ 3"x0.120" (MIN.) TOE-NAILS & 8" O.C. DIRECT-APPLIED GWB CEILING — - PROVIDE 2x4 BLOCKING ● 48" O.C. IN FIRST BAY OF ROOF TRUSSES-CUT TO FIT TIGHT BETWN TRUSS BOT. CHORDS, FASTEN W (3) 3 J V4"x0.120" (MIN.) TOE-NAILS @ EACH END TYPICAL GABLE END BRACING DETAIL SCALE: NOME REQUIRED TRUSS

'L' BRACES FASTENED TO VERTICALS MEERE RECO'D BY TRUSS MANUFACTURER, FASTEN W 16d GUN NAILS (0.131 x 3 1/2") @ 6" O.C.

GABLE END TRUSS SHEATHED-WITH OSB.

BRACE GABLE END TRUSSES PER ABOVE DETAIL WHEN GABLE HEIGHT IS LESS THAN 9"-0". "L" BRACES REQUIRED WHERE NOTED BY TRUSS MANUFACTURER.

REQ'D @ GABLE END TRUSS HEIGHT UP TO 9'-0'

BRACE GABLE END TRUGGES PER ABOVE DETAIL WHEN GABLE HEIGHT EXCEEDS 9'-0'. "L' BRACES NOT REQUIRED.

TYPICAL GABLE END BRACING DETAIL SCALE. NONE REQUIRE GABLE END TRUSS

REQ'D @ GABLE END TRUSS HEIGHT BETWN 9'-0" TO 14'-0"

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NC. Licence # C-38.25



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SMK SMM/FC drawn by: issue date: 11-07-2024

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FRAMING DETAILS 5921-08 MODEL

SERENITY MASTER SET RALEIGH, NC

SD2.1