LONGLEAF WAY **ABBREVIATIONS** A A PRESSURE TREATED WD HWD HARDWOOD (FL R&M RANGE W/MICROWAY LIV LIVING LTL LINTEL LVR LOUVER MAX MAXIMUM DRY DRYER MACHINE TEMP TEMPERED (GLASS U.N.O. UNLLGGOTHERWISE OA F.F. FINISH FLOOR (LINE OBS OBSCURE (GLA WH WATER HEATER FLR FLOOR(ING) FP FIREPLACE OPT OPTIONAL WIC WALK-IN CLOSE FURRED(ING) PEDESTAL (SINK) W/W/O WITH or WITHOUT ROHND FAIL TERPROOF(ING) CIRCUIT INTERRU

GENERAL NOTES

1 - GENERAL BUILDING & DESIGN REQUIREMENTS

1) THE ATTACHED PLANS & SPECIFICATIONS ARE THE SOLE PROPERTY OF TRI POINTE HOMES ANY UNAUTHORIZED USE OF THESE PLANS WITHOUT PRIOR WRITTEN CONSENT OF TRI POINTE HOMES IS STRICTLY

2) TRI POINTE HOMES DESIGNS & BUILDS HOUSING AS SET FORTH BY THE FORMAT AND PROVISIONS OF TH INTERNATIONAL RESIDENTIAL CODE (IRC), AND THE NATIONAL ELECTRIC CODE (NEC). ANY NON-CONFORMING DOCUMENTS DISCOVERED BY THE CONTRACTOR OR HIS AGENTS SHALL BE CALLED TO THE IMMEDIATE ATTENTION OF TRI POINTE HOMES BY CALLING (469)329-0470.

). THESE PLANS ARE SUBJECT TO MODIFICATIONS TO MEET CODE REQUIREMENTS AND/OR TO FACILITATE MECHANICAL/ ELECTRICAL/ PLUMBING INSTALLATION AND/ OR TO IMPLEMENT DESIGN IMPROVEMENTS. ANY

INTENTION TO MODIFY THESE PLANS MUST BE APPROVED IN WRITING BY TRI POINTE HOMES
4) CONTRACTOR SHALL BE RESPONSIBLE FOR VERIFYING ALL DIMENSIONS AFFECTING CONTRACTOR'S PRODUCTS, INSTALLATIONS, OR FABRICATIONS IN THE FIELD PRIOR TO EXPEDITING THE CONSTRUCTION OF SUCH WORK. FIELD VERIFY ALL DIMENSIONS — DO NOT SCALE DRAWINGS!! CONTRACTOR IS RESPONSIBLE FOR SURVEYING THE PROJECT AND BECOMING FAMILIAR WITH THE EXISTING CONDITIONS AND SCOPE OF WORK INCLUDING BUT NOT LIMITED TO SITE AND SOIL BEARING CONDITIONS.
5) ERRORS AND OMISSIONS WHICH MAY OCCUR IN THE CONTRACT DOCUMENTS SHALL BE BROUGHT TO THE

ATTENTION OF THE ARCHITECT, IN WRITING, AND WRITTEN INSTRUCTION SHALL BE OBTAINED PRIOR TO PROCEEDING WITH CONSTRUCTION. THE CONTRACTOR SHALL BE HELD RESPONSIBLE FOR ANY ERRORS, DISCREPANCIES, OR OMISSIONS FOR WHICH THE CONTRACTOR FAILED TO NOTIFY THE ARCHITECT PRIOR TO

2 - SITE CONSTRUCTION

BACK FILL SHALL BE FREE FROM VEGETATION AND CONSTRUCTION DEBRIS

) BACK FILL SHALL BE PLACED IN LIFTS AND COMPACTED IN SUCH A MANNER AS BACKFILL TO NOT DAM THE FOUNDATION WALLS OR ANY WATERPROOFING/ DAMPPROOFING MATERIALS.

3 - CONCRETE

1) SLOPE ON GARAGE SLAB SHALL BE 1/8" PER FOOT TOWARDS VEHICLE DOOR. SLOPE ON PORCH AND

4 - MASONRY

ALL EXTERIOR BRICK MUST MEET ASTM C-216 FOR "SW" CONDITIONS

) MASONRY VENEER SHALL BE ATTACHED TO SUPPORTING WALLS w/ CORRUGATED METAL TIES IN CCORDANCE WITH R703.7.4.1 - I.R.C. OR LOCAL CODE REQUIREMENTS

) WEEPHOLES SHALL BE PROVIDED ALONG THE OUTSIDE WYTHE OF EXTERIOR MASONRY WALLS AT 33" O.C. MAX, SHALL BE A MIN. OF 3/16" IN DIAMETER, AND LOCATED IMMEDIATELY ABOVE THE FLASHING PER 18703.7.6 – LR.C.

5 - METALS

6 - WOOD AND PLASTICS

7 - THERMAL & MOISTURE PROTECTION

) Fire stopping and/ or draft stopping shall meet the requirements of IRC R602.8. 2) Attic ventilation shall be provided at 1/300 th of the Area of the Space ventilated. Cross VANILATION WITH HALF OF THE VENTILATED AREA SHALL BE PROVIDED BY ROOF VENTS AND THE OTHER HALF BY SOFFIT VENTS. VENTS SHALL BE PLACED SO AS TO NOT ALLOW INFILTRATION OF RAIN OR SNOW.) PROVIDE APPROVED TILE BACKER DRYWALL FOR ALL SHOWER AND BATH SPACE) PROVIDE ATTIC VENTILATION PER IRC-R806.1

8 - DOORS AND WINDOWS

-) REVIEW ALL WINDOW HDR HEIGHTS PER PLATE HT. AND VERIFY W/ ELEVATIONS AND CORNICE DETAILS TEMPERED GLASS SHALL BE USED IN HAZARDOUS AREAS AS DESCRIBED IN SECTION R308.4 - LR.C.
- FRONT DOOR WIDTH PER IRC-R311.3
- GARAGE DOOR PER IRC-R309.1

) EMERGENCY EGRESS SHALL MEET REQUIREMENTS OF SECTION R310 - LR C 2018 - SLEEPING ROOMS HALL HAVE AT LEAST ONE EGRESS OPENING OF NOT LESS THAN 5.7 SF AND A CLEAR OPENING OF NOT IFSS THAN 20" WIDE X 24" HIGH AND SHALL NOT BE MORE THAN 44" ABOVE THE FLOOR

15 - MECHANICALS

WOOD BUILT CHIMNEYS AND FIREPLACES SHALL BE INSTALLED PER MANUFACTURER'S INSTRUCTIONS AND RE SUBJECT TO MECHANICAL INSPECTION PER IRC SECTION R1002.1) EXTERIOR AIR INTAKE FOR COMBUSTION AIR PER IRC SECTION AS REQUIRED BY LOCAL MUNICIPALITY

ALL FLECTRICAL INSTALLATION SHALL MEET THE REQUIREMENTS OF THE NATIONAL ELECTRIC CODE (NEC). MATERIAL AND EQUIPMENT SHALL BEAR THE LABEL OF APPROVAL OF THE UNDERWRITERS ABORATORIES, INC.

) ELECTRICAL CONTRACTOR SHALL VERIFY SPACE REQUIRED FOR METER INSTALLATION BEFORE ONSTRUCTION AND SHALL NOTIFY GENERAL CONTRACTOR OF ANY DISCREPANCIES.

VERIFY LOCATION OF ALL RECEPTACLES FOR APPLIANCES WITH MANUFACTURER SPECIFICATIONS. GROUND FAULT INTERRUPTS SHALL BE LOCATED PER THE NEC

ALL SWITCHES SHALL BE INSTALLED AT 3'-6" ABOVE FINISHED FLOOR TO CENTERLINE OF SWITCH VLESS NOTED OTHERWISE

) ALL CONVENIENCE OUTLETS SHALL BE INSTALLED W/ CENTERLINE OF OUTLET LOCATED 1'-3" ABOVE INISHED FLOOR UNLESS NOTED OTHERWISE

ALL CONVENIENCE OUTLETS WITH SWITCHES TO BE SWITCH AT TOP ONLY.

ALL EXTERIOR WALL BRACKET FIXTURES SHALL BE INSTALLED AS NOTED ON PLANS.

APPROVED SMOKE DETECTORS SHALL BE LOCATED ON EVERY STORY OF THE DWELLING UNIT AS PER IRC CTION R317 (SEE SHEET B1.1 FOR LOCATIONS). WHERE MORE THAN ONE DETECTOR IS REQUIRED THEY SHALL BE INTERCONNECTED. POWER SOURCE SHALL BE BUILDING POWER w/ BATTERY BACKUP.)) CONDUCTORS SHALL BE OF COPPER.

GENERAL FRAMING SPECS AND CONSTRUCTION NOTES STAIRS:

1) THE MAXIMUM RISER HEIGHT SHALL BE 7 3/4 INCHES AND THE MINIMUM TREAD DEPTH SHALL BE 10 CHES IN ACCORDANCE WITH SECTION I.R.C.

HANDRAILS HAVING MINIMUM AND MAXIMUM HEIGHTS OF 34 INCHES AND 38 INCHES SHALL BE OVIDED ON AT LEAST. ONE SIDE OF STAIRWAYS IN ACCORDANCE WITH SECTION R315.1 — I.R.C HANDRAIL AND BALUSTRADE (WHERE PRESENT) SHALL BE CONSTRUCTED ACCORDING TO IRC. ALL REQUIRED HAND RAILS SHALL BE CONTINUOUS THE FULL LENGTH OF THE STAIRS W/ 2 OR MORE SERS FROM A POINT ABOVE THE THE TOP RISER OF A FLIGHT TO A POINT ABOVE THE LÓWEST RISER OF THE FLIGHT. ENDS SHALL BE RETURNED OR SHALL TERMINATE AT NEWEL POSTS OR SAFETY TERMINALS. ANDRAILS ADJACENT TO A WALL SHALL HAVE A SPACE OF NOT LESS THAN 1.5" BETWEEN THE WALL

WALLS:

) ALL DIMENSIONS ARE FROM FACE OF STUD TO FACE OF STUD. ALL STUDS ARE 3 1/2" UNLESS NOTED. LL DIMENSIONS PRESENTED HERE ARE FRAME DIMENSIONS ONLY.

I SEPARATION BETWEEN THE RESIDENCE AND THE GARAGE SHALL BE MAINTAINED BY INSTALLATION OF $rac{1}{2}"$ GYPSUM BOARD ON ALL COMMON WALLS. 2-STORY HOMES REQUIRE 5/8" TYPE X GYPSUM BOARD AT CARAGE CEILINGS WHERE HABITABLE ROOMS ARE PRESENT ABOVE.

FLOORS:

STRUCTURAL FLOOR MEMBERS SHALL NOT BE CUT, BORED, OR NOTCHED IN EXCESS OF THE LIMITATIONS ECIFIED IN IRC

) THE ENDS OF EACH JOIST, BEAM, OR GIRDER SHALL HAVE NOT LESS THAN 1.5 INCHES OF BEARING ON WOOD OR METAL AND NOT LESS THAN 3 INCHES ON MASONRY OR CONCRETE OR AS OTHERWISE SPECIFIED

) ALL DIMENSIONAL FLOOR JOISTS TO BE PER ENGINEER STRUCTURAL PLANS.

FRAMING:

ALL FRAMING DIMENSIONS TO FACE OF MEMBER.

ALL BEARING HEADERS TO BE PER ENGINEERING PLANS. FIRE STOPPING AND / OR DRAFT STOPPING SHALL MEET THE REQUIREMENTS OF IRC R602.8.

ROOF

HIP AND VALLEY RAFTERS SHALL BE SUPPORTED AT RIDGE DOWN TO BEARING PARTITION. CUT ENDS OF RAFTERS SHALL BE FULLY SUPPORTED WALL AND RIDGE

REQUIRED VENTILATION AREAS CALCULATED AT 1/300 RATIO

SQUARE FOOTAGE

Elevation "B"

(Slab S.F.)	
Slab Area	Sq. Ft
FIRST FLOOR	186
2 BAY GARAGE	433
PORCH	55
COVERED OUTDOOR LIVING	210
Total Slab Area	256

(Outside of Frame S.F.)

A/C Area	Sq. Ft.
FIRST FLOOR	1867
Total A/C Area	1867
Non-A/C Area	Sq. Ft.
2 BAY GARAGE	433
PORCH	55
COVERED OUTDOOR LIVING	210
Total Non-A/C Area	698

(Inside of Frame S.F.)

A/C Area	Sq. Ft.
FIRST FLOOR	1810
Total A/C Area	1810

NOTE: ALL OPTIONAL SQUARE FOOTAGES LISTED ARE INDEPENDENT OF AND IN ADDITION TO BASE SQUARE FOOTAGES

OPTIONS

T. COV. OUTDOOR LIVING	+IC
FT	+63

BUILDING CODE COMPLIANCE

ELECTRICAL PLANS DESIGNED TO MEET OR EXCEED MINIMUM

CONSTRUCTION PLANS DESIGNED TO MEET OR EXCEED

MINIMUM CODE REQUIREMENTS OF 2018 LR C

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	SHEET LEGEND
SHEET NO.	TYPE OF SHEET/LAYOUT
"G0.01"	COVER SHEET & GEN. NOTES
"G0.11"	REVISIONS & SYMBOLS
"S1.10B"	BASE FOUNDATION PLAN — ELEVATION 'B'
"A1.10B"	FIRST FLOOR PLAN — ELEVATION 'B'
"01.A10"	FLOOR PLAN OPTIONS
"01.A20"	FLOOR PLAN OPTIONS
"01.A30"	2ND FLOOR PLAN OPTION
"A2.01B"	EXTERIOR ELEVATIONS — 'B'
"A2.02B"	EXTERIOR ELEVATIONS — 'B'
"A2.03B"	EXTERIOR ELEVATIONS — OPTIONS — 'B'
"A2.04B"	EXTERIOR ELEVATIONS — OPTIONS — 'B'
"A2.05B"	EXTERIOR ELEVATIONS — OPTIONS — 'B'
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"E1.11B"	1ST FLR. ELECTRICAL PLAN UPGRADE OPTIONS — ELEVATION 'B'
"01.E10"	1ST FLR. ELECTRICAL PLAN OPTIONS
"01.E20"	2ND FLR. ELECTRICAL PLAN OPTION
"01.E11"	1ST FLR. ELECTRICAL PLAN UPGRADE OPTIONS
"01.E30"	2ND FLR. ELECTRICAL PLAN OPTION
"01.E21"	2ND FLR. ELECTRICAL PLAN UPGRADE OPTION

Altis at Serenity - Lot 307 - 5920-05 (Longleaf Way) -**Elevation B**

*9080 Sliding Glass Door at Dining Room

*Primary Bath 1

*Tray Ceiling at Primary Bath

*Extended Covered Outdoor Living

*Gourmet Kitchen 1


*Fireplace at Great Room

*9080 Sliding Glass Door at Great Room

*Bed 3 ILO Flex

*Door from Primary Walk in Closet

*Outdoor Living Fireplace

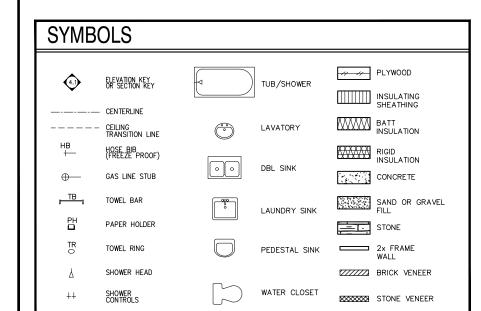

DointeHOMES

Blvd Business Operation 5440 Wade Park Blv Suite 400 Raleigh, NC 27607

Creek GENERAL

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SHEET

Lot 307 24 Shac Altis at \$

SUBDIVISION: ADDRESS: LOT:

09-30-24 Issue Date: ACC

5920-05

LONGLEAF WAY

G0.01

REVISION INDEX			
REL. #	DESCRIPTION	DATE	DRAWN BY
5920-05	NEW PLAN	09/30/2024	ACC
	ADDED ATTIC PULL-DOWN, REVISED ROD/SHELF IN PRIMARY WIC, ADDED OPTIONS — SCREENED COVERED OUTDOOR LIVING, GOURNET KITCHEN KITCHEN, ZERO ENTRY SHOWER AT PRIMARY BATH, ADDED TRIM SURROUNDING VENTS AT VARIOUS ELEVATIONS, REVISED BENCH DETAIL, ADDED OPT. LAUNDRY CABINETS, ADDED (2) 4-LED LIGHTS IN GARAGE, REVISED ELECT LIGHTING AND SWITCHES IN PRIMARY BATH, ADDED DISHWASHER ACCESSIBLE DISCONNECT SWITCH AND COUNTER-TOP AIR SWITCH FOR DISPOSAL NOTES	01/22/2025	ACC
	ADDED SHOWER NICHE NOTE, ADDED CURB TO SHOWERS, REVISED INT/EXT FIREPLACE DEPTHS, REVISED OPENING HEADER HEIGHTS THROUGHOUT, REVISED REAR EXTERIOR DOOR TO 3', REVISED DROP ZONE AREA, ADDED DOOR HEIGHTS TO MAIN FLOOR NOTES, ADDED BATH ACCESSORY HEIGHTS TO MAIN FLOOR NOTES, ADDED ZERO ENTRY SHOWER DETAIL, REMOVED PRIMARY BATH 2 OPTION, ADDED OUTDOOR LIVING PATIO OPTION, ADDED PARTIAL SHOWER NICHE DETAIL, REVISED ELECTRICAL OPTION AT GREAT ROOM AND PRIMARY BATH.	04/23/2025	ACC

tri pointe.

HOMES

5440 WADE PARK BLVD, SUITE 400, RALEIGH, NG 27607

Business Operations 5440 Wade Park Blvd Suite 400 Raleigh, NC 27607

Lot 307 24 Shady Creek Way Altis at Serenity

SUBDIVISION: Lot 307
ADDRESS: 24 C.
LOT:


Issue Date: 09-30-24

Drawn By: ACC

5920-05

PLAN NAME:
LONGLEAF WAY

G0.11

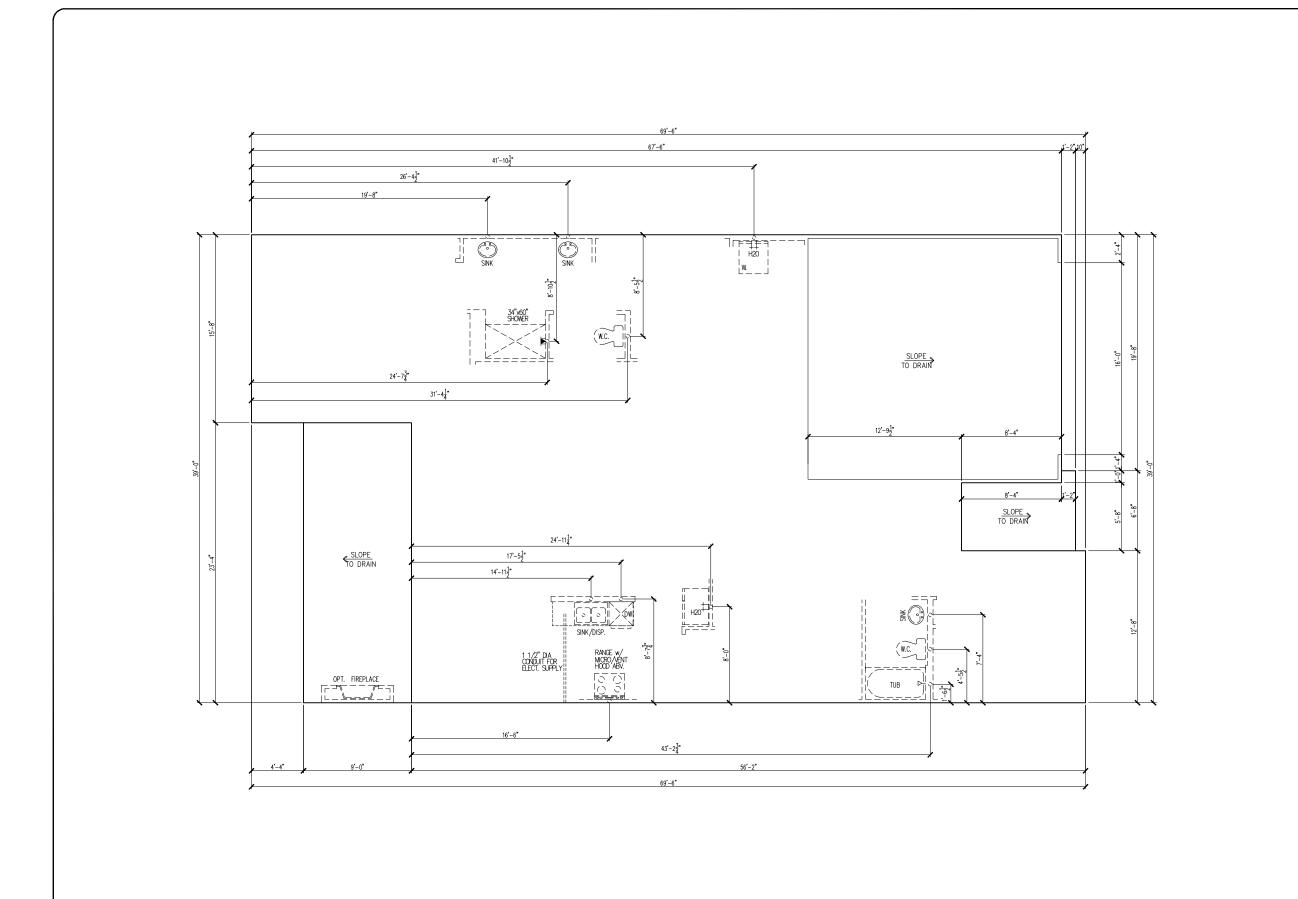

tri pointe.

H O M E \$
5440 WADE PARK BLYD, SUITE 400, RALFIGH, NG 27807

Business Operations 5440 Wade Park Blvd Suite 400 Raleigh, NC 27607

SUBDIVISION:
ADDRESS:
LOT: BI

BASE FOUNDATION PLAN


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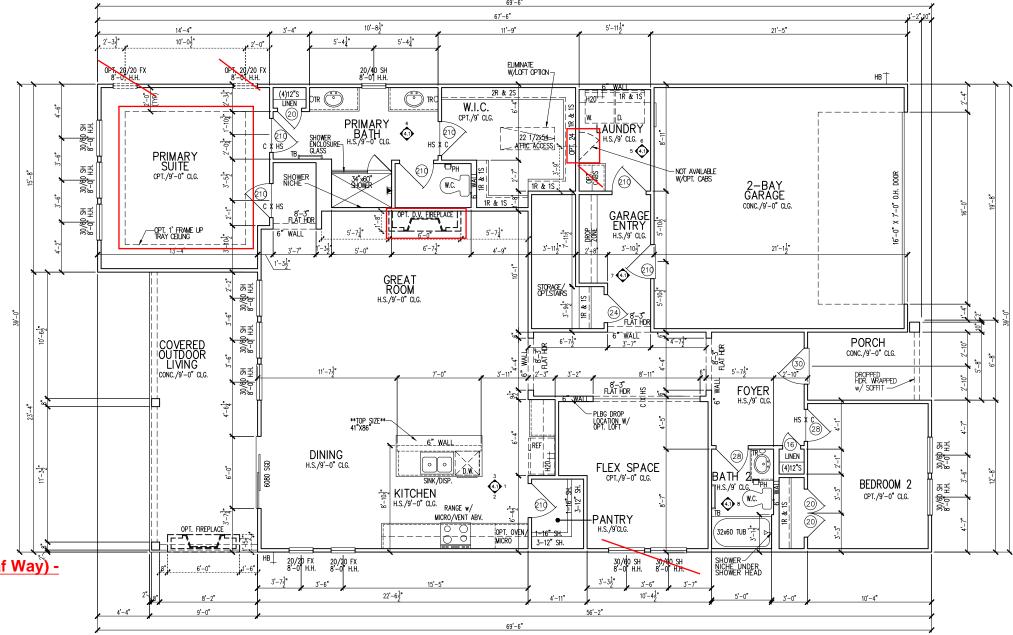
Drawn By: ACC

5920-05

PLAN NAME:
LONGLEAF WAY

S1.10B



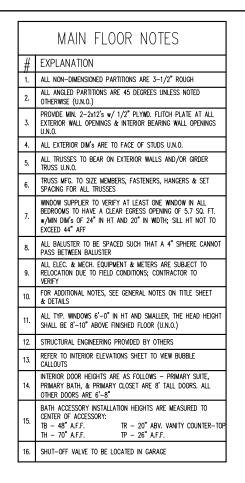

Altis at Serenity - Lot 307 - 5920-05 (Longleaf Way) -**Elevation B**

*Gourmet Kitchen 1

*Fireplace at Great Room

*9080 Sliding Glass Door at Great Room

*9080 Sliding Glass Door at Dining Room

*Bed 3 ILO Flex


*Primary Bath 1

*Tray Ceiling at Primary Bath

*Door from Primary Walk in Closet

*Outdoor Living Fireplace

*Extended Covered Outdoor Living

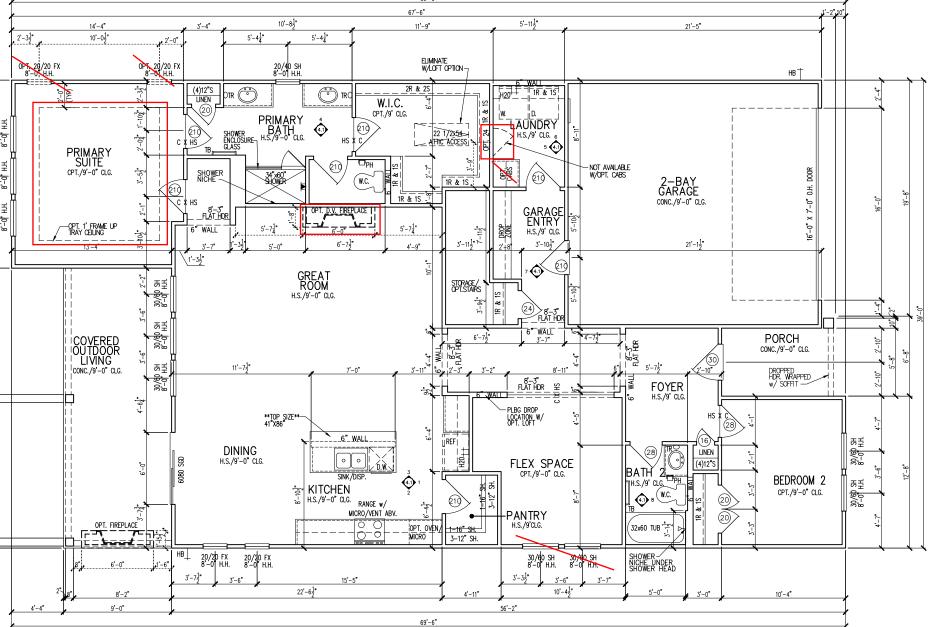

Dointe HOMES

Business Operations 5440 Wade Park Blvd Suite 400 Raleigh, NC 27607

FLOOR

1st

Issue Date:

SUBDIVISION: ADDRESS: LOT: BI

09-30-24

ACC


5920-05

LONGLEAF WAY


A1.10




OPT. SHOWER ILO
TUB AT BATH 2
PARTIAL FLOOR PLAN

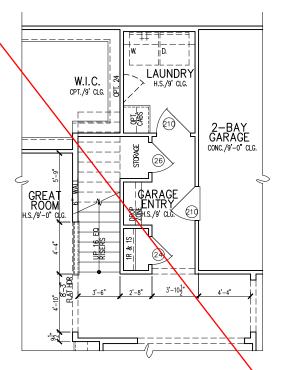


OPT. SECOND FLOOR STAIR PARTIAL FLOOR PLAN

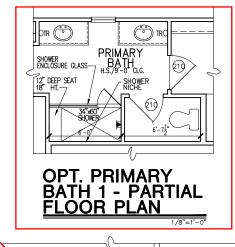

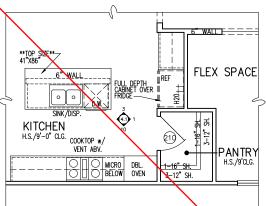


OPT. GOURMET 2 KITCHEN - PARTIAL PARTIAL FLOOR PLAN

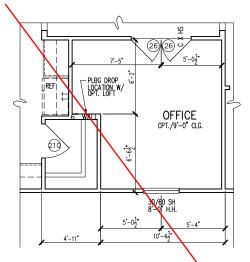

OPT. OFFICE ILO FLEX PARTIAL FLOOR PLAN



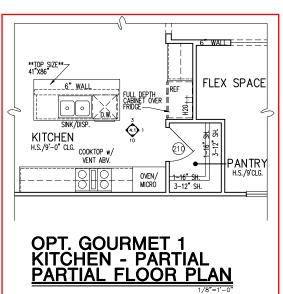



Business Operations 5440 Wade Park Blvd Suite 400 Raleigh, NC 27607

OPTIONS

PLAN

FLOOR

SUBDIVISION: ADDRESS: LOT:

09-30-24 Issue Date: ACC

5920-05

LONGLEAF WAY

01.A10

MAIN FLOOR NOTES

EXPLANATION

ALL NON-DIMENSIONED PARTITIONS ARE 3-1/2" ROUGH

ALL ANGLED PARTITIONS ARE 45 DEGREES UNLESS NOTED

PROVIDE MIN. 2-2x12's w/ 1/2" PLYMD. FLITCH PLATE AT ALL EXTERIOR WALL OPENINGS & INTERIOR BEARING WALL OPENINGS

4. ALL EXTERIOR DIM'S ARE TO FACE OF STUDS U.N.O.

ALL TRUSSES TO BEAR ON EXTERIOR WALLS AND/OR GIRDER TRUSS U.N.O.

WINDOW SUPPLIER TO VERIFY AT LEAST ONE WINDOW IN ALL BEDROOMS TO HAVE A CLEAR EGRESS OPENING OF 5.7 SQ. FT. w/MIN DIM's OF 24" IN HT AND 20" IN WIDTH; SILL HT NOT TO

ALL BALUSTER TO BE SPACED SUCH THAT A 4" SPHERE CANNO

ALL ELEC. & MECH. EQUIPMENT & METERS ARE SUBJECT TO RELOCATION DUE TO FIELD CONDITIONS; CONTRACTOR TO

ALL TYP. WINDOWS 6'-0" IN HT AND SMALLER, THE HEAD HEIGH SHALL BE 8'-10" ABOVE FINISHED FLOOR (U.N.O.)

PRIMARY BATH, & PRIMARY CLOSET ARE 8' TALL DOORS. ALL OTHER DOORS ARE 6'-8"

TR - 20" ABV. VANITY COUNTER-TO

SHUT-OFF VALVE TO BE LOCATED IN GARAGE


TRUSS MFG. TO SIZE MEMBERS, FASTENERS, HANGERS & SET SPACING FOR ALL TRUSSES


PASS BETWEEN BALUSTER


FOR ADDITIONAL NOTES, SEE GENERAL NOTES ON TITLE SHEET


BATH ACCESSORY INSTALLATION HEIGHTS ARE MEASURED TO CENTER OF ACCESSORY:

TP - 26" A.F.F.

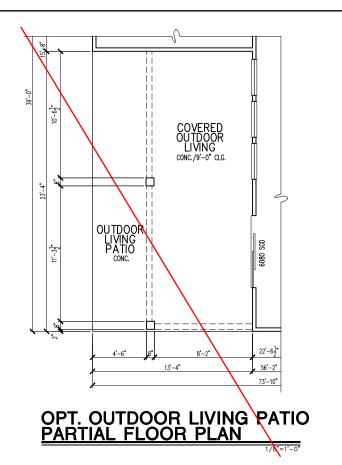


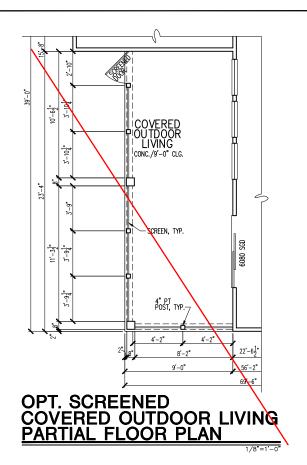

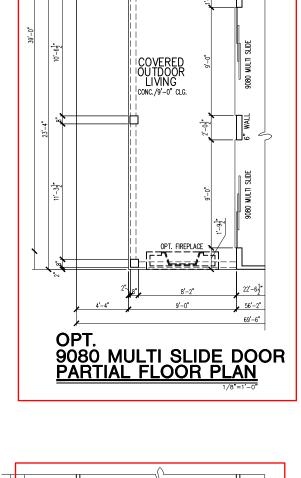

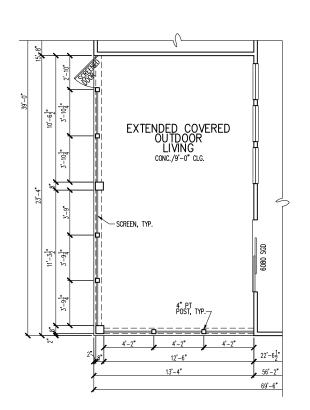



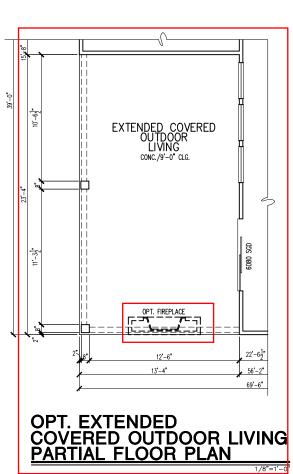



Business Operations 5440 Wade Park Blvd Suite 400 Raleigh, NC 27607

PLAN – OPTIONS

Lot 307
24 Shady Creek Wa Altis at Serenity

SUBDIVISION:
ADDRESS:
LOT: BLOCK

FLOOR

Issue Date: 09-30-24

Drawn By: ACC


PLAN#: 5920-05

LONGLEAF WAY

(01.A20

MAIN FLOOR NOTES # EXPLANATION ALL NON-DIMENSIONED PARTITIONS ARE 3-1/2" ROUGH ALL ANGLED PARTITIONS ARE 45 DEGREES UNLESS NOTED OTHERWISE (U.N.O.) PROVIDE MIN. 2-2x12's w/ 1/2" PLYWD. FLITCH PLATE AT ALL EXTERIOR WALL OPENINGS & INTERIOR BEARING WALL OPENINGS 4. ALL EXTERIOR DIM'S ARE TO FACE OF STUDS U.N.O. ALL TRUSSES TO BEAR ON EXTERIOR WALLS AND/OR GIRDER TRUSS U.N.O. TRUSS MFG. TO SIZE MEMBERS, FASTENERS, HANGERS & SET SPACING FOR ALL TRUSSES WINDOW SUPPLIER TO VERIFY AT LEAST ONE WINDOW IN ALL BEDROOMS TO HAVE A CLEAR ECRESS OPENING OF 5.7 SQ. FT. w/MIN DIM's OF 24" IN HT AND 20" IN WIDTH; SILL HT NOT TO ALL BALUSTER TO BE SPACED SUCH THAT A 4" SPHERE CANNOT PASS BETWEEN BALUSTER ALL ELEC. & MECH. EQUIPMENT & METERS ARE SUBJECT TO RELOCATION DUE TO FIELD CONDITIONS; CONTRACTOR TO VFRIFY FOR ADDITIONAL NOTES, SEE GENERAL NOTES ON TITLE SHEET & DETAILS ALL TYP. WINDOWS 6'-0" IN HT AND SMALLER, THE HEAD HEIGHT 12. STRUCTURAL ENGINEERING PROVIDED BY OTHERS REFER TO INTERIOR ELEVATIONS SHEET TO VIEW BUBBLE CALLOUTS INTERIOR DOOR HEIGHTS ARE AS FOLLOWS - PRIMARY SUITE, PRIMARY BATH, & PRIMARY CLOSET ARE 8' TALL DOORS. ALL OTHER DOORS ARE 6'-8" BATH ACCESSORY INSTALLATION HEIGHTS ARE MEASURED TO CENTER OF ACCESSORY: TR - 20" ABV. VANITY COUNTER-TOP TP - 26" A.F.F. TB — 48" A.F.F. TH — 70" A.F.F.

SHUT-OFF VALVE TO BE LOCATED IN GARAGE

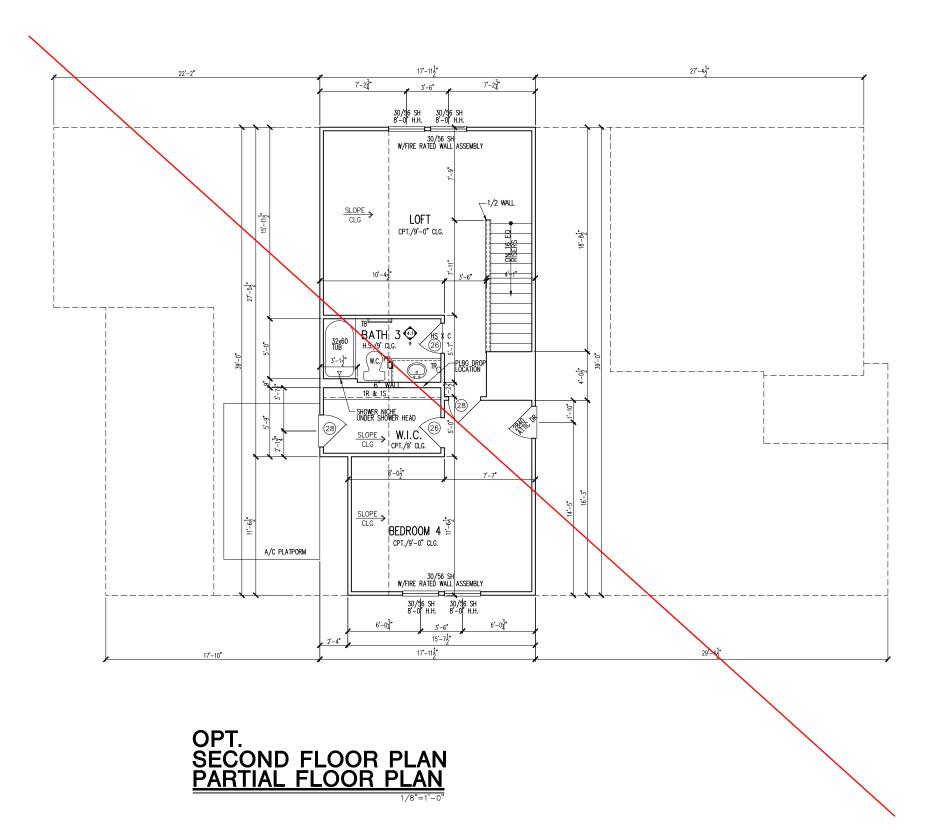

tri pointe H O M E S 540 WDE PARK BLVD, SUIE 400. RALEGH, NG 27607

Business Operations 5440 Wade Park Blvd Suite 400 Raleigh, NC 27607

PLAN - OPTION

2ND FLOOR

Lot 307 24 Shady Creek ¹ 10 ock. Altis at Serenity


SUBDIVISION:
ADDRESS:
LOT: BI

Issue Date: 09-30-24
Drawn By: ACC


5920-05

LONGLEAF WAY


01.A30

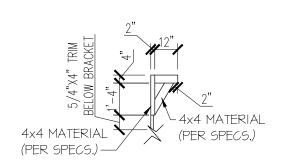

BRACKET DETAIL

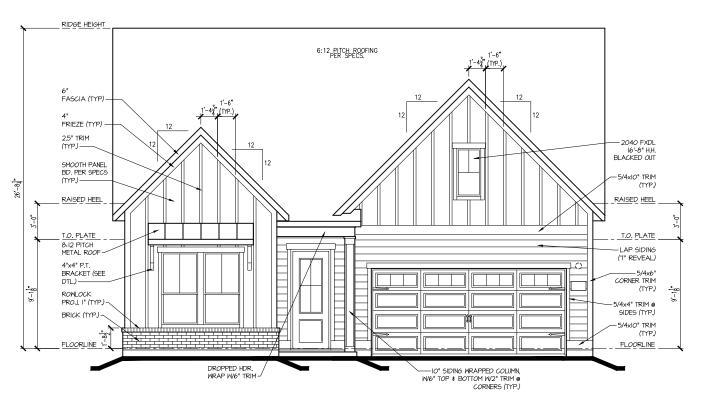

FRONT ELEV. "B"

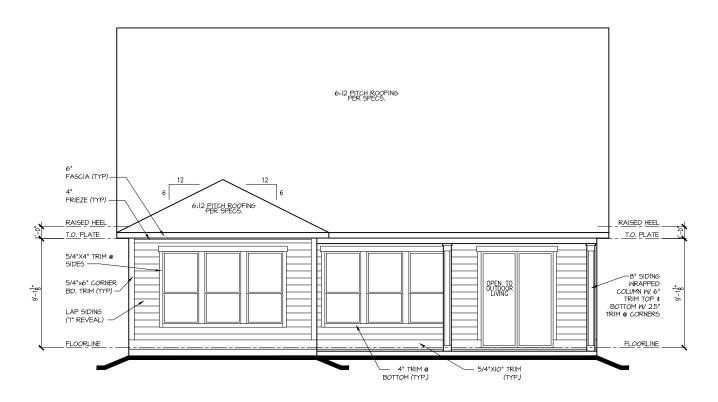

REAR ELEV. "B"

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HOMES
5440 WAE PARK BLVD, SUITE 400, RALEGH, NG 27607

Business Operations 5440 Wade Park Blvd Suite 400 Raleigh, NC 27607

EXTERIOR ELEVATIONS
TISION: Lot 307
24 Shady Creek Way
BLOCK: Altis at Serenity

SUBDIVISION:
ADDRESS:
LOT: BI

Issue Date: 09-30-24


Drawn By: ACC

5920-05

LONGLEAF WAY

A2.01B



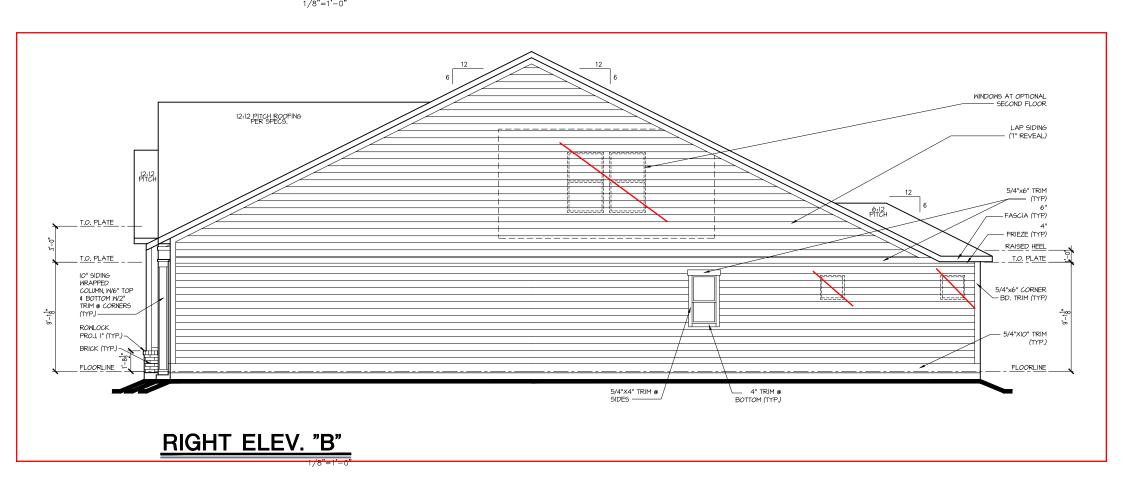

tri pointe.

HOMES

HOMES

5440 WADE PARK BLVD, SUITE 400, RALEIGH, NC 27607

Business Operations 5440 Wade Park Blvd Suite 400 Raleigh, NC 27607

EXTERIOR ELEVATIONS
TISION: Lot 307
24 Shady Creek Way
BLOCK: Altis at Serenity


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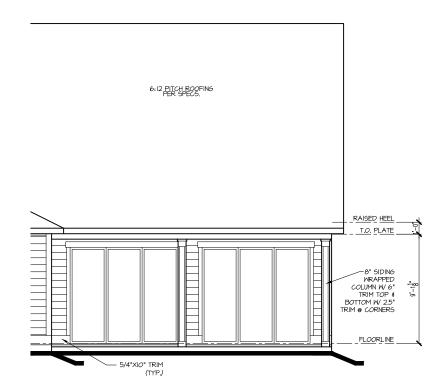
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LONGLEAF WAY

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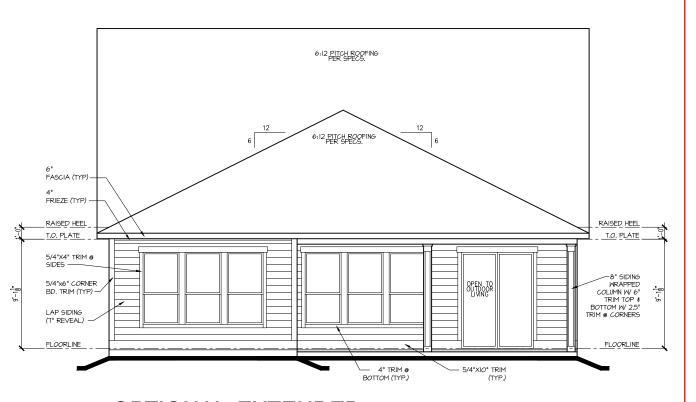


OPTIONAL EXTENDED COVERED OUTDOOR LIVING PARTIAL LEFT ELEVATION



OPT. 9'x8' SLIDING GLASS DOOR @ GREAT ROOM / DINING PARTIAL REAR ELEVATION

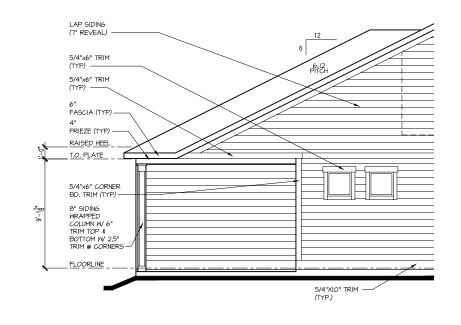1/8"=1'-0"



OPTIONAL EXTENDED COVERED OUTDOOR LIVING PARTIAL REAR ELEVATION

Dointe HOMES RR BLD. SUITE 400, RALEIGH, NC 27607

Business Operations 5440 Wade Park Blvd Suite 400 Raleigh, NC 27607

Lot 307 24 Shady Creek Way Altis at Serenity OPTIONS EXTERIOR ELEVATIONS


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ADDRESS:
LOT: BI

09-30-24 Issue Date: ACC

5920-05

LONGLEAF WAY

A2.03B

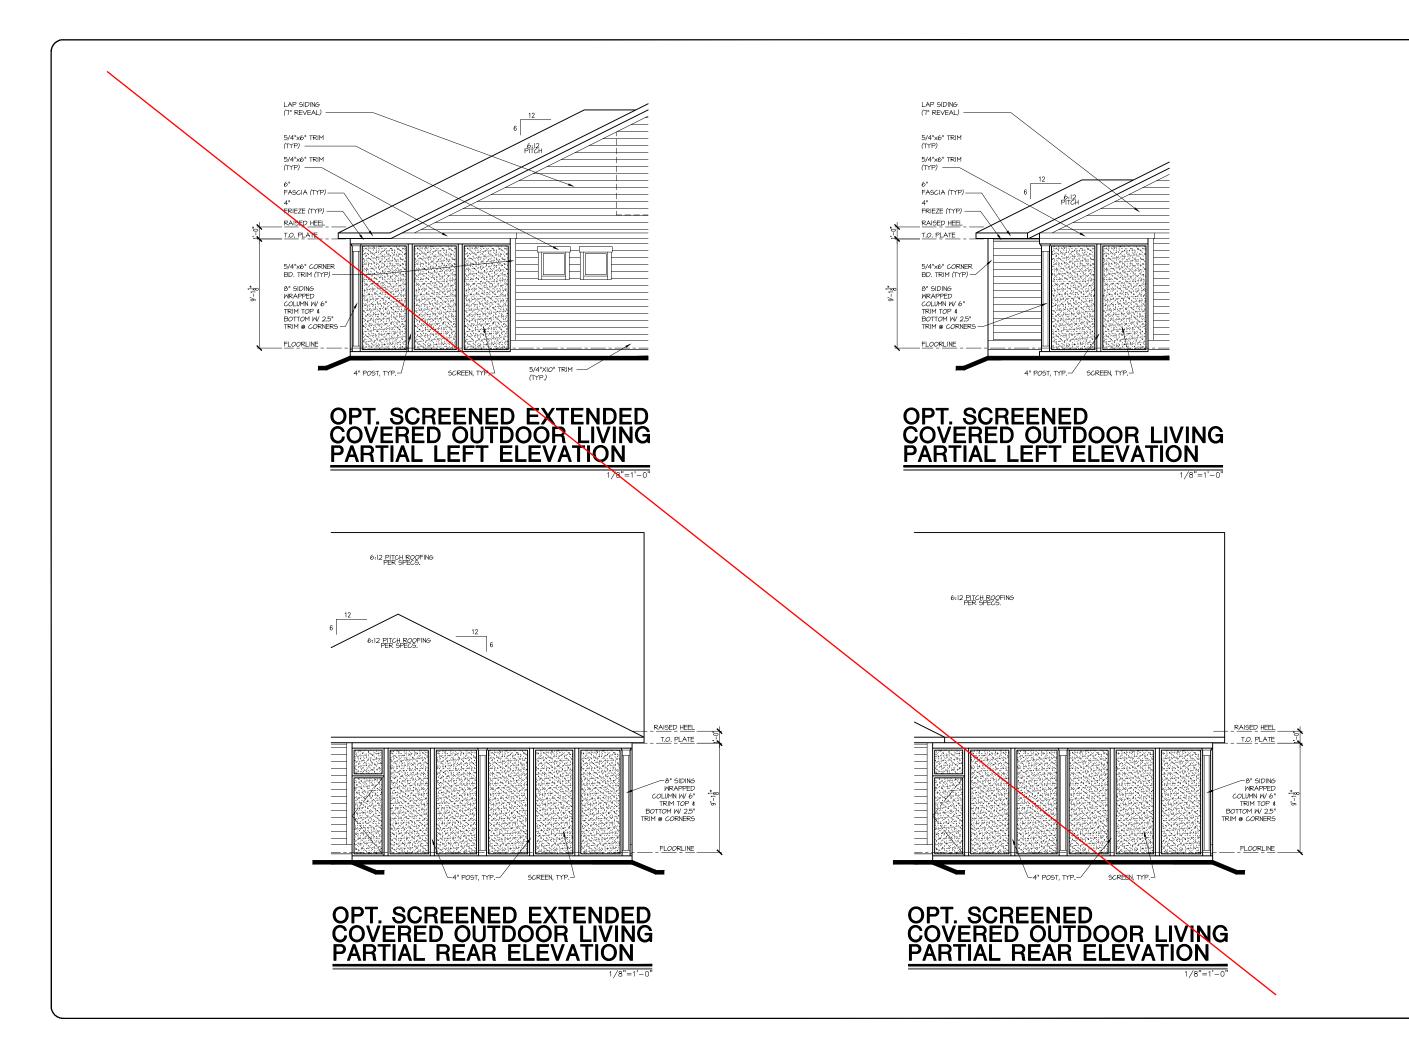

Dointe HOMES RRIVD. SUITE 400, RALEIGH, NC 27607

Business Operations 5440 Wade Park Blvd Suite 400 Raleigh, NC 27607

OPTIONS Creek \ EXTERIOR ELEVATIONS


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ADDRESS:
LOT: BI


Issue Date: 09-30-24 Drawn By: ACC

5920-05

LONGLEAF WAY

A2.04B

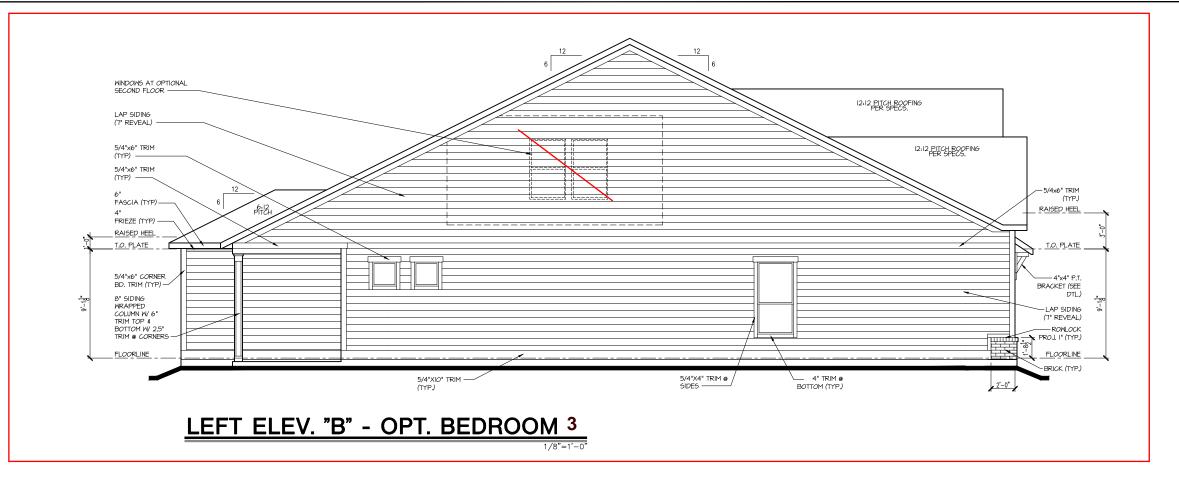

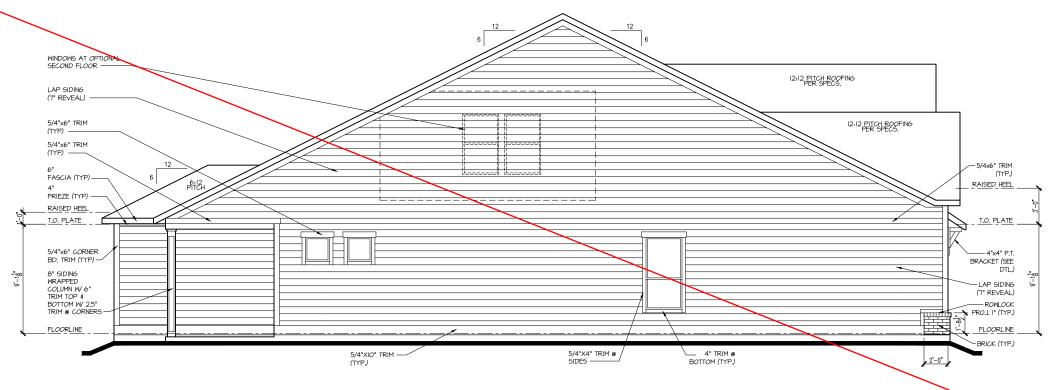

LEFT ELEV. "B" - OPT. OFFICE

Dointe HOMES RR BLYD. SALEIGH, NG 27607

Business Operations 5440 Wade Park Blvd Suite 400 Raleigh, NC 27607

OPTIONS Creek ' EXTERIOR ELEVATIONS


SUBDIVISION:
ADDRESS:
LOT: BI

Issue Date: 09-30-24 Drawn By: ACC

5920-05

LONGLEAF WAY

A2.02B

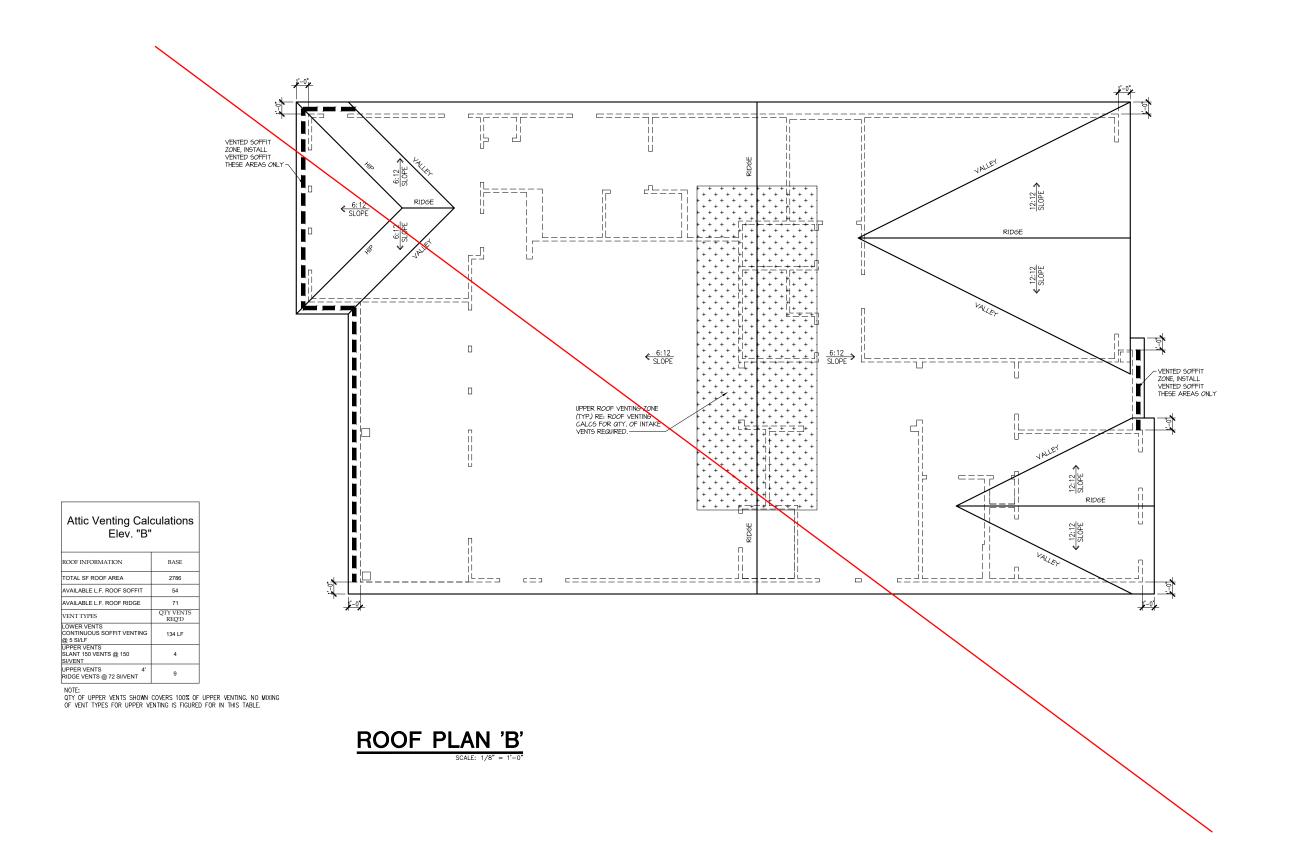

Dointe HOMES RR BLW, SUITE 400, RALEIGH, NG 27607

Business Operations 5440 Wade Park Blvd Suite 400 Raleigh, NC 27607

Creek \ PLAN ROOF


SUBDIVISION:
ADDRESS:
LOT: BI

Issue Date: 09-30-24 Drawn By: ACC

5920-05

LONGLEAF WAY

A3.01B

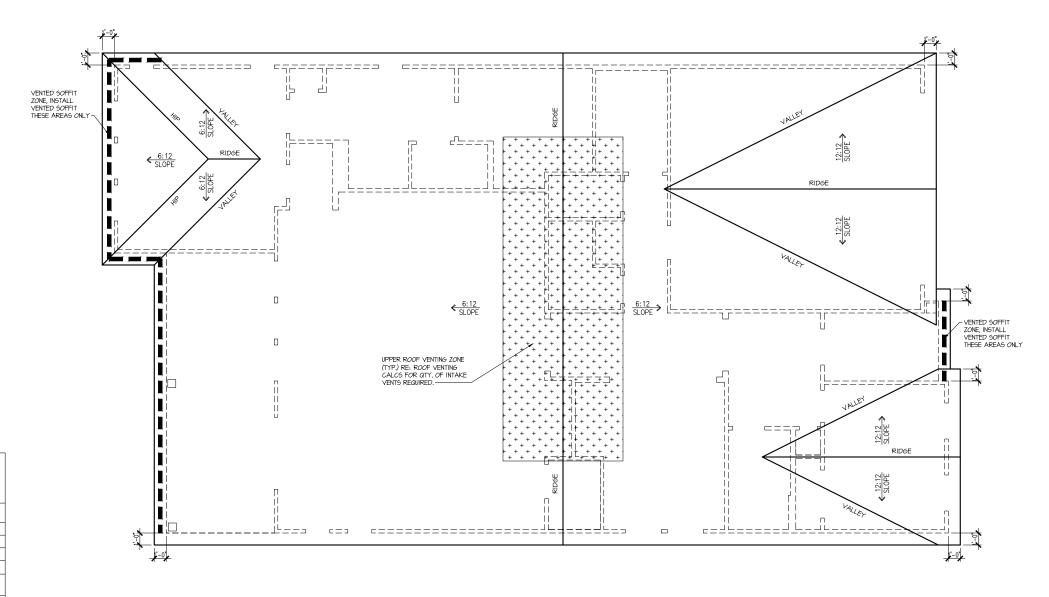



NOTE:
OTY OF UPPER VENTS SHOWN COVERS 100% OF UPPER VENTING. NO MIXING OF VENT TYPES FOR UPPER VENTING IS FIGURED FOR IN THIS TABLE.



Dointe HOMES ** BLVD. SUITE 400, RALEIGH, NG 27807

Business Operations 5440 Wade Park Blvd Suite 400 Raleigh, NC 27607

Lot 307 24 Shady Creek V Altis at Serenity OPTION


ROOF PLAN SUBDIVISION: ADDRESS: LOT: BI

Issue Date: 09-30-24 Drawn By: ACC

5920-05

LONGLEAF WAY

A3.02B

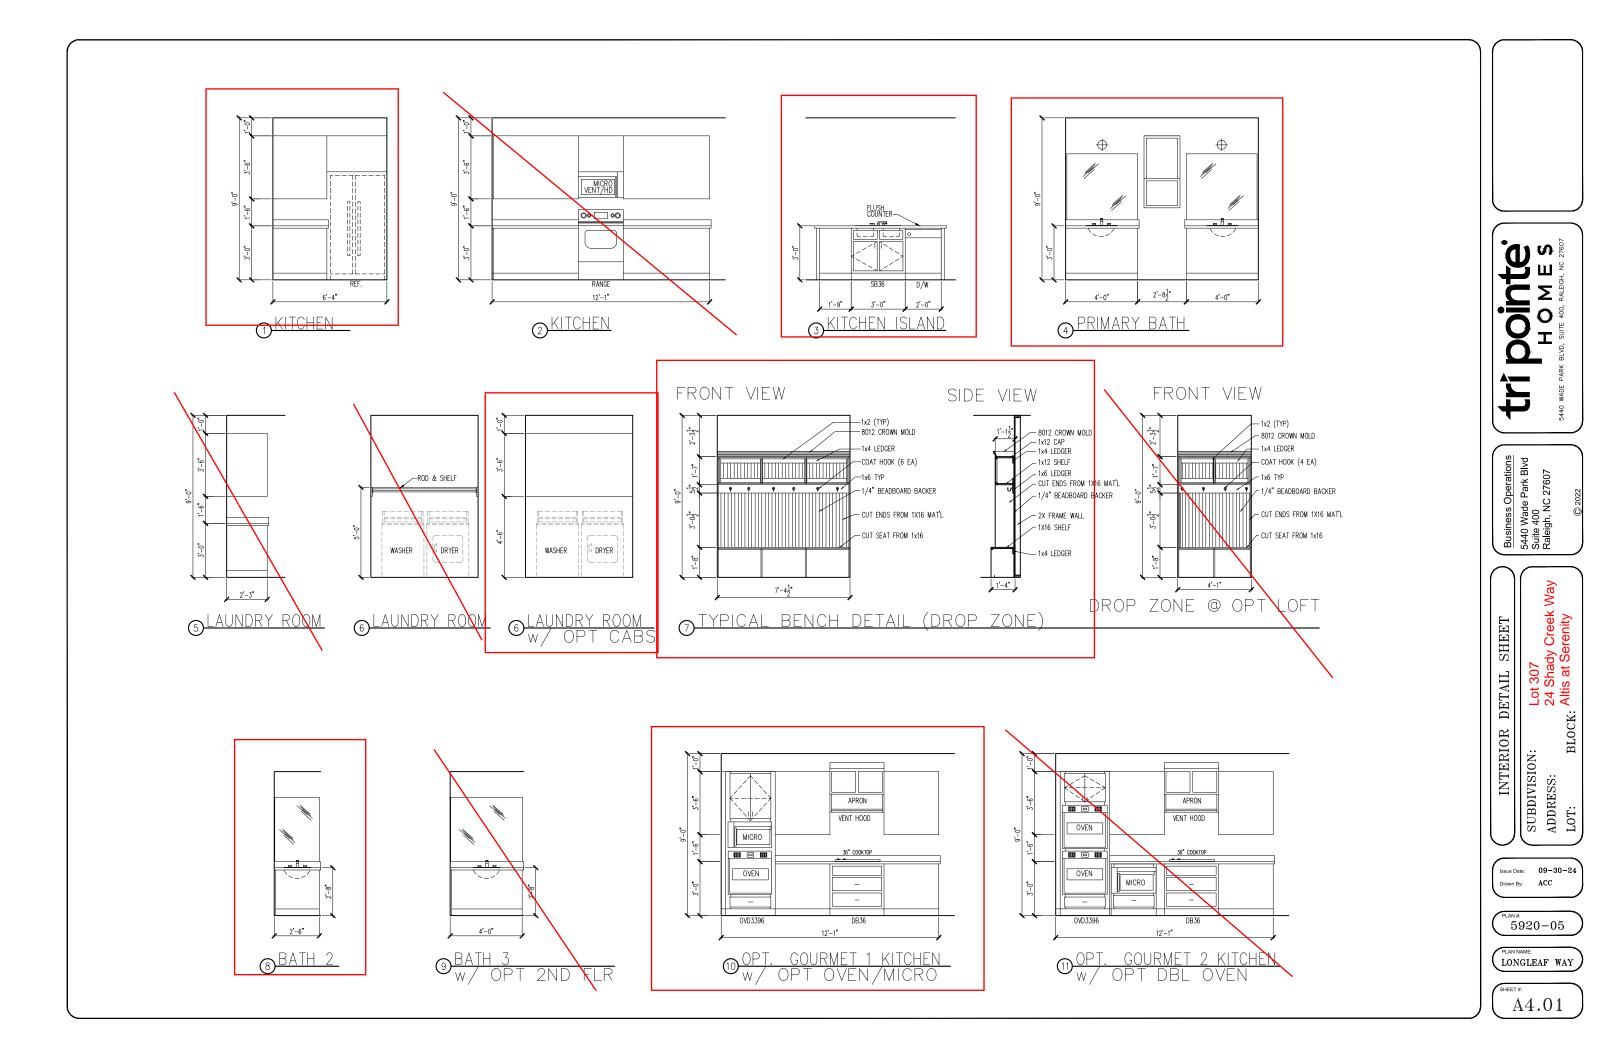

ELECTRICAL FIXTURE SCHEDULE		
DESCRIPTION	SYMBOL	
110V OUTLET	ф	
220V OUTLET	\$ 220	
1/2 HOT OUTLET	₩	
GFI OUTLET	∜\$ GFI	
WP GFI OUTLET	₩P/GFI	
GARAGE DOOR OPENER OUTLET	Ø GDO	
SECURITY SYSTEM	∯ SEC SYS	
DISHWASHER	⊗ DW	
JUNCTION BOX	(I)	
CEILING MOUNTED LIGHT		
CEILING FAN w/ LIGHT KIT	PROVIDE BRACING	
RECESSED CEILING LIGHT	Ø	
RECESSED WATER PROOF LIGHT)®(WP	
WALL MOUNTED LIGHT	9	
WALL MOUNTED PUSH BUTTON	å PB	
TWO WAY SWITCH	\$	
THREE WAY SWITCH	*\$	
FOUR WAY SWITCH	\$	
DIMMER SWITCH	\$ ^{DIM}	
EXHAUST VENTS	S VENT TO EXT	
LOW VOLTAGE PANEL	# 	
PHONE OUTLET	●PH	
TV OUTLET	⊕ TV	
DATA & RG6 COMBO BOX		
SMOKE DETECTOR	9	
CARBON MONOXIDE SMOKE DETECTOR COMBO	⊚ CM/SD	
DOOR CHIMES	CHIMES	
ELECTRICAL PANEL	EP EP	
SURFACE MOUNT LED	•	
EXTERIOR WALL MOUNT UPLIGHT	8	
SOFFIT MOUNT FLOOD LIGHT	442	
UNDER COUNTER LIGHTING	-cc- UCL	
SMURF TUBE		

ELECTRICAL NOTES:


- PROVIDE AND INSTALL LOCALLY CERTIFIED SMOKE AND CARBON MONOXIDE DETECTORS REQUIRED BY NATIONAL FIRE PROTECTION ASSOCIATION (NFPA) AND MEETING THE REQUIREMENTS OF ALL GOVERNING CODES.

 PROVIDE AND INSTALL GROUND FAULT (IRQUIT-INTERRUPTERS (GF)) AS REQUIRED BY NATIONAL ELECTRIC CODE (NEC) AND MEETING THE REQUIREMENTS OF ALL GOVERNING CODES. ELECTRICAL CONTRACTOR TO PROVIDE REQUIRED DIRECT HOOK—UPS/CUTOFFS.

 HVAC CONTRACTOR TO VERIFY THERMOSTAT LOCATIONS.
 ALL ELECTRICAL AND MECHANICAL EQUIPMENT (I.E. FURNACES, A/C UNITS, ELECTRICAL PANELS, SANITARY SUMP PITS, DRAIN TILLE SUMP, AND WATER HEATERS) ARE SUBJECT TO RELOCATION WATER HEATERS) ARE SUBJECT TO RELOCATION

SANITARY SUMP PITS, DRAIN TILE SUMP, AND
WATER HEATERS) ARE SUBJECT TO RELOCATION DUE TO FIELD CONDITIONS.
ELECTRICAL DEVICES: ABOVE FINISHED FLOOR:
SWITCHES OVER COUNTER
WALL OUTLETS OVER COUNTER
+42" TO BOTTOM OF HORIZONTAL OUTLET(TYP. @ COUNTER)
REMAINING SWITCHES
WALL OUTLETS
BATH VANITY BRACKET OUTLET 1,2 (1° ABOVE TOP OF VANITY)
WATER SOFTENER AND SUMP OUTLETS 48" TO CL
EXTERIOR GFI OUTLETS
GARAGE GFI (ABOVE GARAGE FLOOR) 48" TO CL
FRONT DOOR COACH LIGHT
GARAGE DOOR COACH LIGHT, (ABOVE GARAGE FLOOR)
THERMOSTAT
DOORBELL CHIMES
DOORBELL BUTTON
KITCHEN HOOD FAN "WHIP"
KITCHEN WALL HUNG MICROWAVE OUTLET 72" TO CL
KITCHEN DISHWASHER RECEPTACLE UNDER SINK
KITCHEN RANGE
KITCHEN REFRIGERATOR
WASHER/DRYER OUTLET

CL = CENTER LINE 1 = FIELD VERIFY 2 = MASTER BATH STANDARD 30" HIGH VANITY TO BE RAISED 4"

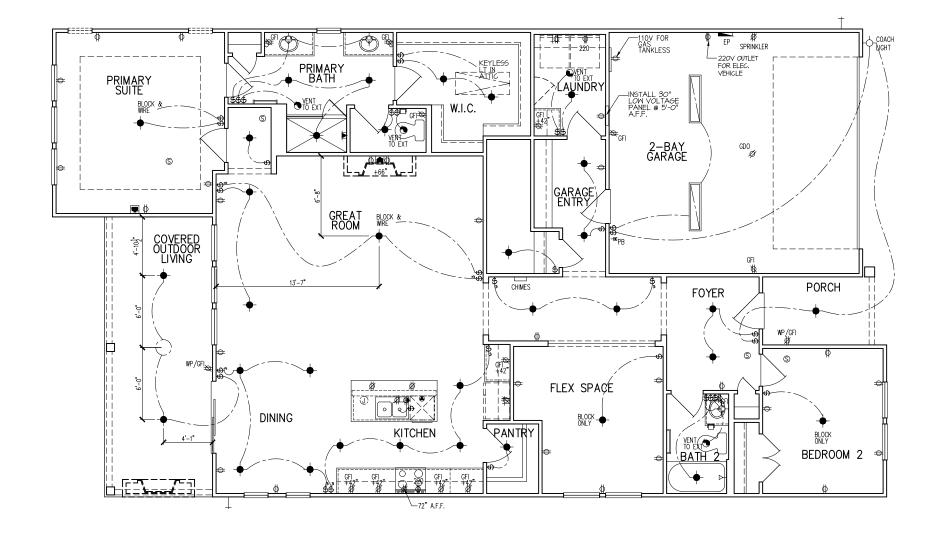

Dointe HOMES RELVO. SALEGH, NG 27607

Business Operations 5440 Wade Park Blvd Suite 400 Raleigh, NC 27607

ELECTRICAL PLAN 24 Shady Creek \ Altis at Serenity 1st FLOOR

SUBDIVISION:
ADDRESS:
LOT: BI

09-30-24 Issue Date: ACC

5920-05

LONGLEAF WAY

E1.10B

ELECTRICAL FIX	KTURE		
OOHEDOLE	ELECTRICAL FIXTURE SCHEDULE		
DESCRIPTION S	SYMBOL		
110V OUTLET	ф		
220V OUTLET	₩ 220		
1/2 HOT OUTLET	•		
GFI OUTLET	₩ GFI		
WP GFI OUTLET	₩P/GFI		
GARAGE DOOR OPENER OUTLET	Ø GDO		
SECURITY SYSTEM	∯SEC SYS		
DISHWASHER	⊕DW		
JUNCTION BOX	Ũ		
CEILING MOUNTED LIGHT			
CEILING FAN w/ LIGHT KIT	PROVIDE		
RECESSED CEILING LIGHT	Ø		
RECESSED WATER PROOF LIGHT	∭ WP		
WALL MOUNTED LIGHT	φ		
WALL MOUNTED PUSH BUTTON	e PB		
TWO WAY SWITCH	\$		
THREE WAY SWITCH	* \$		
FOUR WAY SWITCH	⁴\$		
DIMMER SWITCH	\$ ^{DIM}		
EXHAUST VENTS	S VENT TO EXT		
LOW VOLTAGE PANEL	<u> </u>		
PHONE OUTLET	● PH		
TV OUTLET	⊗ TV		
DATA & RG6 COMBO BOX			
SMOKE DETECTOR	<u>(S)</u>		
CARBON MONOXIDE SMOKE DETECTOR COMBO	⊚ CM/SD		
DOOR CHIMES	CHIMES		
ELECTRICAL PANEL	EP EP		
SURFACE MOUNT LED	-		
EXTERIOR WALL MOUNT UPLIGHT	8		
SOFFIT MOUNT FLOOD LIGHT	443		
UNDER COUNTER LIGHTING	-coo-UCL		
SMURF TUBE			

ELECTRICAL NOTES:

- 1. PROVIDE AND INSTALL LOCALLY CERTIFIED SMOKE AND CARBON MONOXIDE DETECTORS REQUIRED BY NATIONAL FIRE PROTECTION ASSOCIATION (NFPA) AND MEETING THE REQUIREMENTS OF ALL COVERNING CODES 2. PROVIDE AND INSTALL GROUND FAULT CIRCUIT—INTERRUPTERS (GF) AS REQUIRED BY NATIONAL ELECTRIC CODE (NEC) AND MEETING THE REQUIREMENTS OF ALL GOVERNING CODES.

 3. ELECTRICAL CONTRACTOR TO PROVIDE REQUIRED DIRECT HOOK—UPS/CUTOFFS.

 4. HYAC CONTRACTOR TO VERIFY THERMOSTAT LOCATIONS.


 5. ALL ELECTRICAL AND MECHANICAL EQUIPMENT (I.E. FURNACES, A/C UNITS, ELECTRICAL PANELS, SANITARY SUMP PITS, DRAIN TILE SUMP, AND WATER HEATERS) ARE SUBJECT TO RELOCATION DUE TO FIELD CONDITIONS.

DUE TO FIELD CONDITIONS.
ELECTRICAL DEVICES: ABOVE FINISHED FLOOR:
SWITCHES OVER COUNTER
WALL OUTLETS OVER COUNTER
+42" TO BOTTOM OF HORIZONTAL OUTLET(TYP. @ COUNTER)
REMAINING SWITCHES
WALL OUTLETS
BATH VANITY BRACKET OUTLET 1,2 (1" ABOVE TOP OF VANITY)
WATER SOFTENER AND SUMP OUTLETS 48" TO CL
EXTERIOR GFI OUTLETS
GARAGE GFI (ABOVE GARAGE FLOOR) 48" TO CL
FRONT DOOR COACH LIGHT 80". JO CL
GARAGE DOOR COACH LIGHT, (ABOVE GARAGE FLOOR)84".TO CL
THERMOSTAT
DOORBELL CHIMES
DOORBELL BUTTON
KITCHEN HOOD FAN "WHIP"
KITCHEN WALL HUNG MICROWAVE OUTLET 72" TO CL
KITCHEN DISHWASHER RECEPTACLE UNDER SINK
KITCHEN RANGE
KITCHEN REFRIGERATOR
WASHER/DRYER OUTLET
CL = CENTER LINE

CL = CENTER LINE

1 = FIELD VERIFY

2 = MASTER BATH STANDARD 30" HIGH
VANITY TO BE RAISED 4"

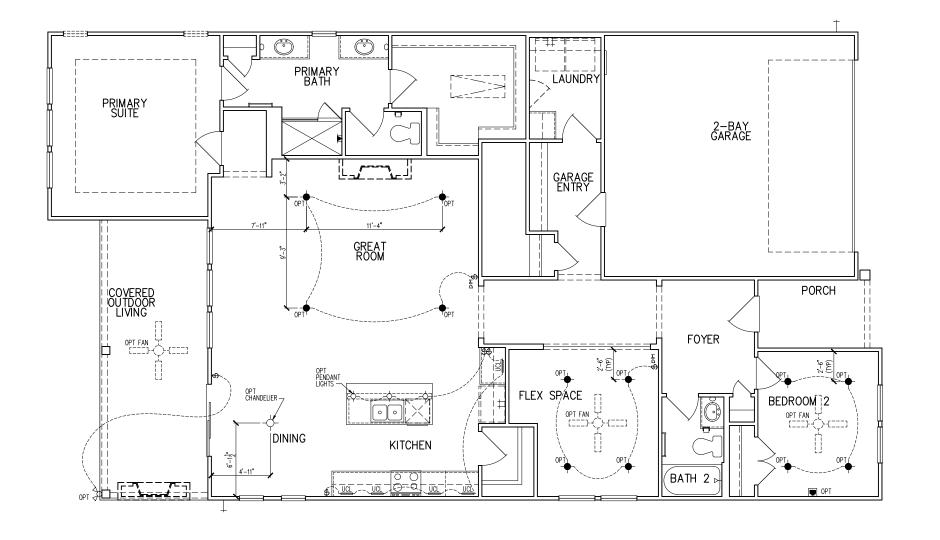

Pointe MES HOW, SUITE 400, RALEGO, NG 27607

Business Operations 5440 Wade Park Blvd Suite 400 Raleigh, NC 27607

OPITONS

Lot 307 24 Shady Creek V Altis at Serenity 1st FLOOR ELEC. PLAN

SUBDIVISION:
ADDRESS:
LOT: BI 09-30-24


Issue Date: ACC

PLAN#: 5920-05


LONGLEAF WAY


E1.11B



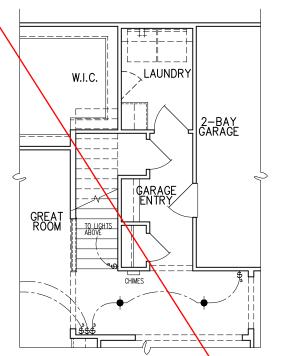


OPT. SECOND FLOOR STAIR PARTIAL ELECTRICAL PLAN

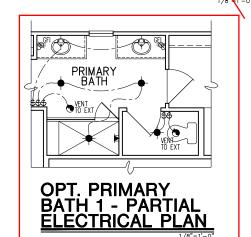

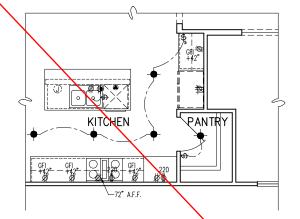


OPT. GOURMET 2 KITCHEN - PARTIAL ELECTRICAL PLAN

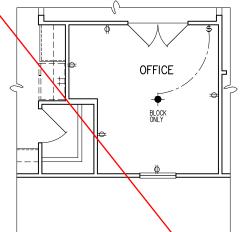


OPT. OFFICE ILO FLEX - PARTIAL ELECTRICAL PLAN



OPT. BEDROOM 3 ILO FLEX - PARTIAL ELECTRICAL PLAN

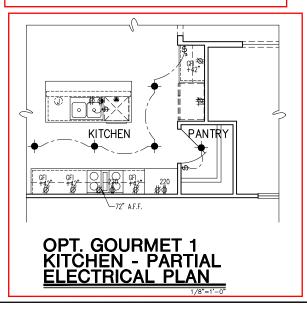

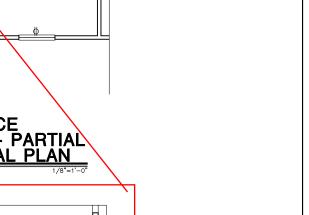

Business Operations 5440 Wade Park Blvd Suite 400 Raleigh, NC 27607

DointeHOMES

Shady Creek 's at Serenity OPTIONS PLAN ELEC.

SUBDIVISION: ADDRESS: LOT:

09-30-24 Issue Date: ACC

5920-05

LONGLEAF WAY

01.E10



EXTERIOR WALL MOUNT UPLIGHT SOFFIT MOUNT FLOOD LIG

ELECTRICAL NOTES:

- PROVIDE AND INSTALL LOCALLY CERTIFIED SMOCK AND CARBON MONOMID DETECTORS REQUIRED BY AMONAL RIFE PROTECTION ASSOCIATION (NFP.) AND METING THE ST. PROVIDE AND INSTALL GROUND FAULT GROUT—INTERRUPTERS (GP) AS REQUIRED BY AN

HIVAC CONTRACTOR TO VERIFY THERMOSTAT LOCATIONS.

ALL ELECTRICAL AND MECHANICAL EQUIPMENT (LIF, FURNACES, A/C UNITS, ELECTRICAL PANELS, SANTARRY SOUMP PITS, DRAIN THE SOUP, AND WATER HARLESS AME SUBJECT TO RELOCATION DUE TO FIELD CONDITIONS.

BECETICAL DEVICES.

MICHORES OVER COUNTER.

48° TO C.

WALL OUTLETS OVER COUNTER.

47° TO BOTTOM OF HORIZONTAL DUTLET(TIP. © CONTER) REMAINING SWITCHES.

48° TO C.

WALL OUTLETS.

48° TO C.

AMERIC SOUTHER AND SUMP OUTLETS.

48° TO C.

EXTERIOR GRI OUTLETS.

48° TO C.

EXPRESSOR GRADES (FLOOR).

48° TO C.

ERRANT DOOR CORAGE (FLOOR).


48° TO C.

ERRANT DOOR CORAGE (FLOOR). 84". TO CL 54". TO CL 84". TO CL BY HANDLE 66". TO CL 72" TO CL UNDER SINK 24". TO CL 48". TO CL 48". TO CL GARAGE DOOR COACH LIGHT, (ABOVE GARAGE FLOOR). . . DOORBELL BUTTON.
KITCHEN HOOD FAN "MHIP"
KITCHEN HOOD FAN "MHIP"
KITCHEN WALL HUNG MICROWAVE OUTLET .
KITCHEN RANGE.
KITCHEN RANGE.
KITCHEN REFRIGERATOR.
WASHER/DRYER OUTLET.

- CL = CENTER LINE

 1 = FIELD VERIFY

 2 = MASTER BATH STANDARD 30" HIGH
 VANITY TO BE RAISED 4"

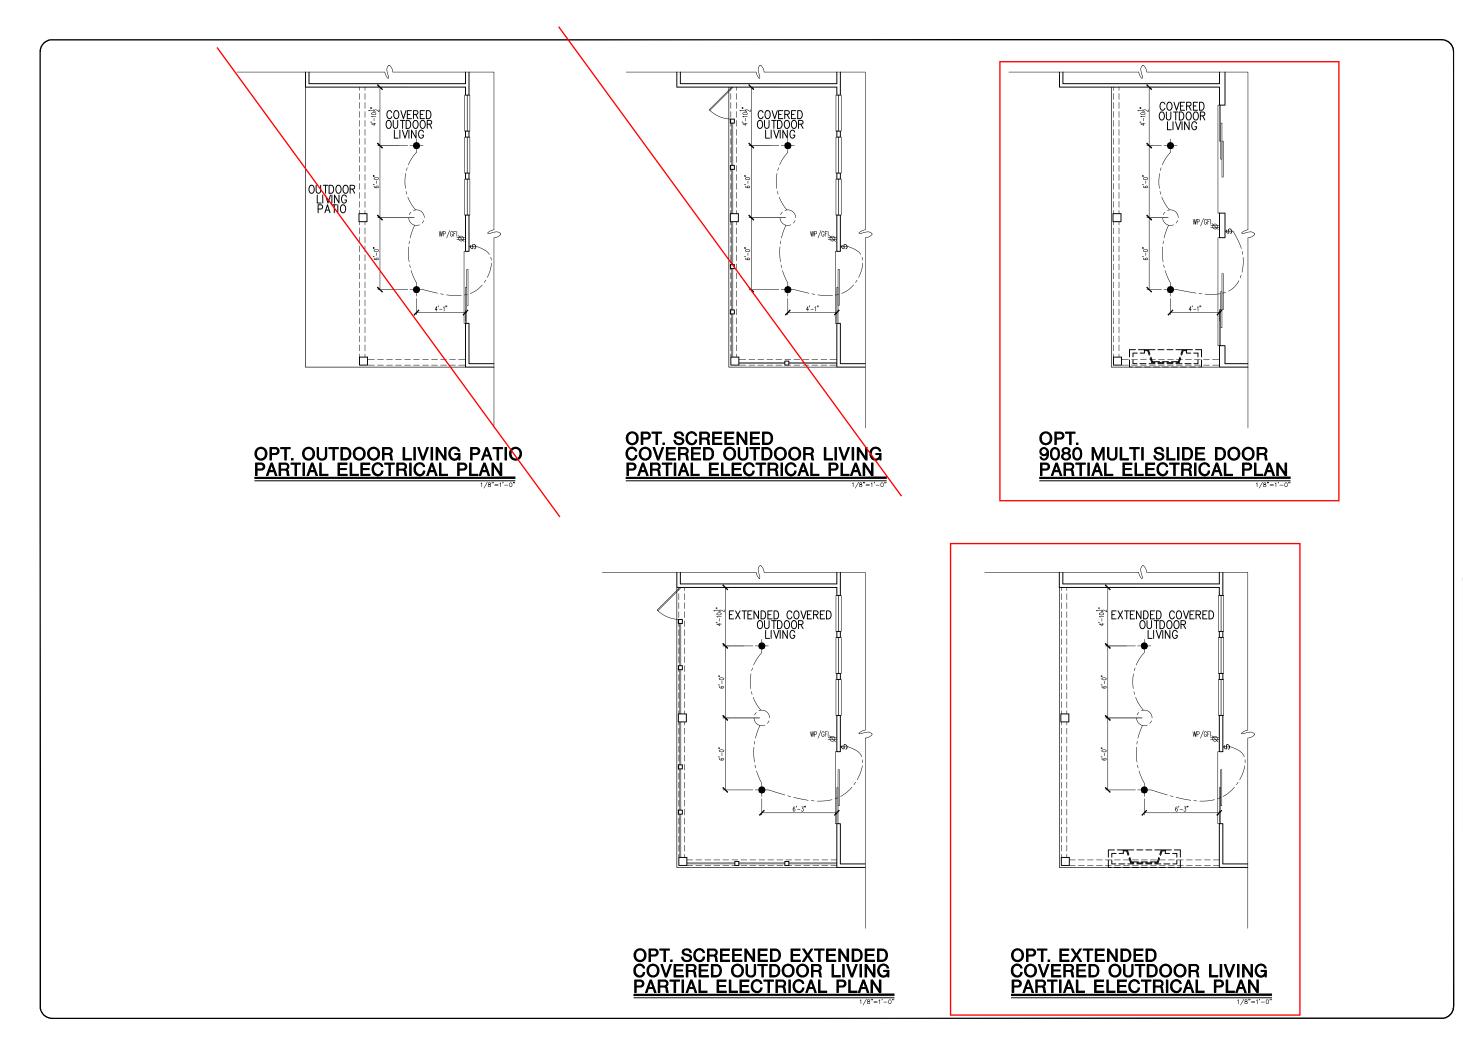

tribointe HOMES 5440 WADE PARK BLVD, SUITE 400, RALEIGH, NG 27607

Business Operations 5440 Wade Park Blvd Suite 400 Raleigh, NC 27607

C. PLAN – OPTIONS

N: Lot 307
24 Shady Creek Way
Altis at Serenity


BLOCK:

SUBDIVISION: CADDRESS: ADDRESS: ADDRESS


Issue Date: 09-30-24
Drawn By: ACC


5920-05


LONGLEAF WAY

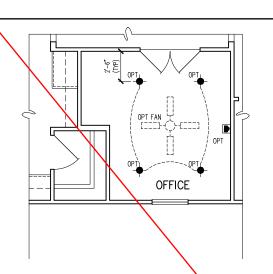

OPT. OFFICE ILO FLEX - PARTIAL ELECTRICAL PLAN

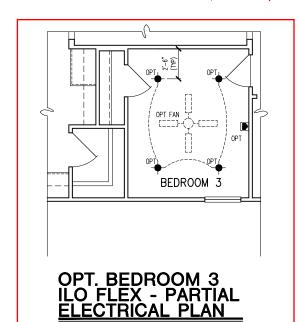


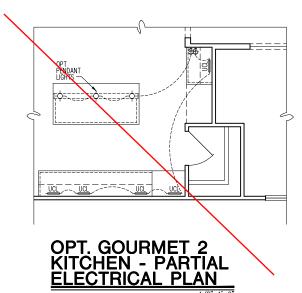

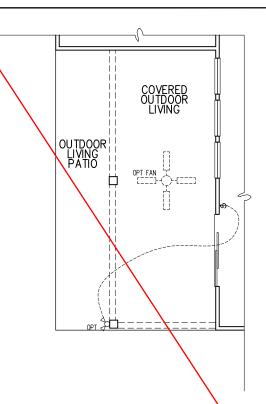


OPT. OUTDOOR LIVING PATIO PARTIAL ELECTRICAL PLAN


OPT. GOURMET 1 KITCHEN - PARTIAL ELECTRICAL PLAN

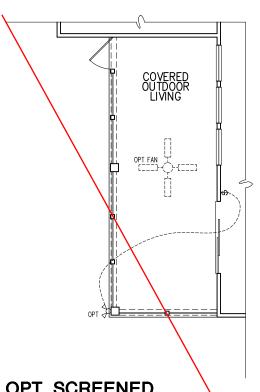


OPT. SCREENED COVERED OUTDOOR LIVING PARTIAL ELECTRICAL PLAN

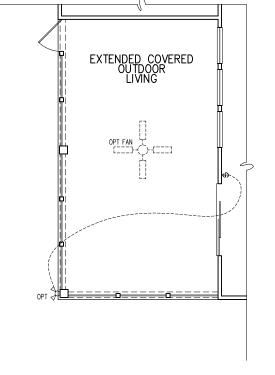

OPT. SCREENED EXTENDED COVERED OUTDOOR LIVING PARTIAL ELECTRICAL PLAN

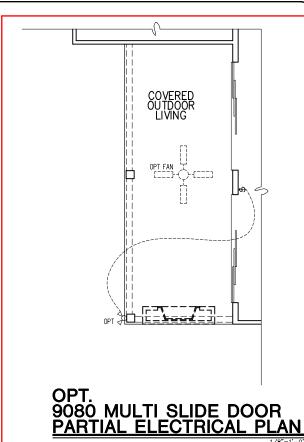

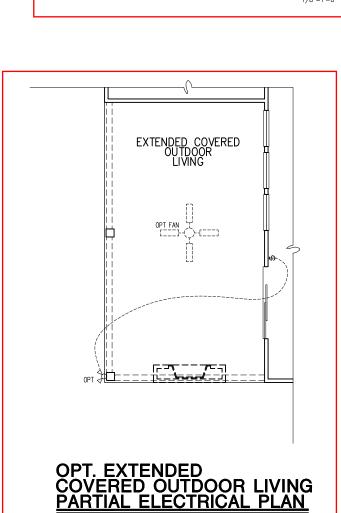

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Business Operations 5440 Wade Park Blvd Suite 400 Raleigh, NC 27607

OPTIONS Lot 307 24 Shady Creek \ Altis at Serenity 1st FLOOR ELEC. PLAN

SUBDIVISION:
ADDRESS:
LOT: BI

09-30-24 Issue Date: ACC

5920-05

LONGLEAF WAY

ELECTRICAL FIXTURE SCHEDULE		
DESCRIPTION	SYMBOL	
110V OUTLET	ф	
220V OUTLET	Q 220	
1/2 HOT OUTLET		
GFI OUTLET	∜ GFI	
WP GFI OUTLET	₩P/GFI	
GARAGE DOOR OPENER OUTLET	Ø GDO	
SECURITY SYSTEM	∯SEC SYS	
DISHWASHER	⊕ DW	
JUNCTION BOX	(3)	
CEILING MOUNTED LIGHT	-	
CEILING FAN w/ LIGHT KIT	PROVIDE	
RECESSED CEILING LIGHT	Ø	
RECESSED WATER PROOF LIGHT)®(WP	
WALL MOUNTED LIGHT	9	
WALL MOUNTED PUSH BUTTON	₫ PB	
TWO WAY SWITCH	\$	
THREE WAY SWITCH	* \$	
FOUR WAY SWITCH	⁴\$	
DIMMER SWITCH	\$ ^{DIM}	
EXHAUST VENTS	S VENT TO EXT	
LOW VOLTAGE PANEL	∳	
PHONE OUTLET	●PH	
TV OUTLET	⊘ TV	
DATA & RG6 COMBO BOX		
SMOKE DETECTOR	(G)	
CARBON MONOXIDE SMOKE DETECTOR COMBO	⊚ CM/SD	
DOOR CHIMES	CHIMES	
ELECTRICAL PANEL	EP.	
SURFACE MOUNT LED	•	
EXTERIOR WALL MOUNT UPLIGHT	8	
SOFFIT MOUNT FLOOD LIGHT	₹\$^	
UNDER COUNTER LIGHTING	UCL	
SMURF TUBE		


ELECTRICAL NOTES:

PROVIDE AND INSTALL LOCALLY CERTIFIED SMOKE AND CARBON MONOXIDE DETECTORS A REQUIRED BY NATIONAL FIRE PROTECTION ASSOCIATION (NFPA) AND MEETING THE REQUIREMENTS OF ALL GOVERNING CODES PROVIDE AND INSTALL GROUND FAULT (IRCUIT-INTERRUPTERS (GFI) AS REQUIRED BY NATIONAL ELECTRIC CODE (NEC) AND MEETING THE REQUIREMENTS OF ALL GOVERNING CODES. ELECTRICAL CONTRACTOR TO PROVIDE REQUIRED DIRECT HOOK—UPS/CUTOFFS.

HVAC CONTRACTOR TO VERIFY THERMOSTAT LOCATIONS.
ALL ELECTRICAL AND MECHANICAL EQUIPMENT (I.E. FURNACES, A/C UNITS, ELECTRICAL PANELS, SANITARY SUMP PITS, DRAIN TILE SUMP, AND WATER HEATERS) ARE SUBJECT TO RELOCATION DUE TO FIELD CONDITIONS.

ELECTRICAL DEVICES. ABOVE FINISHED FLOOR. +42" TO BOTTOM OF HORIZONTAL OUTLET(TYP. @ COUNTER) REMAINING SWITCHES. 48³. TO. CL
WALL OUTLETS. 12." TO CL
BATH VANITY BRACKET OUTLET. J.2
(1' ABOVE TOP OF VANITY) GARAGE DOOR COACH LIGHT, (ABOVE GARAGE FLOOR). . . . 54" TO CL LEVEL W/ DR .HANDLE DOORBELL BUTTON. . . . CL = CENTER LINE 1 = FIELD VERIFY

2 = MASTER BATH STANDARD 30" HIGH VANITY TO BE RAISED 4"

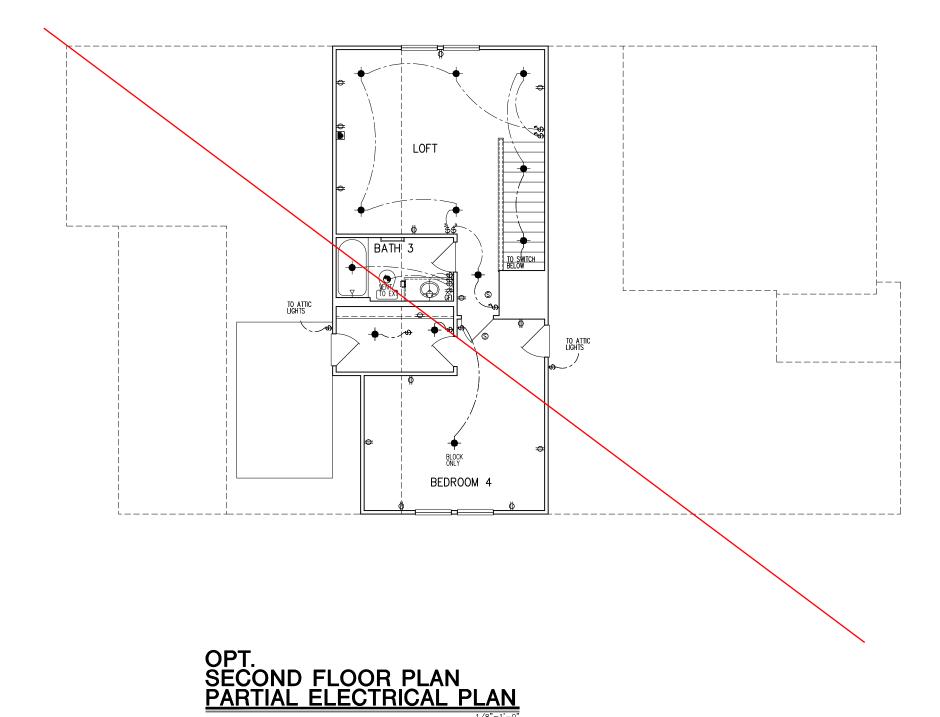

Doint B S ARK BLVD, SUITE 400, RALEIGH, NC 27607

Business Operations 5440 Wade Park Blvd Suite 400 Raleigh, NC 27607

OPTION PLAN


24 Shady Creek W Altis at Serenity BLOCK: FLR ELEC.

SUBDIVISION:
ADDRESS:
LOT: BI 2ND

09-30-24 Drawn By: ACC

5920-05

LONGLEAF WAY

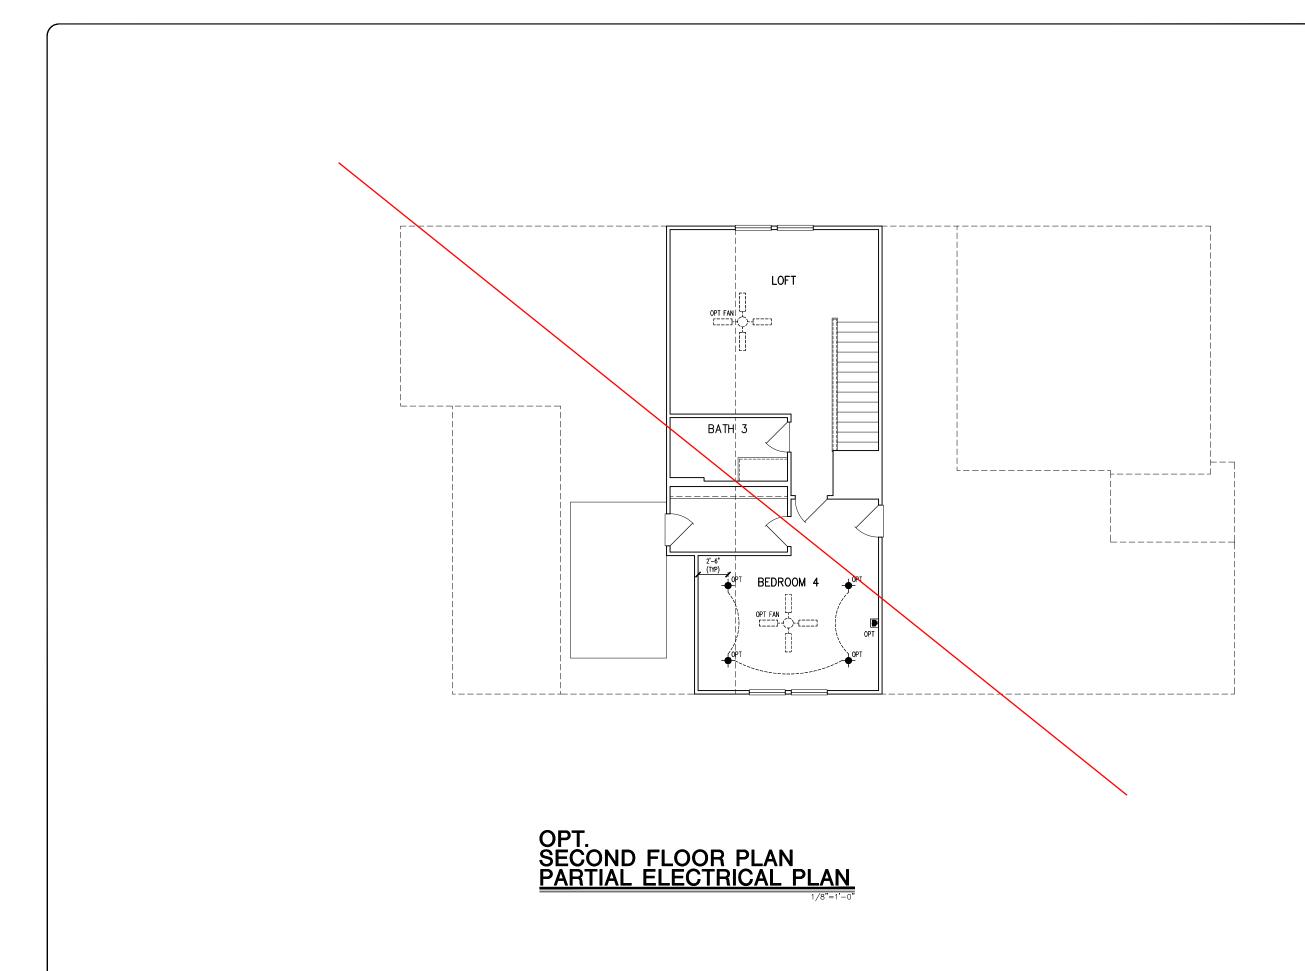

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HOMES

540 WADE PARK BLVD, SUITE 400, RALEIGH, NG 27807

Business Operations 5440 Wade Park Blvd Suite 400 Raleigh, NC 27607

2ND FLOOR ELEC. PLAN – OPTION

SUBDIVISION:
ADDRESS:
LOT:
BL

Issue Date: 09-30-24 Drawn By: ACC

5920-05

PLAN NAME:
LONGLEAF WAY

GENERAL STRUCTURAL NOTES

FLOOR FRAMING

- I IOISTS/TRUSSES SHALL BE DESIGNED BY MANUE TO MEET OR EXCEED L/480 LIVE LOAD DEFLECTION CRITERIA. (EXCLUDES STONE/MARBLE OR WET BED CONSTRUCTED FLOORS - CONTACT M&K FOR EXCLUDED FLOOR DESIGNS)
- PER THE GUIDELINES OF THE TILE COUNCIL OF NORTH AMERICA (TCNA HANDBOOK), IT SHALL BE THE FLOOR FINISH INSTALLER'S RESPONSIBILITY TO VERIEY THAT THE FINISHES TO BE INSTALLED MATCH THE DESIGN CRITERIA NOTED ABOVE (UNDER "DESIGN
- FLOOR SYSTEMS & SHEATHING HAVE BEEN DESIGNED TO SUPPORT ADDITIONAL DEAD LOAD FROM CERAMIC TILE (EXCLUDING MARBLE OR STONE). HOWEVER, IT SHALL BE THE FLOOR FINISH INSTALLER'S RESPONSIBILITY TO PROVIDE PROPER UNDERLAYMENT, UNCOUPLING MEMBRANE AND MORTAR/GROUT PER THE ASSEMBLY DESIGNATIONS IN THE TONA HANDBOOK (TILE COUNCIL OF NORTH AMERICA).
- AT I-JOIST FLOORS, PROVIDE I 1/8" MIN. OSB RIM BOARD.
- METAL HANGERS SHALL BE SPECIFIED BY MANUFACTURER, U.N.O.
- I-JOIST/TRUSS SHOP DWGS. SHALL BE SUBMITTED TO ARCH. & ENG. FOR REVIEW AND APPROVAL PRIOR TO FABRICATION OR DELIVERY
- FLOOR SHEATHING SHALL BE 23/32" A.P.A. RATED 'STURD-I-FLOOR' 24" O.C. EXPOSURE I (OR APPROVED EQUAL) WITH TONGUE AND GROOVE EDGES. FASTEN TO FRAMING MEMBERS W GLUE AND
- 2 ½" x 0.131" NAILS @ 6"o.c. @ PANEL EDGES € @ 12"o.c. FIELD.
- 2 3" x 0.120" NAILS @ 4" O.C. @ PANEL EDGES & @ 8" O.C. FIELD. - 2 3 × 0.113" NAILS @ 3" O.C. @ PANEL EDGES \$ @ 6" O.C. IN FIELD

ROOF FRAMING

- ROOF SHEATHING SHALL BE 7/16" A.P.A. RATED SHEATHING 24/16 EXPOSURE I (OR APPROVED EQUAL). FASTEN TO FRAMING MEMBERS
- W/ 2 ½" x 0.131" NAILS @ 6"o.c. @ PANEL EDGES \$ @ 12" O.C. FIELD.
- · w/ 2 🖁 × 0.120" NAILS 🥑 4"o.c. 💇 PANEL EDGES 🕏 🗗 O.C. FIELD. - w/ 2 3 × 0.113" NAILS @ 3"o.c. @ PANEL EDGES & @ 6" O.C. FIELD.
- WITHIN 48" OF ALL ROOF FDGES RIDGES & HIPS FASTEN ROOF SHEATHING FIELDS PER EDGE NAILING SPEC.
- EASTEN FACH ROOF TRUSS TO TOP PLATE W/ SIMPSON H25T CLIP (OR APPROVED EQUAL) • ALL BEARING POINTS. PROVIDE (2) H2.51 CLIPS AT 2-PLY GIRDER TRUSSES, (3) H2.5T CLIPS AT 3-PLY GIRDER TRUSSES & ROOF BEAMS - AT ALL BEARING POINTS.
- METAL HANGERS SHALL BE SPECIFIED BY THE MANUFACTURER, U.N.O.
- ROOF TRUSS SHOP DWGS SHALL BE SUBMITTED TO ARCH & ENG. FOR REVIEW AND APPROVAL PRIOR TO FABRICATION OR DELIVERY
- ERECT AND INSTALL ROOF TRUSSES PER WTCA & TPI'S BCSI I "GUIDE TO GOOD PRACTICE FOR HANDLING, INSTALLING & BRACING
- OF METAL PLATE CONNECTED WOOD TRUSSES." SUPPORT SHORT SPAN ROOF TRUSSES W/2x4 LEDGER FASTENED TO

FRAMING w/(2) 3" x 0.120" NAILS @ 16" O.C. (UP TO 7' SPAN).

CONNECTION SPECIFICATIONS (TYP. U.N.O.)

DESCRIPTION OF BLDG. ELEMENT	3"x0.131" NAILS	3"x0.120" NAILS		
JOIST TO SOLE PLATE	(3) TOENAILS	(3) TOENAILS*		
SOLE PL. TO JOIST/RIM OR BLK'G	NAILS @ 4" o.c.	NAILS @ 4" o.c.		
STUD TO PLATE	(4) TOENAILS/ (3)END NAILS	(4) TOENAILS/ (4)END NAILS*		
RIM TO TOP PLATE	TOENAILS @ 6" o.c.	TOENAILS @ 4" o.c.*		
BLK'G. BTWN. JOISTS TO TOP PL.	(3) TOENAILS EA. END	(3) TOENAILS EA. END*		
DOUBLE STUD	NAILS @ 16" o.c.	NAILS @ 16" O.C.		
DOUBLE TOP PLATE	NAILS @ 12" o.c.	NAILS @ 8" o.c.		
DOUBLE TOP PLATE LAP SPLICE	(12) NAILS IN LAPPED AREA (24" MIN.)	(15) NAILS IN LAPPED AREA (24" MIN.)		
TOP PLATE LAP @ CORNERS & INTERSECTING WALLS	(3) NAILS	(3) NAILS		
RAFTER/TRUSS TO TOP PLATE	(4) TOENAILS +	(4) TOENAILS +		
	(I) SIMPSON H2.5T	(I) SIMPSON H2.5T		
GAB. END TRUSS TO DBL. TOP PL.	TOENAILS @ 8" o.c.	TOENAILS @ 6" o.c.		
R.T. w/ HEEL HT. 914" TO 12"	2XIO BLK EVERY 3RD BAY FASTENED TO DBL. TOP PLATE W/ TOENAILS @ 6" O.C.	2XIO BLK EVERY 3RD BAY FASTENED TO DBL. TOP PLATE w/ TOENAILS @ 4" O.C.		
R.T. w/ HEEL HT. 12" TO 16"	2x12 BLK EVERY 3RD BAY FASTENED TO DBL. TOP PLATE w/ TOENAILS @ 6" O.C.	2XI2 BLK EVERY 3RD BAY FASTENED TO DBL. TOP PLATE w/ TOENAILS @ 4" O.C.		
R.T. w/ HEEL HT. UP TO 24"	LAP WALL SHTG. W/ DBL. TOP PL. & INSTALL ON TRUSS VERT FASTEN W/ NAILS @ 6" O.C.	LAP WALL SHTG. W/ DBL. TOP PL. \$ INSTALL ON TRUSS VERT FASTEN W/ NAILS @ 6" O.C.*		
R.T. w/ HEEL HT. 24" TO 48"		LAP WALL SHTG. W/ DBL. TOP PL. & INSTALL ON TRUSS VERT FASTEN W/ NAILS @ 6" O.C. PROVIDE 2x BLK @ EA. BAY AT TOP OF HEEL*		
WALL TO FOUNDATION	WALL SHTG. LAP W/ SILL PL. & FASTENED PER SHEAR WALL FASTENING SPEC.			
 2/s/x0.113 IS AN ACCEPTABLE ALTERNATIVE TO A 3"x0.120", SAME SPACING OR NUMBER OF NAILS. (ONLY ACCEPTABLE WHERE * ARE SHOWN) 				

GENERAL STRUCTURAL NOTES

DESIGN LOADING

- DESIGN IS BASED ON 2018 NORTH CAROLINA STATE BUILDING CODE: RESIDENTIAL CODE.
- WOOD FRAME ENGINEERING IS BASED ON NDS, "NATIONAL DESIGN SPECIFICATION FOR WOOD CONSTRUCTION" - LATEST EDITION.
- DESIGN LOADS ROOF

SNOW = 15 PSF (12 PSF GROUND SNOW, TRUSSES) LIVE = 20 PSF (REDUCIBLE BASED ON ROOF PITCH) DEAD = 7 PSF T.C., IO PSF B.C.

LOAD DURATION FACTOR = 1.25 LIVE = 40 PSE (30 PSE @ SLEEPING AREAS)

DEAD = 10 PSF (I-JOISTS), 15 PSF (FLOOR TRUSSES) ADD'L IO PSE @ CERAMIC TILE IN KITCHEN. SUNROOMS, BATHS, FOYER, LAUND, & MUDRIN

2,000 PSF ASSUMED ALLOWABLE BEARING PRESSURE (TO BE VERIFIED BY BUILDER)

115 MPH, EXPOSURE B

GENERAL FRAMING

- ALL TYP, NAIL FASTENER REQUIREMENTS ARE NOTED IN STANDARD CONNECTIONS TABLE (IRC TABLE R602.3(1)) OR ON PLANS. ALL NAILS SPECIFIED ARE MIN DIAMETER AND LENGTH REQUIRED FOR CONNECTION. ALL HANGER NAILS SHALL BE INSTALLED PER MANUFACTURER'S REQUIREMENTS FOR MAX CHARTED CAPACITY NOTE: HANGERS USE COMMON NAIL DIAMETERS NOT TYPICAL FRAMING GUN NAILS.
- EXT & INT BEARING WALLS SHALL BE 2x4 OR 2x6 (AS SHOWN ON PLANS) @ 16" O.C. SPF/SP #2 GRADE LUMBER, OR BETTER, U.N.O.. · WALLS OVER 12' TALL SHALL BE PER PLAN.
- ALL INTERIOR BEARING WALLS ARE ASSUMED TO BE SHEATHED W/ GYP WALL BOARD (ONE SIDE MIN.) OR PROVIDE MID HT. BLOCKING.
- ALL HEADERS, BEAMS & OTHER STRUCTURAL MEMBERS SHALL BE SPRUCE-PINE-FIR #2 (SPE) OR SOUTHERN PINE #2 (SP) LUMBER, OR BETTER, SUPPORT ALL HEADERS/ BEAMS W/ (1)2x JACK STUD & (1)2x KING STUD MINIMUM
- THE NUMBER OF STUDS SPECIFIED AT A SUPPORT INDICATES THE NUMBER OF JACK STUDS REQUIRED, U.N.O.,
- ALL NON-BEARING INTERIOR STUD WALLS SHALL BE CONSTRUCTED WITH 2x 'STUD' GRADE MEMBERS SPACED @ 24" O.C. (MAX., U.N.O.)

 • HEADERS IN NON-LOAD BEARING WALLS SHALL BE: (1)2x4/6 FLAT @ OPENINGS UP TO 4', (2)2x4/6 FLAT UP TO 8'.
- ALL FRAMING LUMBER SHALL BE DRIED TO 15% MC (KD-15)
- ENGINEERED LUMBER BEAMS TO MEET OR EXCEED THE FOLLOWING: • 'LVL' - Fb=2600 psi; Fv=285 psi; E=2.0xl0^6 psi
- ENGINEERED LUMBER POSTS TO MEET OR EXCEED THE FOLLOWING 'LVL' - Fb=2400 psi; FcII=2500 psi; E=I.8xI0^6 psi
- FOR 2 & 3 PLY BEAMS OF EQUAL 134" MAX. WIDTH, FASTEN PLIES TOGETHER WITH 3 ROWS OF 3"X0.120" NAILS @ 8" O/C OR 2 ROWS 18"x3K" SIMPSON SDS SCREWS (OR 3K" TRUSSI OK SCREWS) @ 16" GREATER. APPLY EASTENING AT BOTH FACES FOR 3-PLY CONDITION. LOCATE TOP & BOTTOM NAILS/SCREWS 2" FROM EDGE. SOLID 31/3" OR 51/4" BEAMS ARE ACCEPTABLE, USE 2 ROWS OF NAILS FOR 2x6 \$ 2x8 MEMBERS
- TOGETHER WITH 3 ROWS OF 1/2"x6" SIMPSON SDS SCREWS (OR 6 3/4" TRUSSLOK SCREWS) @ 16" O/C. USE A MINIMUM OF 4 ROWS FOR BEAM DEPTHS OF 14" OR GREATER, APPLY EASTENING AT BOTH FACES (ONE SIDE ONLY FOR TRUSSLOK SCREWS). LOCATE TOP AN BOTTOM SCREWS 2" FROM EDGE. A SOLID 7" BEAM IS ACCEPTABLE
- PROVIDE SOLID BLOCKING IN FLOOR SYSTEM UNDER ALL POSTS CONTINUOUS TO FND./BEARING. BLOCKING TO MATCH POST ABOVE.
- ALL EXTERIOR 4x4 WOOD POSTS SHALL HAVE SIMPSON BCS2-2/4 CAP & ABW44 BASE, U.N.O.
- CORROSION NOTES

Lot 307

Longleaf Way

BUILDER RESPONSIBLE TO DETERMINE CORROSION-RESISTANCE REQUIREMENTS AND COMPATIBILITY OF HARDWARE FASTENERS AND CONNECTORS FOR ENVIRONMENTAL EXPOSURE AND IN CONTACT W/ PRESERVATIVE-TREATED WOOD OF ACTUAL FINAL CONDITIONS AND SOURCED MATERIALS. CONTACT LUMBER & HARDWARE SUPPLIERS TO COORD.

GENERAL STRUCTURAL NOTES

FOUNDATION

- DESIGN IS BASED ON 2018 NORTH CAROLINA STATE BUILDING CODE:
- FOOTING DESIGN 2,000 PSF ALLOWABLE SOIL BEARING
- FASTEN 2x4/6 SILL PLATES TO CONC FND WITH A MINIMUM OF 2
- ANCHORS PER PLATE 12" MAX FROM PLATE ENDS UTILIZING: I/2" DIA. ANCHOR BOLTS 6'-0" O.C,7" MIN. EMBEDMENT
- I/2" DIA. x 6" LONG SIMPSON TITEN HD @ 6'-0" O.C.
- SIMPSON MASA ANCHOR STRAPS @ 6'-0" O.C. (CONCRETE)
- ALL LUMBER EXPOSED TO WEATHER OR IN CONTACT W/ PERIMETER FOUNDATION SHALL BE PRESERVATIVE TREATED SOUTHERN PINE #2.
- BUILDER TO VERIEY CORROSION-RESISTANCE COMPATIBILITY OF HARDWARE & FASTENERS IN CONTACT W/ PRESERVATIVE-TREATED WOOD CONTACT LIMBER & HARDWARE SUPPLIERS TO COORD
- FOOTINGS SHALL BE PLAIN CONCRETE, U.N.O.
- CONCRETE DESIGN BASED ON ACL 318, CONCRETE SHALL ATTAIN THE FOLLOWING MIN. COMPRESSIVE STRENGTHS IN 28 DAYS, U.N.O. f'c = 3,000 psi: FOOTINGS & INTERIOR SLABS ON GRADE 3500 psi: GARAGE & EXTERIOR SLABS ON GRADE fu = 60.000 psi
- ALL CONCRETE EXPOSED TO THE WEATHER SHALL NOT HAVE LESS THAN 5% OR MORE THAN 7% AIR ENTRAINMENT
- ALL FOOTINGS SHALL BEAR BELOW FROST LINE (TYP.) OR 12" MIN I REGIONS WHERE CODE FROST DEPTH IS NOT APPLICABLE. CONSULT SOILS REPORT OR BUILDING DEPT. FOR MINIMUM DEPTH BELOW GRADE
- FOOTINGS AND SLABS ON GRADE SHALL BEAR ON VIRGIN SOIL OR
- PROVIDE CONTROL JOINTS AT ALL INSIDE CORNERS OF SLAB EDGES, AND OTHER LOCATIONS WHERE SLAB CRACKS ARE LIKELY
- JOINTS SHALL BE LOCATED @ 10'-0" O.C. (RECOMMENDED) OR 15'-0" O.C. (MAXIMUM)
- JOINT GRID PATTERN SHALL BE AS CLOSE TO SQUARES AS POSSIBLE (I:I RATIO), WITH A MAXIMUM OF I:I.5 RATIO
- CONTROL JOINTS SHALL <u>NOT</u> BE INSTALLED IN STRUCTURAL
- DIMENSIONS BY OTHERS, BUILDER TO VERIFY.

MEANS & METHODS NOTES

THE STRUCTURE IS DESIGNED TO BE SELF SUPPORTING AND STABLE AFTER THE BUILDING IS FINISHED AND ALL PLAN, DETAIL, AND NOTE SPECIFICATIONS HAVE BEEN COMPLETED. IT IS THE CONTRACTOR'S SOLE RESPONSIBILITY TO DETERMINE THE ERECTION PROCEDURES AND SEQUENCE TO COMPONENTS DURING CONSTRUCTION. THIS INCLUDES BUT IS NOT LIMITED TO, THE ADDITION OF NECESSARY SHORING, SHEETING, TEMPORARY BRACING, GUYS, AND TIE-DOWNS. CONTRACTOR SHALL BE RESPONSIBLE FOR ALL SHORING AND BRACING REQUIRED TO STABILIZE AND PROTECT EXISTING AND ADJACENT STRUCTURES AND SYSTEMS DURING COURSE OF DEMOLITION AND CONSTRUCTION

STRUCTURAL DESIGN AND SPECIFICATIONS ASSUME THAT ALL SUPPORTING AND NON-SUPPORTING ELEMENTS IN CONTACT WITH FLOOR FRAMING ARE LEVEL, INCLUDING, BUT NOT LIMITED TO: FOUNDATIONS. SLABS ON GRADE, BEAMS, WALLS, AND NON-BEARING ELEMENTS. IT IS THE CONTRACTOR'S RESPONSIBILITY TO VERIEY LEVELNESS AND MAKE ADJUSTMENTS AS NECESSARY, INCLUDING CONSIDERATION OF THOSE AREAS THAT MAY BE WITHIN CONTRACTUAL, INDUSTRY OR WARRANTY TOLERANCES.

VENEER LINTEL SCHEDULE

		SPAN (MAX)	HEIGHT OF VENEER ABOVE LINTEL	STEEL ANGLE SIZE
		3'-0"	20 FT. MAX	L3"x3"x¼"
			3 FT. MAX	L3"x3"x¼"
		6'-0"	I2 FT. MAX	L4"x3"x¼"
			20 FT. MAX	L5"x3½"x%;"
		8'-0"	3 FT. MAX	L4"x4"x¼" *
			I2 FT. MAX	L5"x3½"x%;"
			I6 FT. MAX	L6"x3½"x¾"
		9'-6"	I2 FT. MAX	L6"x3½"x%6"
		16'-0"	2 FT. MAX	L7"x4"x½" **
			3 FT, MAX	L8"×4"×½" **

- ILLIMITES.

 \$404LL SIPPORT 2 3/* 3 /5' VIDEER W 40 PM MAXIMM MEIGHT.

 16' SHALL HAVE 4" MIN. BEARING

 16' SHALL HAVE 9" MIN. BEARING

 16' SHALL HAVE 9" MIN. BEARING

 16' SHALL BY STEEPED BACK TO MOOD HEADER IN MALL 446"02. W 3/* DIA. x 3 /5'

 LONG LAG SCREPK IN 2" LONG VERTICALLY SLOTTED HOLES.

 MAY. VEREER IN APPLIES TO ANY FORTION OF PERCK OVER THE OPENING.

 ALL INITIES SHALL BE LONG LEG VERTICAL.

 MAY BEC OF IN THE PELLO TO BE 3/5' MUSE OVER THE BEARING LIGHTH ONLY. THIS

 SEE STRUCTURAL PAINS FOR ANY LIMITEL CANDITION NOT ENCOMPASSED BY THE

 ROOK GERN SHEPPING IVE ANY LIMITEL CANDITION NOT ENCOMPASSED BY THE

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- FOR QUEEN VENEER USE L4x3x/4". 'FOR 3½" VENEER ONLY, SEE PLAN FOR VENEER SUPPORT IF VENEER < 3½" THICK

ADDITIONAL NOTES FOR TRUSS \$ I-JOIST MANUFACTURER

ROOF TRUSS, FLOOR TRUSS AND ENGINEERED JOISTS SHALL BE DESIGNED TO MEET THE DEFLECTION CRITERIA BELOW, UNLESS NOTED OTHERWISE ON PLAN, MULHERN & KULP CANNOT BE HELD RESPONSIBLE FOR ANY STRUCTURAL ISSUES
RELATED TO ANY BUILDING COMPONENT IF COMPONENT SHOP DRAWINGS ARE NOT SUBMITTED TO M&K FOR REVIEW PRIOR TO FABRICATION, DELIVERY, OR INSTALLATION.

TRUSSES/JOISTS SHALL BE DESIGNED SO THAT DIFFERENTIAL DEFLECTION BETWEEN ADJACENT PARALLEL TRUSSES/JOISTS OR GIRDER TRUSSES/FLUS BEAMS DO NOT EXCEED THE FOLLOWING: A ROOF TRUSSES.

- I/4" DEAD LOAD
- B. FLOOR TRUSSES, ATTIC TRUSSES, & I-JOISTS; ABSOLUTE DEAD LOAD DEFECTION OF FLOOR
- TRUSSES/ATTIC TRUSSES WHEN ADJACENT TO FLOOR FRAMING BY OTHERS SHALL BE LIMITED TO 3/16". (NO DIFFERENTIAL DEFLECTION,

FLOOR JOIST NOTES

- ALL FLOOR JOISTS SHALL BE THE DEPTI SPECIFIED ON PLAN FLOOR JOISTS SERIES & SPACING IS PER THE FLOOR JOIST MANUF.
- SPACING SHALL NOT EXCEED 19.2" O.C. (MAX.) LOCATION OF TILE: SPACING SHALL NOT
- EXCEED 16" O.C. (MAX.)

LATERAL/WALL BRACING & WALL SHEATHING SPECIFICATIONS

THIS MODEL HAS BEEN DESIGNED TO RESIST LATERAL FORCES RESULTING FROM:

5 MPH WIND IN 2018 NCSBC:RO

(115 MPH WIND SPEED IN ASCE 7-10 WIND MAP, PER IRC R301,2,1,1) EXP. B, RISK CAT. 2 & SEISMIC CAT. A/B.

THE DESIGN WAS COMPLETED PER 2015 IBC (SECTION 1609) & ASCE 7-10, AS PERMITTED BY R301.1.3 OF THE 2018 NCSBC:RC, ACCORDINGLY THIS MODEL, AS DOCUMENTED AND DETAILED HEREWITHIN, IS ADEQUATE TO RESIST THE CODE REQUIRED LATERAL FORCES.

DESIGN WIND UPLIET LOADS HAVE BEEN CALCULATED UTILIZING ASCE 7-10 (ACCEPTED ENGINEERING PRACTICE) AS ALLOWED PER 2018 NCSBC:RC SECTION R802.II.I.I. THIS MODEL HAS BEEN DETAILED WHERE REQUIRED & ENGINEERED TO RESIST THE WIND UPLIFT LOAD PATH PER SECTIONS R602.3.5& R802.II.

EXT. WALL SHEATHING SPECIFICATION

- 7/16" OSB OR 15/32" PLYWOOD: FASTEN SHEATHING W/ 2 ₹x0.113 NAILS @ 6" O.C. AT EDGES & @ 12" O.C. IN THE PANEL FIELD. (TYP, U.N.O.) ALL SHEATHING PANELS SHALL BE ORIENTED
- VERTICALLY (LONG DIRECTION PARALLEL TO STUDS) AND INSTALLED FULL HEIGHT OF SHEAR WALL - OR 2x HORIZONTAL BLOCKING SHALL BE PROVIDED TO SUPPORT ALL UNSUPPORTED PANEL EDGES & EDGE
- ALL EXT. WALLS SHALL BE CONTINUOUSLY SHEATHED AND ARE CONSIDERED SHEAR WALLS.
- ALT. STAPLE CONNECTION SPEC: 1 3/4" 16 GA STAPLES (1/6" CROWN) @ 3" O.C. AT EDGES \$ @ 6" O.C IN FIELD.

<u>3" O.C. EDGE NAILING</u>

 AT DESIGNATED AREAS - FASTEN PANEL EDGES OF WOOD STRUCTURAL WALL SHEATHING TO FRAMING W 2 🖁 × 0.113" NAILS @ 3" O.C. AND 12" O.C. IN THE PANEL FIELD NO STAPLE ALTERNATIVE AVAILABLE AT THIS SPEC. ALL SHEATHING PANELS SHALL BE ORIENTED VERTICALLY (LONG DIRECTION PARALLEL TO STUD) AND INSTALLED FULL HEIGHT OF SHEAR WALL - OR - 2x HORIZONTAL BLOCKING SHALL BE PROVIDED TO SUPPORT UNSUPPORTED PANEL EDGES AND 3" O.C. EDGE FASTENING.

TYP. UNIT SEPARATION WALL SHEATHING SPECIFICATION

•1/2" OR 5/8" GYPSUM WALL BOARD: FASTEN GWB SHEATHING TO FRAMING W/ I \$"X0.086" COOLER NAILS OR I 1/4" DRYWALL SCREWS @ 7" O.C. " PANEL EDGES & PANEL FIELD (INCLUDING T&B PLATES

- SEE CONNECTION SPECIFICATIONS CHART FOR STANDARD SHEAR TRANSFER DETAILING. IF ADDITIONAL CAPACITY IS REQUIRED BY DESIGN. T WILL BE SPECIFICALLY NOTED ON PLAN.
- DESIGN ASSUMES 16" O.C MAX. STUD SPACING, U.N.O.
- · ALL STRUCTURAL PANELS ARE TO BE DIRECTLY APPLIED TO STUD FRAMING.
- PRE-MANUFACTURED PANELIZED WALLS: FASTEN TOGETHER END STUDS OF WALL PANELS SHFATHED W/ OSB OR PLYWOOD W/ 3" x 0.120" NAILS @ 4" O.C. (THRU ONE SIDE ONLY)

INDICATES EXTENT OF INT. OSB SHEARWALL, BLOCKED PANEL EDGES. AND/OR 3" O.C. EDGE NAILING

INDICATES HOLDOWN

MULHERN+KULP
RESIDENTIAL STRUCTURAL ENGINEBRING



lulhern+Kulp project numbe

243-2403 SMI drawn by SMI

08-16-24

ssue date: REVISIONS

initial: 1-08-202 SMM AME, OPT. EXT. COVID. PORCH, 05-08-2025 MISC, ARCH UPDATE


NOTES MODE GENERAL

-05 SERENITY MASTER SET RALEIGH, NC 5920-

S0.0

Opt Extended Covered Outdoor Living

Plan 5920-05 Elevation B- Garage Right

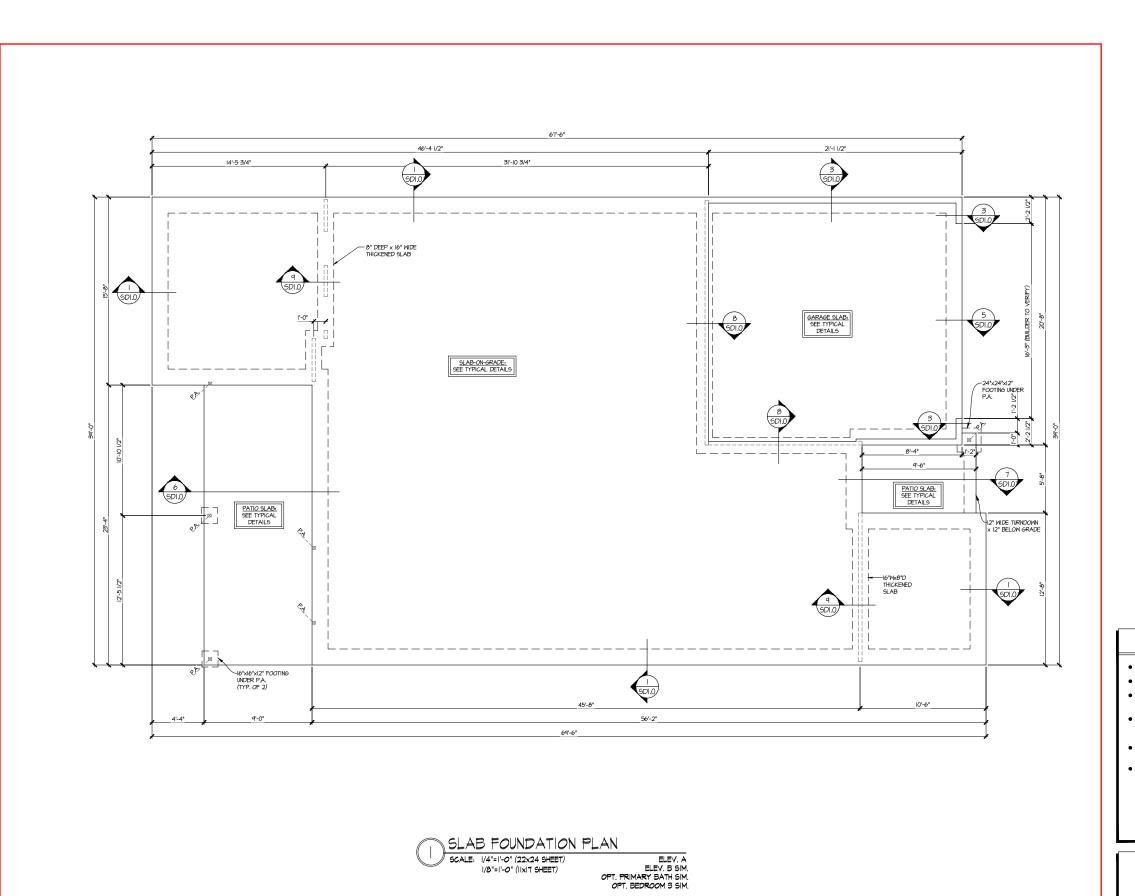

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Mulhern+Kulp project number:

243-2403

SMK SMM drawn by: issue date: 08-16-24

REVISIONS:

date: II-08-2024 UPDATED MODEL NAM OPT. OFFICE 05-08-2025 MISC. ARCH UPDATES initial: SMM . NAME, OPT. EXT. COVID. PORCH,

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5920-05 MODEL SERENITY MASTER SET RALEIGH, NC

FOUNDATION PLAN


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LEGEND

- INTERIOR BEARING WALL
- ==== BEARING WALL ABOVE (B.W.A.)
- --- BEAM / HEADER
- INDICATES EXTENT OF INT.

 OSB SHEARWALL AND/OR
 3" O.C. EDGE NAILING
- EXTENT OF VALLEY TRUSS OVERFRAMING
- EXTENT OF FLOOR SYSTEM TO BE DESIGNED FOR TILE
- ► INDICATES HOLDOWN
- * INDICATES POST ABOVE. PROVIDE SOLID BLOCKING UNDER POST OR JAMB ABOVE.

REFER TO SO.O FOR TYPICAL STRUCTURAL NOTES # SCHEDULES

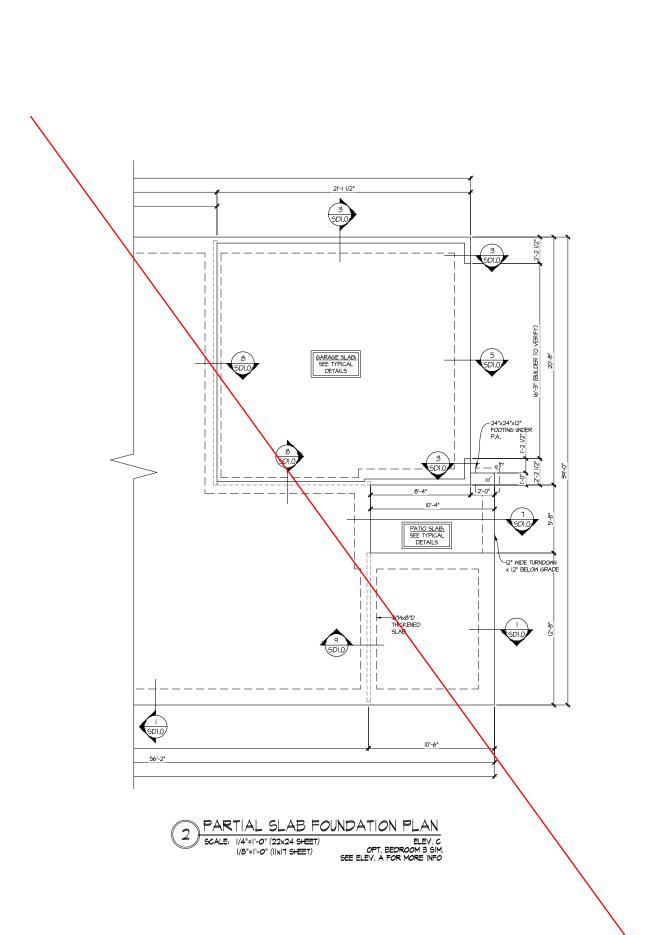

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243-2403

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FOUNDATION PLAN 5920-05 MODEL

LEGEND

- INTERIOR BEARING WALL
- ==== BEARING WALL ABOVE (B.W.A.)
- ---- BEAM / HEADER
- INDICATES EXTENT OF INT.

 OSB SHEARWALL AND/OR
 3" O.C. EDGE NAILING
- EXTENT OF VALLEY TRUSS OVERFRAMING 24" O.C. (MAX.)
- EXTENT OF FLOOR SYSTEM TO BE DESIGNED FOR TILE
- ► INDICATES HOLDOWN


REFER TO SO.O FOR

TYPICAL STRUCTURAL NOTES

& SCHEDULES

- **JL** METAL HANGER
- * INDICATES POST ABOVE. PROVIDE SOLID BLOCKING UNDER POST OR JAMB ABOVE.

SERENITY MASTER SET RALEIGH, NC

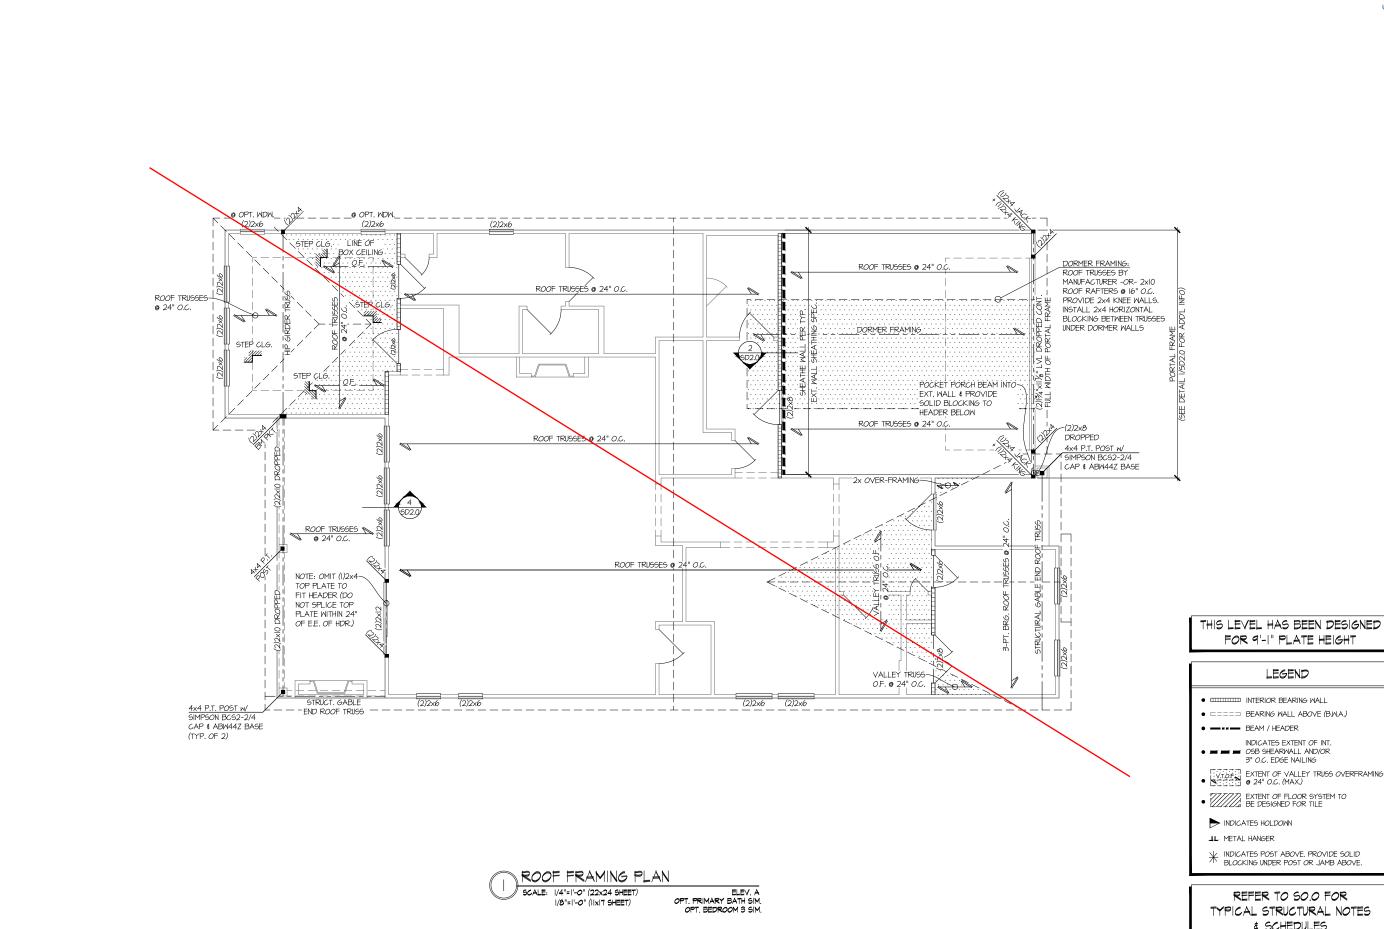

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tri pointe

THIS LEVEL HAS BEEN DESIGNED FOR 9'-1" PLATE HEIGHT

LEGEND

- IIIIII INTERIOR BEARING WALL
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- INDICATES EXTENT OF INT.

 OSB SHEARWALL AND/OR
 3" O.C. EDGE NAILING


- | INDICATES POST ABOVE. PROVIDE SOLID BLOCKING UNDER POST OR JAMB ABOVE.


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ROOF FRAMING PLAN 5920-05 MODEI

S2.0

SERENITY MASTER SET RALEIGH, NC



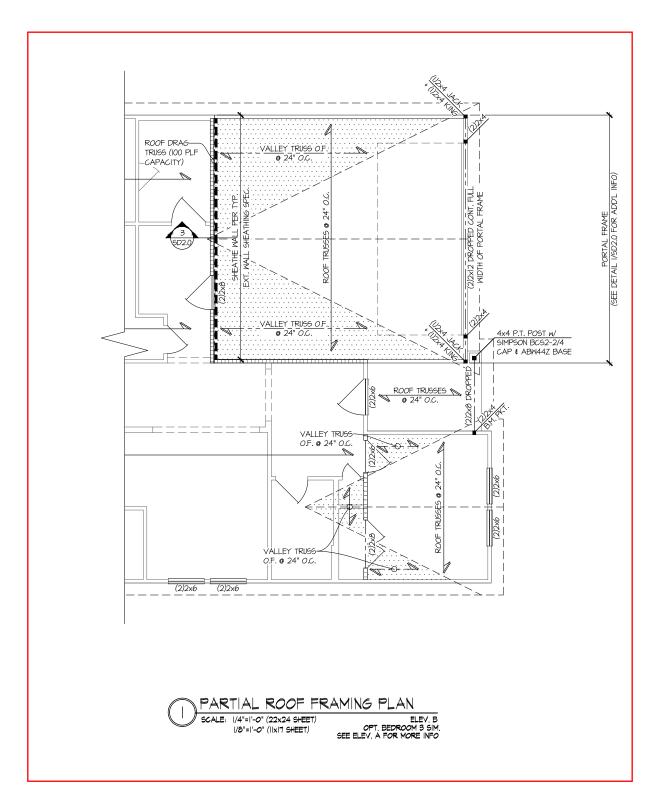

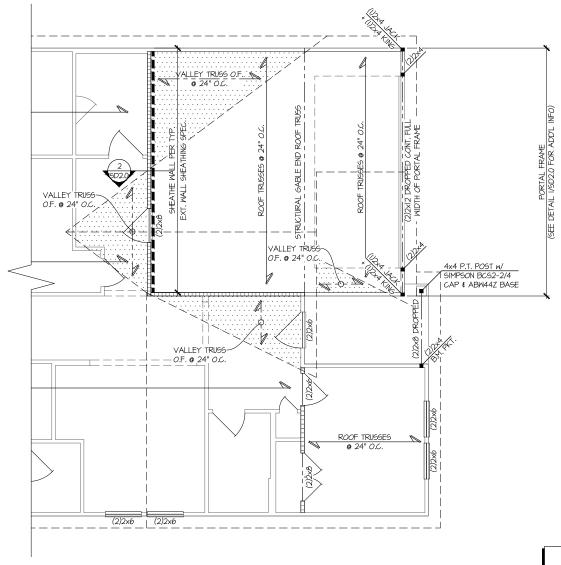PARTIAL ROOF FRAMING PLAN 2 SCALE: |/4"=|'-0" (22x24 SHEET)

1/8"=1'-0" (IIxI7 SHEET)

ELEV. C OPT. BEDROOM 3 SIM. SEE ELEV. A FOR MORE INFO

THIS LEVEL HAS BEEN DESIGNED FOR 9'-1" PLATE HEIGHT

REFER TO SO.O FOR TYPICAL STRUCTURAL NOTES # SCHEDULES

LEGEND

- IIIIII INTERIOR BEARING WALL
- □===□ BEARING WALL ABOVE (B.W.A.)
- ---- BEAM / HEADER
- INDICATES EXTENT OF INT.

 OSB SHEARWALL AND/OR
 3" O.C. EDGE NAILING
- EXTENT OF VALLEY TRUSS OVERFRAMING

 24" O.C. (MAX.)

- EXTENT OF FLOOR SYSTEM TO BE DESIGNED FOR TILE
- NDICATES HOLDOWN
- | INDICATES POST ABOVE. PROVIDE SOLID BLOCKING UNDER POST OR JAMB ABOVE.

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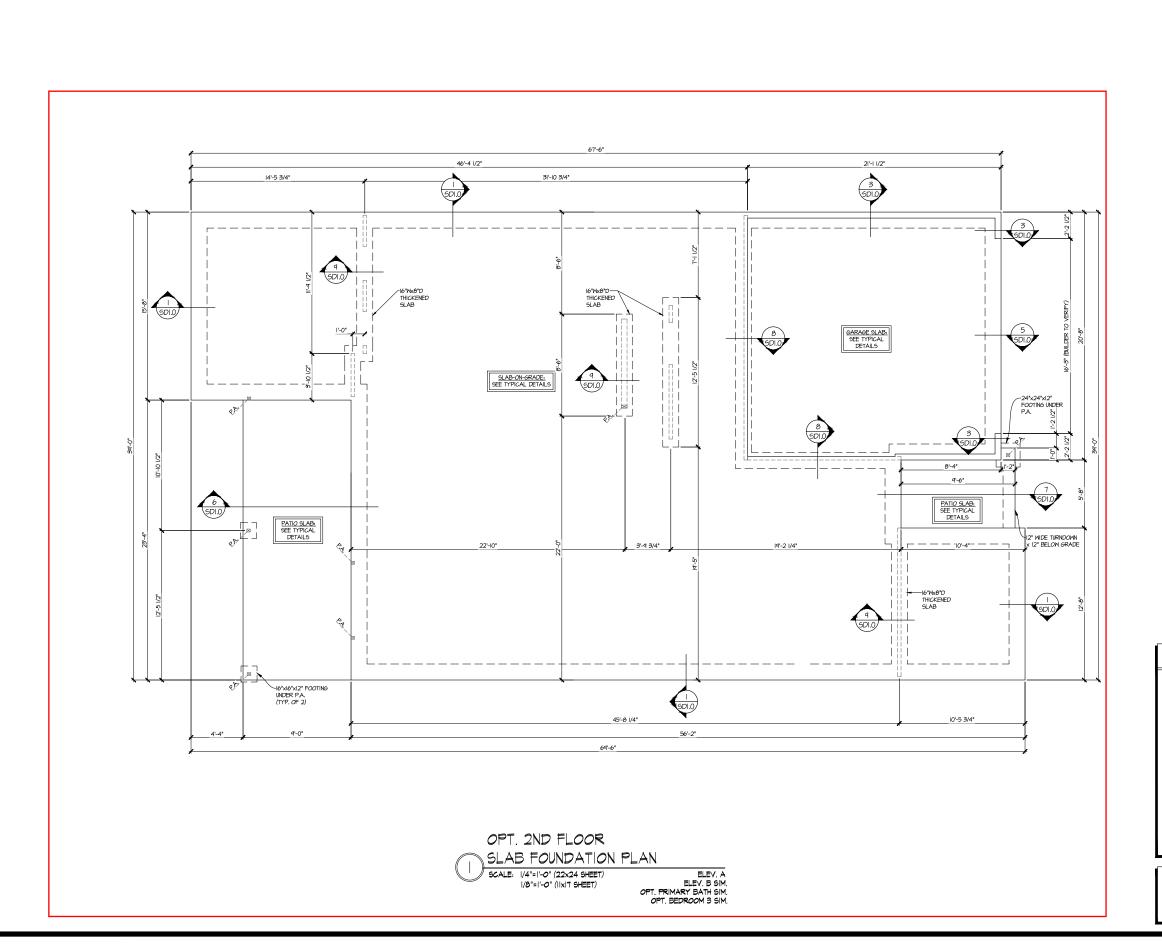
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ROOF FRAMING PLAN 5920-05 MODEI

SERENITY MASTER SET RALEIGH, NC

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Mulhern+Kulp project number:

243-2403

SMK

SMM 08-16-24

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- BEAM / HEADER
- INDICATES EXTENT OF INT.

 OSB SHEARWALL AND/OR
 3" O.C. EDGE NAILING
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- NDICATES HOLDOWN

- | INDICATES POST ABOVE. PROVIDE SOLID BLOCKING UNDER POST OR JAMB ABOVE.


REFER TO SO.O FOR TYPICAL STRUCTURAL NOTES # SCHEDULES

STRUCTURAL OPTIONS

5920-05 MODEI

S3.0

SERENITY MASTER SET RALEIGH, NC

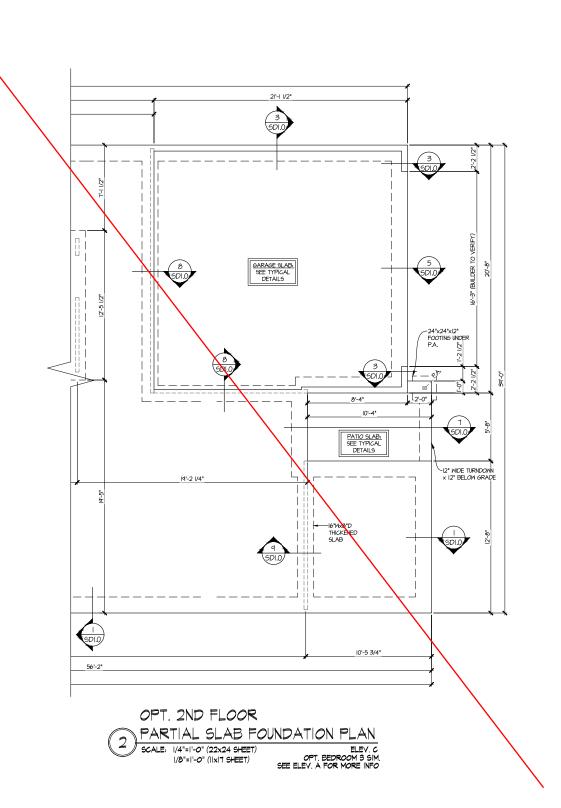

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NC Licence # C-2825



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tri pointe

STRUCTURAL OPTIONS 5920-05 MODEI SERENITY MASTER SET RALEIGH, NC

EXTENT OF FLOOR SYSTEM TO BE DESIGNED FOR TILE

REFER TO SO.O FOR

TYPICAL STRUCTURAL NOTES

SCHEDULES

JL METAL HANGER

| INDICATES POST ABOVE. PROVIDE SOLID BLOCKING UNDER POST OR JAMB ABOVE.

LEGEND

 INTERIOR BEARING WALL • ==== BEARING WALL ABOVE (B.W.A.)

• ---- BEAM / HEADER


INDICATES EXTENT OF INT.

OSB SHEARWALL AND/OR
3" O.C. EDGE NAILING

EXTENT OF VALLEY TRUSS OVERFRAMING • 24" O.C. (MAX.)

NDICATES HOLDOWN

S3.1

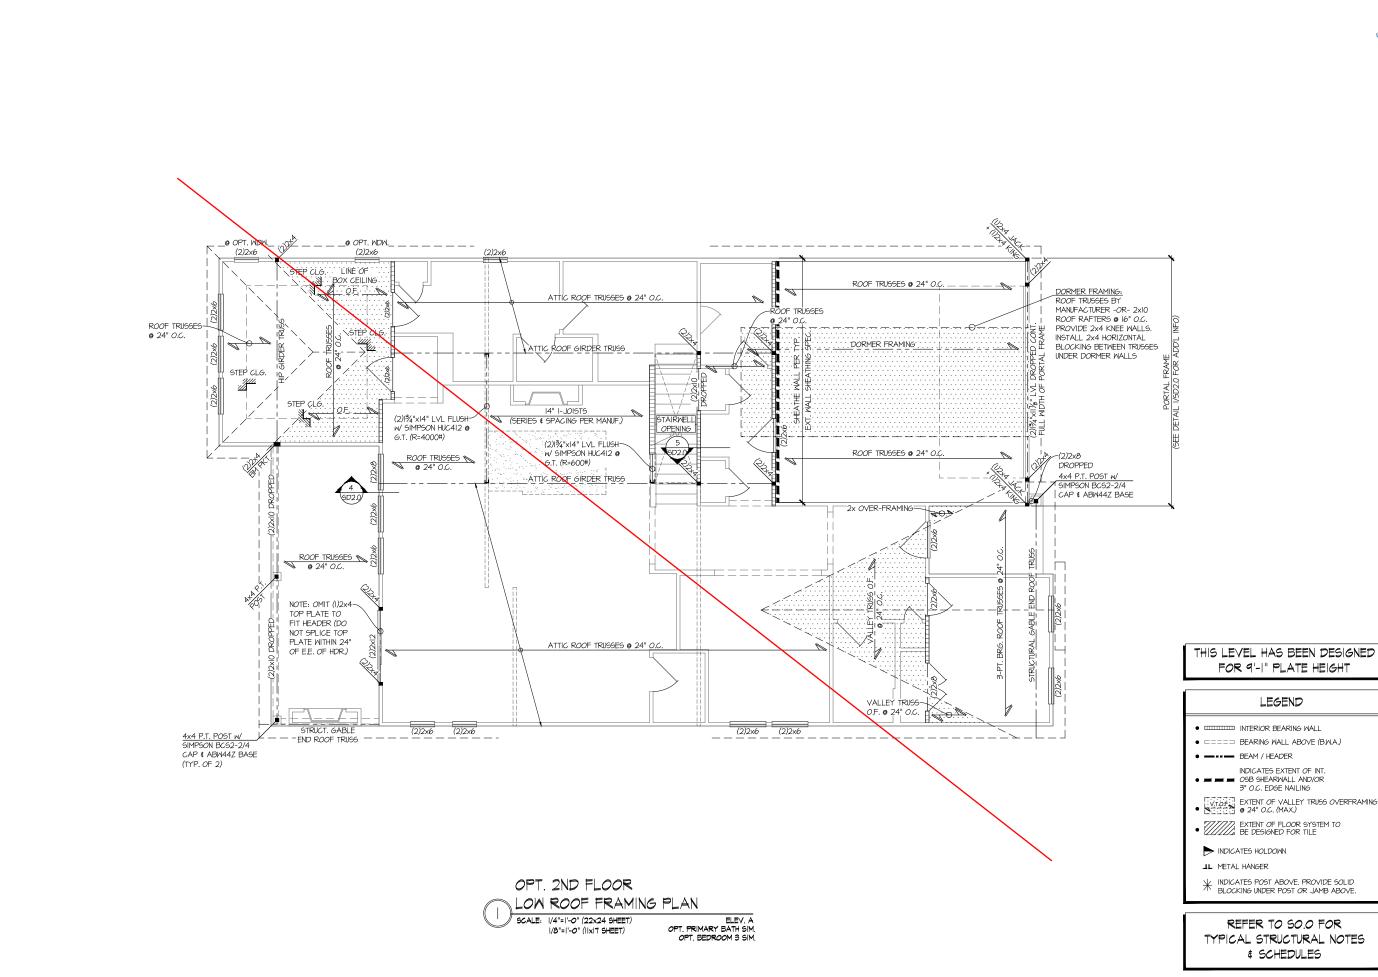

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NC. Licence # C-3625

Mulhern+Kulp project number

243-2403

SMK

SMN

08-16-24 issue date:

REVISIONS:

SMM . NAME, OPT. EXT. COVID. PORCH, 11-08-2024 05-08-2025 MISC. ARCH UPDATES

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THIS LEVEL HAS BEEN DESIGNED FOR 9'-1" PLATE HEIGHT

- IIIIIII INTERIOR BEARING WALL
- ==== BEARING WALL ABOVE (B.W.A.)
- INDICATES EXTENT OF INT.

 OSB SHEARWALL AND/OR
 3" O.C. EDGE NAILING

- | INDICATES POST ABOVE. PROVIDE SOLID | BLOCKING UNDER POST OR JAMB ABOVE.

REFER TO SO.O FOR TYPICAL STRUCTURAL NOTES \$ SCHEDULES


STRUCTURAL


OPTIONS

S3.2

5920-05 MODEI

SERENITY MASTER SET RALEIGH, NC

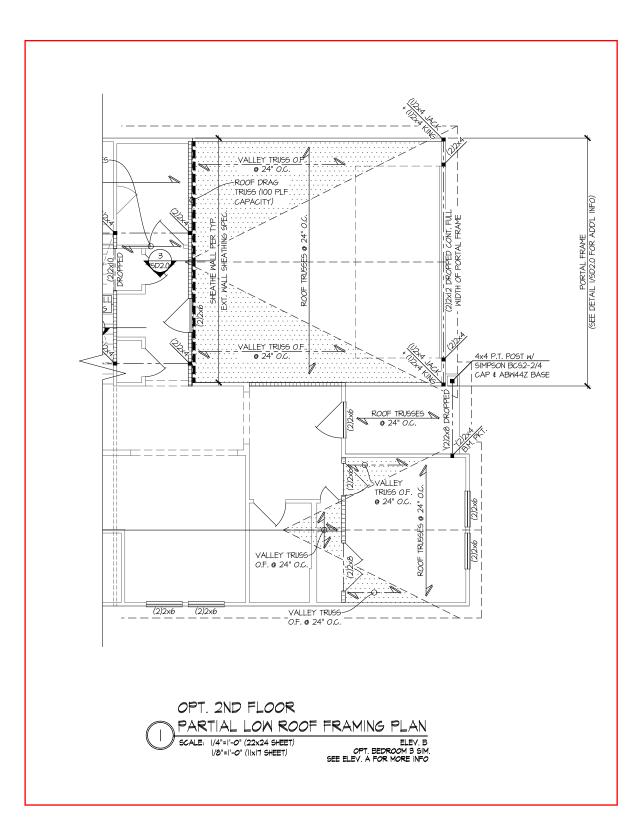

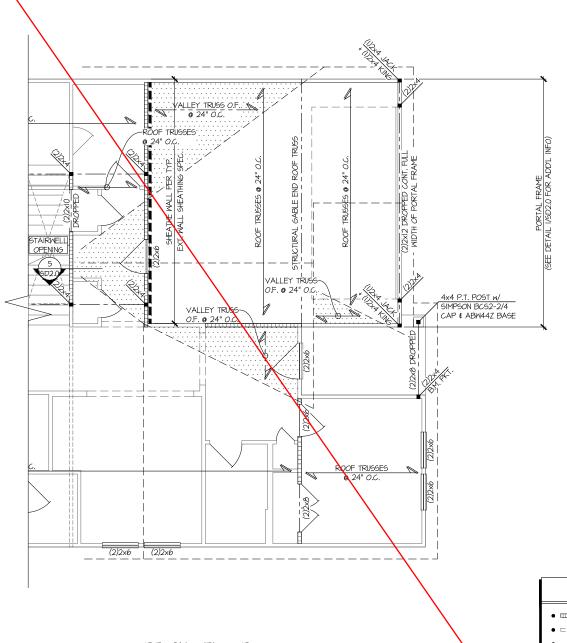

OPT. 2ND FLOOR

PARTIAL LOW ROOF FRAMING PLAN

SCALE: 1/4"=1'-0" (22x24 SHEET) 1/8"=1'-0" (11x17 SHEET)

ELEV. C OPT. BEDROOM 3 SIM. SEE ELEV. A FOR MORE INFO

THIS LEVEL HAS BEEN DESIGNED FOR 9'-1" PLATE HEIGHT

REFER TO SO.O FOR TYPICAL STRUCTURAL NOTES # SCHEDULES

LEGEND

- INTERIOR BEARING WALL
- □===□ BEARING WALL ABOVE (B.W.A.)
- ---- BEAM / HEADER
- INDICATES EXTENT OF INT.

 OSB SHEARWALL AND/OR
 3" O.C. EDGE NAILING
- EXTENT OF VALLEY TRUSS OVERFRAMING

 24" O.C. (MAX.)
- EXTENT OF FLOOR SYSTEM TO BE DESIGNED FOR TILE
- NDICATES HOLDOWN
- | INDICATES POST ABOVE. PROVIDE SOLID BLOCKING UNDER POST OR JAMB ABOVE.

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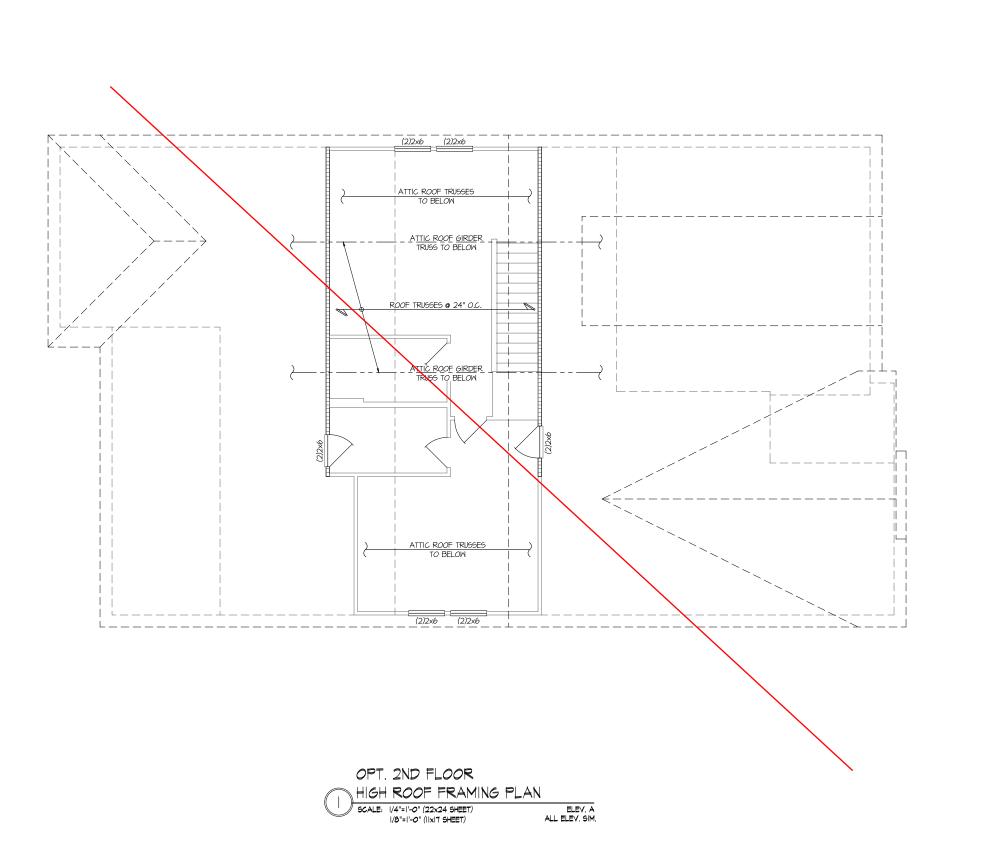
14 SMM EL NAME, OPT. EXT. COVID. PORCH, 11-08-2024 UPDATED MODEL NAM OPT. OFFICE 05-08-2025 MISC. ARCH UPDATES

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STRUCTURAL OPTIONS 5920-05 MODEI

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S3.3



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THIS LEVEL HAS BEEN DESIGNED FOR 9'-I" PLATE HEIGHT

LEGEND

- IIIIII INTERIOR BEARING WALL
- ==== BEARING WALL ABOVE (B.W.A.)
- INDICATES EXTENT OF INT.

 OSB SHEARWALL AND/OR
 3" O.C. EDGE NAILING
- EXTENT OF VALLEY TRUSS OVERFRAMING
 24" O.C. (MAX.)
- EXTENT OF FLOOR SYSTEM TO BE DESIGNED FOR TILE
- NDICATES HOLDOWN

- | INDICATES POST ABOVE. PROVIDE SOLID BLOCKING UNDER POST OR JAMB ABOVE.


REFER TO SO.O FOR TYPICAL STRUCTURAL NOTES # SCHEDULES


STRUCTURAL OPTIONS

5920-05 MODEL

S3.4

SERENITY MASTER SET RALEIGH, NC

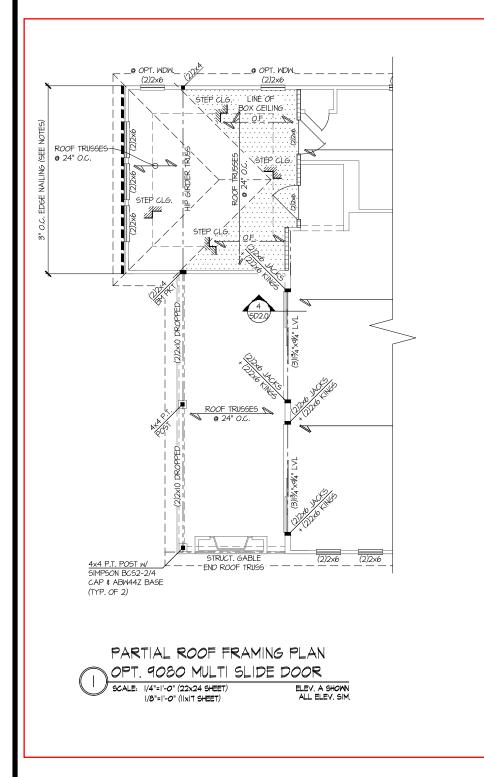


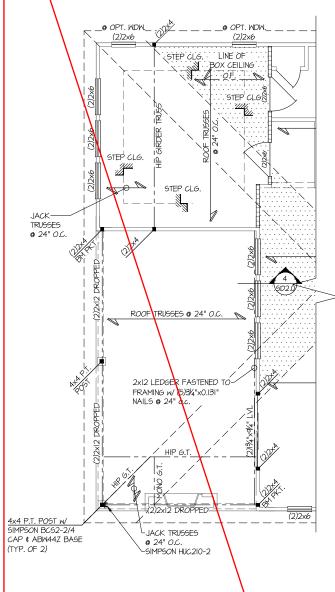

PARTIAL ROOF FRAMING PLAN OPT. EXT. COVERED PORCH

SCALE: 1/4"=1'-0" (22x24 SHEET) 1/8"=1'-0" (IIxIT SHEET)

ELEV. A
ALL ELEV. SIM.
OPT. SCREENED EXTENDED
COVERED OUTDOOR LIVING SIM.

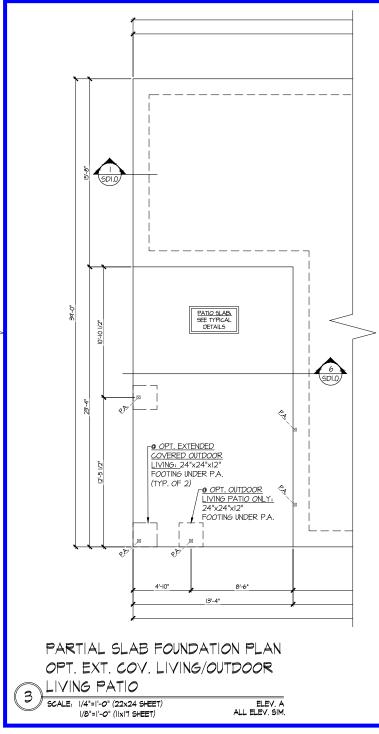

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SMK drawn by: SMN issue date: 08-16-24

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OPTIONS

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initial: SMM NAME, OPT. EXT. COVID. PORCH, 11-08-2024 05-08-2025 MISC, ARCH UPDATE

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THIS LEVEL HAS BEEN DESIGNED FOR 9'-I" PLATE HEIGHT

- IIIII INTERIOR BEARING WALL
- ==== BEARING WALL ABOVE (B.W.A.)
- INDICATES EXTENT OF INT.

 OSB SHEARWALL AND/OR

- INDICATES HOLDOWN

REFER TO SO.O FOR TYPICAL STRUCTURAL NOTES \$ SCHEDULES

LEGEND

BEAM / HEADER

3" O.C. EDGE NAILING


EXTENT OF VALLEY TRUSS OVERFRAMING


224" O.C. (MAX.)

EXTENT OF FLOOR SYSTEM TO BE DESIGNED FOR TILE

| INDICATES POST ABOVE. PROVIDE SOLID BLOCKING UNDER POST OR JAMB ABOVE.

S3.5

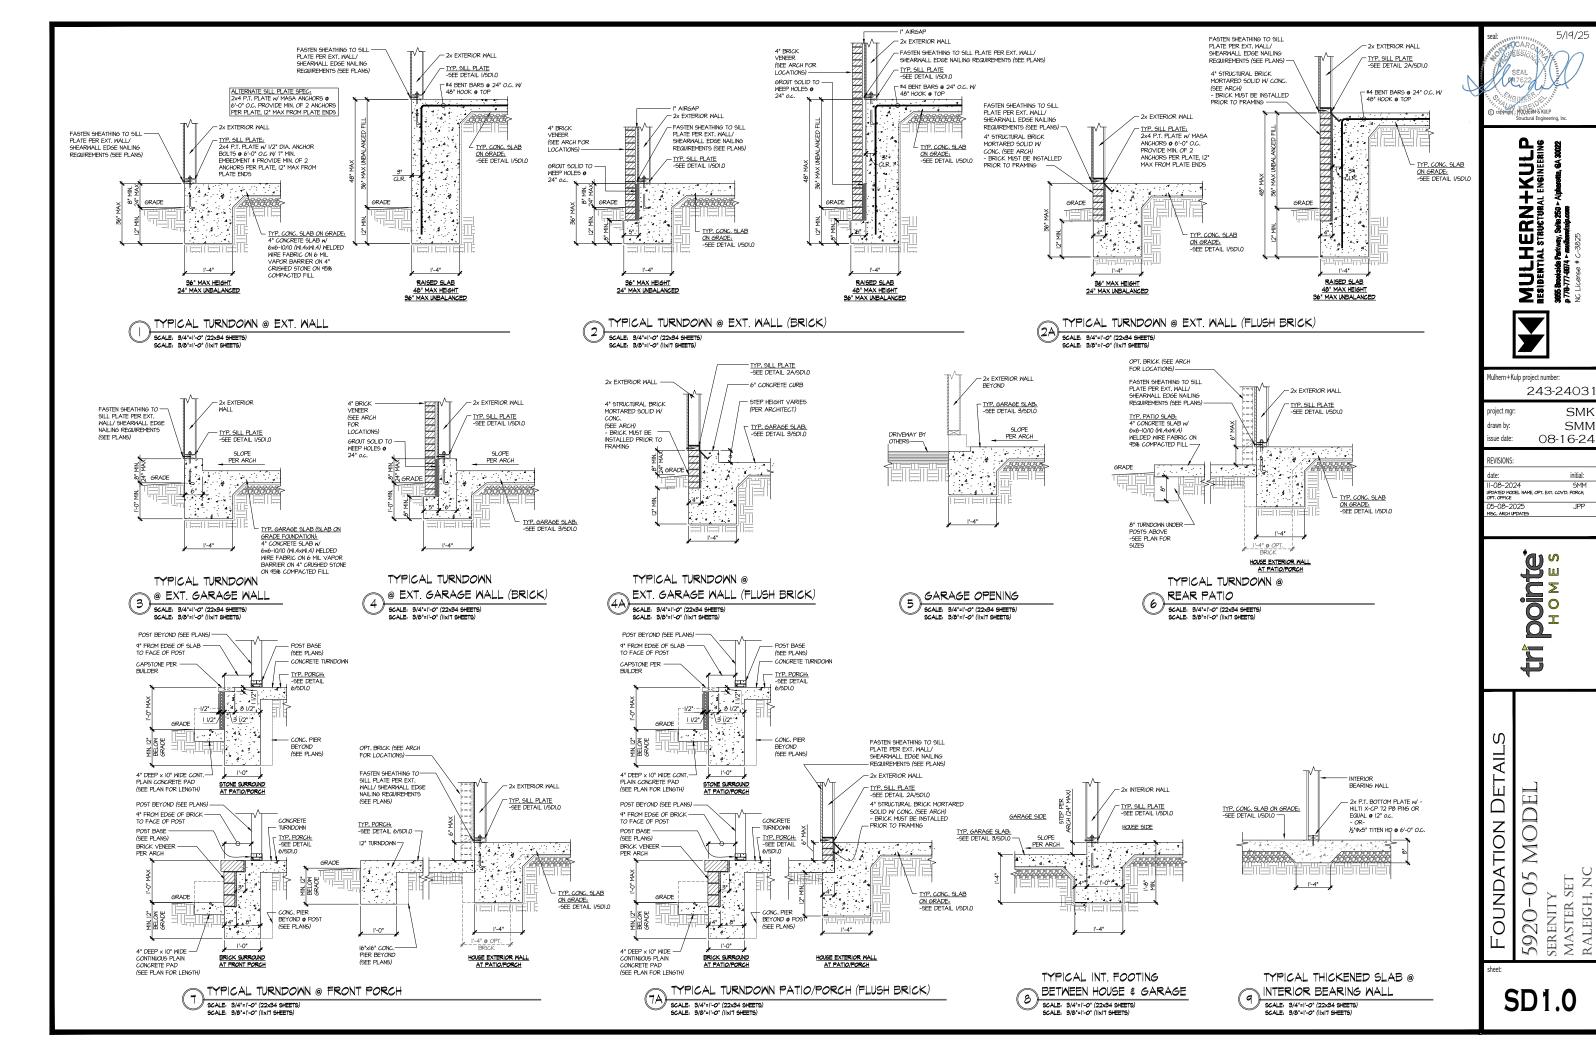

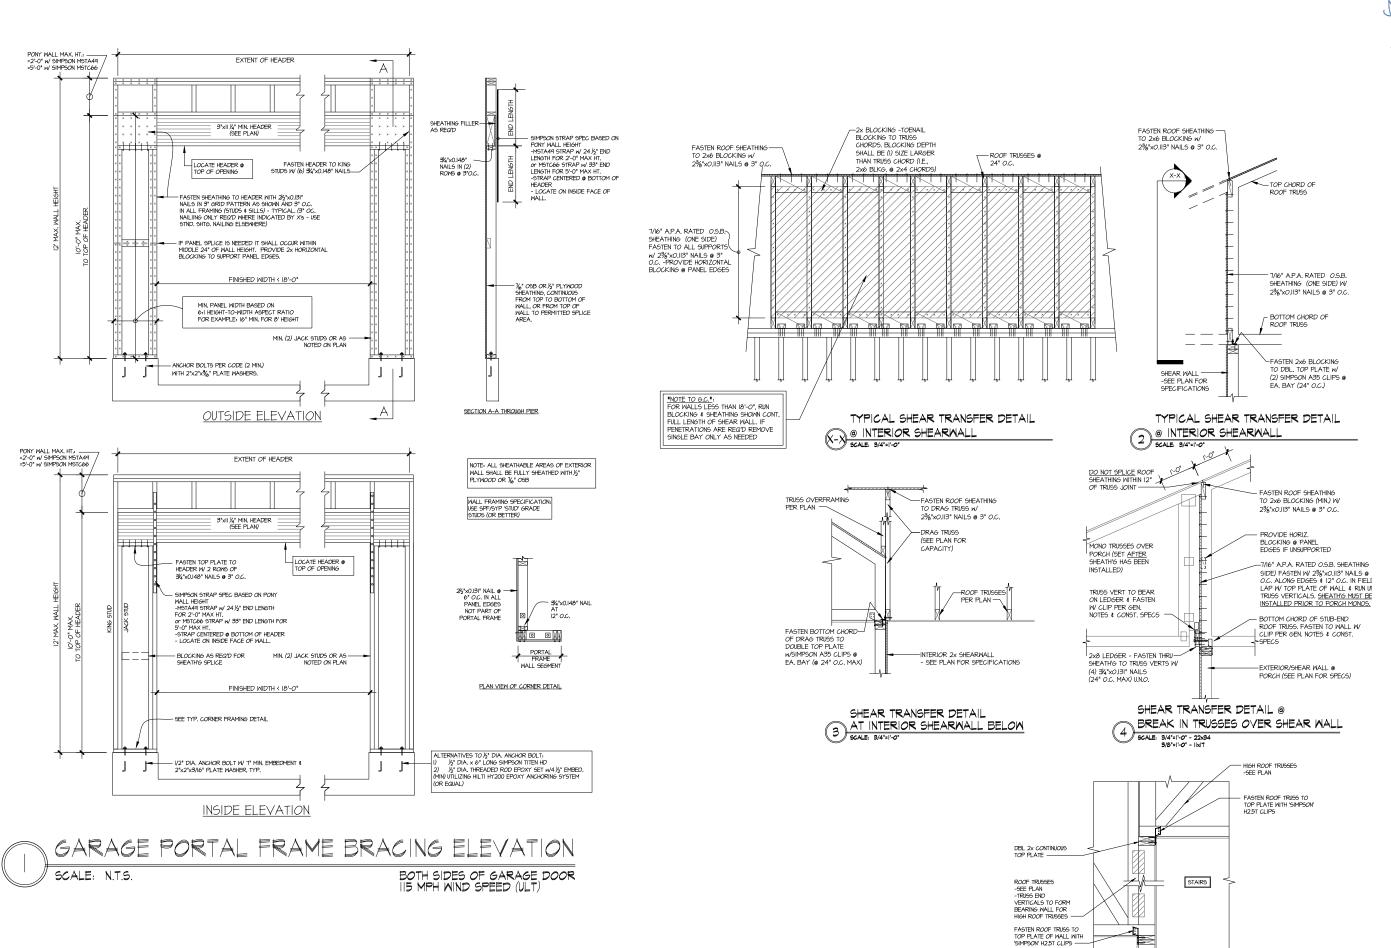

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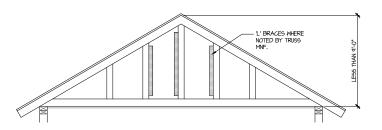
05-08-2025 MISC. ARCH UPDATE


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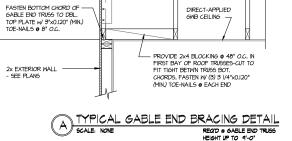
Ŵ DETAIL MODEI FRAMING

SERENITY MASTER SET RALEIGH, NC 5920-05

SD2.0





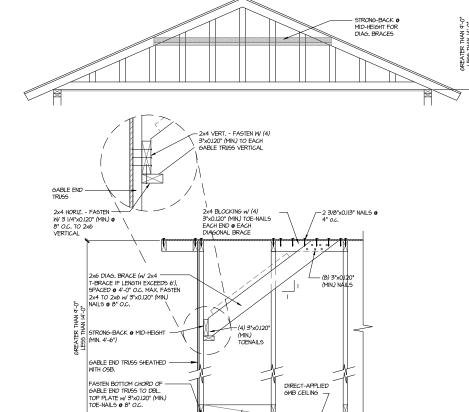

DIRECT-APPLIED GWB CEILING —

'L' BRACES FASTENED TO VERTICALS MEERE RECO'D BY TRUSS MANUFACTURER, FASTEN W 16d GUN NAILS (0.131 x 3 1/2") @ 6" O.C.

GABLE END TRUSS SHEATHED-WITH OSB.

BRACE GABLE END TRUSSES PER ABOVE DETAIL WHEN GABLE HEIGHT IS LESS THAN 9"-0". "L" BRACES REQUIRED WHERE NOTED BY TRUSS MANUFACTURER.

TYPICAL GABLE END BRACING DETAIL SCALE. NONE REQUIRE GABLE END TRUSS REQ'D @ GABLE END TRUSS HEIGHT BETWN 9'-0" TO 14'-0"

- PROVIDE 2x4 BLOCKING @ 48° O.C. IN FIRST BAY OF ROOF TRUSSES-CUT TO FIT TIGHT BETINN TRUSS BOT. CHORDS, FASTEN W (4) 3°X0,120° (MIN.) TOE-NAILS @ EACH END

BRACE GABLE END TRUSSES PER ABOVE DETAIL WHEN GABLE HEIGHT EXCEEDS 9'-0'. "L' BRACES NOT REQUIRED.

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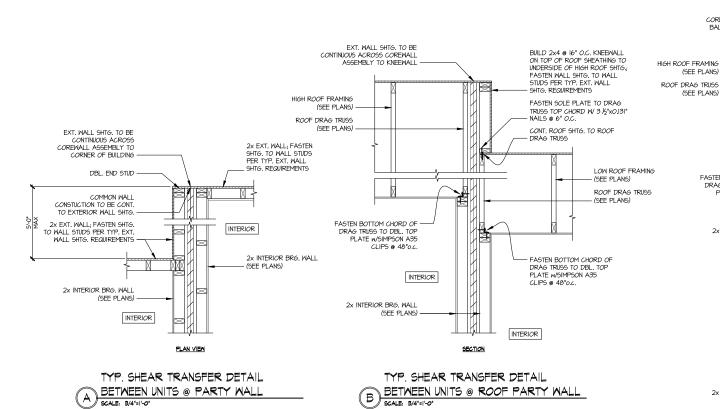
REVISIONS:

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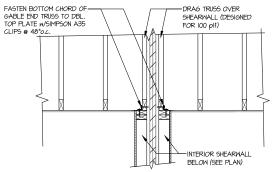
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FRAMING DETAILS 5920-05 MODEL SERENITY MASTER SET RALEIGH, NC

SD2.1



ROOF SHTG. TO BE CONTINUOUS ACROSS COREWALL ASSEMBLY TO BALLOON FRAMED WALL -(SEE PLANS) -(SEE PLANS) -TOP OF WALL
PLATE HEIGHT @
ADJACENT UNIT FASTEN BOTTOM CHORD OF DRAG TRUSS TO DBL. TOP PLATE W/SIMPSON A35 CLIPS @ 48"o.c. INTERIOR 2x INTERIOR BRG. WALL -(SEE PLANS) EXTERIOR ADJACENT UNIT FLOOR SYSTEM (SEE PLANS) · 2x EXT. WALL; FASTEN SHTG. TO WALL STUDS PER TYP. EXT. WALL SHTG. REQUIREMENTS INTERIOR 2x INTERIOR BRG WALL SECTION



TYP. SHEAR TRANSFER DETAIL BETWEEN UNITS @ EXT. PARTY WALL (c) SCALE: 3/4"=1'-0"

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initial: SMM . NAME, OPT. EXT. COVID. PORCH, 11-08-2024 JPP

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DETAILS 5920-05 MODEI PARTY WALL SERENITY MASTER SET RALEIGH, NC

SD2.2

