
THIS PLAN HAS BEEN DRAWN TO CONFORM TO THE 2018 NORTH CAROLINA RESIDENTIAL CODE


CONTRACTOR SHALL VERIFY ALL DIMENSIONS AND CONDITIONS PRIOR TO BEGGINING WORK. CONTRACTOR IS RESPONSIBLE FOR COMPLIANCE WITH ALL STATE AND LOCAL BUILDING CODES AND ORDINANCES. KADS CUSTOM HOME DESIGNS ASSUMES NO LIABILITY FOR SITE CONDITIONS, CONSTRUCTION METHODS OR ANY DEVIATION OF THESE PLANS.


NOTE:

ALL WINDOWS TO BE INSTALLED MUST MEET
A MAXIMUM OF .32 U VALUE OR BETTER, UNLESS
ENERGY CALCULATIONS ARE SUBMITTED WITH PLANS
PROVIDED BY BUILDER AT TIME OF PLAN REVIEW.

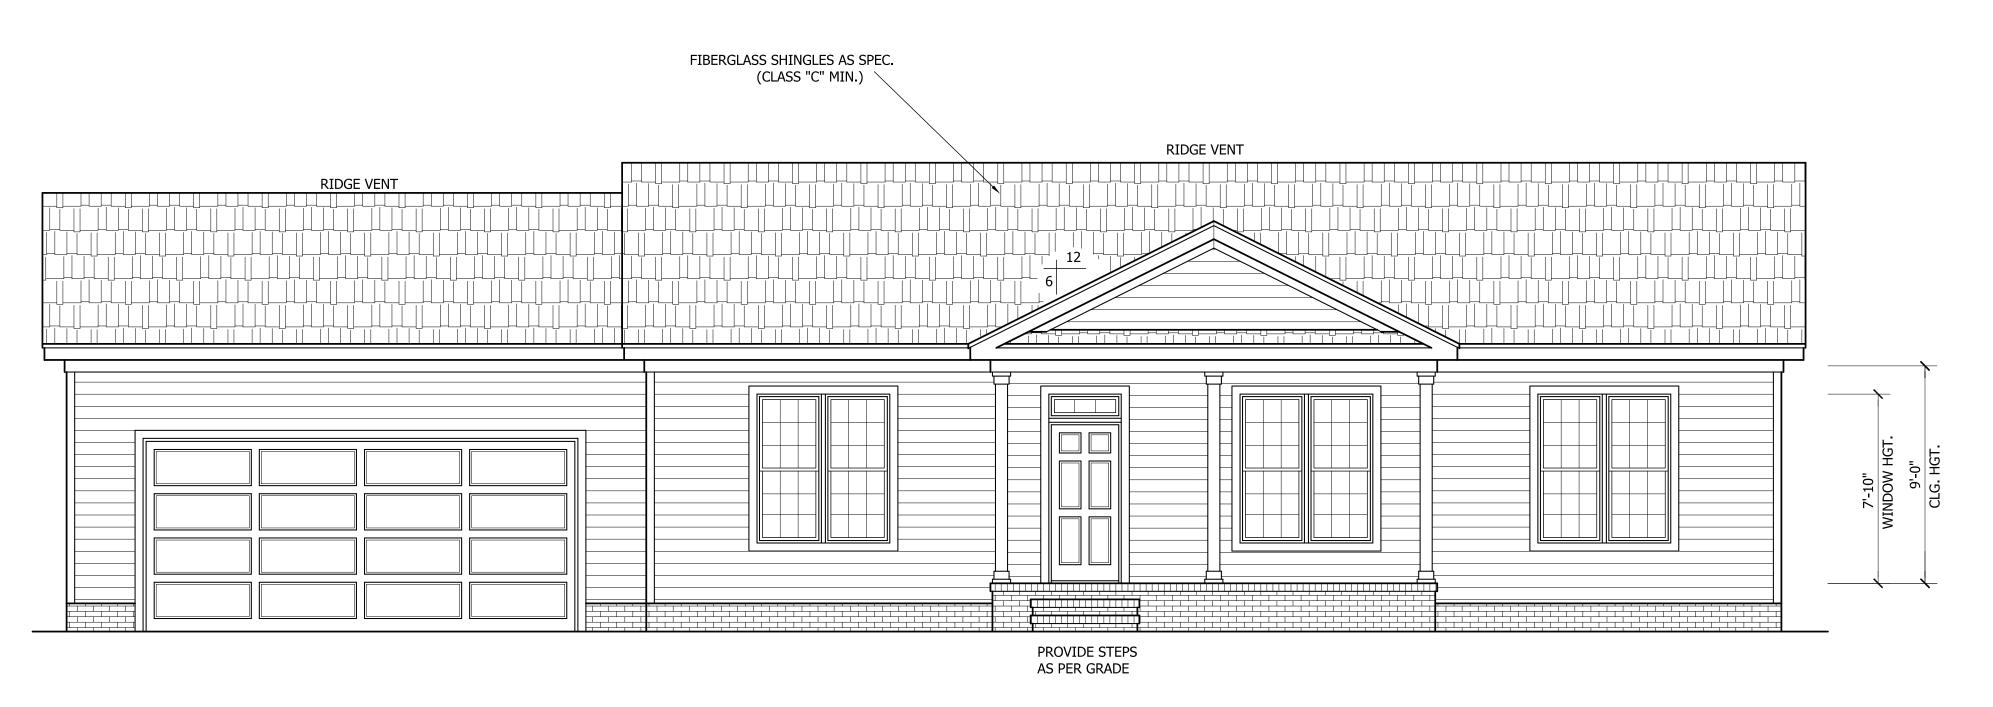

FRONT ELEVATION SCALE: 1/4"=1'-0"

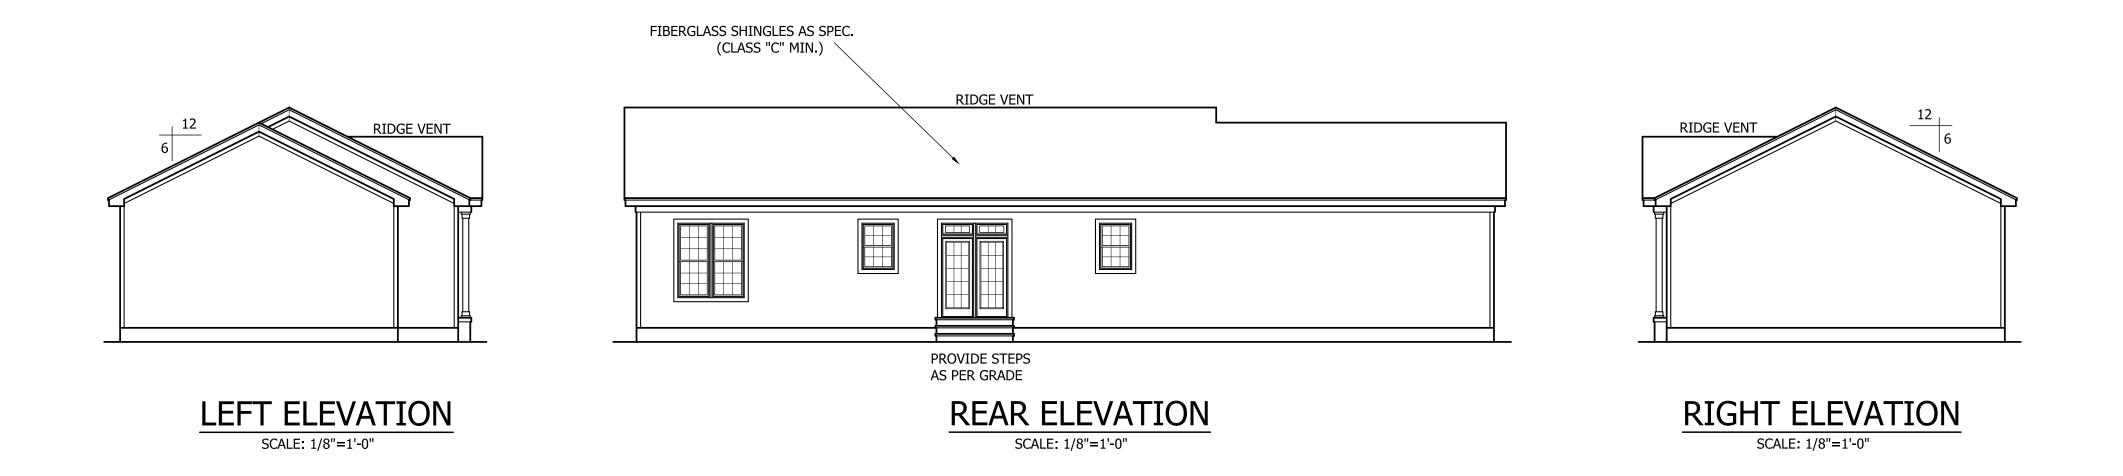

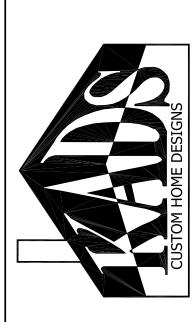

ANGIER, NC 919-369-7181

DRAWN BY: D.W.O.


DATE: 3/18/25

PAGE NO

1

OF

PLAN NO. DK1263

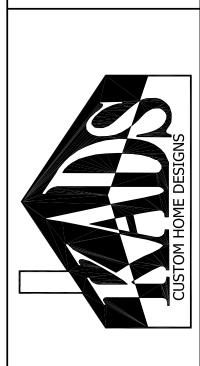

ANGIER, NC 919-369-7181

> DRAWN BY: D.W.O.

DATE:

3/18/25

HEATED FIRST FLOOR HTD. SQ. FT. = 1263

FIRST FLOOR PLAN

= 71

= 552

UNHEATED

GARAGE SQ. FT.


FRONT PORCH SQ. FT.

SCALE: 1/4"=1'-0" 9'-0" CLG. HGT. SET WINDOWS AT 7'-10" A.F.F. PAGE NO

2

OF

PLAN NO. DK1263

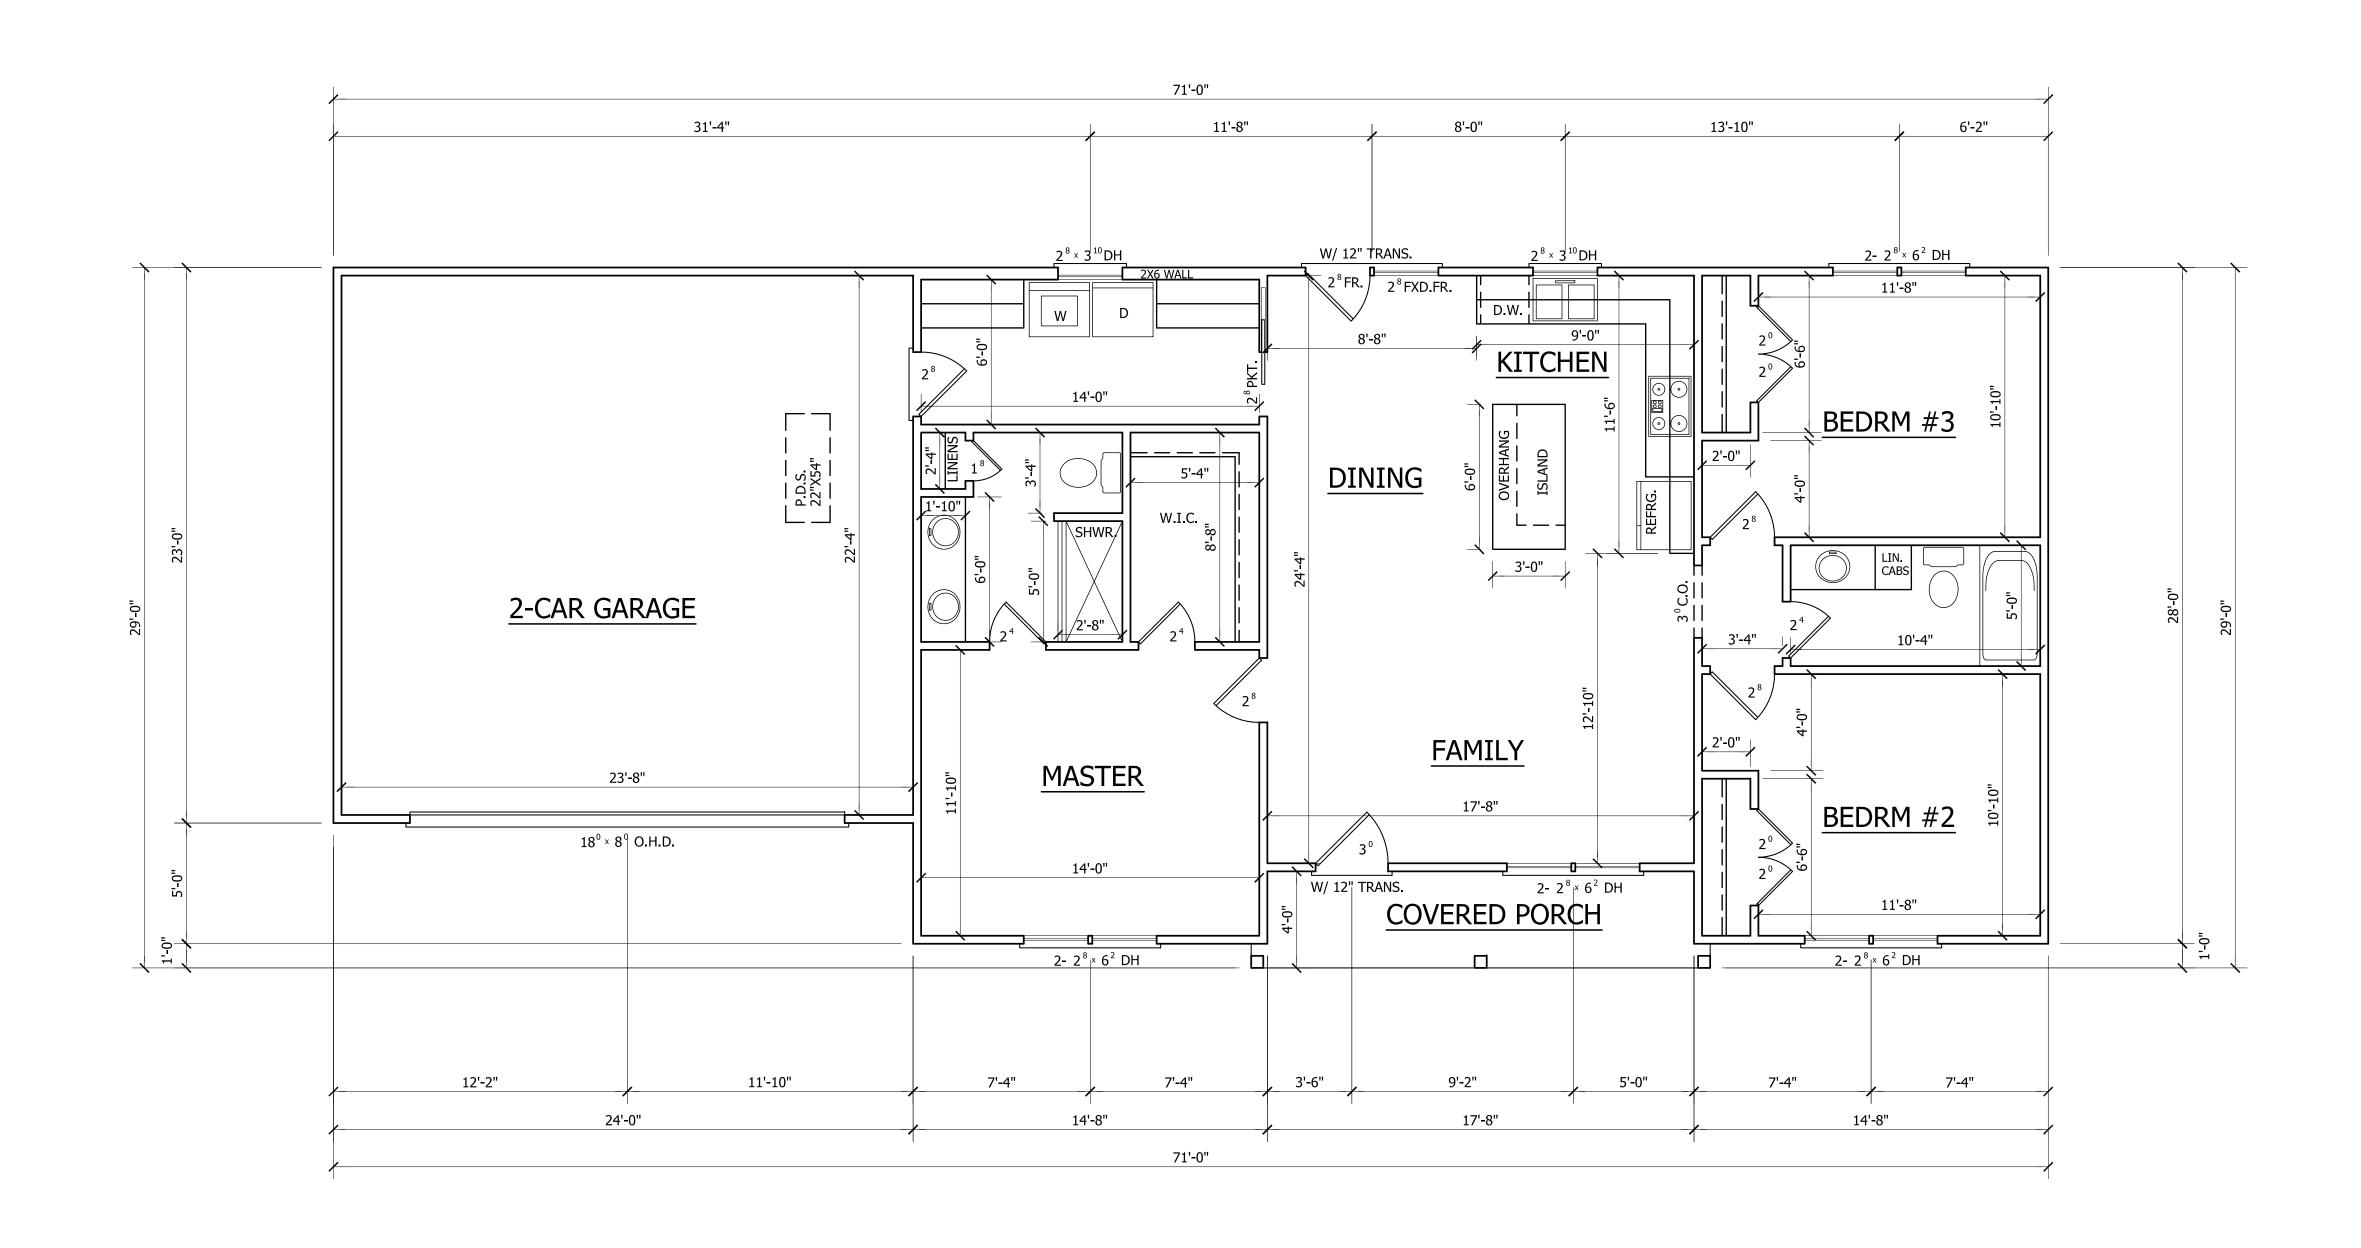



ANGIER, NC 919-369-7181


> DRAWN BY: D.W.O.

DATE:

3/18/25 PAGE NO

OF

PLAN NO. DK1263

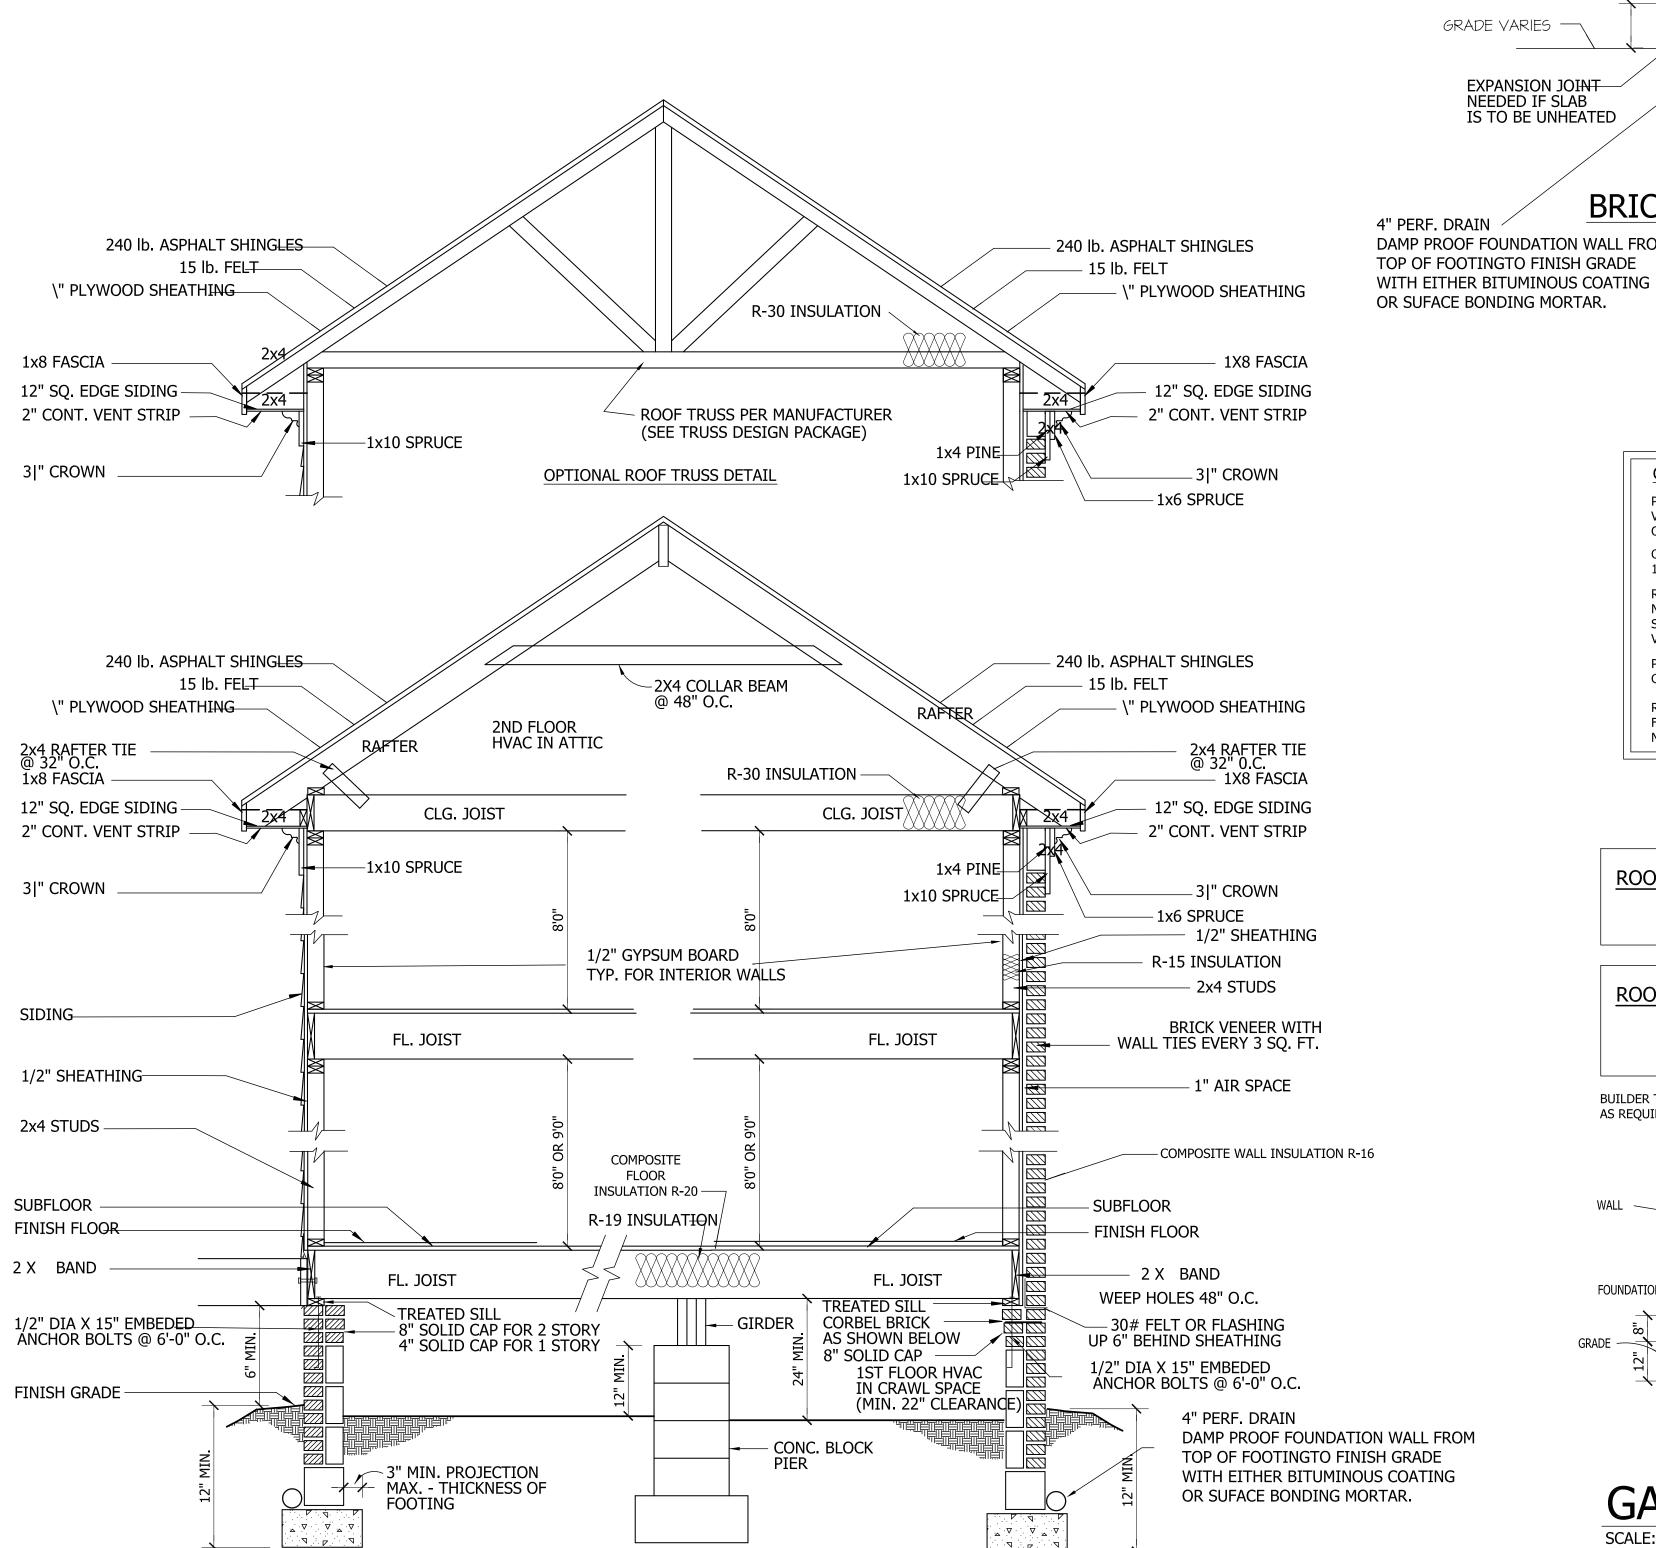

SIDING 4" CONC. SLAB SHEATHING 4" BRICK VENEER – 6X6 10/10 WWM-INSUL. 6 MIL. POLY VAPOR BARRIER 1" AIR SPACE 2"x4" SILL— 2"x4" SILL 4" GRAVEL FILL-1/2" DIA X 15" EMBEDED ÁNCHOR BOLTS @ 6'-0" O.C. GRADE VARIES -GRADE VARIES EXPANSION JOINT NEEDED IF SLAB IS TO BE UNHEATED 1"x24" PERIMETER INSULATION - EXPANSION JOINT NEEDED IF SLAB IS TO BE UNHEATED BRICK VENEER SIDING DAMP PROOF FOUNDATION WALL FROM SLAB FDN. DETAIL TOP OF FOOTINGTO FINISH GRADE

SCALE: 1" = 1'-0"

CRAWL SPACE VENTILATION

PROVIDE AT LEAST 1.0 SQ. FT. NET FREE VENTILATION AREA FOR EACH 150 SQ. FT. OF CRAWL SPACE. CRAWL SPACE AREA = 1263 SQ.FT.

1263/150 = 8.42 SQ. FT. REQ'D.REDUCE REQUIRED AREA TO 1.0 SQ. FT NET FREE VENTILATION AREA FOR EACH 1,500 SQ. FT. OF CRAWL SPACE WITH APPROVED VAPOR BARRIER.

PROVIDE (1) VENT WITHIN 3'-0" OF EACH

REFER TO MANUFACTURER SPECIFICATIONS FOR ACTUAL VENTS USED TO DETERMINE NUMBER OF VENTS REQUIRED.


ROOF VENTILATING REQUIREMENTS

= <u>12.57</u> SQ. FT. REQ'D


ROOF VENTILATING REQUIREMENTS (POWER ROOF VENTILATOR REQUIRED) = <u>6.28</u> SQ. FT. REQ'D

BUILDER TO PROVIDE APPROPRIATE VENTILATING

AS REQUIRED.

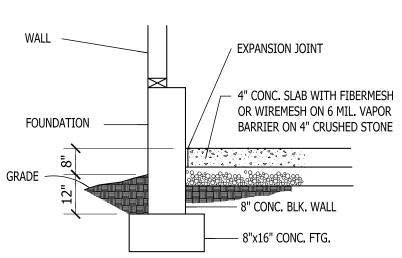

GARAGE SLAB

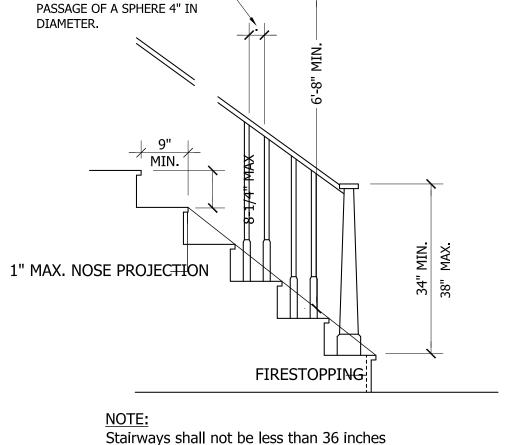

REQUIRED GUARDS SHALL NOT HAVE OPENINGS FROM

HEIGHT WHICH ALLOW

THE WALKING SURFACE TO THE REQUIRED GUARD

> a handrail is installed on one side and 27 inches where handrails are provided on both sides STAIR DETAIL

in clear width at all points above the permitted

Handrails shall not project more than 4.5 inches

handrail height and below the required headroom height.

on either side of the stairway and the minimum clear width


of the stairway at and below the handrail height, including

treads and landings, shall not be less than 31-1/2 inches where

WALL SECTION SCALE: \" = 1'-0"

BRICK SECTION

SIDING SECTION

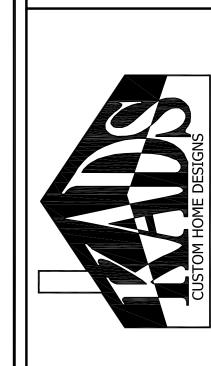

ANGIER, NC 919-369-7181

DRAWN BY: D.W.O.

DATE:


3/18/25

PAGE NO

<u>S1</u>

OF

PLAN NO. DK1263

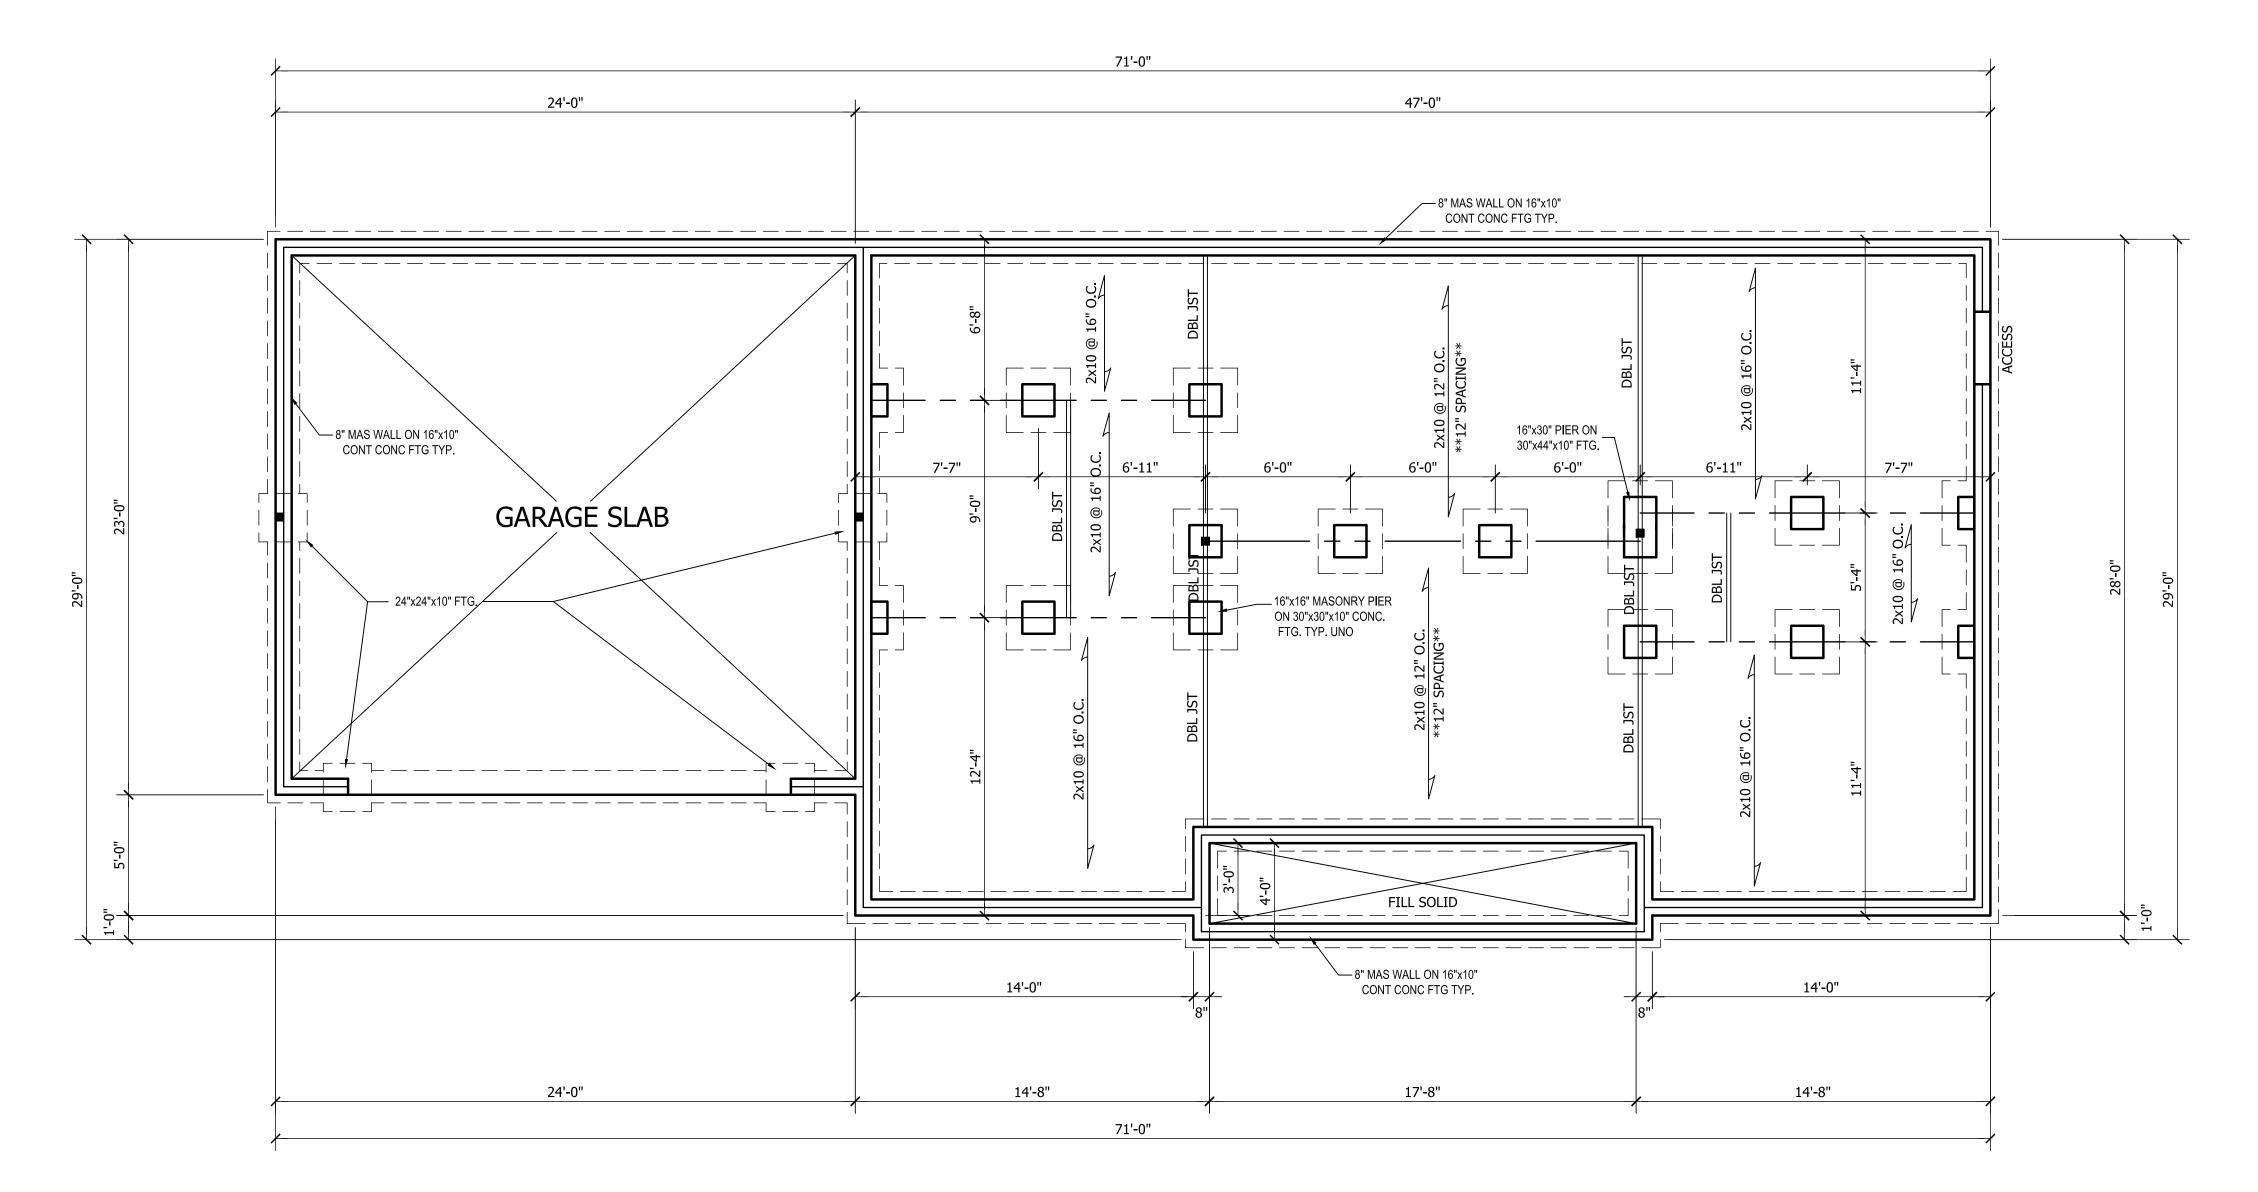

O32702
4-2-25

SNGINEES FS. IIII

WILLIAM R. E. JOHNSON

MANUAL M

Structural Engineering by:

Mark E. Jones, PE

6425 Glen Dean Court

Raleigh, NC 27603

Phone: (919) 395-5618

*Engineers seal applies only to structural components on this document. Seal does not include construction means, methods, techniques, sequences, procures or safety precautions.


*Any deviations or discrepancies on plans are to be brought to the immediate attention of Mark E. Jones, PE. Failure to do so will void Mark E. Jones, PE liability.

Structural analysis based on NCResidential Building Code 2018.

Project No. 25-064

FOUNDATION PLAN
SCALE: 1/4"=1'-0"




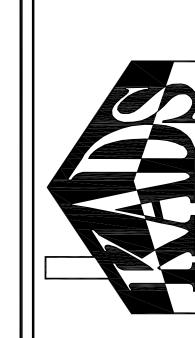

DRAWN BY:

PAGE NO

PLAN NO. DK1263

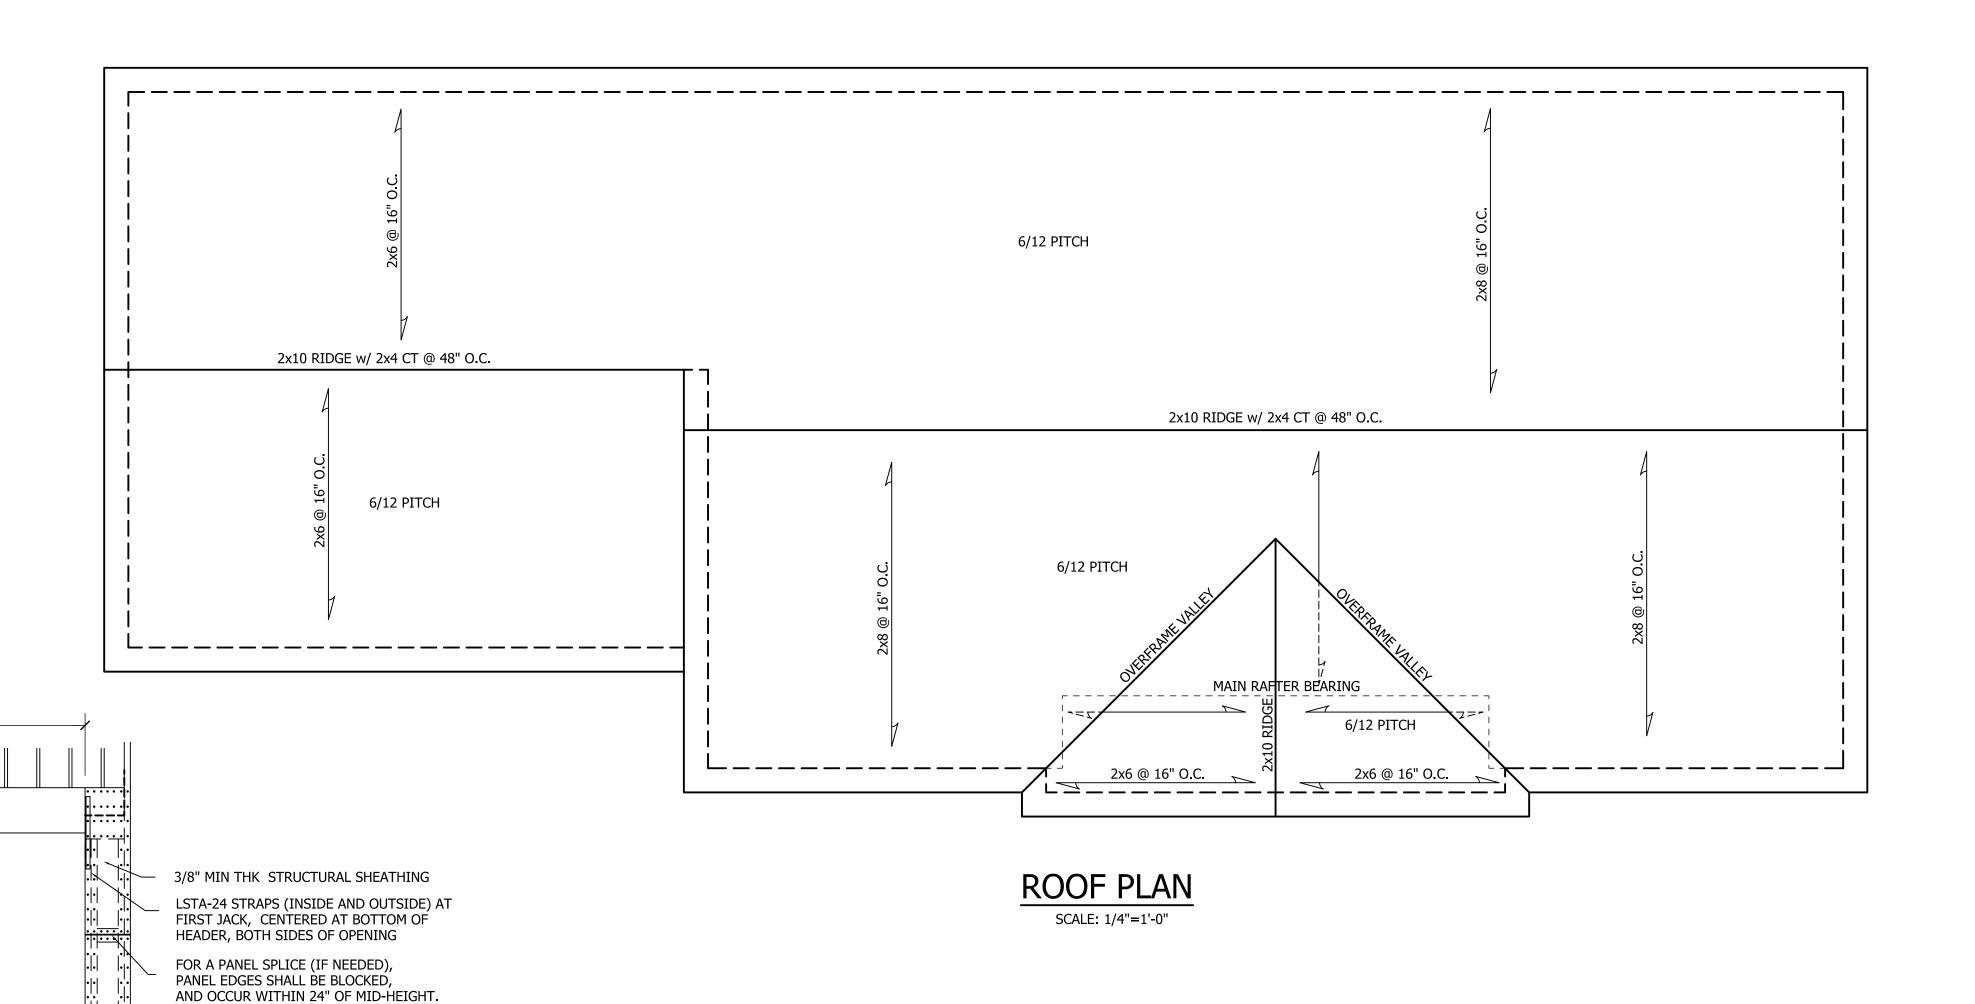

PORTAL FRAME DETAIL

ONE ROW OF TYP SHEATHING-TO-FRAMING NAILING IS REQD IF 2X4

BLOCKING IS USED, THE 2X4's MUST BE NAILED TOGETHER WITH 3-16d SINKERS

6' TO 18'

SEE PLAN FOR HEADER SIZE

- FASTEN SHEATHING TO HDR WITH 8d COMMON OR GALV BOX NAILS IN 3" GRID PATTERN AS SHOWN AND 3" O.C. IN ALL FRAMING, TYP


WIDTH BASED ON 6:1 HEIGHT-TO-WIDTH RATIO

MAY BE REDUCED BY 50% IF WSP INSTALLED ON INTERIOR WALL ALSO (10" MIN. FOR 8' DOOR)


`∤_ HEADER FASTENED TO KING STUD

WITH 6-16d SINKER NAILS.

ANCHOR BOLTS PER

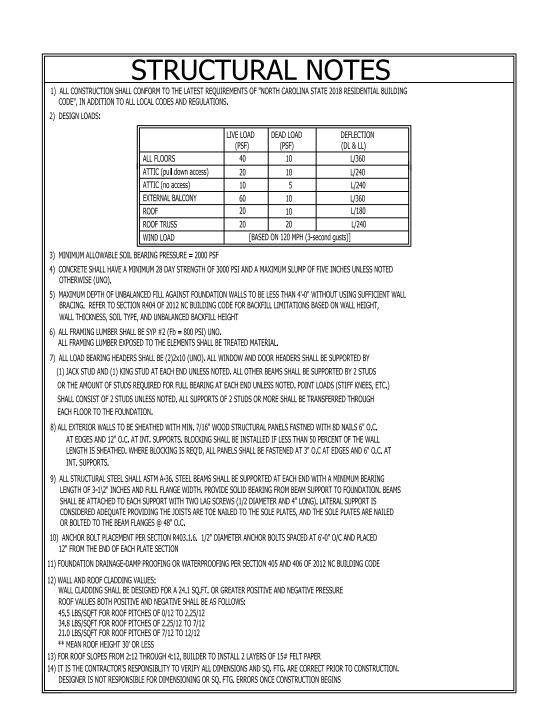

THIS PLAN SHALL BE CONTINUOUSLY BRACED WITH WOOD STRUCTURAL PANELS PER SECTION R602.10.3 OF THE NC RESIDENTIAL BUILDING CODE. NOTE ALL WALL BRACING LINES SATISFY THE MINIMUM AMOUNTS OF WALL BRACING PER CODE. GARAGE DOOR HEADER SHALL BE CONSTRUCTED PER FIGURE R602.10.1, METHOD PF.

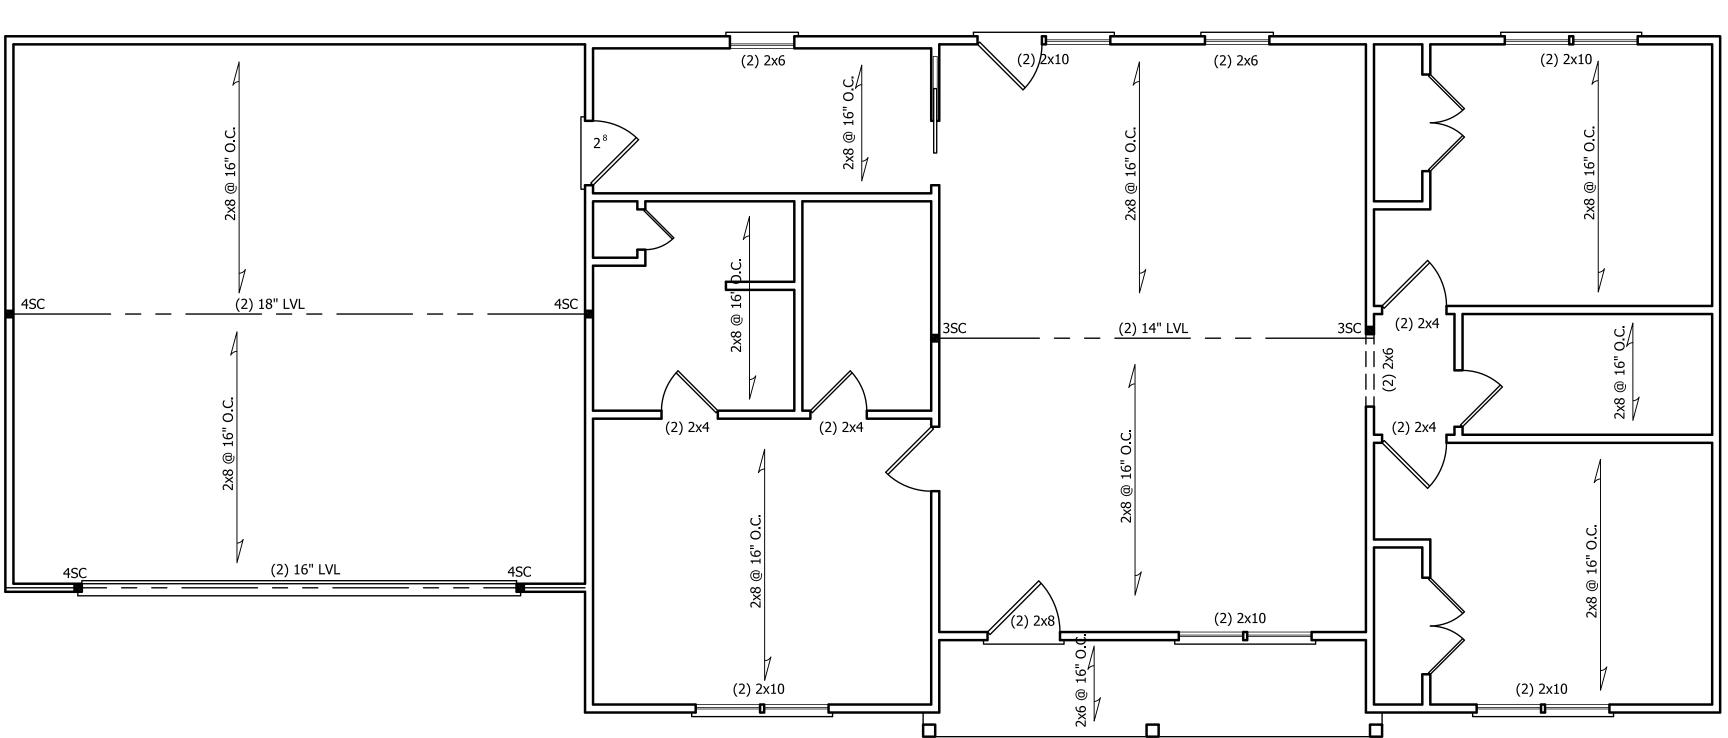

CEILING STRUCTURAL PLAN SCALE: 1/4"=1'-0"

(2) 2x8 TYP.

ANGIER, NC 919-369-7181

D.W.O.

DATE:

3/18/25

Structural Engineering by:

Mark E. Jones, PE

6425 Glen Dean Court

Raleigh, NC 27603 Phone: (919) 395-5618

*Engineers seal applies only to structural components on this document. Seal does not include construction means, methods, techniques, sequences, procures or safety precautions.

*Any deviations or discrepancies on plans are to be brought to the immediate attention of

Mark E. Jones, PE. Failure to do so will void Mark E. Jones, PE liability.

Structural analysis based on NCResidential Building Code 2018.

Project No. 25-064