



1 Front - Elev A
1/8" = 1'-0"



2 Rear - Elev A
1/8" = 1'-0"

Elevation A - Sheet List

Sheet Number	Sheet Name
Pg1	Front & Rear Elevations
Pg2	Side Elevations
Pg3	1st Floor Plan
Pg4	Roof Plan
Pg5	Building Section
Pg6	Electrical & Flooring
Sec-Crawl/Blk 1flr	Typical Wall Section
Structural Pages	by Engineer

Area Schedule (Elevation A)

Name	Area
Heated	
1st Floor	1323 SF
	1323 SF
Unheated	
Front Porch	50 SF
Garage	240 SF
Screened Porch	134 SF
	424 SF
Under Roof	1747 SF

CYPRESS - Elevation A

Front & Rear Elevations

Value Series

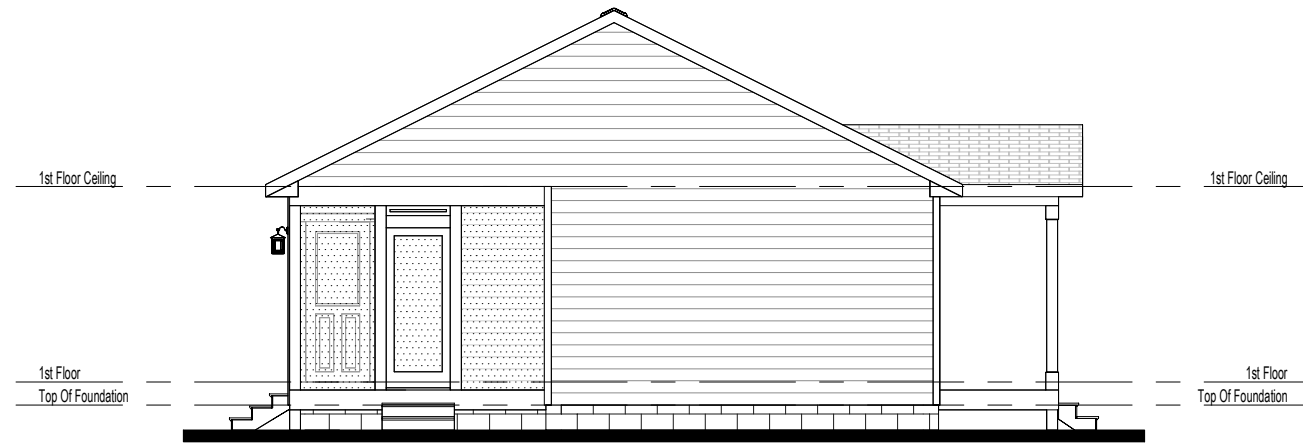
Job #: 25-FAY-SAN-019
Address: 1129 Holder Rd
Lillington, NC 27546
County: Harnett County

Plan Version Date:
10-4-24

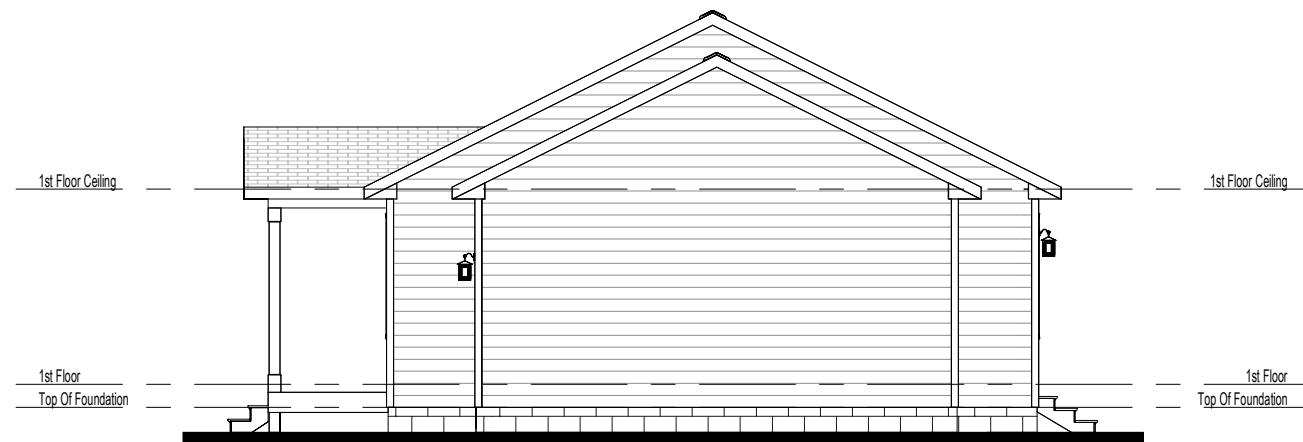
Job Version Date:
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Sheet #:
Pg1

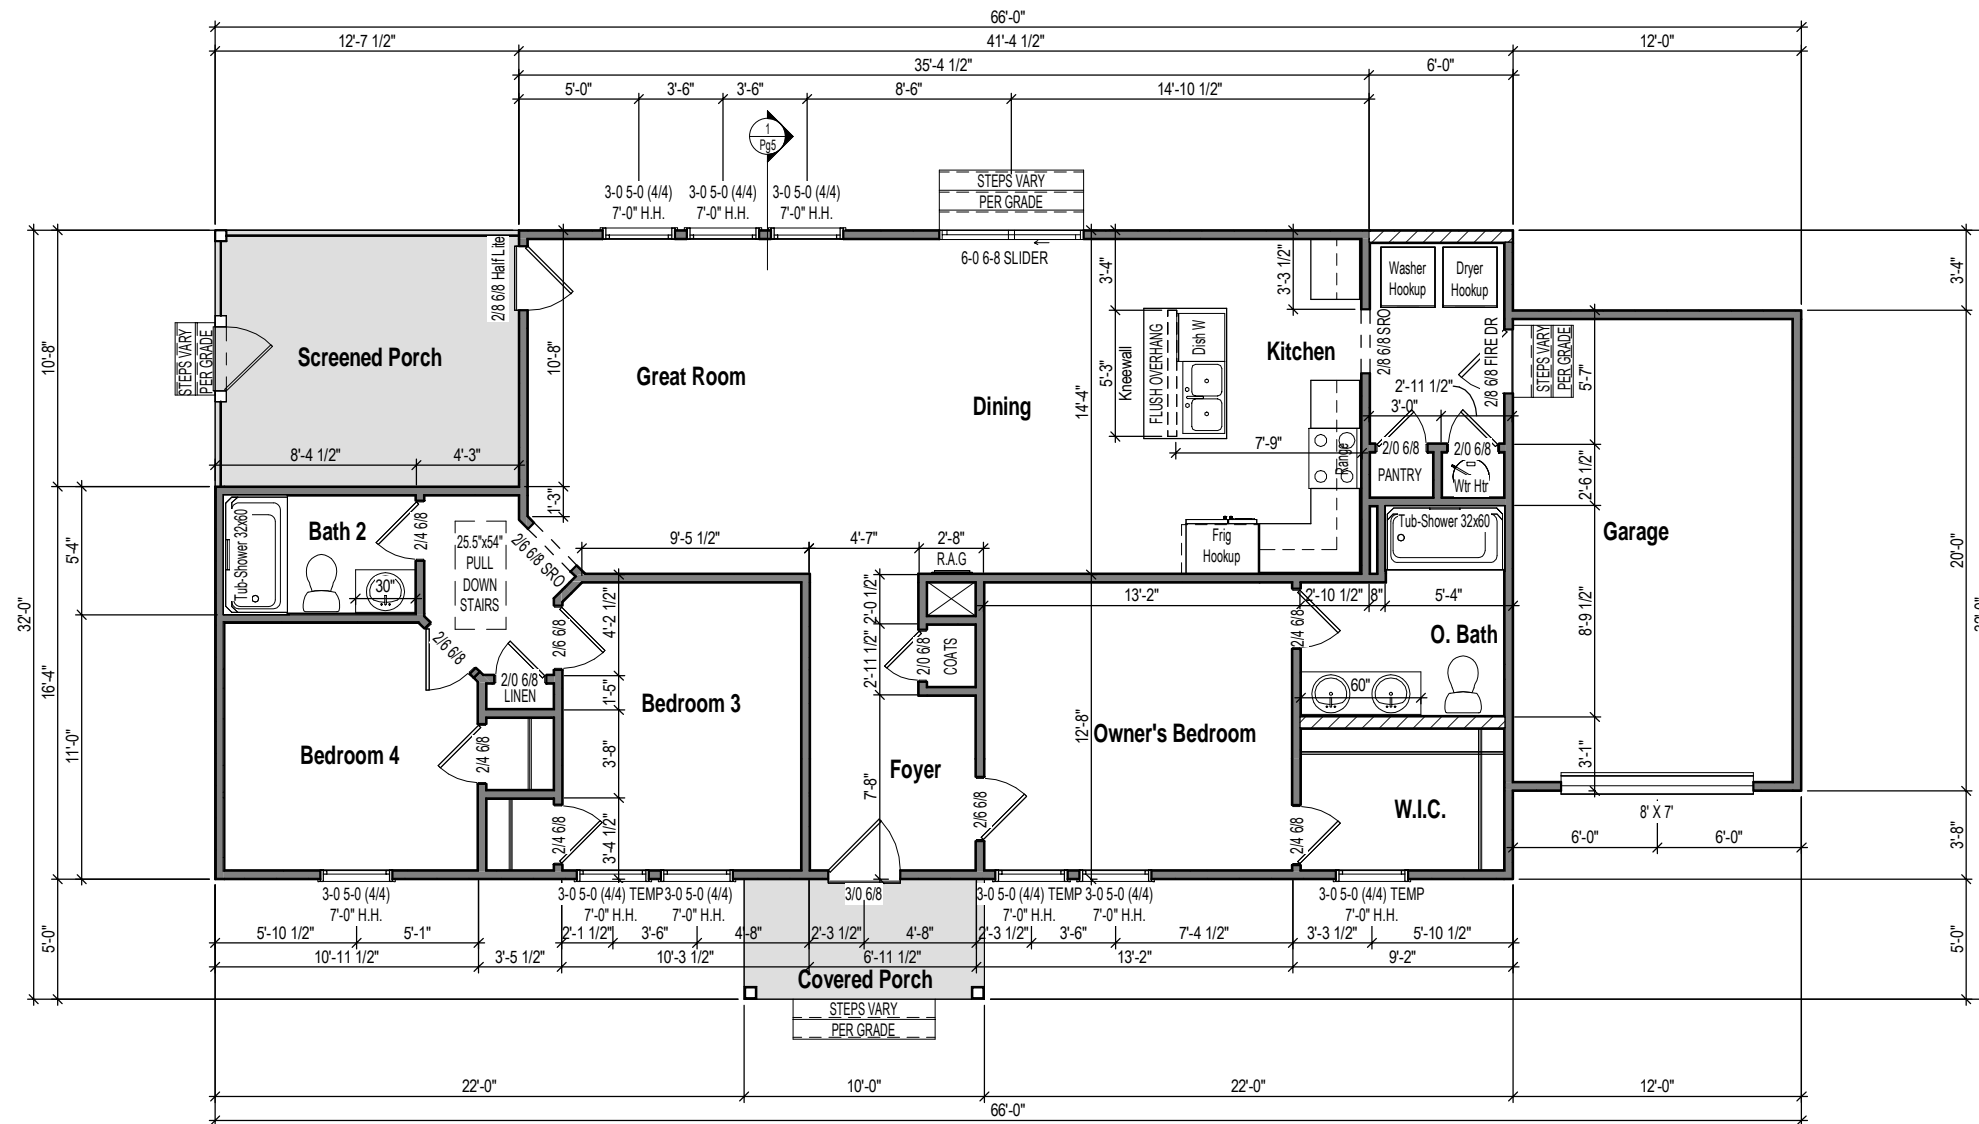




① Left - Elev A
1/8" = 1'-0"



② Right - Elev A
1/8" = 1'-0"



1 1st Floor Plan - Elev A
1/8" = 1'-0"

WALL STUD SIZES

— = 2x4 // = 2x6

DIMENSIONS

- EXTERIOR WALL DIMENSIONS ARE TO FACE OF SHEATHING
- INTERIOR WALL DIMENSIONS ARE TO FACE OF STUD

EXTERIOR DOOR ROUGH OPENINGS

- ALL EXTERIOR SWING DOORS HAVE A HEADER HEIGHT = TO 3" HIGHER THAN CALL SIZE
- ALL EXTERIOR SLIDING DOORS HAVE A HEADER HEIGHT = TO CALL SIZE

CYPRESS - Elevation A

1st Floor Plan

Value Series

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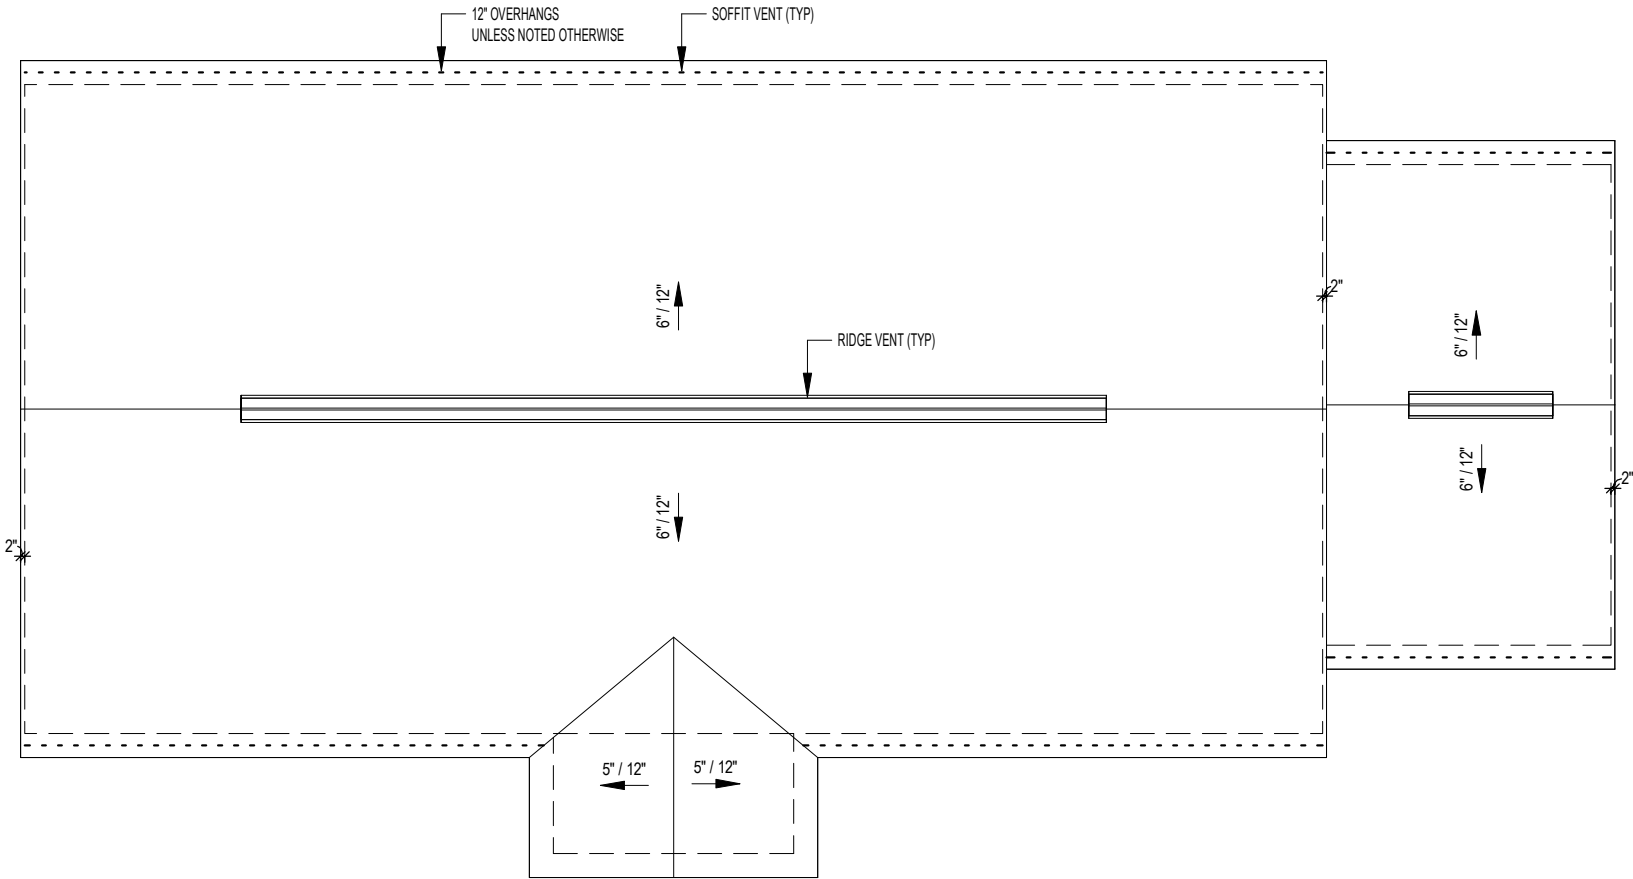
Pg3

Attic Ventilation Calcs 1/300 (sq.in.)

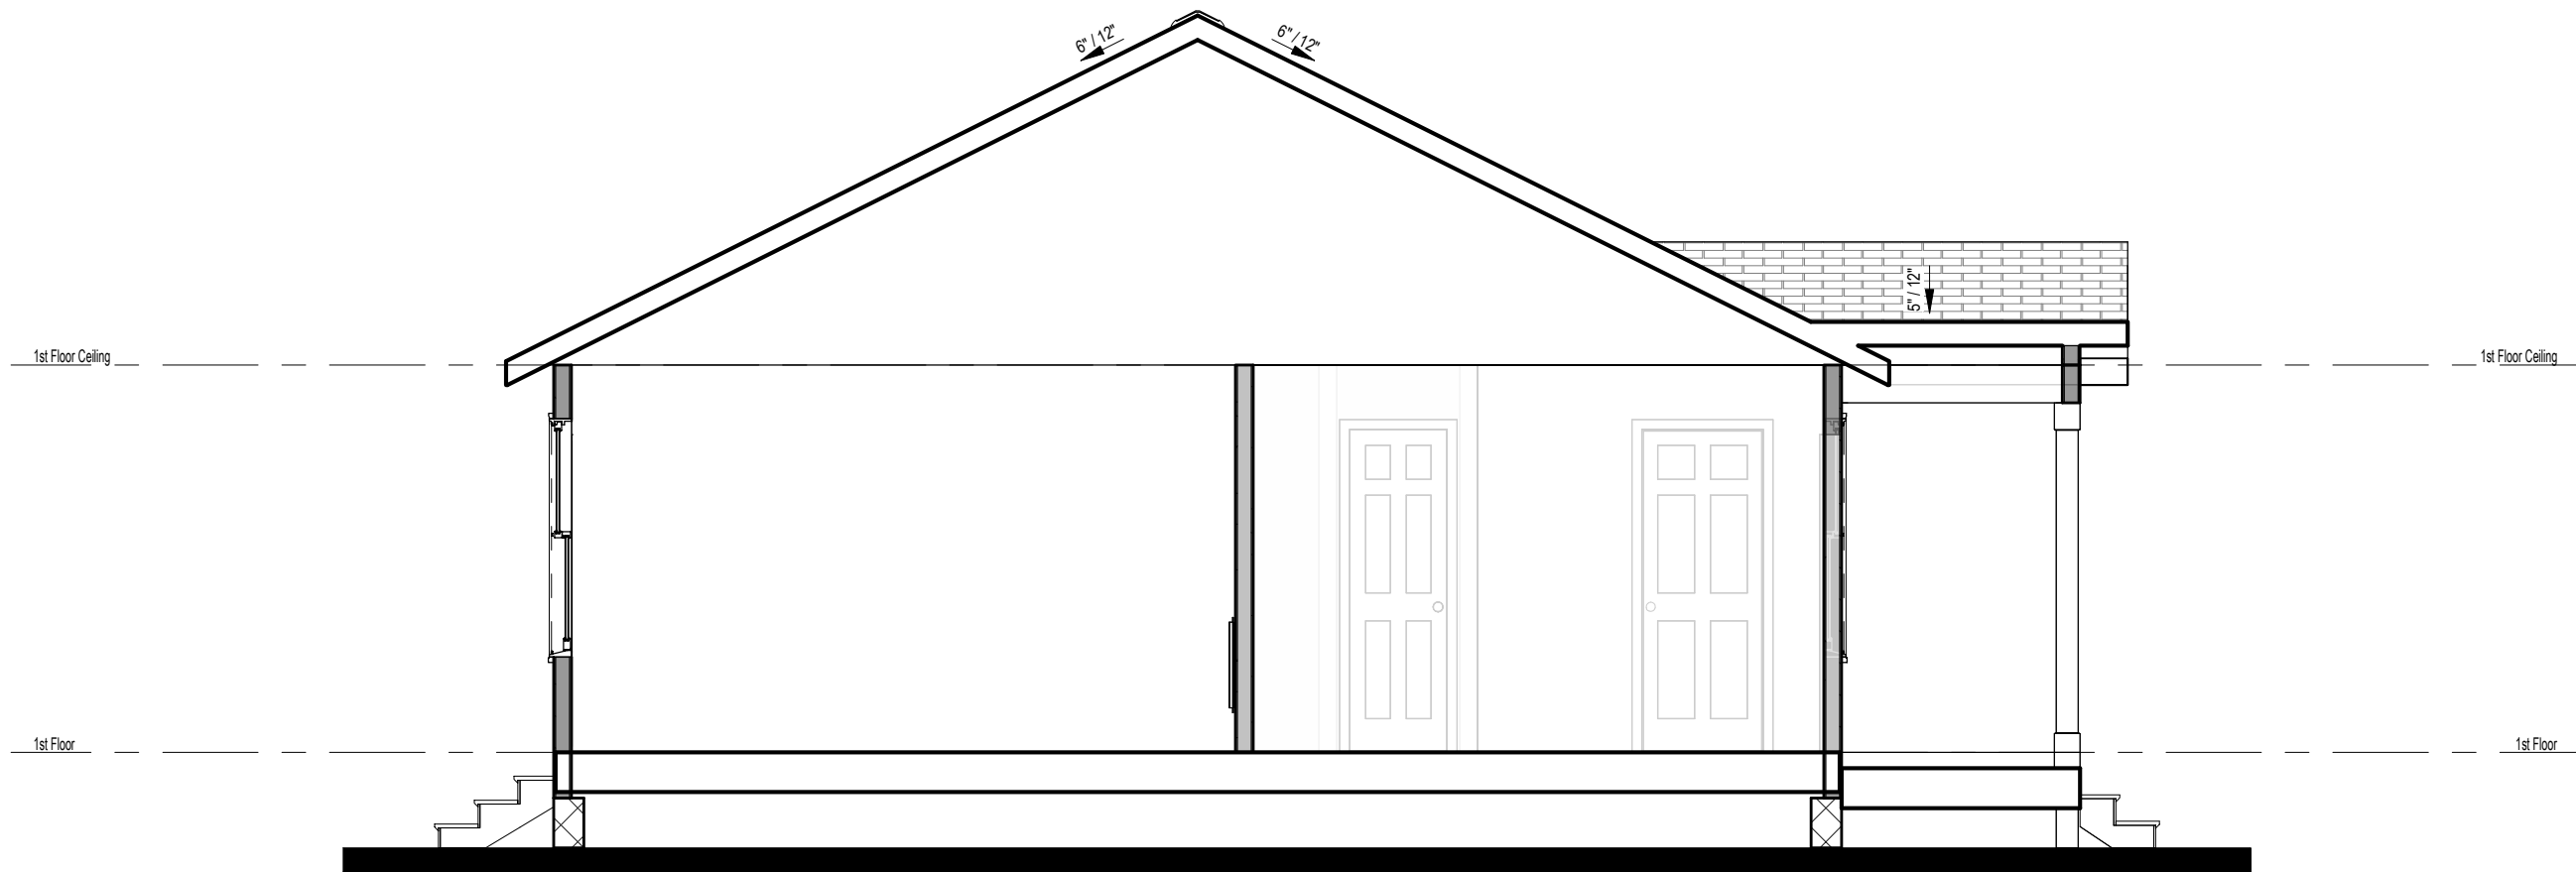
Area	Ventilation Required (sq.in.)	Max Upper (sq.in.)	Min Upper (sq.in.)	Upper Ventilation (sq.in.)	Lower Ventilation (sq.in.)	Total Ventilation (sq.in.)	Ridge Vent (ln.ft.)	Roof Vents (ea)	Soffit Vents (sq.ft.)
1458 SF	700	560	350	540	588	1128	36	0	98
240 SF	115	92	58	90	144	234	6	0	24

CALCS BASED ON THE FOLLOWING VALUES

- Ridge Vents = 15 in² of net free area per linear foot
- Roof Vents = 50 in² of net free area per unit
- Soffit Vents = 6 in² of net free area per square foot



1 Roof Plan - Elev A
1/8" = 1'-0"



1 Building Section - Elevation A
1/4" = 1'-0"

CYPRESS - Elevation A

Electrical & Flooring

Value Series

Job #:

25-FAY-SAN-019

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1129 Holder Rd
Lillington, NC 27546

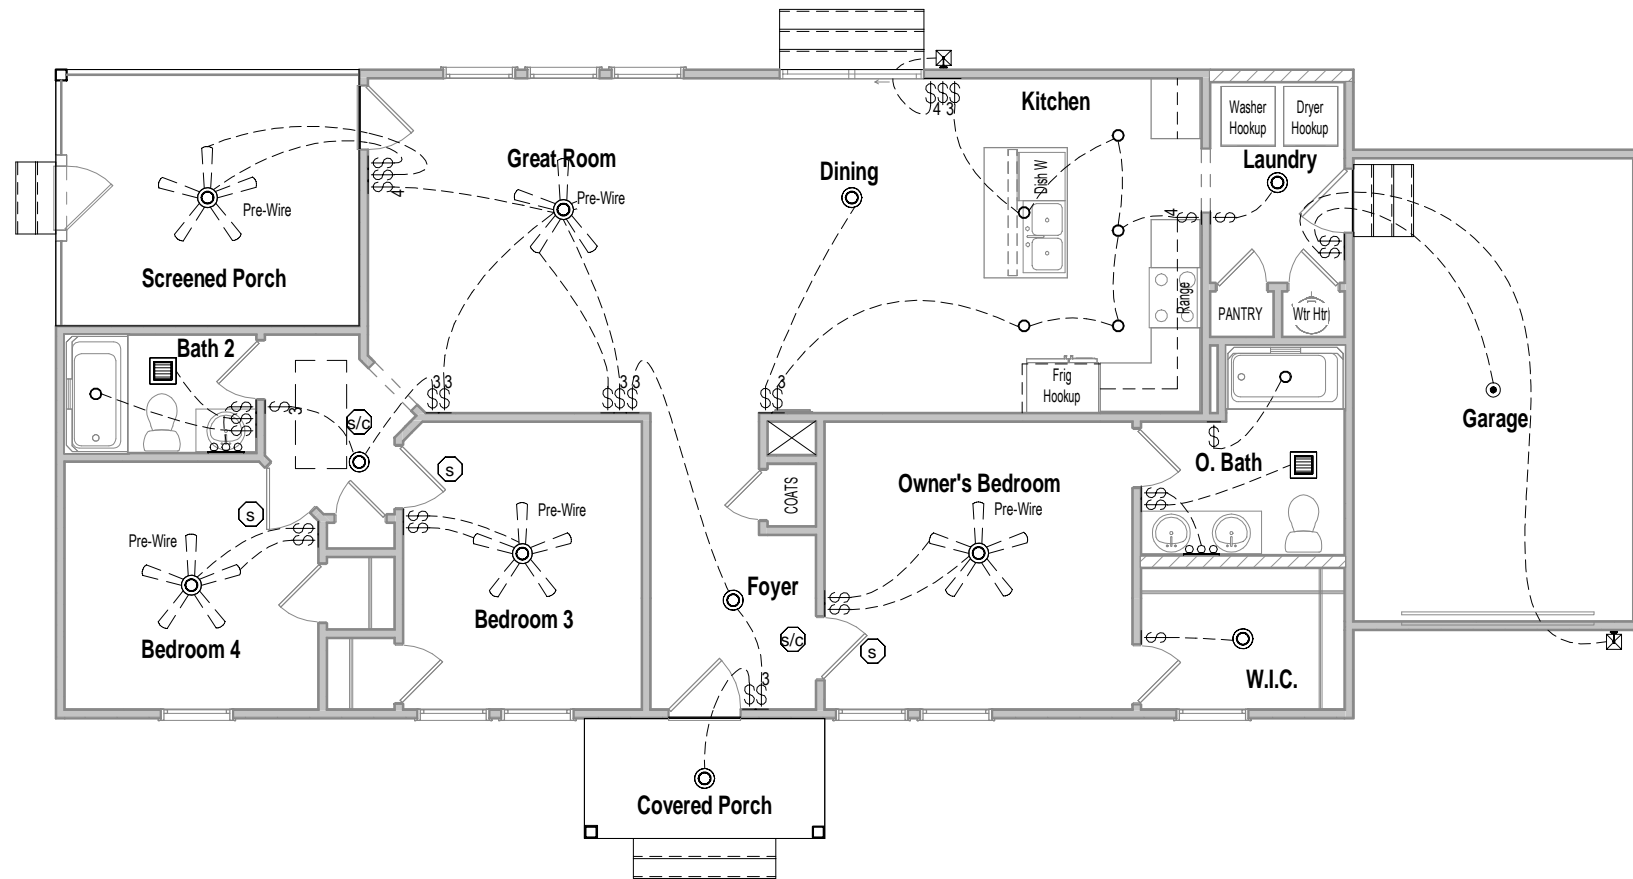
County:

Harnett County

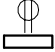


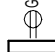



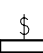

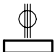
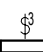
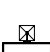
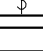
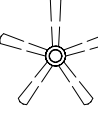


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6-6-25

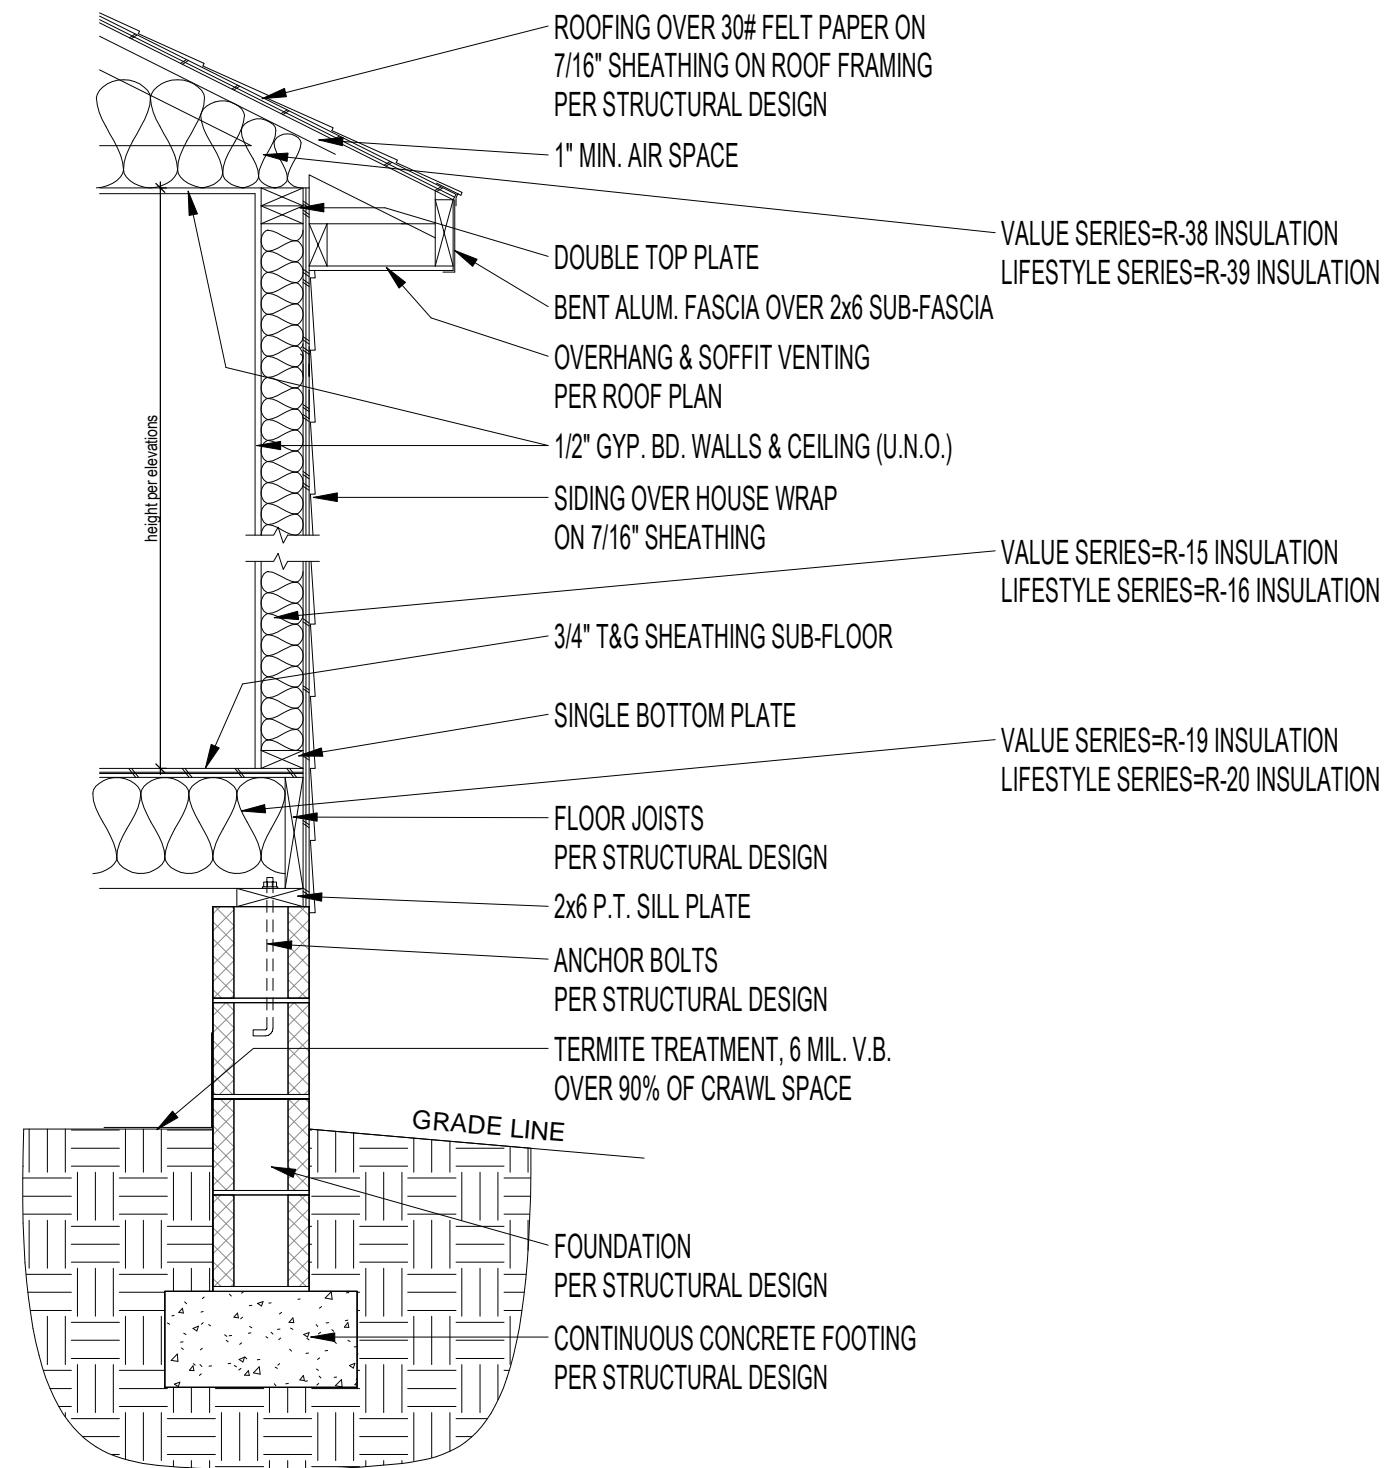
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Pg6



1 1st Floor Electrical - Elevation A
1/8" = 1'-0"

ELECTRICAL LEGEND					
WALL MOUNTED FIXTURES			CEILING MOUNTED FIXTURES		
	OUTLET - 110V		OUTLET - TV		GARAGE DOOR OPENER PREWIRE
	OUTLET - 110V GROUND FAULT INTERRUPTER		OUTLET - PHONE		18" LIGHT BAR
	OUTLET - 110V GROUND FAULT INTERRUPTER WATER PROOF		SWITCH - SINGLE POLE		COACH LIGHT - FRONT DOOR
	OUTLET - 220V		SWITCH - 3 WAY		COACH LIGHT - REAR DOOR
			SWITCH - 4 WAY		FLUSH MOUNT W-FAN PREWIRE
					FLUORESCENT 4' - 2 LAMPS
					FLUORESCENT 2' - 1 LAMP

Outlets shown on the electrical layout are in addition to the outlets that shall be provided in accordance with International Residential Code Sections E3901.2 through E3901.11.



1 Typical Wall Section - Block Fnd 1 floor
3/4" = 1'-0"

CYPRESS - Elevation A

Typical Wall Section

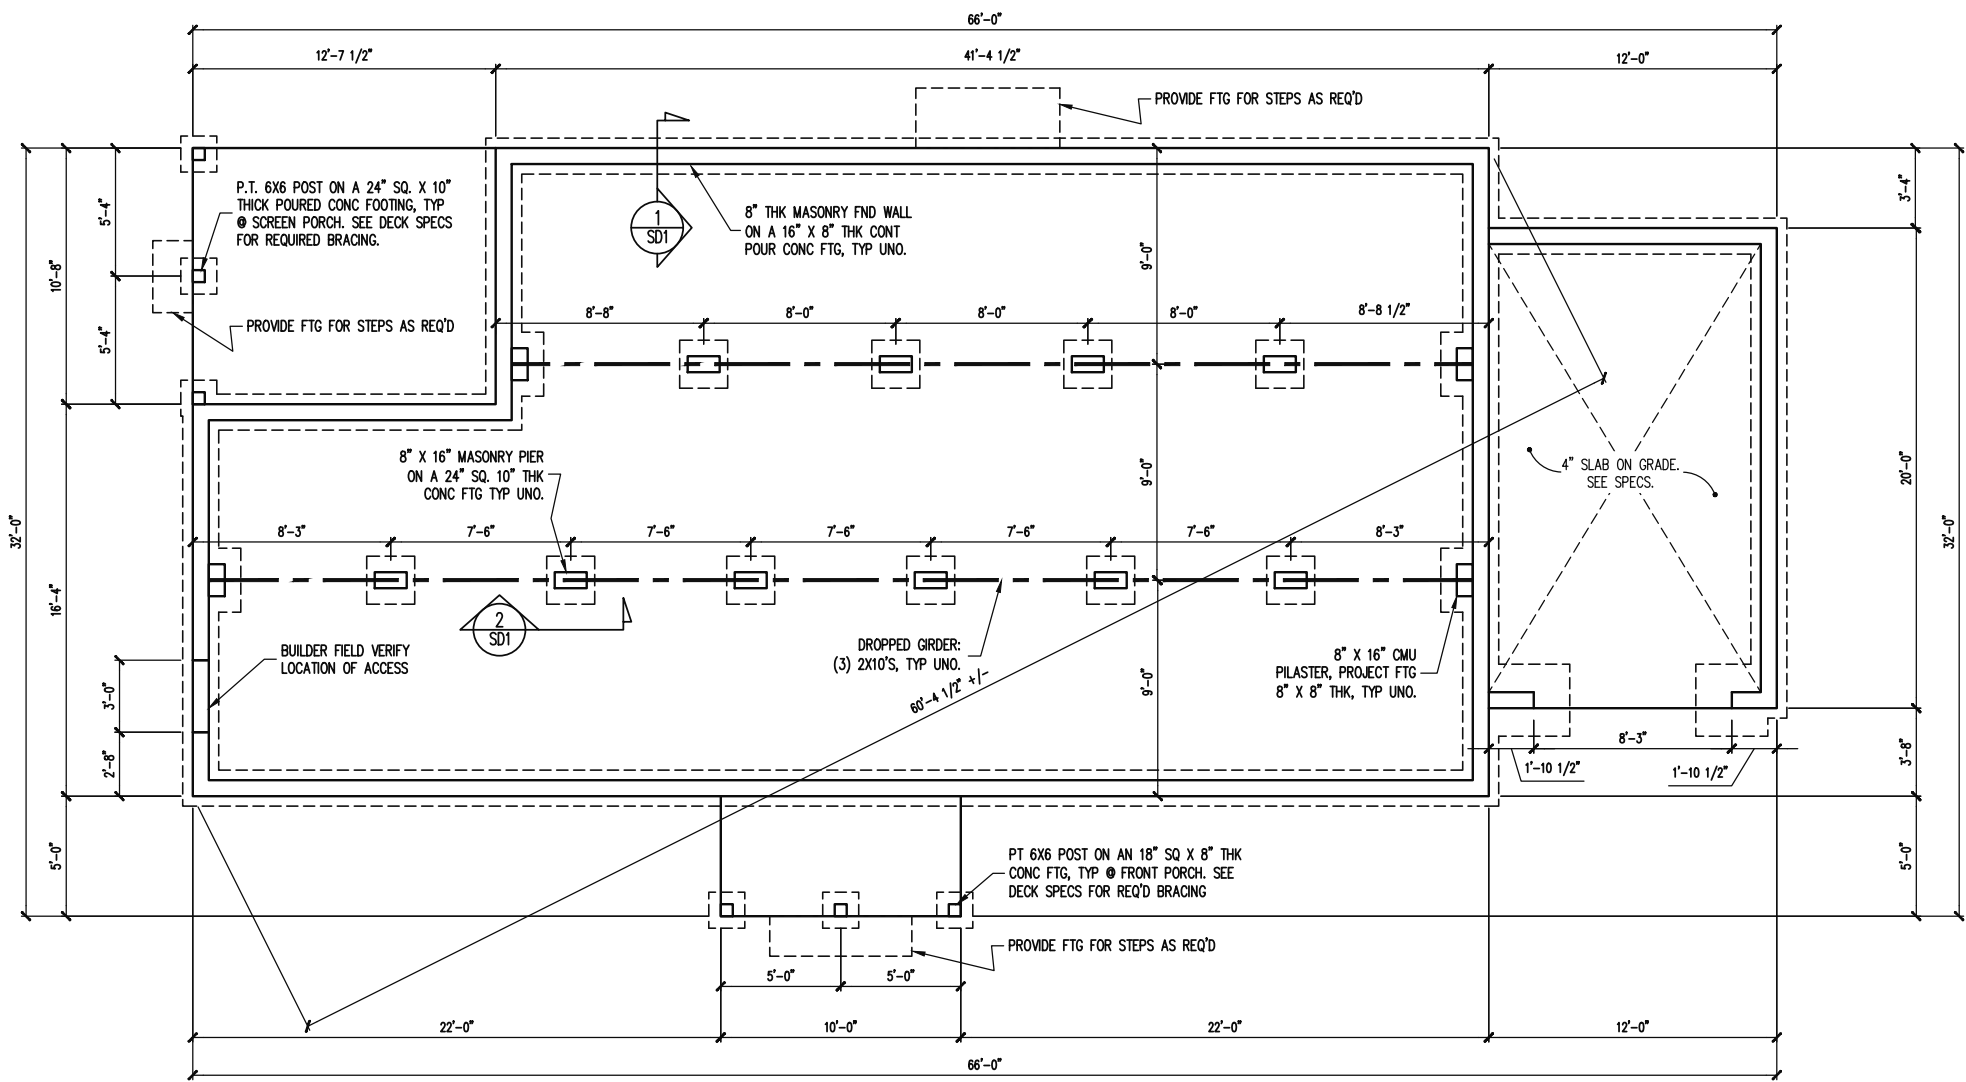
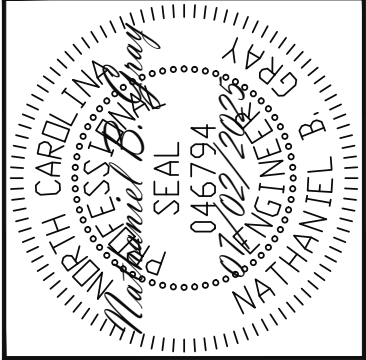
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Sheet #:
Sec-Crawl/Blk 1flr

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PLAN DESIGNED UNDER
2018 NORTH CAROLINA
RESIDENTIAL CODE

NOTES:
-HEIGHT AND BACKFILL LIMITATIONS FOR
FOUNDATION WALLS ARE TO BE GOVERNED
BY THE NCSBC, LATEST EDITION.
REINFORCEMENT AND GROUTING SHALL BE
DETERMINED BY FINAL SITE CONDITIONS.
-BUILDER TO FIELD LOCATE CRAWLSPACE
ACCESS OPENING WITH MINIMUM DIMENSIONS
OF 18X24. DO NOT LOCATE ACCESS OPENING
BELOW POINT LOADS FROM ABOVE WITHOUT
ENGINEER APPROVAL.

FOUNDATION PLAN
1/8" = 1'-0"

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VALUE BUILD HOMES	
STRUCTURAL ADDENDUM	
SCOPE:	1129 HOLDER RD
LOC:	LILLINGTON, NC
JOB# 25-FAY-SAN-019 SINGLER	

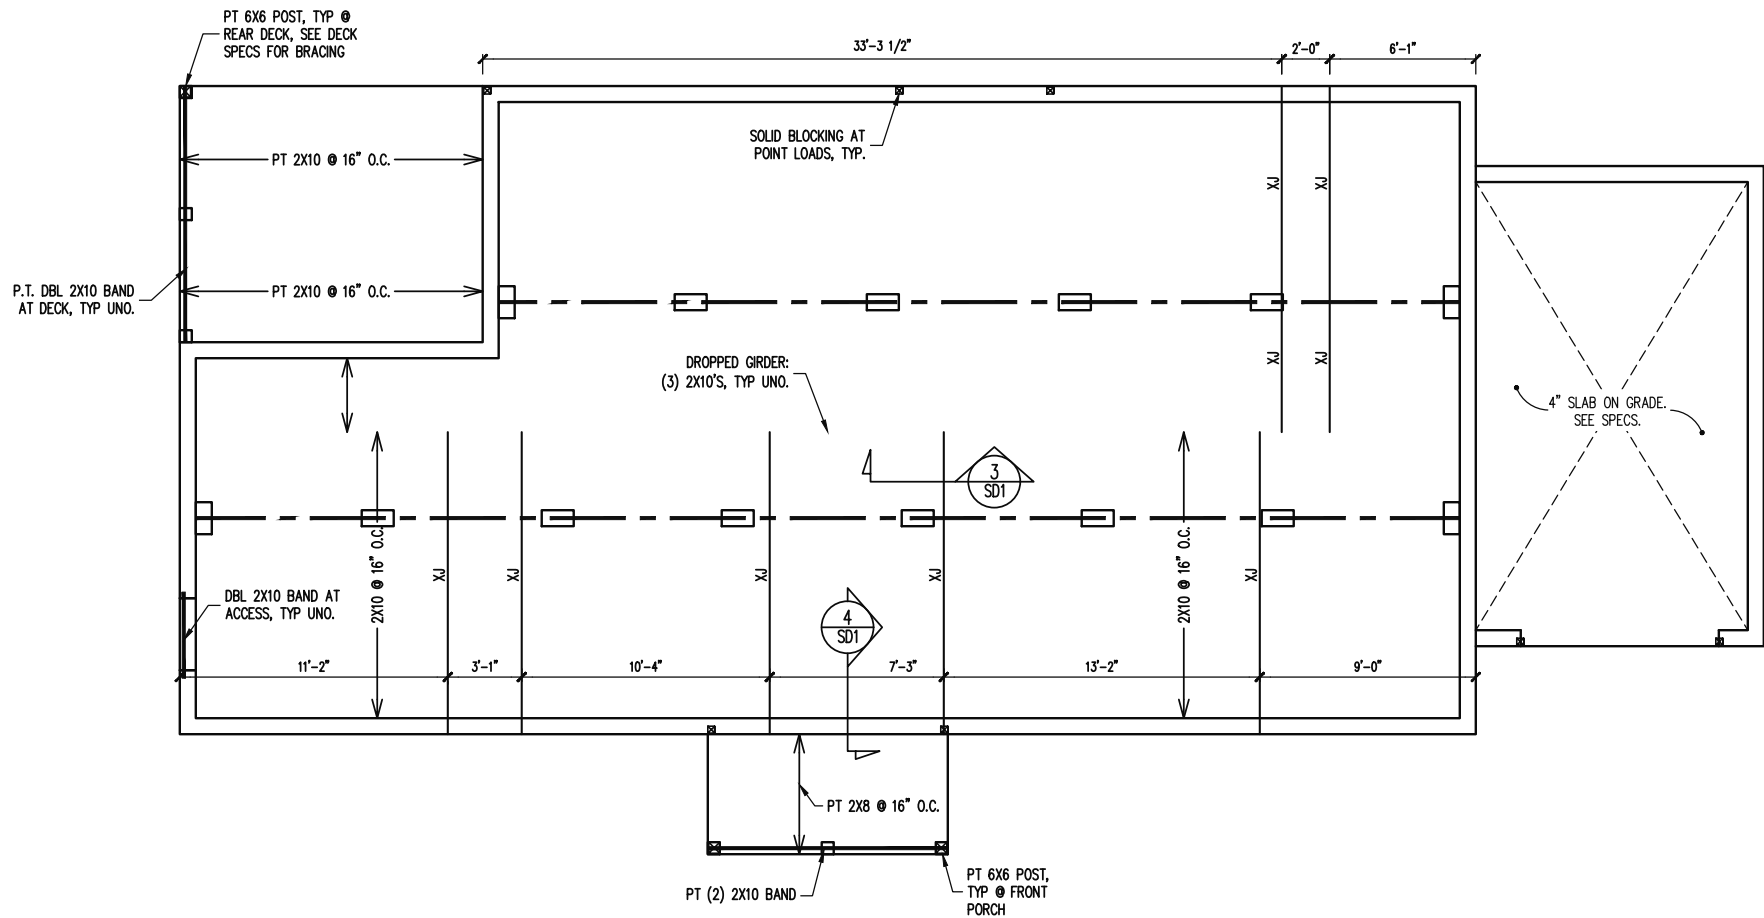
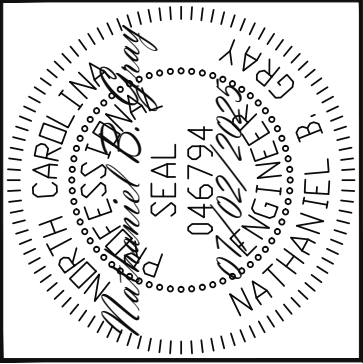
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CYPRESS

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25-26-081

SHEET NO.
S1
1 of 6

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PLAN
CYPRESS

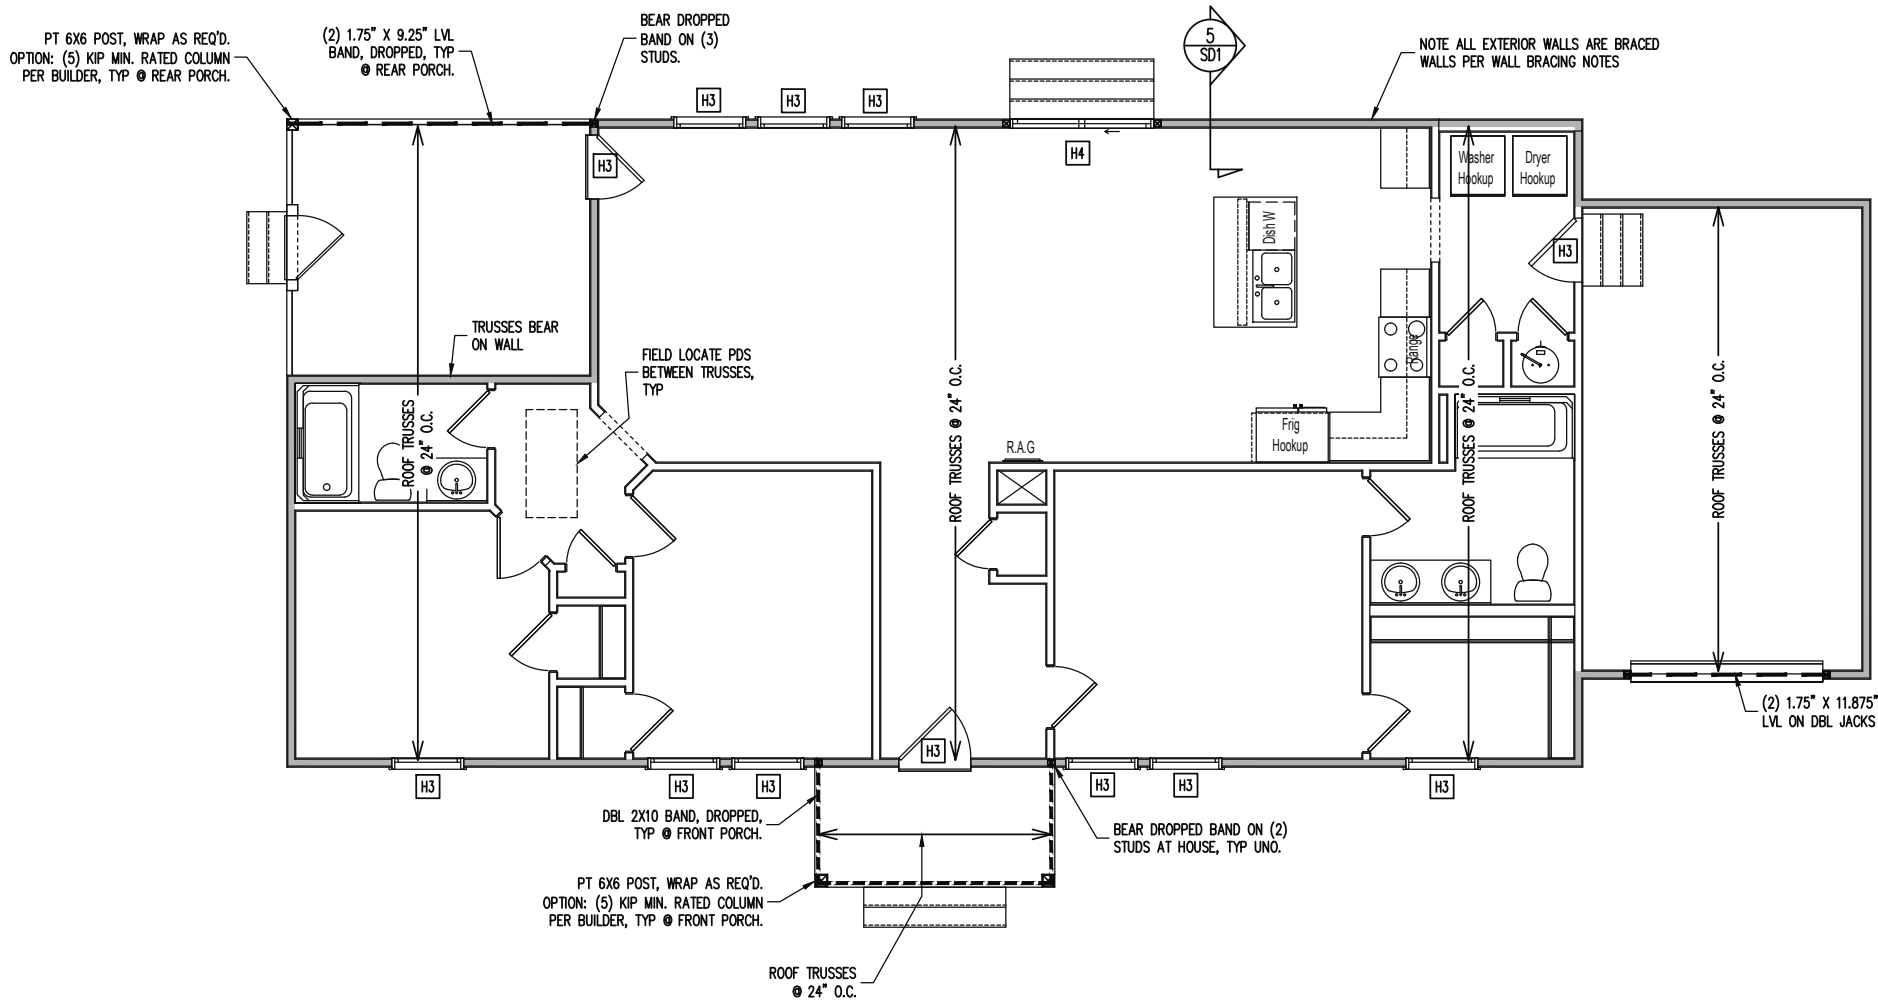
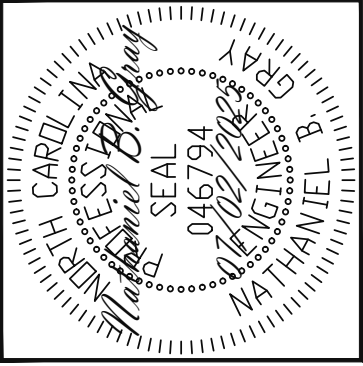
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SHEET NO.
S2

CRAWL SPACE FRAMING PLAN

3/16" = 1'-0"

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CONSTRUCTION SPECIFICATIONS
INSTANT REFERENCES

REFER TO THE CONSTRUCTION SPECIFICATIONS
SECTIONS FOR THE FOLLOWING INFORMATION:

PART 1.01: CURRENT GOVERNING CODE

PART 14: STUD SUPPORT FOR BEAMS

PART 17: KING STUDS FOR EXTERIOR WALLS

SEE DETAIL / CONSTRUCTION SPECIFICATIONS
SHEETS FOR I-JOISTS ALLOWABLE SUBSTITUTIONS

WALL BRACING

SHADED WALLS:

ALL EXTERIOR STUD WALLS, EXTERIOR SIDE,
ARE TO BE CONTINUOUSLY SHEATHED WITH
7/16 APA RATED OSB NAILED TO STUDS WITH
8d NAILS @ 6" O.C. AT PANEL EDGES, 12" O.C.
IN PANEL FIELD.

NOTES:
PROVIDED CONTINUOUS SHEATHING = 185' MIN.

REFERENCE PART 16.02 OF CONSTRUCTION
SPECIFICATIONS FOR GENERAL WIND BRACING
INFORMATION.

HEADER SCHEDULE

- H1 SINGLE 2X4 TURNED FLAT (A)
- H2 (2) 2X4'S ON SINGLE JACKS (B)
- H3 (2) 2X8'S ON SINGLE JACKS (C)
- H4 (2) 1.75" X 9.25" LVL'S ON DBL JACKS
- (A) TYPICAL FOR INTERIOR NON LOAD BEARING
WALLS ONLY, ROUGH OPENING 38" MAX.
- (B) TYPICAL FOR INTERIOR NON LOAD BEARING
WALLS ONLY, ROUGH OPNG 38" TO 74" MAX.
- (C) TYPICAL FOR ALL CONDITIONS NOT LISTED
IN (A) OR (B) UNO.
- NOTES:
-HEADERS IN NON LOAD BEARING INTERIOR
WALLS ARE NOT LABELED.

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SCOPE	1129 HOLDER RD
LOC	LILLINGTON, NC
	JOB# 25-FAY-SAN-019 SINGLER

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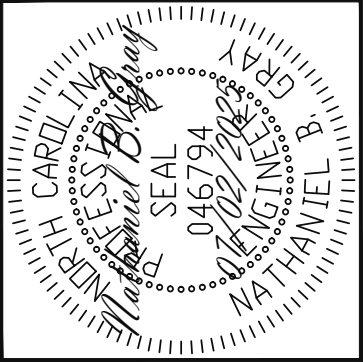
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CYPRESS

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SHEET NO.
S3

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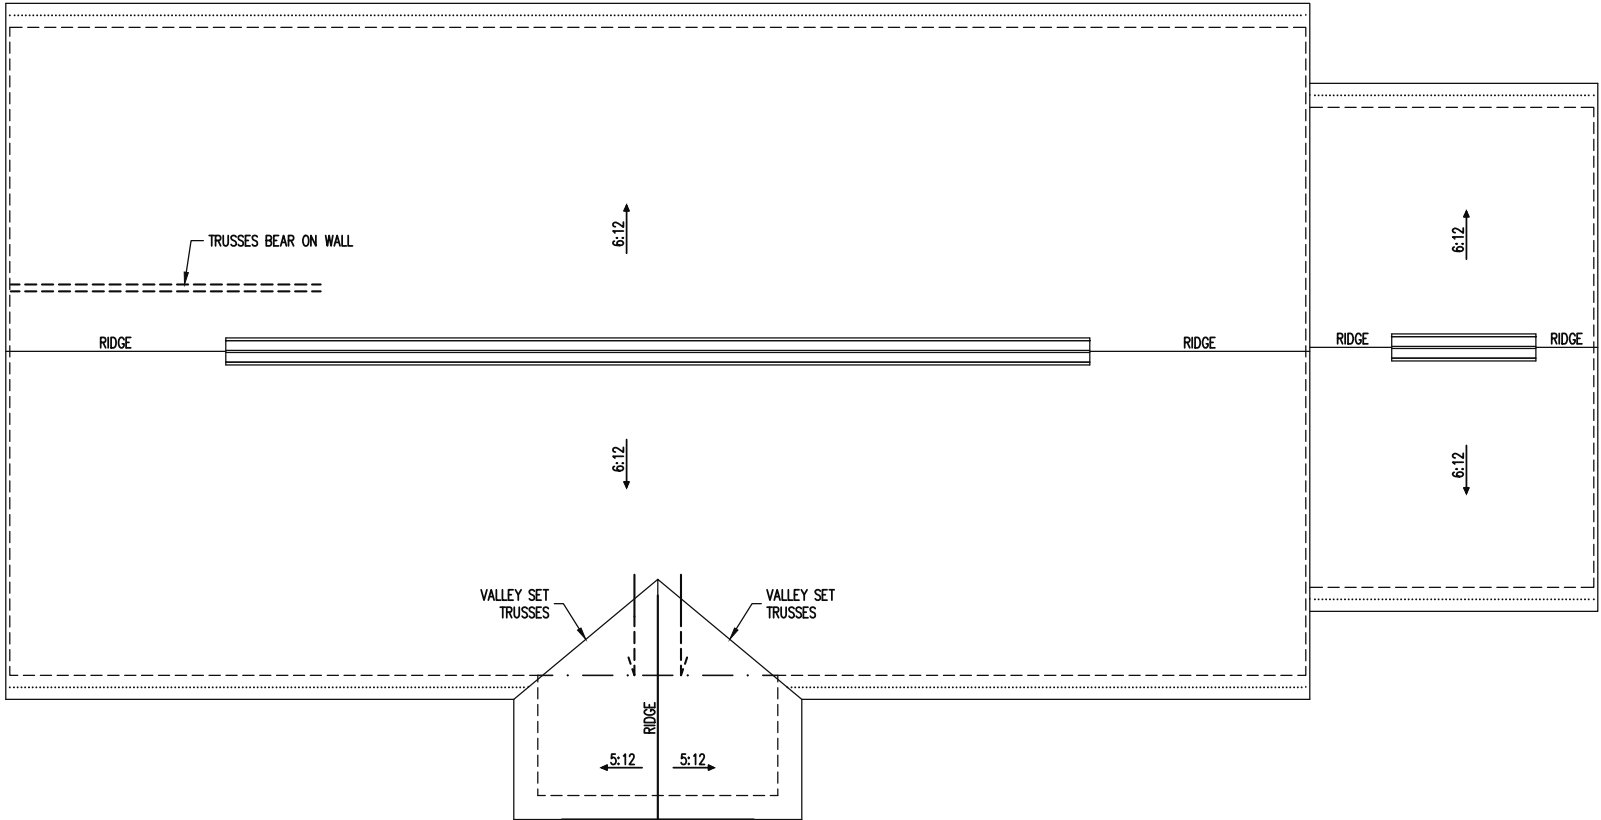
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TRUSS UPLIFT CONNECTORS

EXPOSURE B, 120 MPH, ANY PITCH
24" O.C. MAX ROOF TRUSS SPACING

TRUSSES SHALL BE ATTACHED TO SUPPORT WALL FOR UPLIFT RESISTANCE. CONTINUOUS OSB WALL SHEATHING BELOW PROVIDES CONTINUOUS UPLIFT RESISTANCE TO FOUNDATION. ALL TRUSSES SUPPORTED BY INTERMEDIATE SUPPORT WALLS, KNEEWALLS OR BEAMS SHALL BE ATTACHED TO SUPPORTING MEMBER PER SCHEDULE BELOW.

ROOF SPAN IS MEASURED HORIZONTALLY BETWEEN FURTHEST SUPPORT POINTS.

ROOF SPAN UP TO 18'	CONNECTOR NAILING PER TABLE 602.3(1) NCRBC 2018 EDITION
OVER 18'	(1) SIMPSON H2.5A HURRICANE CLIP TO DBL TOP PLATE OR BEAM

FRAMING NOTES

ROOF ONLY

—ROOF TRUSSES PER MANUFACTURER, TYP U.N.O.

—VERIFY ROOF PITCHES, OVERHANG LENGTHS, AND KNEEWALL FRAMING HGTS WITH ARCHITECTURAL DRAWINGS, TYPICAL.

ROOF FRAMING PLAN

1/8" = 1'-0"

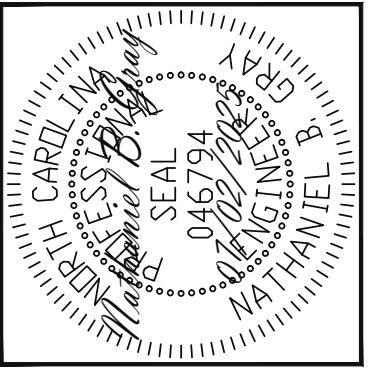
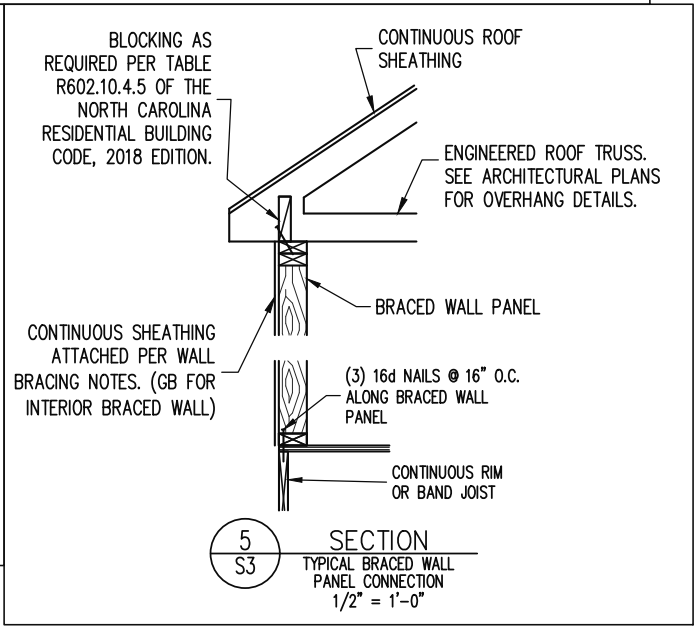
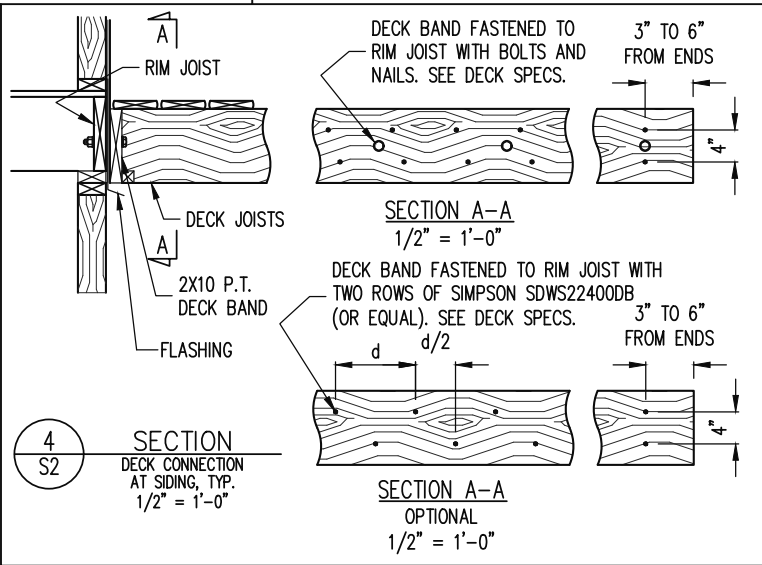
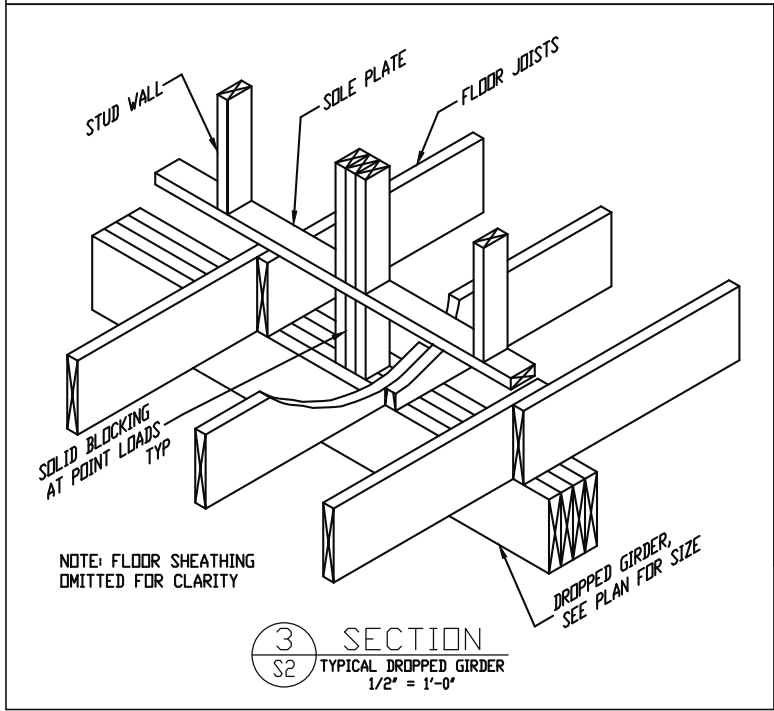
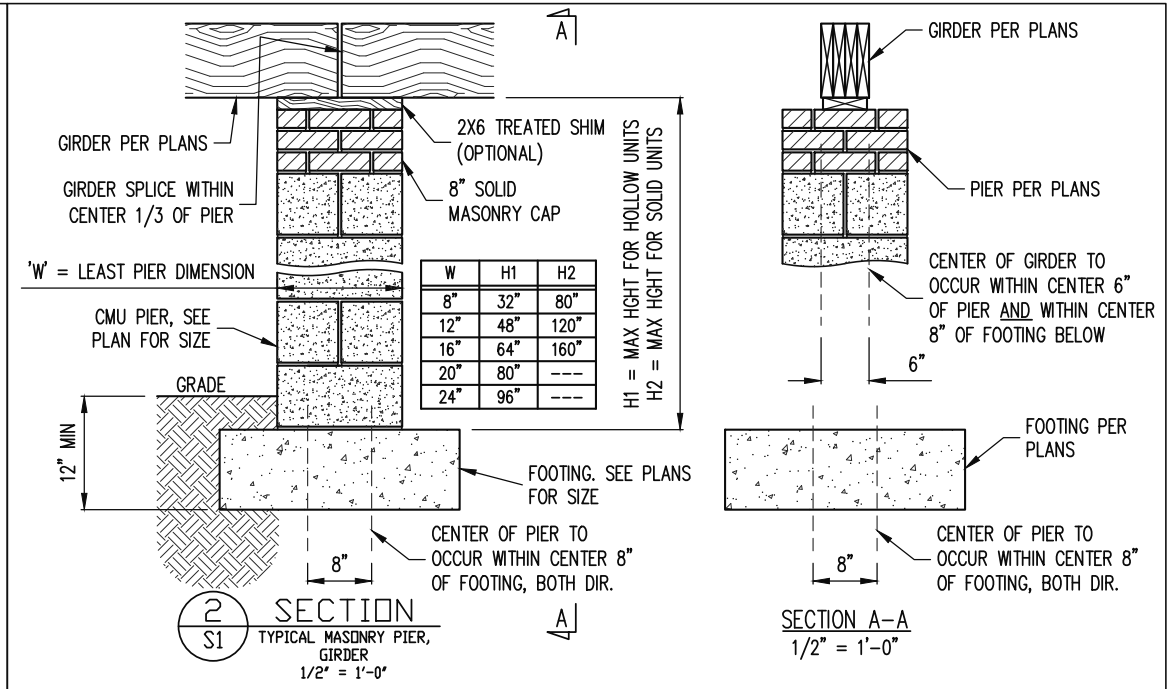
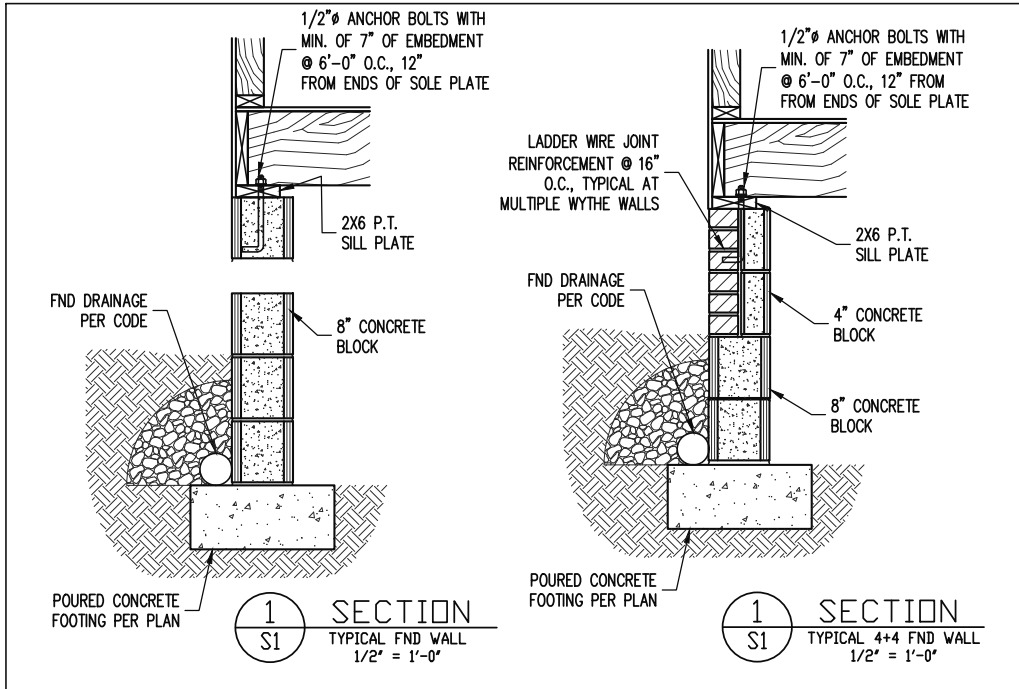
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SHEET NO.
S4
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VALUE BUILD HOMES
STRUCTURAL ADDENDUM
SCOPE: 1129 HOLDER RD
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CYPRESS

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SD1
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