

LOT 36 WATSON RIDGE INVENTORY MARKED

EMBARK DREAM FINDERS HOMES

PLAN REVISIONS

01-04-20 ADJUSTED THE PATIO/PAD TO MEASURE 10' X 8' AND ADJUSTED DIMENSIONS OF CONCRETE PAD/FATIO.
VERIFIED HDR. HTG. WAS AT LEAST 1'-0" ON ALL EXTERIOR WINDOWS.
VERIFIED ROOM SIZES AND DIMENSIONS.
CHANGED WASHER, DRYER, AND REFRIGERATOR TO OPTIONAL COMPONENTS.
VERIFIED MASTERS WAS CHANGED TO OWNER'S THROUGHOUT PLAN.
CHANGED FRONT DOOR ON ELEVATION C TO 3-PANEL INSTEAD OF 2-PANEL DOOR.
ADDED ROOF VENT CALCULATIONS OF ALL ELEVATION.
CHANGED 2X4 WALL AT REAR OF THE GARAGE TO 2X6 WALL.
UPDATED SLAB INTERFACE PLAN AND OPTIONS.
ADDED OPT. DEL. OPEN TO PLANS IN KITCHEN.
ADDED INSULATION DETAIL TO PLANS SHEETS.
ADDED 3'-0"-0" JUDGMENT AT OWNER'S BEDROOM FOR VENTILATION PURPOSES.
REMOVED CUTSHEETS.
CHANGE ALL CEILING FANS TO OPTIONAL.

06-08-20 ADDED WINDOW SCHEDULE
CHANGED OWNERS BATH DOOR TO 10'-0".
ADDED DETAIL FOR DECORATIVE BRACKET ON ELEVATION A, ELEVATION B, & ELEVATION D.
CHANGED COLUMNS TO MATCH STANDARD COLUMNS ACROSS ALL FLOOR PLANS.
REMOVED COLUMN BASE FROM ELEVATION D AND CREATED FULL HEIGHT OF SQUARE COLUMN.
REMOVED GARAGE SHAKE FROM ELEVATION D.
CHANGED LINEN HALL DOOR FROM 1/8 BIFOLD TO 1/6 STD.
CHANGED LINEN DOOR FROM 1/0 BIFOLD TO 1/0 STD.
CHANGED OWNERS BATH LINEN DOOR FROM 1/6 BIFOLD TO 1/6 STD.
CHANGED COATS DOOR FROM 1/6 BIFOLD TO 1/6 STD.
CHANGED BED 2 CLOSET DOORS FROM 1/6 BIFOLD TO 1/6 STD.
CHANGED BED 3 CLOSET DOOR FROM 1/6 BIFOLD TO 1/6 STD.
CHANGED OWNERS BEDROOM DOOR FROM 1/6 BIFOLD TO 1/6 STD.
REMOVED OPTIONAL DOUBLE OVEN.
REMOVED VENT FROM GABLE ON ELEVATION A (01-18-24)

12-01-22 ADDED ELEVATION D2 SHOWING BRICK COLUMN AND D3 SHOWING STONE COLUMN
ADDED SQUARE FOOTAGE BLOCK FOR D2 AND D3 ELEVATIONS.
VERIFIED AND UPDATED OPTIONAL OWNERS BATH + 3 LAYOUTS.
CHANGING OF FIRST FLOOR CEILING HEIGHT FROM 9'-0" TO 8'-0" CEILING HEIGHT.
SQUARE FOOTAGE OF FRONT PORCH ON ELEVATION 'D' CHANGED TO 16 SQ.FT.
SQUARE FOOTAGE OF FRONT PORCH ON ELEVATION 'D2' CHANGED TO 16 SQ.FT.
SQUARE FOOTAGE OF FRONT PORCH ON ELEVATION 'D3' CHANGED TO 16 SQ.FT.
12-01-22 CHANGED GARDEN TUB OF OPTIONAL OWNERS BATH 1 FROM 66" TO 60".
CHANGED GARDEN TUB OF OPTIONAL OWNERS BATH 3 FROM 66" TO 60".
CHANGED WINDOW HEAD HEIGHTS TO 85".
ADDED 16 OPTIONAL LED CAN LIGHTS IN KITCHEN (06-15-23)

08-15-24 CEILING HEIGHT CHANGED FROM 8'-0" TO 9'-0"
OPTIONAL COVERED PATIO CREATED

REVISED SF. AS FOLLOWS:
LIVING WAS 11'-0" X 12'-0", NOW 11'-0" X 12'-0".
GARAGE WAS 12'-0" X 12'-0", NOW 12'-0" X 12'-0".
FRONT PORCH AT ELEVATION B WAS 63 SF, NOW 65 SF.
REMOVED RAILING AT 50 FT. BLOCK PORCH A WAS 63 SF, NOW 65 SF. PORCH B WAS 73 SF.
NOW IS 72 SF.
CHANGED SHUTTERS TO BE 14" WIDE.
REMOVED OFF. RETIE BOARD AT REAR AND SIDE ELEVATIONS.
CREATED LEFT HAND GARAGE VERSION

DREAM FINDERS HOMES	27167.03 DRAWING NO. COP. DATE NAME: EMBARK_R ISSUED 11-02-17 09-14-18 09-24-19 06-01-20 06-08-20 12-01-22 12-07-22 08-15-24	DRAWINGS ON THIS SHEET ARE ONE HALF THE SCALE NOTED	LOT 36 WATSON RIDGE
EMBARK (GARAGE RIGHT)	DREAM FINDERS HOMES	SHEET LOG	1724
EMBARK (GARAGE LEFT)	DREAM FINDERS HOMES	SHEET CS	
SQUARE FOOTAGE	SQUARE FOOTAGE	SQUARE FOOTAGE	SQUARE FOOTAGE
HEATED AREAS	ELEV 'B'	HEATED AREAS	ELEV 'D'
LIVING	1725 SQ. FT.	LIVING	1725 SQ. FT.
TOTAL HEATED SF	1725 SQ. FT.	TOTAL HEATED SF	1725 SQ. FT.
UNHEATED AREAS		UNHEATED AREAS	
GARAGE	248 SQ. FT.	FRONT PORCH	126 SQ. FT.
COVERED AREAS		UNCOVERED AREAS	
PAD	16 SQ. FT.	PAD	16 SQ. FT.
HEATED OPTIONS		HEATED OPTIONS	
UNHEATED OPTIONS		UNHEATED OPTIONS	
OPTIONAL PATIO		OPTIONAL PATIO	
OPTIONAL COVERED PATIO		OPTIONAL COVERED PATIO	
OPTIONAL 1-CAR GARAGE		OPTIONAL 1-CAR GARAGE	
SQUARE FOOTAGE	SQUARE FOOTAGE	SQUARE FOOTAGE	SQUARE FOOTAGE
HEATED AREAS	ELEV 'D2'	HEATED AREAS	ELEV 'D3'
LIVING	1725 SQ. FT.	LIVING	1725 SQ. FT.
TOTAL HEATED SF	1725 SQ. FT.	TOTAL HEATED SF	1725 SQ. FT.
UNHEATED AREAS		UNHEATED AREAS	
GARAGE	248 SQ. FT.	FRONT PORCH	136 SQ. FT.
COVERED AREAS		UNCOVERED AREAS	
PAD	16 SQ. FT.	PAD	16 SQ. FT.
HEATED OPTIONS		HEATED OPTIONS	
UNHEATED OPTIONS		UNHEATED OPTIONS	
OPTIONAL PATIO		OPTIONAL PATIO	
OPTIONAL COVERED PATIO		OPTIONAL COVERED PATIO	
OPTIONAL 1-CAR GARAGE		OPTIONAL 1-CAR GARAGE	

SEQUENCE OF PLANS FROM THIS DRAFTER'S OFFICE SHALL NOT RELIEVE THE BUILDER OR
RESPONSIBLE FOR REVIEW AND VERIFY ALL NOTES, DIRECTIONS AND ADVICE RELATED TO APPLICABLE
BUILDING CODES PRIOR TO CONSTRUCTION OF ANY CONSTRUCTION.
AN INCONCERN OF ERRORS, NOTES, DIRECTIONS OR ADVICE TO APPLICABLE BUILDING
CODES SHALL BE BROUGHT TO THE ATTENTION OF THE DRAFTER'S OFFICE FOR CORRECTION BEFORE
CONSTRUCTION.
ANY REVISIONS OR CHANGES NOT RELATED TO THE CORRECTION OF ERRORS THAT ARE MADE
AFTER THE FINAL PLANS HAVE BEEN COMPLETED SHALL BE SUBJECT TO ADDITIONAL FEES.
IF ANY MODIFICATIONS ARE MADE TO THESE PLANS BY ANY OTHER PARTY OTHER THAN THE
DRAFTER'S OFFICE, THE DRAFTER SHALL NOT BE HELD RESPONSIBLE.

SCALE NOTE: LARGE FORMAT PRINTS ARE TO SCALE AS NOTED
11" x 17" PRINTS ARE ONE HALF THE NOTED SCALE

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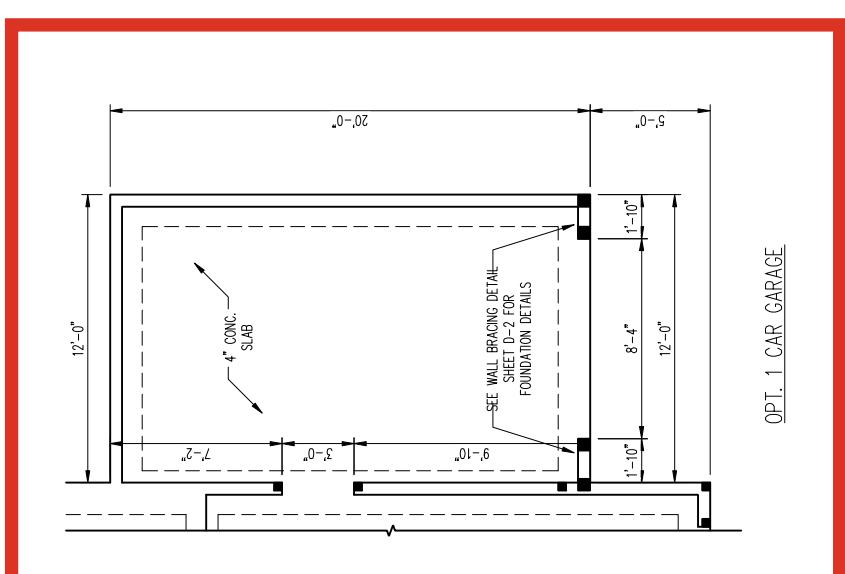
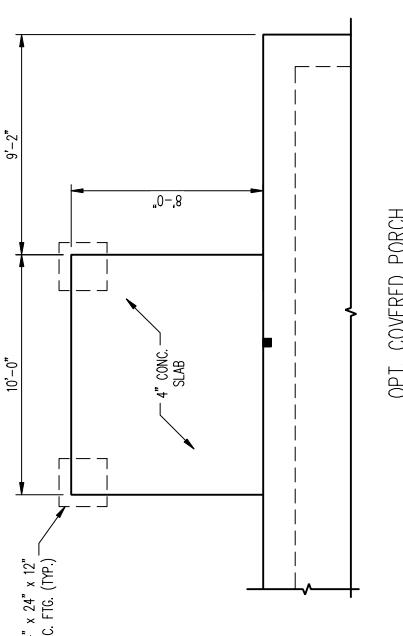
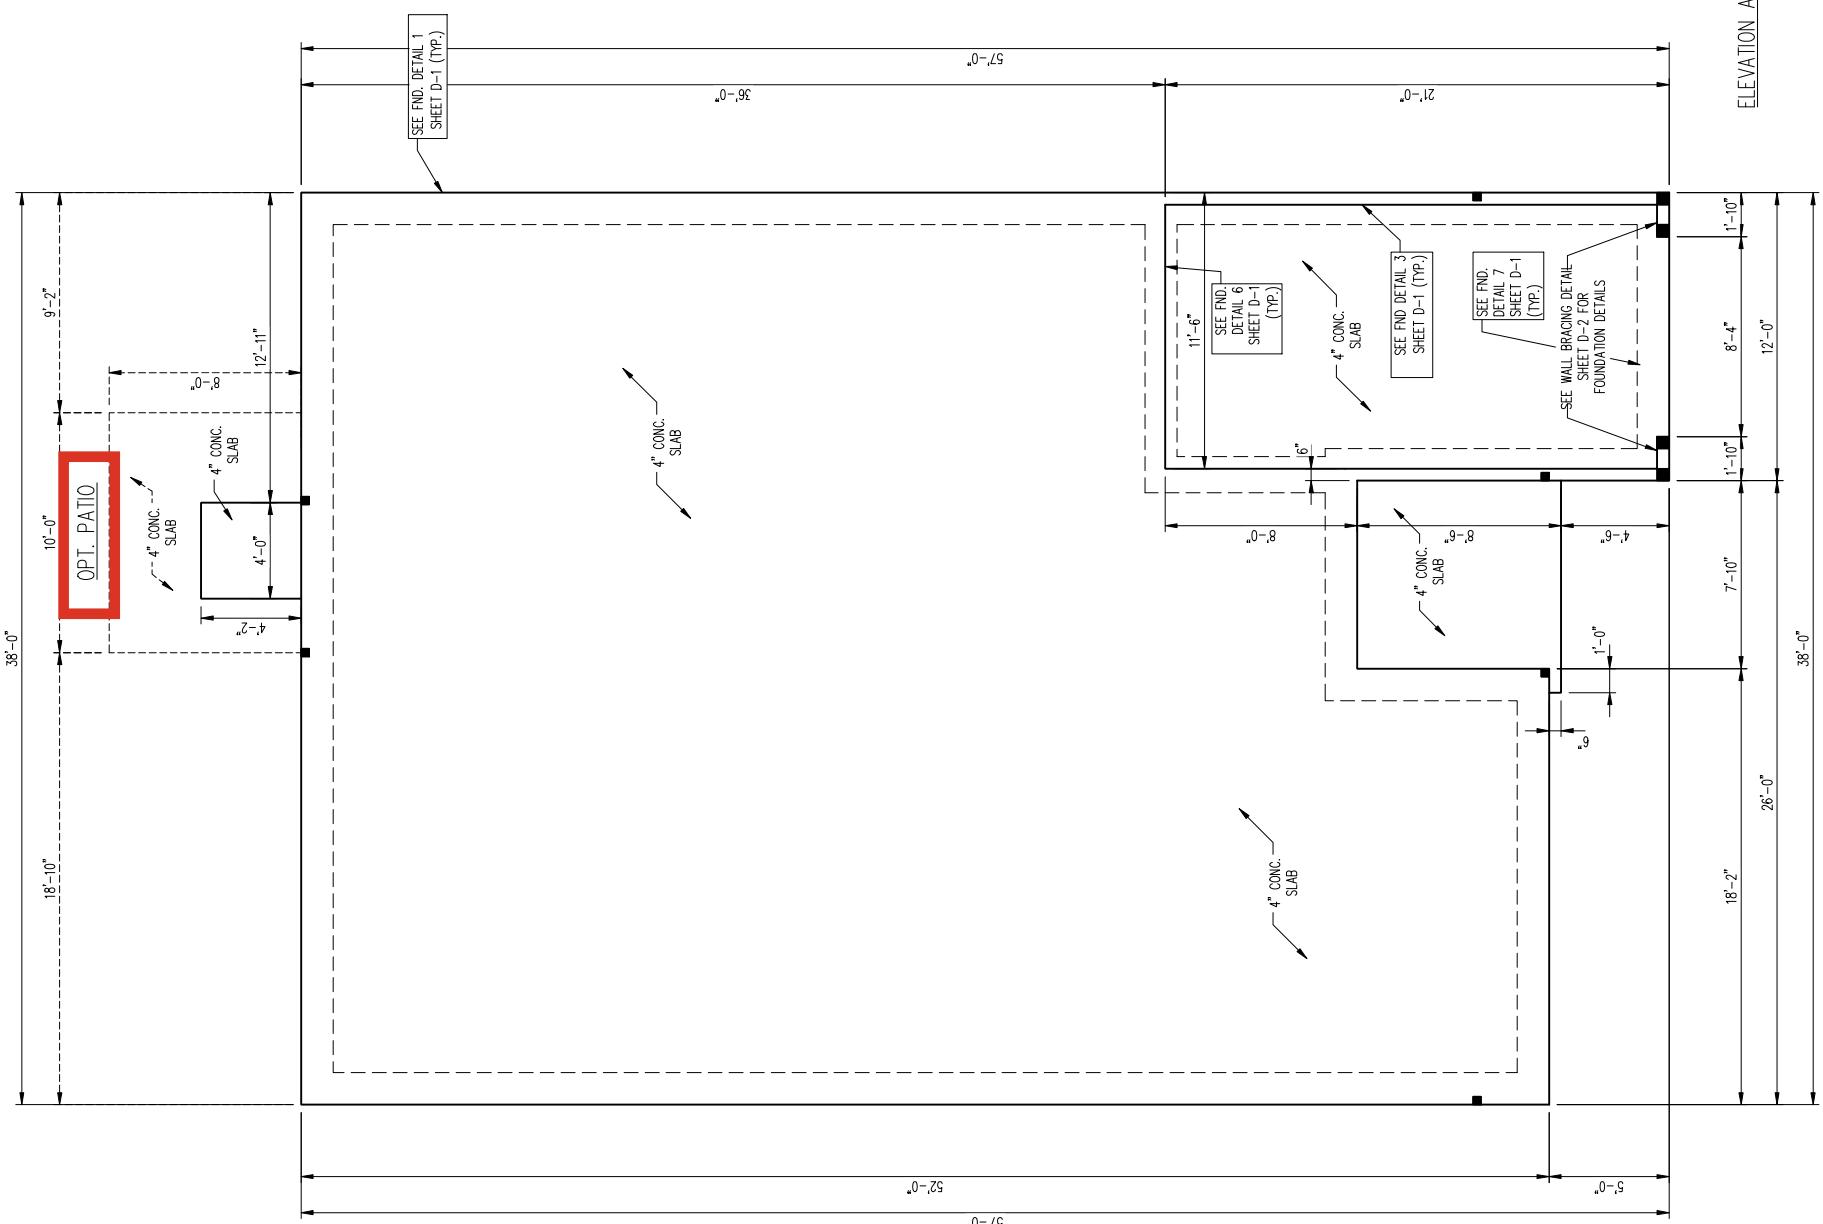
DREAM FINDERS HOMES
EMBARK



DATE: AUGUST 27, 2014
SCALE: 1/4" = 1'-0"
DRAWN BY: DAVIS BEWS DESIGN CO.
ENGINEERED BY: WTB

S-1.2a
MONO SLAB
FOUNDATION PLAN

卷之三

8/29/2024



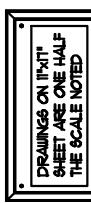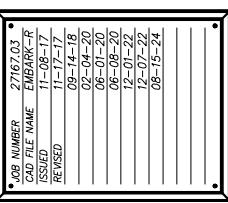

EMBAKK (GARAGE RIGHT) DREAM FINDERS HOMES

1724

TITLE
INTERFACE PLAN

10

SHEET
10

FLOOR PLAN


SCAN E: 1/4" = 1'-0"

SCAN E: 1/4" = 1'-0"

SLAB INTERFACE PLAN A

SLAB IN LK

ELEV. A SHOWS
SMALL AIR AT ALL ELEVATIONS (NO BLOWING CHANGES)

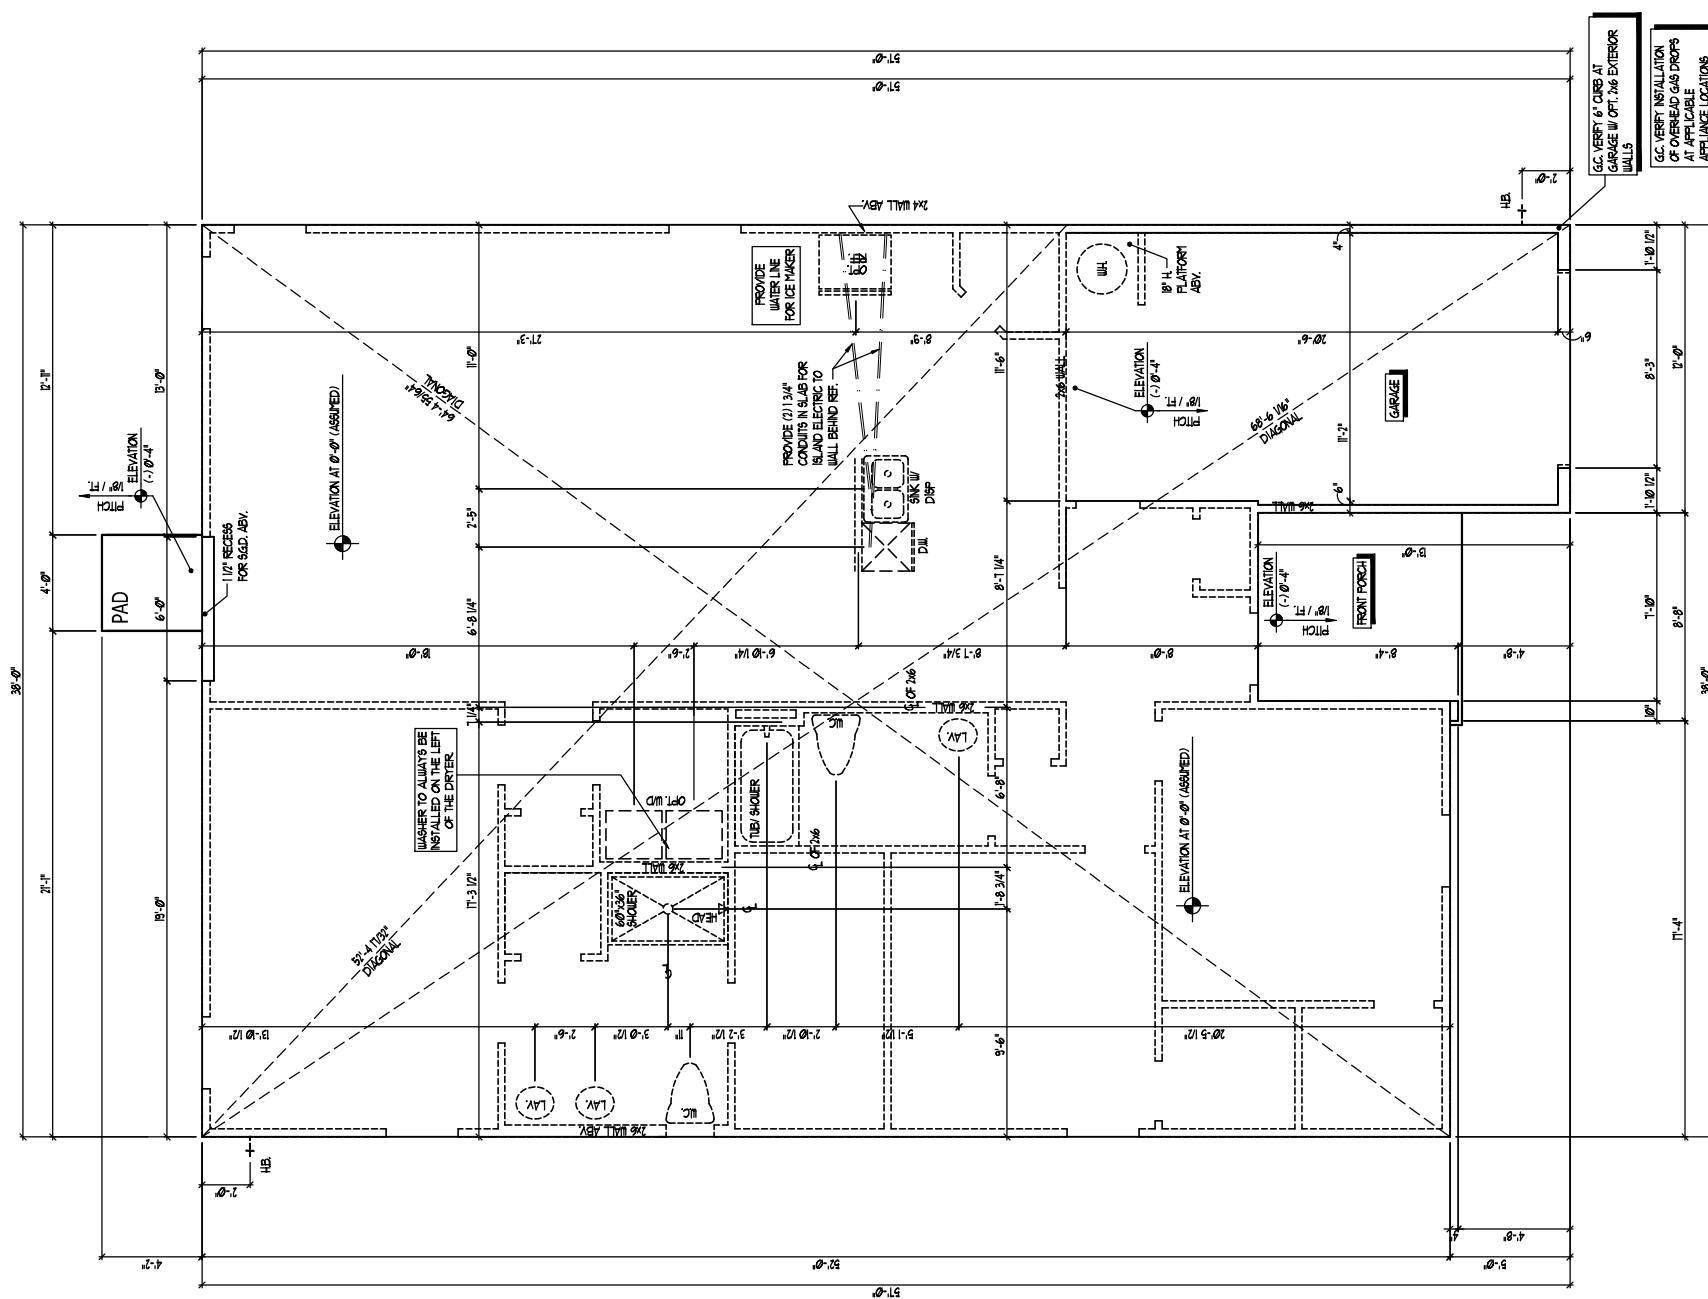

RELIANCE OF PLANS FROM THIS DRAFTER'S OFFICE SHALL NOT RELIEVE THE BUILDER OF RESPONSIBILITY TO REVIEW AND VERIFY ALL NOTES, DIMENSIONS, AND ADHERENCE TO APPLICABLE BUILDING CODES PRIOR TO COMMENCEMENT OF ANY CONSTRUCTION. ANY DISCREPANCY OF ERROR IN NOTES, DIMENSIONS OR ADHERENCE TO APPLICABLE BUILDING CODES SHALL BE FORWARDED TO THE ATTENTION OF THE DRAFTER'S OFFICE FOR CORRECTION BEFORE COMMENCEMENT OF ANY CONSTRUCTION. ANY REVISIONS OR CHANGES NOT RELATED TO THE CORRECTION OF ERRORS THAT ARE MADE AFTER THE PLANS HAVE BEEN COPIED SHALL BE SUBJECT TO ADDITIONAL FEES. IF ANY MODIFICATIONS ARE MADE TO THESE PLANS BY ANY OTHER PARTY OTHER THAN THE DRAFTER'S OFFICE, THE DRAFTER SHALL NOT BE HELD RESPONSIBLE.

DREAM FINDERS
HOMES



DOC NUMBER:	27167.03
CO. OR NAME:	EMBAK
ISSUED:	11-07-17
RE-USED:	09-12-18
	09-14-19
	09-14-20
	06-01-20
	06-08-20
	12-01-22
	12-07-22
	08-15-24

DRAWINGS ON THIS SHEET ARE ONE HALF THE SCALE NOTED

DREAM FINDERS HOMES

EMBAK (GARAGE RIGHT)


DREAM FINDERS HOMES

1724


SLAB INTERFACE PLAN

SHEET


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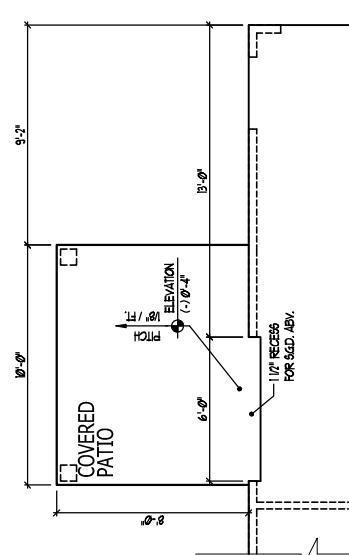
OPT. OWNER'S BATH 3

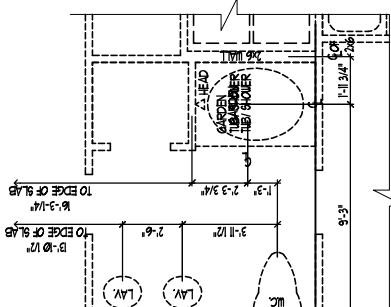


OPT. OWNER'S BATH 2

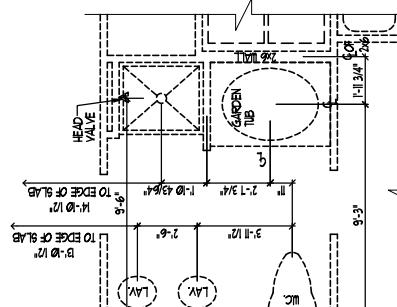

OPT.1 CAR GARAGE

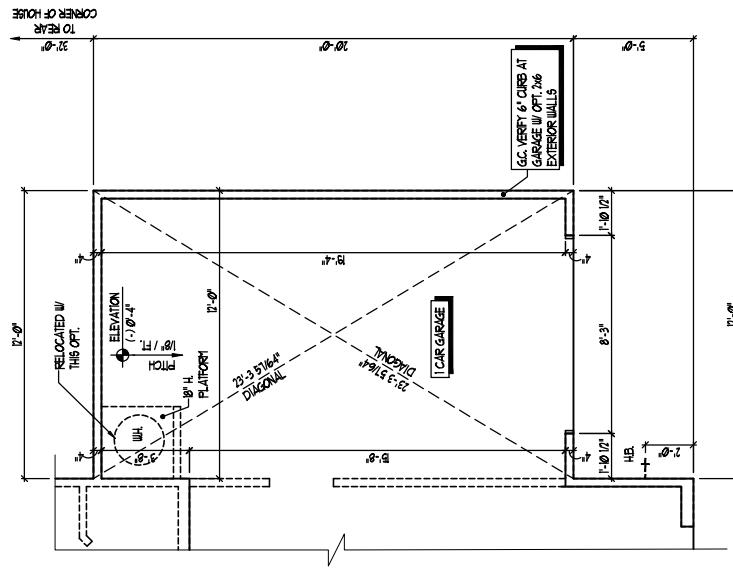

OPT. COVERED PATIO

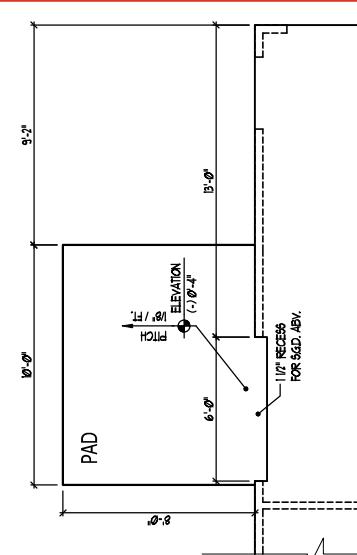


OPT. PATIO

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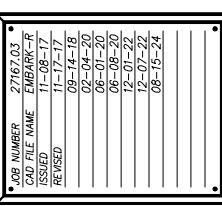
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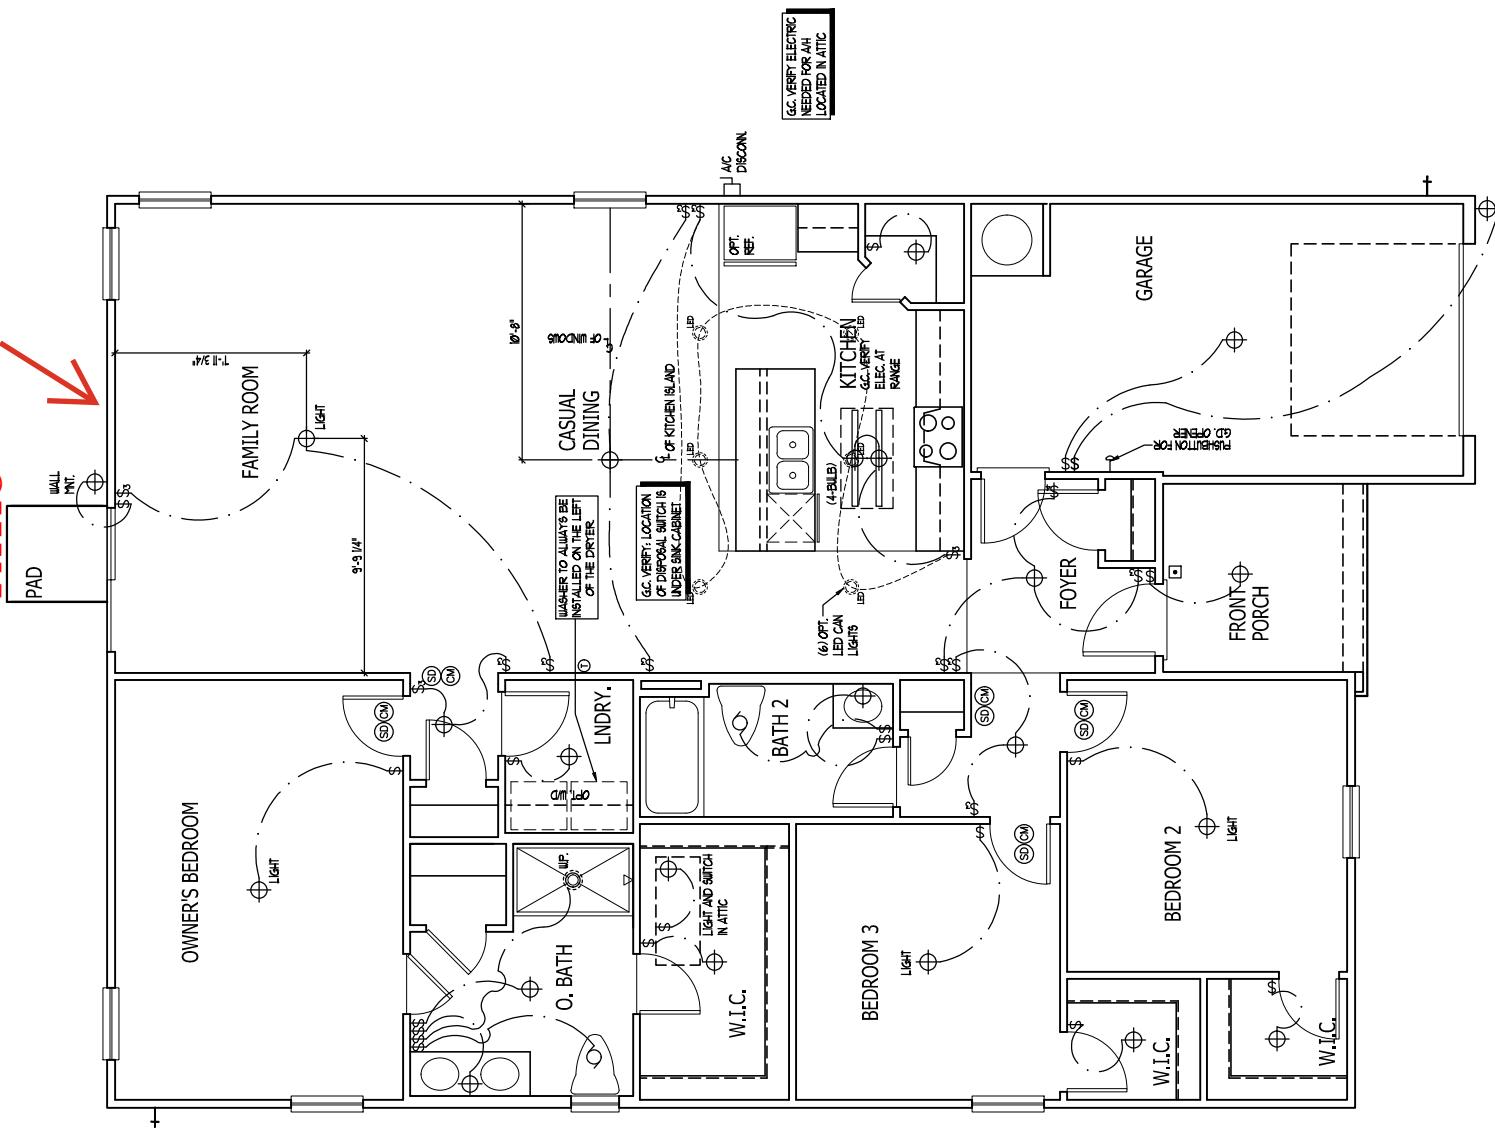
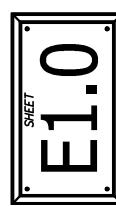
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CENTER FIREPLACE BETWEEN WINDOWS

PATIO

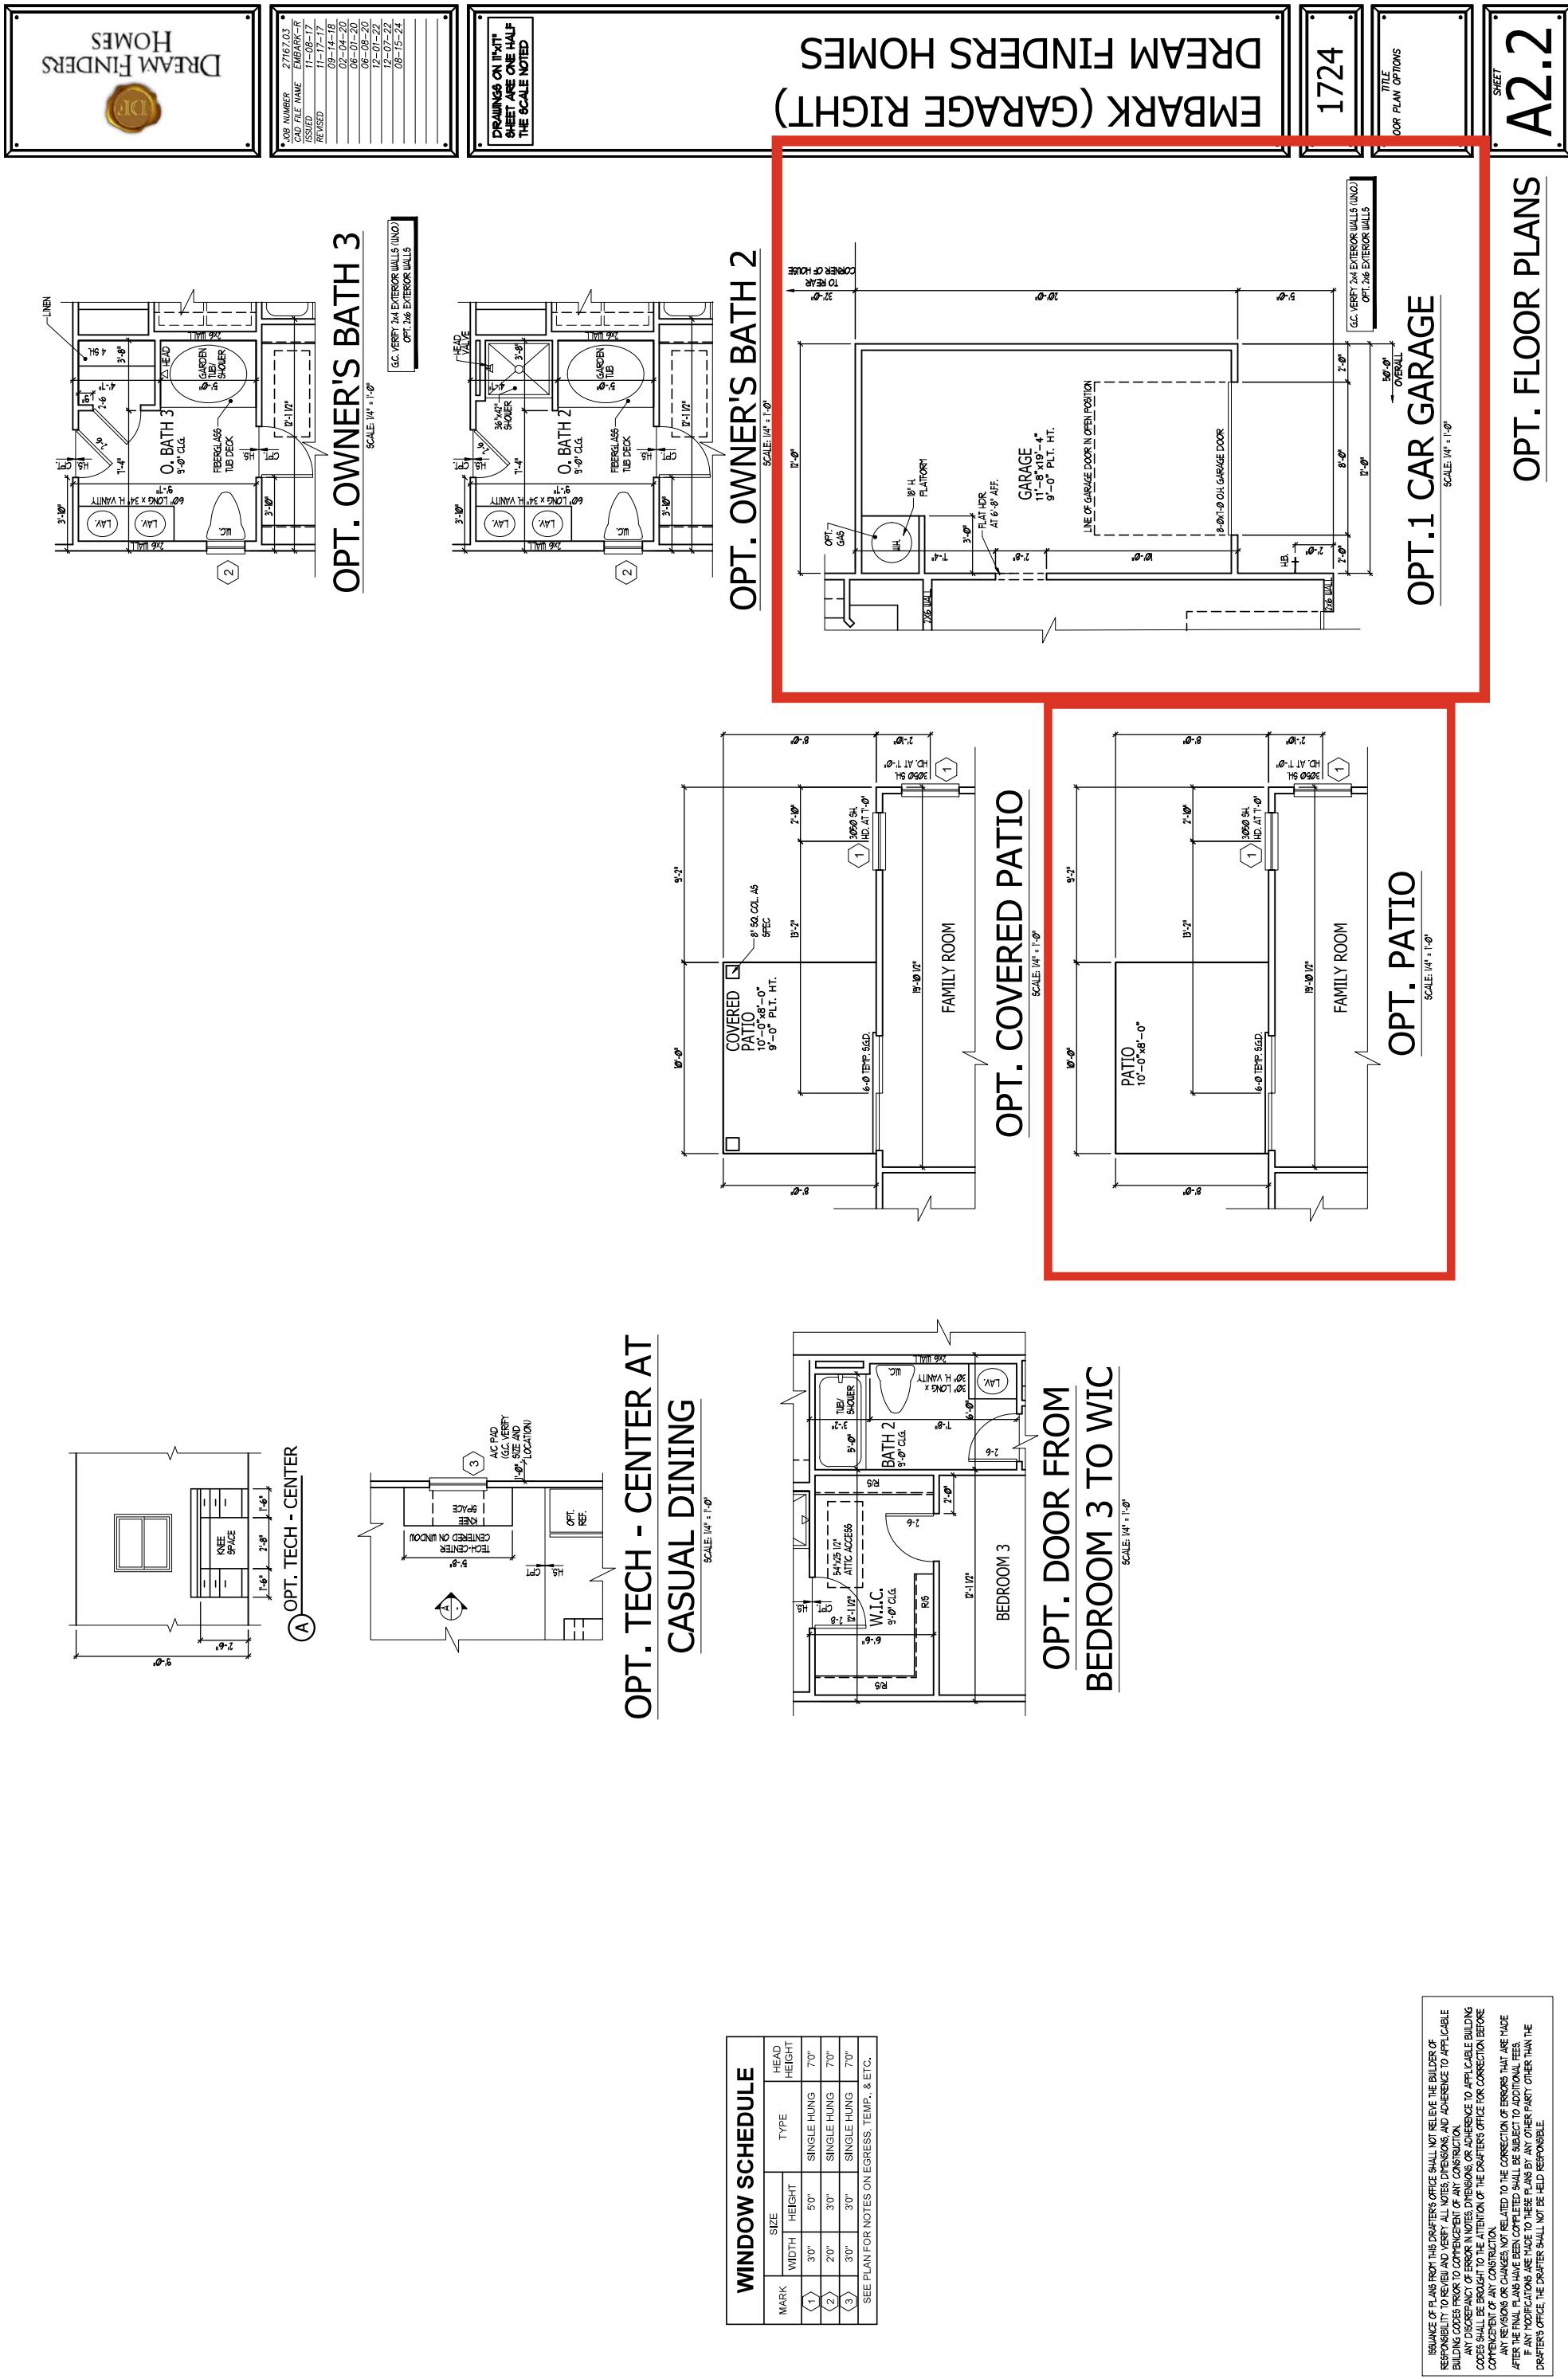

EMBARK (GARAGE RIGHT) DREAM FINDERS HOMES



FLOOR PLAN

ELECTRICAL PLAN A

CLC |

ELECTRICAL KEY

DREAM FINDERS

**ELECTRICAL KEY**

- DUREX CONVENIENCE OUTLET
- DUREX OUTLET ABOVE COUNTER
- DUREX OUTLET DUREX OUTLET
- GROUND FAULT INTERRUPTER DUREX OUTLET
- HALF-SWITCHED DUREX OUTLET
- SPECIAL PURPOSE OUTLET
- WATERPROOF DUREX OUTLET
- DUREX OUTLET IN FLOOR
- 220 VOL. OUTLET
- WALL SWITCH
- THREE-WAY SWITCH
- FOUR-WAY SWITCH
- DIMMER SWITCH
- CIRCUIT (OPTIONAL)
- CEILING MOUNTED INCANDESCENT LIGHT FIXTURE
- WALL MOUNTED INCANDESCENT LIGHT FIXTURE
- RECESSED INCANDESCENT LIGHT FIXTURE
- LED CAN LIGHT
- LED PROFILE WITH FULL CHAIN
- TRACK LIGHT
- FLUORESCENT LIGHT FIXTURE
- EXHAUST FAN
- EXHAUST FAN/LIGHT COMBINATION
- ELECTRIC DOOR OPERATOR (OPTIONAL)
- PIR/BURGLAR SWITCH (OPTIONAL)
- CARBON MONOXIDE DETECTOR
- SMOKE / CARBON MONOXIDE DETECTOR
- TELEPHONE (OPTIONAL)
- TELEVISION (OPTIONAL)
- THERMOSTAT
- ELECTRIC METER
- ELECTRIC PANEL
- DISCONNECT SWITCH
- SPEAKER (OPTIONAL)
- ROUGH-IN FOR OPT. CEILING FAN
- CEILING MOUNTED INCANDESCENT LIGHT FIXTURE W/ ROUGH-IN FOR OPT. CEILING FAN

NOTES:

1. PROVIDE AND TEST GRAND FAULT CIRCUIT INTERFACES (GFI) AS INDICATED

ON PLANS OR AS ITEM NO. 4 AND 5 BELOW INDICATES.

2. UNLESS OTHERWISE NOTATED, INSTALL SWITCHES AND RECEPTACLES AT THE

FOLLOWING HEIGHTS ABOVE FINISHED FLOOR:

SWITCHES...42"

OUTLETS...14"

TELEPHONE...14" UNLESS ASY CENTER(OPT.)

TELEVISION...14"

3. ALL SMOKE DETECTORS SHALL BE HARDWIRED INTO AN ELECTRICAL POWER

SOURCE AND SHALL BE EQUIPPED WITH A MONITORED BATTERY BACKUP. PROVIDE

AND INSTALL LOCALLY CERTIFIED SMOKE DETECTORS.

4. ALL 5A AND 20A RECEPTACLES IN SLEEPING ROOMS, FAMILY ROOMS, DINING

ROOMS, LIVING ROOMS, PARLORS, LIBRARIES, DEN, BUNK ROOMS, RECREATION ROOMS,

CLOSETS, HALLWAYS AND KITCHEN AREAS WILL RECEIVE A GROUPE TYPE AFCI

DEVICE AND GROUPE TYPE GFCI RECEPTACLES AS PER NEC, 2011, 404.7 AND 406.13

5. ALL 5A AND 20A RECEPTACLES LOCATED IN THE GARAGE AND UTILITY

ROOMS SHALL BE GROUPE PROTECTED (GFI).

6. IT IS THE RESPONSIBILITY OF THE DRAWN ELECTRICIAN TO ENSURE THAT ALL

ELECTRICAL WORK IS IN FULL COMPLIANCE WITH NFPA 70, 2011, AND ALL

APPLICABLE LOCAL STANDARDS, CODES, AND ORDINANCES.

7. EVER BUILDING HAVING A FOSSIL FUEL BURNING HEATER OR APPLIANCE

FIREPLACE OR AN ATTACHED GARAGE SHALL HAVE AN OPERATIONAL CARBON

MONoxide DETECTOR INSTALLED WITHIN 10 FEET OF EACH ROOM USED FOR SLEEPING

PURPOSES.

8. ALARMS SHALL RECEIVE THEIR PRIMARY POWER FROM THE BUILDING WIRING WHEN


SUCH ALARMS ARE SERVED FROM THE LOCAL POWER UTILITY. SUCH ALARMS SHALL HAVE

A BACKUP COMBINATION BATTERY/CARBON MONOXIDE ALARM SHALL BE


LISTED OR LABELED BY A NATIONALLY RECOGNIZED TESTING LABORATORY.

SOURCE OF PLANS FROM THIS DRAWER'S OFFICE SHALL NOT RELIEVE THE BUILDER OR
RESPONSIBLE CONTRACTOR OF ANY LIABILITY FOR DEFECTIVE OR NON-COMPLIANT WORK.
ALL WORK MUST BE CONDUCTED IN ACCORDANCE WITH THE APPROPRIATE BUILDING
CODES SHALL BE ENFORCED BY THE LOCAL POWER UTILITY. SUCH ALARMS SHALL HAVE
A BACKUP COMBINATION BATTERY/CARBON MONOXIDE ALARM WHICH SHALL BE
LISTED OR LABELED BY A NATIONALLY RECOGNIZED TESTING LABORATORY.


DREAM FINDERS HOMES

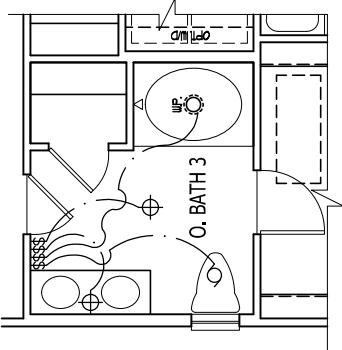EMBAK (GARAGE RIGHT)**OPT. OWNER'S BATH 3**


SCALE: 1/4" = 1'-0"

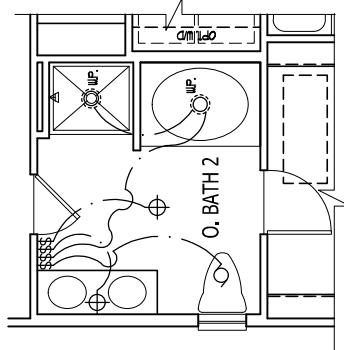**OPT. OWNER'S BATH 2**


SCALE: 1/4" = 1'-0"

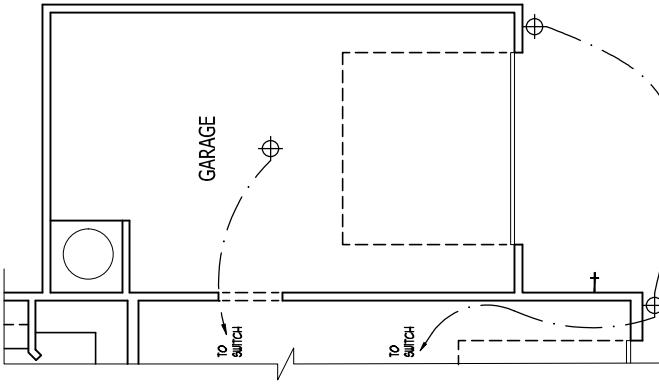**OPT.1 CAR GARAGE**


SCALE: 1/4" = 1'-0"

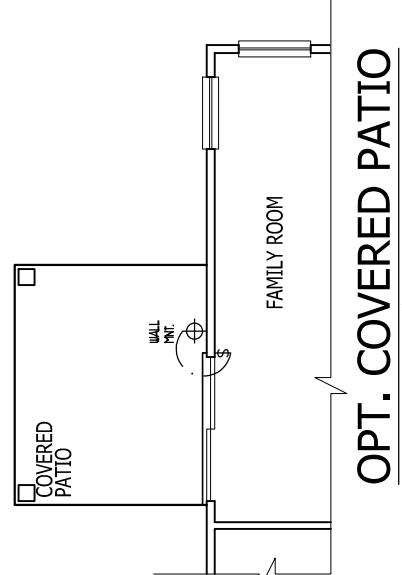**OPT. COVERED PATIO**

SCALE: 1/4" = 1'-0"

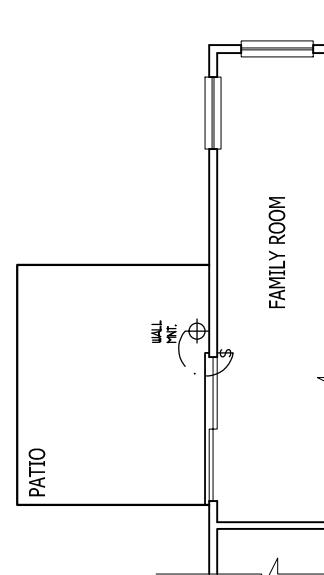**OPT. PATIO**

SCALE: 1/4" = 1'-0"

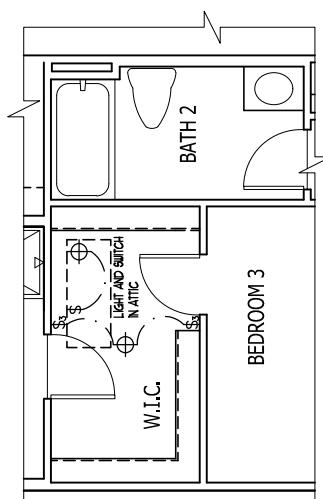
**OPT. DOOR FROM
BEDROOM 3 TO WIC**

SCALE: 1/4" = 1'-0"

ELECTRICAL PLANS**E1.1**


SHEET

TITLE: **ELECTRICAL PLAN OPTIONS**
- - -
SHEET

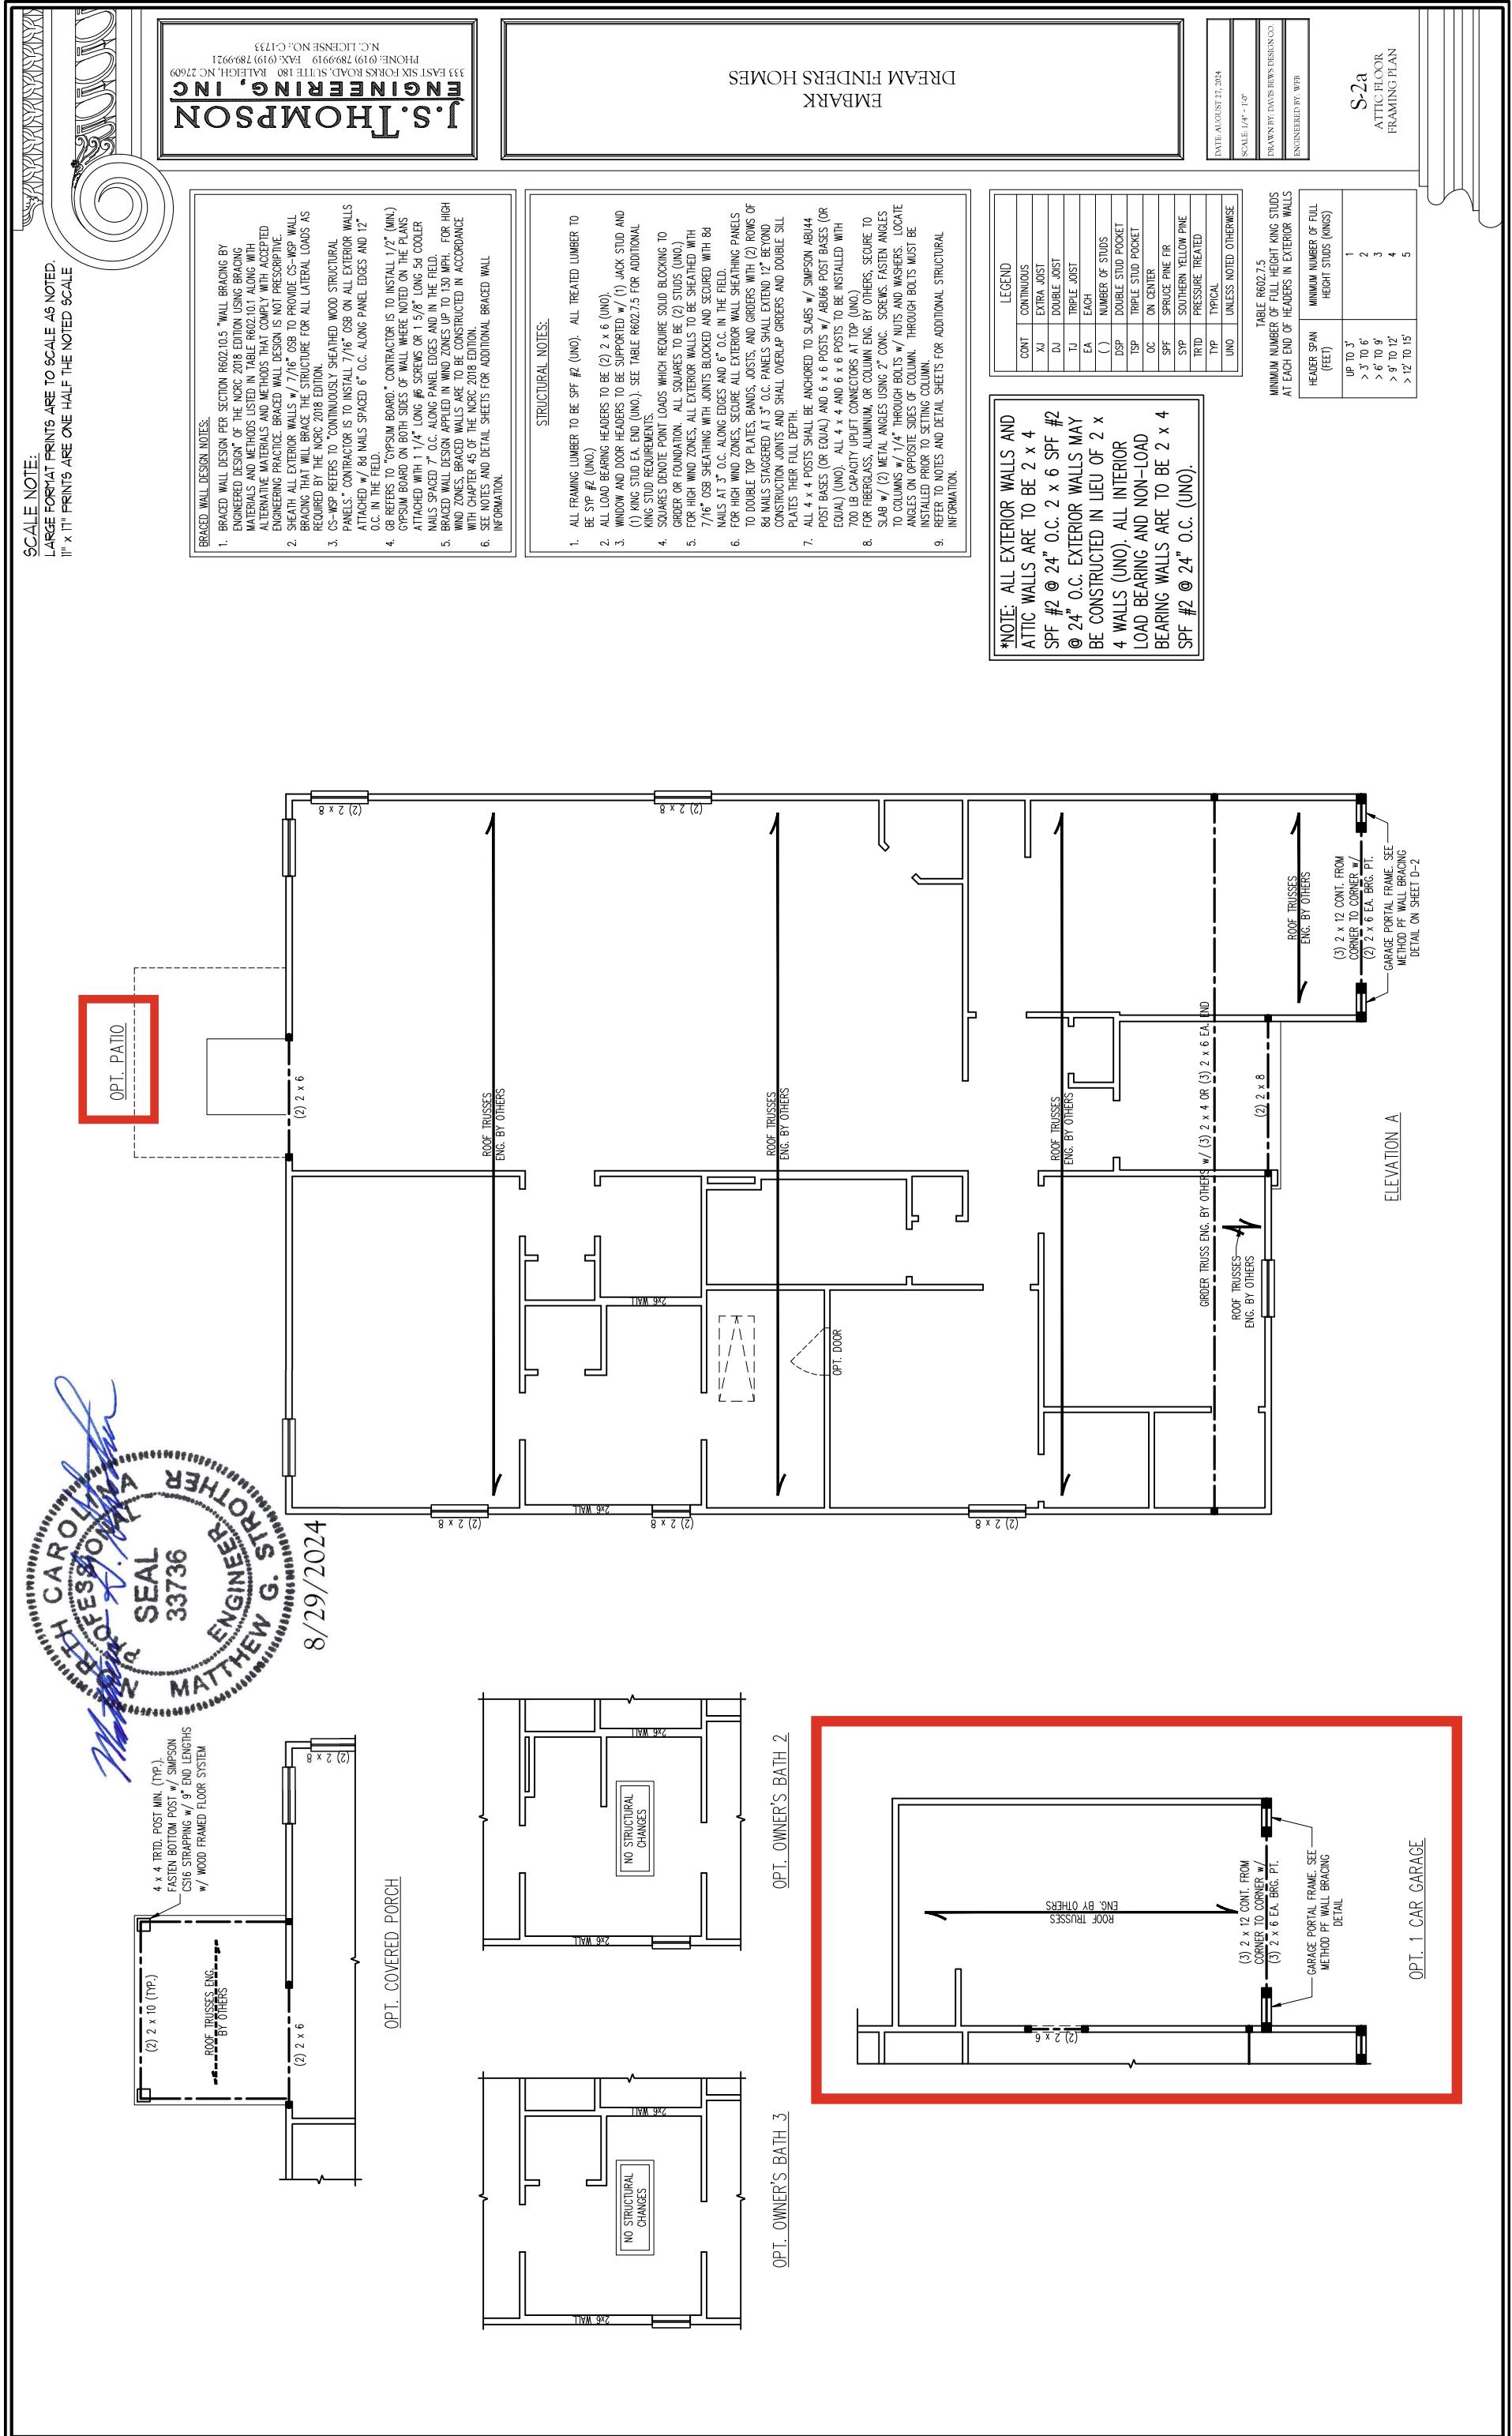

SCALE NOTE: LARGE FORMAT PRINTS ARE TO SCALE AS NOTED.
11" x 17" PRINTS ARE ONE HALF THE NOTED SCALE

OPTIONAL COVERED PORCH

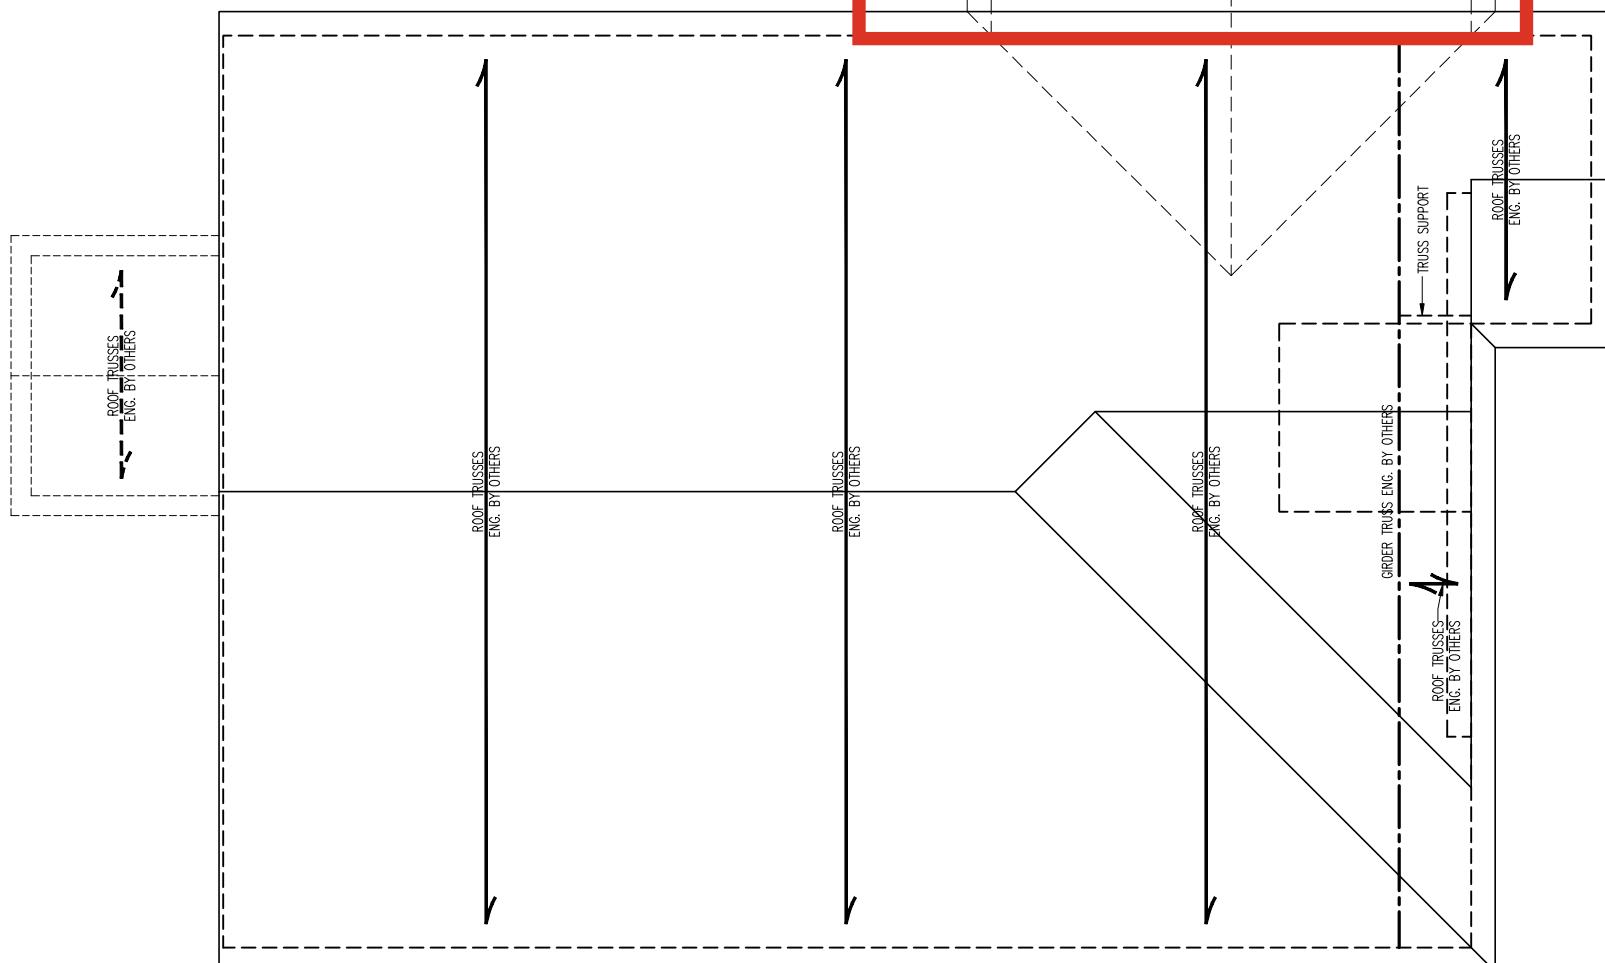

DREAM FINDERS HOMES
EMBODIANN

STRUCTURAL NOTES

- ALL FRAMING LUMBER TO BE #2 SPF (UNO).
 - CIRCLES DENOTE (3) 2 X 4 POSTS FOR ROOF SUPPORT.
 - FRAME DORMER WALLS ON TOP OF DOUBLE OR TRIPLE RAFTERS.
 - HIP SPICES ARE TO BE SPACED A MIN. OF 6'-0". FASTEN MEMBERS WITH THREE ROWS OF 12D NAILS @ 16 O.C. (TYP.).
 - STICK FRAME OVER-FRAMED ROOF SECTIONS @ 8' O.C. SPAN 2 X 6 RAFTERS @ 16' O.C. AND FLAT 2 X 10 VALLEYS OR USE VALLEY TRUSSES.
 - FASTEN FLAT VALLEYS TO RARTERS OR TRUSSES WITH SIMPSON H2.5A HURRICANE TIES @ 32" O.C. MAX. PASS HURRICANE TIES THROUGH NOTCH IN ROOF SHEATHING. EACH RAFTER IS TO BE FASTENED TO THE FLAT VALLEY WITH A MIN. OF (6) 12D TOE NAILS.
 - REFER TO SECTION R802.11 OF THE 2015 NBC FOR REQUIRED UPLIFT RESISTANCE AT RAFTERS AND TRUSSES.
 - REFER TO NOTES AND DETAIL SHEETS FOR ADDITIONAL STRUCTURAL INFORMATION.

LEGEND	
XT	EXTRA TRUSS
TS	TRUSS SUPPORT
XR	EXTRA RAFTER
RS	RAFTER SUPPORT
CONT	CONTINUOUS
EA	EACH
OC	ON CENTER
SPF	SPRUCE PINE FIR
SPP	SOUTHERN YELLOW PINE
TYP	Typical
UNO	Unless noted otherwise

DATE: AUGUST 27, 2024
SCALE: 1/4" = 1'-0"
DRAWN BY: DAVIS BEWS DES
ENGINEERED BY: WFR

DATE: AUGUST 27, 2024
SCALE: 1/4" = 1'-0"
DRAWN BY: DAVIS BEWS LTD
ENGINEERED BY: WFB

S-3a
ROOF FRAMING
PLAN

EVALUATION A

8/29/2024



MONOLITHIC SLAB DETAILS

DETAIL 1	DETAIL 2
 WALL FRAMING AND TRD. SILL PLATE PER PLAN TRD. BOTTOM PLATE SECURED BY 1/2" DIA. BOLTS. SEE CHART FOR SPACING AND EMBEDMENT REQ. 4" CONCRETE SLAB W/ FIBER REINFORCING OR WELDED WIRE FABRIC 6 MIL. VAPOR BARRIER 4" COMPACTED WELL-DRAINING SOIL OR WASHED STONE UNDISTURBED EARTH, COMPACTED FILL OR WASHED STONE TYPICAL SLAB DETAIL	 WALL FRAMING AND TRD. SILL PLATE PER PLAN TRD. BOTTOM PLATE SECURED BY 1/2" DIA. BOLTS. SEE CHART FOR SPACING AND EMBEDMENT REQ. 4" CONCRETE SLAB W/ FIBER REINFORCING OR WELDED WIRE FABRIC 6 MIL. VAPOR BARRIER 4" COMPACTED WELL-DRAINING SOIL OR WASHED STONE UNDISTURBED EARTH, COMPACTED FILL OR WASHED STONE BRICK VENEER DETAIL
DETAIL 3	DETAIL 4
 WALL FRAMING AND TRD. SILL PLATE PER PLAN TRD. BOTTOM PLATE SECURED BY 1/2" DIA. BOLTS. SEE CHART FOR SPACING AND EMBEDMENT REQ. 4" CONCRETE SLAB W/ FIBER REINFORCING OR WELDED WIRE FABRIC 6 MIL. VAPOR BARRIER 4" COMPACTED WELL-DRAINING SOIL OR WASHED STONE UNDISTURBED EARTH, COMPACTED FILL OR WASHED STONE GARAGE CURB DETAIL	 WALL FRAMING AND TRD. SILL PLATE PER PLAN TRD. BOTTOM PLATE SECURED BY 1/2" DIA. BOLTS. SEE CHART FOR SPACING AND EMBEDMENT REQ. 4" CONCRETE SLAB W/ FIBER REINFORCING OR WELDED WIRE FABRIC 6 MIL. VAPOR BARRIER 4" COMPACTED WELL-DRAINING SOIL OR WASHED STONE UNDISTURBED EARTH, COMPACTED FILL OR WASHED STONE GARAGE CURB BRICK LEDGE DETAIL
DETAIL 5	DETAIL 6
 WALL FRAMING AND TRD. SILL PLATE PER PLAN TRD. BOTTOM PLATE SECURED BY 1/2" DIA. BOLTS. SEE CHART FOR SPACING AND EMBEDMENT REQ. 4" CONCRETE SLAB W/ FIBER REINFORCING OR WELDED WIRE FABRIC 6 MIL. VAPOR BARRIER 4" COMPACTED WELL-DRAINING SOIL OR WASHED STONE UNDISTURBED EARTH, COMPACTED FILL OR WASHED STONE THICKENED SLAB DETAIL	 WALL FRAMING AND TRD. SILL PLATE PER PLAN TRD. BOTTOM PLATE SECURED BY 1/2" DIA. BOLTS. SEE CHART FOR SPACING AND EMBEDMENT REQ. 4" CONCRETE SLAB W/ FIBER REINFORCING OR WELDED WIRE FABRIC 6 MIL. VAPOR BARRIER 4" COMPACTED WELL-DRAINING SOIL OR WASHED STONE UNDISTURBED EARTH, COMPACTED FILL OR WASHED STONE STEP IN GARAGE DETAIL
DETAIL 7	DETAIL 8
 WALL FRAMING AND TRD. SILL PLATE PER PLAN TRD. BOTTOM PLATE SECURED BY 1/2" DIA. BOLTS. SEE CHART FOR SPACING AND EMBEDMENT REQ. 4" CONCRETE SLAB W/ FIBER REINFORCING OR WELDED WIRE FABRIC 6 MIL. VAPOR BARRIER 4" COMPACTED WELL-DRAINING SOIL OR WASHED STONE UNDISTURBED EARTH, COMPACTED FILL OR WASHED STONE THICKENED SLAB AT GARAGE DOOR DETAIL	 WALL FRAMING AND TRD. SILL PLATE PER PLAN TRD. BOTTOM PLATE SECURED BY 1/2" DIA. BOLTS. SEE CHART FOR SPACING AND EMBEDMENT REQ. 4" CONCRETE SLAB W/ FIBER REINFORCING OR WELDED WIRE FABRIC 6 MIL. VAPOR BARRIER 4" COMPACTED WELL-DRAINING SOIL OR WASHED STONE UNDISTURBED EARTH, COMPACTED FILL OR WASHED STONE INSIDE EDGE OF MASONRY STEMWALL BRICK MASONRY OUTSIDE EDGE OF BRICK AND STICK FRAMED WALL ABOVE NOTCH BRICK @ THREADED ROD AND GROUT SOLD THREADED ROD THROUGH BRICK MASONRY

STEMWALL DETAILS

OPTIONAL DETAIL 1	OPTIONAL DETAIL 2
 WALL FRAMING AND TRD. SILL PLATE PER PLAN TRD. BOTTOM PLATE SECURED BY 1/2" DIA. BOLTS. SEE CHART FOR SPACING AND EMBEDMENT REQ. 4" CONCRETE SLAB W/ FIBER REINFORCING OR WELDED WIRE FABRIC 6 MIL. VAPOR BARRIER 4" COMPACTED WELL-DRAINING SOIL OR WASHED STONE UNDISTURBED EARTH, COMPACTED FILL OR WASHED STONE TOP TWO COURSES OF STEM WALL AND ALL CELLS W/ REINF. TO BE GROUTED SOLD. FOR OPTIONAL STEM WALL DETAIL 16" WIDE BY 8" DEEP CONT. CONC. FIG.	 WALL FRAMING AND TRD. SILL PLATE PER PLAN TRD. BOTTOM PLATE SECURED BY 1/2" DIA. BOLTS. SEE CHART FOR SPACING AND EMBEDMENT REQ. 4" CONCRETE SLAB W/ FIBER REINFORCING OR WELDED WIRE FABRIC 6 MIL. VAPOR BARRIER 4" COMPACTED WELL-DRAINING SOIL OR WASHED STONE UNDISTURBED EARTH, COMPACTED FILL OR WASHED STONE TOP TWO COURSES OF STEM WALL AND ALL CELLS W/ REINF. TO BE GROUTED SOLD. FOR OPTIONAL STEM WALL DETAIL 16" WIDE BY 8" DEEP CONT. CONC. FIG.
DETAIL 3	DETAIL 4
 WALL FRAMING AND TRD. SILL PLATE PER PLAN TRD. BOTTOM PLATE SECURED BY 1/2" DIA. BOLTS. SEE CHART FOR SPACING AND EMBEDMENT REQ. 4" CONCRETE SLAB W/ FIBER REINFORCING OR WELDED WIRE FABRIC 6 MIL. VAPOR BARRIER 4" COMPACTED WELL-DRAINING SOIL OR WASHED STONE UNDISTURBED EARTH, COMPACTED FILL OR WASHED STONE TOP TWO COURSES OF STEM WALL AND ALL CELLS W/ REINF. TO BE GROUTED SOLD. FOR OPTIONAL STEM WALL DETAIL 16" WIDE BY 8" DEEP CONT. CONC. FIG.	 WALL FRAMING AND TRD. SILL PLATE PER PLAN TRD. BOTTOM PLATE SECURED BY 1/2" DIA. BOLTS. SEE CHART FOR SPACING AND EMBEDMENT REQ. 4" CONCRETE SLAB W/ FIBER REINFORCING OR WELDED WIRE FABRIC 6 MIL. VAPOR BARRIER 4" COMPACTED WELL-DRAINING SOIL OR WASHED STONE UNDISTURBED EARTH, COMPACTED FILL OR WASHED STONE TOP TWO COURSES OF STEM WALL AND ALL CELLS W/ REINF. TO BE GROUTED SOLD. TYPICAL STEM WALL FND. DETAIL W/ CURB @ GARAGE
DETAIL 5	DETAIL 6
 WALL FRAMING AND TRD. SILL PLATE PER PLAN TRD. BOTTOM PLATE SECURED BY 1/2" DIA. BOLTS. SEE CHART FOR SPACING AND EMBEDMENT REQ. 4" CONCRETE SLAB W/ FIBER REINFORCING OR WELDED WIRE FABRIC 6 MIL. VAPOR BARRIER 4" COMPACTED WELL-DRAINING SOIL OR WASHED STONE UNDISTURBED EARTH, COMPACTED FILL OR WASHED STONE TOP TWO COURSES OF STEM WALL AND ALL CELLS W/ REINF. TO BE GROUTED SOLD. OPTIONAL STEM WALL END. DETAIL W/ GARAGE	 WALL FRAMING AND TRD. SILL PLATE PER PLAN TRD. BOTTOM PLATE SECURED BY 1/2" DIA. BOLTS. SEE CHART FOR SPACING AND EMBEDMENT REQ. 4" CONCRETE SLAB W/ FIBER REINFORCING OR WELDED WIRE FABRIC 6 MIL. VAPOR BARRIER 4" COMPACTED WELL-DRAINING SOIL OR WASHED STONE UNDISTURBED EARTH, COMPACTED FILL OR WASHED STONE TOP TWO COURSES OF STEM WALL AND ALL CELLS W/ REINF. TO BE GROUTED SOLD. TYPICAL STEM WALL END. DETAIL W/ BRICK MASONRY
DETAIL 7	DETAIL 8
 WALL FRAMING AND TRD. SILL PLATE PER PLAN TRD. BOTTOM PLATE SECURED BY 1/2" DIA. BOLTS. SEE CHART FOR SPACING AND EMBEDMENT REQ. 4" CONCRETE SLAB W/ FIBER REINFORCING OR WELDED WIRE FABRIC 6 MIL. VAPOR BARRIER 4" COMPACTED WELL-DRAINING SOIL OR WASHED STONE UNDISTURBED EARTH, COMPACTED FILL OR WASHED STONE TOP TWO COURSES OF STEM WALL AND ALL CELLS W/ REINF. TO BE GROUTED SOLD. OPTIONAL STEM WALL END. DETAIL W/ CURB @ GARAGE	 WALL FRAMING AND TRD. SILL PLATE PER PLAN TRD. BOTTOM PLATE SECURED BY 1/2" DIA. BOLTS. SEE CHART FOR SPACING AND EMBEDMENT REQ. 4" CONCRETE SLAB W/ FIBER REINFORCING OR WELDED WIRE FABRIC 6 MIL. VAPOR BARRIER 4" COMPACTED WELL-DRAINING SOIL OR WASHED STONE UNDISTURBED EARTH, COMPACTED FILL OR WASHED STONE TOP TWO COURSES OF STEM WALL AND ALL CELLS W/ REINF. TO BE GROUTED SOLD. TYPICAL STEM WALL END. DETAIL W/ BRICK MASONRY

FOUNDATION DETAILS

OPTIONAL STEMWALL SPECIFICATIONS	MASONRY STEMWALL SPECIFICATIONS
 WALL HEIGHT (FEET) 8" CMU 4" CMU 4" BRICK AND 8" CMU MASONRY WALL TYPE 8" CMU 4" CMU 4" BRICK AND 8" CMU MASONRY WALL TYPE 2 AND BELOW 3 4 5 6 7 AND GREATER STRUCTURAL NOTES: 1. WALL HEIGHT MEASURED FROM TOP OF FOOTING TO TOP OF THE WALL. 2. THE MULTIPLE WITNESSES TOGETHER WITH LADDER WIRE AT 16" O.C. VERTICALLY. 3. CHART APPLICABLE FOR HOUSE FOUNDATION ONLY. CONSULT ENGINEER FOR DESIGN OF GARAGE FOUNDATION NOT COMMON TO HOUSE. 4. BACKFILL OF CLEAN #57 / #67 WASHED STONE IS ALLOWABLE. 5. BACKFILL OF WELL DRAINED OR SAND - GRAVEL MIXTURE SOILS (45 PSF/FT BELOW GRADE) CLASSIFIED AS GROUP 1 ACCORDING TO UNITED SOILS CLASSIFICATION SYSTEM IN ACCORDANCE WITH TABLE B405.1 OF THE 2018 INTERNATIONAL RESIDENTIAL CODE ARE ALLOWABLE. 6. PREP. SLAB PER RS06.2.1 AND RS06.2.2 BASE OF THE 2018 INTERNATIONAL RESIDENTIAL CODE. 7. MINIMUM 24" LAP SPLICE LENGTH. 8. LOCATE REBAR IN CENTER OF FOUNDATION WALL. 9. WHERE REQUIRED, FILL BLOCK SOLID REQUIRED WHEN FILLING WALLS WITH GROUT AT HEIGHTS OF 5' AND GREATER. ENGINEERED DESIGN BASED ON SITE CONDITIONS.	 WALL HEIGHT (FEET) 8" CMU 4" CMU 4" BRICK AND 8" CMU MASONRY WALL TYPE 2 AND BELOW 3 4 5 6 7 AND GREATER STRUCTURAL NOTES: 1. WALL HEIGHT MEASURED FROM TOP OF FOOTING TO TOP OF THE WALL. 2. THE MULTIPLE WITNESSES TOGETHER WITH LADDER WIRE AT 16" O.C. VERTICALLY. 3. CHART APPLICABLE FOR HOUSE FOUNDATION ONLY. CONSULT ENGINEER FOR DESIGN OF GARAGE FOUNDATION NOT COMMON TO HOUSE. 4. BACKFILL OF CLEAN #57 / #67 WASHED STONE IS ALLOWABLE. 5. BACKFILL OF WELL DRAINED OR SAND - GRAVEL MIXTURE SOILS (45 PSF/FT BELOW GRADE) CLASSIFIED AS GROUP 1 ACCORDING TO UNITED SOILS CLASSIFICATION SYSTEM IN ACCORDANCE WITH TABLE B405.1 OF THE 2018 INTERNATIONAL RESIDENTIAL CODE ARE ALLOWABLE. 6. PREP. SLAB PER RS06.2.1 AND RS06.2.2 BASE OF THE 2018 INTERNATIONAL RESIDENTIAL CODE. 7. MINIMUM 24" LAP SPLICE LENGTH. 8. LOCATE REBAR IN CENTER OF FOUNDATION WALL. 9. WHERE REQUIRED, FILL BLOCK SOLID REQUIRED WHEN FILLING WALLS WITH GROUT AT HEIGHTS OF 5' AND GREATER. ENGINEERED DESIGN BASED ON SITE CONDITIONS.
120 MPH - 130 MPH ULTIMATE DESIGN DETAILS	DREAM FINDERS HOMES
 WIND ZONE 120 MPH SPACING 6'-0" O.C. INSTALL MIN. (2) ANCHORS PER PLATE SECTION AND (1) ANCHOR WITHIN 12" OF CORNERS EMBEDMENT 7' NOTE: THREADED ROD WITH EPOXY, SIMPSON Titen HD, OR APPROVED ANCHORS SPACED AS REQUIRED TO PROVIDE EQUIVALENT ANCHORAGE TO 1/2" DIAMETER ANCHOR BOLTS MAY BE USED IN LIEU OF 1/2" ANCHOR BOLTS. DATE: NOVEMBER 28, 2022 SCALE: S1/S DRAWN BY: JST ENGINEERED BY: JST	 WIND ZONE 120 MPH SPACING 6'-0" O.C. INSTALL MIN. (2) ANCHORS PER PLATE SECTION AND (1) ANCHOR WITHIN 12" OF CORNERS EMBEDMENT 7' NOTE: THREADED ROD WITH EPOXY, SIMPSON Titen HD, OR APPROVED ANCHORS SPACED AS REQUIRED TO PROVIDE EQUIVALENT ANCHORAGE TO 1/2" DIAMETER ANCHOR BOLTS MAY BE USED IN LIEU OF 1/2" ANCHOR BOLTS. DATE: NOVEMBER 28, 2022 SCALE: S1/S DRAWN BY: JST ENGINEERED BY: JST
120 MPH - 130 MPH ULTIMATE DESIGN DETAILS	D-1
 WIND ZONE 120 MPH SPACING 6'-0" O.C. INSTALL MIN. (2) ANCHORS PER PLATE SECTION AND (1) ANCHOR WITHIN 12" OF CORNERS EMBEDMENT 7' NOTE: THREADED ROD WITH EPOXY, SIMPSON Titen HD, OR APPROVED ANCHORS SPACED AS REQUIRED TO PROVIDE EQUIVALENT ANCHORAGE TO 1/2" DIAMETER ANCHOR BOLTS MAY BE USED IN LIEU OF 1/2" ANCHOR BOLTS. DATE: NOVEMBER 28, 2022 SCALE: S1/S DRAWN BY: JST ENGINEERED BY: JST	 WIND ZONE 120 MPH SPACING 6'-0" O.C. INSTALL MIN. (2) ANCHORS PER PLATE SECTION AND (1) ANCHOR WITHIN 12" OF CORNERS EMBEDMENT 7' NOTE: THREADED ROD WITH EPOXY, SIMPSON Titen HD, OR APPROVED ANCHORS SPACED AS REQUIRED TO PROVIDE EQUIVALENT ANCHORAGE TO 1/2" DIAMETER ANCHOR BOLTS MAY BE USED IN LIEU OF 1/2" ANCHOR BOLTS. DATE: NOVEMBER 28, 2022 SCALE: S1/S DRAWN BY: JST ENGINEERED BY: JST

SEAL

**CAROLINA
PROFESSIONAL
ENGINEER
MATTHEW G. STRICKLAND
33736**

8/29/2024

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