OAK HAVEN **ABBREVIATIONS** A A PRESSURE TREATED WD H.R. HALF ROUN HS HARD SURFACE HWD HARDWOOD (FLC ILLO. N LIEU OF ISUL NSULATED(TION INT NTERIOR ITC N THE CLEAR KIT KITCHEN R&M RANGE W/MICROWAY LIV LIVING LTL LINTEL LVR LOUVER MAX MAXIMUM DRY DRYER MACHINE TEMP TEMPERED (GLASS MISC MISCELLANE MULL MULLION(ED ELEC ELECTRIC(AL U.N.O. OTHERWISE EXTERIOR OA OVERALL F.F. FINISH FLOOR (LINE OBS OBSCURE (GLA WH WATER HEATER FLR FLOOR(ING FP FIREPLACE OPT OPTIONAL WIC WALK-IN CLOSE FURRED(ING) PEDESTAL (SINK) W/ W/O WITH or WITHOUT ROHND FAIL TERPROOF(ING) CIRCUIT INTERRU

GENERAL NOTES

1 - GENERAL BUILDING & DESIGN REQUIREMENTS

1) THE ATTACHED PLANS & SPECIFICATIONS ARE THE SOLE PROPERTY OF TRI POINTE HOMES ANY UNAUTHORIZED USE OF THESE PLANS WITHOUT PRIOR WRITTEN CONSENT OF TRI POINTE HOMES IS STRICTLY

2) TRI POINTE HOMES DESIGNS & BUILDS HOUSING AS SET FORTH BY THE FORMAT AND PROVISIONS OF TH INTERNATIONAL RESIDENTIAL CODE (IRC), AND THE NATIONAL ELECTRIC CODE (NEC). ANY NON-CONFORMING DOCUMENTS DISCOVERED BY THE CONTRACTOR OR HIS AGENTS SHALL BE CALLED TO THE IMMEDIATE ATTENTION OF TRI POINTE HOMES BY CALLING (469)329-0470.

). THESE PLANS ARE SUBJECT TO MODIFICATIONS TO MEET CODE REQUIREMENTS AND/OR TO FACILITATE MECHANICAL/ ELECTRICAL/ PLUMBING INSTALLATION AND/ OR TO IMPLEMENT DESIGN IMPROVEMENTS. ANY

INTENTION TO MODIFY THESE PLANS MUST BE APPROVED IN WRITING BY TRI POINTE HOMES
4) CONTRACTOR SHALL BE RESPONSIBLE FOR VERIFYING ALL DIMENSIONS AFFECTING CONTRACTOR'S PRODUCTS, INSTALLATIONS, OR FABRICATIONS IN THE FIELD PRIOR TO EXPEDITING THE CONSTRUCTION OF SUCH WORK. FIELD VERIFY ALL DIMENSIONS — DO NOT SCALE DRAWINGS!! CONTRACTOR IS RESPONSIBLE FOR SURVEYING THE PROJECT AND BECOMING FAMILIAR WITH THE EXISTING CONDITIONS AND SCOPE OF WORK INCLUDING BUT NOT LIMITED TO SITE AND SOIL BEARING CONDITIONS.
5) ERRORS AND OMISSIONS WHICH MAY OCCUR IN THE CONTRACT DOCUMENTS SHALL BE BROUGHT TO THE

ATTENTION OF THE ARCHITECT, IN WRITING, AND WRITTEN INSTRUCTION SHALL BE OBTAINED PRIOR TO PROCEEDING WITH CONSTRUCTION. THE CONTRACTOR SHALL BE HELD RESPONSIBLE FOR ANY ERRORS, DISCREPANCIES, OR OMISSIONS FOR WHICH THE CONTRACTOR FAILED TO NOTIFY THE ARCHITECT PRIOR TO

2 - SITE CONSTRUCTION

BACK FILL SHALL BE FREE FROM VEGETATION AND CONSTRUCTION DEBRIS

) BACK FILL SHALL BE PLACED IN LIFTS AND COMPACTED IN SUCH A MANNER AS BACKFILL TO NOT DAMA THE FOUNDATION WALLS OR ANY WATERPROOFING/ DAMPPROOFING MATERIALS.

3 - CONCRETE

1) SLOPE ON GARAGE SLAB SHALL BE 1/8" PER FOOT TOWARDS VEHICLE DOOR. SLOPE ON PORCH AND

4 - MASONRY

ALL EXTERIOR BRICK MUST MEET ASTM C-216 FOR "SW" CONDITIONS

2) MASONRY VENEER SHALL BE ATTACHED TO SUPPORTING WALLS w/ CORRUGATED METAL TIES IN ACCORDANCE WITH R703.7.4.1 - I.R.C. OR LOCAL CODE REQUIREMENTS

) WEEPHOLES SHALL BE PROVIDED ALONG THE OUTSIDE WYTHE OF EXTERIOR MASONRY WALLS AT 33" O.C. MAX, SHALL BE A MIN. OF 3/16" IN DIAMETER, AND LOCATED IMMEDIATELY ABOVE THE FLASHING PER 18703.7.6 – LR.C.

5 - METALS

6 - WOOD AND PLASTICS

7 - THERMAL & MOISTURE PROTECTION

) Fire stopping and/ or draft stopping shall meet the requirements of IRC R602.8. 2) Attic ventilation shall be provided at 1/300 th of the Area of the Space ventilated. Cross VENTILATION WITH HALF OF THE VENTILATED AREA SHALL BE PROVIDED BY ROOF VENTS AND THE OTHER HALF BY SOFFIT VENTS. VENTS SHALL BE PLACED SO AS TO NOT ALLOW INFILTRATION OF RAIN OR SNOW. S) PROVIDE APPROVED TILE BACKER DRYWALL FOR ALL SHOWER AND BATH SPACE) PROVIDE ATTIC VENTILATION PER IRC-R806.1

8 - DOORS AND WINDOWS

-) REVIEW ALL WINDOW HDR HEIGHTS PER PLATE HT. AND VERIFY W/ ELEVATIONS AND CORNICE DETAILS TEMPERED GLASS SHALL BE USED IN HAZARDOUS AREAS AS DESCRIBED IN SECTION R308.4 - LR.C.
- FRONT DOOR WIDTH PER IRC-R311.3
- GARAGE DOOR PER IRC-R309.1

FMERGENCY EGRESS SHALL MEET REQUIREMENTS OF SECTION R310 - LR C 2018 - SLEEPING ROOMS HALL HAVE AT LEAST ONE EGRESS OPENING OF NOT LESS THAN 5.7 SF AND A CLEAR OPENING OF NOT IFSS THAN 20" WIDE X 24" HIGH AND SHALL NOT BE MORE THAN 44" ABOVE THE FLOOR

15 - MECHANICALS

WOOD BUILT CHIMNEYS AND FIREPLACES SHALL BE INSTALLED PER MANUFACTURER'S INSTRUCTIONS AND RE SUBJECT TO MECHANICAL INSPECTION PER IRC SECTION R1002.1) EXTERIOR AIR INTAKE FOR COMBUSTION AIR PER IRC SECTION AS REQUIRED BY LOCAL MUNICIPALITY

16 - ELECTRICAL

ALL FLECTRICAL INSTALLATION SHALL MEET THE REQUIREMENTS OF THE NATIONAL ELECTRIC CODE (NEC). MATERIAL AND EQUIPMENT SHALL BEAR THE LABEL OF APPROVAL OF THE UNDERWRITERS ABORATORIES, INC.

) ELECTRICAL CONTRACTOR SHALL VERIFY SPACE REQUIRED FOR METER INSTALLATION BEFORE ONSTRUCTION AND SHALL NOTIFY GENERAL CONTRACTOR OF ANY DISCREPANCIES.

VERIFY LOCATION OF ALL RECEPTACLES FOR APPLIANCES WITH MANUFACTURER SPECIFICATIONS.

GROUND FAULT INTERRUPTS SHALL BE LOCATED PER THE NEC

ALL SWITCHES SHALL BE INSTALLED AT 3'-6" ABOVE FINISHED FLOOR TO CENTERLINE OF SWITCH VLESS NOTED OTHERWISE

) ALL CONVENIENCE OUTLETS SHALL BE INSTALLED W/ CENTERLINE OF OUTLET LOCATED 1'-3" ABOVE INISHED FLOOR UNLESS NOTED OTHERWISE

ALL CONVENIENCE OUTLETS WITH SWITCHES TO BE SWITCH AT TOP ONLY.

ALL EXTERIOR WALL BRACKET FIXTURES SHALL BE INSTALLED AS NOTED ON PLANS.

APPROVED SMOKE DETECTORS SHALL BE LOCATED ON EVERY STORY OF THE DWELLING UNIT AS PER IRC ECTION R317 (SEE SHEET B1.1 FOR LOCATIONS). WHERE MORE THAN ONE DETECTOR IS REQUIRED THEY SHALL BE INTERCONNECTED. POWER SOURCE SHALL BE BUILDING POWER w/ BATTERY BACKUP.)) CONDUCTORS SHALL BE OF COPPER.

GENERAL FRAMING SPECS AND CONSTRUCTION NOTES STAIRS:

1) THE MAXIMUM RISER HEIGHT SHALL BE 7 3/4 INCHES AND THE MINIMUM TREAD DEPTH SHALL BE 10 CHES IN ACCORDANCE WITH SECTION I.R.C.

HANDRAILS HAVING MINIMUM AND MAXIMUM HEIGHTS OF 34 INCHES AND 38 INCHES SHALL BE OVIDED ON AT LEAST. ONE SIDE OF STAIRWAYS IN ACCORDANCE WITH SECTION R315.1 — I.R.C HANDRAIL AND BALUSTRADE (WHERE PRESENT) SHALL BE CONSTRUCTED. ACCORDING TO IRC. ALL REQUIRED HAND RAILS SHALL BE CONTINUOUS THE FULL LENGTH OF THE STAIRS W/ 2 OR MORE SERS FROM A POINT ABOVE THE THE TOP RISER OF A FLIGHT TO A POINT ABOVE THE LÓWEST RISER OF THE FLIGHT. ENDS SHALL BE RETURNED OR SHALL TERMINATE AT NEWEL POSTS OR SAFETY TERMINALS. ANDRAILS ADJACENT TO A WALL SHALL HAVE A SPACE OF NOT LESS THAN 1.5" BETWEEN THE WALL

WALLS:

) ALL DIMENSIONS ARE FROM FACE OF STUD TO FACE OF STUD. ALL STUDS ARE 3 1/2" UNLESS NOTED. ALL DIMENSIONS PRESENTED HERE ARE FRAME DIMENSIONS ONLY.

I SEPARATION BETWEEN THE RESIDENCE AND THE GARAGE SHALL BE MAINTAINED BY INSTALLATION OF $rac{1}{2}"$ GYPSUM BOARD ON ALL COMMON WALLS. 2-STORY HOMES REQUIRE 5/8" TYPE X GYPSUM BOARD AT CARAGE CEILINGS WHERE HABITABLE ROOMS ARE PRESENT ABOVE.

FLOORS:

STRUCTURAL FLOOR MEMBERS SHALL NOT BE CUT, BORED, OR NOTCHED IN EXCESS OF THE LIMITATIONS ECIFIED IN IRC

) THE ENDS OF EACH JOIST, BEAM, OR GIRDER SHALL HAVE NOT LESS THAN 1.5 INCHES OF BEARING ON WOOD OR METAL AND NOT LESS THAN 3 INCHES ON MASONRY OR CONCRETE OR AS OTHERWISE SPECIFIED

) ALL DIMENSIONAL FLOOR JOISTS TO BE PER ENGINEER STRUCTURAL PLANS.

FRAMING:

ALL FRAMING DIMENSIONS TO FACE OF MEMBER.

ALL BEARING HEADERS TO BE PER ENGINEERING PLANS. FIRE STOPPING AND / OR DRAFT STOPPING SHALL MEET THE REQUIREMENTS OF IRC R602.8.

ROOF

HIP AND VALLEY RAFTERS SHALL BE SUPPORTED AT RIDGE DOWN TO BEARING PARTITION. CUT ENDS OF AFTERS SHALL BE FULLY SUPPORTED WALL AND RIDGE

REQUIRED VENTILATION AREAS CALCULATED AT 1/300 RATIO

SQUARE FOOTAGE Elevation "C"

(Slab S.F.) VERED OUTDOOR LIVING

(Outside of Frame S.F.)

A/C Area	Sq. Ft.
FIRST FLOOR	1674
Total A/C Area	1674
Non-A/C Area	Sq. Ft.
2 BAY GARAGE	405
PORCH	33
COVERED OUTDOOR LIVING	162
Total Non-A/C Area	600

(Inside of Frame S.F.)

A/C Area	Sq. Ft.
FIRST FLOOR	1625
Total A/C Area	1625

NOTE: ALL OPTIONAL SQUARE FOOTAGES LISTED ARE INDEPENDENT OF AND IN ADDITION TO BASE SQUARE FOOTAGES

OPTIONS

BUILDING CODE COMPLIANCE

ELECTRICAL PLANS DESIGNED TO MEET OR EXCEED MINIMUM

CONSTRUCTION PLANS DESIGNED TO MEET OR EXCEED

MINIMUM CODE REQUIREMENTS OF 2018 LR C

EXT. COV. OUTDOOR LIVING +114

TABLE OF CONTENTS

"G0.01" COVER SHEET & GEN. NOTES "G0.11" REVISIONS & SYMBOLS "S1.10C" BASE FOUNDATION PLAN - ELEVATION 'C' "A1.10C" FIRST FLOOR PLAN - ELEVATION 'C' "O1.A1O" FLOOR PLAN OPTIONS "A2.01C" EXTERIOR ELEVATIONS - 'C' "A2.02C" EXTERIOR ELEVATIONS - 'C' "A2.03C" EXTERIOR ELEVATIONS - OPTIONS - 'C' "A2.04C" EXTERIOR ELEVATIONS - OPTIONS - 'C' "A3.01C" ROOF PLAN - ELEVATION 'C' "A3.01C" ROOF PLAN - DPTION - ELEVATION 'C' "A4.01" INTERIOR DETAIL SHEET "E1.10C" 1ST FLR. ELECTRICAL PLAN UPGRADE OPTIONS - ELEVATION 'C' "O1.E10" 1ST FLR. ELECTRICAL PLAN OPTIONS "01.E11" 1ST FLR. ELECTRICAL PLAN OPTIONS	SHEET NO.	TYPE OF SHEET/LAYOUT
"S1.10C" BASE FOUNDATION PLAN - ELEVATION 'C' "A1.10C" FIRST FLOOR PLAN - ELEVATION 'C' "O1.A1O" FLOOR PLAN OPTIONS "A2.01C" EXTERIOR ELEVATIONS - 'C' "A2.02C" EXTERIOR ELEVATIONS - 'C' "A2.03C" EXTERIOR ELEVATIONS - OPTIONS - 'C' "A2.04C" EXTERIOR ELEVATIONS - OPTIONS - 'C' "A3.01C" ROOF PLAN - ELEVATION 'C' "A3.02C" ROOF PLAN - OPTION - ELEVATION 'C' "A4.01" INTERIOR DETAIL SHEET "E1.10C" 1ST FLR. ELECTRICAL PLAN UPGRADE OPTIONS - ELEVATION 'C' "01.E10" 1ST FLR. ELECTRICAL PLAN OPTIONS	"G0.01"	COVER SHEET & GEN. NOTES
"A1.10C" FIRST FLOOR PLAN — ELEVATION 'C' "01.A1O" FLOOR PLAN OPTIONS "A2.01C" EXTERIOR ELEVATIONS — 'C' "A2.02C" EXTERIOR ELEVATIONS — 'C' "A2.03C" EXTERIOR ELEVATIONS — OPTIONS — 'C' "A2.04C" EXTERIOR ELEVATIONS — OPTIONS — 'C' "A3.01C" ROOF PLAN — ELEVATION 'C' "A3.02C" ROOF PLAN — OPTION — ELEVATION 'C' "A4.01" INTERIOR DETAIL SHEET "E1.10C" 1ST FLR. ELECTRICAL PLAN — ELEVATION 'C' "E1.11C" 1ST FLR. ELECTRICAL PLAN UPGRADE OPTIONS — ELEVATION 'C' "01.E10" 1ST FLR. ELECTRICAL PLAN OPTIONS	"G0.11"	REVISIONS & SYMBOLS
"01.A10" FLOOR PLAN OPTIONS "A2.01C" EXTERIOR ELEVATIONS - 'C' "A2.02C" EXTERIOR ELEVATIONS - 'C' "A2.03C" EXTERIOR ELEVATIONS - OPTIONS - 'C' "A2.04C" EXTERIOR ELEVATIONS - OPTIONS - 'C' "A3.01C" ROOF PLAN - ELEVATION 'C' "A3.02C" ROOF PLAN - OPTION - ELEVATION 'C' "A4.01" INTERIOR DETAIL SHEET "E1.10C" 1ST FLR. ELECTRICAL PLAN - ELEVATION 'C' "E1.11C" 1ST FLR. ELECTRICAL PLAN UPGRADE OPTIONS - ELEVATION 'C' "01.E10" 1ST FLR. ELECTRICAL PLAN OPTIONS	"S1.10C"	BASE FOUNDATION PLAN — ELEVATION 'C'
"A2.01C" EXTERIOR ELEVATIONS - 'C' "A2.02C" EXTERIOR ELEVATIONS - 'C' "A2.03C" EXTERIOR ELEVATIONS - OPTIONS - 'C' "A2.04C" EXTERIOR ELEVATIONS - OPTIONS - 'C' "A3.01C" ROOF PLAN - ELEVATION 'C' "A3.02C" ROOF PLAN - OPTION - ELEVATION 'C' "A4.01" INTERIOR DETAIL SHEET "E1.10C" 1ST FLR. ELECTRICAL PLAN - ELEVATION 'C' "E1.11C" 1ST FLR. ELECTRICAL PLAN UPGRADE OPTIONS - ELEVATION 'C' "01.E10" 1ST FLR. ELECTRICAL PLAN OPTIONS	"A1.10C"	FIRST FLOOR PLAN - ELEVATION 'C'
"A2.02C" EXTERIOR ELEVATIONS - 'C' "A2.03C" EXTERIOR ELEVATIONS - OPTIONS - 'C' "A2.04C" EXTERIOR ELEVATIONS - OPTIONS - 'C' "A3.01C" ROOF PLAN - ELEVATION 'C' "A3.02C" ROOF PLAN - OPTION - ELEVATION 'C' "A4.01" INTERIOR DETAIL SHEET "E1.10C" 1ST FLR. ELECTRICAL PLAN - ELEVATION 'C' "E1.11C" 1ST FLR. ELECTRICAL PLAN UPGRADE OPTIONS - ELEVATION 'C' "01.E10" 1ST FLR. ELECTRICAL PLAN OPTIONS	"01.A10"	FLOOR PLAN OPTIONS
"A2.03C" EXTERIOR ELEVATIONS — OPTIONS — 'C' "A2.04C" EXTERIOR ELEVATIONS — OPTIONS — 'C' "A3.01C" ROOF PLAN — ELEVATION 'C' "A3.02C" ROOF PLAN — OPTION — ELEVATION 'C' "A4.01" INTERIOR DETAIL SHEET "E1.10C" 1ST FLR. ELECTRICAL PLAN — ELEVATION 'C' "E1.11C" 1ST FLR. ELECTRICAL PLAN UPGRADE OPTIONS — ELEVATION 'C' "01.E10" 1ST FLR. ELECTRICAL PLAN OPTIONS	"A2.01C"	EXTERIOR ELEVATIONS - 'C'
"A2.04C" EXTERIOR ELEVATIONS — OPTIONS — 'C' "A3.01C" ROOF PLAN — ELEVATION 'C' "A3.02C" ROOF PLAN — OPTION — ELEVATION 'C' "A4.01" INTERIOR DETAIL SHEET "E1.10C" 1ST FLR. ELECTRICAL PLAN — ELEVATION 'C' "E1.11C" 1ST FLR. ELECTRICAL PLAN UPGRADE OPTIONS — ELEVATION 'C' "01.E10" 1ST FLR. ELECTRICAL PLAN OPTIONS	"A2.02C"	EXTERIOR ELEVATIONS - 'C'
"A3.01C" ROOF PLAN - ELEVATION 'C' "A3.02C" ROOF PLAN - OPTION - ELEVATION 'C' "A4.01" INTERIOR DETAIL SHEET "E1.10C" 1ST FLR. ELECTRICAL PLAN - ELEVATION 'C' "E1.11C" 1ST FLR. ELECTRICAL PLAN UPGRADE OPTIONS - ELEVATION 'C' "01.E10" 1ST FLR. ELECTRICAL PLAN OPTIONS	"A2.03C"	EXTERIOR ELEVATIONS - OPTIONS - 'C'
"A3.02C" ROOF PLAN - OPTION - ELEVATION 'C' "A4.01" INTERIOR DETAIL SHEET "E1.10C" 1ST FLR. ELECTRICAL PLAN - ELEVATION 'C' "E1.11C" 1ST FLR. ELECTRICAL PLAN UPGRADE OPTIONS - ELEVATION 'C' "01.E10" 1ST FLR. ELECTRICAL PLAN OPTIONS	"A2.04C"	EXTERIOR ELEVATIONS - OPTIONS - 'C'
"A4.01" INTERIOR DETAIL SHEET "E1.10C" 1ST FLR. ELECTRICAL PLAN – ELEVATION 'C' "E1.11C" 1ST FLR. ELECTRICAL PLAN UPGRADE OPTIONS – ELEVATION 'C' "01.E10" 1ST FLR. ELECTRICAL PLAN OPTIONS	"A3.01C"	ROOF PLAN - ELEVATION 'C'
"E1.10C" 1ST FLR. ELECTRICAL PLAN — ELEVATION 'C' "E1.11C" 1ST FLR. ELECTRICAL PLAN UPGRADE OPTIONS — ELEVATION 'C' "01.E10" 1ST FLR. ELECTRICAL PLAN OPTIONS	"A3.02C"	ROOF PLAN - OPTION - ELEVATION 'C'
"E1.11C" 1ST FLR. ELECTRICAL PLAN UPGRADE OPTIONS – ELEVATION 'C' "01.E10" 1ST FLR. ELECTRICAL PLAN OPTIONS	"A4.01"	INTERIOR DETAIL SHEET
"01.E10" 1ST FLR. ELECTRICAL PLAN OPTIONS	"E1.10C"	1ST FLR. ELECTRICAL PLAN — ELEVATION 'C'
	"E1.11C"	1ST FLR. ELECTRICAL PLAN UPGRADE OPTIONS - ELEVATION 'C'
"01.E11" 1ST FLR. ELECTRICAL PLAN UPGRADE OPTIONS	"01.E10"	1ST FLR. ELECTRICAL PLAN OPTIONS
	"01.E11"	1ST FLR. ELECTRICAL PLAN UPGRADE OPTIONS

Altis at Serenity - Lot 289 - 5919-03 (Oak Haven) -**Elevation C**

*Gourmet Kitchen 1

*Fireplace at Great Room

*Office ILO Flex Space

*Primary Bath 1

*Tray Ceiling


*Screened Outdoor Living

*Tile walls at Secondary Bath

SYMBOLS

++

SHOWER CONTROLS

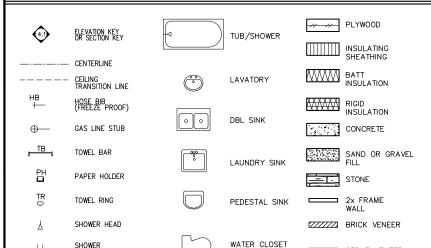

DointeHOMES

Blvd Business Operation 5440 Wade Park Blv Suite 400 Raleigh, NC 27607

Crossin GENERAL Serei Ser at ૹ

SUBDIVISION: ADDRESS: LOT:

SHE

10-01-24 Issue Date: ACC

5919-03

OAK HAVEN

G0.01

STONE VENEER

REVISION INDEX				
REL. # DESCRIPTION DATE DRAWN BY				
5919-03	NEW PLAN	10/01/2024	ACC	
	ADDED ATTIC PULL-DOWN, REVISED ROD/SHELF IN PRIMARY M.C. ADDED OPTIONS - SCREENED COVERED OUTDOOR LIVING, COURMET KITCHEN KITCHEN, ZERO ENTRY SHOWER AT PRIMARY BATH, ADDED TRIM SURROUNDING VENTS AT VARIOUS ELEVATIONS, REVISED BENCH DETAIL, ADDED OPT. LAUNDRY CABINITS, ADDED (2) 4-LED LIGHTS IN GARAGE, REVISED ELECT LIGHTING AND SWITCHES IN PRIMARY BATH, ADDED DISHWASHER ACCESSIBLE DISCONNECT SWITCH AND COUNTER-TOP AIR SWITCH FOR DISPOSAL NOTES	01/19/2025	ACC	
	ADDED SHOWER NICHE NOTE, ADDED CURB TO SHOWERS, REVISED INT/EXT FIREPLACE DEPTHS, REVISED OPENING HEADER HEIGHTS THROUGHOUT, REVISED REAR EXTERIOR DOOR TO 3', ADDED DOOR HEIGHTS TO MAIN FLOOR NOTES, ADDED BATH ACCESSORY HEIGHTS TO MAIN FLOOR NOTES, ADDED ZERO ENTRY SHOWER DETAIL, REMOVED PRIMARY BATH 2 OPTION, ADDED OUTDOOR LIVING PATIO OPTION, ADDED PARTIAL SHOWER NICHE DETAIL, ADDED GOURMET KITCHEN INTERIOR, REVISED ELECTRICAL / ELECTRICAL OPTION AT OREAT ROOM AND PRIMARY BATH.	04/13/2025	ACC	
	DEFINE, RUDED COORDILLY INTO HER INTERIOR, RETURN ELECTRICAL OF HOR AT ORDER ROOM AND FRAMENT DATE.			

·		

tri pointe.

HOMES

5440 WADE PARK BLVD, SUITE 400, RALEIGH, NG 27607

Business Operations 5440 Wade Park Blvd Suite 400 Raleigh, NC 27607

SUBDIVISION: Lot 289
ADDRESS: Alis at Serenity
LOT: BLOCK:


Issue Date: 10-01-24

Drawn By: ACC

5919-03

OAK HAVEN

G0.11

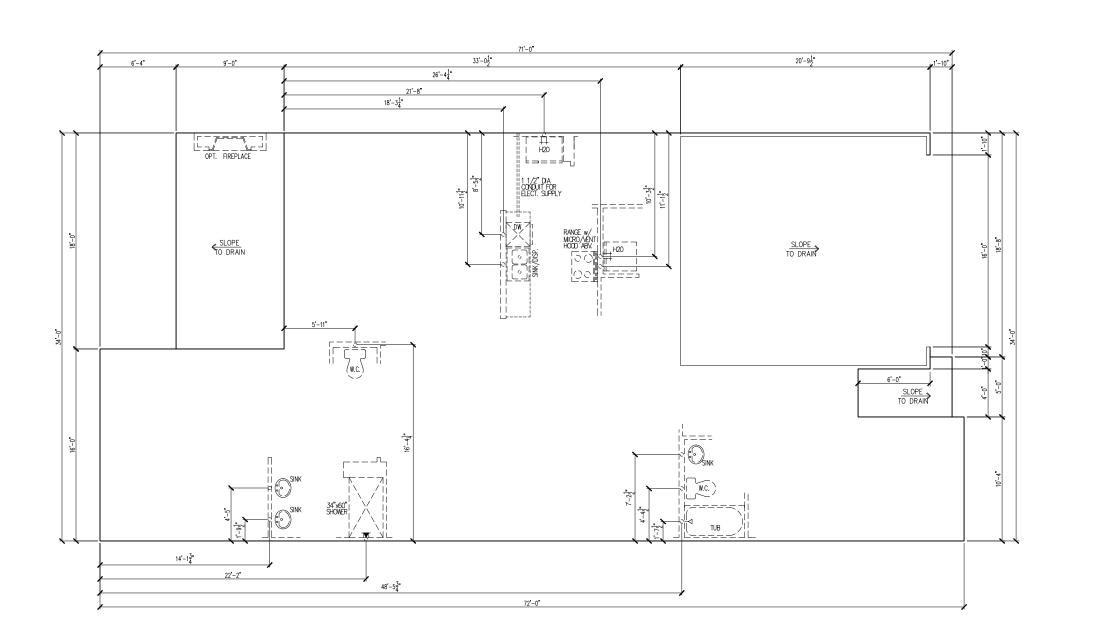

tribointe.

HOMES

5440 WADE PARK BLYD, SUITE 400, RALFIGH, NG 27807

Business Operations 5440 Wade Park Blvd Suite 400 Raleigh, NC 27607

SUBDIVISION: Lot 289
ADDRESS: 160 Serene Crossing Altis at Serenity LOT: BLOCK: BASE FOUNDATION PLAN

Issue Date: 10-01-24

Drawn By: ACC

5919-03

OAK HAVEN

SHEET#: S1.10C

MAIN FLOOR NOTES


EXPLANATION

- 1. ALL NON-DIMENSIONED PARTITIONS ARE 3-1/2" ROUGH
- 2. ALL ANGLED PARTITIONS ARE 45 DEGREES UNLESS NOTED
- PROVIDE MIN. 2-2x12's w/ 1/2" PLYWD. FLITCH PLATE AT ALL EXTERIOR WALL OPENINGS & INTERIOR BEARING WALL OPENINGS
- 4. ALL EXTERIOR DIM'S ARE TO FACE OF STUDS U.N.O.
- 5. ALL TRUSSES TO BEAR ON EXTERIOR WALLS AND/OR GIRDER TRUSS U.N.O.
- 6. TRUSS MFG. TO SIZE MEMBERS, FASTENERS, HANGERS & SET SPACING FOR ALL TRUSSES
- WINDOW SUPPLIER TO VERIFY AT LEAST ONE WINDOW IN ALL BEDROOMS TO HAVE A CLEAR EGRESS OPENING OF 5.7 SQ. FT.

 W/MIN DIM's OF 24" IN HT AND 20" IN WIDTH; SILL HT NOT TO EXCEED 44" AFF
- 8. ALL BALUSTER TO BE SPACED SUCH THAT A 4" SPHERE CANNOT PASS BETWEEN BALUSTER
- 9. RELOCATION DUE TO FIELD CONDITIONS; CONTRACTOR TO
- 10. FOR ADDITIONAL NOTES, SEE GENERAL NOTES ON TITLE SHEET
- 11. ALL TYP. WINDOWS 6'-0" IN HT AND SMALLER, THE HEAD HEIGHT SHALL BE 8'-10" ABOVE FINISHED FLOOR (U.N.O.)
- 12. STRUCTURAL ENGINEERING PROVIDED BY OTHERS
- 13. REFER TO INTERIOR ELEVATIONS SHEET TO WEW BUBBLE
- 13. CALLOUTS
- 14. INTERIOR DOOR HEIGHTS ARE AS FOLLOWS PRIMARY SUITE, PRIMARY BATH, & PRIMARY CLOSET ARE 8' TALL DOORS. ALL OTHER DOORS ARE 6'-8"
- BATH ACCESSORY INSTALLATION HEIGHTS ARE MEASURED TO CENTER OF ACCESSORY:
- 15. CENTER OF ACCESSORY: TB - 48" A.F.F. TR - 20" ABV. VANITY COUNTER-TOP
- 16. SHUT-OFF VALVE TO BE LOCATED IN GARAGE

1st Floor Options:

- *Gourmet Kitchen 1
- *Fireplace at Great Room
- *Office ILO Flex Space
- *Tile walls at Secondary Bath
- *Primary Bath 1
- *Tray Ceiling
- *Screened Outdoor Living

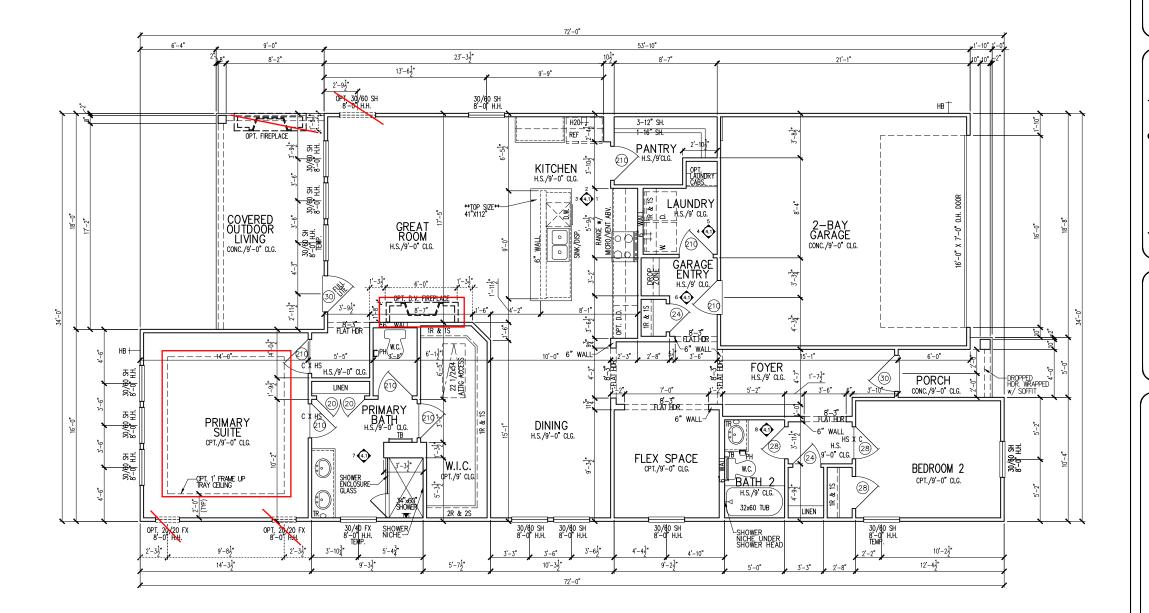

tripointe.

HOMES

S40 WAE PARK BLYD, SUITE 400, RALEIGH, NC 27607

Business Operations 5440 Wade Park Blvd Suite 400 Raleigh, NC 27607


SUBDIVISION: Lot 289
ADDRESS: Altis at Serenity
LOT: BLOCK:


Issue Date: 10-01-24
Drawn By: ACC


5919-03


OAK HAVEN

A1.10

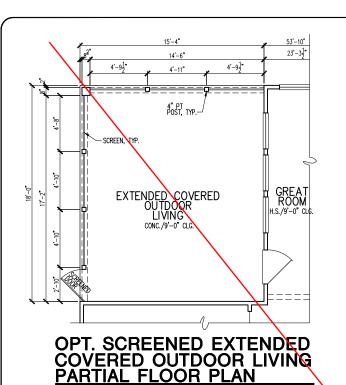

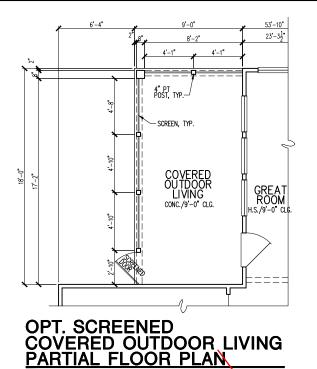

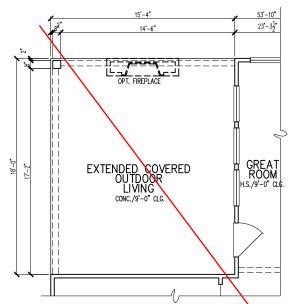

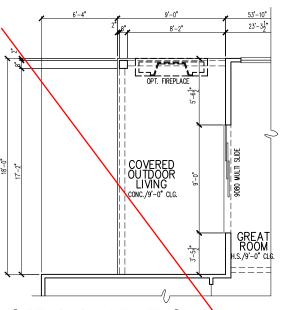


OPT. EXTENDED COVERED OUTDOOR LIVING PARTIAL FLOOR PLAN


OPT. 9080 MULTI SLIDE DOOR AT GREAT RROM PARTIAL FLOOR PLAN



OPT. GOURMET KITCHEN 1 PARTIAL FLOOR PLAN

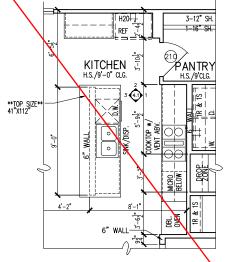



OPT. GOURMET KITCHEN 2
PARTIAL FLOOR PLAN

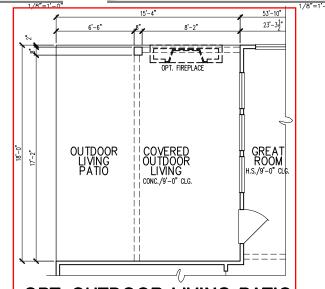

OPT. OUTDOOR LIVING PATIO PARTIAL FLOOR PLAN



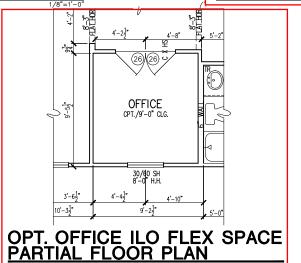

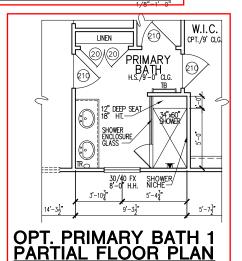

Dointe HOMES

Business Operations 5440 Wade Park Blvd Suite 400 Raleigh, NC 27607

Crossing OPTIONS 289) Serene Cros s at Serenity PLAN FLOOR

SUBDIVISION: ADDRESS: LOT:

10-01-24 ssue Date: ACC

5919-03

OAK HAVEN

01.A10

MAIN FLOOR NOTES

EXPLANATION

ALL NON-DIMENSIONED PARTITIONS ARE 3-1/2" ROUGH

ALL ANGLED PARTITIONS ARE 45 DEGREES UNLESS NOTE OTHERWISE (U.N.O.)

PROVIDE MIN. 2-2x12's w/ 1/2" PLYWD. FLITCH PLATE AT ALL EXTERIOR WALL OPENINGS & INTERIOR BEARING WALL OPENINGS

ALL EXTERIOR DIM'S ARE TO FACE OF STUDS U.N.O.

ALL TRUSSES TO BEAR ON EXTERIOR WALLS AND/OR GIRDER

TRUSS MFG. TO SIZE MEMBERS, FASTENERS, HANGERS & SET SPACING FOR ALL TRUSSES WINDOW SUPPLIER TO VERIFY AT LEAST ONE WINDOW IN ALL BEDROOMS TO HAVE A CLEAR EGRESS OPENING OF 5.7 SQ. FT. w/MIN DIM'S OF 24" IN HT AND 20" IN WIDTH; SILL HT NOT TO

ALL BALUSTER TO BE SPACED SUCH THAT A 4" SPHERE CANNO

PASS BETWEEN BALUSTER ALL ELEC. & MECH. EQUIPMENT & METERS ARE SUBJECT TO RELOCATION DUE TO FIELD CONDITIONS; CONTRACTOR TO

FOR ADDITIONAL NOTES, SEE GENERAL NOTES ON TITLE SHEET

SHALL BE 8'-10" ABOVE FINISHED FLOOR (U.N.O.)

STRUCTURAL ENGINEERING PROVIDED BY OTHERS


REFER TO INTERIOR ELEVATIONS SHEET TO VIEW BUBBLE

INTERIOR DOOR HEIGHTS ARE AS FOLLOWS - PRIMARY SUITE, PRIMARY BATH, & PRIMARY CLOSET ARE 8' TALL DOORS. ALL OTHER DOORS ARE 6'-8"


BATH ACCESSORY INSTALLATION HEIGHTS ARE MEASURED TO CENTER OF ACCESSORY

TH - 70" A.F.F


SHUT-OFF VALVE TO BE LOCATED IN GARAGE

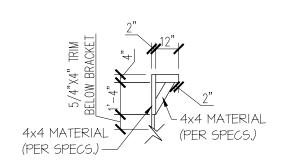

BRACKET DETAIL

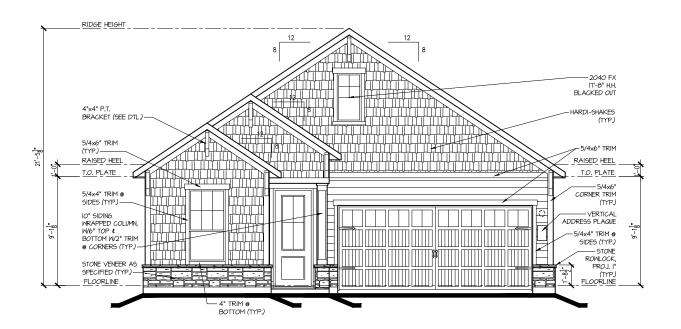

FRONT ELEV. "C"

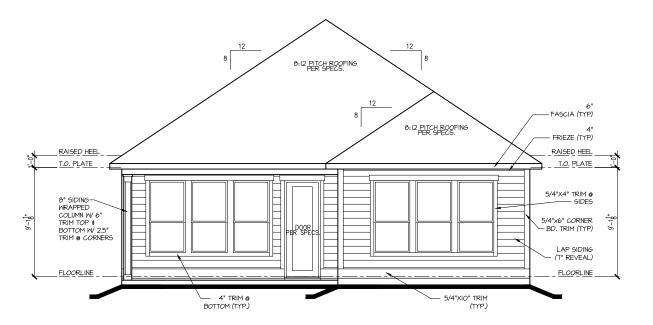

REAR ELEV. "C"

1/8"=1'-0"

tri pointe.

HOMES

540 WADE PARK BLYD, SUITE 400, RALEIGH, NG 27607

Business Operations 5440 Wade Park Blvd Suite 400 Raleigh, NC 27607

EXTERIOR ELEVATIONS
TISION: Lot 289
TS: 160 Serene Crossing
Altis at Serenity
BLOCK:


SUBDIVISION:
ADDRESS:
LOT:
BLC


Drawn By: ACC

5919-03

OAK HAVEN

A2.01C

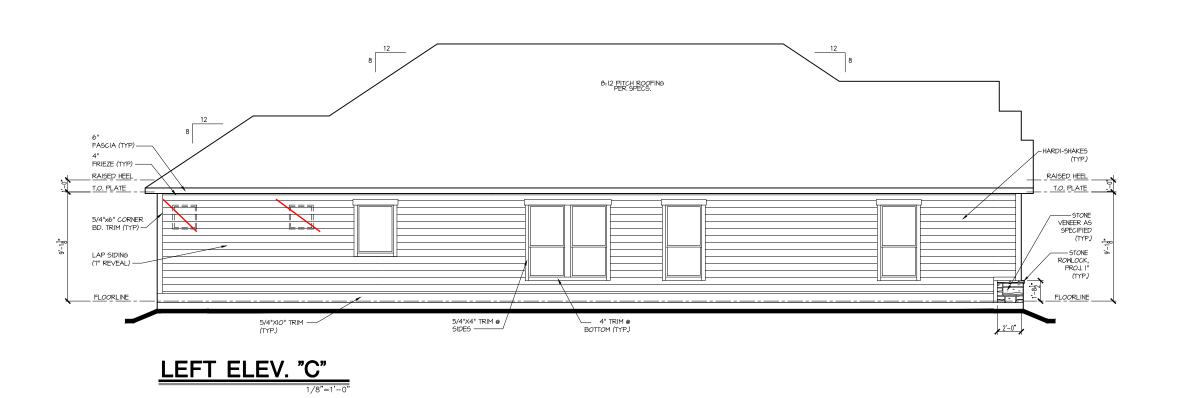

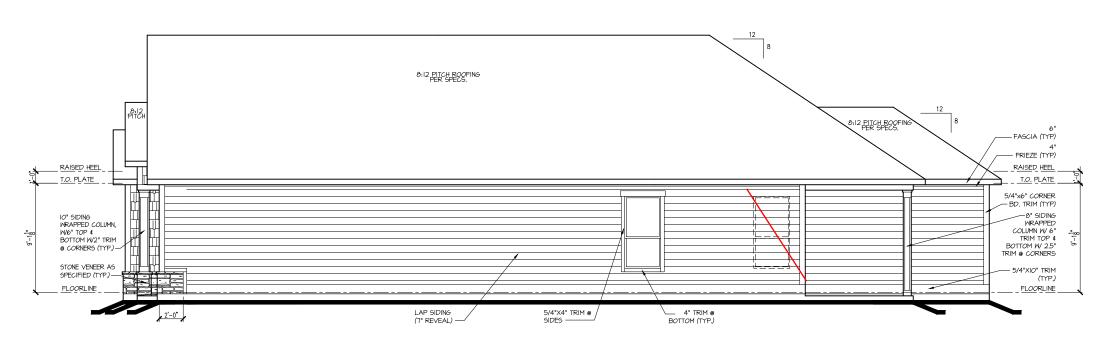

RIGHT ELEV. "C"

tri pointe HOMES 540 WADE PARK BLVD, SUITE 400, RALEIGH, NG 22607

Business Operations 5440 Wade Park Blvd Suite 400 Raleigh, NC 27607


SUBDIVISION: Lot 289
ADDRESS: Altis at Serenity
LOT: BLOCK:

Issue Date: 10-01-24
Drawn By: ACC

5919-03

OAK HAVEN

(A2.02C

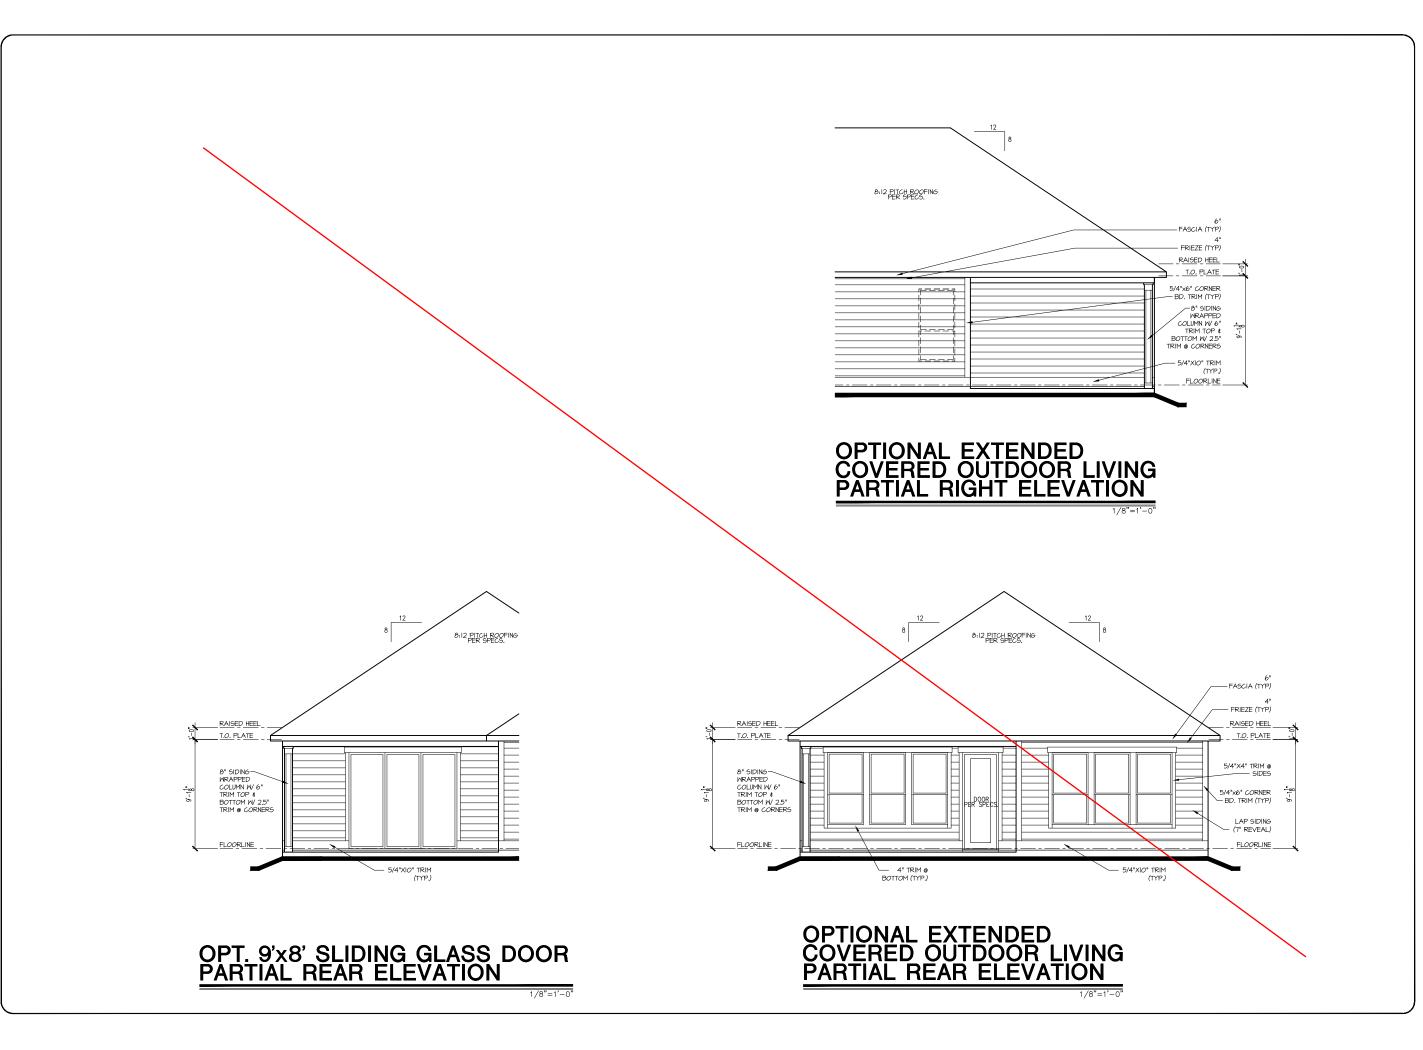

Dointe S HOMES ARK BLVD, SUITE 400, RALEGH, NC 27607 4

Business Operations 5440 Wade Park Blvd Suite 400 Raleigh, NC 27607

OPTIONS DN: Lot 289
160 Serene Crossing
Altis at Serenity
BLOCK: EXTERIOR ELEVATIONS


SUBDIVISION:
ADDRESS:
LOT: BL

10-01-24 Drawn By: ACC


5919-03


OAK HAVEN

A2.03C

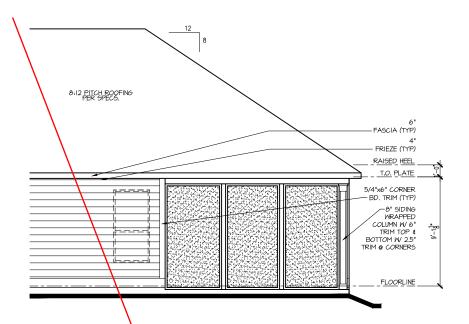


OPT. SCREENED EXTENDED COVERED OUTDOOR LIVING PARTIAL LEFT ELEVATION

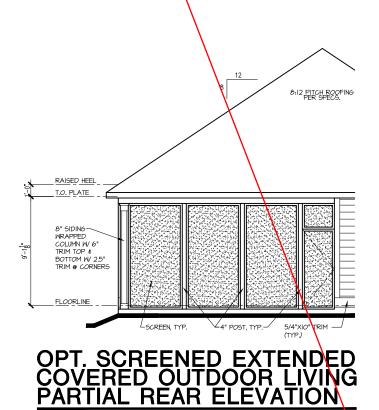

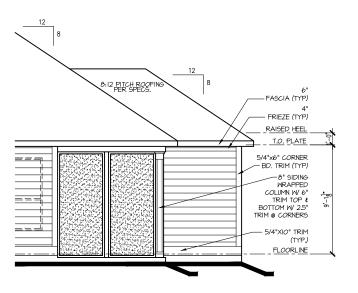

OPT. SCREENED COVERED OUTDOOR LIVING PARTIAL RIGHT ELEVATION

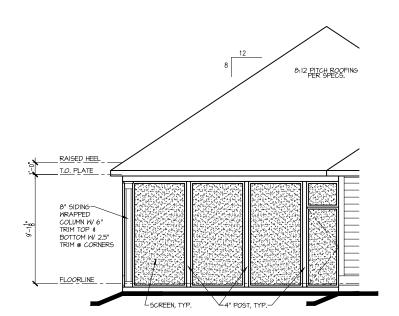

OPT. SCREENED COVERED OUTDOOR LIVING PARTIAL REAR ELEVATION

Dointe AD MES 4

Business Operations 5440 Wade Park Blvd Suite 400 Raleigh, NC 27607

OPTIONS N: Lot 289 160 Serene Crossing Altis at Serenity BLOCK: EXTERIOR ELEVATIONS


SUBDIVISION:
ADDRESS:
LOT: BL

Issue Date: 10-01-24 Drawn By: ACC

5919-03

OAK HAVEN

A2.04C

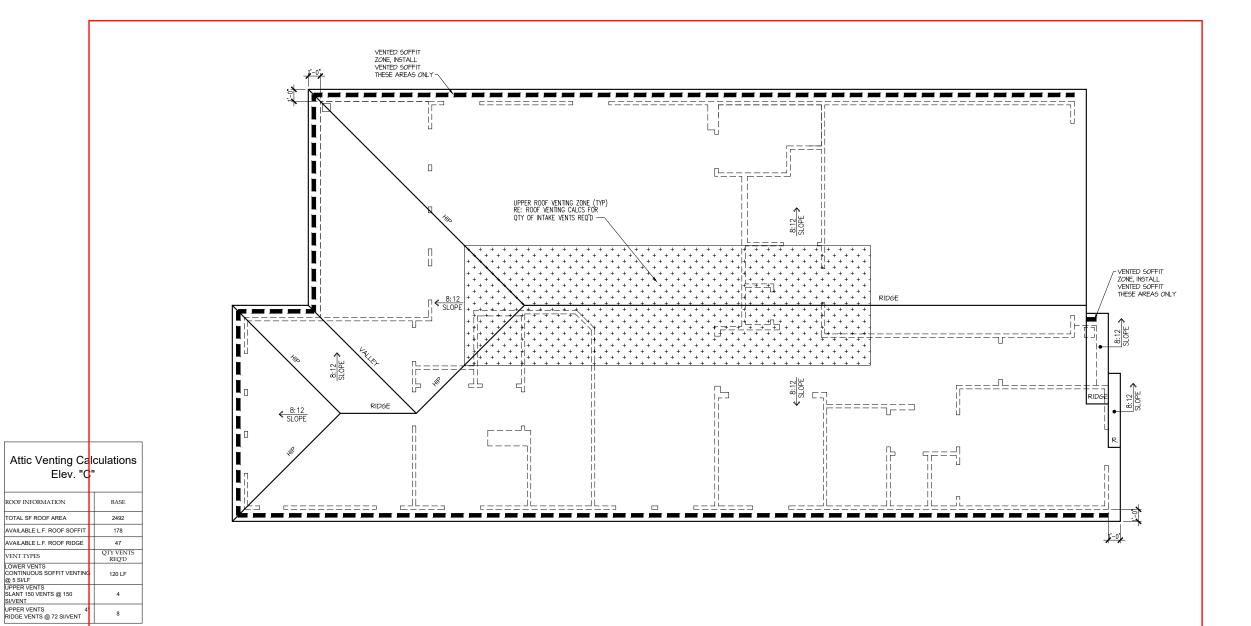

VENT TYPES

NOTE:
OTY OF UPPER VENTS SHOWN COVERS 100% OF UPPER VENTING. NO MIXING OF VENT TYPES FOR UPPER VENTING IS FIGURED FOR IN THIS TABLE.

ROOF PLAN 'C'

DointeHOMES

Business Operations 5440 Wade Park Blvd Suite 400 Raleigh, NC 27607

Crossing ROOF PLAN


SUBDIVISION:
ADDRESS:
LOT: BI

Issue Date: 10-01-24 Drawn By: ACC

5919-03

OAK HAVEN

A3.01C

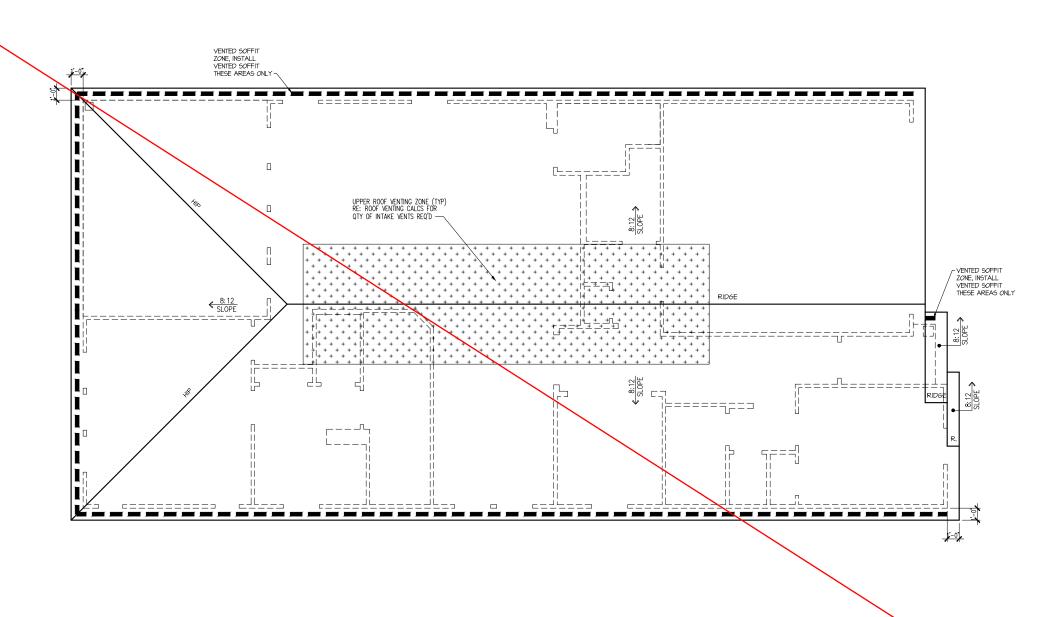

Attic Venting Calculations
Elev. "C"

ROOF INFORMATION BASE

TOTAL SF ROOF AREA 2606
AVAILABLE LF. ROOF SOFFIT 178
AVAILABLE LF. ROOF RIDGE 50
VENT TYPES QTY VENTIS
CONTINUOUS SOFFIT VENTING @ 5 SILF
UPPER VENTS
SLANT 150 VENTS @ 150
SLIVENT UPPER VENTS
SLANT 150 VENTS @ 150
SIVENT UPPER VENTS #1
UPPER VENTS #1
UPPER VENTS #1
SIVENT #1
RIDGE VENTS @ 72 SI/VENT 9

NOTE:
OTY OF UPPER VENTS SHOWN COVERS 100% OF UPPER VENTING. NO MIXING
OF VENT TYPES FOR UPPER VENTING IS FIGURED FOR IN THIS TABLE.

EXTENDED OUTDOOR LIVING OPT. ROOF PLAN 'C'

CALE: 1/8" = 1'-0"

tribointe HOME S
HOME SA40 WADE PARK BLVD, SUITE 400, RALEIGH, NC 27607

Business Operations 5440 Wade Park Blvd Suite 400 Raleigh, NC 27607

ROOF PLAN – OPTION
TISION: Lot 289
160 Serene Crossing
SS: Altis at Serenity

SUBDIVISION:
ADDRESS:
LOT: BL


Issue Date: 10-01-24

Drawn By: ACC

5919-03

OAK HAVEN

(A3.02C

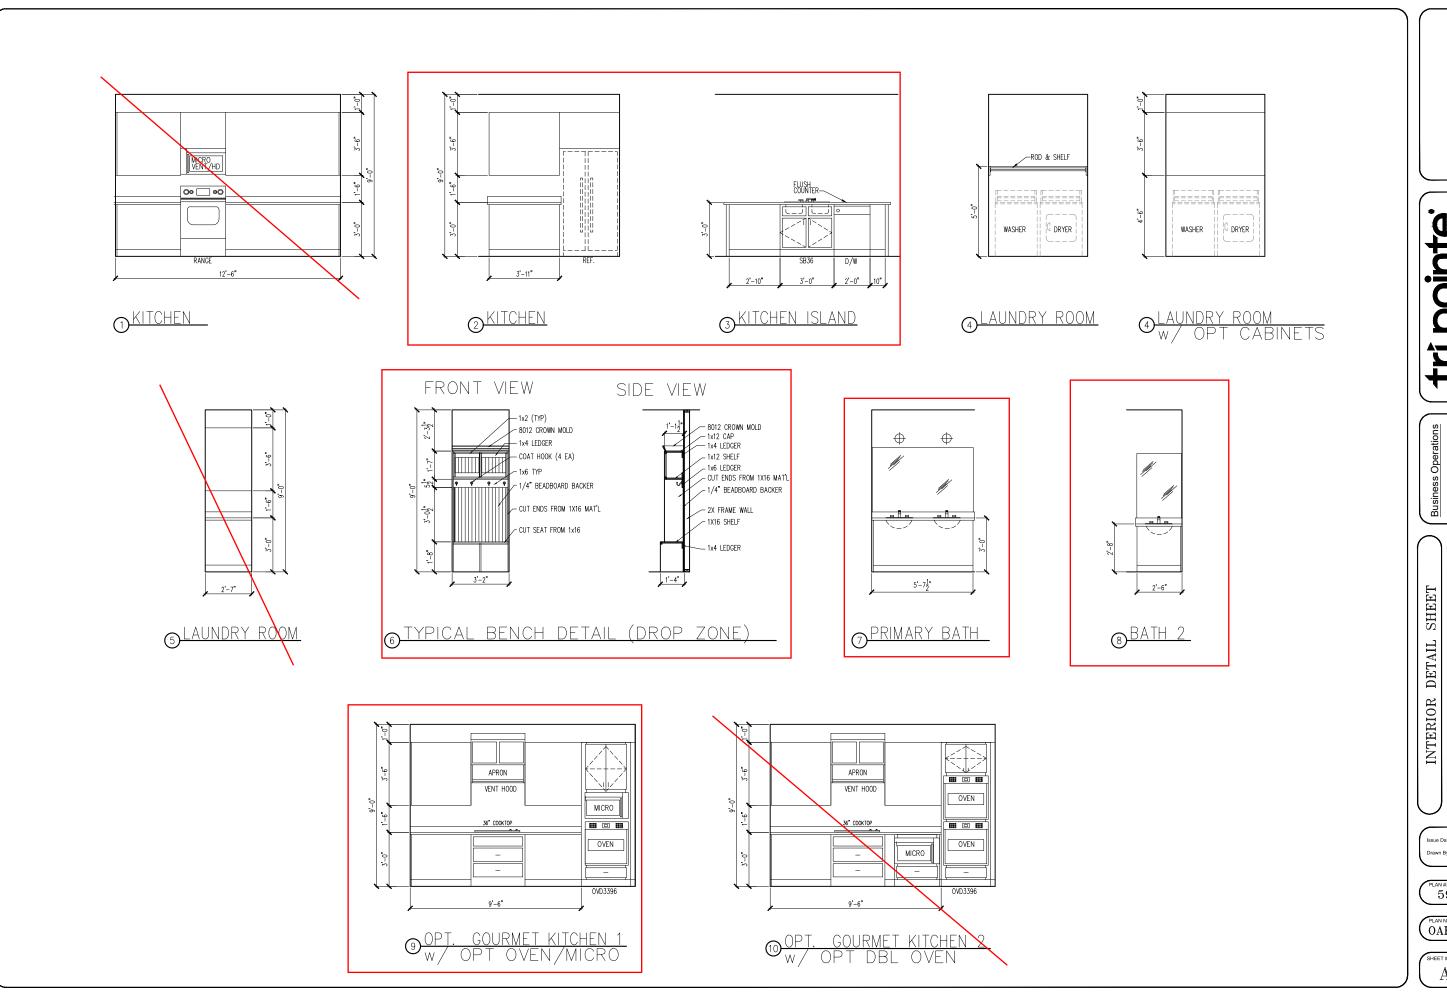

tri pointe HOMES 5440 WADE PARK BLVD, SUITE 400, RALEIGH, NG 27807

Business Operations 5440 Wade Park Blvd Suite 400 Raleigh, NC 27607

Busin 5440 V Suite 4 Raleial

N: Lot 289
160 Serene Crossing
Altis at Serenity
BLOCK:

SUBDIVISION:
ADDRESS:
LOT: BI

Issue Date: 10-01-24
Drawn By: ACC

5919-03

OAK HAVEN

A4.01

ELECTRICAL I SCHEDU	FIXTURE LE
DESCRIPTION	SYMBOL
110V OUTLET	Ф
220V OUTLET	
1/2 HOT OUTLET	₩
GFI OUTLET	∜\$ GFI
WP GFI OUTLET	₩P/GFI
GARAGE DOOR OPENER OUTLET	Ø GDO
SECURITY SYSTEM	∯SEC SYS
DISHWASHER	⊕ DW
JUNCTION BOX	٦
CEILING MOUNTED LIGHT	
CEILING FAN w/ LIGHT KIT	BRACING
RECESSED CEILING LIGHT	Ø
RECESSED WATER PROOF LIGHT	⊠ WP
WALL MOUNTED LIGHT	9
WALL MOUNTED PUSH BUTTON	å PB
TWO WAY SWITCH	\$
THREE WAY SWITCH	3\$
FOUR WAY SWITCH	⁴\$
DIMMER SWITCH	\$ ^{DIM}
EXHAUST VENTS	SVENT TO EXT
LOW VOLTAGE PANEL	
PHONE OUTLET	●PH
TV OUTLET	● TV
DATA & RG6 COMBO BOX	
SMOKE DETECTOR	<u>©</u>
CARBON MONOXIDE SMOKE DETECTOR COMBO	⊚ CM/SD
DOOR CHIMES	CHIMES
ELECTRICAL PANEL	EP EP
SURFACE MOUNT LED	•
EXTERIOR WALL MOUNT UPLIGHT	8
SOFFIT MOUNT FLOOD LIGHT	44
UNDER COUNTER LIGHTING	esse-UCL
SMURF TUBE	

ELECTRICAL NOTES:

- PROVIDE AND INSTALL LOCALLY CERTIFIED SMOKE AND CARBON MONOXIDE DETECTORS AS REQUIRED BY NATIONAL FIRE PROTECTION ASSOCIATION (NFPA) AND MEETING THE REQUIREMENTS OF ALL GOVERNING CODES.

 PROVIDE AND INSTALL GROUND FAULT (IRCUIT-INTERRUPTERS (GF)) AS REQUIRED BY NATIONAL ELECTRIC CODE (NEC) AND MEETING THE REQUIREMENTS OF ALL GOVERNING CODES.


 ELECTRICAL CONTRACTOR TO PROVIDE REQUIRED DIRECT HOOK—UPS/CUTOFS.

 HVAC CONTRACTOR TO VERIFY THERMOSTAT LOCATIONS.

 ALL ELECTRICAL AND MECHANICAL POWDENT (I.E. FURNACES, A/C UNITS, ELECTRICAL PANELS, SANITARY SUMP PITS, DRAIN TILE SUMP, AND WATER HEATERS) ARE SUBJECT TO RELOCATION DUE TO FIELD CONDITIONS.

DUE TO FIELD CONDITIONS.	JATION
ELECTRICAL DEVICES: ABOVE FINISH	ED FLOOR:
SWITCHES OVER COUNTER	48". TO. CL
WALL OUTLETS OVER COUNTER	
+42" TO BOTTOM OF HORIZONTAL OUTLET(TYP. @	
REMAINING SWITCHES	
WALL OUTLETS	
BATH VANITY BRACKET OUTLET (1" ABOVE TOP OF VANITY)	
WATER SOFTENER AND SUMP OUTLETS	
EXTERIOR GFI OUTLETS	
GARAGE GFI (ABOVE GARAGE FLOOR)	
FRONT DOOR COACH LIGHT	
GARAGE DOOR COACH LIGHT, (ABOVE GARAGE FLOOR)	. 84".TO CL
THERMOSTAT	. 54". TO .CL .
DOORBELL CHIMES	84" TO CL
DOORBELL BUTTON	. DR HANDLE
KITCHEN HOOD FAN "WHIP"	
KITCHEN WALL HUNG MICROWAVE OUTLET	. 72" TO CL
KITCHEN DISHWASHER RECEPTACLE	
KITCHEN RANGE	. 24".TD.CL.
KITCHEN REFRIGERATOR	
WASHER/DRYER OUTLET	48". TO. CL

CL = CENTER LINE 1 = FIELD VERIFY 2 = MASTER BATH STANDARD 30" HIGH VANITY TO BE RAISED 4"

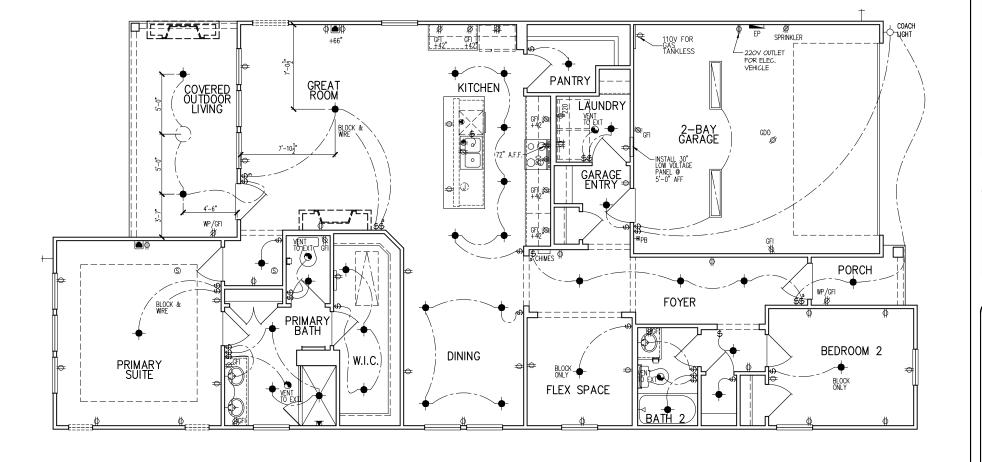

Dointe HOMES RR BLVD. SUITE 400, RALEGOH, NG 27/607

Business Operations 5440 Wade Park Blvd Suite 400 Raleigh, NC 27607

t 289 0 Serene Crossing is at Serenity ELECTRICAL PLAN N: Lot 28 160 S Altis a BLOCK: 1st FLOOR

SUBDIVISION:
ADDRESS:
LOT: BI

Issue Date: 10-01-24 ACC

5919-03

OAK HAVEN

E1.10C


ELECTRICAL FIX	KTURE
OOTTLDOLL	- - -
DESCRIPTION S	SYMBOL
110V OUTLET	ф
220V OUTLET	₩ Ф 220
1/2 HOT OUTLET	•
GFI OUTLET	₩ GFI
WP GFI OUTLET	₩P/GFI
GARAGE DOOR OPENER OUTLET	Ø GDO
SECURITY SYSTEM	∯SEC SYS
DISHWASHER	⊕DW
JUNCTION BOX	Ũ
CEILING MOUNTED LIGHT	
CEILING FAN w/ LIGHT KIT	PROVIDE
RECESSED CEILING LIGHT	Ø
RECESSED WATER PROOF LIGHT	∭ WP
WALL MOUNTED LIGHT	φ
WALL MOUNTED PUSH BUTTON	e PB
TWO WAY SWITCH	\$
THREE WAY SWITCH	* \$
FOUR WAY SWITCH	⁴\$
DIMMER SWITCH	\$ ^{DIM}
EXHAUST VENTS	S VENT TO EXT
LOW VOLTAGE PANEL	<u> </u>
PHONE OUTLET	● PH
TV OUTLET	⊗ TV
DATA & RG6 COMBO BOX	
SMOKE DETECTOR	<u>(S)</u>
CARBON MONOXIDE SMOKE DETECTOR COMBO	⊚ CM/SD
DOOR CHIMES	CHIMES
ELECTRICAL PANEL	EP EP
SURFACE MOUNT LED	-
EXTERIOR WALL MOUNT UPLIGHT	8
SOFFIT MOUNT FLOOD LIGHT	443
UNDER COUNTER LIGHTING	-coo-UCL
SMURF TUBE	

ELECTRICAL NOTES:

- 1. PROVIDE AND INSTALL LOCALLY CERTIFIED SMOKE AND CARBON MONOXIDE DETECTORS REQUIRED BY NATIONAL FIRE PROTECTION ASSOCIATION (NFPA) AND MEETING THE REQUIREMENTS OF ALL GOVERNING CODES
 2. PROVIDE AND INSTALL GROUND FAULT (IRCUIT—INTERRUPTERS (GF) AS REQUIRED BY NATIONAL ELECTRIC CODE (NEC) AND MEETING THE REQUIREMENTS OF ALL GOVERNING CODES.
 3. ELECTRICAL CONTRACTOR TO PROVIDE REQUIRED DIRECT HOOK—UPS/CUTOFFS.
 4. HVAC CONTRACTOR TO VERIFY THERMOSTAT LOCATIONS.
 5. ALL ELECTRICAL AND MECHANICAL EQUIPMENT (I.E. FURNACES, A/C UNITS, ELECTRICAL PANELS, SANITARY SUMP PITS, DRAIN TILE SUMP, AND WATER HEATERS) ARE SUBJECT TO RELOCATION DIE TO FIELD CONDITIONS.
 ELECTRICAL DEVICES: ABOVE FINISHED FLOORS:

DOE TO TIEED CONDITIONS
ELECTRICAL DEVICES: ABOVE FINISHED FLOOR:
SWITCHES OVER COUNTER
WALL OUTLETS OVER COUNTER
+42" TO BOTTOM OF HORIZONTAL OUTLET(TYP. @ COUNTER)
REMAINING SWITCHES
WALL OUTLETS
BATH VANITY BRACKET OUTLET 1,2 (1" ABOVE TOP OF VANITY)
WATER SOFTENER AND SUMP OUTLETS 48" TO CL
EXTERIOR GFI OUTLETS
GARAGE GFI (ABOVE GARAGE FLOOR) 48" TO CL
FRONT DOOR COACH LIGHT 80". TO CL
GARAGE DOOR COACH LIGHT, (ABOVE GARAGE FLOOR)
THERMOSTAT
DOORBELL CHIMES
DOORBELL BUTTON
KITCHEN HOOD FAN "WHIP"
KITCHEN WALL HUNG MICROWAVE OUTLET 72" TO CL
KITCHEN DISHWASHER RECEPTACLE JINDER SINK
KITCHEN RANGE
KITCHEN REFRIGERATOR
WASHER/DRYER OUTLET
CL = CENTER LINE

CL = CENTER LINE 1 = FIELD VERIFY 2 = MASTER BATH STANDARD 30" HIGH VANITY TO BE RAISED 4"

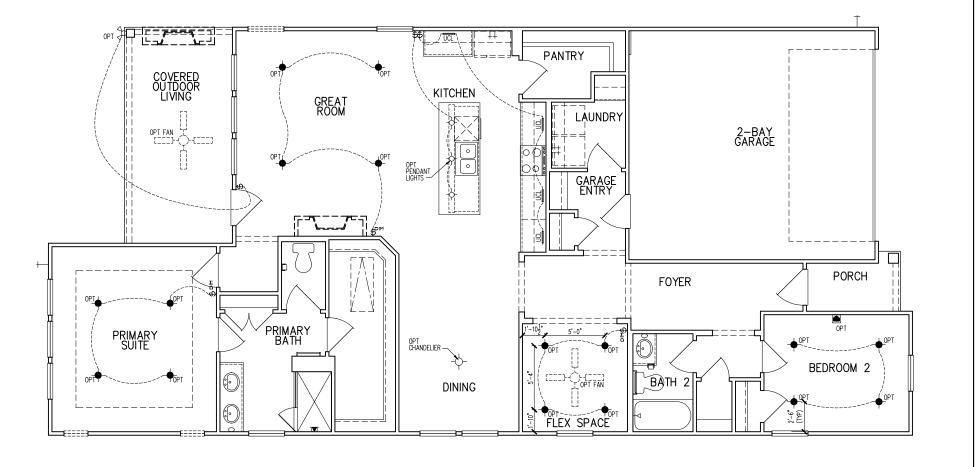

Dointe HOMES ** BLVD, SUITE 400, RALEIGH, NG 27607

Business Operations 5440 Wade Park Blvd Suite 400 Raleigh, NC 27607

- OPITONS N: Lot 289 160 Serene Crossing Altis at Serenity BLOCK: 1st FLOOR ELEC. PLAN


SUBDIVISION:
ADDRESS:
LOT: BL


Issue Date: 10-01-24 ACC

5919-03


OAK HAVEN

E1.11C

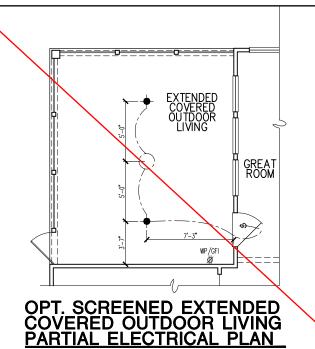


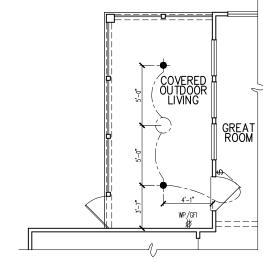


OPT. SCREENED COVERED OUTDOOR LIVING PARTIAL ELECTRICAL PLAN

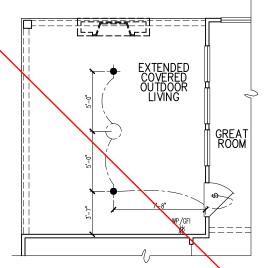


OPT. EXTENDED COVERED OUTDOOR LIVING PARTIAL ELECTRICAL PLAN

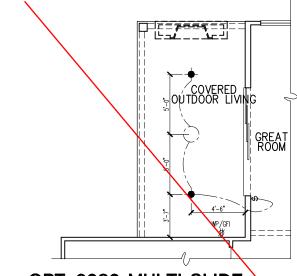

OPT. 9080 MULTI SLIDE DOOR AT GREAT ROOM PARTIAL ELECTRICAL PLAN

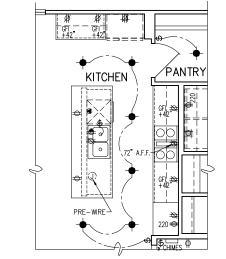

OPT. GOURMET KITCHEN 1 PARTIAL ELECT. PLAN

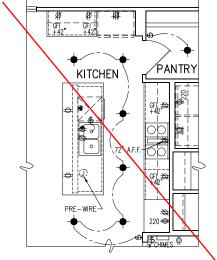

OPT. GOURMET KITCHEN 2 PARTIAL ELECT. PLAN



PRIMARY BATH

OPT. PRIMARY BATH 1 PARTIAL ELECTRICAL PLAN

L	220V OUTLET	Ф 220	
ı	1/2 HOT OUTLET		
ı	GFI OUTLET	₩ GFI	ELE
ı	WP GFI OUTLET	₩P/GFI	
l	GARAGE DOOR OPENER OUTLET	Ø GDO	1. PR SMO
ı	SECURITY SYSTEM	♦ SEC SYS	REQ ASS
ı	DISHWASHER	⊕ DW	2. PEQ
ı	JUNCTION BOX	0	CIRC
ı	CEILING MOUNTED LIGHT	4	NATI THE
	CEILING FAN w/ LIGHT KIT	BRAXINE	3. ELE REQI 4. HV/ LOC
ı	RECESSED CEILING LIGHT	Ø	5. ALL (I.E.
l	RECESSED WATER PROOF LIGHT)⊠WP	SAN WAT
ı	WALL MOUNTED LIGHT	Q	DUE
ı	WALL MOUNTED PUSH BUTTON	₫ PB	ELEC' SWITC
ı	TWO WAY SWITCH	\$	WALL
ı	THREE WAY SWITCH	*\$	+42*
ı	FOUR WAY SWITCH	\$	REMA WALL
ı	DIMMER SWITCH	\$PM	BATH
ı	EXHAUST VENTS	S WENT TO EXT	(1* A

CHIMES

EP EP

ELECTRICAL FIXTURE SCHEDULE

DESCRIPTION SYMBOL

110V OUTLET

CARBON MONOXIDE SMO

DOOR CHIMES

ELECTRICAL PANEI

SURFACE MOUNT LE

EXTERIOR WALL MOUNT
UPLIGHT
SOFFIT MOUNT FLOOD LIG

ECTRICAL NOTES:

PROVIDE AND INSTALL LOCALLY CERTIFIED (OKE AND CARBON MONOXIDE DETECTORS QUINED BY AND AND AND THE PROFICE TO SOCIATION (NPFA) AND MEETING THE COMERNING CODE (NPFA) AND MEETING THE COMERNING CODE (NPFA) AND MEETING THE COMERNING CODE (NPFA) AND MEETING ERECURRENTS OF ALL COMERNING CODES. ECTIFICAL CONTRACTOR TO PROMOTE

VAC CONTRACTOR TO VERTY "HERMOSTAT
ACADINS.

CALADINS.

CALADINS. WALL OUTLETS.
(1" ABOVE TOP OF VANITY)
WATER SOFTENER AND SUMP OUTLETS.
EXTERIOR GFI OUTLETS.
GARAGE GFI (ABOVE GARAGE FLOOR).
FRONT DOOR COACH LIGHT. GARAGE DOOR COACH LIGHT, (ABOVE GARAGE FLOOR). . . . 84". TO CL . DR HANDLE . 66". TO CL . 72" TO CL . UNDER SINI . 24". TO CL . 48". TO CL . 48". TO CL DOORBELL BUTTON.

KITCHEN HOOD FAN "MHIP"

KITCHEN WALL HUNG MICROWAYE OUTLET.

KITCHEN BUSHWASHER RECEPTACLE.


KITCHEN RANGE.

KITCHEN RANGE.

KITCHEN REPRICERATOR.

WASHER/DRYER OUTLET.

CL = CENTER LINE 1 = FIELD VERIFY 2 = MASTER BATH STANDARD 30" HIGH VANITY TO BE RAISED 4"

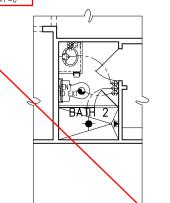

OPT. SHOWER
ILO TUB AT BATH 2
PARTIAL ELECTRICAL PLAN



OPT. OFFICE ILO FLEX SPACE PARTIAL ELECT. PLAN

10-01-24 Issue Date: ACC

5919-03

W.I.C.

OAK HAVEN

Dointe MES MESON SALEGH, NO 27607

れば

Business Operations 5440 Wade Park Blvd Suite 400 Raleigh, NC 27607

Serene Crossing s at Serenity

OPTIONS


PLAN

ELEC.

SUBDIVISION:

ADDRESS: LOT:

01.E10

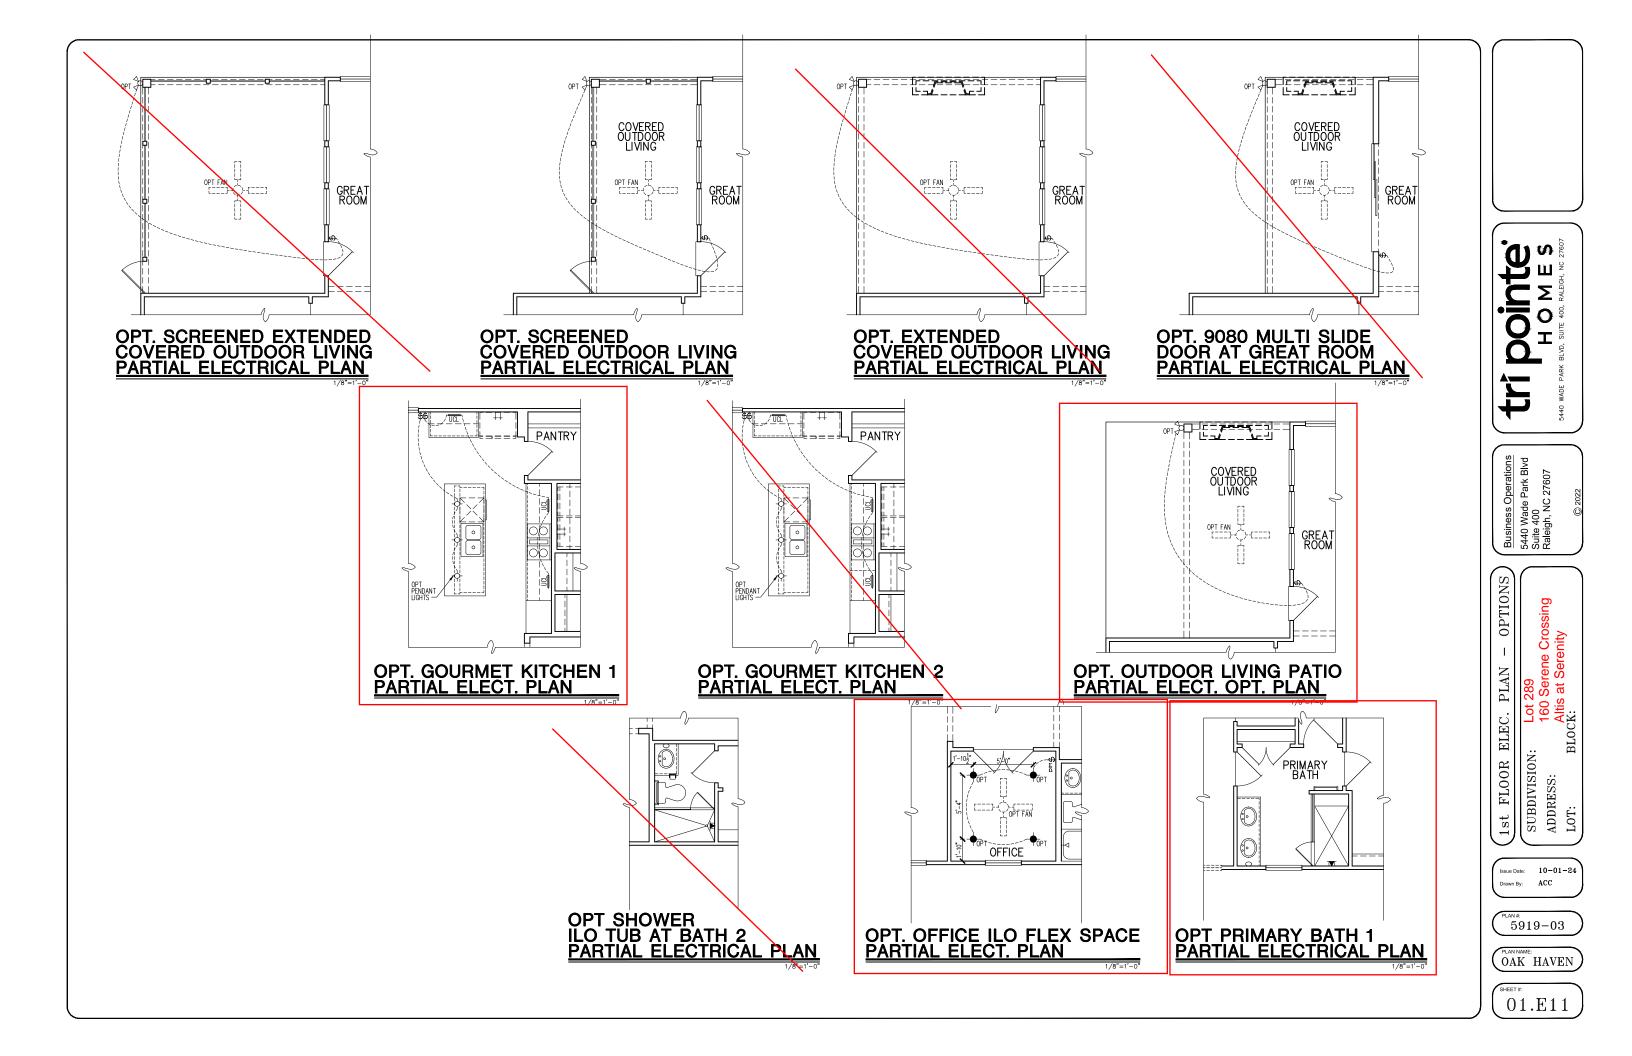

GENERAL STRUCTURAL NOTES

FLOOR FRAMING

- I IOISTS/TRUSSES SHALL BE DESIGNED BY MANUE TO MEET OR EXCEED L/480 LIVE LOAD DEFLECTION CRITERIA. (EXCLUDES STONE/MARBLE OR WET BED CONSTRUCTED FLOORS - CONTACT M&K FOR EXCLUDED FLOOR DESIGNS)
- PER THE GUIDELINES OF THE TILE COUNCIL OF NORTH AMERICA (TCNA HANDBOOK), IT SHALL BE THE FLOOR FINISH INSTALLER'S RESPONSIBILITY TO VERIEY THAT THE FINISHES TO BE INSTALLED MATCH THE DESIGN CRITERIA NOTED ABOVE (UNDER "DESIGN
- FLOOR SYSTEMS & SHEATHING HAVE BEEN DESIGNED TO SUPPORT ADDITIONAL DEAD LOAD FROM CERAMIC TILE (EXCLUDING MARBLE OR STONE). HOWEVER, IT SHALL BE THE FLOOR FINISH INSTALLER'S RESPONSIBILITY TO PROVIDE PROPER UNDERLAYMENT, UNCOUPLING MEMBRANE AND MORTAR/GROUT PER THE ASSEMBLY DESIGNATIONS IN THE TONA HANDBOOK (TILE COUNCIL OF NORTH AMERICA).
- AT I-JOIST FLOORS, PROVIDE I 1/8" MIN. OSB RIM BOARD.
- METAL HANGERS SHALL BE SPECIFIED BY MANUFACTURER, U.N.O.
- I-JOIST/TRUSS SHOP DWGS. SHALL BE SUBMITTED TO ARCH. & ENG FOR REVIEW AND APPROVAL PRIOR TO FABRICATION OR DELIVERY
- FLOOR SHEATHING SHALL BE 23/32" A.P.A. RATED 'STURD-I-FLOOR 24" O.C. EXPOSURE I (OR APPROVED EQUAL) WITH TONGUE AND GROOVE EDGES. FASTEN TO FRAMING MEMBERS W GLUE AND
- 2 1 x 0.131" NAILS @ 6"o.c. @ PANEL EDGES & @ 12"o.c. FIELD.
- 2 3" x 0.120" NAILS @ 4" O.C. @ PANEL EDGES & @ 8" O.C. FIELD.
- 2 3 × 0.113" NAILS @ 3" O.C. @ PANEL EDGES \$ @ 6" O.C. IN FIELD

ROOF FRAMING

- ROOF SHEATHING SHALL BE 7/16" A.P.A. RATED SHEATHING 24/16 EXPOSURE I (OR APPROVED EQUAL). FASTEN TO FRAMING MEMBERS
- W/ 2 ½" x 0.131" NAILS @ 6"o.c. @ PANEL EDGES \$ @ 12" O.C. FIELD.
- · w/ 2 🖁 × 0.120" NAILS 🥑 4"o.c. 💇 PANEL EDGES 🕏 🗗 O.C. FIELD. - w/ 2 3 × 0.113" NAILS @ 3"o.c. @ PANEL EDGES & @ 6" O.C. FIELD.
- WITHIN 48" OF ALL ROOF EDGES, RIDGES, & HIPS FASTEN ROOF SHEATHING FIELDS PER EDGE NAILING SPEC.
- EASTEN FACH ROOF TRUSS TO TOP PLATE W/ SIMPSON H25T CLIP (OR APPROVED EQUAL) • ALL BEARING POINTS. PROVIDE (2) H2.51 CLIPS AT 2-PLY GIRDER TRUSSES, (3) H2.5T CLIPS AT 3-PLY GIRDER TRUSSES & ROOF BEAMS - AT ALL BEARING POINTS.
- METAL HANGERS SHALL BE SPECIFIED BY THE MANUFACTURER, U.N.O. ROOF TRUSS SHOP DWGS SHALL BE SUBMITTED TO ARCH & ENG
- FOR REVIEW AND APPROVAL PRIOR TO FABRICATION OR DELIVERY ERECT AND INSTALL ROOF TRUSSES PER WTCA & TPI'S BCSI I
- "GUIDE TO GOOD PRACTICE FOR HANDLING, INSTALLING & BRACING OF METAL PLATE CONNECTED WOOD TRUSSES."
- SUPPORT SHORT SPAN ROOF TRUSSES W/2x4 LEDGER FASTENED TO FRAMING w/(2) 3" x 0.120" NAILS @ 16" O.C. (UP TO T' SPAN).

CONNECTION SPECIFICATIONS (TYP. U.N.O.)

DESCRIPTION OF BLDG. ELEMENT	3"x0.131" NAIL5	3"x0.120" NAILS
JOIST TO SOLE PLATE	(3) TOENAILS	(3) TOENAILS*
SOLE PL. TO JOIST/RIM OR BLK'G	NAILS @ 4" o.c.	NAILS @ 4" o.c.
STUD TO PLATE	(4) TOENAILS/ (3)END NAILS	(4) TOENAILS/ (4)END NAILS*
RIM TO TOP PLATE	TOENAILS @ 6" o.c.	TOENAILS @ 4" o.c.*
BLK'G. BTWN. JOISTS TO TOP PL.	(3) TOENAILS EA. END	(3) TOENAILS EA. END*
DOUBLE STUD	NAILS @ 16" o.c.	NAILS @ 16" O.C.
DOUBLE TOP PLATE	NAILS @ 12" o.c.	NAILS @ 8" o.c.
DOUBLE TOP PLATE LAP SPLICE	(12) NAILS IN LAPPED AREA (24" MIN.)	(15) NAILS IN LAPPED AREA (24" MIN.)
TOP PLATE LAP @ CORNERS & INTERSECTING WALLS	(3) NAILS	(3) NAILS
RAFTER/TRUSS TO TOP PLATE	(4) TOENAILS +	(4) TOENAILS +
	(I) SIMPSON H2.5T	(I) SIMPSON H2.5T
GAB. END TRUSS TO DBL. TOP PL.	TOENAILS @ 8" o.c.	TOENAILS @ 6" o.c.
R.T. w/ HEEL HT. 9 1/4" TO 12"	2xIO BLK EVERY 3RD BAY FASTENED TO DBL. TOP PLATE W/ TOENAILS @ 6" O.C.	2xIO BLK EVERY 3RD BAY FASTENED TO DBL. TOP PLATE W/ TOENAILS @ 4" O.C.
R.T. w/ HEEL HT. 12" TO 16"	2xI2 BLK EVERY 3RD BAY FASTENED TO DBL. TOP PLATE W/ TOENAILS @ 6" O.C.	2xI2 BLK EVERY 3RD BAY FASTENED TO DBL. TOP PLATE w/ TOENAILS @ 4" O.C.
R.T. w/ HEEL HT. UP TO 24"	LAP WALL SHTG. W/ DBL. TOP PL. \$ INSTALL ON TRUSS VERT FASTEN W/ NAILS @ 6" O.C.	LAP WALL SHTG. W/ DBL. TOP PL. \$ INSTALL ON TRUSS VERT FASTEN W/ NAILS @ 6" O.C.*
R.T. w/ HEEL HT. 24" TO 48"	LAP WALL SHTG. W DBL. TOP PL. & INSTALL ON TRUSS VERT FASTEN W NAILS @ 6" O.C. PROVIDE 2x BLK @ EA. BAY AT TOP OF HEEL	LAP WALL SHTG. W/ DBL. TOP PL. & INSTALL ON TRUSS YERT FASTEN W/ NAILS @ 6" O.C. PROVIDE 2x BLK @ EA. BAY AT TOP OF HEEL*
WALL TO FOUNDATION	WALL SHTG. LAP w/ SILL PL. & FASTENED PER SHEAR WALL FASTENING SPEC.	

GENERAL STRUCTURAL NOTES

DESIGN LOADING

- DESIGN IS BASED ON 2018 NORTH CAROLINA STATE BUILDING CODE: RESIDENTIAL CODE.
- WOOD FRAME ENGINEERING IS BASED ON NDS, "NATIONAL DESIGN SPECIFICATION FOR WOOD CONSTRUCTION" - LATEST EDITION.

FLOOR LIVE = 40 PSF (30 PSF @ SLEEPING AREAS)

- DESIGN LOADS ROOF
 - SNOW = 15 PSF (12 PSF GROUND SNOW, TRUSSES) LIVE = 20 PSF (REDUCIBLE BASED ON ROOF PITCH) DEAD = 7 PSF T.C., IO PSF B.C.
 - LOAD DURATION FACTOR = 1.25
 - DEAD = 10 PSF (I-JOISTS), 15 PSF (FLOOR TRUSSES) ADD'L IO PSE @ CERAMIC TILE IN KITCHEN SUNROOMS, BATHS, FOYER, LAUND. & MUDRMS
 - 2,000 PSF ASSUMED ALLOWABLE BEARING PRESSURE (TO BE VERIFIED BY BUILDER)

GENERAL FRAMING

115 MPH, EXPOSURE B

- ALL TYP, NAIL FASTENER REQUIREMENTS ARE NOTED IN STANDARD CONNECTIONS TABLE (IRC TABLE R602.3(1)) OR ON PLANS. ALL NAILS SPECIFIED ARE MIN DIAMETER AND LENGTH REQUIRED FOR CONNECTION. ALL HANGER NAILS SHALL BE INSTALLED PER MANUFACTURER'S REQUIREMENTS FOR MAX CHARTED CAPACITY NOTE: HANGERS USE COMMON NAIL DIAMETERS NOT TYPICAL FRAMING GUN NAILS.
- EXT & INT BEARING WALLS SHALL BE 2x4 OR 2x6 (AS SHOWN ON PLANS) @ 16" O.C. SPF/SP #2 GRADE LUMBER, OR BETTER, U.N.O.. · WALLS OVER 12' TALL SHALL BE PER PLAN.
- ALL INTERIOR BEARING WALLS ARE ASSUMED TO BE SHEATHED W/ GYP WALL BOARD (ONE SIDE MIN.) OR PROVIDE MID HT. BLOCKING
- ALL HEADERS, BEAMS & OTHER STRUCTURAL MEMBERS SHALL BE SPRUCE-PINE-FIR #2 (SPE) OR SOUTHERN PINE #2 (SP) LUMBER, OR BETTER, SUPPORT ALL HEADERS/ BEAMS W/ (1)2x JACK STUD & (1)2x KING STUD MINIMUM
- THE NUMBER OF STUDS SPECIFIED AT A SUPPORT INDICATES THE NUMBER OF JACK STUDS REQUIRED, U.N.O.,
- ALL NON-BEARING INTERIOR STUD WALLS SHALL BE CONSTRUCTED WITH 2x 'STUD' GRADE MEMBERS SPACED @ 24" O.C. (MAX., U.N.O.)

 • HEADERS IN NON-LOAD BEARING WALLS SHALL BE: (I)2x4/6 FLAT @ OPENINGS UP TO 4', (2)2x4/6 FLAT UP TO 8'.
- ALL FRAMING LUMBER SHALL BE DRIED TO 15% MC (KD-15)
- ENGINEERED LUMBER BEAMS TO MEET OR EXCEED THE FOLLOWING: • 'LVL' - Fb=2600 psi; Fv=285 psi; E=2.0xl0^6 psi
- ENGINEERED LUMBER POSTS TO MEET OR EXCEED THE FOLLOWING 'LVL' - Fb=2400 psi; FcII=2500 psi; E=I.8xI0^6 psi
- FOR 2 & 3 PLY BEAMS OF EQUAL 134" MAX, WIDTH, FASTEN PLIES TOGETHER WITH 3 ROWS OF 3"X0.120" NAILS @ 8" O/C OR 2 ROWS 18"x3K" SIMPSON SDS SCREWS (OR 3K" TRUSSI OK SCREWS) @ 16" GREATER. APPLY EASTENING AT BOTH FACES FOR 3-PLY CONDITION. LOCATE TOP & BOTTOM NAILS/SCREWS 2" FROM EDGE. SOLID 31/3" OR 51/4" BEAMS ARE ACCEPTABLE, USE 2 ROWS OF NAILS FOR 2x6 \$ 2x8 MEMBERS
- FOR 4 PLY BEAMS OF EQUAL 13/4" MAX. WIDTH, FASTEN PLIES TOGETHER WITH 3 ROWS OF 1/2"x6" SIMPSON SDS SCREWS (OR 6 3/4" TRUSSLOK SCREWS) @ 16" O/C. USE A MINIMUM OF 4 ROWS FOR BEAM DEPTHS OF 14" OR GREATER, APPLY EASTENING AT BOTH FACES (ONE SIDE ONLY FOR TRUSSLOK SCREWS). LOCATE TOP AN BOTTOM SCREWS 2" FROM EDGE. A SOLID 7" BEAM IS ACCEPTABLE
- PROVIDE SOLID BLOCKING IN FLOOR SYSTEM UNDER ALL POSTS CONTINUOUS TO FND./BEARING. BLOCKING TO MATCH POST ABOVE.
- ALL EXTERIOR 4x4 WOOD POSTS SHALL HAVE SIMPSON BCS2-2/4 CAP & ABW44 BASE, U.N.O.

Lot 289

Oak Haven

BUILDER RESPONSIBLE TO DETERMINE CORROSION-RESISTANCE REQUIREMENTS AND COMPATIBILITY OF HARDWARE FASTENERS AND CONNECTORS FOR ENVIRONMENTAL EXPOSURE AND IN CONTACT W/ PRESERVATIVE-TREATED WOOD OF ACTUAL FINAL CONDITIONS AND SOURCED MATERIALS. CONTACT LUMBER & HARDWARE SUPPLIERS TO COORD.

Plan 5919-03 Elevation C- Garage Right

GENERAL STRUCTURAL NOTES

FOUNDATION

- DESIGN IS BASED ON 2018 NORTH CAROLINA STATE BUILDING CODE:
- FOOTING DESIGN 2,000 PSF ALLOWABLE SOIL BEARING
- FASTEN 2x4/6 SILL PLATES TO CONC FND WITH A MINIMUM OF 2
- ANCHORS PER PLATE 12" MAX FROM PLATE ENDS UTILIZING: I/2" DIA. ANCHOR BOLTS 6'-0" O.C,7" MIN. EMBEDMENT
- I/2" DIA. x 6" LONG SIMPSON TITEN HD @ 6'-0" O.C. • SIMPSON MASA ANCHOR STRAPS @ 6'-0" O.C. (CONCRETE)
- ALL LUMBER EXPOSED TO WEATHER OR IN CONTACT W/ PERIMETER
- FOUNDATION SHALL BE PRESERVATIVE TREATED SOUTHERN PINE #2. BUILDER TO VERIEY CORROSION-RESISTANCE COMPATIBILITY OF HARDWARE & FASTENERS IN CONTACT W/ PRESERVATIVE-TREATED
- WOOD, CONTACT LUMBER & HARDWARE SUPPLIERS TO COORD. • FOOTINGS SHALL BE PLAIN CONCRETE, U.N.O.
- CONCRETE DESIGN BASED ON ACL 318, CONCRETE SHALL ATTAIN THE FOLLOWING MIN. COMPRESSIVE STRENGTHS IN 28 DAYS, U.N.O. f'c = 3,000 psi: FOOTINGS & INTERIOR SLABS ON GRADE 3500 psi: GARAGE & EXTERIOR SLABS ON GRADE fu = 60.000 psi
- ALL CONCRETE EXPOSED TO THE WEATHER SHALL NOT HAVE LESS THAN 5% OR MORE THAN 7% AIR ENTRAINMENT
- ALL FOOTINGS SHALL BEAR BELOW FROST LINE (TYP.) OR 12" MIN I REGIONS WHERE CODE FROST DEPTH IS NOT APPLICABLE. CONSULT SOILS REPORT OR BUILDING DEPT. FOR MINIMUM DEPTH BELOW GRADE
- FOOTINGS AND SLABS ON GRADE SHALL BEAR ON VIRGIN SOIL OR
- PROVIDE CONTROL JOINTS AT ALL INSIDE CORNERS OF SLAB EDGES, AND OTHER LOCATIONS WHERE SLAB CRACKS ARE LIKELY
- JOINTS SHALL BE LOCATED @ 10'-0" O.C. (RECOMMENDED) OR 15'-0" O.C. (MAXIMUM)
- JOINT GRID PATTERN SHALL BE AS CLOSE TO SQUARES AS POSSIBLE (I:I RATIO), WITH A MAXIMUM OF I:I.5 RATIO
- CONTROL JOINTS SHALL <u>NOT</u> BE INSTALLED IN STRUCTURAL
- DIMENSIONS BY OTHERS, BUILDER TO VERIFY.

HOLD-DOWN SCHEDULE

SYMBOL	SPECIFICATION
₽ D	SIMPSON CSI6 STRAP TIE W/ 14" END LENGT
► HD-2	SIMPSON MSTC66 STRAP TIE W 24" END LENGTI
▶ HD-3	SIMPSON HTT4 HOLD-DOWN *
► HD-4	SIMPSON HDU5-SDS2.5 HOLD-DOWN *

UTILIZE SIMPSON "SET-3G" EPOXY SYSTEM TO FASTEN %" DIA. THREADED ROD INTO CONCRETE FOUNDATION. PROVIDE 12" MIN. EMBEDMENT INTO CONCRETE. INSTALL PER MANUE, RECOMMENDATIONS, DO NOT LOCATE ANCHORS WITHIN I 3/4" OF EDGE OF FOUNDATION

► HD-5 SIMPSON STHDI4RJ HOLD-DOWN *

MEANS & METHODS NOTES

THE STRUCTURE IS DESIGNED TO BE SELF SUPPORTING AND STABLE AFTER THE BUILDING IS FINISHED AND ALL PLAN, DETAIL, AND NOTE SPECIFICATIONS HAVE BEEN COMPLETED. IT IS THE CONTRACTOR'S SOLE RESPONSIBILITY TO DETERMINE THE ERECTION PROCEDURES AND SEQUENCE TO COMPONENTS DURING CONSTRUCTION. THIS INCLUDES BUT IS NOT LIMITED TO, THE ADDITION OF NECESSARY SHORING, SHEETING, TEMPORARY BRACING, GUYS, AND TIE-DOWNS. CONTRACTOR SHALL BE RESPONSIBLE FOR ALL SHORING AND BRACING REQUIRED TO STABILIZE AND PROTECT EXISTING AND ADJACENT STRUCTURES AND SYSTEMS DURING COURSE OF DEMOLITION AND CONSTRUCTION

STRUCTURAL DESIGN AND SPECIFICATIONS ASSUME THAT ALL SUPPORTING AND NON-SUPPORTING ELEMENTS IN CONTACT WITH FLOOR FRAMING ARE LEVEL, INCLUDING, BUT NOT LIMITED TO: FOUNDATIONS SLABS ON GRADE, BEAMS, WALLS, AND NON-BEARING ELEMENTS. IT IS THE CONTRACTOR'S RESPONSIBILITY TO VERIEY LEVELNESS AND MAKE ADJUSTMENTS AS NECESSARY, INCLUDING CONSIDERATION OF THOSE AREAS THAT MAY BE WITHIN CONTRACTUAL, INDUSTRY OR WARRANTY TOLERANCES.

VENEER LINTEL SCHEDULE

	SPAN (MAX)	HEIGHT OF VENEER ABOVE LINTEL	STEEL ANGLE SIZE
	3'-0"	20 FT. MAX	L3"x3"x¼"
	6'-0"	3 FT. MAX	L3"x3"x¼"
		I2 FT. MAX	L4"x3"x1/4"
		20 FT. MAX	L5"x3½"x¾"
	8'-0"	3 FT. MAX	L4"x4"x¼" *
		I2 FT. MAX	L5"x3½"x¾"
		I6 FT. MAX	L6"x3½"x¾"
	9'-6"	I2 FT. MAX	L6"x3½"x¾6"
	16'-0"	2 FT. MAX	L7"x4"x½" **
	I	3 ET MAY	1 8"\\\\"\\\!\\\"\\\\\\\\\\\\\\\\\\\\\\\\

- . Liniels: 'Aull Support 2 %' 3 ½' Veneer W 40 psf Maximum Meight. '5 Ghall Have 4' min, Bearing '6 Ghall Have 5' min, Bearing '6 Ghall Not Be Fastished Back to Hadder. '6 Ghall Be Fastished Back to Modo Header in Mail (add)'.

FOR QUEEN VENEER USE L4x34/4". FOR 3½" VENEER ONLY, SEE PLAN FOR VENEER SUPPORT IF VENEER < 3½" THICK.

ADDITIONAL NOTES FOR TRUSS \$ I-JOIST MANUFACTURER

ROOF TRUSS, FLOOR TRUSS AND ENGINEERED JOISTS SHALL BE DESIGNED TO MEET THE DEFLECTION CRITERIA BELOW, UNLESS NOTED OTHERWISE ON PLAN. MULHERN & KULP CANNOT BE HELD RESPONSIBLE FOR ANY STRUCTURAL ISSUES
RELATED TO ANY BUILDING COMPONENT IF COMPONENT SHOP DRAWINGS ARE NOT SUBMITTED TO M&K FOR REVIEW PRIOR TO FABRICATION, DELIVERY, OR INSTALLATION.

TRUSSES/JOISTS SHALL BE DESIGNED SO THAT DIFFERENTIAL DEFLECTION BETWEEN ADJACENT PARALLEL TRUSSES/JOISTS OR GIRDER TRUSSES/FLUS BEAMS DO NOT EXCEED THE FOLLOWING: A ROOF TRUSSES.

- I/4" DEAD LOAD
- FLOOR TRUSSES, ATTIC TRUSSES, & I-JOISTS:

ABSOLUTE DEAD LOAD DEFECTION OF FLOOR TRUSSES/ATTIC TRUSSES WHEN ADJACENT TO FLOOR FRAMING BY OTHERS SHALL BE LIMITED TO 3/16". (NO DIFFERENTIAL DEFLECTION)

FLOOR JOIST NOTES

- · ALL FLOOR JOISTS SHALL BE THE DEPTH SPECIFIED ON PLAN FLOOR JOISTS SERIES & SPACING IS PER THE FLOOR JOIST MANUF.
- SPACING SHALL NOT EXCEED 19.2" O.C. (MAX.) @ LOCATION OF TILE: SPACING SHALL NOT EXCEED 16" O.C. (MAX.)

LATERAL/WALL BRACING & WALL

THIS MODEL HAS BEEN DESIGNED TO RESIST LATERAL FORCES RESULTING FROM:

SHEATHING SPECIFICATIONS

5 MPH WIND IN 2018 NCSBC:RO

(115 MPH WIND SPEED IN ASCE 7-10 WIND MAP, PER IRC R301,2,1,1) EXP. B, RISK CAT. 2 & SEISMIC CAT. A/B.

THE DESIGN WAS COMPLETED PER 2015 IBC (SECTION 1609) & ASCE 7-10, AS PERMITTED BY R301.1.3 OF THE 2018 NGSBG:RG, ACCORDINGLY THIS MODEL, AS DOCUMENTED AND DETAILED HEREWITHIN, IS ADEQUATE TO RESIST THE CODE REQUIRED LATERAL FORCES.

DESIGN WIND UPLIFT LOADS HAVE BEEN CALCULATED UTILIZING ASCE 7-10 (ACCEPTED ENGINEERING PRACTICE) AS ALLOWED PER 2018 NCSBC:RC SECTION R802.II.I.I. THIS MODEL HAS BEEN DETAILED WHERE REQUIRED & ENGINEERED TO RESIST THE WIND UPLIFT LOAD PATH PER SECTIONS R602.3.5& R802.II.

EXT. WALL SHEATHING SPECIFICATION

- 7/16" OSB OR 15/32" PLYWOOD: FASTEN SHEATHING W/ 2 ₹x0.113 NAILS @ 6" O.C. AT EDGES & @ 12" O.C. IN THE PANEL FIELD. (TYP, U.N.O.)
- ALL SHEATHING PANELS SHALL BE ORIENTED VERTICALLY (LONG DIRECTION PARALLEL TO STUDS) AND INSTALLED FULL HEIGHT OF SHEAR WALL - OR 2x HORIZONTAL BLOCKING SHALL BE PROVIDED TO SUPPORT ALL UNSUPPORTED PANEL EDGES & EDGE
- ALL EXT. WALLS SHALL BE CONTINUOUSLY SHEATHED AND ARE CONSIDERED SHEAR WALLS.
- ALT. STAPLE CONNECTION SPEC: 1 3/4" 16 GA STAPLES (1/6" CROWN) @ 3" O.C. AT EDGES \$ @ 6" O.C IN FIELD.

3" O.C. EDGE NAILING

 AT DESIGNATED AREAS - FASTEN PANEL EDGES OF WOOD STRUCTURAL WALL SHEATHING TO FRAMING W 2 🖁 × 0.113" NAILS @ 3" O.C. AND 12" O.C. IN THE PANEL FIELD NO STAPLE ALTERNATIVE AVAILABLE AT THIS SPEC. ALL SHEATHING PANELS SHALL BE ORIENTED VERTICALLY (LONG DIRECTION PARALLEL TO STUD) AND INSTALLED FULL HEIGHT OF SHEAR WALL - OR - 2x HORIZONTAL BLOCKING SHALL BE PROVIDED TO SUPPORT UNSUPPORTED PANEL EDGES AND 3" O.C. EDGE FASTENING.

TYP. UNIT SEPARATION WALL SHEATHING SPECIFICATION

•1/2" OR 5/8" GYPSUM WALL BOARD: FASTEN GWB SHEATHING TO FRAMING W/ I \$"X0.086" COOLER NAILS OR I 1/4" DRYWALL SCREWS @ 7" O.C. " PANEL EDGES & PANEL FIELD (INCLUDING T&B PLATES

- SEE CONNECTION SPECIFICATIONS CHART FOR STANDARD SHEAR TRANSFER DETAILING. IF ADDITIONAL CAPACITY IS REQUIRED BY DESIGN. T WILL BE SPECIFICALLY NOTED ON PLAN.
- DESIGN ASSUMES 16" O.C MAX. STUD SPACING, U.N.O.
- ALL STRUCTURAL PANELS ARE TO BE DIRECTLY APPLIED TO STUD FRAMING.
- FASTEN TOGETHER END STUDS OF WALL PANELS SHEATHED W/ OSB OR PLYWOOD W/ 3" x 0.120" NAILS @ 4" O.C. (THRU ONE SIDE ONLY)

INDICATES EXTENT OF INT. OSB SHEARWALL, BLOCKED PANEL EDGES. AND/OR 3" O.C. EDGE NAILING

INDICATES HOLDOWN

MULHERN+KULP RESIDENTIAL STRUCTURAL ENGINEERING



lulhern+Kulp project numbe 243-2402

SMI MF(ssue date: 08-14-2024

REVISIONS


1/06/202 SMM LAME, OPT. EXT. COVID. PORCH, 2/16/2024 MEM ADDED DORMER TO ELEV. D 5/15/2025 MISC. ARCH. UPDATE

NOTE MOD GENERAL 03

SERENITY MASTER SET RALEIGH, NC 5919

S0.0

Standard Covered Outdoor Living w/ Opt Outdoor Living Patio

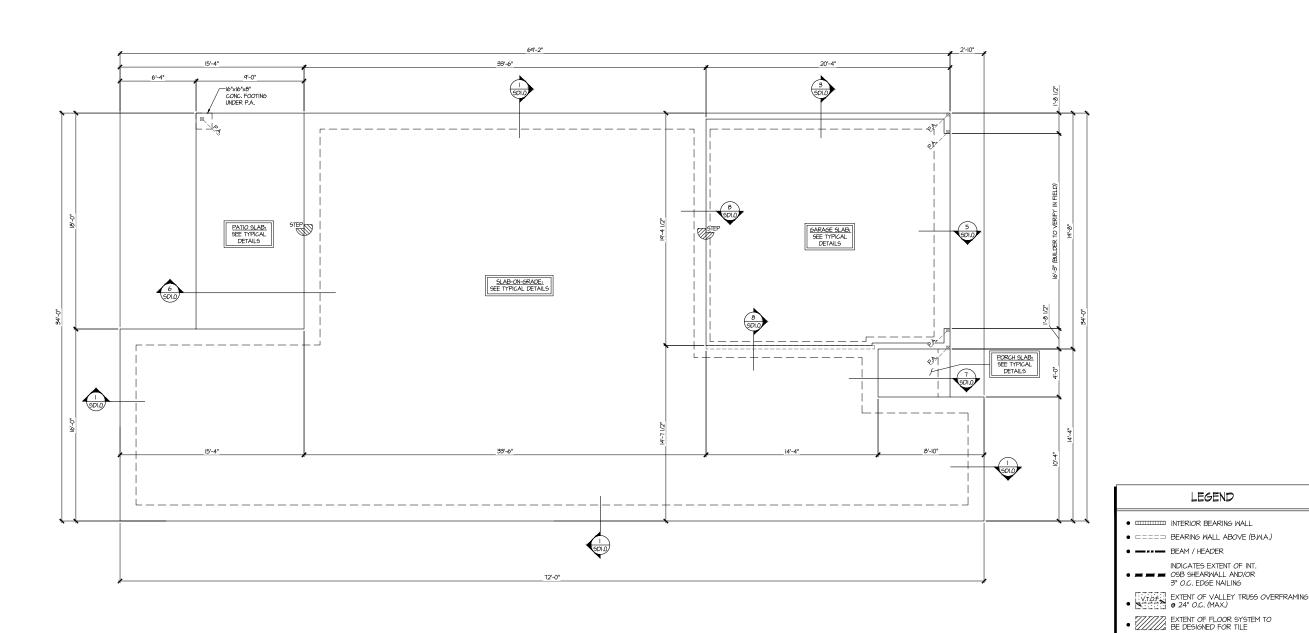

MULHERN+KULP
RESIDENTIAL STRUCTURAL ENSINEERING
3855 Broiside Parkway, Sain 250 - Aphwenta, GA 38022
p.776-777-4074 - mediamicapasam
NC License # C-38255



Mulhern+Kulp project number:

243-24029

SMK MEG issue date: 08-14-2024

REVISIONS:

initial: GAILE:
II/06/2024
UPDATED MODEL NAME, OPT. EX
OPT. OFFICE
I2/16/2024
ADDED DORMER TO ELEV. D
5/15/2025
MISC. ARCH. UPDATE SMM NAME, OPT. EXT. COVID. PORCH, MEM

tri pointe

LEGEND

* INDICATES POST ABOVE. PROVIDE SOLID BLOCKING UNDER POST OR JAMB ABOVE.

REFER TO SO.O FOR

TYPICAL STRUCTURAL NOTES

& SCHEDULES

NDICATES HOLDOWN


FOUNDATION PLAN 5919-03 MODEL

S1.0

SERENITY MASTER SET RALEIGH, NC

SLAB FOUNDATION PLAN SCALE: 1/4"=1'-0" (22x24 SHEET) 1/8"=1'-0" (IIXIT SHEET)

ELEV. A

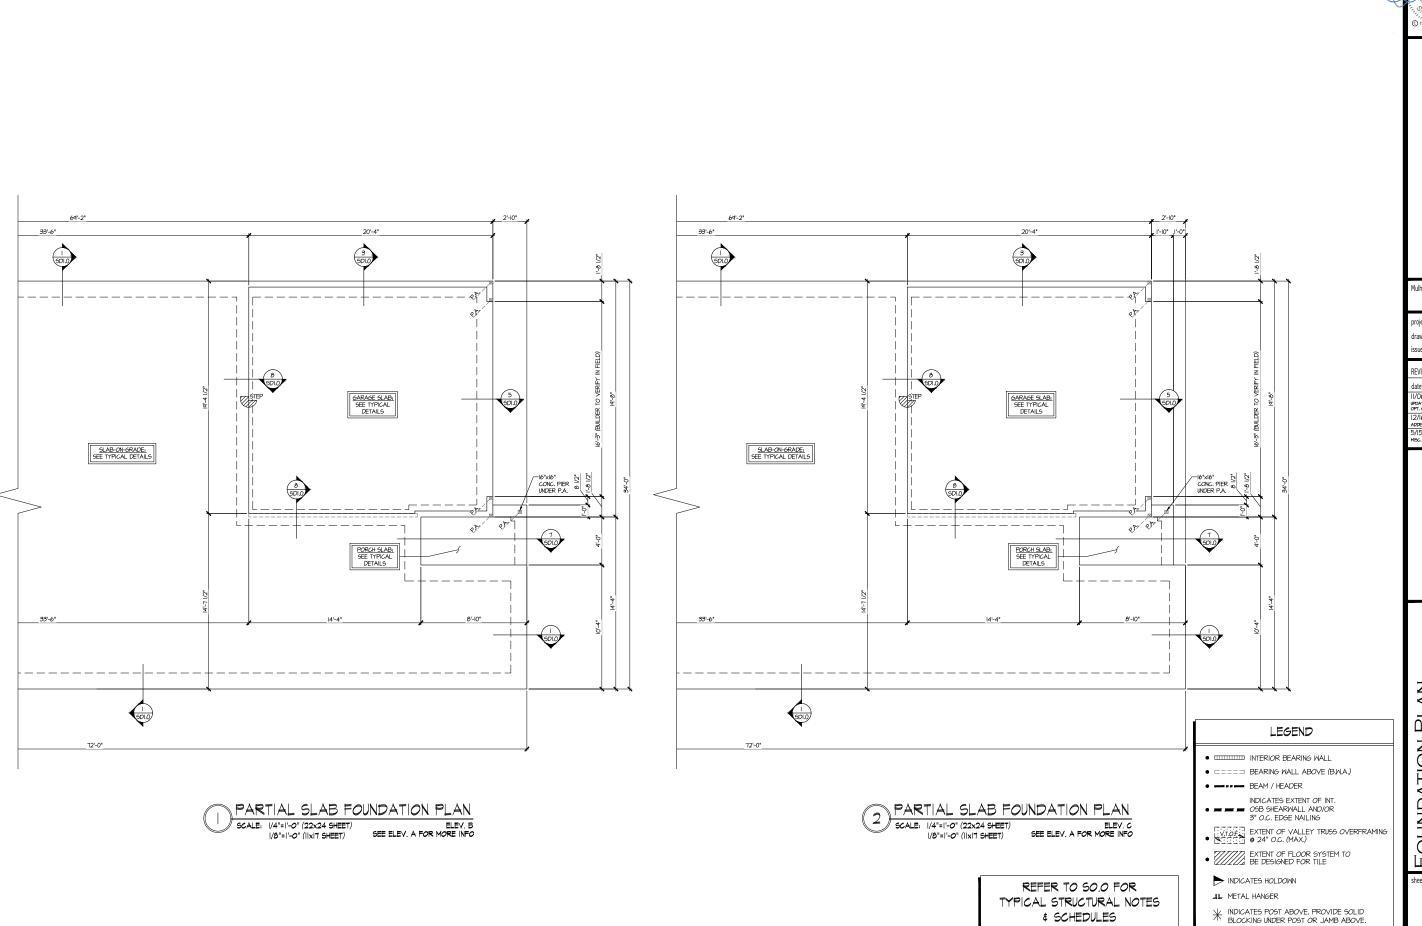

MULHERN+KULP

BESIDENTIAL STRUCTURAL ENGINEERING

WES Broadstor Parkway, Sale 250 - Aphweria, SA, 2002

P.TO-TT-0074 - multimatoposm

NC. Licence # C-3925

Mulhern+Kulp project number:

243-24029

SMK MEG issue date: 08-14-2024


REVISIONS:

initial: SMM NAME, OPT. EXT. COVID. PORCH, 11/06/2024 IPDATED MOPEL NAME, OPT. EX OPT. OFFICE IZ/16/2024 ADDED DORMER TO ELEV. D 5/15/2025 MISC. ARCH. UPDATE MEM

tri pointe

5919-03 MODEI SERENITY MASTER SET RALEIGH, NC

FOUNDATION PLAN

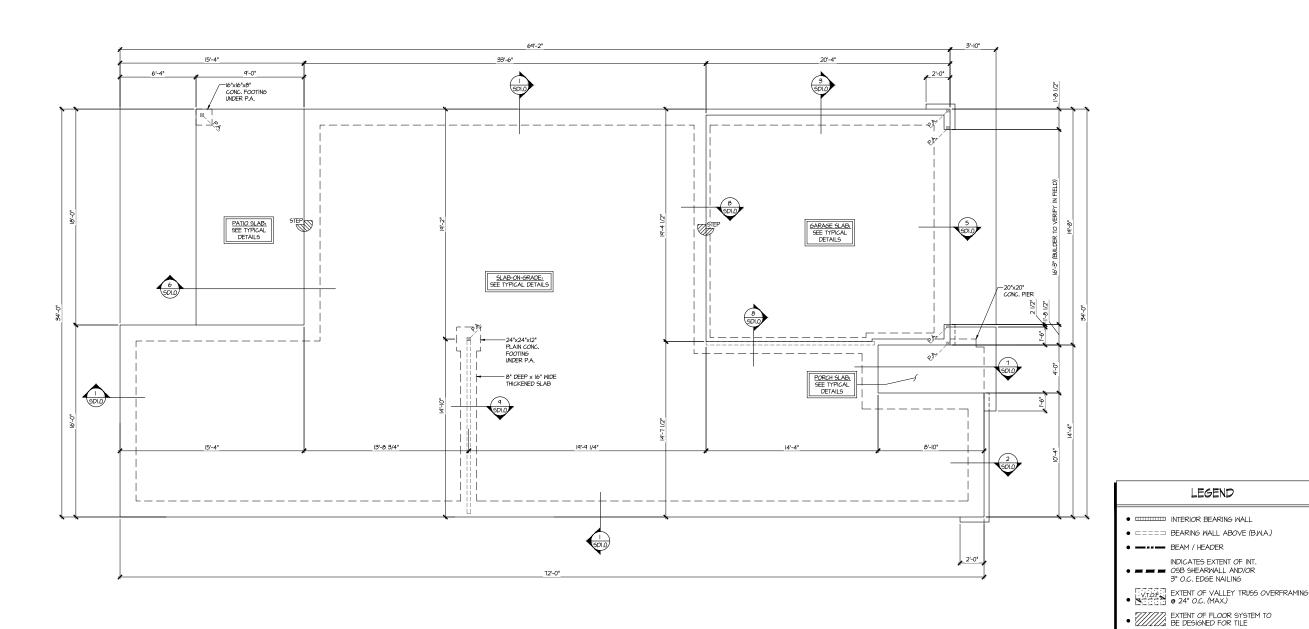

MULHERN+KULP

BESIDENTIAL STRUCTURAL ENSINEERING

SEES Brodiside Parkway, Saire 250 - Apharona, SA, 2002

P.TO-TT-4074 - methomicipsom

N. Licence # C-3825



Mulhern+Kulp project number:

243-24029

SMK MEG issue date: 08-14-2024

REVISIONS:

initial: GAILE:
II/06/2024
UPDATED MODEL NAME, OPT. EX
OPT. OFFICE
I2/16/2024
ADDED DORMER TO ELEV. D
5/15/2025
MISC. ARCH. UPDATE SMM NAME, OPT. EXT. COVID. PORCH, MEM

tri pointe

LEGEND

* INDICATES POST ABOVE. PROVIDE SOLID BLOCKING UNDER POST OR JAMB ABOVE.

REFER TO SO.O FOR

TYPICAL STRUCTURAL NOTES

SCHEDULES

NDICATES HOLDOWN


FOUNDATION PLAN 5919-03 MODEL

S1.2

SERENITY MASTER SET RALEIGH, NC

SLAB FOUNDATION PLAN SCALE: 1/4"=1'-0" (22x24 SHEET) 1/8"=1'-0" (IIxIT SHEET)

ELEV. D

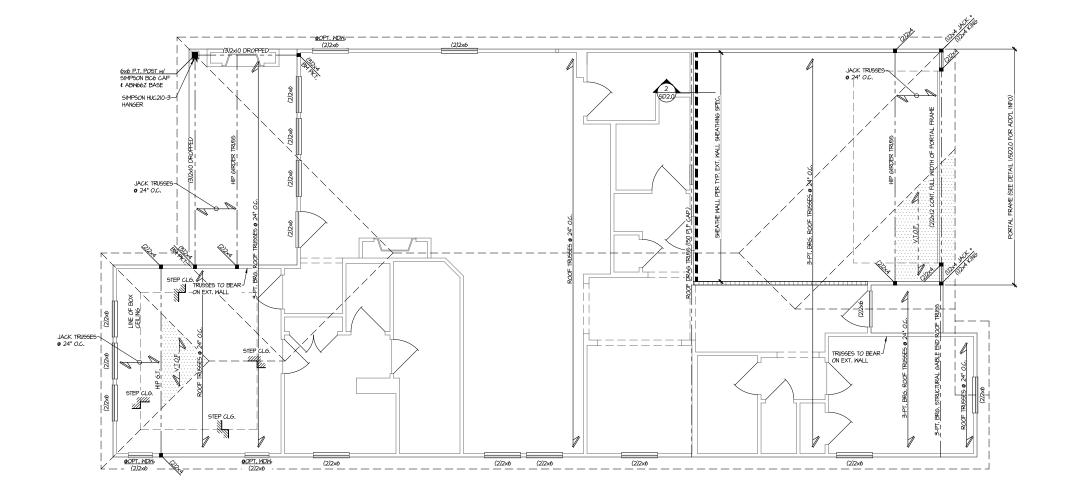



MULHERN + KULP

RESIDENTIAL STRUCTURAL ENGINEERING

3055 Brodside Parkway, Saire 250 - Alphaetta, GA 30022

P.778-777-4074 - morbornicapsom

NC Licence # C-38225



Mulhern+Kulp project number:

243-24029

project mgr: SMK drawn by: MEC issue date: 08-14-2024

REVISIONS:

tri pointe

THIS LEVEL HAS BEEN DESIGNED FOR 9'-I" PLATE HEIGHT

LEGEND

- INTERIOR BEARING WALL
- ==== BEARING WALL ABOVE (B.W.A.)
- BEAM / HEAD!
- INDICATES EXTENT OF INT.

 OSB SHEARWALL AND/OR
 3" O.C. EDGE NAILING
- EXTENT OF VALLEY TRUSS OVERFRAMING
 24" O.C. (MAX.)
- EXTENT OF FLOOR SYSTEM TO BE DESIGNED FOR TILE
- NDICATES HOLDOWN
- JL METAL HANGER
- | INDICATES POST ABOVE. PROVIDE SOLID BLOCKING UNDER POST OR JAMB ABOVE.

REFER TO SO.O FOR
TYPICAL STRUCTURAL NOTES
\$ SCHEDULES


ROOF FRAMING PLAN 5919-03 MODEL

S2.0

SERENITY MASTER SET RALEIGH, NC

ROOF FRAMING PLAN

SCALE: 1/4"=1"-0" (22x24 SHEET)
1/8"=1"-0" (11x17 SHEET)

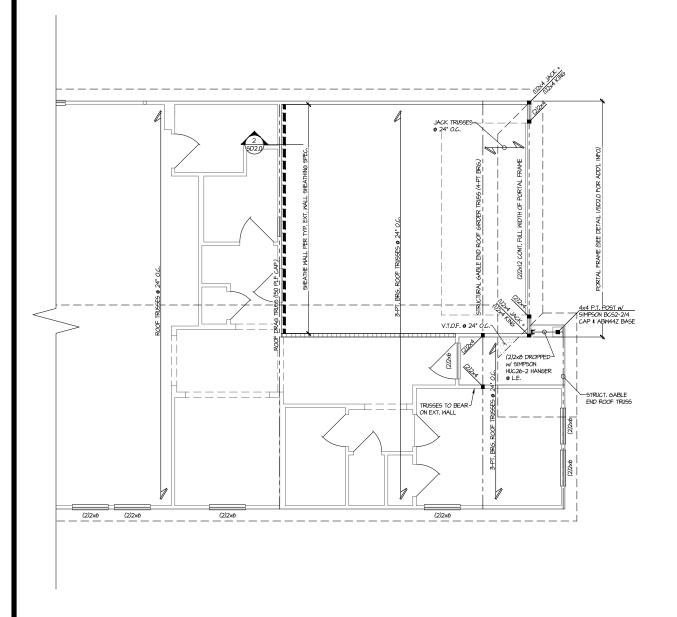

TRUSSES TO BEAR-(2)2x8 DROPPED-w/ SIMPSON HJC26-2 HANGER Ø L.E. -STRUCT, GABLE END ROOF TRUSS (2)2x6 (2)2x6 (2)2x6

PARTIAL SLAB FOUNDATION PLAN SCALE: 1/4"=1'-0" (22x24 SHEET) ELEV. B SEE ELEV. A FOR MORE INFO 1/8"=1'-0" (11x17 SHEET)

PARTIAL SLAB FOUNDATION PLAN

SCALE: 1/4"=1'-0" (22x24 SHEET) 1/8"=1'-0" (11x17 SHEET)

ELEV. C SEE ELEV. A FOR MORE INFO

THIS LEVEL HAS BEEN DESIGNED FOR 9'-1" PLATE HEIGHT

REFER TO SO.O FOR TYPICAL STRUCTURAL NOTES # SCHEDULES

LEGEND

- INTERIOR BEARING WALL
- □===□ BEARING WALL ABOVE (B.W.A.)
- BEAM / HEADER
- INDICATES EXTENT OF INT.

 OSB SHEARWALL AND/OR
 3" O.C. EDGE NAILING
- EXTENT OF VALLEY TRUSS OVERFRAMING 24" O.C. (MAX.)
- EXTENT OF FLOOR SYSTEM TO BE DESIGNED FOR TILE
- NDICATES HOLDOWN
- * INDICATES POST ABOVE. PROVIDE SOLID BLOCKING UNDER POST OR JAMB ABOVE.

MULHERN+KULP RESIDENTIAL STRUCTURAL ENGINEERING



Mulhern+Kulp project number:

243-24029

SMK MEG issue date: 08-14-2024

REVISIONS:


SMM NAME, OPT. EXT. COVID. PORCH, 11/06/2024 12/16/2024 ADDED DORMER TO ELEV. D 5/15/2025 MISC. ARCH. UPDATE MEM

tri pointe

ROOF FRAMING PLAN 5919-03 MODEI

SERENITY MASTER SET RALEIGH, NC

S2.1

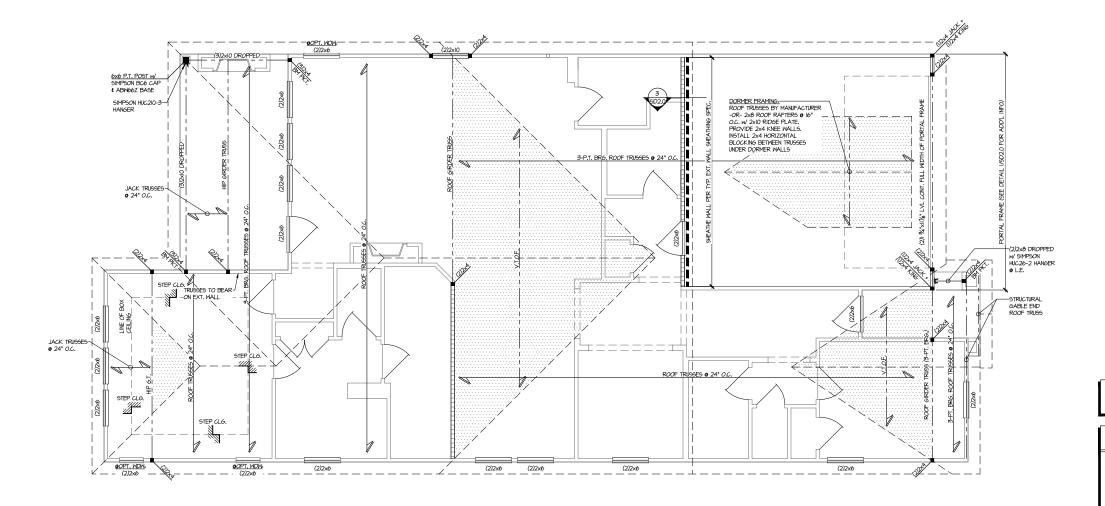

ROOF FRAMING PLAN SCALE: 1/4"=1'-0" (22x24 SHEET)

1/8"=1'-0" (IIxI7 SHEET)

ELEV. D

MULHERN+KULP
RESIDENTIAL STRUCTURAL ENSINEERING
3855 Broiside Parkway, Sain 250 - Aphwenta, GA 38022
p.776-777-4074 - mediamicapasam
NC License # C-38255



Mulhern+Kulp project number:

243-24029

SMK MEG issue date: 08-14-2024

REVISIONS:

initial: SMM NAME, OPT. EXT. COVID. PORCH, 11/06/2024 12/16/2024 ADDED DORMER TO ELEV. D 5/15/2025 MISC. ARCH. UPDATE MEM

tri pointe

THIS LEVEL HAS BEEN DESIGNED FOR 9'-I" PLATE HEIGHT

LEGEND

- IIIIII INTERIOR BEARING WALL
- ==== BEARING WALL ABOVE (B.W.A.)
- INDICATES EXTENT OF INT.


 OSB SHEARWALL AND/OR
 3" O.C. EDGE NAILING
- EXTENT OF VALLEY TRUSS OVERFRAMING
 24" O.C. (MAX.)
- EXTENT OF FLOOR SYSTEM TO BE DESIGNED FOR TILE
- ► INDICATES HOLDOWN
- | INDICATES POST ABOVE. PROVIDE SOLID BLOCKING UNDER POST OR JAMB ABOVE.

REFER TO SO.O FOR TYPICAL STRUCTURAL NOTES & SCHEDULES

ROOF FRAMING PLAN 5919-03 MODEI


S2.2

SERENITY MASTER SET RALEIGH, NC

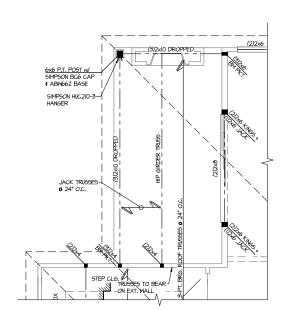

PARTIAL ROOF FRAMING PLAN OPT. 9080 MULTI SLIDE DOOR SCALE: 1/4"=1'-0" (22x24 SHEET) ELEV. A SHOWN. ALL ELEV. SIM.

1/8"=1'-0" (11x17 SHEET)

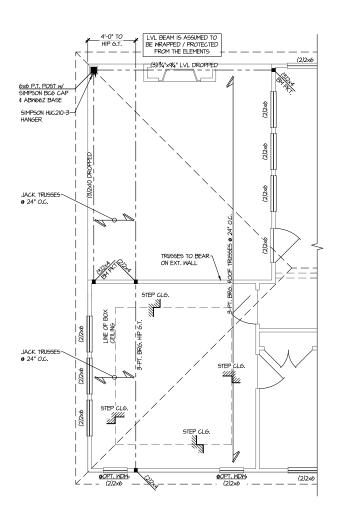


PARTIAL ROOF FRAMING PLAN OPT. EXT. COVERED PORCH

SCALE: 1/4"=1'-0" (22x24 SHEET)

1/8"=1'-0" (11x17 SHEET)


ELEV. A ALL ELEV. SIM. OPT. SCREENED EXTENDED COVERED OUTDOOR LIVING SIM.

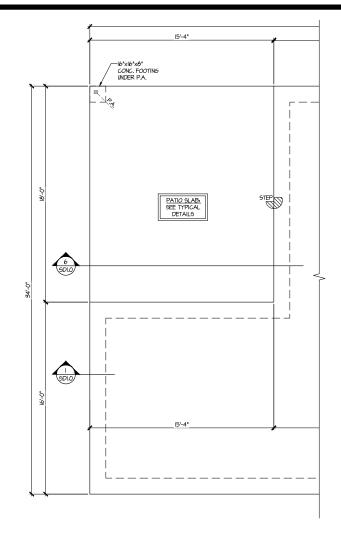

PARTIAL SLAB FOUNDATION PLAN OPT. EXT. COVERED PORCH

SCALE: 1/4"=1'-0" (22x24 SHEET)

ELEV. A ALL ELEV. SIM.

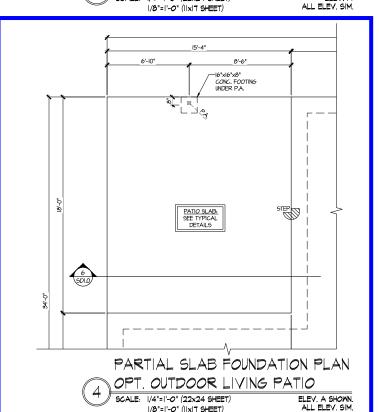



MULHERN+KULP
RESIDENTIAL STRUCTURAL ENGINEERING
SEES Bruscide Parkney, Sule 250 - Aphresia, 6A 3002
p.770-777-0074 - multimochanic



Mulhern+Kulp project number:

243-24029

SMK MEG issue date: 08-14-2024

REVISIONS:

initial: SMM NAME, OPT. EXT. COVID. PORCH, 11/06/2024 12/16/2024 ADDED DORMER TO ELEV. D 5/15/2025 MISC. ARCH. UPDATE MEM

tri pointe

THIS LEVEL HAS BEEN DESIGNED FOR 9'-1" PLATE HEIGHT

LEGEND

- INTERIOR BEARING WALL
- BEAM / HEADER
- INDICATES EXTENT OF INT.

 OSB SHEARWALL AND/OR 3" O.C. EDGE NAILING
- EXTENT OF VALLEY TRUSS OVERFRAMING


 224" O.C. (MAX.)
- EXTENT OF FLOOR SYSTEM TO BE DESIGNED FOR TILE
- NDICATES HOLDOWN
- INDICATES POST ABOVE. PROVIDE SOLID BLOCKING UNDER POST OR JAMB ABOVE.

REFER TO SO.O FOR TYPICAL STRUCTURAL NOTES & SCHEDULES

ROOF FRAMING PLAN

MODEI SERENITY MASTER SET RALEIGH, NC 5919-03

S3.0

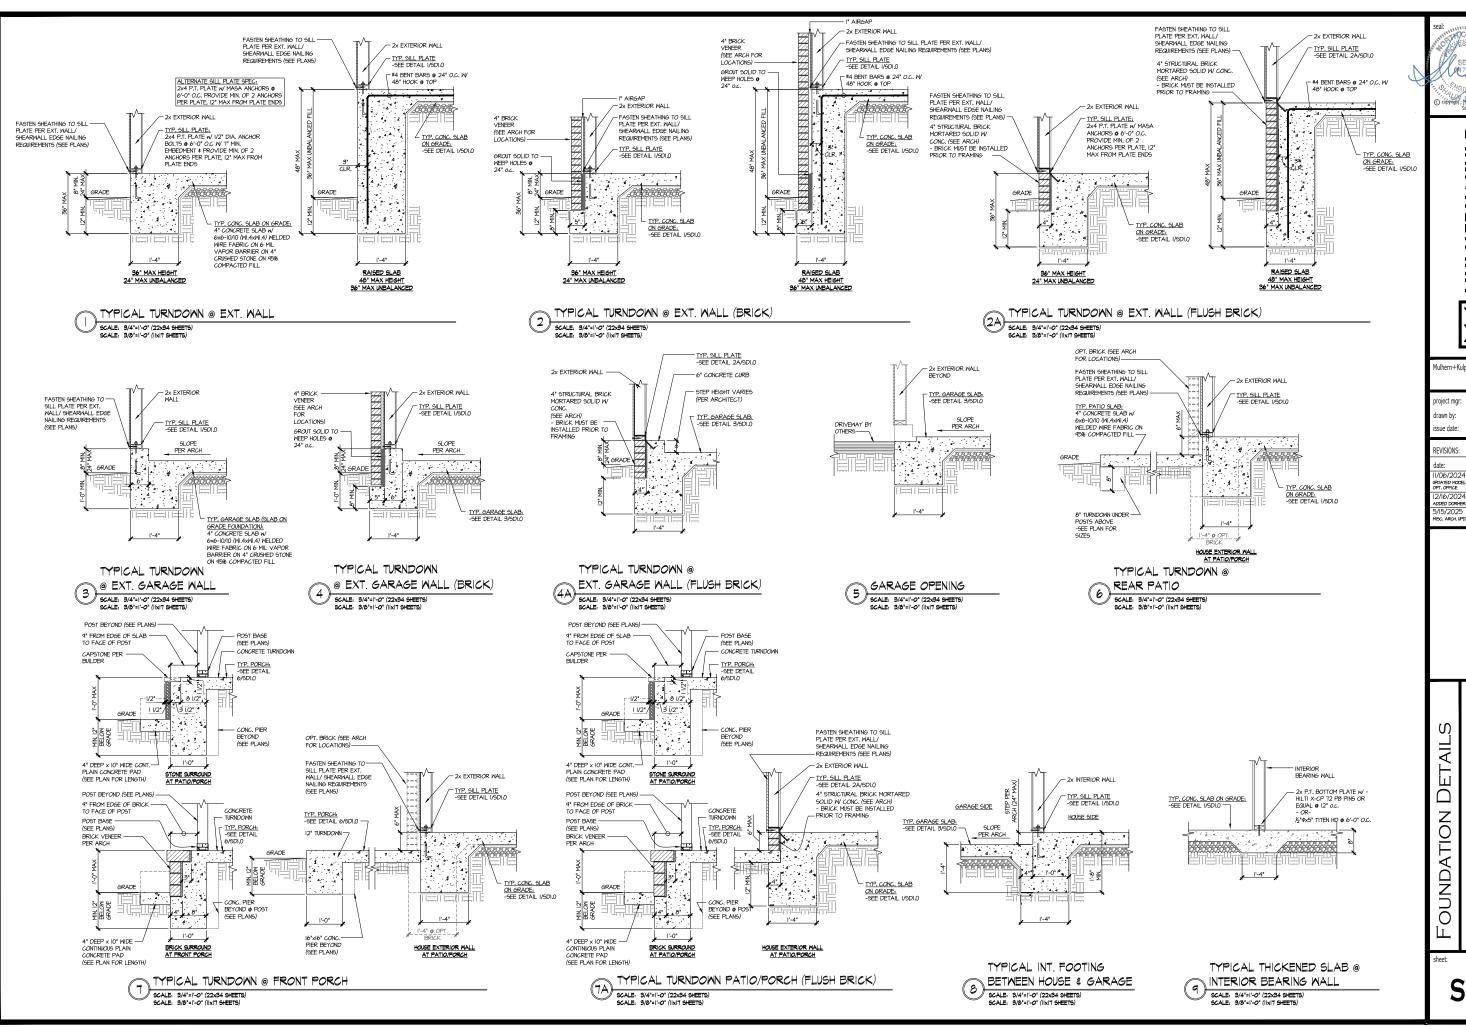

MULHERN+KULP
RESIDENTIAL STRUCTURAL ENGINEERING

lulhern+Kulp project number 243-2402

SMK MEC issue date: 08-14-2024


initial: SMM NAME, OPT. EXT. COVID. PORCH, 12/16/2024 ADDED DORMER TO ELEV. D 5/15/2025 MISC. ARCH. UPDATE MEM

pointe. HOMES

03

SERENITY MASTER SET RALEIGH, NC 5919

SD1.0

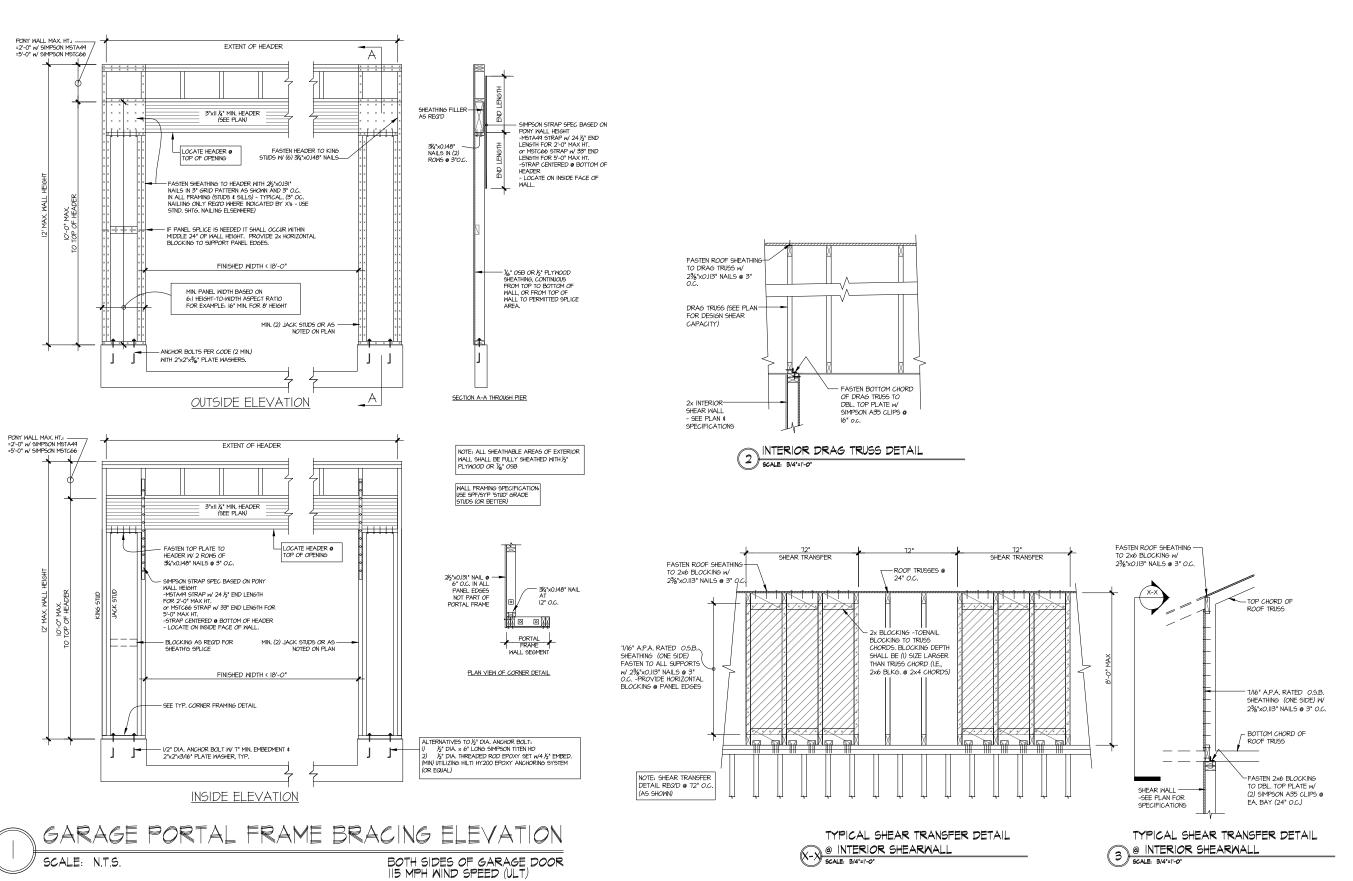

MULHERN+KULP
RESIDENTIAL STRUCTURAL ENGINEERING
SEES Bruscide Parkney, Sule 250 - Aphresia, 6A 3002
p.770-777-0074 - multimochanic



Aulhern+Kulp project number

243-24029

SMK MEC issue date: 08-14-2024

REVISIONS:


initial: SMM NAME, OPT. EXT. COVID. PORCH, 11/06/2024 12/16/2024 ADDED DORMER TO ELEV. D 5/15/2025 MISC. ARCH. UPDATE MEM


tri pointe

FRAMING DETAILS MODEI

SERENITY MASTER SET RALEIGH, NC -03 5919-

SD2.0

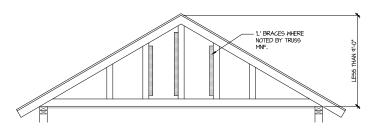

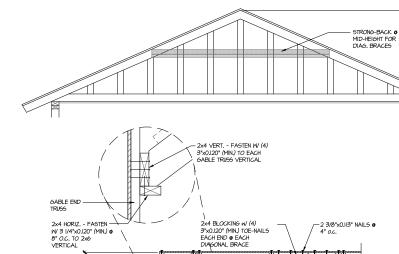


2x6 DIAG. BRACE (w/ 2x4
T-BRACE IF LENGTH EXCEEDS 61),
SPACED 6 4-0" O.C. MAX. FASTEN
2x4 T0 2x6 w/ 3"x0.120" (MIN.)
NAILS 6 8" O.C.

E E E STRONG-BACK & MID-HEIGHT (MIN. 4'-6")

GABLE END TRUSS SHEATHED -WITH OSB.

FASTEN BOTTOM CHORD OF — GABLE END TRUSS TO DBL. TOP PLATE w/ 3"X0.120" (MIN.) TOE-NAILS @ 8" O.C.

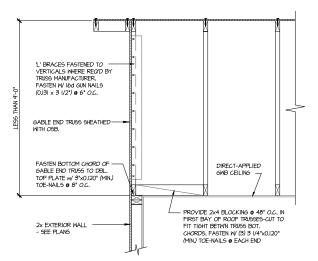

TYPICAL GABLE END BRACING DETAIL
SCALE: NONE REOD & GABLE END TRUSS
HEIGHT UP TO 4'-0'

BRACE GABLE END TRUSSES PER ABOVE DETAIL WHEN GABLE HEIGHT IS LESS THAN 9"-0". "L" BRACES REQUIRED WHERE NOTED BY TRUSS MANUFACTURER.

TYPICAL GABLE END BRACING DETAIL
SCALE: NONE REDO 6 ABLE END TRUSS
HEIGHT BETRIN 91-0* TO 14-0*

- PROVIDE 2x4 BLOCKING @ 48° O.C. IN FIRST BAY OF ROOF TRUSSES-CUT TO FIT TIGHT BETINN TRUSS BOT. CHORDS, FASTEN W (4) 3°X0,120° (MIN.) TOE-NAILS @ EACH END

(4) 3"x0.120"_j

- (8) 3"x0,120" (MIN.) NAILS

BRACE GABLE END TRUSSES PER ABOVE DETAIL WHEN GABLE HEIGHT EXCEEDS 9'-0'. "L' BRACES NOT REQUIRED. SEAL PROPERTY STREET, Inc.

MULHERN + KULP

RESIDENTIAL STRUCTURAL ENSINEERING

3655 Broiside Parkway, Sale 250 - Aphaesta, 6A 30022

P.770-777-6074 - mortemizapean

NC Licence # C-38.25



Mulhern+Kulp project number:

243-24029

project mgr: SMK drawn by: MEC issue date: 08-14-2024

REVISIONS:

tri pointe

FRAMING DETAILS

5919–03 MODEI Serenity Master set Raleigh, nc

sheet:

SD2.1