

COLLEX595INVENTORYMARKEDPLAN

Dream Finders Homes

JORDAN

JORDAN

REVISION LIST - STRUCTURAL:

1. CODE UPDATE TO SCRC 2018 (1-20)
2. CHANGE 2X6 EXTERIOR WALLS TO 2X4 EXTERIOR WALLS. (3-5-20)
3. ADDED BASEMENT PLAN WHICH EXTENDS GARAGE FRONT 2'-0". (5-1-20)
4. UPDATING SC CODE FROM 2018 TO 2021 (11-28-22)

JORDAN

REVISION LIST - ARCHITECTURAL:

1. CHANGED WINDOW IN OPTIONAL OWNERS BATH 3 FROM 2'-0" 4'-0" TO A 4'-0" 1'-0" TRANSOM
2. CHANGED ATTIC ACCESS FROM 2'-0" 4'-0" TO 22 1/2" X 38"
3. OPTIONAL BRICK/STONE WATERTABLE ADDED TO SIDE & REAR ELEVATIONS
4. REMOVED DIMENSIONS FROM ATTIC DOORS IN OPT. BEDROOM 4 ILO STUDY & SECOND FLOOR PLAN STUDY 7-12-23




COVER SHEET

DREAM FINDERS HOMES
JORDAN

PD: NOVEMBER 28, 2022
DRAWN BY:
ENGINEERED BY:
REVIEWED BY:

CS

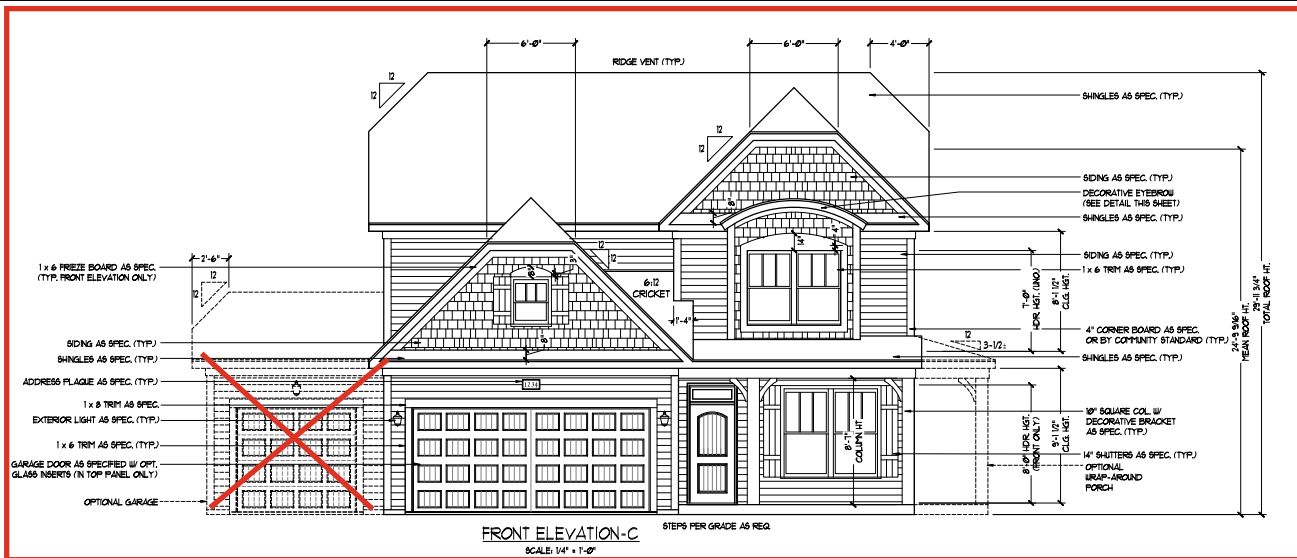

1 x 8 TRIM AS SPEC. (TYP.)

1 x 2 TRIM AS SPEC. (TYP.)

GARAGE DOOR AS SPECIFIED w/ OPT. GLASS INSERTS (IN TOP PANEL ONLY.)

[illegible]

SIDING (TYP.) 4021-
 USE VENER UP TO WATER
 TABLE ELEVATION 4-4 ONLY
 (SEE SHEET 4-12)

EXTERIOR
 LIGHT AS SPEC.
 (TYP.)

SHINGLES

OPTIONAL 1/4" PRIZEE BOARD

OPT. FIREPLACE

1'-0" C.G. NOT.
 1'-0" C.G. NOT.
 1'-0" C.G. NOT.
 1'-0" C.G. NOT.
 1'-0" C.G. NOT.
 1'-0" C.G. NOT.

OPT. PORCH

OPT. BASEMENT

EXTERIOR
 LIGHT AS SPEC.
 (TYP.)

REAR ELEVATION

SCALE: 1/8" = 1'-0"

WATER TABLE (SHINGLES) - OVER VENEER ELEVATION C-4 ONLY (SEE SHEET A-32)

SHINGLES

CRICKET BEYOND

SHINGLES

SIDING

OPTIONAL 1x6 FREEZE BOARD

REMOVE WINDOW WITH BEDROOM 5 OPTION

OPT. 12'-0" WIDE X 10'-0" DEEP PORCH OPTION

ONE-CAR GARAGE OPT.

OPT. EXTERIOR LIGHT AS SPEC. (TYP.)

WRAP AROUND PORCH OPTION

OPT. BRICK-STONE WATERTABLE PER COMMUNITY SPEC.

SIDING (TYP.) NOTE: USE VENEER UP TO WATER TABLE ELEVATION C-4 ONLY (SEE SHEET A-32)

OPT. FIREPLACE

7'-0" FIN. HGT.

7'-0" FIN. HGT.











5'-6" HGT.

5'-6" HGT.

CL. 10'-0" CL. 10'-0"

SIDE ELEVATION


SCALE: 1/8" = 1'-0"

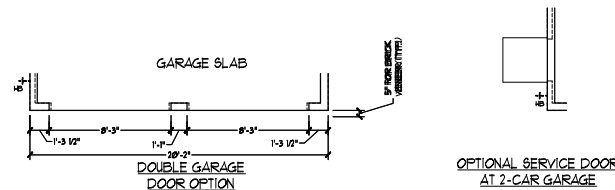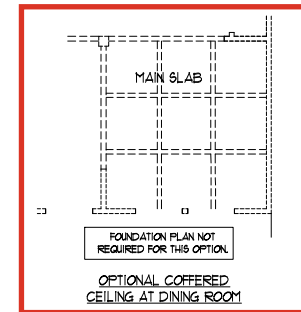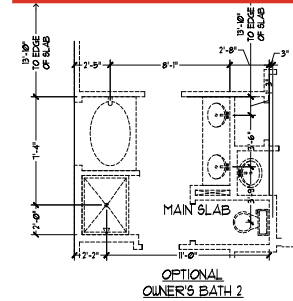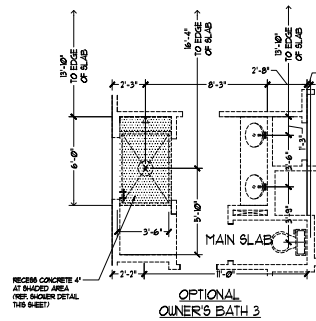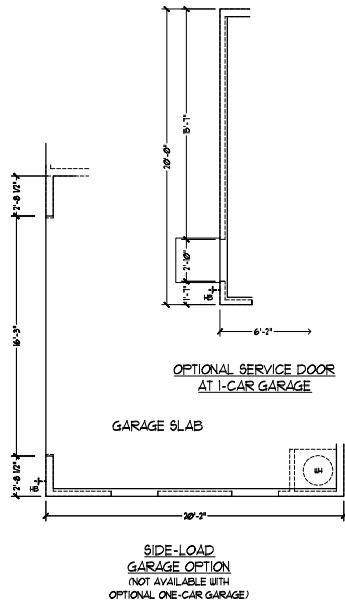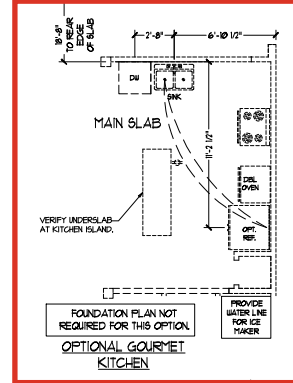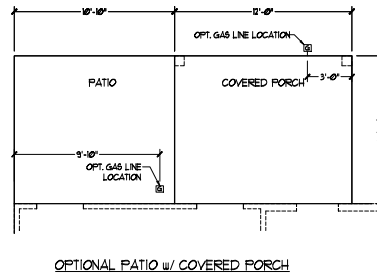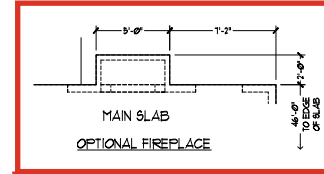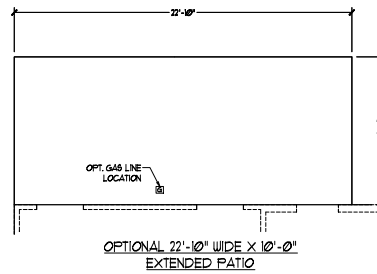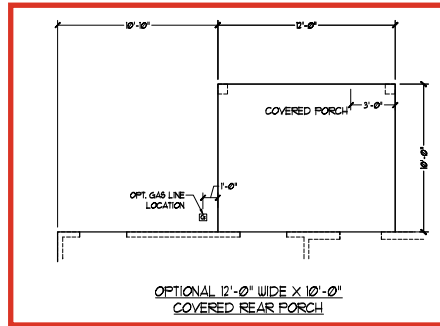

NOTE: ALL EXTERIOR WALLS AND ATTIC WALLS ARE TO BE 2' x 4' @ 16" O.C. (NO.) ALL INTERIOR LOAD BEARING WALLS ARE TO BE 2' x 4' @ 16" O.C. (NO) AND NON-LOAD BEARING INTERIOR WALLS ARE TO BE 2' x 4' @ 24" O.C. (NO.)

2nd WALL

- SHAVED WALLS ARE TO BE 2' x 6' @ 16" O.C. (LOAD BEARING) OR 2' x 4' @ 24" O.C. (NON-LOAD BEARING) REGARDLESS OF EXTERIOR WALL CONDITION

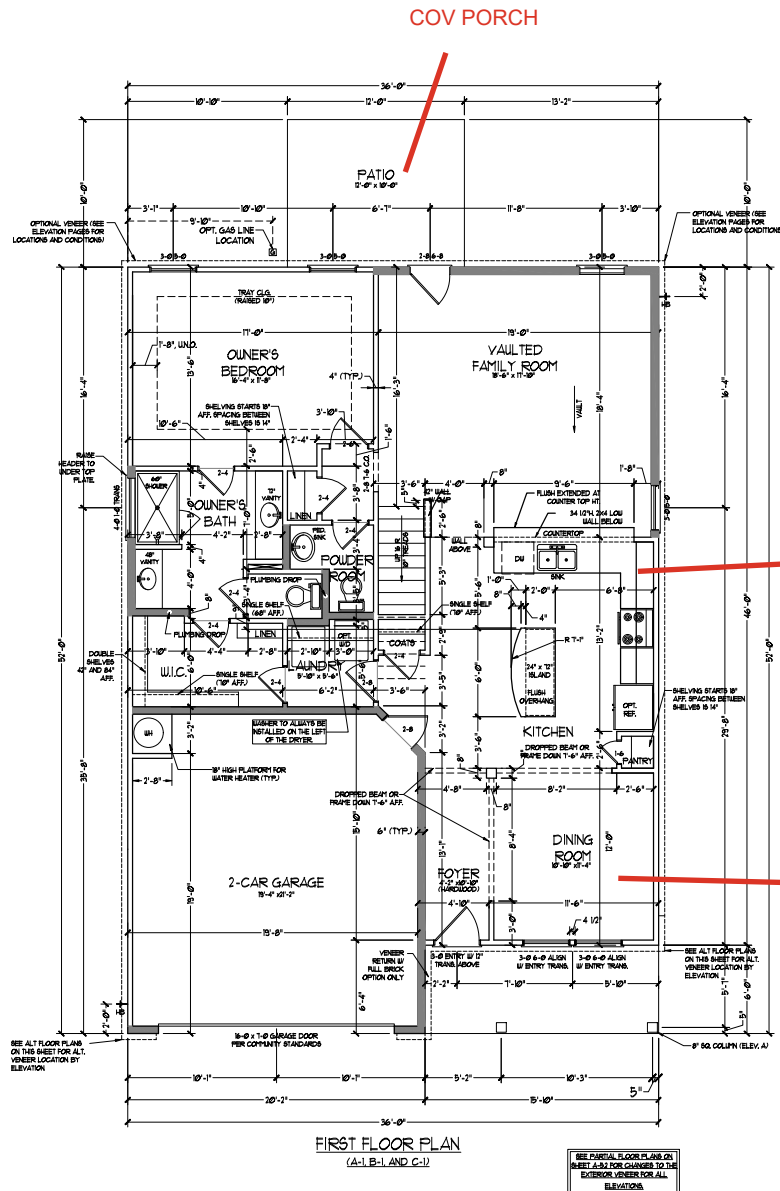

COV PORCH

- GOURMET KITCHEN

- COFFERED CEILING



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DREAM FINDERS HOMES
JORDAN

FD.: NOVEMBER 28, 2022

SCALE: 1/4"=1'-0"


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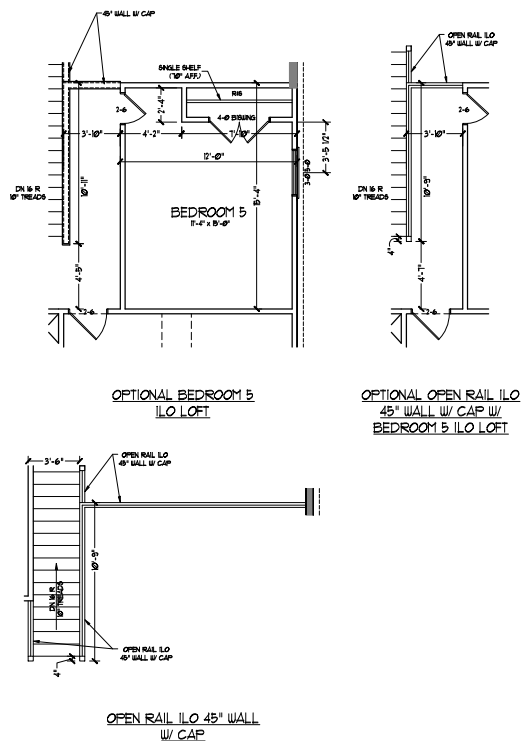
REVIEWED BY:

FIRST FLOOR
PLAN


A-6



SECOND FLOOR
PLAN
A-7

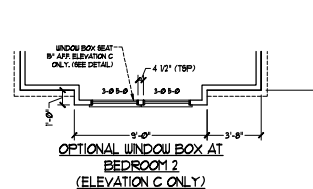

TOTAL UNDER ROOF AREA		1667 SQ. FT. / 300 -	1667 SQ. FT.
VENTING AREA REQUIRED TO ALL EXHAUSTS		1667 SQ. FT. / 300 -	5.56 SQ. FT.
		LOW OR 2.28	UPPER: 2.28
LOWER AREA VENTING			
SCAFF VENT	SIZE	PER UNIT	# UNITS
	-	(4) 1/2" I.F.	77-97
			3.2
LOWER AREA VENTING PROVIDED		-	
UPPER AREA VENTING			
SCAFF VENT	SIZE	PER UNIT	# UNITS
	-	(1) 1/2" I.F.	32-47
			4.2
UPPER AREA VENTING PROVIDED		-	
TOTAL AREA PROVIDED			
SCAFF AND RIDGE VENT		7.2	

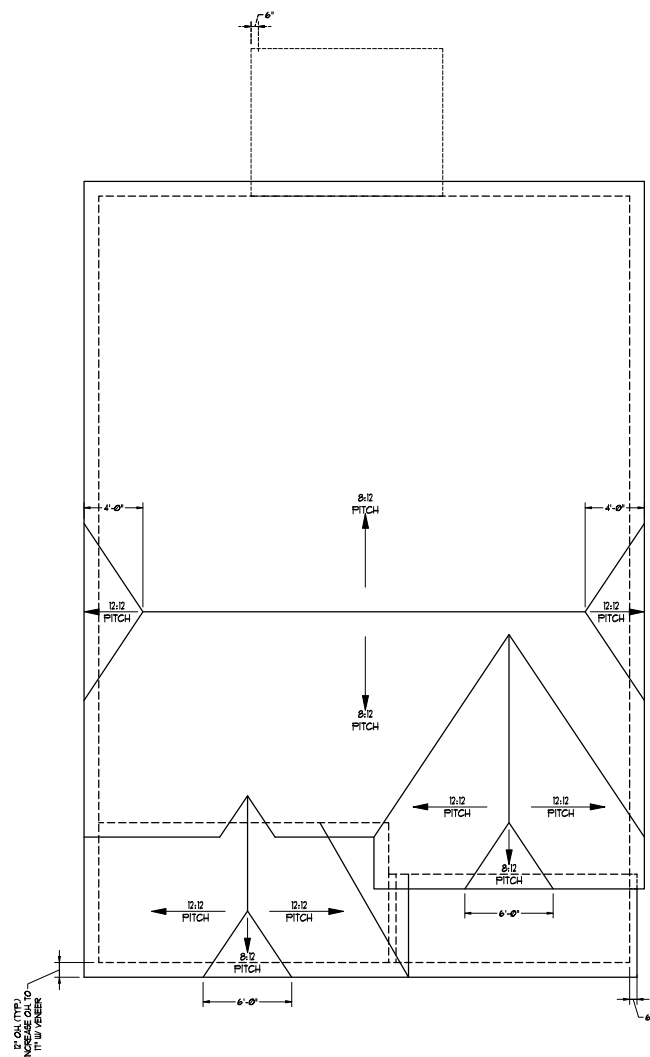

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DREAM FINDERS HOMES
JORDAN

PD.: NOVEMBER 28, 2022

SCALE: 1/4"=1'-0"

DRAWN BY:



ENGINEERED BY:

REVIEWED BY:

ROOF PLAN
ELEVATION - C
A-8.1



DREAM FINDERS
HOMES

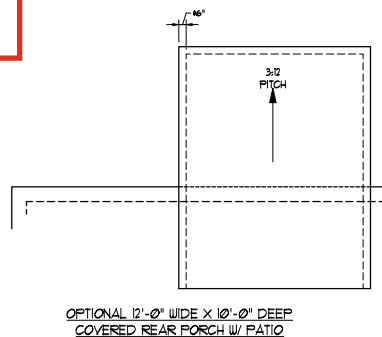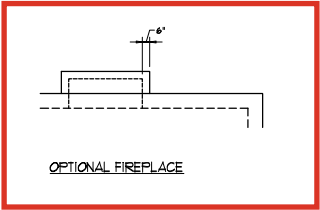

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DREAM FINDERS HOMES
JORDAN

PD.: NOVEMBER 28, 2022

SCALE: 1/4"=1'-0"

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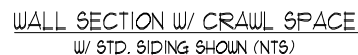
ROOF PLAN

ELEVATION - A/B

&C

402

A-8.2



STAR NOTES:

BAILING
BAILSTERS SHALL BE SPACED TO THAT A 4" SPACING CANNOT PASS THROUGH.

THE TRIANGULAR OPENINGS FORMED BY THE REAR HEAD AND BOTTOM RAIL OF A GUARD AT THE OPEN END OF A STANWAY ARE PERMITTED TO BE SUCH A SIZE THAT A SPHERE OF 4" DIAMETER CANNOT PASS THROUGH.

OPENINGS FOR ROLLERS GUARDING THE SIDES OF STAIR TRUCKS SHALL NOT ALLOW A SPHERE 4 INCHES TO PASS THROUGH.

HANDRAILS
HANDRAILS FOR STANWAYS SHALL BE CONTINUOUS FOR THE FULL LENGTH OF THE FLIGHT FROM A POINT DIRECTLY ABOVE THE FIRST STEP TO A POINT DIRECTLY ABOVE THE LAST STEP. THE LOWEST RISER, HANDRAIL ENDS SHALL BE RETURNED OR SHALL TERMINATE IN NEEL FLOORS OR GATEWAY TERRACES.
HANDRAILS ADJACENT TO WALLS SHALL HAVE A SPACE OF NOT LESS THAN 1-1/2 INCH BETWEEN THE WALL AND HANDRAILS.

CONTINUOUS GRAPHS/ WALLS, MUST MEET TYPE OR BE THE OTHER

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DREAM FINDERS HOMES
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PD.: NOVEMBER 28, 2022

SCALE: 1/4"=1'-0"

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






















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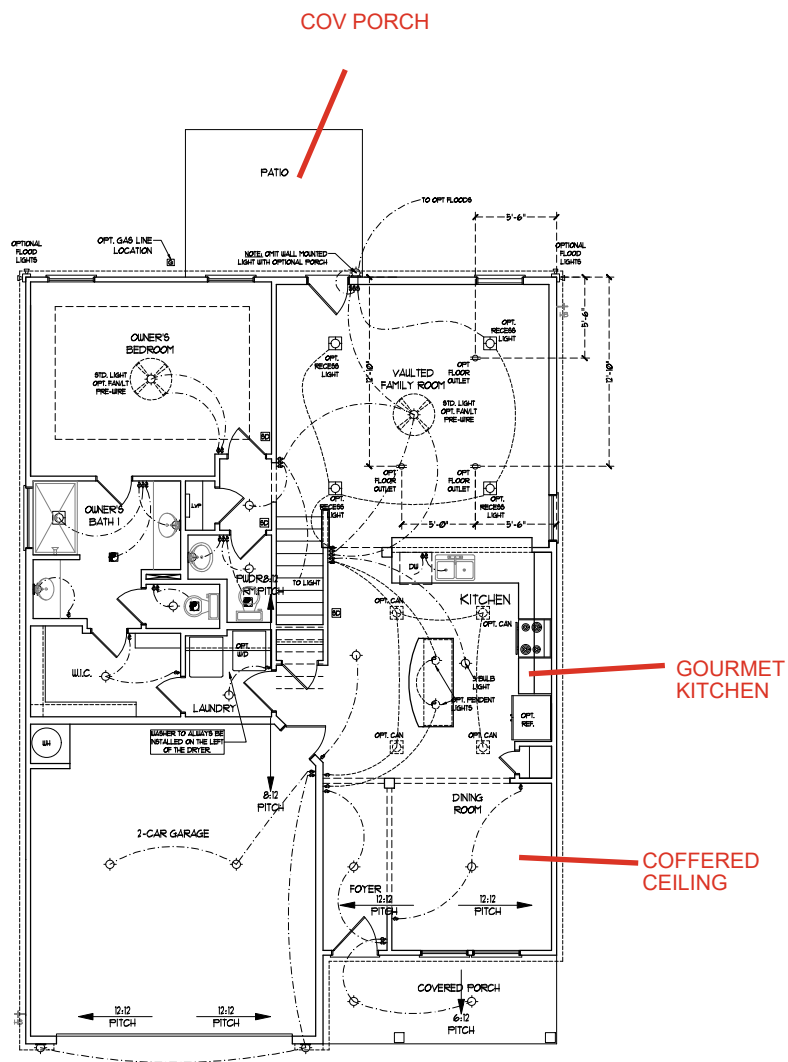
WALL SECTIONS AND STAIR DETAIL

AD-1

DREAM FINDERS
HOMES

- 1) BLOCK AND WIRE FOR ALL
CEILING FANS PER PLAN.
- 2) VANITY LIGHTS TO BE SET
@ 90° AFF. (TYP.)
- 3) ADDITIONAL EXTERIOR OUTLETS
REQUIRED BY CODE TO BE
LOCATED BY ELECTRICIAN.
- 4) PLACE SWITCHES 8" MIN FROM
ROUGH OPENINGS.

ELECTRICAL LEGEND	
	NO V. OUTLET
	WALL MOUNT LIGHT
	CEILING MOUNT LIGHT
	PENDANT LIGHT
	RECESSED CAN LIGHT
	TRN CAN LIGHT
	INTBALL LIGHT
	FLUORESCENT LIGHT
	2 LAMP, 4 FLUORESCENT
	FLOOD LIGHT
	SWITCH
	3-WAY SWITCH
	4-WAY SWITCH
	COPPER SHIRT COMPONENT
	LIFING
	SPREADER
	DOORBELL CHIME
	NO V. SMOKE DETECTOR
	CO DETECTOR
	SHOWER PAN
	LOW VOLTAGE PANEL
	CEILING FAN
	CEILING FAN W/ LIGHT













FIRST FLOOR PLAN
(A-1, B-1, AND C-1)

ELECTRICAL LAYOUT NOTES:

- 1) BLOCK AND WIRE FOR ALL CEILING FANS PER PLAN.
- 2) VANITY LIGHTS TO BE SET # 30" APP. (TYP)
- 3) ADDITIONAL EXTERIOR OUTLETS REQUIRED BY CODE TO BE LOCATED BY ELECTRICIAN.
- 4) PLACE SWITCHES IF 1" MIN FROM ROUGH OPENING.

ELECTRICAL LEGEND

	10 V OUTLET
	WALL MOUNT LIGHT
	CEILING MOUNT LIGHT
	PENDANT LIGHT
	RECESSED CAN LIGHT
	WAX CAN LIGHT
	EXTERNAL LIGHT
	FLUORESCENT LIGHT
	2 LAMP, 4 FLUORESCENT LIGHT
	FLOOD LIGHT
	SWITCH
	3-WAY SWITCH
	4-WAY SWITCH
	DIMMER SWITCH
	CONDUIT FOR COMPONENT WIRING
	BREAKER
	DOORBELL CHIME
	10 V SMOKE DETECTOR
	CO DETECTOR
	EXHAUST FAN
	LOW VOLTAGE PANEL
	CEILING FAN
	CEILING FAN W/ LIGHT

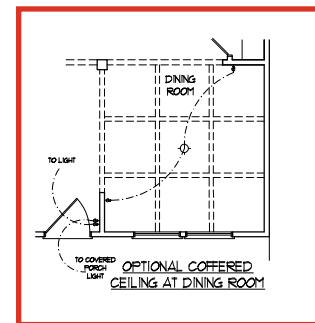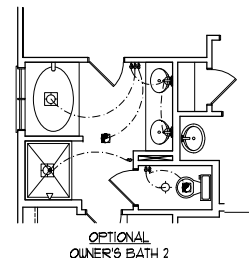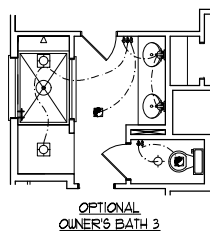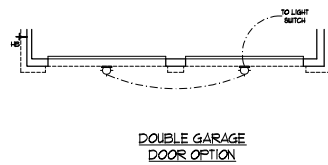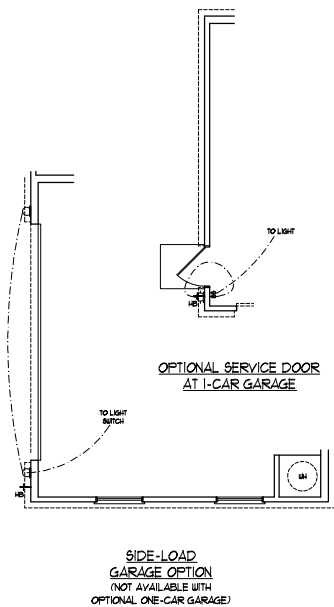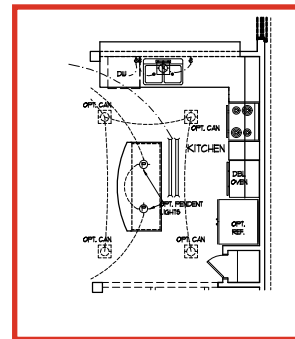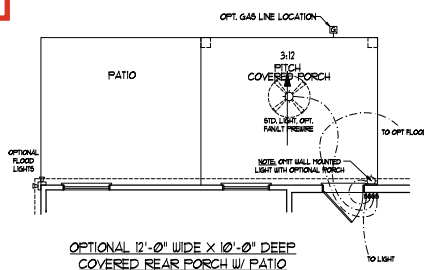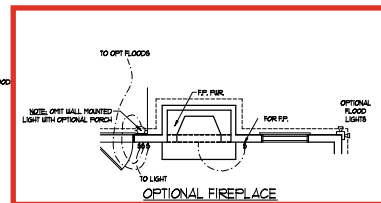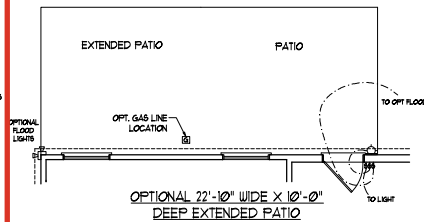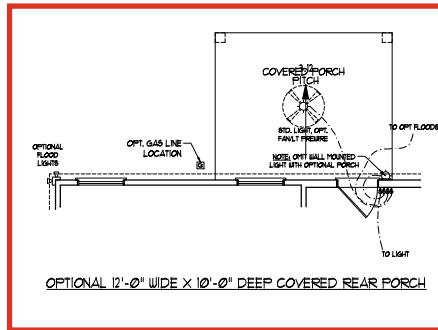

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DREAM FINDER HOMES
JORDAN

PD: NOVEMBER 28, 2022

SCALE: 1/4" = 1'-0"

DRAWN BY:

ENGINEERED BY:

REVIEWED BY:

FIRST FLOOR ELECTRICAL OPTIONS

E-1.1


ELECTRICAL LAYOUT NOTES:

- 1/ BLOCK AND WIRE FOR ALL CEILING FAN PENTRAIL.
- 2/ VANTY LIGHTS TO BE SET # 800 APP. (TYP)
- 3/ ADDITIONAL EXTERIOR OUTLETS REQUIRED BY CODE TO BE LOCATED BY ELECTRICIAN.
- 4/ PLACE SWITCHES 12" FROM ROUGH OPENING.

ELECTRICAL LEGEND

	10 V OUTLET
	WALL MOUNT LIGHT
	CEILING MOUNT LIGHT
	PENDANT LIGHT
	RECESSED CAN LIGHT
	RM CAN LIGHT
	ETERNAL LIGHT
	FLUORESCENT LIGHT
	2 LAMP, 2 FLUORESCENT LIGHT
	FLOOD LIGHT
	SWITCH
	3-WAY SWITCH
	4-WAY SWITCH
	DIMMER SWITCH
	CONDUIT FOR COMPONENT WIRING
	SPEAKER
	DOORBELL CHIME
	10 V SMOKE DETECTOR
	CO DETECTOR
	EXHAUST FAN
	LOW VOLTAGE PANEL
	CEILING FAN
	CEILING FAN W/ LIGHT

BED #4

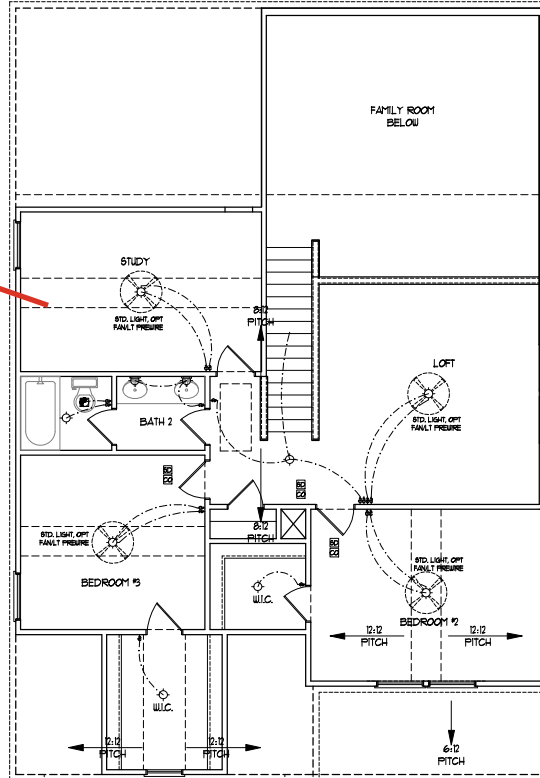

SECOND FLOOR PLAN
(A-1, B-1, AND C-1)



OPTIONAL WINDOW BOX AT
BEDROOM 2
(ELEVATION C ONLY)

DREAM FINDERS
HOMES

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COPYRIGHT © DREAM FINDERS HOMES

DREAM FINDERS HOMES
JORDAN

PD, NOVEMBER 28, 2022

SCALE: 1/4" = 1'-0"

DRAWN BY:

ENGINEERED BY:

REVIEWED BY:

SECOND FLOOR
ELECTRICAL
PLAN





E-2

ELECTRICAL LAYOUT NOTES:

- 1) BLOCK AND WIRE FOR ALL CEILING FAN PENTRAL.
- 2) VINTY LIGHTS TO BE SET # 80" APP. (TYP)
- 3) ADDITIONAL EXTERIOR OUTLETS REQUIRED BY CODE TO BE LOCATED BY ELECTRICIAN.
- 4) PLACE SWITCHES 8" (MIN) FROM ROUGH OPENING.

ELECTRICAL LEGEND

	10 V OUTLET
	WALL MOUNT LIGHT
	CEILING MOUNT LIGHT
	PENDANT LIGHT
	RECESSED CAN LIGHT
	TRI CAN LIGHT
	ETERNAL LIGHT
	FLUORESCENT LIGHT
	2 LAMP, 2 FLUORESCENT LIGHT
	FLOOD LIGHT
	SWITCH
	3-WAY SWITCH
	4-WAY SWITCH
	DIMMER SWITCH
	CONDUIT FOR COMPONENT WIRING
	SPEAKER
	DOORBELL CHIME
	10 V SMOKE DETECTOR
	CO DETECTOR
	EXHAUST FAN
	LOW VOLTAGE PANEL
	CEILING FAN
	CEILING FAN W/ LIGHT

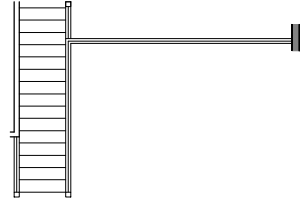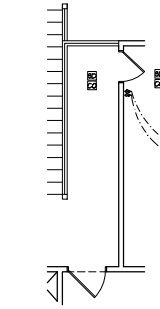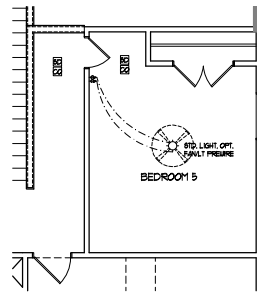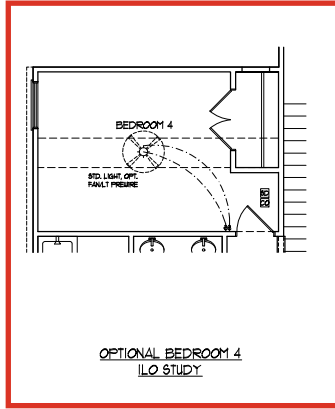

PRICES, PROMOTIONS, INCENTIVES, FEATURES, OPTIONS, FLOOR PLANS, ELEVATIONS, DESIGNS, MATERIALS AND FINISHES ARE SUBJECT TO CHANGE WITHOUT NOTICE. SQUARE FOOTAGE AND DIMENSIONS ARE ESTIMATED AND NOT GUARANTEED. THE ACTUAL SQUARE FOOTAGE AND DIMENSIONS OF HOUSES ON LOT WILL BE DETERMINED BY THE SITE. DREAM FINDERS HOMES IS NOT RESPONSIBLE FOR ANY DAMAGES OR INJURIES TO PERSONS OR PROPERTY ARISING FROM THE USE OF THIS PLAN. THE COPYRIGHTED PROPERTY OF DREAM FINDERS HOMES IS NOT TO BE REPRODUCED OR TRANSMITTED IN ANY FORM OR BY ANY MEANS, ELECTRONIC OR MECHANICAL, INCLUDING PHOTOCOPYING, RECORDING, OR BY ANY INFORMATION STORAGE AND RETRIEVAL SYSTEM. WITHOUT PERMISSION IN WRITING FROM DREAM FINDERS HOMES. USE/REUSE OF THIS PLAN IS STRICTLY PROHIBITED. SEE NEW CONSTRUCTION FOR FURTHER DETAILS.

DREAM FINDERS HOMES
JORDAN

PD: NOVEMBER 28, 2022
SCALE: 1/4"=1'-0"
DRAWN BY:
ENGINEERED BY:
REVIEWED BY:

SECOND FLOOR
ELECTRICAL
OPTIONS

E-2.1

- 7. ENGINEER'S SEAL APPLIES ONLY TO STRUCTURAL COMPONENTS. ENGINEER'S SEAL DOES NOT CERTIFY DRAINAGE, ACCURACY OR ORIENTATION. LATITUDE AND LONGITUDE SPECIAL CONSIDERATION TO CHAPTER 45 (HIGH AND LOW FOR 100 MPH WINDS).
- 8. STRUCTURAL DESIGN PER NORTH CAROLINA BUILDING CODE, 2018 EDITION, AND SPECIAL CONSIDERATION TO CHAPTER 45 (HIGH AND LOW FOR 100 MPH WINDS).
- 9. FOUNDATION DESIGN PER PROVIDER. CONNECTIONS AS REQUIRED BY CHAPTER 45 (HIGH AND LOW FOR 100 MPH WINDS) OF THE NORTH CAROLINA BUILDING CODE, 2018 EDITION.
- 10. FOUNDATION ADJUSTMENT TO COMPLY WITH SECTION 4004 OF THE NORTH CAROLINA BUILDING CODE, 2018 EDITION.
- 11. MEAN ROOF RISE IS LESS THAN 30 FEET.
- 12. MEAN ROOF RISE IS 30 FEET OR MORE AND -32 PSF (+/-) INDICATE POSITIVE / NEGATIVE PRESSURE (TPS).
- 13. MEAN ROOF RISE FOR 100 PSF PSF -28 PSF AND 144 PSF PSF 7/12 TO 12/12.
- 14. MEAN ROOF RISE FOR 100 PSF PSF -37 PSF FOR 12/12 TO 22/12 TO 7/12.
- 15. MEAN ROOF RISE FOR 100 PSF PSF -17 PSF FOR 12/12 TO 22/12 TO 7/12.
- 16. FOUNDATION DESIGN IS REQUIRED ON ALL EXTERIOR WALLS.
- 17. DESIGN TO BE DRAWN IN ACCORDANCE WITH SECTION 600.02 OF THE NORTH CAROLINA BUILDING CODE, 2018 EDITION AND AS NOTED BY THE ARCHITECT.
- 18. ENERGY EFFICIENCY COMPLIANCE AND INSULATION VALUES OF THE BUILDING TO BE IN ACCORDANCE WITH SECTION 600.02 OF THE NORTH CAROLINA BUILDING CODE, 2018 EDITION AND AS NOTED BY THE ARCHITECT.

120 MPH ULTIMATE DESIGN WIND SPEED
NOTES FOR LESS THAN
30' MEAN ROOF HEIGHT:

1. ENGINEER'S SEAL APPLIES ONLY TO STRUCTURAL COMPONENTS. ENGINEER'S SEAL DOES NOT CERTIFY DIMENSIONAL ACCURACY OR ARCHITECTURAL DETAIL INCLUDING ROOF SYSTEM.
2. STRUCTURAL DESIGN PER 2018 CAROLINA RESIDENTIAL CODE, 2018 EDITION.
3. INSTALL 1/2" ANCHOR BOLTS 6'-0" O.C. AND 1'-0" O.C. AT WALLS AND CORNERS. ALL ANCHOR BOLTS MUST EXCEED A MINIMUM 6" INTO MASONRY OR CONCRETE. LOCATE BOLT WITHIN MIDLINE THIRD OF PLANE.
4. PROVIDE 1/2" ANCHOR BOLTS AT 30 FEET.
5. EXTERIOR WALLS DESIGNED FOR 120 MPH WINDS.
6. PROVIDE FLASHING FOR +15.5 PSF AND -20 PSF (+/-) (INCLUDE POSITIVE / NEGATIVE PRESSURE DRAINING).
7. ROOF CLADDING DESIGN FOR +14.2 PSF AND -18 PSF FOR ROOF PITCHES 7/12 TO 12/12 AND +10 PSF AND -18 PSF FOR ROOF PITCHED 2.25/12 TO 1/12.
8. INSTALL 3/8" OR SHEATHING ON ALL EXTERIOR WALLS OF ALL STORIES IN ACCORDANCE WITH SECTION 05110 OF THE 2018 CAROLINA RESIDENTIAL CODE. WALL BRACING NOTES AND DETAILS SHEET FOR MORE INFORMATION.
9. PROVIDE COMPLIANCE AND INSULATION VARIATIONS OF THE BUILDING TO BE IN ACCORDANCE WITH CHAPTER 11 OF THE 2018 CAROLINA RESIDENTIAL CODE.
10. REFER TO NOTES AND DETAIL SHEETS FOR STRUCTURAL REQUIREMENTS.

LEGEND	
CONT	CONTINUOUS
XJ	EXTRA JOIST
DJ	DOUBLE JOIST
TJ	TRIPLE JOIST
EA	EACH
FDN	FOUNDATION
FTG	FOOTING
OC	ON CENTER
SPF	SPRUCE PINE FIR
SP	SOUTHERN YELLOW PINE
TRTD	PRESSURE TREATED
TYP	TYPICAL
UNO	UNLESS NOTED OTHERWISE

10'-0"

12'-0"

10" x 18" x 12" CONC. FTG. (TYP.)

OPT. PATIO

4" CONC. SLAB


4" CONC. SLAB

10'-0"

OPTIONAL REAR COVERED PORCH

OPTIONAL REAR
COVERED PORCH

RECESSED SLAB FOR ZERO ENTRY SHOWER

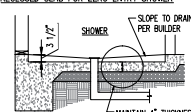

- MAINTAIN 4" THICKNESS
EXCAVATE SUBGRADE
TO ENSURE SLAB
THICKENED PROPERLY.

DETAIL A-
N.T.S.



1/4/2023

OPTIONAL WRAP
AROUND PORCH

OPTIONAL WRAP
AROUND PORCH

SIDE-LOAD
GARAGE OPTION
(NOT AVAILABLE WITH
OPTIONAL ONE-CAR GARAGE)

DOUBLE GARAGE
DOOR OPTION

J.S. THOMPSON
ENGINEERING, INC.
333 EAST SIX FORKS ROAD, SUITE 160, BALIECH, NC 27609
PHONE: (919) 789-9919 FAX: (919) 789-9952

JORDAN
DREAM FINDERS HOMES

DATE: JANUARY 3, 2023

SCALE: 1/4" = 1'-0"

DRAWN BY: DH

ENGINEERED BY: JAG

S.1.1

MONO SLAB
FOUNDATION PLAN

TABLE R602.7.5 MINIMUM NUMBER OF FULL HEIGHT KING STUDS AT EACH END OF HEADERS IN EXTERIOR WALLS	
HEADER SPAN (FEET)	MINIMUM NUMBER OF FULL HEIGHT STUDS (KINGS)
UP TO 3'	2
> 3' TO 4'	3
> 4' TO 6'	4
> 6' TO 8'	5
> 8' TO 12'	6
> 12' TO 16'	7

STRUCTURAL NOTES:

- ALL FRAMING LUMBER TO BE #2 SPF (UNO).
- ALL LOAD BEARING HEADERS TO BE (3) 2 x 8 (UNO).
- SQUARES DENOTE POINT LOADS WHICH REQUIRE SOLID BLOCKING TO ORDER OR FOUNDATION. SUPPORT UNSPECIFIED PT. LOADS ALONG FRAMED WALLS w/ (2) STUDS (UNO).
- INSTALL AN EXTRA JOIST UNDER WALLS PARALLEL TO FLOOR JOISTS WHERE NOTED ON THE PLANS.
- STEP POURED FOUNDATION WALL DOWN TO 2 x 4 @ 16" O.C. STUD WALL AS GRADE PERMITS.
- ALL LOAD BEARING INTERIOR WALLS TO BE 2 x 4 @ 12" O.C. OR 2 x 6 @ 16" O.C. (UNO).
- FOR HIGH WIND ZONES, ALL EXTERIOR WALLS TO BE SHEATHED WITH 7/16" OSB SHEATHING WITH JOISTS BLOCKED AND SECURED WITH 8d NAILS AT 3" O.C. ALONG EDGES AND 6" O.C. IN THE FIELD.
- FOR HIGH WIND ZONES, SECURE ALL EXTERIOR WALL SHEATHING PANELS TO DOUBLE TOP PLATES, BANDS, JOISTS, AND GIRDERS WITH (2) ROWS OF 8d NAILS STAGGERED AT 3" O.C. PANELS SHALL EXTEND 12" BEYOND CONSTRUCTION JOISTS AND SHALL OVERLAP GIRDERS AND DOUBLE SILL PLATES THEIR FULL DEPTH.
- ALL 4 x 4 POSTS SHALL BE ANCHORED TO SLABS w/ SIMPSON ABU44 POST BRACES (OR EQUAL) AND 6 x 6 POSTS w/ ABRAE POST BRACES (OR EQUAL) (UNO). ALL 4 x 4 AND 6 x 6 POSTS TO BE INSTALLED WITH 700 LB CAPACITY UPLIFT CONNECTORS AT TOP (UNO).
- FOR FIBERGLASS, ALUMINUM, OR COLUMN ENDG. BY OTHERS, SECURE TO SLAB w/ (2) METAL ANGLES USING 2" CONC. SCREWS. FASTEN ANGLES TO COLUMNS w/ 1/4" THROUGH BOLTS w/ NUTS AND WASHERS. LOCATE ANGLES ON OPPOSITE SIDES OF COLUMN. THROUGH BOLTS MUST BE INSTALLED PRIOR TO SETTING COLUMN.
- REFER TO NOTES AND DETAIL SHEETS FOR ADDITIONAL STRUCTURAL INFORMATION.

BRACED WALL DESIGN NOTES:

- BRACED WALL DESIGN PER SECTION R602.10.6 OF THE NCRC 2018 EDITION.
- CS-WSP REFERS TO "CONTINUOUS SHEATHING - WOOD STRUCTURAL PANELS" CONTRACTOR IS TO INSTALL 7/16" OSB ON ALL EXTERIOR WALLS ATTACHED w/ 8d NAILS SPACED 6" O.C. ALONG PANEL EDGES AND 12" O.C. IN THE FIELD.
- WSP REFERS TO "GYPSUM BOARD" CONTRACTOR IS TO INSTALL 1/2" (MIN) GYPSUM WALL BOARD WHERE NOTED ON THE PLANS. FASTEN GB WITH 1 1/4" SCREWS OR 1 5/8" NAILS SPACED 7" O.C. ALONG PANEL EDGES AND IN THE FIELD INCLUDING TOP AND BOTTOM PLATES.
- BRACED WALL DESIGN APPLIED IN WIND ZONES UP TO 130 MPH. FOR HIGH WIND ZONES, BRACE WALLS ARE TO BE CONSTRUCTED IN ACCORDANCE WITH CHAPTER 45 OF THE NCRC 2018 EDITION.
- SEE NOTES AND DETAIL SHEETS FOR ADDITIONAL BRACED WALL INFORMATION.

NOTES:




- PER SECTION R602.10.4.6 OF THE 2018 NCRC, THE AMOUNT OF BRACING REQUIRED ON THE WALK OUT BASEMENT WALLS EXCEEDS THE AMOUNT OF BRACING ON THE WALL ABOVE MULTIPLIED BY A FACTOR OF 1.15.
- SHEATH ALL EXTERIOR WALLS WITH 7/16" OSB SHEATHING ATTACHED WITH 8d NAILS AT 6" O.C. ALONG PANEL EDGES AND 12" O.C. IN THE FIELD.

LUNTEL SCHEDULE FOR BRICK/NATURAL STONE SUPPORT	
LENGTH (FT.)	SIZE OF LUNTEL
UP TO 4 FT.	L 3 1/2 x 3 1/2 x 1/4
4-8	L 5 x 3 1/2 x 5/16 LLV
8 AND GREATER	L 6 x 4 x 5/16 LLV

BRICK SUPPORT NOTES:

- LUNTEL SCHEDULE APPLIES TO ALL OPENINGS IN BRICK VENEER (UNO). SEE ARCH DWGS. FOR SIZE AND LOCATION OF OPENINGS.
- (LLV) = LONG LEG VERTICAL.
- LENGTH = CLEAR OPENING.
- EMBED ALL ANGLE IRONS MIN. 4" EACH SIDE INTO VENEER TO PROVIDE BEARING.
- FOR ALL HEADERS 8'-0" AND GREATER IN LENGTH, ATTACH STEEL ANGLE TO HEADER w/ 1/2" LAG SCREWS @ 12" O.C. STAGGERED.
- FOR ALL BRICK SUPPORT @ ROOF LINES, FASTEN (2) 2 x 10 BLOCKING BETWEEN STUDS w/ (4) 12d NAILS PER PLY. FASTEN A 6" x 4" x 5/16" STEEL ANGLE TO (2) 2 x 10 BLOCKING w/ (2) 1/2" LAG SCREWS @ 12" O.C. STAGGERED. SEE SECTION R703.8.2.1 OF THE 2018 NCRC FOR ADDITIONAL BRICK SUPPORT INFORMATION.
- PRECAST REINFORCED CONCRETE LUNTELS ENGINEERED BY OTHERS MAY BE USED IN LIEU OF STEEL LUNTELS.

LEGEND	
CONT	CONTINUOUS
XJ	EXTRA JOIST
DJ	DOUBLE JOIST
TJ	TRIPLE JOIST
EA	EACH
FDW	FOUNDATION
FTD	FOOTING
O.C.	ON CENTER
SPF	SPRUCE PINE FIR
SWP	SOUTHERN YELLOW PINE
PTD	PRESSURE TREATED
TYP	TYPICAL
UNO	UNLESS NOTED OTHERWISE

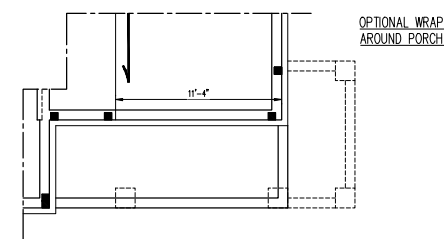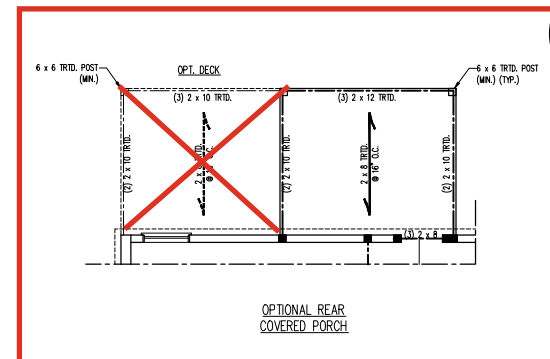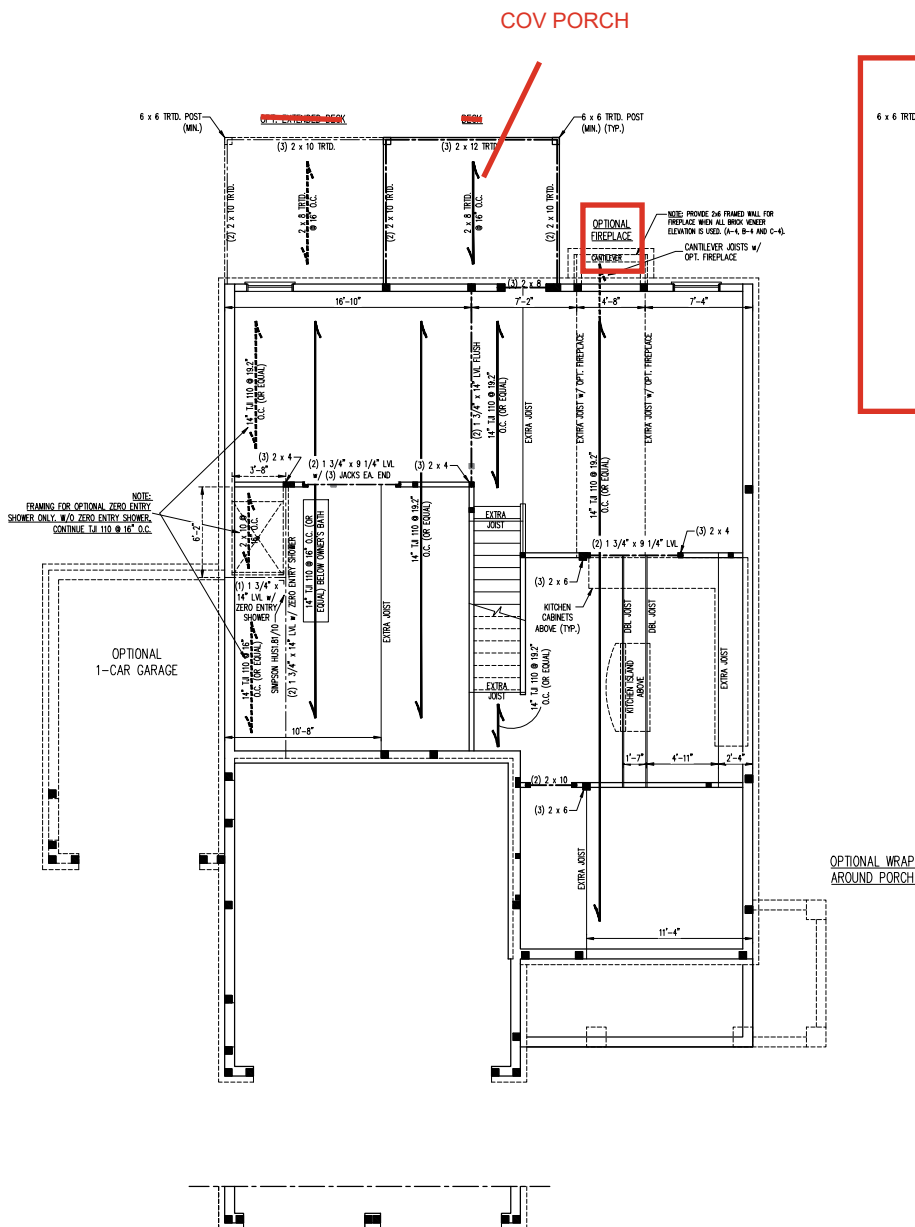

PORCH w/ FULL BRICK OPTION



1/4/2023

DOUBLE GARAGE
DOOR OPTION

**J.S. THOMPSON
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151 EAST MAIN STREET, SUITE 100, COLUMBUS, NC 28702
PHONE (919) 789-9919 • FAX (919) 789-9921
N.C. LICENSE NO. C-1131

JORDAN
DREAM FINDERS HOMES

DATE: JANUARY 3, 2023

SCALE: 1/4" = 1'-0"

DRAWN BY: DHI

ENGINEERED BY: JGT

S-1.4a
FIRST FLOOR
FRAMING PLAN

TABLE R602.7.5
MINIMUM NUMBER OF FULL HEIGHT KING STUDS
AT EACH END OF HEADERS IN EXTERIOR WALLS

HEADER SPAN (FEET)	MINIMUM NUMBER OF FULL HEIGHT STUDS (MINES)
UP TO 3'	1
> 3' TO 4'	2
> 4' TO 5'	3
> 5' TO 10'	4
> 10' TO 15'	5

NOTE: ALL EXTERIOR WALLS AND ATTIC
WALLS ARE TO BE 2 x 6 @ 16" O.C. (UNO).
2 x 4 @ 16" O.C. EXTERIOR WALLS MAY BE
CONSTRUCTED IN LIEU OF 2 x 6 WALLS
(UNO). ALL INTERIOR LOAD BEARING WALLS
ARE TO BE 2 x 4 @ 16" O.C. (UNO) AND
NON-LOAD BEARING INTERIOR WALLS ARE
TO BE 2 x 4 @ 24" O.C. (UNO).



STRUCTURAL NOTES:

- ALL FRAMING LUMBER TO BE SPF #2 (UNO). ALL
TREATED LUMBER TO BE SPF #2 (UNO).
- ALL LOAD BEARING HEADERS TO BE (2) 2 x 6
(UNO).
- INSTALL AN EXTRA JOIST UNDER WALLS PARALLEL
TO FLOOR JOISTS WHERE NOTED ON THE PLANS.
- WINDOW AND DOOR HEADERS TO BE SUPPORTED W/
(1) JACK STUD AND (1) KING STUD EA. END (UNO).
SEE TABLE R602.7.5 FOR ADDITIONAL KING STUD
REQUIREMENTS.
- SQUARES DENOTE POINT LOADS WHICH REQUIRE
SOLID BLOCKING TO ORDER OR FOUNDATION. ALL
SQUARES TO BE (2) STUDS (UNO).
- FOR HIGH WIND ZONES, ALL EXTERIOR WALLS TO BE
SHEATHED WITH 7/16" OSB SHEATHING WITH JOINTS
BLOCKED AND SECURED WITH 8d NAILS AT 3" O.C.
ALONG EDGES AND 4" O.C. IN THE FIELD.
- FOR HIGH WIND ZONES, SECURE ALL EXTERIOR WALL
SHEATHING PANELS TO DOUBLE TOP PLATES, BANGS,
JOISTS, AND ORDERS WITH (2) ROWS OF 8d NAILS
STAGGERED AT 3" O.C. PANELS SHALL EXTEND 12"
BEYOND CONSTRUCTION JOINTS AND SHALL OVERLAP
ORDERS AND DOUBLE SILL PLATES THEIR FULL
DEPTH.
- ALL 4 x 4 POSTS SHALL BE ANCHORED TO SLABS
W/ SIMPSON ANCHOR POST BASES (OR EQUAL) AND 6
x 6 POSTS W/ ANCHOR POST BASES (OR EQUAL)
(UNO). ALL 4 x 4 AND 6 x 6 POSTS TO BE
INSTALLED WITH 700 LB CAPACITY UPLIFT
CONNECTORS AT TOP (UNO).
- FOR FIBERGLASS, ALUMINUM, OR COLUMN ENG. BY
OTHERS, SECURE TO SLAB W/ (2) METAL ANCHORS
USING 2" CONC. SCREWS FASTEN ANCHORS TO
COLUMNS W/ 1/4" THROUGH BOLTS W/ NUTS AND
WASHERS. LOCATE ANCHORS ON OPPOSITE SIDES OF
COLUMN. THROUGH BOLTS MUST BE INSTALLED
PRIOR TO SETTING COLUMN.
- REFER TO NOTES AND DETAIL SHEETS FOR
ADDITIONAL STRUCTURAL INFORMATION.

LEGEND

CONT	CONTINUOUS
XJ	EXTRA JOIST
DJ	DOUBLE JOIST
TJ	TRIPLE JOIST
EA	EACH
()	NUMBER OF STUDS
DSP	DOUBLE STUD POCKET
TSP	TRIPLE STUD POCKET
OC	ON CENTER
SPF	SUPPLY PINE FIR
SPF	SOUTHERN YELLOW PINE
HTD	PRESSURE TREATED
TYP	TYPICAL
UNO	UNLESS NOTED OTHERWISE

SIDE-LOAD GARAGE OPTION
(NOT AVAILABLE WITH
OPTIONAL ONE-CAR GARAGE)

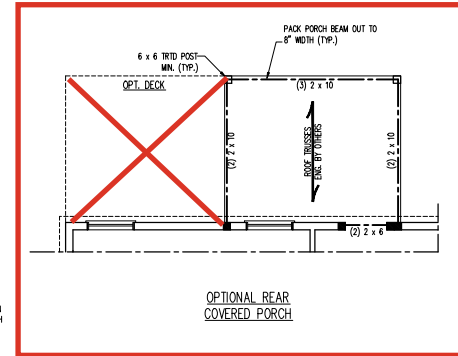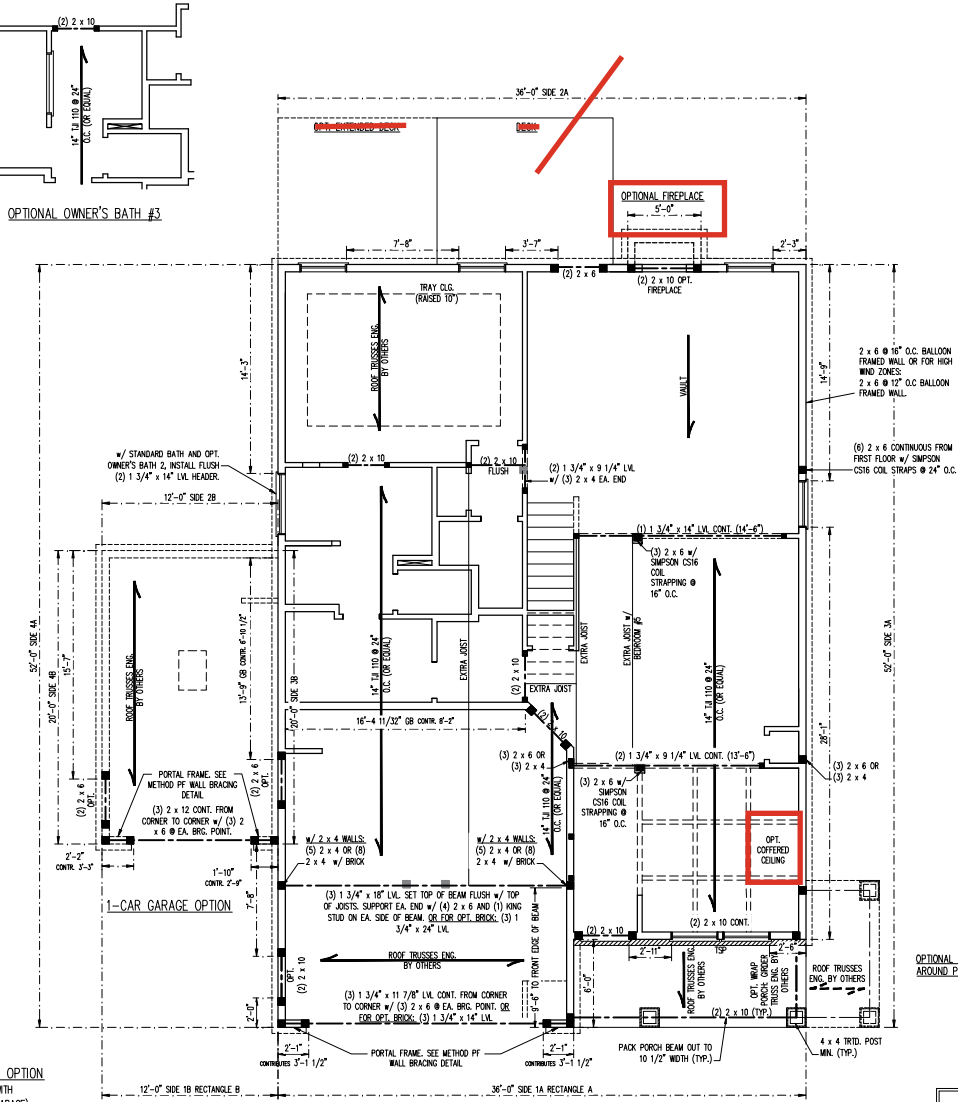

BRACED WALL DESIGN

RECTANGLE A	RECTANGLE B
SIDE 1A (FRONT LOAD)	SIDE 1B
METHOD: CS-WSP/PF/DB	METHOD: CS-WSP/PF
TOTAL REQUIRED LENGTH: 16'	TOTAL REQUIRED LENGTH: 13.2'
TOTAL PROVIDED LENGTH: 19.83'	TOTAL PROVIDED LENGTH: 8'
SIDE 2A	SIDE 2B
METHOD: CS-WSP	METHOD: CS-WSP
TOTAL REQUIRED LENGTH: 16'	TOTAL REQUIRED LENGTH: 3.2'
TOTAL PROVIDED LENGTH: 18.5'	TOTAL REQUIRED LENGTH: 12'
SIDE 3A	SIDE 3B / SIDE 4A CUMULATIVE
METHOD: CS-WSP	METHOD: CS-WSP/DB
TOTAL REQUIRED LENGTH: 11.4'	TOTAL REQUIRED LENGTH: 13.4'
TOTAL PROVIDED LENGTH: 48.83'	TOTAL PROVIDED LENGTH: 30.6'
SIDE 4A (SIDE LOAD)	SIDE 4B
METHOD: CS-WSP/PF	METHOD: CS-WSP
TOTAL REQUIRED LENGTH: 11.4'	TOTAL REQUIRED LENGTH: 2'
TOTAL PROVIDED LENGTH: 35.2'	TOTAL PROVIDED LENGTH: 15.58'

- BRACED WALL DESIGN NOTES:
- BRACED WALL DESIGN PER SECTION R602.10 OF THE IBC 2018 EDITION.
 - CS-WSP REFERS TO "CONTINUOUS SHEATHING - WOOD STRUCTURAL PANELS" CONTRACTOR IS TO INSTALL 7/16" OSB ON ALL EXTERIOR WALLS ATTACHED W/ 8d NAILS SPACED 6" O.C. ALONG PANEL EDGES AND 12" O.C. IN THE FIELD.
 - WSP REFERS TO "GYPSUM BOARD" CONTRACTOR IS TO INSTALL 1/2" (MIN.) GYPSUM WALL BOARD WHERE NOTED ON THE PLANS. FASTEN GB WITH 1 1/4" SCREWS OR 1 5/8" NAILS SPACED 7" O.C. ALONG PANEL EDGES AND 12" IN THE FIELD INCLUDING TOP AND BOTTOM PLATES.
 - BRACED WALL DESIGN APPLIED IN WIND ZONES UP TO 130 MPH. FOR HIGH WIND ZONES, BRACE WALLS ARE TO BE CONSTRUCTED IN ACCORDANCE WITH CHAPTER 45 OF THE IBC 2018 EDITION.
 - SEE NOTES AND DETAIL SHEETS FOR ADDITIONAL BRACED WALL INFORMATION.



1/4/2023

LINTEL SCHEDULE FOR BRICK/NATURAL STONE SUPPORT		BRICK SUPPORT NOTES:	
LENGTH (FT.)	SIZE OF LINTEL	1. LINTEL SCHEDULE APPLIES TO ALL OPENINGS IN BRICK VENEER (UNO). SEE ARCH DWGS. FOR SIZE AND LOCATION OF OPENINGS.	
UP TO 4 FT.	1.3 1/2 x 3 1/2 x 1/4	2. (LLV) = LONG LEG VERTICAL	
4-8	1.5 x 3 1/2 x 5/16 LLV	3. LENGTH = CLEAR OPENING	
8 AND GREATER	1.6 x 4 x 5/16 LLV	4. SAVED ALL ANGLE IRONS MIN. 4\"/>	

J.S. THOMPSON
ENGINEERING, INC.
1311 EAST PHONE (919) 899-9191 FAX (919) 899-9121
N.C. LICENSE NO. C-131

JORDAN
DREAM FINDERS HOMES

DATE: JANUARY 3, 2023

SCALE: 1/4\"/>

DRAWN BY: DPH

ENGINEERED BY: JAG

S-2
SECOND FLOOR
FRAMING PLAN

1/4/2023

JORDAN
DREAM FINDERS HOMES

ENGINEERED BY: JAG

S-4b
ROOF FRAMING
PLAN

1/4/2023

BRICK SUPPORT NOTE:



1. FASTEN (2) 2 x 10 BLOCKING BETWEEN WALL STUDS w/ (4) 12d NAILS PER PLY. FASTEN A 6" x 4" x 5/16" STEEL ANGLE TO (2) 2 x 10 BLOCKING @ (2) 1/2" LAG SCREWS @ 12" O.C. STAGGERED. SEE SECTION R703.8.2.1. OF THE 2018 NRCRC FOR ADDITIONAL BRICK SUPPORT INFORMATION.
2. WHERE ROOF SLOPES EXCEED 7:12, INSTALL 3" x 3" x 1/4" STEEL PLATE STOPS AT 24" O.C. PER SECTION R703.8.2.1 OF THE NORTH CAROLINA RESIDENTIAL CODE, 2018 EDITION.

STRUCTURAL NOTES:

1. ALL FRAMING LUMBER TO BE #2 SPF UNFIN.
2. ORGLES DETONITE (3) 2 x 4 POSTS FOR ROOF SUPPORT.
3. FRAME DOORER WALLS ON TOP OF DOUBLE OR TRIPLE RAFTERS.
4. HP JOISTS ARE TO BE SPACED A MIN. OF 8'-0". FASTEN MEMBERS WITH THREE ROWS OF 12d NAILS @ 16" O.C. (TP#).
5. STICK FRAME OVER-FRAMED ROOF SECTIONS W/ 2" X 8 RIDGES, 2 X 6 BRACES @ 16" O.C. AND PLATE 2 X 10 VALLEYS OR USE VALLEY TRUSSES.
6. FASTEN PLATE VALLEYS TO RAFTERS OR TRUSSES WITH SPMSS H2A.5 HURRICANE RESIST @ 32" O.C. MAX.
7. PASTH LARGEST TREES THROUGH UNIFORM IN ROOF SHEETING. EACH RAFTER IS TO BE FASTENED TO THE FLAT VALLEY WITH A MIN. OF (6) 12d TAIL NAILS.
8. REFER TO SECTION 9802.11 OF THE 2018 IBC FOR REQUIRED UPLIFT RESISTANCE AT RAFTERS AND TRUSSES.
9. REFER TO NOTES AND DETAIL SHEETS FOR ADDITIONAL STRUCTURAL INFORMATION.


LEGEND

XT	EXTRA TRUSS
TS	TRUSS SUPPORT
XR	EXTRA RAFTER
RS	RAFTER SUPPORT
CONT	CONTINUOUS
EA	EACH
OC	ON CENTER
SPF	SPRUCE PINE FIR
SPY	SOUTHERN YELLOW PINE
TYP	TYPICAL
UNO	UNLESS NOTED OTHERWISE

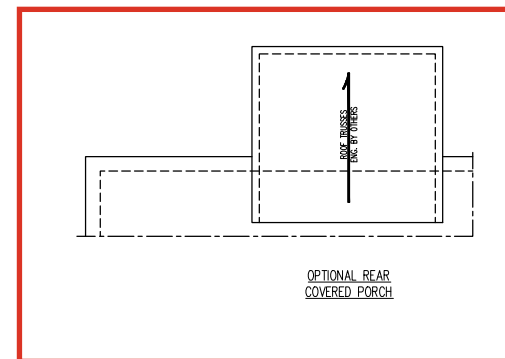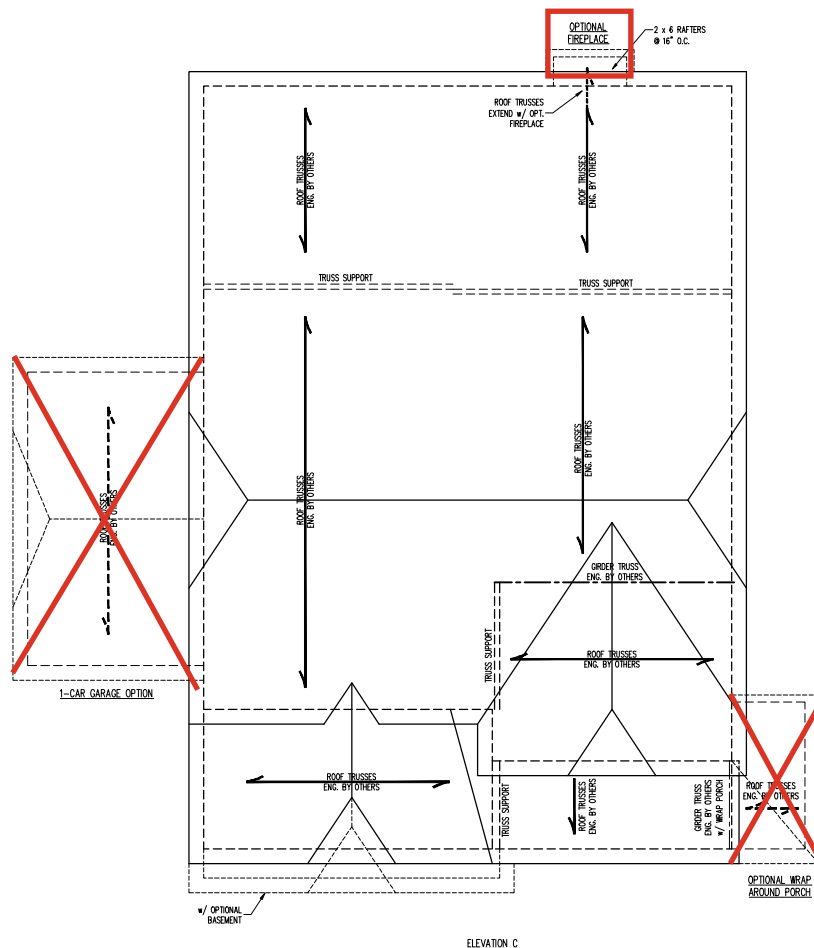


MONOLITHIC SLAB DETAILS

DETAIL 1

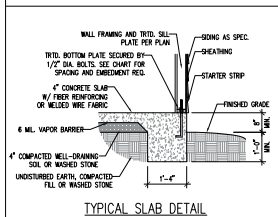


TYPICAL SLAB DETAIL

DETAIL 2

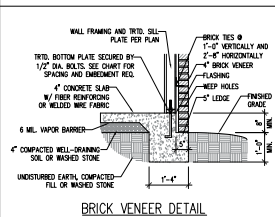


BRICK VENEER DETAIL

DETAIL 3

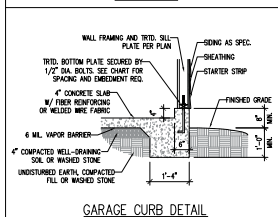


GARAGE CURB DETAIL

DETAIL 4

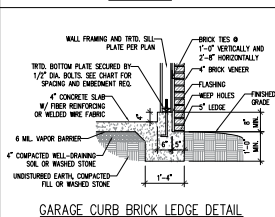


GARAGE CURB BRICK LEDGE DETAIL

DETAIL 5

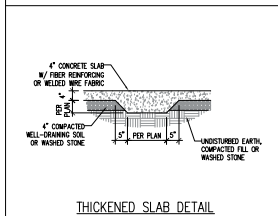


THICKENED SLAB DETAIL

DETAIL 6

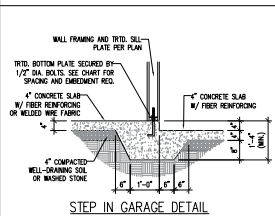

STEP IN GARAGE DETAIL


DETAIL 7

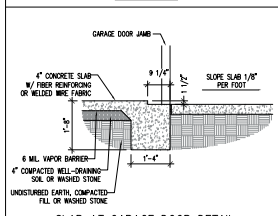

SLAB AT GARAGE DOOR DETAIL


STEM WALL DETAILS

DETAIL 1

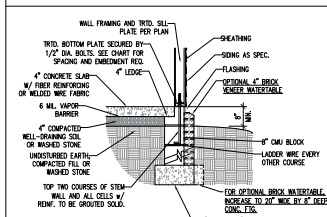


TYPICAL STEM WALL DETAIL
(w/ OPTIONAL WATERTABLE)

OPTIONAL DETAIL 1

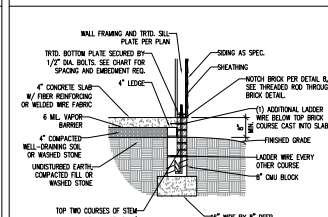


OPTIONAL STEM WALL DETAIL

DETAIL 2

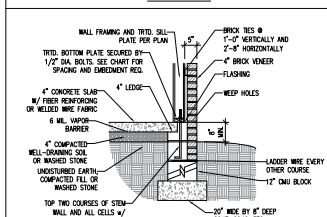


TYPICAL STEM WALL FND. DETAIL
w/ BRICK DETAIL

DETAIL 3

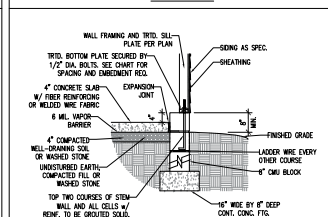


TYPICAL STEM WALL FND. DETAIL
w/ CURB @ GARAGE

OPTIONAL DETAIL 3

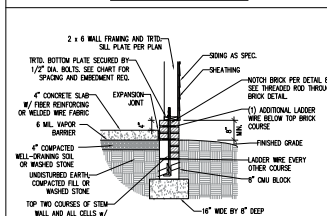


OPTIONAL STEM WALL FND. DETAIL
w/ CURB @ GARAGE

DETAIL 4

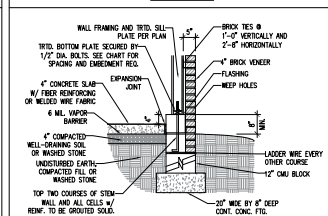

TYPICAL STEM WALL FND. DETAIL w/ BRICK
AND CURB @ GARAGE

DETAIL 8

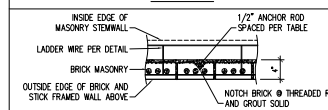

THREADED ROD THROUGH BRICK MASONRY

MASONRY STEM WALL SPECIFICATIONS

WALL HEIGHT (FEET)	MASONRY WALL TYPE			
	8" CMU	4" BRICK AND 4" CMU	4" BRICK AND 8" CMU	12" CMU
2 AND BELOW	UNGRADED	GRAOUT SOLID	UNGRADED	UNGRADED
3	UNGRADED	GRAOUT SOLID	UNGRADED	UNGRADED
4	GRAOUT SOLID	GRAOUT SOLID w/ #4 REBAR @ 48" O.C.	GRAOUT SOLID	GRAOUT SOLID w/ #4 REBAR @ 64" O.C.
5	GRAOUT SOLID w/ #4 REBAR @ 36" O.C.	NOT APPLICABLE	GRAOUT SOLID w/ #4 REBAR @ 36" O.C.	GRAOUT SOLID w/ #4 REBAR @ 64" O.C.
6	GRAOUT SOLID w/ #4 REBAR @ 24" O.C.	NOT APPLICABLE	GRAOUT SOLID w/ #4 REBAR @ 24" O.C.	GRAOUT SOLID w/ #4 REBAR @ 64" O.C.
7 AND GREATER	ENGINEERED DESIGN BASED ON SITE CONDITIONS			

STRUCTURAL NOTES:

1. WALL HEIGHT MEASURED FROM TOP OF FOOTING TO TOP OF THE WALL.
2. THE MULTIPLE WYTHES TOGETHER WITH LADDER WIRE AT 16" O.C. VERTICALLY.
3. CHART APPLICABLE FOR HOUSE FOUNDATION ONLY. CONSULT ENGINEER FOR DESIGN OF GARAGE FOUNDATION NOT COMMON TO HOUSE.
4. BACKFILL OF CLEAN #57 / #57 WASHED STONE IS ALLOWABLE.
5. BACKFILL OF WELL DRAINED OR SAND - GRAVEL MIXTURE SOILS (AS PER FT. BELOW GRADE) CLASSIFIED AS GROUP 1 ACCORDING TO UNITED SOILS CLASSIFICATION SYSTEM IN ACCORDANCE WITH TABLE 2002.1 OF THE 2018 INTERNATIONAL RESIDENTIAL CODE ARE ALLOWABLE.
6. PREP. SLAB PER 2002.2.1 AND 2002.2.2 BASE OF THE 2018 INTERNATIONAL RESIDENTIAL CODE.
7. MINIMUM 24" LAP SPlice LENGTH.
8. LOCATE REBAR IN CENTER OF FOUNDATION WALL.
9. WHERE REQUIRED, FILL BLOCK SOLID WITH TYPE "N" MORTAR OR 3000 PSI GRAUT. USE OF "LOW LIFT GRAUTING" METHOD REQUIRED WHEN FILLING WALLS WITH GRAUT AT HEIGHTS OF 5' AND GREATER.

ANCHOR SPACING AND EMBEDMENT

WIND ZONE	120 MPH	130 MPH
	6'-0" O.C.	4'-0" O.C.
SPACING	INSTALL MIN. (2) ANCHORS PER PLATE SECTION AND (1) ANCHOR WITHIN 12" OF CORNERS	INSTALL MIN. (2) ANCHORS PER PLATE SECTION AND (1) ANCHOR WITHIN 12" OF CORNERS
EMBEDMENT	7"	15" INTO MASONRY 7" INTO CONCRETE

NOTE:

THREADED ROD WITH EPOXY, SIMPSON TITEN HD, OR APPROVED ANCHORS SPACED AS REQUIRED TO PROVIDE EQUIVALENT ANCHORAGE TO 1/2" DIAMETER ANCHOR BOLTS MAY BE USED IN LIEU OF 1/2" ANCHOR BOLTS.

**J.S. THOMPSON
ENGINEERING, INC.**
101 EAST 10TH STREET, SUITE 100
FISHER, NC 27839-9999 FAX: (919) 889-9921
N.C. LICENSE NO. C-173

120 MPH - 130 MPH ULTIMATE DESIGN WIND SPEED
FOUNDATION DETAILS
DREAM FINDERS HOMES

DATE: NOVEMBER 28, 2022

SCALE: 3/8"

DRAWN BY: JST

APPROVED BY: JST




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1/4/2023


D-1
FOUNDATION DETAILS

GENERAL WALL BRACING NOTES:

1. WALL BRACING DESIGNED IN ACCORDANCE WITH CHAPTER 6 OF THE 2018 NC RESIDENTIAL BUILDING CODE (NRC). TABLES AND FIGURES REFERENCED ARE FROM THE 2018 NRC.
2. SEE THIS SHEET FOR GENERAL DETAILS. REFER TO THE 2018 NRC FOR ADDITIONAL INFORMATION AS NEEDED.
3. BRACED EXTERIOR WALLS SUPPORTING ROOF TRUSSES AND RAFTERS, INCLUDING STORIES BELOW THE TOP FLOOR, HAVE BEEN DESIGNED PER R602.3.5 (3). WALL SHEATHING AND FASTENERS HAVE BEEN DESIGNED TO RESIST COMBINED UPLIFT AND SHEAR FORCES IN ACCORDANCE WITH ACCEPTED ENGINEERING PRACTICE.
4. SEE STRUCTURAL SHEETS FOR BRACED WALL LOCATIONS, DIMENSIONS, HOLD DOWN TYPE AND LOCATIONS, BRACED WALL LINE KEY WITH WALL DESIGN SUMMARY OF REQUIRED/PROVIDED TOTALS FOR EACH WALL LINE AND ANY SPECIAL NOTES OR REQUIREMENTS.
5. ALL EXTERIOR WALLS ARE TO BE SHEATHED WITH CS-WSP IN ACCORDANCE WITH SECTION R602.10.3 UNLESS NOTED OTHERWISE.
6. ALL EXTERIOR AND INTERIOR WALLS TO HAVE 1/2" GYPSUM WALLBOARD. WHEN NOT USING METHOD "GB", GYPSUM TO BE FASTENED PER TABLE R702.3.5. METHOD GB TO BE FASTENED PER TABLE R602.10.1.
7. CS-WSP REFERS TO THE "CONTINUOUS SHEATHING - WOOD STRUCTURAL PANELS" WALL BRACING METHOD. 7/16" OSB SHEATHING IS TO BE INSTALLED ON ALL EXTERIOR WALLS ATTACHED w/ 6d COMMON NAILS OR 8d (2 1/2" LONG x 0.113" DIAMETER) NAILS SPACED 6" O.C. ALONG PANEL EDGES AND 12" O.C. IN THE FIELD (U.L.O.).
8. GB REFERS TO THE "GYPSUM BOARD" WALL BRACING METHOD. 1/2" (MIN.) GYPSUM WALL BOARD IS TO BE INSTALLED ON BOTH SIDES OF THE BRACED WALL FASTENED WITH 1 1/4" SCREWS OR 1 5/8" NAILS SPACED 7" O.C. ALONG PANEL EDGES INCLUDING TOP AND BOTTOM PLATES AND INTERMEDIATE SUPPORTS (U.L.O.). VERIFY ALL FASTENER OPTIONS FOR 1/2" AND 5/8" GYPSUM PRIOR TO CONSTRUCTION. FOR INTERIOR FASTENER OPTIONS SEE TABLE R702.3.5. FOR EXTERIOR FASTENER OPTIONS SEE TABLE R602.3(1). EXTERIOR GB TO BE INSTALLED VERTICALLY.
9. REQUIRED BRACED WALL LENGTH FOR EACH SIDE OF THE GROUND-ANCHORED TRIANGLE ARE INTERPOLATED PER TABLE R602.10.3. METHOD CS-WSP CONTRIBUTES ITS ACTUAL LENGTH, METHOD GB CONTRIBUTES 3 ITS ACTUAL LENGTH, AND METHOD PF CONTRIBUTES 1.5 TIMES ITS ACTUAL LENGTH.

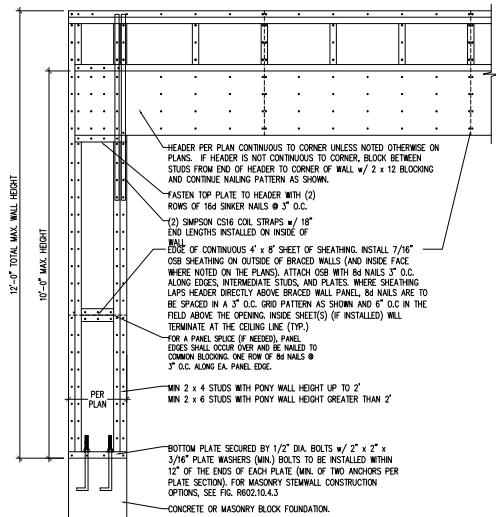




OVER CONCRETE OR MASONRY BLOCK FOUNDATION

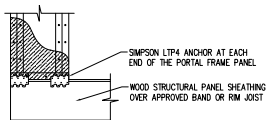

OVER RAISED WOOD FLOOR - FRAMING ANCHOR OPTION

- * APPLICABLE w/ GREATER THAN 12" KNEE WALL HEIGHTS IN CRAWL SPACE AND ABOVE FRAMED BASEMENT WALLS *


METHOD PF-PORTAL FRAME DETAIL ①

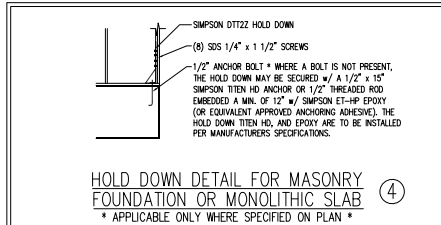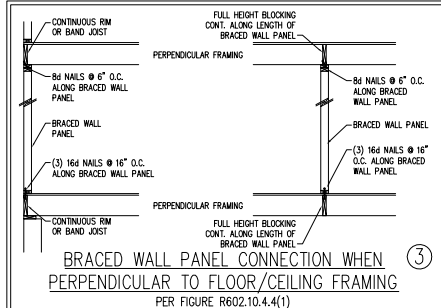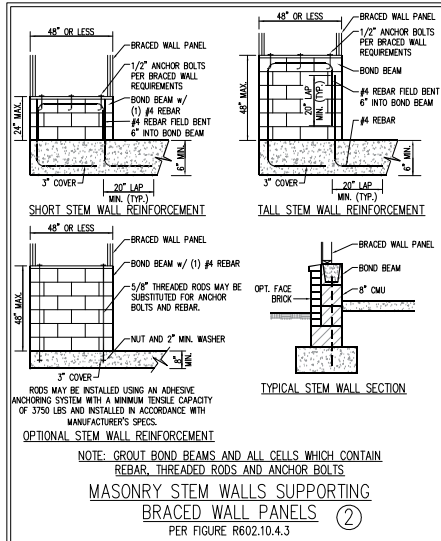


HOLD DOWN DETAIL FOR MASONRY FOUNDATION OR MONOLITHIC SLAB ④

- * APPLICABLE ONLY WHERE SPECIFIED ON PLAN *


TYPICAL EXTERIOR CORNER FRAMING FOR CONTINUOUS SHEATHING ⑤

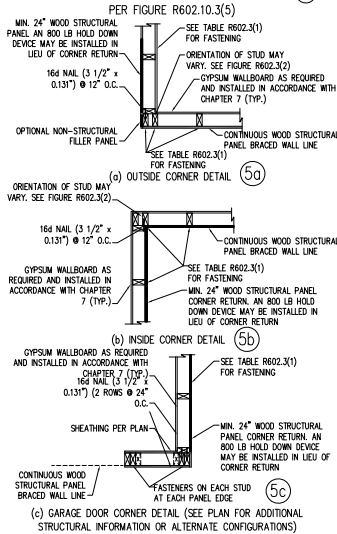


BRACED WALL PANEL CONNECTION WHEN PARALLEL TO FLOOR/CEILING FRAMING ⑥

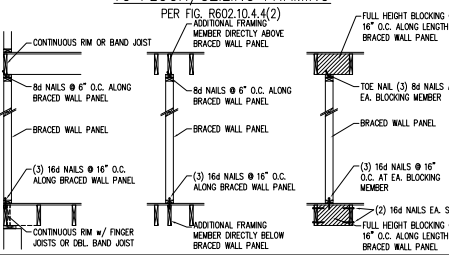


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BRACED WALL PANEL CONNECTION TO PERPENDICULAR RAFTERS ⑧

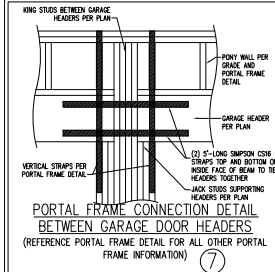

BRACED WALL PANEL CONNECTION TO PERPENDICULAR ROOF TRUSSES ⑨

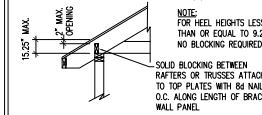

1/4/2023

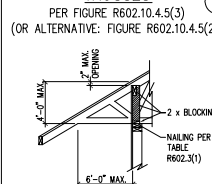J.S. THOMPSON ENGINEERING, INC.
1400 S. 11TH STREET, SUITE 100
FARMINGHAM, NC 27534
919.486.9691
N.C. LICENSE NO. 00701

120 MPH - 130 MPH ULTIMATE DESIGN WIND SPEED
WALL BRACING NOTES AND DETAILS
DREAM HINDERS HOMES

DATE: NOVEMBER 28, 2022
SCALE: 1/4" = 1'-0"
DRAWN BY: JST
CHECKED BY: JST

D-2
BRACED WALL
NOTES AND DETAILS
AND 77 DETAIL

FRAMING NOTES

- ALL FRAMING LUMBER SHALL BE @2 SPLY MINIMUM (Fb = 875 PSI, Fv = 375 PSI, E = 1600000 PSI) UNLESS NOTED OTHERWISE (UNO). ALL TREATED LUMBER SHALL BE @2 SPLY MINIMUM (Fb = 975 PSI, Fv = 475 PSI, E = 1600000 PSI) UNLESS NOTED OTHERWISE (UNO).
2. LAMINATED VENER LUMBER (VL) SHALL HAVE THE FOLLOWING MINIMUM PROPERTIES: Fb = 2600 PSI, Fv = 385 PSI, E = 1900000 PSI. LAMINATED STRAND LUMBER (LSL) SHALL HAVE THE FOLLOWING MINIMUM PROPERTIES: Fb = 2325 PSI, Fv = 370 PSI, E = 1550000 PSI. PARALLEL STRAND LUMBER (PSL) UP TO 7" DEPTH SHALL HAVE THE FOLLOWING MINIMUM PROPERTIES: Fc = 2500 PSI, E = 1800000 PSI. PARALLEL STRAND LUMBER (PSL) MORE THAN 7" DEPTH SHALL HAVE THE FOLLOWING MINIMUM PROPERTIES: Fc = 2900 PSI, E = 2000000 PSI. INSTALL ALL CONNECTIONS PER MANUFACTURER'S SPECIFICATIONS.
3. STRUCTURAL STEEL SHALL CONFORM TO THE FOLLOWING ASTM SPECIFICATIONS
- | | |
|--------------------------------|--------------------------------|
| A. W AND Wt SHAPES: | ASTM A992 |
| B. CHANNELS AND ANGLES: | ASTM A36 |
| C. PLATES AND BARS: | ASTM A36 |
| D. HOLLOW STRUCTURAL SECTIONS: | ASTM A500 GRADE B |
| E. STEEL PIPE: | ASTM A53, GRADE B, TYPE E OR S |
4. STEEL BEAMS SHALL BE SUPPORTED AT EACH END WITH A MINIMUM BEARING LENGTH OF 3 1/2" AND FULL FLANGE WIDTH (UNO). PROVIDE SLOD BEARING FROM BEAM SUPPORT TO FOUNDATION. BEAMS SHALL BE ATTACHED AT THE BOTTOM FLANGE TO EACH SUPPORT AS FOLLOWS (UNO):
- | | |
|----------------------------|---|
| A. WOOD FRAMING | (2) 1/2" DIA. x 4" LONG LAG SCREWS |
| B. CONCRETE | (2) 1/2" DIA. x 4" WEDGE ANCHORS |
| C. MASONRY (FULLY GROUTED) | (2) 1/2" DIA. x 4" LONG SIMPSON TIE-ROD ANCHORS |
| D. STEEL PIPE COLUMN | (3) 3/4" DIA. A325 BOLTS OR 3/16" FILD WELD |
- LATERAL SUPPORT IS CONSIDERED ADEQUATE PROVIDED THE JOISTS ARE TOE NAILLED TO THE 2x STUD NAILER ON TOP OF THE STEEL BEAM, AND THE 2x NAILER IS SECURED TO THE TOP OF THE STEEL BEAM \forall (2) ROWS OF SELF TAPPING SCREWS @ 16" O.C. AND (2) ROWS OF 1/2" DIA. DIAMETER BOLTS @ 16" O.C. 1/2" BOLTS ARE USED TO FASTEN THE NAILER, THE STEEL BEAM SHALL BE FLAT W/ (2) ROWS OF 9/16" DIA. DIAMETER HOLES @ 16" O.C.
5. SQUARES DENOTE POINT LOADS WHICH REQUIRE SLOD BEARING TO GROUND OR FOUNDATION. SHADED SQUARES DENOTE POINT LOADS FROM ABOVE WHICH REQUIRE SLOD BEARING TO SUPPORT MEMBER BELOW.
6. ALL LOAD BEARING HEADERS OR SUPPORTS TO TABLE 602.2(1) AND 602.2(2) OF THE NCRG, 2018 EDITION OR BE (2) x 2 x 6 WITH (1) JACK AND (1) KING STUD EACH END (UNO), HOWEVER IF GREATER ALL HEADERS TO BE SECURED TO EACH 2x STUD WITH (4) 8d NAILS. ALL BEAMS TO BE SUPPORTED WITH (2) STUDS AT EACH BEARING POINT (UNO). INSTALL KING STUDS PER SECTION 602.7.5 OF THE NORTH CAROLINA RESIDENTIAL CODE, 2018 EDITION.
7. ALL BEAMS, HEADERS, OR ORDER TRUSSES PARALLEL TO WALLS ARE TO BEAR FULLY ON (1) JACK OR (2) STUDS MINIMUM OR THE NUMBER OF JACKS OR STUDS NOTED. ALL BEAMS OR ORDER TRUSSES PERPENDICULAR TO WALL AND SUPPORTED BY (3) STUDS OR LESS ARE TO HAVE 1 1/2" MINIMUM BEARING (UNO). ALL BEAMS OR ORDER TRUSSES PERPENDICULAR TO WALL AND SUPPORTED BY MORE THAN (3) STUDS OR OTHER NOTED COLUMN ARE TO BEAR FULLY ON SUPPORT COLUMN FOR ENTIRE WALL DEPTH (UNO). BEAM ENDS THAT BUTT INTO ONE ANOTHER ARE TO BE AT EACH BEAR EQUAL LENGTHS (UNO).
8. FLUTCH BEAMS SHALL BE BOLTED TOGETHER USING 1/2" DIAMETER STUDS (ASTM A307) WITH WASHERS PLACED AT THREADED END OF BOLT. BOLT SHALL BE SPACED AT 24" CENTERS (MAXIMUM), AND STAGGERED AT TOP AND BOTTOM OF BEAM (2" EDGE DISTANCE), WITH (2) BOLTS LOCATED AT 4" FROM EACH END (UNO).
9. ALL 1--JOIST OR TRUSS LAYOUTS ARE TO BE IN COMPLIANCE WITH THE OVERALL DESIGN SPECIFIED ON THE PLANS. ALL DEVIATIONS ARE TO BE BROUGHT TO THE ATTENTION OF THE ENGINEER OF RECORD PRIOR TO INSTALLATION.
10. BRACED WALL PANELS SHALL BE CONSTRUCTED ACCORDING TO THE NORTH CAROLINA RESIDENTIAL CODE 2018 EDITION WALL BRACING CRITERIA. ANOMALY, LENGTH, AND LOCATION OF BRACING SHALL COMPLY WITH ALL APPLICABLE TABLES IN SECTION 602.10.
11. PROVIDE DOUBLE JOIST SUPPORTS UNDER ALL WALLS PARALLEL TO FLOOR JOISTS. PROVIDE SUPPORT UNDER ALL WALLS PARALLEL TO FLOOR TRUSSES OR 1--JOISTS PER MANUFACTURER'S SPECIFICATIONS. INSTALL BRACING BETWEEN JOISTS OR TRUSSES FOR POINT LOAD SUPPORT FOR ALL POINT LOADS ALONG OFFSET LOAD LINES.
12. FOR ALL HEADERS SUPPORTING BRICK VENEER THAT ARE LESS THAN 6'-0" IN LENGTH, REST A 6" x 4" x 5/8" STEEL ANGLE WITH 6" MINIMUM EMBEDMENT AT SIDES FOR BRICK SUPPORT (UNO). FOR ALL HEADERS 6'-0" AND GREATER IN LENGTH, BOLT A 6" x 4" x 5/8" STEEL ANGLE TO HEADER WITH 1 1/2" LAG SCREWS AT 12" O.C. STAGGERED FOR BRICK SUPPORT. FOR ALL BRICK SUPPORT AT ROOF LINES, BOLT A 6" x 4" x 5/8" STEEL ANGLE TO (2) x 2x12 BLOOMING INSTALLED W/ (1) 12d NAIL EA. FL.Y. BETWEEN WALL STUDS WITH (2) ROWS OF 1/2" LAG SCREWS AT 12" O.C. STAGGERED AND IN ACCORDANCE WITH SECTION 703.8.2.1 OF THE NCRG, 2018 EDITION.
13. FOR STOCK FRAMED ROOFS: CIRCLES DENOTE (3) 2 x 4 POSTS FOR ROOF MEMBER SUPPORT. HP SPICES ARE TO BE SPACED A MINIMUM OF 6'-0". FASTEN MEMBERS WITH THREE ROWS OF 12d NAILS AT 16" O.C. FRAME DORMER WALLS ON TOP OF DOUBLE OR TRIPLE RAFTERS AS SHOWN (UNO).
14. FOR TRUSSED ROOFS: FRAME DORMER WALLS ON TOP OF 2 x 4 LADDER FRAMING AT 24" O.C. BETWEEN ADJACENT ROOF TRUSSES. STOCK FRAME OVER-FRAMED ROOF SECTIONS WITH 2x6 ROIDS, 2x6 BRACERS AT 16" O.C. AND FLAT 2 x 10 VALLEYS (UNO).
15. ALL 4 x 4 AND 6 x 6 POSTS TO BE INSTALLED WITH 700 LB CAPACITY UPLIFT CONNECTORS TOP AND BOTTOM (UNO). POSTS MAY BE SECURED USING ONE SIMPSON H6 OR 12152 UPLIFT CONNECTOR FASTENED TO THE BAND AT THE BOTTOM AND THE BEAM AT THE TOP OF EACH POST. ONE 6" SECTION OF CONCRETE CUBE CO. STRENGTHING WITH (8) 8d HD NAILS AT EACH END MAY BE USED IN THE BEAM OF EACH TRIM STAP FOR DESIGN. FOR MASONRY OR CONCRETE CUBE CO. STRENGTHING WITH (8) 8d HD NAILS AT EACH END MAY BE USED IN THE BEAM OF EACH TRIM STAP FOR DESIGN.

1. FOUNDATION DESIGN BASED ON A MINIMUM ALLOWABLE BEARING CAPACITY OF 2000 PSF. CONTACT GEOTECHNICAL ENGINEER IF BEARING CAPACITY IS NOT ACHIEVED.
2. FOR ALL CONCRETE SLABS AND FOOTINGS, THE AREA WITHIN THE PERIMETER OF THE BUILDING ENVELOPE SHALL HAVE ALL VEGETATION, TOP SOIL AND FOREIGN MATERIAL REMOVED. FILL MATERIAL SHALL BE FREE OF VEGETATION AND FOREIGN MATERIAL. THE FILL SHALL BE COMPACTED TO ASSURE UNIFORMITY OF 95% AND 90% FOR THE FILL. THE FILL SHALL BE SETTLING 24" FOR CLEAN SAND OR GRAVEL, 4" FOR THICK BASED COURSE CONSISTING OF CLEAN GRADED SAND OR GRAVEL SHALL BE PLACED. A BASE COURSE IS NOT REQUIRED WHERE A CONCRETE SLAB IS INSTALLED ON WELL-DRAINED OR SAND-DRAINED MEDIUM SOILS CLASSIFIED AS GROUP 1, ACCORDING TO THE UNITED SOIL CLASSIFICATION SYSTEM IN TABLE 100.1 OF THE NORTH CAROLINA PROJECT MANUAL.
3. PROPERLY DEEPEN EXCAVATION PRIOR TO POURING CONCRETE WHEN BOTTOM OF CONCRETE SLAB IS AT OR BELOW WATER TABLE. IF APPLICABLE, 3/4" - 1" DEEP CORROSION ANTS ARE TO BE SPACED WITHIN 4 TO 12 HOURS OF CONCRETE FINISHING AND WALL LOCATIONS HAVE BEEN MARKED. ADJUST WHERE NECESSARY.
4. CONCRETE SHALL CONFORM TO SECTION 802.02.4 OF THE NCRC, 2018 EDITION. CONCRETE REINFORCING STEEL TO BE ASTM A615 GRADE 60, MELTED WIRE FABRIC TO BE ASTM A195. MAINTAIN A MINIMUM COVERAGE AROUND REINFORCING STEEL OF 3" IN FOOTINGS AND 1 1/2" IN SLABS. REINFORCING STEEL SHALL BE MEASURED FROM THE INSIDE FACE OF THE WALL. SHALL NOT BE LESS THAN 3/4". CONCRETE COVER FOR REINFORCING STEEL MEASURED FROM THE OUTSIDE FACE OF THE WALL. SHALL NOT BE LESS THAN 1 1/2" FOR SLABS OR SMALLER, AND NOT LESS THAN 2" FOR #6 BARS OR LARGER.
5. MASONRY UNITS TO CONFORM TO AC 530/ASCE 5/MS 402, MORTAR SHALL CONFORM TO ASTM C270.
6. THE UNDESIGNED HEIGHT OF MASONRY PIERS SHALL NOT EXCEED FOUR TIMES THEIR LEAST DIMENSION FOR UNFILLED HOLLOW CONCRETE MASONRY UNITS AND TEN TIMES THEIR LEAST DIMENSION FOR SOLID OR SOLID FILLED PIERS. PIERS MAY BE FILLED WITH CONCRETE OR TYPE III OR M S MORTAR. PIERS AND WALLS SHALL BE CAPPED WITH 8" OF SOLID MASONRY.
7. THE CENTER OF EACH OF THE PIERS SHALL BEAR IN THE MIDDLE THIRD OF ITS RESPECTIVE FOOTING. EACH GROSSER SHALL BEAR IN THE MIDDLE THIRD OF THE PIERS.
8. ALL CONCRETE AND MASONRY FOUNDATION WALLS ARE TO BE CONSTRUCTED IN ACCORDANCE WITH THE PROVISIONS OF SECTION 804.04 OF THE NCRC, 2018 EDITION OR IN ACCORDANCE WITH AD 318, AD 332, NCMA THRU-4 OR AC 530/ASCE 5/MS 402. MASONRY FOUNDATION WALLS SHALL BE REINFORCED PER TABLE 1004.1(1), 1004.1(2)(1), 1004.1(3)(1), 1004.1(4)(1) OF THE NCRC, 2018 EDITION. CONCRETE FOUNDATION WALLS ARE TO BE REINFORCED PER TABLE 100.1(1), 100.1(2), 100.1(3), 100.1(4) OF THE NCRC, 2018 EDITION. STEP CONCRETE FOUNDATION WALLS TO 2 x 6 FRAMED WALLS SHALL BE REINFORCED AS FOLLOWS (S40).

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120 MPH - 130 MPH ULTIMATE DESIGN WIND SPEED
STANDARD STRUCTURAL NOTES
DREAM FINDERS HOMES

DATE: JUNE 17, 2023

SCALE:NTS

DRAWN BY: IST

ENGINEERED BY JS

S-0
STRUCTURAL
NOTES

1/4/2023