

PLAN REVISIONS:

- ELIMINATED FIRST FLOOR TO SECOND FLOOR ROOF CONDITION TO REMOVE CEILING BEAMS AND UPLIFT ISSUES FOR HIGH MINI
 - SLIGHTLY REDESIGNED KITCHEN SO THAT PANTRY AREA IS IMPROVED AND TO MAKE FOR A NICER GOURMET OPTION WHEN CHOSEN
 - RELOCATED STAIRS TO ACCOMODATE FOR A DEEPER GREAT ROOM SO THAT THE BAR AREA DID NOT ENCRACK THE FURNITURE PLACENT
 - REDESIGNED MASTER BEDROOM, MASTER BATH, LAUNDRY AND MUD TO ACCOMODATE NEW STAIR LOCATION
 - MADE FIREPLACE AN INSIDE FOOTPRINT OPTION
 - ADDED 2 TO REAR OF HOUSE
 - REMOVED ALL SPACE OVER GARAGE TO ELIMINATE EWP OVER GARAGE AREA
 - SHIFTED SECOND FLOOR TO REAR WALL SO THAT ENTIRE SECOND FLOOR STACKS WITH FIRST FLOOR
 - MADE OVERLOOK AREA FROM LOFT A FULL 2-STORY TO SIMPLIFY TRUSS DESIGN AND MAKE AN OPPORTUNITY FOR A REC ROOM OPTION
- 7/31/23
- ADDED B AND C ELEVATIONS
- 8/16/23
- MADE OPEN TO BELOW GREAT ROOM WALLS 2X6 BALLOON FRAMING

- 10/23/23
- CHANGE PANTRY CAB TO FRAMED REACH-IN PANTRY
 - SHOWER PANS AND TUBS IN INCHES
 - REMOVE SEAT IN SHOWER
 - MAKE 36X60 WITH 3010 AND PACK OUT EACH SIDE EVENLY AND MAKE VANITY 66" FOR SHOWER ONLY BATH, LEAVE OPTIONAL BATH AS IS
 - CHANGE 36X60 BATH UPGRADE TO P BATH NOT Q BATH
 - POWDER WALL PLUMBED 2X6 AT BENCH AND AT TOILETM BED WALL
 - OPTIONAL 3050 IN DINING CENTERED ON LEFT WALL
 - 32" WALL IN GARAGE AT WATER HEATER WITH DEDICATED OUTLET
 - BED 5 OPTION EDITED TO INCLUDE BATH WITHIN OPTION
 - CHANGE EXTRA BEDROOM ENTRY DOORS TO 26"
 - CHASE ADDED TO BED 2

- 12/11/23
- MODIFIED P BATH STANDARD SLIGHTLY TO ALLOW FOR SHOWER UNIT IN O TILE SURROUND SHOWER
 - ADDED OPTIONAL PATIO
 - CHANGED ROOM NAMES TO NEW DREAMFINDERS STANDARDS

- 1/5/23
- MADE ALL MULLED WINDOWS INTO 2 SINGLE WINDOWS WITH STUD POCKETS
 - ADDED COFFEE OPTION TO DINING
 - ADDED PLUMB DROP DIMENSION TO MONO AND STEM WALL SLAB
 - ROTATE WATER HEATER AND WING WALL
 - ADD PULL DOWN STAIR LOCATION
 - MAKE COVERED PORCH OPTION COME WITH OVERHEAD LIGHT IN O WALL LIGHT
 - ADD CAN TO KITCHEN AND REARRANGE
 - ADJUST OUTLETS IN PRIMARY BATHS
 - ADD CAN OPTION TO SINGLE STORY GREAT ROOM
 - MAKE PENDANTS OPTIONAL IN KITCHEN
 - CENTER LIGHT OVER STAIR FOR BETTER STAIRWELL LIGHTING

- 6/27/24
- SHIFT SHOWER IN PRIMARY STANDARD AND TUB IN PRIMARY UPGRADE TO ALLOW MORE ROOM TO ENTER THE AREA
 - OPT FAN ROUGH-INS IN BEDROOMS
 - ADD OPT DOOR FROM MP TO LAUNDRY
 - ADDED 30 PERCENT BRICK ELEVATIONS ABC

- 10/7/24
- ADDED OPTIONAL BRICK/STONE WAHSCOTING TO ELEV A
 - OPT STONE/BRICK NOTES ON ELEV B
 - STONE OR BRICK NOTES ON ELEV C

COLLEX469INVENTORYMARKEDPLAN



Elevation 'A'

A/B MEAN ROOF HGT = 22'-4"
C MEAN ROOF HGT = 21'-11"

ENERGY COMPLIANCE MINIMUMS
MAX GLAZING U-FACTOR = 0.35
WALL R-VALUE = 15
CEILING R-VALUE = 38
FLOOR R-VALUE = 19



2 Elevation 'B'

0-CS WHEN PRINTED ON 11"x17" / ANSI B PAPER SIZE
1/4" = 1'-0"

WHEN PRINTED ON 22"x34" / ANSI D PAPER SIZE

3 Elevation 'C'

0-CS WHEN PRINTED ON 11"x17" / ANSI B PAPER SIZE
1/4" = 1'-0"

Heated SQFT Elev. A	
Description	Area
1st Floor Livable	1426 SF
2nd Floor Livable	1087 SF
Gross Heated SF	2513 SF

Heated SQFT W Recroom A	
Description	Area
1st Floor Livable	1426 SF
2nd Floor Livable	1386 SF
Gross Heated SF	2812 SF

Heated SQFT Elev. B/C	
Description	Area
1st Floor Livable	1426 SF
2nd Floor Livable	1098 SF
Gross Heated SF	2524 SF

Unheated SQFT	
Description	Area
Front Porch	93 SF
Garage	418 SF
Opt. Cov'd Porch	120 SF








Bellwood Carolinas 3654 - RH
Dream Finders Homes
Cover Sheet

Date: 10/7/24
Drawn By: rdc
Checked By: sgm

DREAM FINDERS HOMES

0-CS

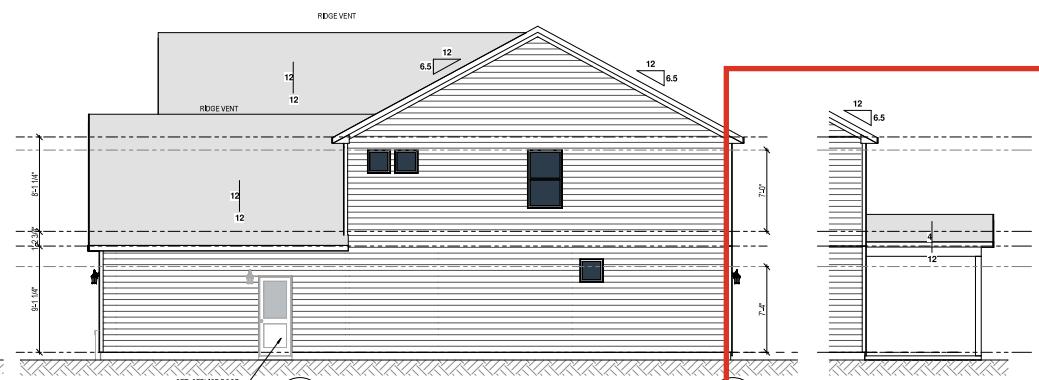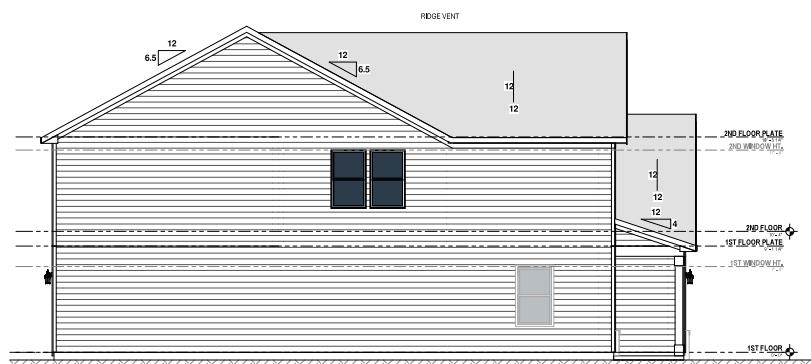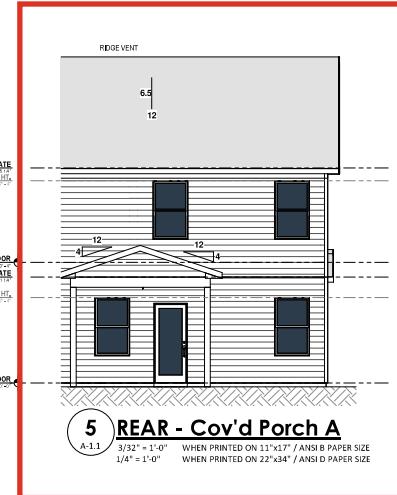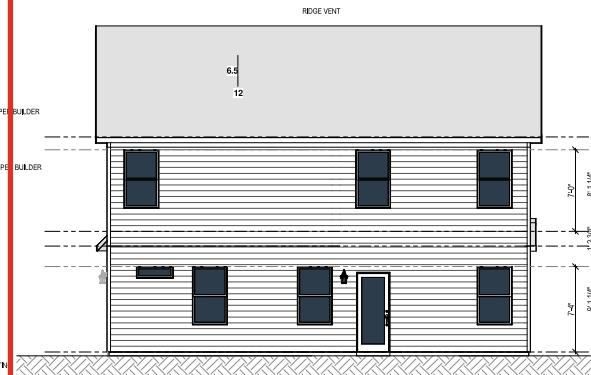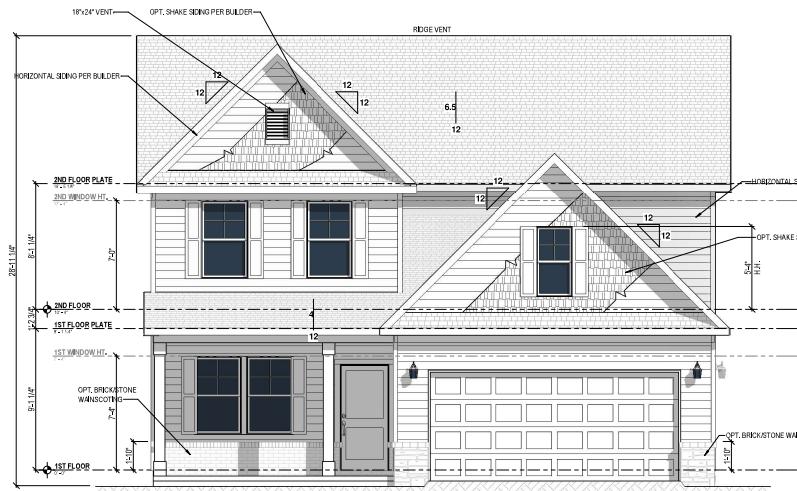

Bellwood Carolinas 3654 - RH
 Dream Finders Homes
 Elevations - A

Date: 10/7/24
 Drawn By: rdc
 Checked By: sgm



DREAM FINDERS
 HOMES



A-1.1



Wall Notes

- NOTE:
 • ALL EXTERIOR WALLS TO BE 2X4 WALLS (STUD SPACING PER STRUCTURAL DRAWINGS)
 • ALL INTERIOR WALLS TO BE 2X4 UNLESS OTHERWISE NOTED (SPACING PER STRUCTURAL DRAWINGS)

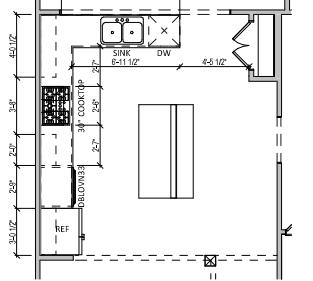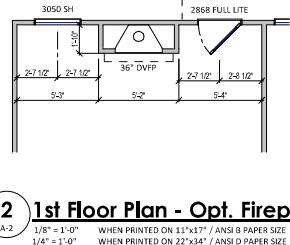


6 Opt. Dining Coffered Coffer A

A-2
 1/8" = 1'-0" WHEN PRINTED ON 11"x17" / ANSI B PAPER SIZE
 1/4" = 1'-0" WHEN PRINTED ON 22"x34" / ANSI D PAPER SIZE

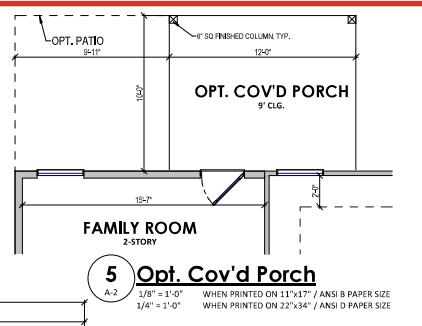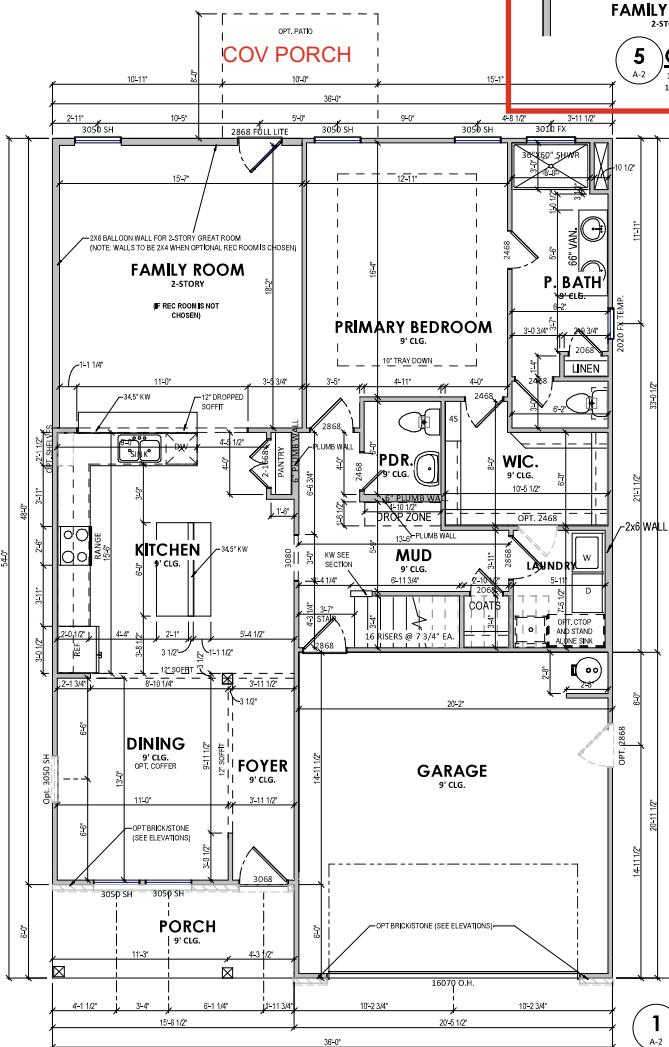

5 Opt. Cov'd Porch

1/8" = 1'-0" WHEN PRINTED ON 11"x17" / ANSI B PAPER SIZE
 1/4" = 1'-0" WHEN PRINTED ON 22"x34" / ANSI D PAPER SIZE

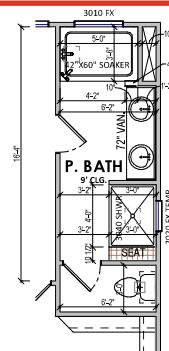


4 1st Floor Plan - P. Bath Upgrade

A-2
 1/8" = 1'-0" WHEN PRINTED ON 11"x17" / ANSI B PAPER SIZE
 1/4" = 1'-0" WHEN PRINTED ON 22"x34" / ANSI D PAPER SIZE




Wall Notes

- NOTE:
 • ALL EXTERIOR WALLS TO BE 2X4 WALLS (STUD SPACING PER STRUCTURAL DRAWINGS)
 • ALL INTERIOR WALLS TO BE 2X4 UNLESS OTHERWISE NOTED (SPACING PER STRUCTURAL DRAWINGS)

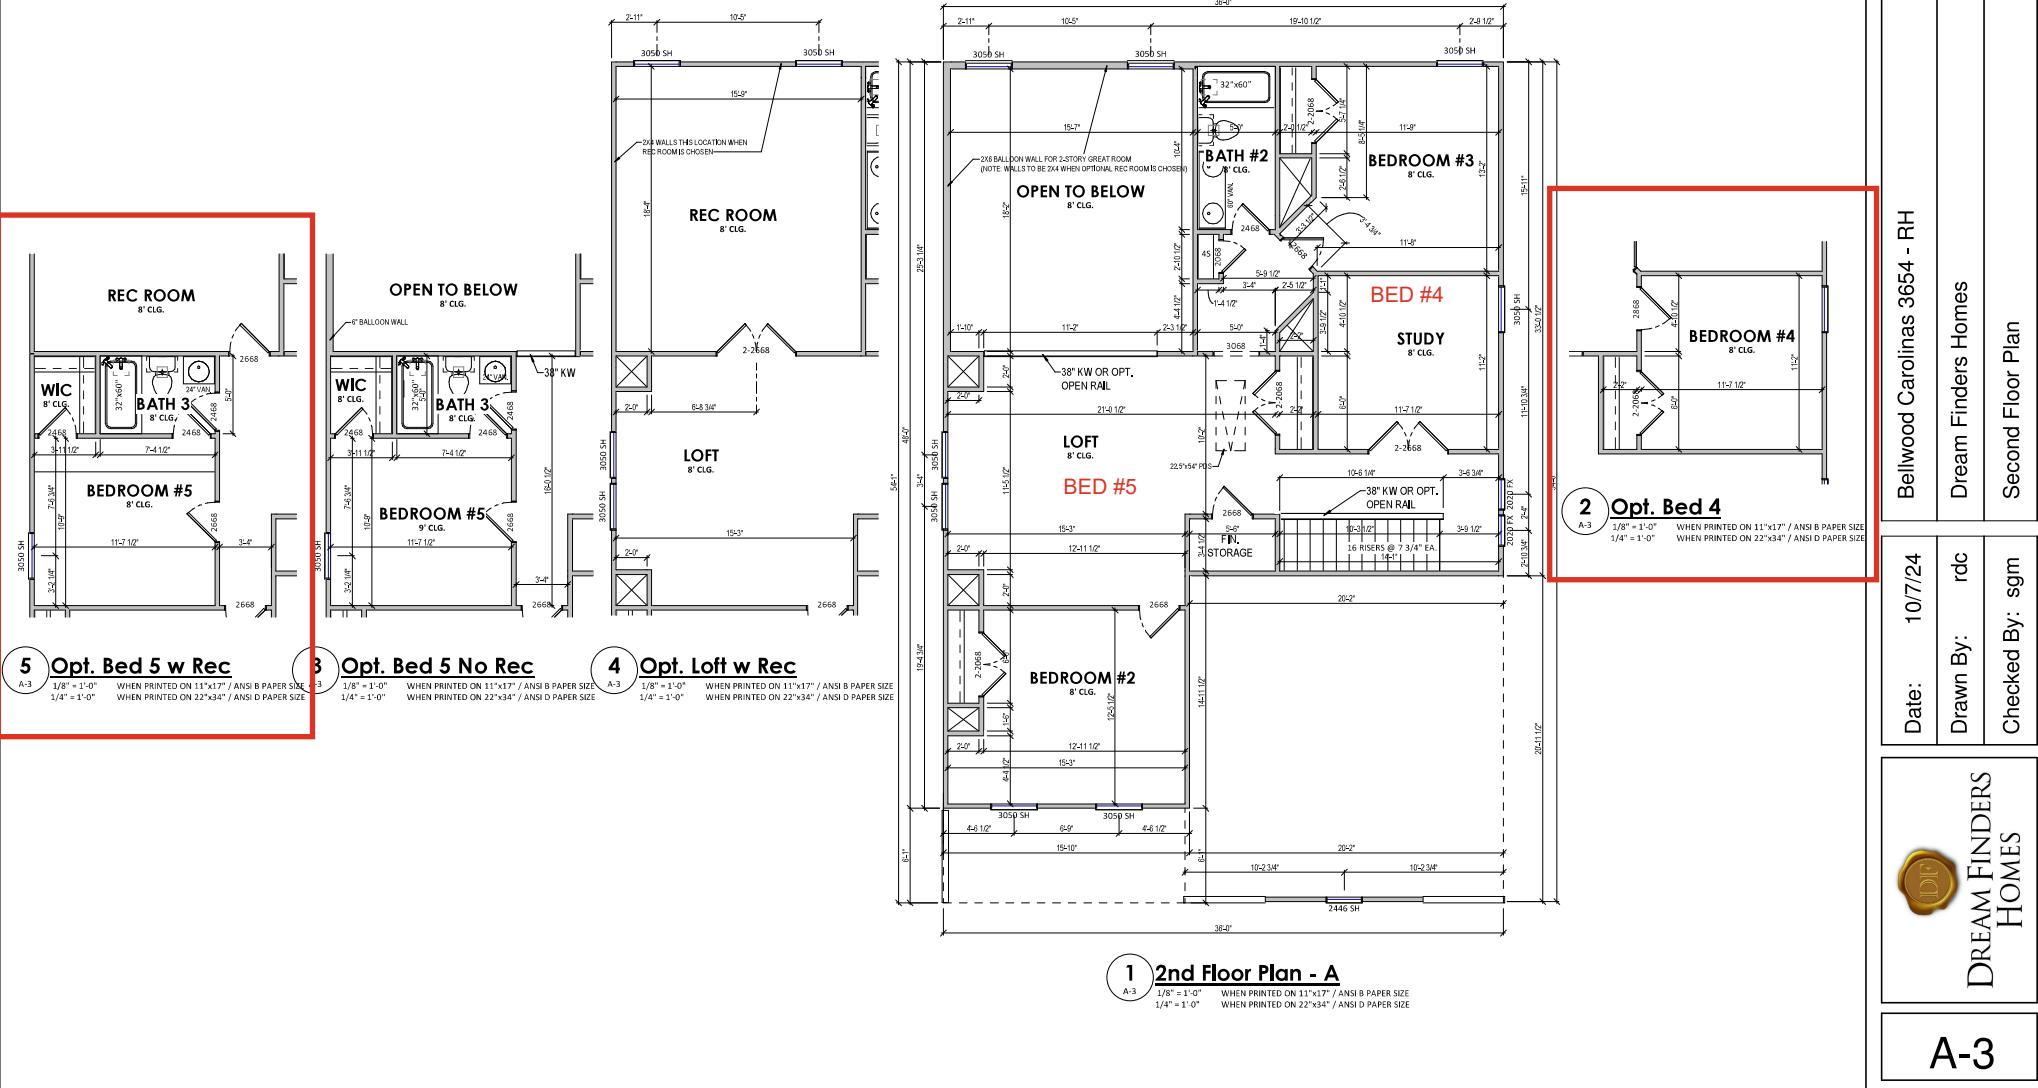

NOTE: THIS SHEET IS AN ARCHITECTURAL FOUNDATION SHEET INTENDED ONLY FOR EXTERIOR DIMENSIONS AND VISUALIZATION OF THE FOUNDATION PERIMETER

SEE SEALED STRUCTURAL PAGE FOR INFORMATION REGARDING, BUT NOT LIMITED TO, FOOTING LOCATIONS AND SPECIFICATIONS, SLAB THICKNESS AND COMPACTION

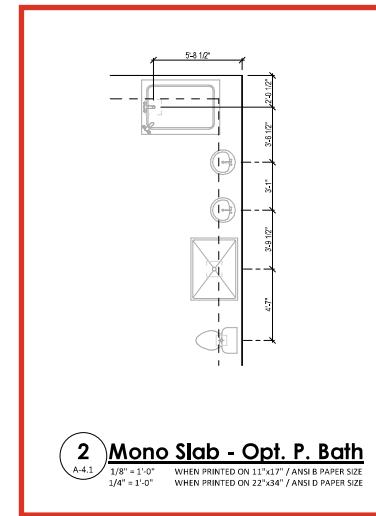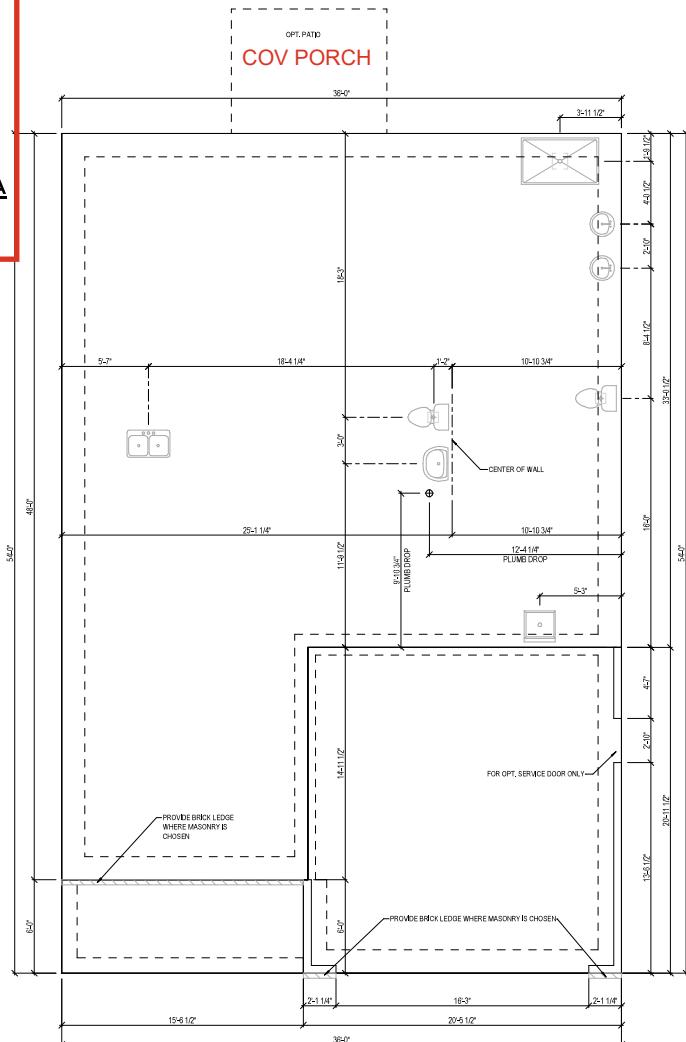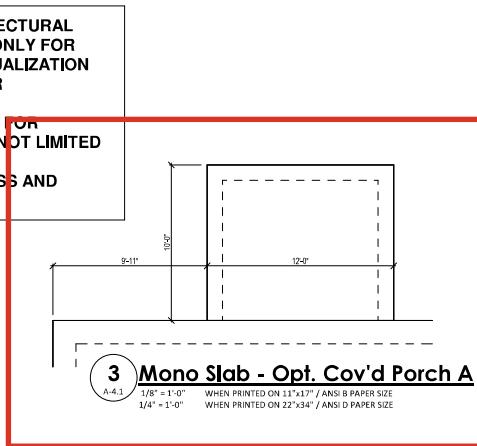

Bellwood Carolinas 3654 - RH
Dream Finders Homes
Mono Slab Foundation - A

Date: 10/7/24
Drawn By: sgm
Checked By: sgm


DREAM FINDERS HOMES


A-4.1

NOTE: PLANSOURCE DESIGNS IS NOT RESPONSIBLE FOR THE STRUCTURAL CALCULATIONS FOR THIS CONSTRUCTION PLAN SET. ALL STRUCTURAL DESIGN AND APPROVALS, INCLUDING, BUT NOT LIMITED TO, BEAM SIZES, FLOOR SPANS, STUD COLUMNS AND, FOOTING SIZES, ARE TO BE THE RESPONSIBILITY OF THE BUILDER AND/OR ENGINEER.

A-4.1
1/8" = 1'-0"
1/4" = 1'-0"
WHEN PRINTED ON 11"x17" / ANSI B PAPER SIZE
WHEN PRINTED ON 22"x34" / ANSI D PAPER SIZE


ROOF VENT CALCULATIONS

TOTAL AREA UNDER ROOF =	1804
TOTAL VENTILATION REQ'D =	1804/150
BUILDER SHALL PROVIDE =	12.03 SQFT OF VENT

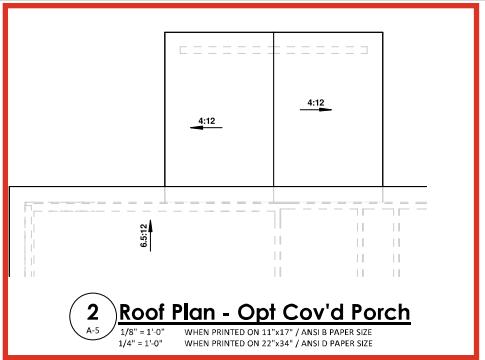

2 Roof Plan - Opt Cov'd Porch

A-5 1/8" = 1'-0" WHEN PRINTED ON 11"x17" / ANSI B PAPER SIZE
1/4" = 1'-0" WHEN PRINTED ON 22"x34" / ANSI D PAPER SIZE

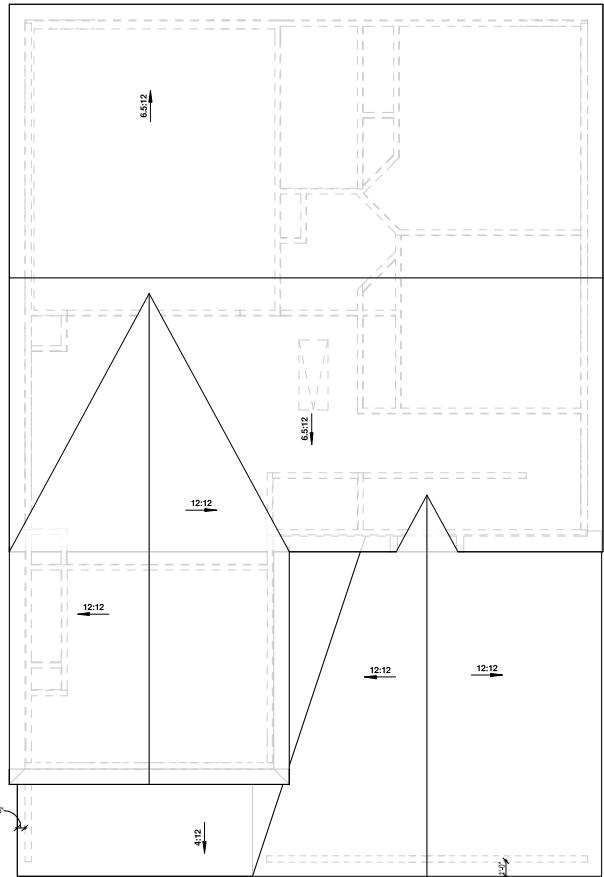

1 Roof Plan - A

A-5 1/8" = 1'-0" WHEN PRINTED ON 11"x17" / ANSI B PAPER SIZE
1/4" = 1'-0" WHEN PRINTED ON 22"x34" / ANSI D PAPER SIZE

NOTE: PLANSOURCE DESIGNS IS NOT RESPONSIBLE FOR THE STRUCTURAL CALCULATIONS FOR THIS CONSTRUCTION PLAN SET. ALL STRUCTURAL DESIGN ELEMENTS, INCLUDING BUT NOT LIMITED TO, BEAM SIZES, FLOOR SPANS, STUD COLUMNS AND FOOTING SIZES, ARE TO BE THE RESPONSIBILITY OF THE BUILDER AND/OR ENGINEER.



Bellwood Carolinas 3654 - RH
Dream Finders Homes
Roof Plan - A



Date: 10/7/24
Drawn By: sgm
Checked By: sgm

DREAM FINDERS HOMES


A-5

ELECTRICAL LEGEND


1	SINGLE POLE SWITCH
2	3-WAY SWITCH
3	4-WAY SWITCH
4	DIMMER SWITCH
5	220 VOLT OUTLET
6	DUREX OUTLET
7	GROUND FAULT
8	OUTLET
9	SMOKE DETECTOR
10	CARBON MONOXIDE DETECTOR
11	TELEVISION OUTLET
12	PANEL
13	SERVICE METER
14	WALL MOUNT LIGHT
15	FLOOD LIGHT
16	STRIP LIGHT
17	BATH FAN & LIGHT
18	CLOSET CASTER LIGHT
19	CASTER
20	PULL CHAIN LIGHT
21	FLUSH MOUNT LIGHT
22	HANGING PENDANT LIGHT
23	RECESSED CAN LIGHT
24	FLUORESCENT LIGHT
25	CEILING FAN
26	LIGHTED CEILING PAN
27	DOOR BELL BUTTON
28	CHIME
29	GARAGE DOOR
30	BUTTON
31	OPEN
32	WATERPROOF
33	OUTLET
34	CEILING OUTLET
35	FLOOR OUTLET
36	CARBON MONOXIDE & SMOKE DETECTOR
37	DATA
38	WORK OUTLET
39	PH
40	GARBAGE DISPOSAL
41	ACCENT
42	SINGLE SCONCE
43	DOUBLE SCONCE
44	STAR LIGHT
45	BATH FAN
46	UNDER CABINET LIGHT
47	KEYLESS LIGHT
48	HANGING
49	MINIATURE PUCK
50	LIGHT
51	RECESSED EYEBALL
52	FLUORESCENT LIGHT
53	RECTANGULAR
54	ROUGH
55	LIGHT w/ FAN
56	ROUGH
57	LCF
58	ROUGH
59	LIGHT & FAN
60	ROUGH

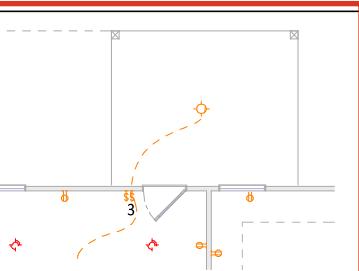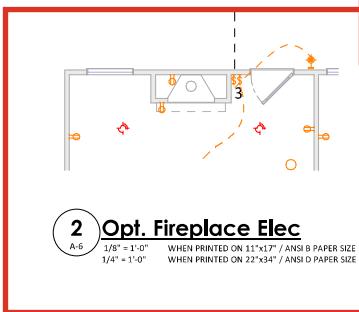


4 Opt. Cov'd Porch Elec
A-6
1/8" = 1'-0" WHEN PRINTED ON 11"x17" / ANSI B PAPER SIZE
1/4" = 1'-0" WHEN PRINTED ON 22"x34" / ANSI D PAPER SIZE

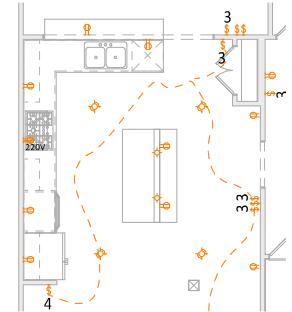

3 Opt. Gourmet Kitchen
A-6
1/8" = 1'-0" WHEN PRINTED ON 11"x17" / ANSI B PAPER SIZE
1/4" = 1'-0" WHEN PRINTED ON 22"x34" / ANSI D PAPER SIZE

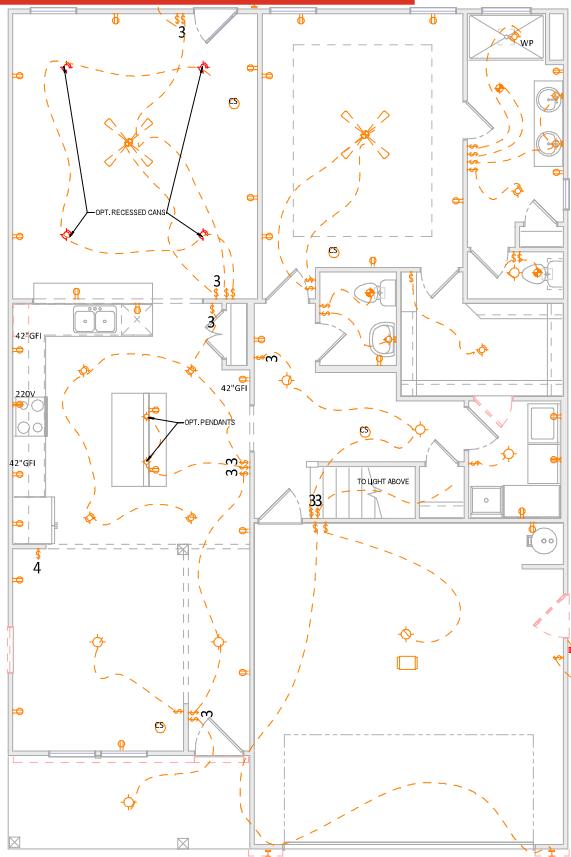

1 1st Floor Electrical
A-6
1/8" = 1'-0" WHEN PRINTED ON 11"x17" / ANSI B PAPER SIZE
1/4" = 1'-0" WHEN PRINTED ON 22"x34" / ANSI D PAPER SIZE

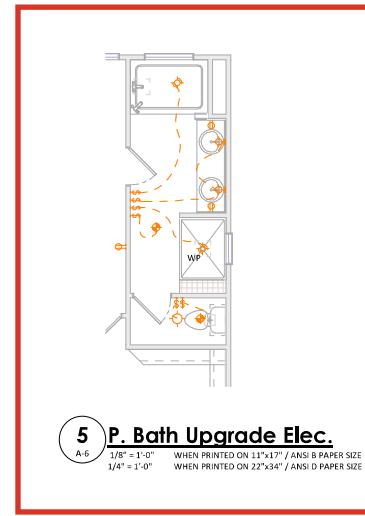

5 P. Bath Upgrade Elec.
A-6
1/8" = 1'-0" WHEN PRINTED ON 11"x17" / ANSI B PAPER SIZE
1/4" = 1'-0" WHEN PRINTED ON 22"x34" / ANSI D PAPER SIZE

Bellwood Carolinas 3654 - RH
Dream Finders Homes
First Floor Electrical - A


Date: 10/7/24
Drawn By: rdc
Checked By: sgm

DREAM FINDERS HOMES
DIF


A-6

ELECTRICAL LEGEND


\$	SINGLE POLE SWITCH	DB	DOOR BELL BUTTON
E	3-WAY SWITCH	CHIME	DOOR BELL CHIME
4	4-WAY SWITCH	GD	GARAGE DOOR
D	DIMMER SWITCH	GD	GARAGE DOOR
220	220 VOLT OUTLET	WPS	WEATHERPROOF
DU	DUPLEX OUTLET	OUTLET	CEILING OUTLET
GFI	GROUND FAULT	FLR	FLOOR OUTLET
SD	SMOKE DETECTOR	CARBON MONOXIDE & SMOKE DETECTOR	
C	CARBON MONOXIDE DETECTOR	DATA	WORK OUTLET
TU	TELEVISION OUTLET	PH	TELEPHONE OUTLET
PAN	SERVICE PANEL		GARBAGE DISPOSAL
M	SERVICE METER	ACCENT	ACCENT LIGHT
W	WALL MOUNT LIGHT	SINGLE SCONCE	
F	FLOOD LIGHT	DOUBLE SCONCE	
STR	STRIP LIGHT	STR	STAIR LIGHT
COMBO	COMBO CASTER LIGHT	BATH FAN	
CASTER	CASTER CASTER LIGHT	UC	UNDER CABINET
PUL	PUL CHAIN LIGHT	LIGHT	KEYLESS LIGHT
HANG	FLUSH MOUNT LIGHT	HANGING	HANGING LIGHT
PNDT	HANGING PENDANT	MINI	MINIATURE PUCK
LIGHT	DERESSED CAN LIGHT	LIGHT	DERESSED EYEBALL
FLU	FLUORESCENT LIGHT	FLU	FLUORESCENT LIGHT
REC	RECTANGULAR	ROUND	ROUND
CF	CEILING FAN	LCF	ROUGH
LCF	LIGHTED CEILING FAN	LCF	ROUGH
LCF	ROUGH	LCF	ROUGH
LCF	ROUGH	LCF	ROUGH

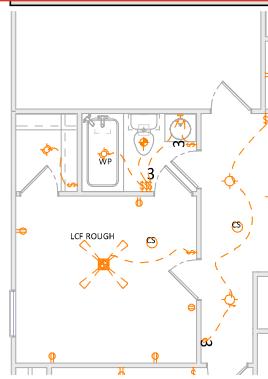
4 Opt. Bed 5 w Rec Elec


A-7 1/8" = 1'-0" WHEN PRINTED ON 11"x17" / ANSI B PAPER SIZE
1/4" = 1'-0"

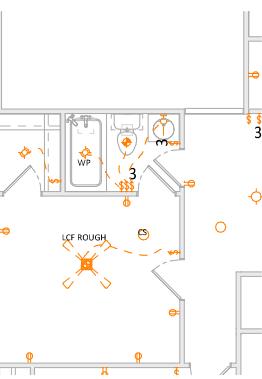
3 Opt. Bed 5 No Rec Elec


A-7 1/8" = 1'-0" WHEN PRINTED ON 11"x17" / ANSI B PAPER SIZE
1/4" = 1'-0"

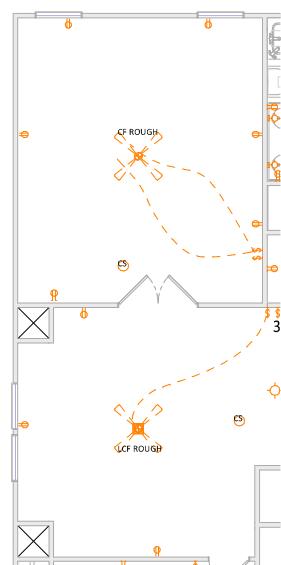
5 Opt. Loft w Rec Elec

A-7 1/8" = 1'-0" WHEN PRINTED ON 11"x17" / ANSI B PAPER SIZE
1/4" = 1'-0"

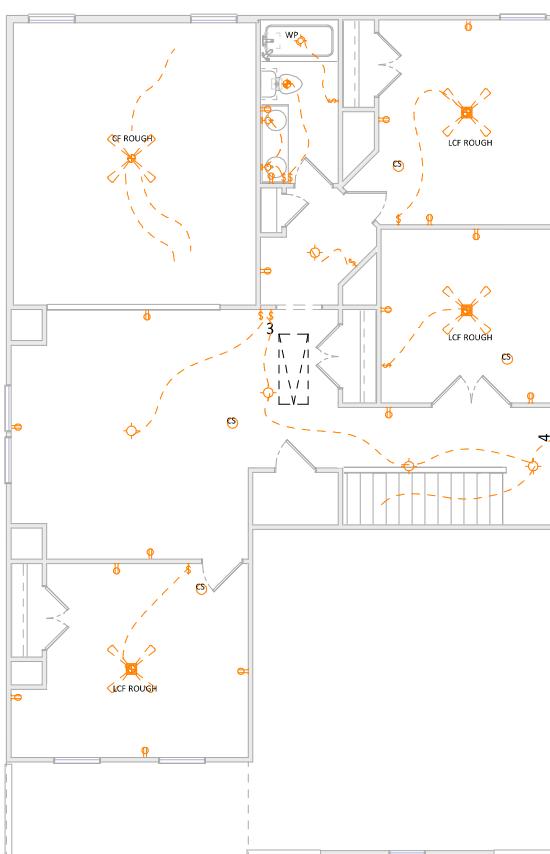
1 2nd Floor Electrical Plan

A-7 1/8" = 1'-0" WHEN PRINTED ON 11"x17" / ANSI B PAPER SIZE
1/4" = 1'-0"

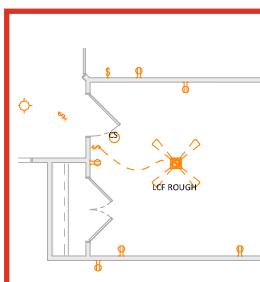
2 Opt. Bed 4 Elec


A-7 1/8" = 1'-0" WHEN PRINTED ON 11"x17" / ANSI B PAPER SIZE
1/4" = 1'-0"

Bellwood Carolinas 3654 - RH
Dream Finders Homes
Second Floor Electrical - A

Date: 10/7/24
Drawn By: rdc
Checked By: sgm

DREAM FINDERS HOMES


A-7

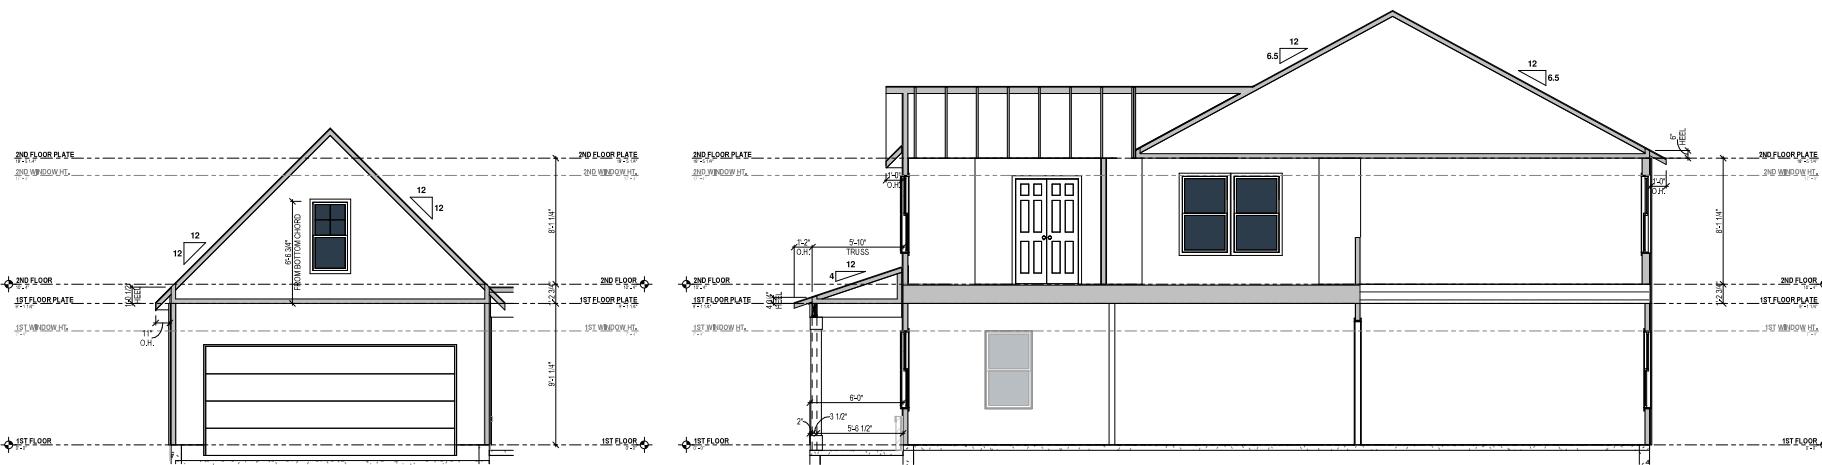

1 GARAGE A

A-8 1/8" = 1'-0" WHEN PRINTED ON 11"x17" / ANSI B PAPER SIZE
1/4" = 1'-0" WHEN PRINTED ON 22"x34" / ANSI D PAPER SIZE

2 HOUSE SECTION A

A-8 1/8" = 1'-0" WHEN PRINTED ON 11"x17" / ANSI B PAPER SIZE
1/4" = 1'-0" WHEN PRINTED ON 22"x34" / ANSI D PAPER SIZE

Bellwood Carolinas 3654 - RH
Dream Finders Homes
Sections

Date: 10/7/24
Drawn By: sgm
Checked By: sgm

DREAM FINDERS
HOMES

A-8



BELLWOOD RH

NORTH CAROLINA

THESE DRAWINGS ARE TO BE USED IN CONJUNCTION WITH AND COORDINATED WITH THE ARCHITECTURAL, CIVIL, MECHANICAL, ELECTRICAL, AND PLUMBING DRAWINGS. THIS COORDINATION IS NOT THE RESPONSIBILITY OF THE STRUCTURAL ENGINEER OF RECORD (SER). SHOULD ANY DISCREPANCIES BECOME APPARENT, THE CONTRACTOR SHALL NOTIFY KSE ENGINEERING, P.C. BEFORE CONSTRUCTION BEGINS. IT IS THE INTENT OF THE ENGINEER LISTED ON THESE DOCUMENTS THAT THESE DOCUMENTS BE ACCURATE, PROVIDING LICENSED PROFESSIONALS CLEAR INFORMATION. EVERY ATTEMPT HAS BEEN MADE TO PREVENT ERROR, THE BUILDER AND ALL SUBCONTRACTORS ARE REQUIRED TO REVIEW ALL OF THE INFORMATION CONTAINED IN THESE DOCUMENTS PRIOR TO THE COMMENCEMENT OF ANY WORK. THE ENGINEER IS NOT RESPONSIBLE FOR ANY PLAN ERRORS, OMISSIONS, OR MISINTERPRETATIONS UNDETECTED AND NOT REPORTED TO THE ENGINEER PRIOR TO CONSTRUCTION. ALL CONSTRUCTION MUST BE IN ACCORDANCE TO THE INFORMATION FOUND IN THESE DOCUMENTS.

DESIGN SPECIFICATIONS:

DESIGN BUILDING CODE (REFERRED TO HEREIN AS "THE BUILDING CODE"):

- 2018 NORTH CAROLINA RESIDENTIAL CODE, WALL BRACING PER INTERNATIONAL RESIDENTIAL CODE 2015 EDITION.

DESIGN LIVE LOADS:

- ROOF = 20 PSF (LOAD DURATION FACTOR=1.25)
- UNINHABITABLE ATTICS WITH LIMITED STORAGE = 20 PSF (WHERE SPECIFIED ON PLANS)
- HABITABLE ATTICS AND ATTICS SERVED WITH FIXED STAIRS = 30 PSF
- FLOOR = 40 PSF
- FLOOR (SLEEPING AREAS) = 30 PSF
- DECK = 40 PSF
- BALCONY = 40 PSF
- STAIRS = 40 PSF

DESIGN DEAD LOADS:

- ROOF TRUSS = 17 PSF (TC=7, BC=10)
- FLOOR TRUSS = 15 PSF (TC=10, BC=5)
- FLOOR JOIST = 10 PSF
- QUEEN ANNE BRICK = 25 PSF

NOTE: STRUCTURAL FRAMING HAS NOT BEEN DESIGNED FOR TILE, GRANITE, MARBLE OR OTHER MATERIALS HEAVIER THAN THE ABOVE LOADING UNLESS SPECIFICALLY NOTED ON PLANS.

DESIGN WIND LOADS:

- ULTIMATE WIND SPEED = Up to 120 MPH
- EXPOSURE CATEGORY = B

ASSUMED SOIL BEARING CAPACITY = 2000 PSF

ASSUMED LATERAL SOIL PRESSURE = 45 PCF

FROST DEPTH = 12"

SEISMIC DESIGN CATEGORY = B

ENGINEERED LUMBER SHALL HAVE THE FOLLOWING MINIMUM DESIGN VALUES:

- TJI 210 SERIES (SERIES AND SPACING PER PLANS)
 - LSL: $E=1,550,000$ PSI, $F_a=2,325$ PSI, $F_v=310$ PSI, $F_c=900$ PSI
 - LVL: $E=2,000,000$ PSI, $F_a=2,600$ PSI, $F_v=285$ PSI, $F_c=750$ PSI
 - PSL: $E=2,100,000$ PSI, $F_a=2,900$ PSI, $F_v=290$ PSI, $F_c=625$ PSI

THIS PLAN HAS BEEN DESIGNED PER THE 2018 EDITION OF THE NC RESIDENTIAL CODE, WHERE FRAMING, FOUNDATION, OR OTHER STRUCTURAL ITEMS DO NOT COMPLY WITH THE PRESCRIPTIVE METHODS OF THE CODE, THOSE ITEMS HAVE BEEN DESIGNED IN ACCORDANCE WITH ACCEPTED ENGINEERING PRACTICE PER NCRC R301.1.3.





Cover Sheet

Project #: 105-23003
Designed By:
Checked By:
Issue Date: 8/17/23
Re-Issue: 7/18/24
Scale: 1/8"=1'-0" @ 11x17
1/4"=1'-0" @ 22x34



S-0

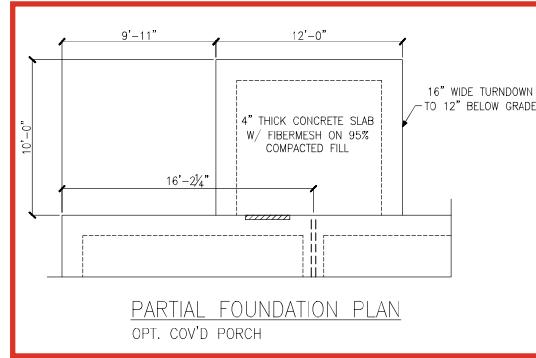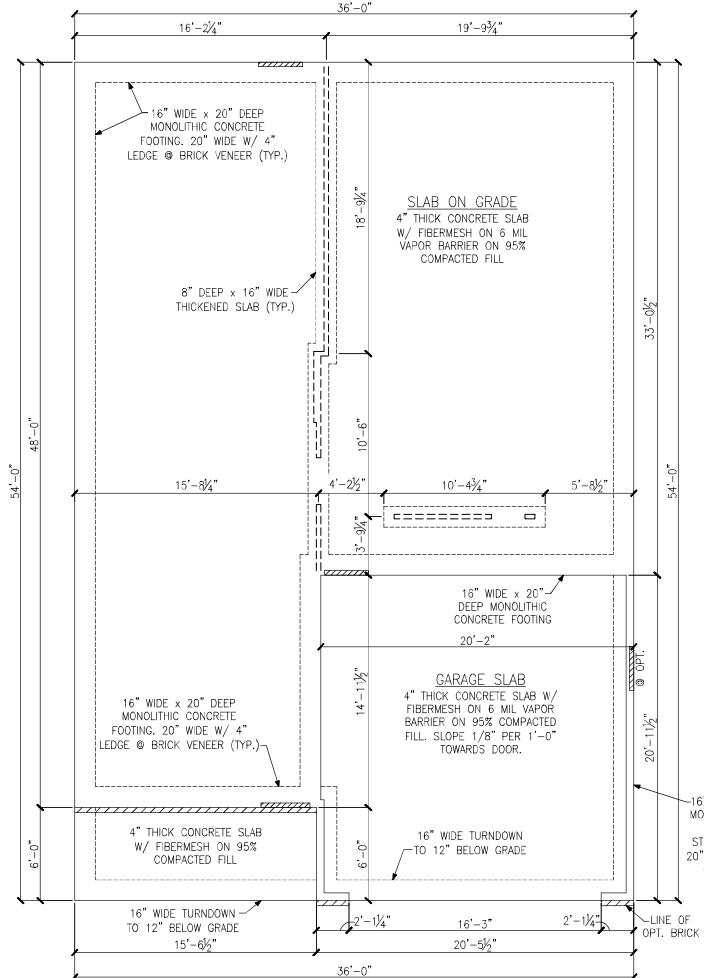

LEGEND	
★	PROVIDE SOLID BLOCKING WITHIN FLOOR SYSTEM TO MATCH POST SIZE ABOVE.
→	BEARING WALL ABOVE
□□□□□	INTERIOR BEARING WALL
▨▨▨▨▨	SPACED WALL PANEL 48" WSP (SEE KSE STRUCTURAL DETAILS SET FOR SPACED WALL PANEL SHEATHING FASTENING & BLOCKING DETAILS)
▨▨▨▨▨	LOCATION OF DOOR ABOVE



REFER TO KSE STRUCTURAL DETAILS SET FOR GENERAL STRUCTURAL NOTES AND TYPICAL DETAILS

Monolithic Slab Foundation Plans
Elevation 'A' & Options
Bellwood Model - RH
Up To 120 M.R.H.
Carolina Division

Project #: 105-23003
Designed By: KRK
Checked By:
Issue Date: 8/17/23
Re-Issue: 7/16/24
Scale: 1/8"=1'-0" @ 11x17
1/4"=1'-0" @ 22x34



S-1

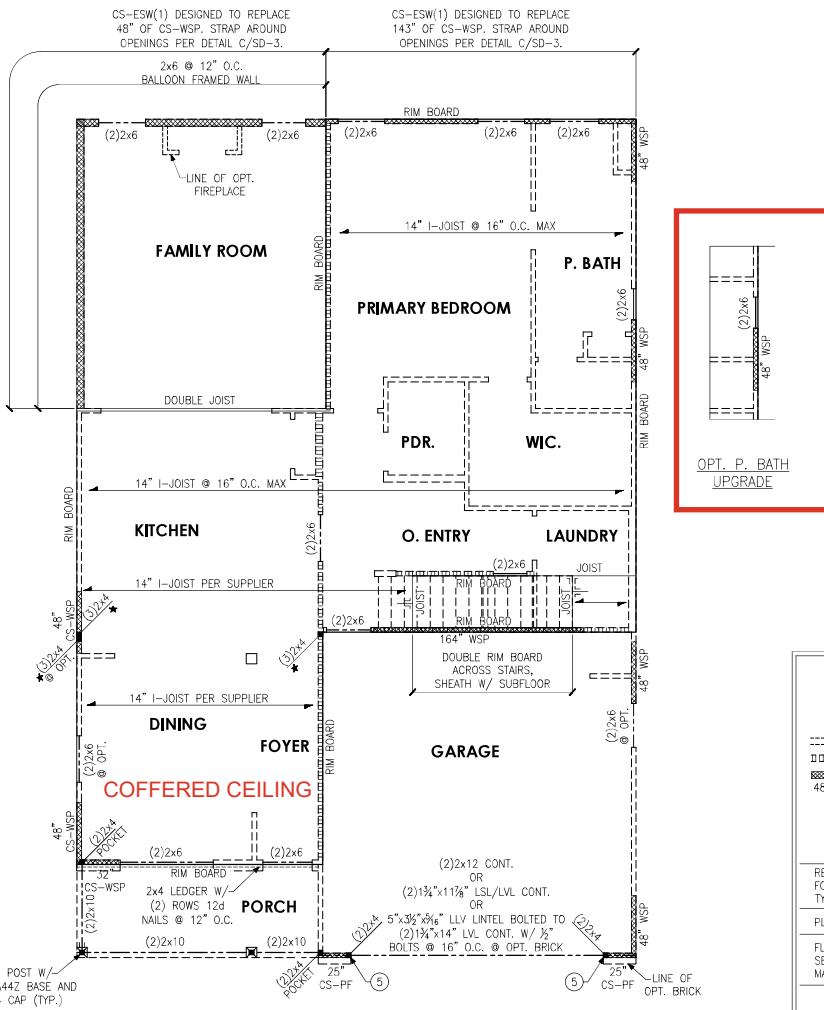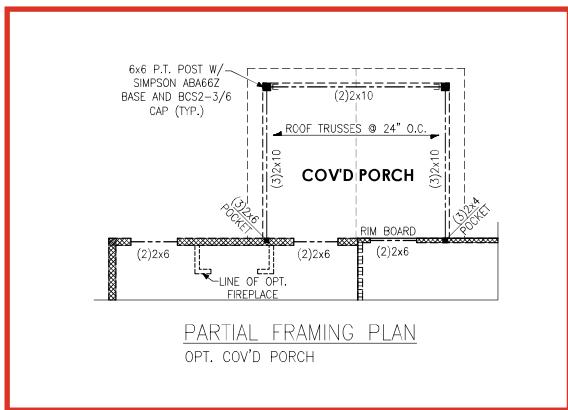


LEGEND	
★	PROVIDE SOLID BLOCKING WITHIN FLOOR SYSTEM TO MATCH POST SIZE ABOVE.
=====	BEARING WALL ABOVE
=====	INTERIOR BEARING WALL
	BRACED WALL PANEL
48" WSP	(SEE KSE STRUCTURAL DETAILS SET FOR BRACED WALL PANEL SHEATHING FASTENING & BLOCKING DETAILS)
NH	NO HEADER REQUIRED
REFER TO KSE STRUCTURAL DETAILS SET FOR GENERAL STRUCTURAL NOTES AND TYPICAL DETAILS	
PLAN DESIGNED WITH 9' WALL PLATES	
FLOOR FRAMING TO BE 14" DEEP TJI 110 SERIES OR EQUAL, SPACING PER MANUFACTURER.	
KEYNOTES:	
⑤ INSTALL TWO PANEL CS-PF PORTAL FRAME PER DETAIL A OR B/SD-4.	

Second Floor Framing Plans
Elevation 'A' & Options
Bellwood Model - RH
Up To 120 M.P.H.
Carolina Division

Project #: 105-23003
Designed By: KRK
Checked By:
Issue Date: 9/17/23
Re-Issue: 7/16/24
Scale: 1/8"=1'-0" @ 11x17
1/4"=1'-0" @ 22x34



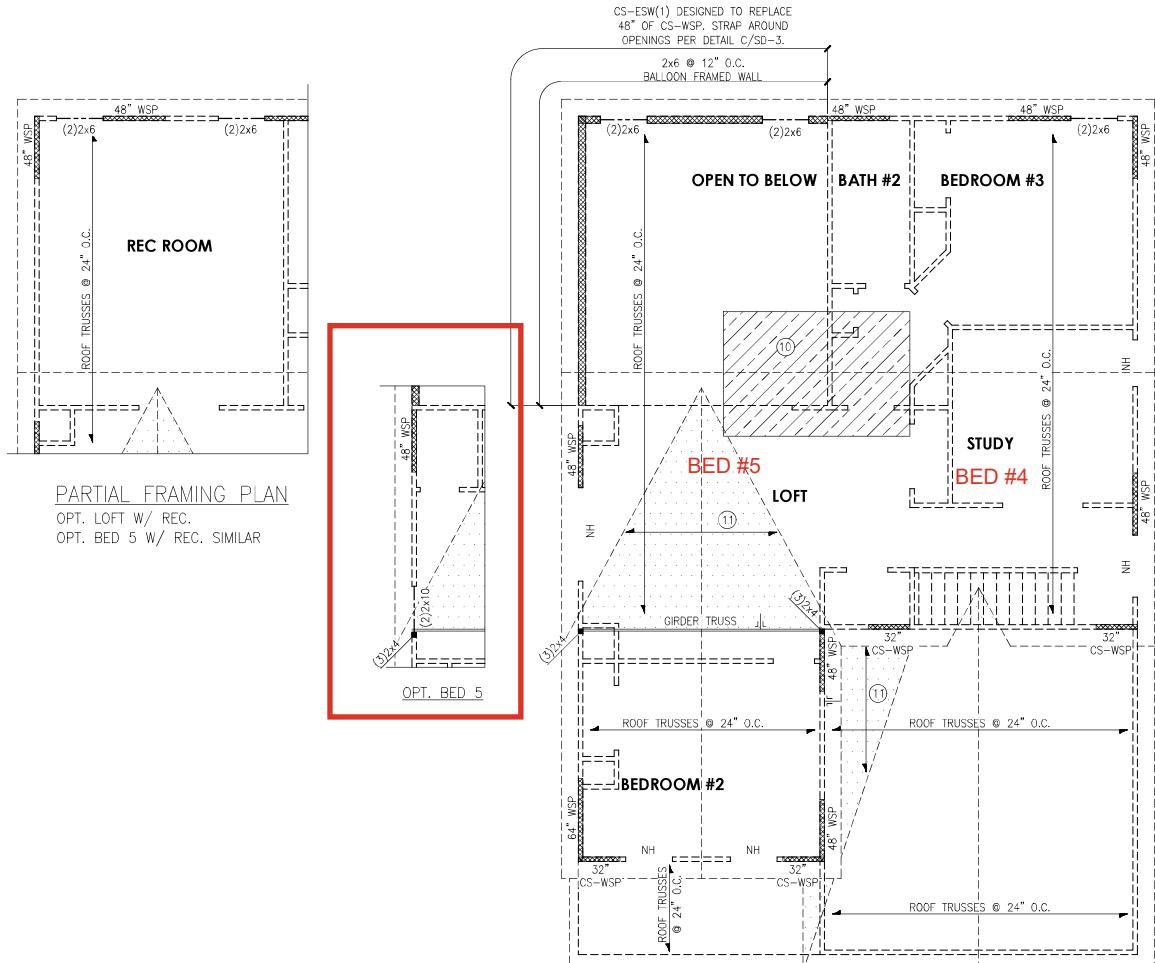

ROOF FRAMING PLAN
ELEVATION 'A'

LEGEND	
★	PROVIDE SOLID BLOCKING WITHIN FLOOR SYSTEM TO MATCH POST SIZE ABOVE.
-----	BEARING WALL ABOVE
	INTERIOR BEARING WALL
	BRACED WALL PANEL (SEE KSE STRUCTURAL DETAILS SET FOR BRACED WALL PANEL SHEATHING FASTENING & BLOCKING DETAILS)
NH	NO HEADER REQUIRED
REFER TO KSE STRUCTURAL DETAILS SET FOR GENERAL STRUCTURAL NOTES AND TYPICAL DETAILS	
PLAN DESIGNED WITH 8" WALL PLATES	
KEYNOTES:	
(10)	8'x16' HVAC PLATFORM TRUSSES DESIGNED TO SUPPORT HVAC UNITS.
(11)	2x6 OVERFRAMING W/ 2x8 RIDGE AND VALLEY PLATES OR VALLEY SET TRUSSES @ 24" C.C. (TYP.)

Roof Framing Plans
Elevation 'A' & Option
Bellwood Model - RH
Up To 120 M.P.H.
Carolina Division


Project #: 105-23003
Designed By: KRK
Checked By:
Issue Date: 9/17/23
Re-Issue: 7/16/24
Scale: 1/8"=1'-0" @ 11x17
1/4"=1'-0" @ 22x34




S-3




DREAM FINDERS HOMES

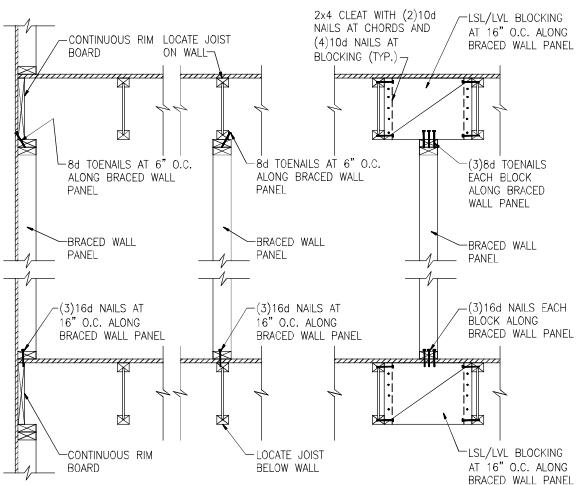


(A) TYPICAL BRACED WALL PANEL TO FLOOR/CEILING CONNECTION
BRACED WALL PANELS PARALLEL TO I-JOISTS

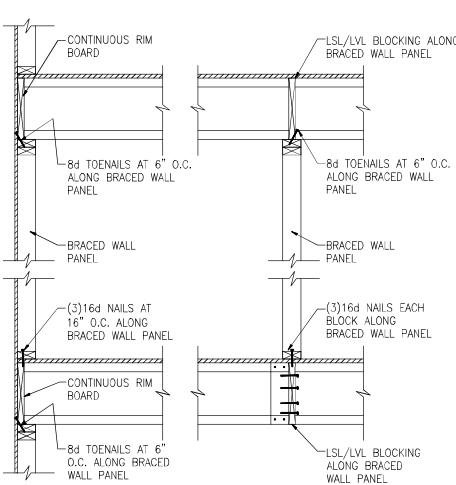


(B) TYPICAL BRACED WALL PANEL TO FLOOR/CEILING CONNECTION
BRACED WALL PANELS PERPENDICULAR TO I-JOISTS

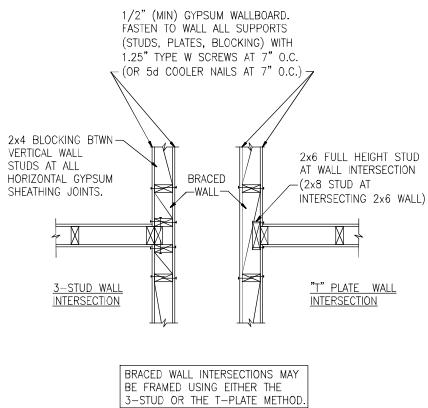

(C) METHOD GB(1) AND GB(2) INTERSECTION DETAILS

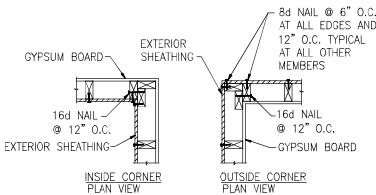

(D) TYPICAL EXTERIOR CORNER WALL FRAMING

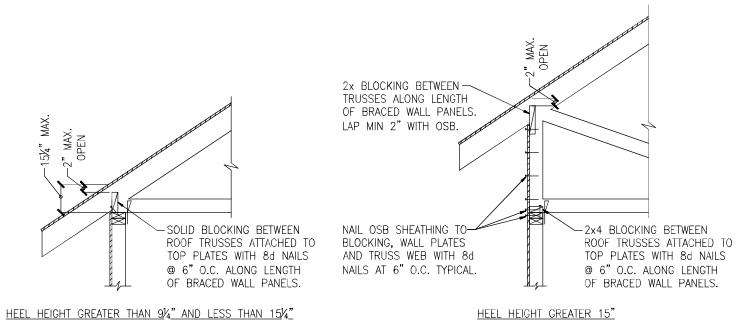

(E) ROOF TRUSS BEARING/BLOCKING AT BRACED WALL PANELS
ONLY REQUIRED AT BRACED WALL PANELS


Braced Wall Details

Up To 120 M.P.H.
North Carolina


Project #: 105-19000
Designed By: KSE
Checked By:
Issue Date: 1/1/19
Re-Issue:




SD-1

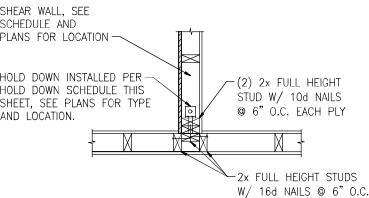


A TYPICAL HOLD DOWN DETAIL

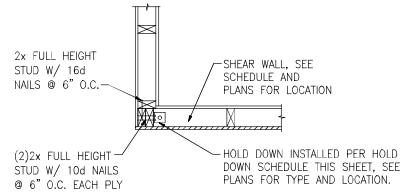


B TYPICAL HOLD DOWN DETAIL

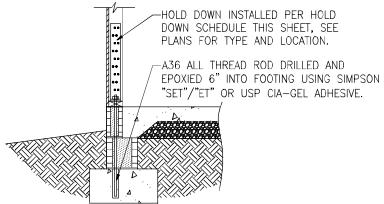


C HOLD DOWN AT STEMWALL SLAB FOUNDATION

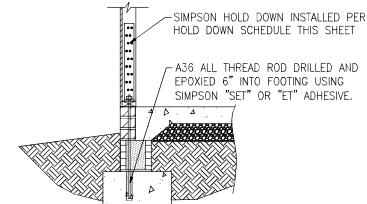


C HOLD DOWN AT STEMWALL SLAB

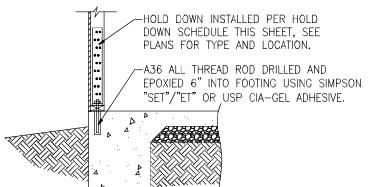


D HOLD DOWN AT MONOLITHIC SLAB FOUNDATION

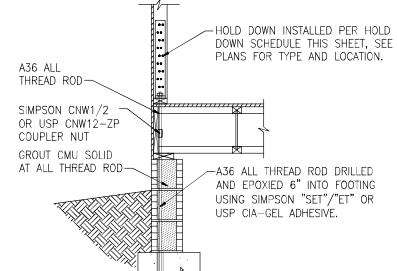

E HOLD DOWN AT CRAWL SPACE FOUNDATION

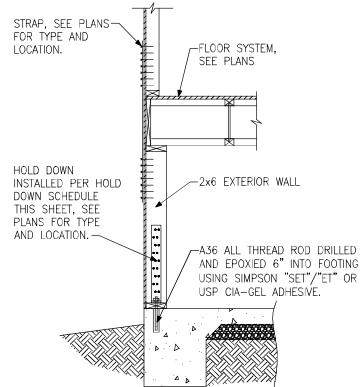

F HOLD DOWN AT BASEMENT FOUNDATION

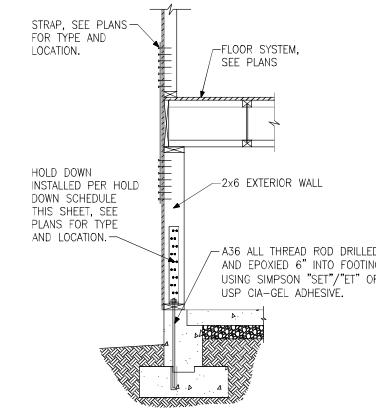

G HOLD DOWN AT BASEMENT FOUNDATION


HOLD DOWN SCHEDULE			
HOLD DOWN	ALL THREAD ROD	FASTENERS	
SIMPSON	USP		
LTP2	N.A.	$\frac{1}{2}$ " DIA.	(12)0.148"x2 $\frac{1}{2}$ " LONG NAILS
HT4	HT16	$\frac{5}{8}$ " DIA.	(18)0.148"x2 $\frac{1}{2}$ " LONG NAILS
HT5	HT45	$\frac{5}{8}$ " DIA.	(26)0.148"x2 $\frac{1}{2}$ " LONG NAILS

Hold Down Details

Up To 120 M.P.H.
North Carolina

Project #: 105-19000
Designed By: KRK
Checked By:
Issue Date: 1/1/19
Re-Issue:
NC Firm #G-2101
SEAL OF THE STATE OF NORTH CAROLINA PROFESSIONAL ENGINEERS AND LAND SURVEYORS AND ARCHITECTS
Andrew A. Morris 1/18/24
Scale: 1/8"=1'-0" @ 11x17 1/4"=1'-0" @ 22x34

SD-2

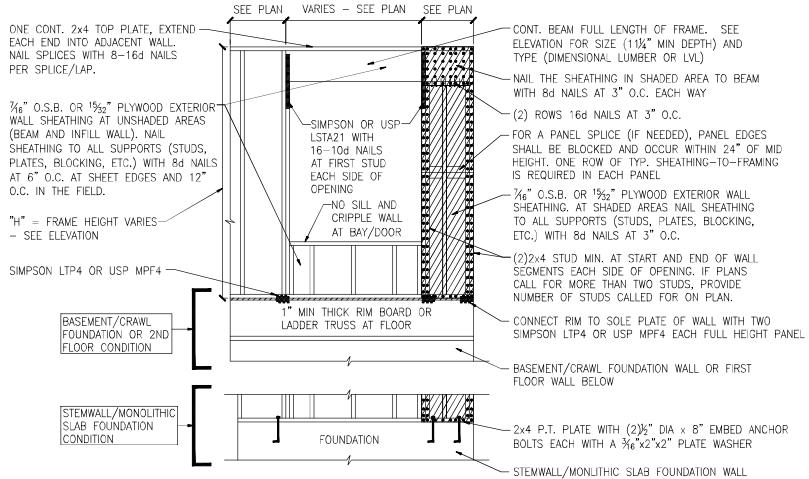


A METHOD CS-PF: CONTINUOUS PORTAL FRAME PANEL CONSTRUCTION

ONE BRACED WALL SEGMENT

BRACED WALL PANEL AND ENGINEERED SHEAR WALL SCHEDULE			
PANEL TYPES	PANEL TYPE	MATERIAL	FASTENERS
WSP	INTERMITTENT WOOD STRUCTURAL PANEL	7/16" OSB	6D OR 8D COMMON NAILS AT 6" O.C. AT SHEET EDGES AND 12" O.C. AT INTERMEDIATE SUPPORTS. ENGINEERED ALTERNATIVE: 16 GAGE BY 1 1/2" LONG STAPLES AT 3" O.C. AT SHEET EDGES AND 6" O.C. AT INTERMEDIATE SUPPORTS
GB(1)	INTERMITTENT GYPSUM BOARD (SHEATHING ON FACE OF WALL)	1/2" GYPSUM	1.5" LONG GALV. ROOFING NAILS, 6d COMMON NAILS, OR 1.25" LONG TYPE W DRYWALL SCREWS AT 7" O.C. AT SHEET EDGES AND INTERMEDIATE SUPPORTS.
GB(1)-4	INTERMITTENT GYPSUM BOARD (SHEATHING ONE FACE OF WALL)	1/2" GYPSUM	1.5" LONG GALV. ROOFING NAILS, 6d COMMON NAILS, OR 1.25" LONG TYPE W DRYWALL SCREWS AT 4" O.C. AT SHEET EDGES AND INTERMEDIATE SUPPORTS.
GB(2)	INTERMITTENT GYPSUM BOARD (SHEATHING BOTH FACES OF WALL)	1/2" GYPSUM	1.5" LONG GALV. ROOFING NAILS, 6d COMMON NAILS, OR 1.25" LONG TYPE W DRYWALL SCREWS AT 7" O.C. AT SHEET EDGES AND INTERMEDIATE SUPPORTS.
CS-WSP	CONTINUOUS SHEATHED WOOD STRUCTURAL PANEL	7/16" OSB	6D OR 8D COMMON NAILS AT 6" O.C. AT SHEET EDGES AND 12" O.C. AT INTERMEDIATE SUPPORTS. ENGINEERED ALTERNATIVE: 16 GAGE BY 1 1/2" LONG STAPLES AT 3" O.C. AT SHEET EDGES AND 6" O.C. AT INTERMEDIATE SUPPORTS
CS-PF	CONTINUOUS SHEATHED PORTAL FRAME	7/16" OSB	NAILING PER DETAIL
PFH	PORTAL FRAME WITH HOLD DOWNS	7/16" OSB	NAILING PER DETAIL
CS-ESW(1)	ENGINEERED SHEAR WALL, TYPE 1	7/16" OSB	8D COMMON NAILS AT 6" O.C. AT SHEET EDGES AND 12" O.C. AT INTERMEDIATE SUPPORTS. CONTINUOUS OSB AROUND DOOR/WINDOW OPENINGS
CS-ESW(2)	ENGINEERED SHEAR WALL, TYPE 2	7/16" OSB	8D COMMON NAILS AT 4" O.C. AT SHEET EDGES AND 12" O.C. AT INTERMEDIATE SUPPORTS. CONTINUOUS OSB AROUND DOOR/WINDOW OPENINGS
CS-ESW(3)	ENGINEERED SHEAR WALL, TYPE 3	7/16" OSB	8D COMMON NAILS AT 3" O.C. AT SHEET EDGES AND 12" O.C. AT INTERMEDIATE SUPPORTS. CONTINUOUS OSB AROUND DOOR/WINDOW OPENINGS


BRACED WALL PANEL NOTES:

1. ALL BRACED WALL PANELS, EXCEPT GB(1) & GB(2), SHALL HAVE 2x BLOCKING BETWEEN WALL STUDS AT ALL HORIZONTAL SHEET EDGES.
2. PROVIDE NAILING/BLOCKING ABOVE AND BELOW ALL BRACED WALL PANELS PER KSE BRACED WALL DETAILS.
3. SHEATH ALL EXTERIOR WALLS OF THE HOUSE WITH 1/2" O.S.B. OR 15/32" PLYWOOD, FASTENED PER IRC. AT EXTERIOR CORNERS, SHEATHING SHALL BE FASTENED PER KSE BRACED WALL DETAILS. AT INTERIOR WALL INTERSECTIONS, FASTEN STUDS & WALL BRACING PER KSE BRACED WALL DETAILS.
4. BRACED WALL PANELS AND ENGINEERED SHEAR WALLS ARE PROVIDED PER IRC. PANEL LENGTHS SHOWN ON PLANS ARE THE MINIMUM LENGTH REQUIRED.

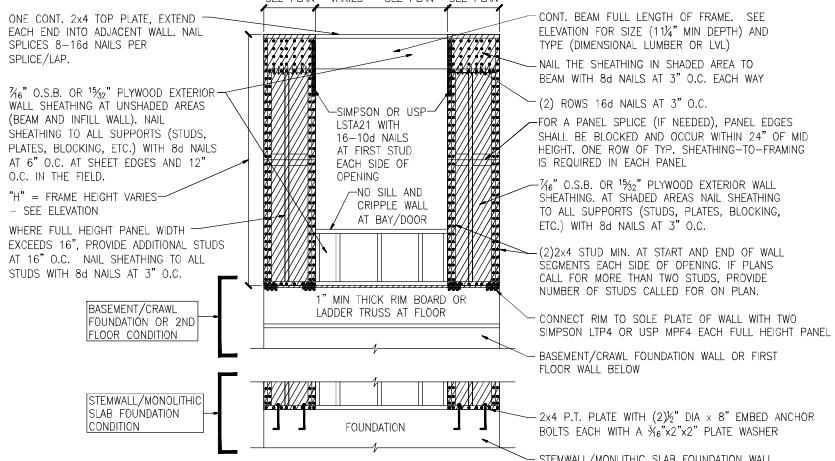

B METHOD CS-PF: CONTINUOUS PORTAL FRAME PANEL CONSTRUCTION

TWO BRACED WALL SEGMENTS

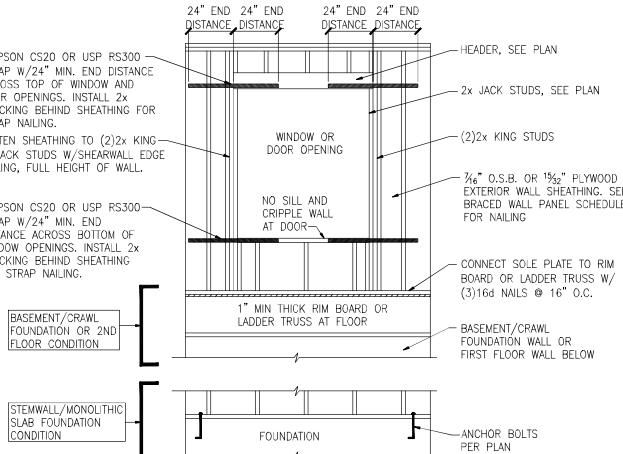

C WINDOW OR DOOR REINFORCEMENT IN ENGINEERED SHEAR WALL

ONLY REQUIRED WHERE SPECIFIED ON PLANS




DREAM FINDERS HOMES




Portal Frame Details

Up To 120 M.P.H.
North Carolina

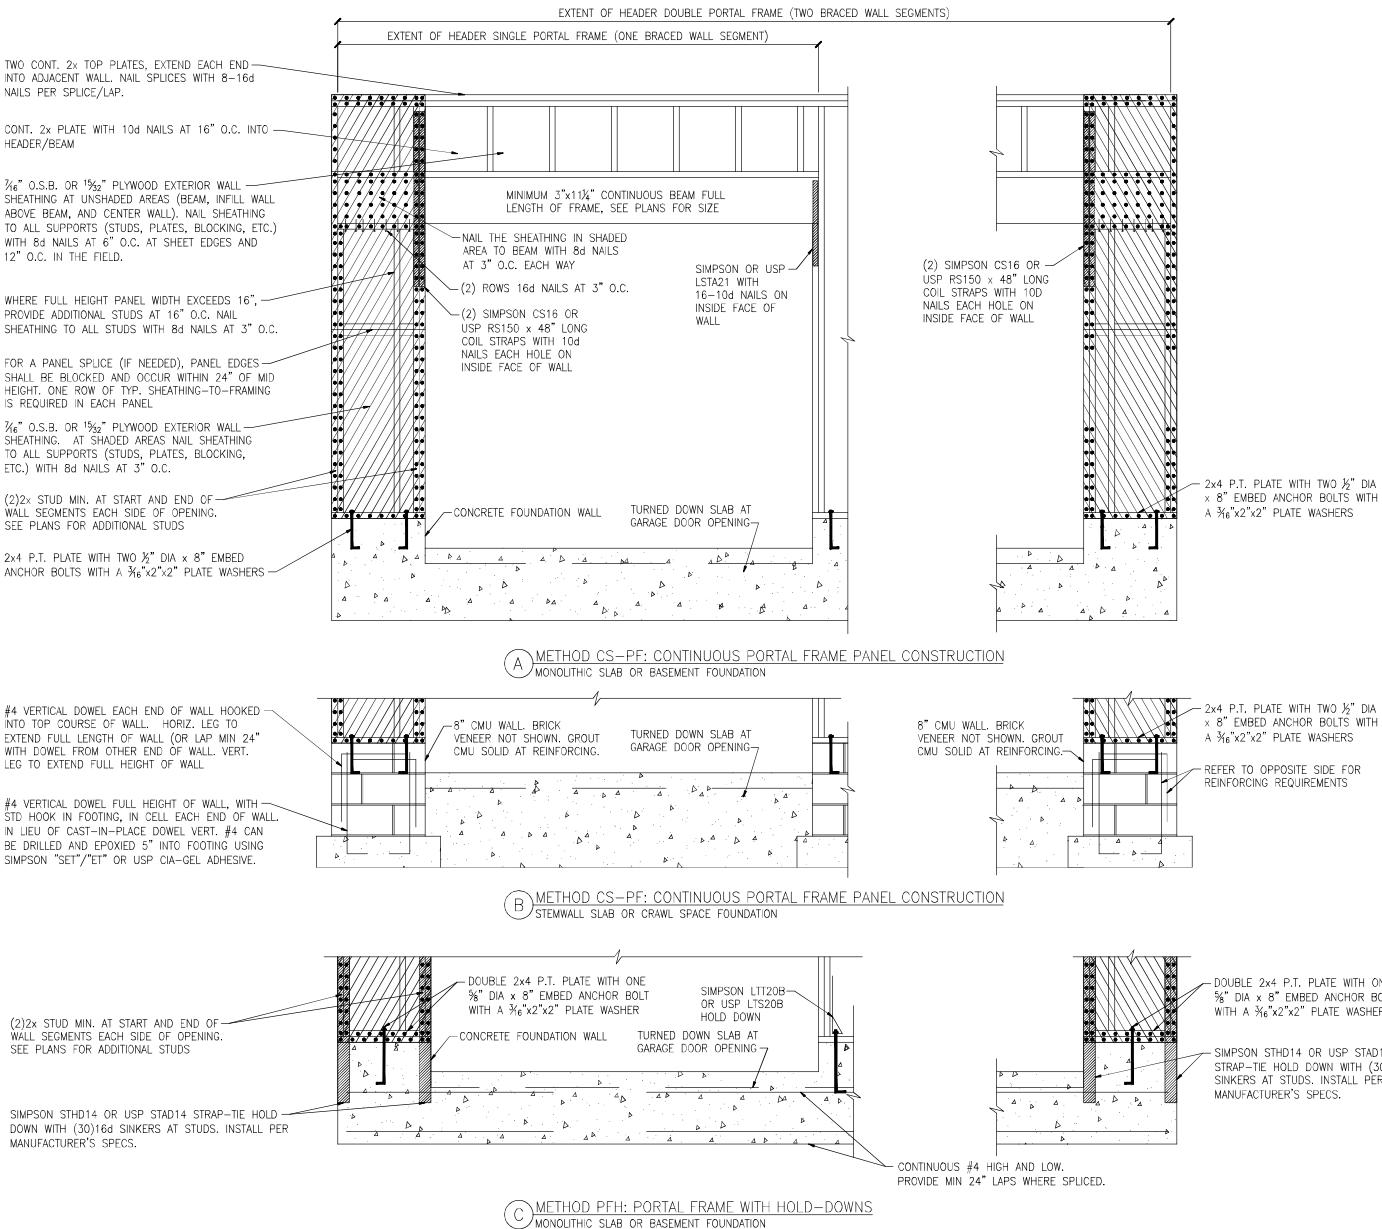


SD-4

Project #: 105-19000
Designed By: KRK
Checked By:
Issue Date: 1/1/19
Re-Issue:
Scale: 1/8"=1'-0" @ 1/4"=1'-0" @ 22x34

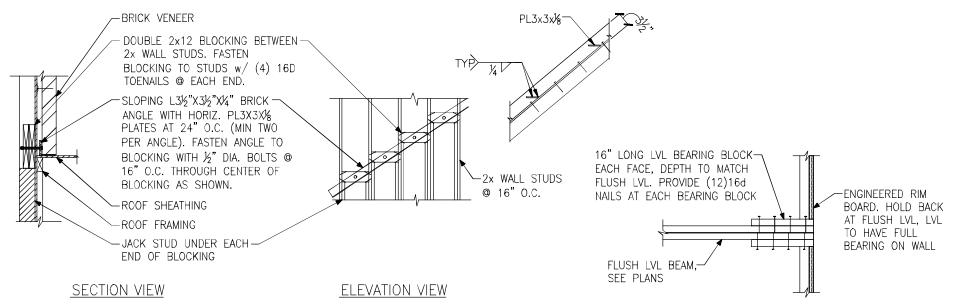


(A) BRICK LEDGER CONNECTION DETAIL


(B) BEARING ENHANCER
FLUSH LVL

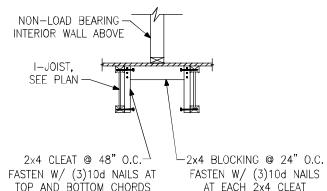

(C) I-JOIST LADDER BLOCKING
AS REQUIRED @ PARALLEL WALLS

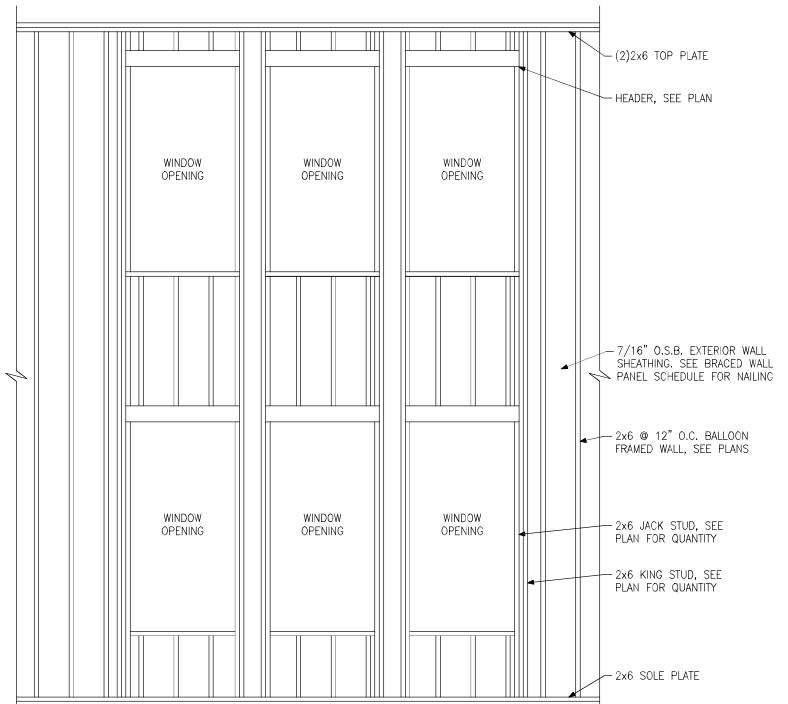

(D) BALLOON FRAMED WALL DETAIL
N.T.S.

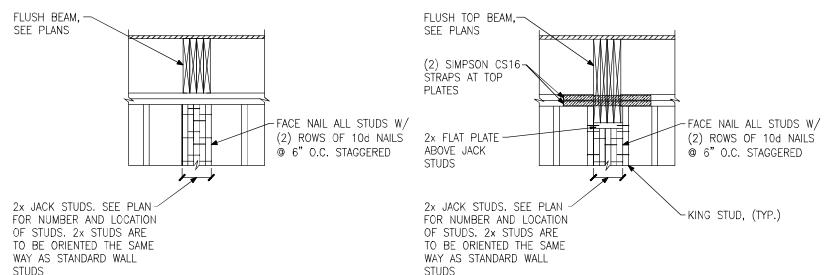

(E) BUILT-UP STUD DETAIL SUPPORTING BEAM

Miscellaneous Framing Details

Up To 120 M.P.H.
North Carolina





ENGINEERING

DREAM FINDERS HOMES






Miscellaneous Framing Details

Up To 120 M.P.H.
North Carolina

Project #: 105-19000
Designed By: KRK
Checked By:
Issue Date: 1/1/19
Re-Issue:

Scale: 1/8"=1'-0" @ 11x17
1/4"=1'-0" @ 22x34
7/18/24


SD-6

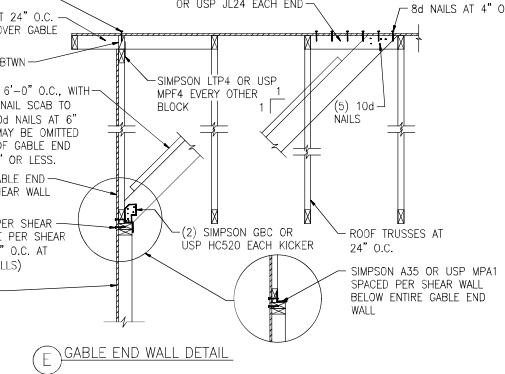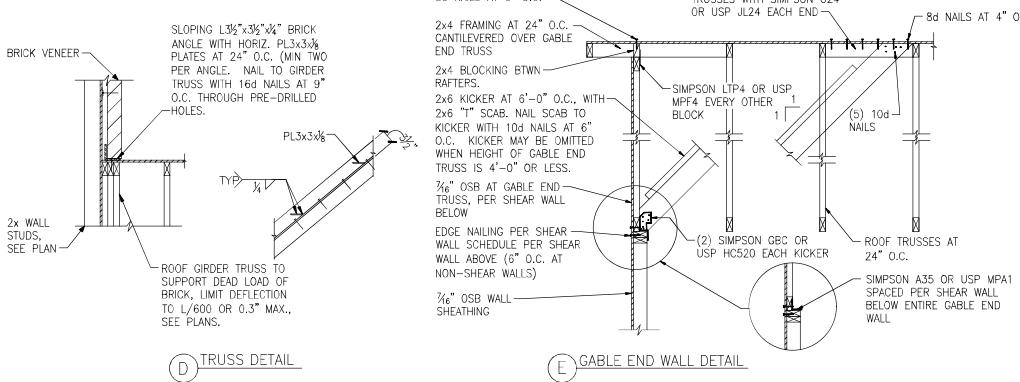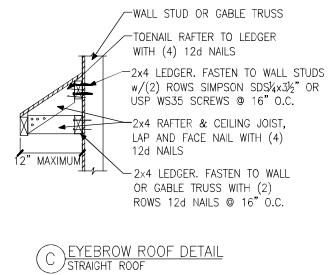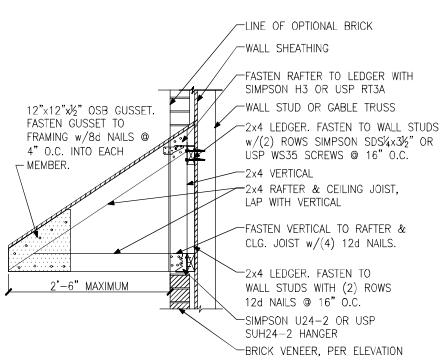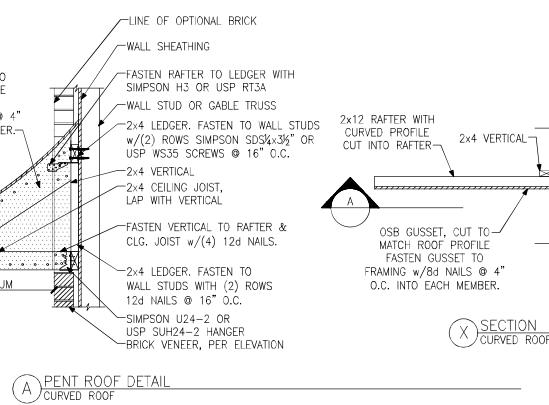




Monolithic Slab Foundation Details


Up To 120 M.P.H.
North Carolina

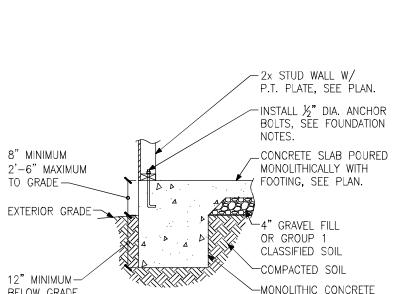


A FOUNDATION SECTION
EXTERIOR WALL

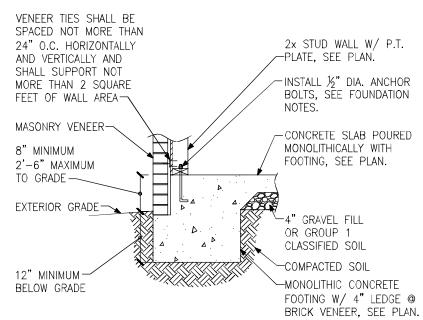


B FOUNDATION SECTION
EXTERIOR WALL @ MASONRY
VENEER

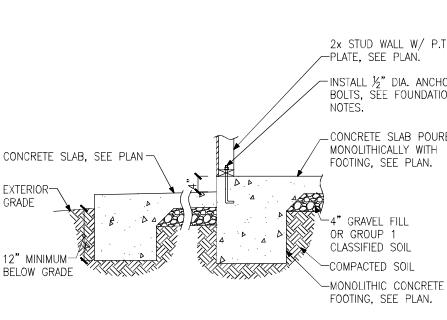


C FOUNDATION SECTION
EXTERIOR WALL AT PORCH

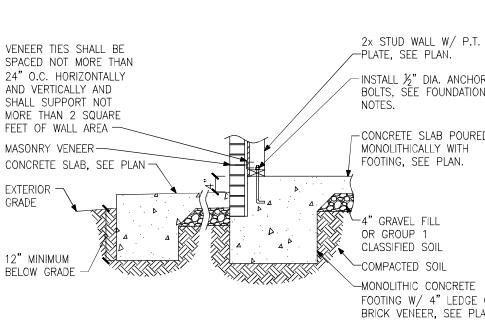


D FOUNDATION SECTION
EXTERIOR WALL AT PORCH W/ MASONRY
VENEER

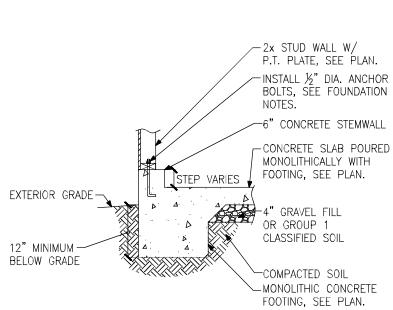


E FOUNDATION SECTION
EXTERIOR GARAGE WALL

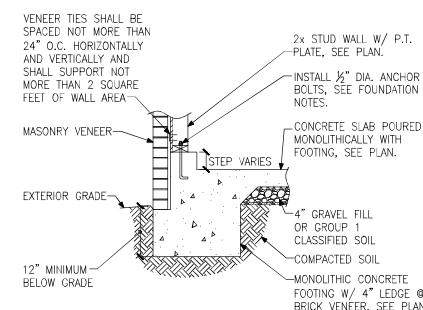


F FOUNDATION SECTION
EXTERIOR GARAGE WALL @ MASONRY
VENEER

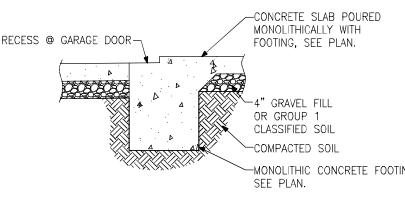


G FOUNDATION SECTION
GARAGE DOOR

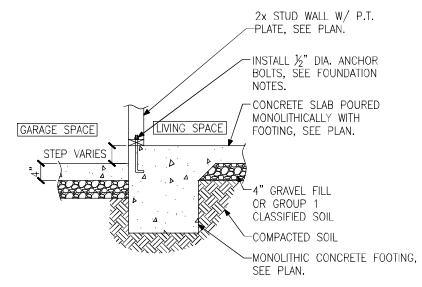


H FOUNDATION SECTION
INTERIOR GARAGE WALL

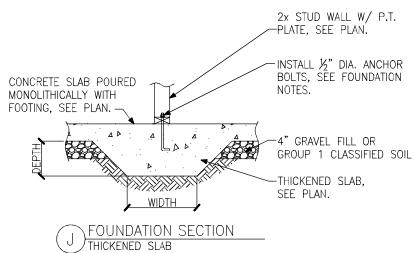

J FOUNDATION SECTION
THICKENED SLAB

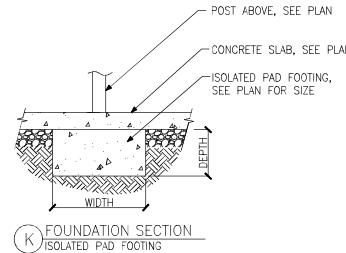

K FOUNDATION SECTION
ISOLATED PAD FOOTING

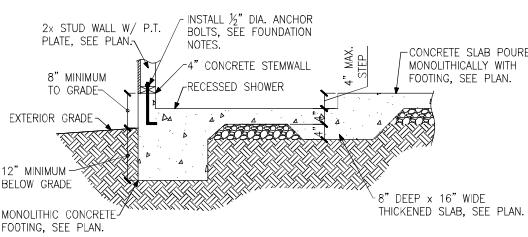

L FOUNDATION SECTION
THICKENED SLAB @ RECESSED SHOWER

Project #: 105-1900
Designed By: KRK
Checked By:
Issue Date: 1/1/19
Re-Issue:
Scale: 1/8"=1'-0" @ 11x17 1/4"=1'-0" @ 22x34




SD-7




Stem Wall Slab Foundation Details


Up To 120 M.P.H.
North Carolina

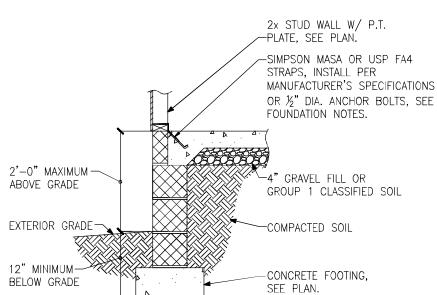


A FOUNDATION SECTION
EXTERIOR WALL

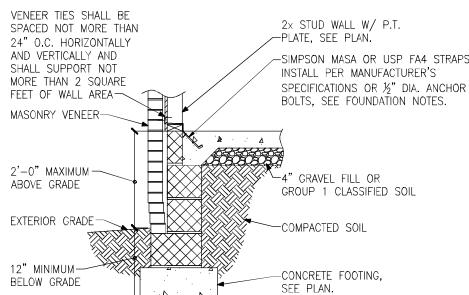


B FOUNDATION SECTION
EXTERIOR WALL @ MASONRY VENEER

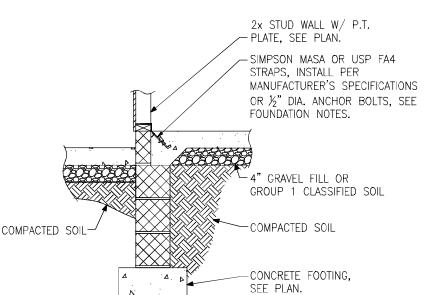


C FOUNDATION SECTION
EXTERIOR WALL AT PORCH

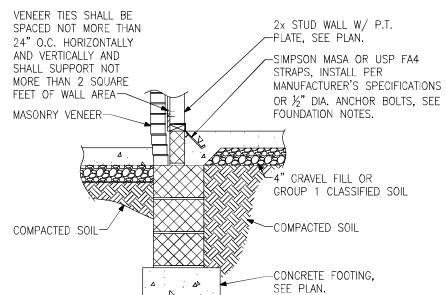


D FOUNDATION SECTION
EXTERIOR WALL AT PORCH W/ MASONRY VENEER

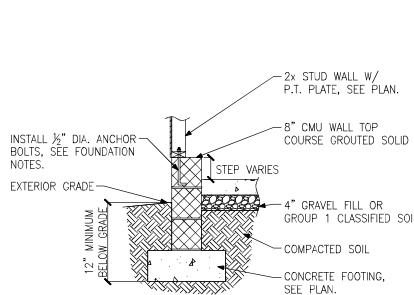


E FOUNDATION SECTION
EXTERIOR GARAGE WALL

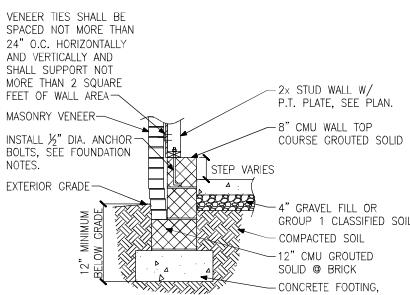


F FOUNDATION SECTION
EXTERIOR GARAGE WALL @ MASONRY VENEER

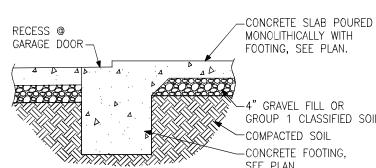


G FOUNDATION SECTION
GARAGE DOOR

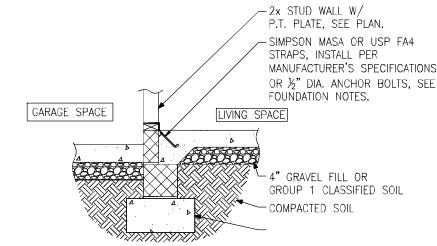


H FOUNDATION SECTION
INTERIOR GARAGE WALL

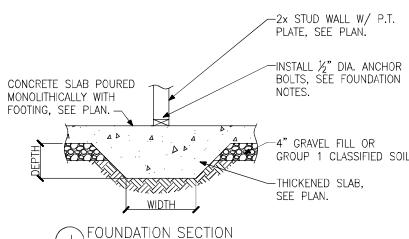

J FOUNDATION SECTION
THICKENED SLAB










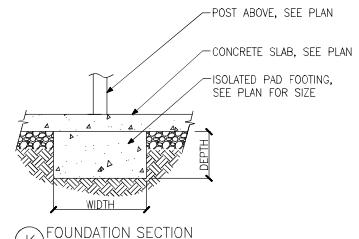


K FOUNDATION SECTION
ISOLATED PAD FOOTING

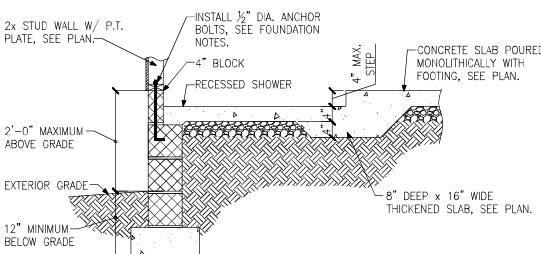

L FOUNDATION SECTION
THICKENED SLAB @ RECESSED SHOWER



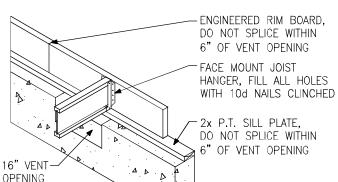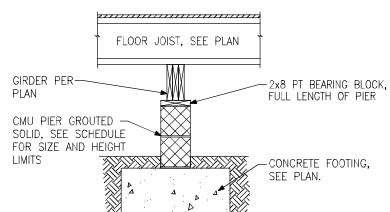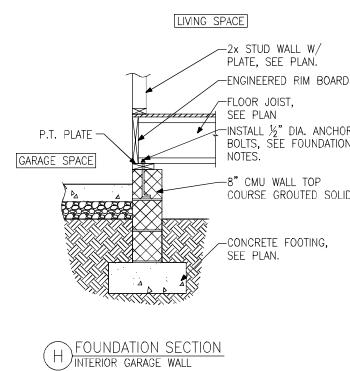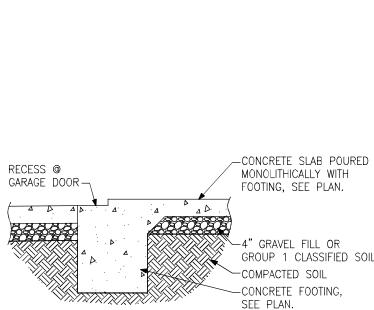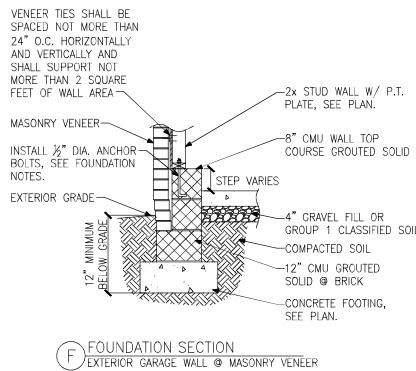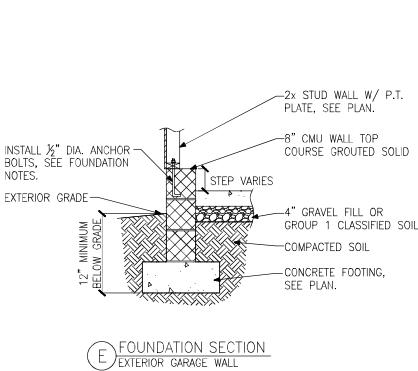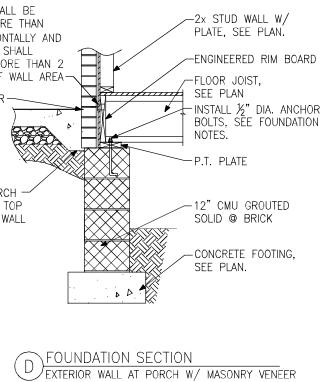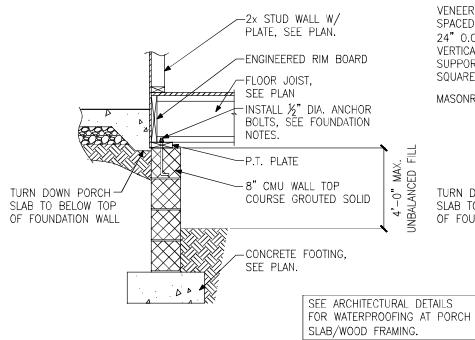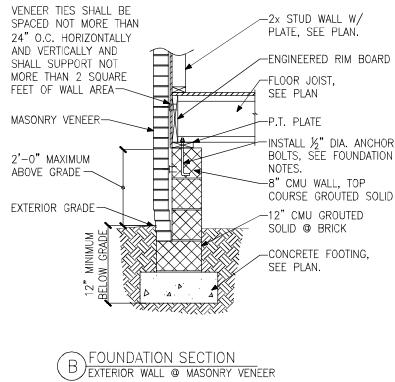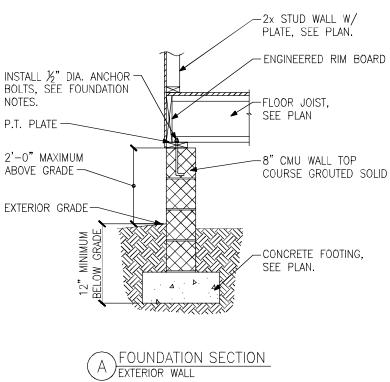

PIER HEIGHT	PIER SIZE	MIN. FOOTING SIZE
UP TO 2'-8"	8" x 16"	24" x 24" x 12" U.N.O.
UP TO 5'-4"	16" x 16"	24" x 24" x 12" U.N.O.
UP TO 8'-0"	16" x 16"	30" x 30" x 12" U.N.O.

NOTE:
PIERS SHALL BE CAPPED WITH 8" OF SOLID MASONRY OR CONCRETE OR TOP COURSE FILLED SOLID WITH CONCRETE/MORTAR.
PIERS OVER 5'-4" SHALL BE FILLED SOLIDLY WITH CONCRETE OR TYPE M OR S MORTAR.
FOR PIERS OVER 8'-0" CONTACT KSE ENGINEERING FOR PIER AND FOOTING DESIGN.

Crawl Space Foundation Details
Up To 120 M.P.H.
North Carolina

Project #: 105-19000
Designed By: KSE
Checked By:
Issue Date: 1/1/19
Re-Issue:
Scale: 1/8"=1'-0" @ 11x17
1/4"=1'-0" @ 22x34
NC Firm #G-2101
1/18/24

