

# KENT

## KENT REVISION LIST - STRUCTURAL:

13

## KENT REVISION LIST - ARCHITECTURAL:

1.

CHANGE FIREPLACE FROM 36" TO 32". (11-21-19)
2.

ADDED ROOM DIMENSIONS. (11-21-19)
3.

CHANGE ROOM NAMES FROM MASTERS TO OWNERS. (11-21-19)
4.

VERIFIED AND UPDATED SQUARE FOOTAGE ON FIRST AND SECOND FLOOR. (11-21-19)
5.

ADDED ROOF VENTING CALCULATIONS FOR ELEV A, B, AND C. (11-29-19)
6.

ADDED GOURMET KITCHEN LAYOUT OPTION. (12-23-19)
7.

CHANGE FIREPLACE FROM STANDARD TO OPTIONAL. (12-23-19)
8.

REMOVE GLASS INSERTS AT GARAGE DOORS. (12-23-19)
9.

REMOVE METAL ACCESSORIES AT GARAGE DOORS. (12-23-19)
10.

UPDATED CUTSHEETS PER H&H STANDARDS. (1-16-20)
11.

CHANGE FIREPLACE FROM STANDARD TO OPTIONAL. (1-16-20)
12.

CALLED OUT REFRIGERATOR, WASHER, AND DRYER ARE OPTIONAL COMPONENTS. (1-16-20)
13.

VERIFIED COACH LIGHT LOCATIONS ON ALL ELEVATIONS (03-30-20)
14.

REMOVED GRIDS FROM WINDOWS AND DOORS ON ALL SIDE AND REAR ELEVATIONS (03-30-20)
15.

REMOVED ROOF HATCH FROM ALL ELEVATIONS (03-30-20)
16.

CHANGED NOTE FOR ALL GARAGES ON ELEVATIONS TO UPDATED NOTE (03-30-20)
17.

UPDATED HATCHES ON ALL ELEVATIONS TO REPRESENT STONE BETTER (03-30-20)
18.

ADDED ELEVATIONS TO SHOW STONE AND BRICK OPTIONS ON A2, A3, B2, B3, C2, & C3 (03-30-20)
19.

ADDED COLUMN DETAIL FOR B ELEVATIONS (03-30-20)
20.

FIXED WINDOW TRIM AND BRICK ROWLOCK ON B3 & B4 (03-30-20)
21.

VERIFIED AND UPDATED SQUARE FOOTAGE WITH & WITHOUT BRICK (03-30-20)
22.

ADDED DIAGONAL DIMENSIONS TO SLAB INTERFACE PLAN (03-30-20)
23.

ADDED OWNER'S BATH 2 & 3 IN OPTIONS SHEET (03-30-20)
24.

REPLACED OWNER'S BATH WITH OWNER'S BATH 1 ON BASE PLAN (03-30-20)
25.

CHANGED ALL WALLS FROM 2x6 TO 2x4 EXCEPT WHERE SHADED (03-30-20)
26.

CHANGED ROOM NAME 'NOOK' TO 'DINING ROOM' (03-30-20)
27.

ADDED HOSE BIB LOCATIONS TO OPPOSITE SIDES OF THE HOUSE ON FRONT AND REAR (03-30-20)
28.

CHANGED STANDARD PATIO TO 12x10' (03-30-20)
29.

NOTED 'TEMP.' WINDOWS IN OWNER'S BATH (03-30-20)
30.

MOVED ALL OPTIONS TO SEPARATE SHEET (03-30-20)
31.

SHOWED DORMER WINDOWS ON SECOND FLOOR (03-30-20)
32.

ADDED NOTE FOR ATTIC ACCESS DOOR ON SECOND FLOOR (03-30-20)
33.

NOTED 'TEMP.' WINDOWS IN BEDROOM 2 AND BEDROOM 4 (03-30-20)
34.

CHANGED STANDARD LIGHT IN KITCHEN TO FLUORESCENT LIGHT (03-30-20)
35.

NOTED PENDANT LIGHTS AS OPTIONAL (03-30-20)
36.

ADDED OPTIONAL FLOOR OUTLETS IN FAMILY ROOM (03-30-20)
37.

REMOVED ALL OUTLETS EXCEPT OPTIONAL FLOOR OUTLET (03-30-20)
38.

VERIFIED ALL COACH LIGHT LOCATIONS (03-30-20)
39.

NOTED ALL FANS AS 'STD LIGHT, OPT FAN/LT PREWIRE' IN ALL BEDROOMS (03-30-20)
40.

UPDATED ELECTRICAL LEGEND (03-30-20)
41.

NOTED FLOOD LIGHTS AS OPTIONAL (03-30-20)
42.

UPDATED OWNER'S BATHROOM WINDOWS TO REAR ELEVATIONS (08-29-22)
43.

OPTIONAL BRICK/STONE WATERTABLE ADDED TO SIDE & REAR ELEVATIONS (05-01-23)
- CHANGES ON 09-23-24
1.

WINDOW CHANGED IN OPTIONAL OWNER'S BATH FROM 20x40 TO 4010
2.

OWNER'S BEDROOM CHANGED TO PRIMARY BEDROOM. OWNER'S BATH CHANGED TO PRIMARY BATH



COVER SHEET













DREAM FINDERS HOMES  
KENT

DATE: MARCH 27, 2019  
REV: SEPTEMBER 23, 2024  
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ENGINEERED BY:  
REVIEWED BY:



CS



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DREAM FINDERS HOMES  
KENT

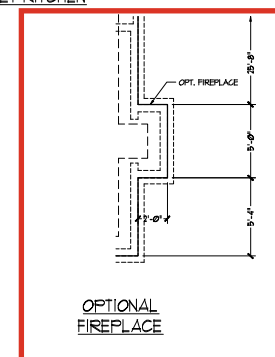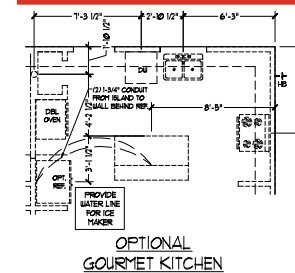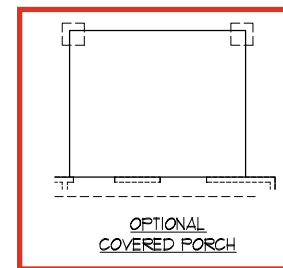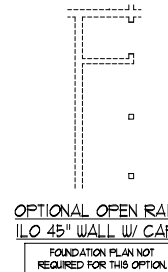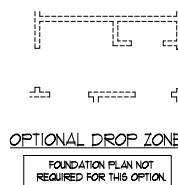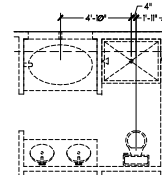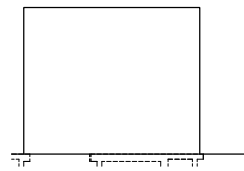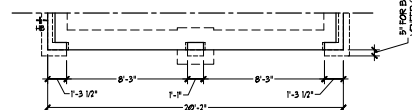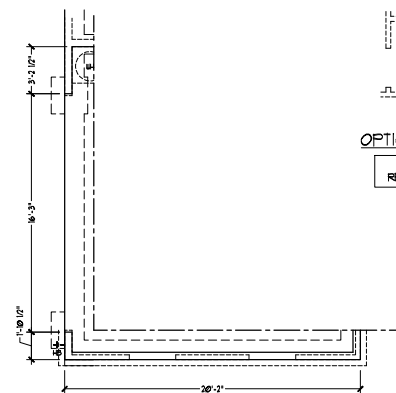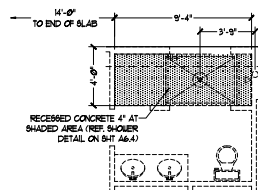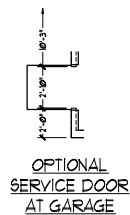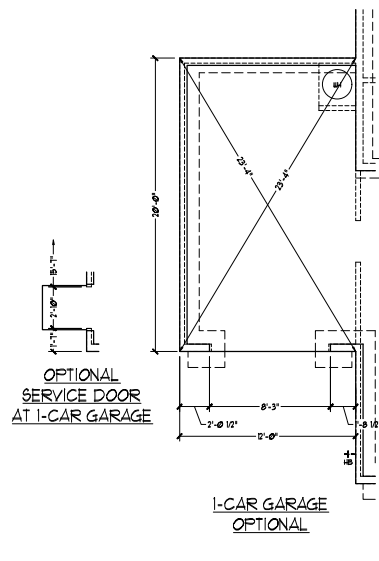DATE: MARCH 27, 2019  
REV.: JUNE 01, 2020  
SCALE: 1/4"=1'-0"  
DRAWN BY: W/G  
ENGINEERED BY:  
REVIEWED BY:  
SLAB INTERFACE  
PLAN - PARTIAL  
PLAN ELEV. A

A-5.2

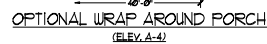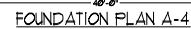

2x6 WALL

• SHADED WALLS ARE TO BE 2 x 6 x 16" O.C. (LOAD BEARING) OR 2 x 6 x 24" O.C. (NON-LOAD BEARING) REGARDLESS OF EXTERIOR WALL CONDITION.

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DRAWN BY: WCG  
ENGINEERED BY:  
REVIEWED BY:

FIRST FLOOR  
PLAN

A-6






(W/ BRICK)



(W/ STONE)

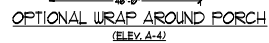

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ENGINEERED BY:  
REVIEWED BY:





FIRST FLOOR  
PLAN - ELEV A  
PARTIAL PLANS

A-6.2





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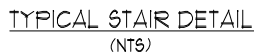

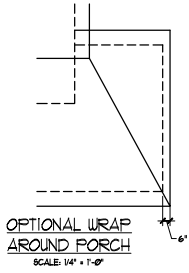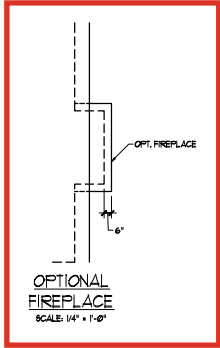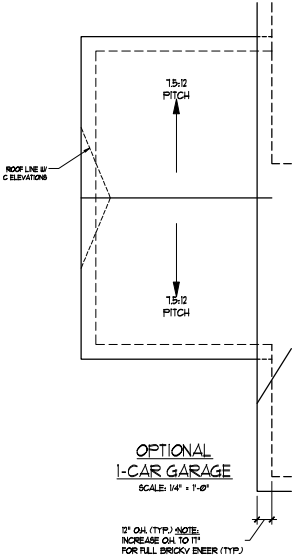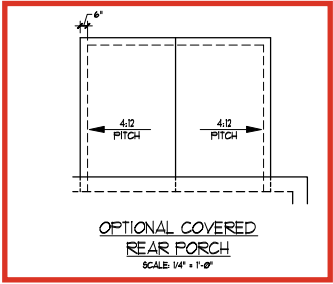
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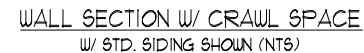
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DRAWN BY: W/G  
ENGINEERED BY:  
REVIEWED BY:

### ROOF PLAN OPTIONS A-8.3



WALL SECTION W/ SLAB  
W/ STD. SIDING SHOWN (NTS)




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SCALE: 1/4"=1'-0"  
DRAWN BY: WG  
ENGINEERED BY:  
REVIEWED BY:  
WALL SECTIONS  
AND STAIR  
DETAIL

AD-1





COV PORCH

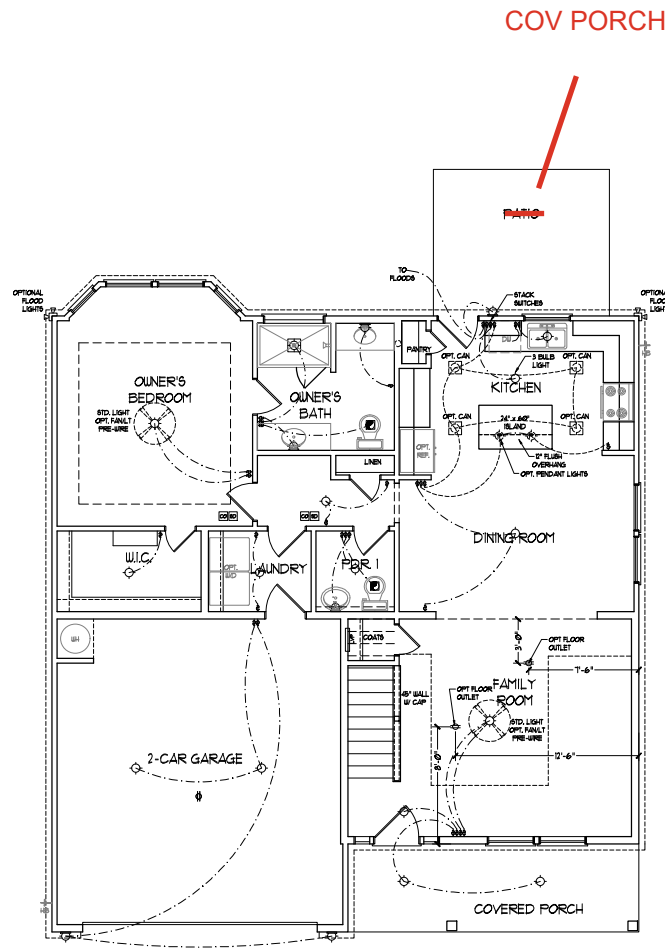FIRST FLOOR PLAN  
(A-1, B-1 AND C-1)

- ELECTRICAL LAYOUT NOTES:**
- 1) BLOCK AND WIRE FOR ALL CEILING FANS PER PLAN
  - 2) VANITY LIGHTS TO BE SET 4" HGT. (TYP.)
  - 3) ADDITIONAL EXTERIOR OUTLETS REQUIRED BY CODE TO BE LOCATED BY ELECTRICIAN
  - 4) PLACE SWITCHES IF 1" MIN FROM ROUGH OPENING



ELECTRICAL LEGEND	
	10 V OUTLET
	WALL MOUNT LIGHT
	CEILING MOUNT LIGHT
	PENDANT LIGHT
	RECESSED CAN LIGHT
	MINI CAN LIGHT
	EYEBALL LIGHT
	FLUORESCENT LIGHT
	2 LAMP, 4' FLUORESCENT LIGHT
	FLOOD LIGHT
	SWITCH
	3-WAY SWITCH
	4-WAY SWITCH
	DIFFER SWITCH
	CONDUIT FOR COMPONENT WIRING
	SPEAKER
	DOORBELL CHIME
	NO V SMOKE DETECTION
	CO DETECTOR
	EXHAUST FAN
	LOW VOLTAGE PANEL
	CEILING FAN
	CEILING FAN w/ LIGHT

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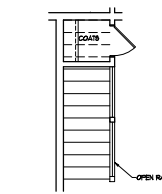
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KENT

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REV: JUNE 01, 2020  
SCALE: 1/4" = 1'-0"  
DRAWN BY: WGO  
ENGINEERED BY:  
REVIEWED BY:  
FIRST FLOOR ELECTRICAL PLAN




OPTIONAL DROP ZONE

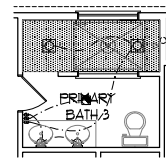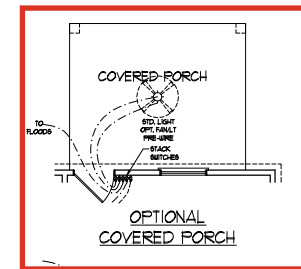
OPTIONAL DROP ZONE




OPTIONAL OPEN  
RAIL ILO 45" WALL  
W/ CAP

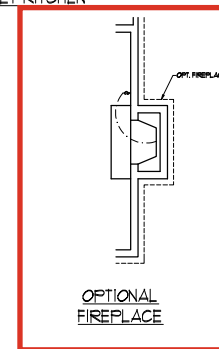


OPTIONAL  
FIREPLACE

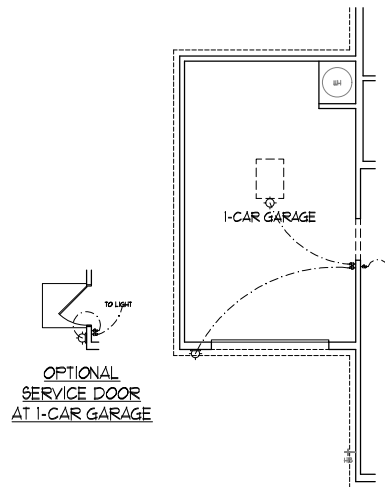


OPTIONAL  
SERVICE DOOR  
AT 1-CAR GARAGE

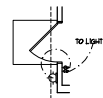


OPTIONAL  
SERVICE DOOR  
AT GARAGE

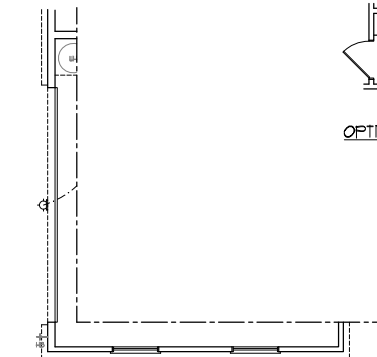


SIDE-LOAD  
GARAGE OPTION  
(NOT AVAILABLE WITH  
OPTIONAL ONE-CAR GARAGE)

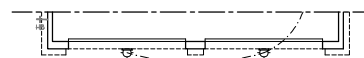


DOUBLE GARAGE  
DOOR OPTION  
(ONLY AVAILABLE WITH  
FRONT LOAD GARAGE)

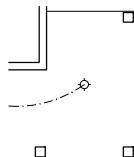

OPTIONAL WRAP AROUND PORCH  
(ELEV. A-1)

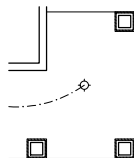

OPTIONAL WRAP AROUND PORCH  
(ELEV. B-1)

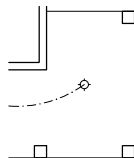

OPTIONAL WRAP AROUND PORCH  
(ELEV. C-1)





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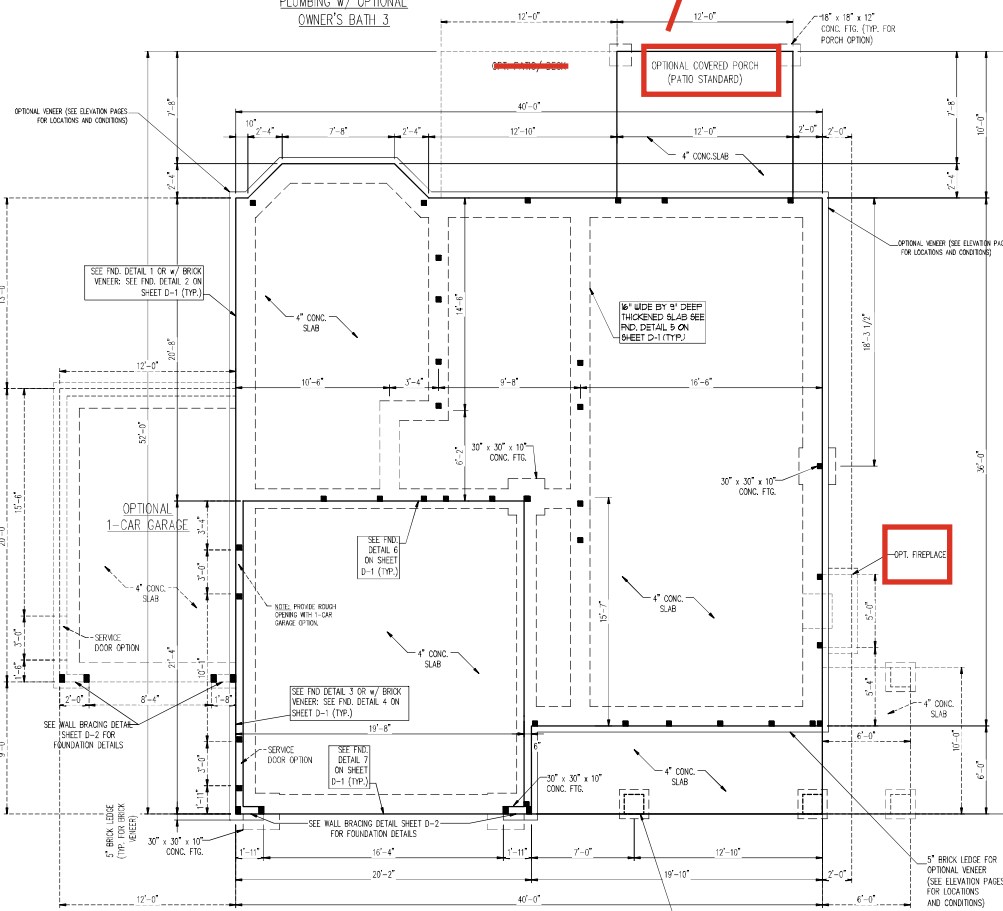
DATE: MARCH 27, 2019  
REV.: JUNE 01, 2020  
SCALE: 1/4"=1'-0"  
DRAWN BY: W/G  
ENGINEERED BY:  
REVIEWED BY:  
FIRST FLOOR  
ELECTRICAL  
PLAN - PARTIAL  
PLANS  
E-1.2






COV PORCH

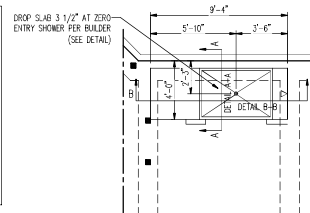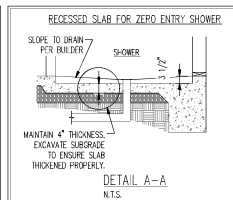
PLUMBING w/ OPTIONAL  
OWNER'S BATH 3



**SIDE-LOAD  
GARAGE OPTION**  
(NOT AVAILABLE WITH  
OPTIONAL ONE-CAR GARAGE)

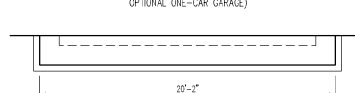

DOUBLE GARAGE  
DOOR OPTION

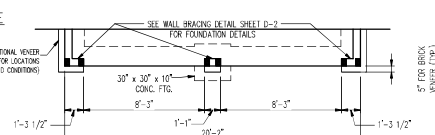[illegible]

- 100 MPH 1-LATE DESIGN WIND AND SPEED
- NOTES FOR LESS THAN  
30' MEAN ROOF HEIGHT:
1. ENGINEER'S SEAL APPLIES ONLY TO  
STRUCTURAL COMPONENTS. ENGINEER'S SEAL  
NOT REQUIRED FOR OTHERS. SEE SECTION 05100  
FOR ACCURACY OR ARCHITECTURAL LAYOUT  
INCLUDING ROOF SYSTEM.
2. ROOF DESIGN FOR 100 MPH WIND NORTH CAROLINA  
RESIDENTIAL CODE, 1998 EDITION.
3. ROOF DESIGN FOR 100 MPH WIND, 100' O.C. AND  
WINDUPT 10' HIGHER OF EACH CORNER.
4. ANCHOR BOLTS MUST EXTEND A MINIMUM OF  
12" BELOW THE ROOF OR CORNER TO THE  
BOTTOM WIND UPRIGHT. MIN. OF PLATE THICK-  
NESS 1/4" WITH 4" MIN. SPACING.
5. EXTERIOR WALLS DESIGNED FOR 100 MPH WIND.
6. ROOF CLADDING DESIGNED FOR -45 PSF AND  
-30 PSF (4" - 16" NICHARGE INSULATION  
MEASURE 1/2").
7. ROOF CLADDING DESIGNED FOR 14.2 PSF AND  
-8 PSF FOR ROOF PITCHES 10:12 OR  
FLATTER. 10:12 - 34 PSF. 12:12 - 40 PSF.  
PITCHES 23:10 TO 12:1.
8. ALL ROOFING SHALL BE BASED ON THE  
EXTENDED WALLS OF ALL STORES IN  
AGREEMENT WITH SECTION DETAILS SHEET  
FOR ROOFING SYSTEM.
9. PROVIDE NOTES AND DETAILS SHEET FOR  
ROOFING SYSTEM.
10. ENERGY EFFICIENCY COMPLIANCE AND  
INSULATION VALUATION OF THE BUILDING TO BE  
IN ACCORDANCE WITH CODES OF THE  
NORTH CAROLINA, 1998 EDITION.
11. PROVIDE NOTES AND DETAILS SHEETS FOR  
ADDITIONAL STRUCTURAL INFORMATION.

LEGEND	
CONT	CONTINUOUS
XJ	EXTRA JOIST
DJ	DOUBLE JOIST
TJ	TRIPLE JOIST
EA	EACH
FDN	FOUNDATION
FTG	FOOTING
OC	ON CENTER
SPF	SPRUCE PINE FIR
SPY	SOUTHERN YELLOW PINE
TRTD	PRESSURE TREATED
TYP	TYPICAL
UNO	UNLESS NOTED OTHERWISE

KENT  
DREAM FINDERS HOMES

DATE: OCTOBER 4, 2024

SCALE: 1/4" = 1'-0"

DRAWN BY: RENAISSANCE  
RESIDENTIAL DESIGN

ENGINEERED BY: WTB

S-1.2  
MONO SLAB  
FOUNDATION PLAN





PORCH

1. BRACED WALL DESIGN PER SECTION 9002.02.10 "WALL BRACING"  
ENGINEERED DESIGN OF THE NCRB 2018 EDITION USING BRACING  
MATERIALS AND METHODS LISTED IN TABLE 9002.02.10 ALONG WITH  
THE ASSUMPTIONS, BRACING AND BRACE CONNECTIONS WITH ASSUMED  
ENGINEERING FACTORS. BRACED WALL DESIGN IS NOT PRESCRIPTIVE.
2. SHEATH ALL EXTERIOR WALLS WITH 7/16" OSB TO PROVIDE CS-WP  
BRACING THAT WILL BRACE THE STRUCTURE FOR ALL LATERAL LOADS AS  
REQUIRED BY THE NCRB 2018 EDITION.
3. CS-WP REQUIRED TO "CONTINUOUSLY" SHEATH WOOD STRUCTURAL  
PARTS. CONTRACTOR IS TO INSTALL 7/16" OSB ON ALL EXTERIOR WALL  
HEIGHTS OF 8' OR WALL SPACES 6' OR LONG. AROUND PANELS AND 12"  
ON CENTER.
4. ATTACHED TO "GYPSUM BOARD" CONSTRUCTION IS TO INSTALL 1/2"  
GYPSUM BOARD ON BOTH SIDES OF WALL WHERE NOTED ON THE PLANS  
ATTACHED WITH 1 1/4" LONG OR SHORTER OR 1 5/8" LONG 50d GALV  
NAILS SPACED 12" O.C. AROUND PANEL EDGES AND IN THE FIELD.
5. BRACED WALL DESIGN APPROVED BY THE NCRB 2018 EDITION FOR FHD  
WIND ZONES, BRACED WALLS ARE TO BE CONSTRUCTED IN ACCORDANCE  
WITH CHAPTER 45 OF THE NCRB 2018 EDITION.
6. SEE NOTES AND DETAIL SHEETS FOR ADDITIONAL BRACED WALL  
INFORMATION.

**BRICK SUPPORT NOTES:**

1. UNTIL SCHEDULE APPLIES TO ALL OPENINGS IN BRICK VENER (UNO), SEE ARCH DWGS. FOR SIZE AND LOCATION OF OPENINGS.
2. (1) V = LONG LEG VERTICAL  
LENGTH = CLEAR OPENING
3. EMBED ALL ANGLE IRONS MIN. 4" EACH SIDE IN VENER TO PROVIDE BEARING.
4. FOR ALL HEADERS 8" - 0" AND GREATER IN LENGTH, ATTACH STEEL ANGLE TO HEADER // 1/2" LAG SCREWS @ 12" O.C. STAGGERED.
5. FOR ALL BRICK SOPS @ ROOF LEVELS, FASTEN (2) 2x2 TO BLOCKING BETWEEN STUDS // (4) 12d NAILS PER PLY. FASTEN A MIN. 6" 4" x 5/16" STEEL ANGLE TO (2) 2x2 TO BLOCKING // (2) 1/2" LAG SCREWS @ 12" O.C. STAGGERED. SEE SECTION R703.8.2.1 OF THE 2018 NRC NC FOR ADDITIONAL BRICK SUPPORT INFORMATION.
6. PRECAST REINFORCED CONCRETE UNITS, ENGINEERED BY OTHERS MAY BE USED IN LIEU OF STEEL UNITS.

[illegible]

100


NOTE: BCI 4500s-1.8 JOISTS  
MAY BE INSTALLED IN LIEU OF  
TJI 110 JOISTS AT THE DEPTH  
AND SPACING INDICATED ON THE  
PLAN

**J.S. THOMPSON**  
**ENGINEERING, INC.**  
333 EAST SIX FORK ROAD, SUITE 100, RALEIGH, NC 27609  
PHONE: (919) 786-0919 FAX: (919) 786-0909

KENT  
DREAM FINDERS HOMES


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DOUBLE GARAGE  
DOOR OPTION

FILL BETWEEN JACK STUDS w/ KING STUDS. SECURE  
HEADERS TOGETHER w/ (2) 4" LONG CS16 STRAPS.  
INSTALL (1) STRAP ACROSS TOP AND (1) STRAP  
ACROSS BOTTOM OF HEADERS ON INSIDE FACE.

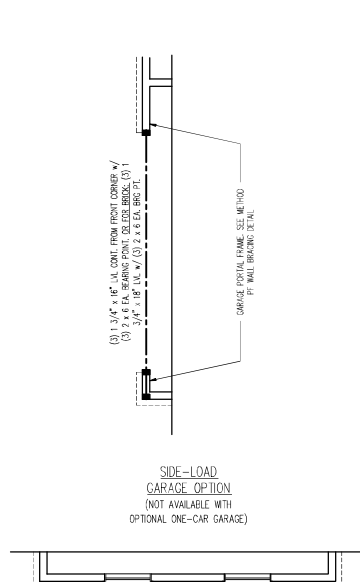

ELEVATION 11,000'

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N.C. LICENSE NO.: C4733

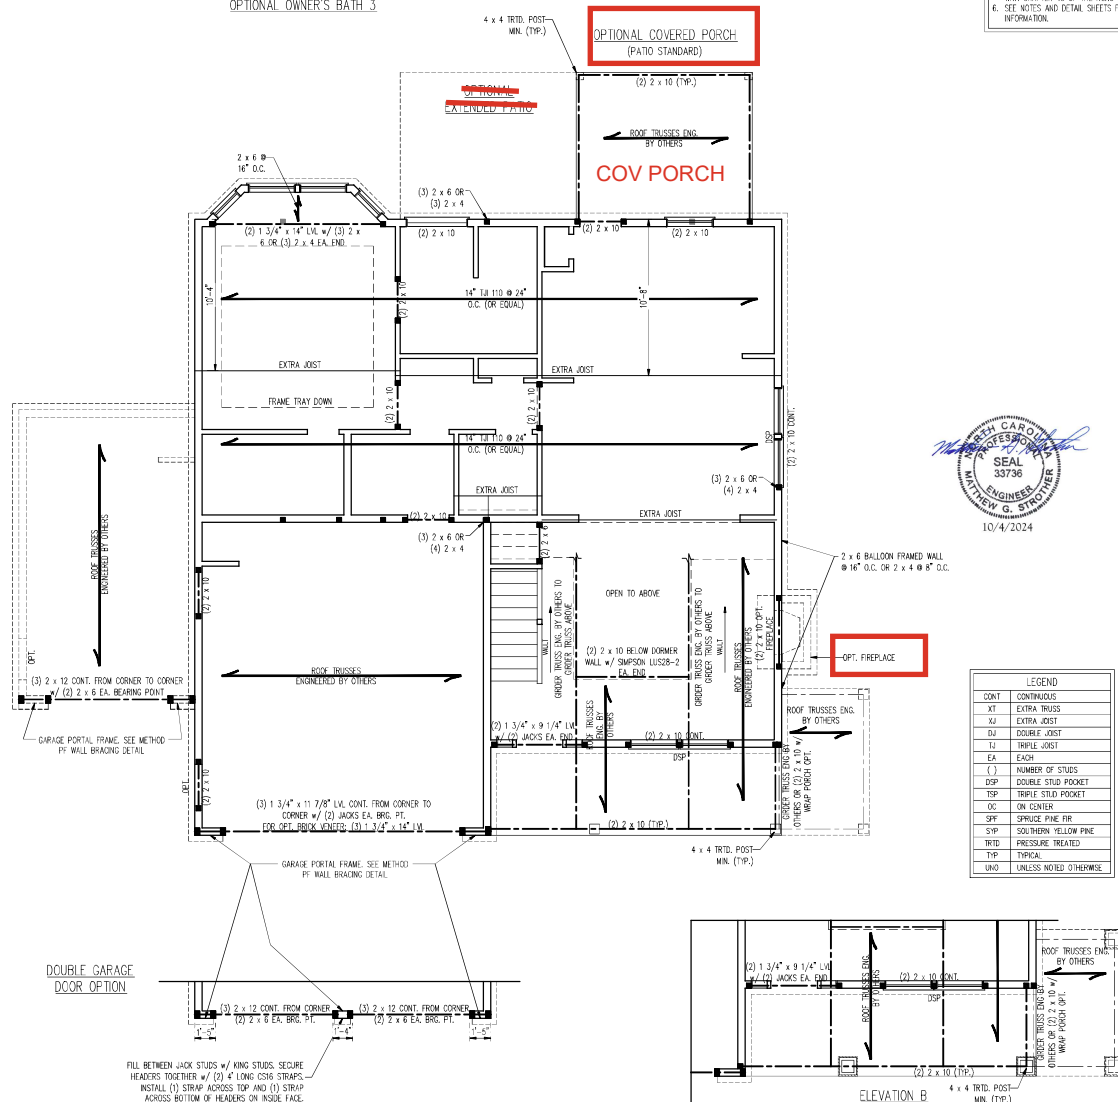1. BRACED WALL DESIGN PER SECTION R602.10.5 "WALL BRACING BY ENGINEERED DESIGN" OF THE NIRC 2018 EDITION USING BEAMING MATERIALS AND METHODS LISTED IN PART 6 R602.10.1.1 AND USING ALTERNATIVE MATERIALS AND METHODS THAT COMPLY WITH ACCEPTED ENGINEERING PRACTICE.
2. SHEATH ALL EXTERIOR WALLS W/ 1/8" OSB TO PROVIDE CS-WALL BRACING THAT SHALL BRACE THE STRUCTURE FOR ALL LATERAL LOADS AS REQUIRED BY THE NIRC 2018 EDITION.
3. CS-WP REFERS TO "CONTINUOUSLY SHEATHED NON-STRUCTURAL PLANES" CONTRACTOR IS TO PROVIDE 1/8" OSB SHEATHING TO ALL EXTERIOR WALLS BRACED BY 2x4 WALLS SPACED @ 16" O.C. ALONG PLANE OF WALLS @ 12" O.C. IN THE FIELD.
4. OSB REFERS TO "GYPSUM BOARD" CONTRACTOR IS TO INSTALL 1/2" (MIN) GYPSUM BOARD ON BOTH SIDES OF WALL WHERE NOTED IN THE PLANS ATTACHED TO 1'-4" LONG AS SCORERS @ 16" O.C. @ 54 INCHES MAXIMUM SPACING.
5. BRACED WALL DESIGN APPLIED IN WIND ZONES UP TO 130 MPH. FOR HIGHER WIND ZONES, BRACED WALLS ARE TO BE CONSTRUCTED IN ACCORDANCE WITH CHAPTER 45 OF THE NIRC 2018 EDITION.
6. SEE NOTES AND DETAIL SHEETS FOR ADDITIONAL BRACED WALL INFORMATION.


BRICK SUPPORT NOTES:

1. UNITE. SELECTION APPLIES TO ALL OPENINGS IN BRICK VENEER (UNO). SEE ARCH DOORS, FOR SIZE AND LOCATION OF OPENINGS.
2. (LLV) = LONG LEG VERTICAL.
3. (LH) = LONG LEG HORIZONTAL.
4. EMERD ALL ANGLE IRONS MIN. 4" EACH SIDE INTO VENEER TO PROVIDE BRACING.
5. FOR ALL HEADERS 8"-0" AND GREATER IN LENGTH, ATTACH STEEL ANGLE TO HEADER W/ 1/2" LAG BOLTS @ 12" O.C. STAGGERED.
6. FOR ALL BRICK SUPPORT @ ROOF LINES, FASTEN (2) 2" X 10 BLOCKING BETWEEN STUDS @ 4' 128 MILS PER PLY. FASTEN 6" x 6" x 5/16" STEEL ANGLE TO (2) 2" X 10 BLOCKING @ 12" O.C. LAG BOLTS @ 12" O.C. STAGGERED. SEE DETAIL R703.8.2.1 FOR THE WORK FOR AN ALTERNATE, BRICK SUPPORT INFORMATION.
7. PRECAST REINFORCED CONCRETE UNITS. UNITS BY OTHERS MAY BE USED IN PLACE OF STEEL UNITS.

1. ALL FRAMING LUMBER TO BE 6/6 P (UNO)
2. ALL TREATED LUMBER TO BE SPP (UNO)
3. ALL LOAD BEARING HEADERS TO BE (2) X 6
4. UNDOUL AND DOUBLE DOORS TO BE SUPPORTED BY (1) JACK STUD AND (1) KING STUD END (UNO) SEE TABLE 600000 FOR MINIMUM ALLOWED SPACING OF STUDS
5. SQUARES PENOTE POINT LOADS WHICH REQUIRES SOLID BLOCKING TO GIRDERS OR FOUNDATION. ALL SQUARES TO BE (7) STUDS (UNO)
6. FOR HIGH WIND ZONES, ALL EXTERIOR WALLS TO BE WEATHERED WITH "X" DOGS SHEATHING AND ALL EXTERIOR DOORS AND WINDOWS TO BE 6" X 8" O.C. ALONG EDGES AND 6" X 8" O.C. IN THE FIELD.
7. FOR HIGH WIND ZONES, SECURE ALL EXTERIOR SHEATHING PANELS TO DOUBLE TOP PLATES, BRIMS, JOISTS, AND GIRDERS WITH (2) ROWS OF 60 NAILS SPACING 12" O.C. 3' O.C. AT CORNERS, EXTEND 2' BEYOND CONSTRUCTION JOINTS AND SHALL OVERLAP GIRDERS AND DOUBLE SOLID PLATES THEIR FULL DEPTH AND BE NAILED AND BOLTED TOGETHER FOR ADDITIONAL STRUCTURAL INFORMATION.

DATE: OCTOBER 4, 2024
SCALE: 1/4" = 1'-0"
DRAWN BY: RENAISSANCE RESIDENTIAL DESIGN
ENGINEERED BY: WTB

S-3  
CEILING  
FRAMING PLAN

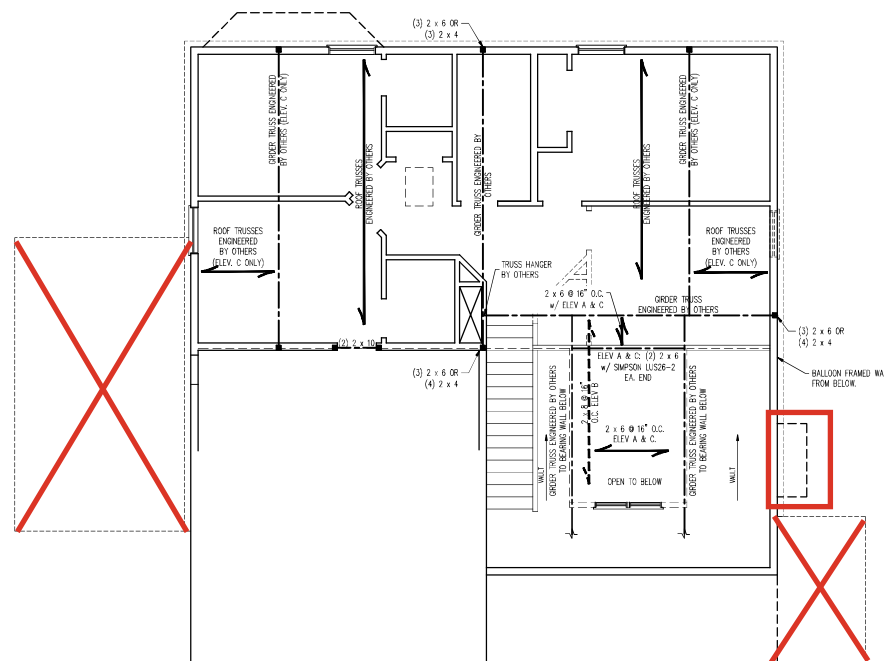

LEGEND	
CONT	CONTINUOUS
XT	EXTRA TRUSS
XJ	EXTRA JOIST
DJ	DOUBLE JOIST
TJ	TRIPLE JOIST
EA	EACH
( )	NUMBER OF STUDS
BSP	DOUBLE STUD POCKET
TSP	TRIPLE STUD POCKET
OC	ON CENTER
SPF	SPRUCE PINE FIR
SYP	SOUTHERN YELLOW PINE
TRTD	PRESSURE TREATED
TYP	TYPICAL
UNO	UNLESS NOTED OTHERWISE

BRICK SUPPORT NOTE:

1. FASTEN (2) 2 x 10 BLOCKING BETWEEN WALL STUDS w/ (4) 16D NAILS PER PLY. FASTEN A 6" x 4" x 5/8" STEEL ANGLE TO (2) 2 x 10 BLOCKING w/ (2) 1/2" LAG SCREWS @ 12" O.C. STAGGERED. SEE SECTION K100.8.2.1 OF THE 2018 NRC FOR ADDITIONAL BRICK SUPPORT INFORMATION.
2. WHERE ROOF SLOPES EXCEED 1/2, INSTALL 3" x 3" x 1/4" STEEL PLATE STOPS AT 24" O.C. PER SECTION K100.8.2.1 OF THE NORTH CAROLINA RESIDENTIAL CODE 2018 EDITION.

STRUCTURAL NOTES:

1. ALL TRACING LINES TO BE 1/8" W/4" UNO.
2. CIRCLES DENOTE (3) 2 x 4 POSTS FOR ROOF SUPPORT.
3. TRUSS CORNER WALLS ON TOP OF DOUBLE OR TRIPLE RAFTERS.
4. HP BRICES ARE TO BE SPACED 4" MIN OR 8" O/C. FASTEN MEMBERS WITH THREE ROWS OF 24 NAILS @ 16" O.C. (TYP).
5. STOCK TRUSS OVER-HAUNG ROOF SECTIONS w/ 2 x 8 RIDGES, 2 x 6 RAFTERS @ 16" O.C. AND FLAT 2 x 10 VALLEYS OR USE VALLEY TRUSSES.
6. FASTEN FLAT VALLEYS TO RAFTERS OR TRUSSES WITH SIMPSON HD34 HURRICANE TIES @ 32" O.C. MAX. PASS HURRICANE TIES THROUGH NOTCH IN ROOF SHEATHING. EACH RAFTER IS TO BE FASTENED TO THE FLAT VALLEY WITH 4 MIN OF (6) 16D TOE NAILS.
7. REFER TO SECTION R602.1 OF THE 2018 NRC FOR REQUIRED UPLIFT RESISTANCE AT RAFTERS AND TRUSSES.
8. REFER TO NOTES AND DETAIL SHEETS FOR ADDITIONAL STRUCTURAL INFORMATION.

LEGEND

XR	EXTRA RAFTER
XT	EXTRA TRUSS
DR	DOUBLE RAFTER
TR	TRIPLE RAFTER
RS	RAFTER SUPPORT
TS	TRUSS SUPPORT
CONT	CONTINUOUS
EA	END
OC	ON CENTER
SPT	SPRUCE PINE FIR
SYF	SOUTHERN YELLOW PINE
TYP	TYPICAL
UNO	UNLESS NOTED OTHERWISE

NOTE: REFER TO ARCHITECTURAL DRAWINGS FOR ROOF PITCHES, PLATE HEIGHTS, DIMENSIONS, OVERHANG WIDTHS, AND ATTIC VENT CALCS.

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N.C. LICENSE NO. C-173

KENT  
DREAM FINDERS HOMES

DATE: OCTOBER 4, 2024

SCALE: 1/4" = 1'-0"


DRAWN BY: RENAISSANCE  
RESIDENTIAL DESIGNS

INNOVATED BY: WFF

S-4a  
ROOF FRAMING  
PLAN



10/4/2024

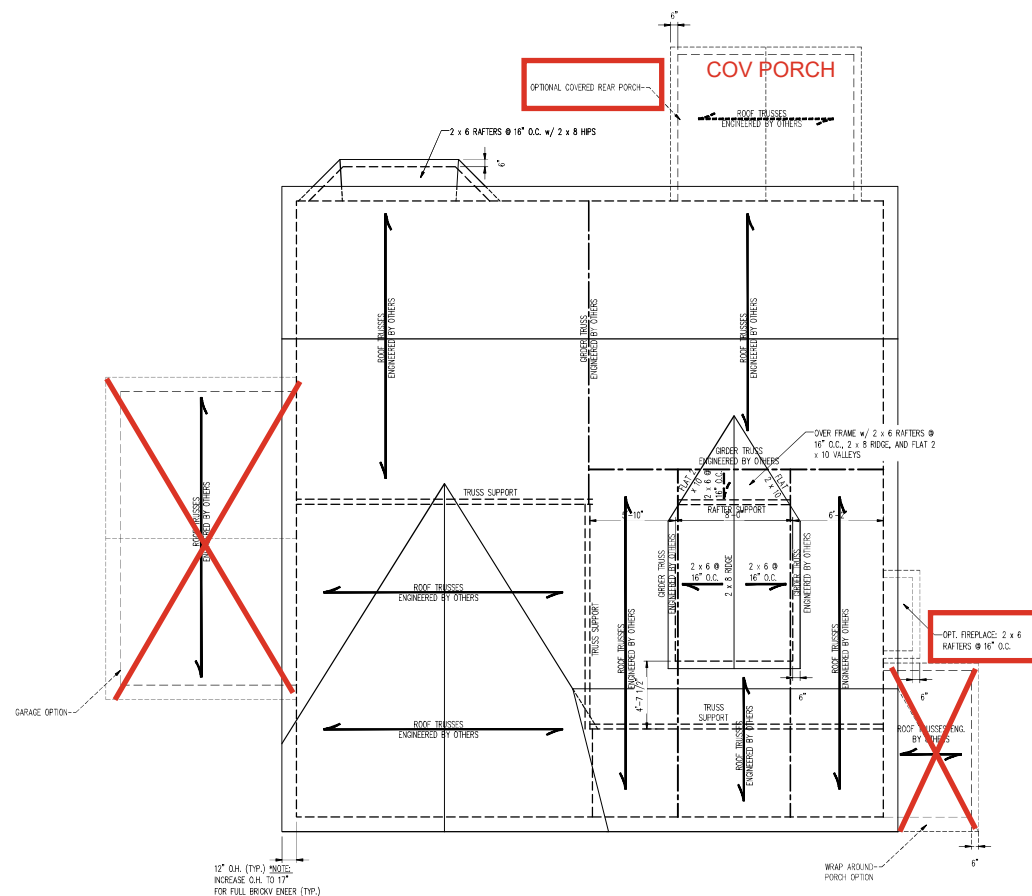


ELEVATION A




## MONOLITHIC SLAB DETAILS

DETAIL 1

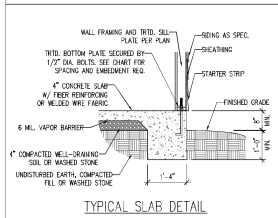


TYPICAL SLAB DETAIL

DETAIL 2

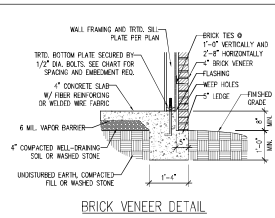


BRICK VENEER DETAIL

DETAIL 3

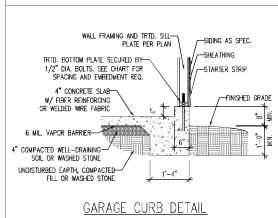


GARAGE CURB DETAIL

DETAIL 4

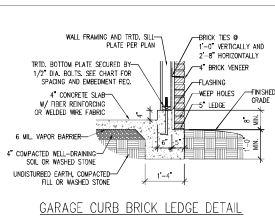


GARAGE CURB BRICK LEDGE DETAIL

DETAIL 5

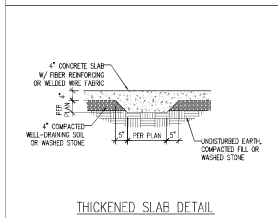


THICKENED SLAB DETAIL

DETAIL 6

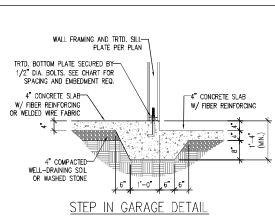

STEP IN GARAGE DETAIL


DETAIL 7

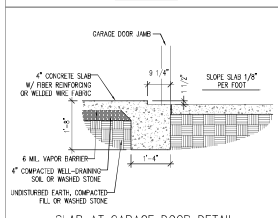

SLAB AT GARAGE DOOR DETAIL


## STEM WALL DETAILS

DETAIL 1

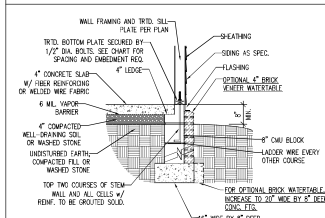


TYPICAL STEM WALL DETAIL  
(w/ OPTIONAL WATERBABLE)

OPTIONAL DETAIL 1

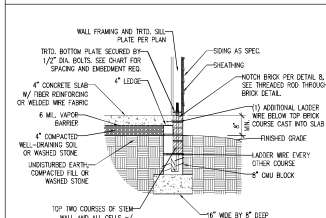


OPTIONAL STEM WALL DETAIL

DETAIL 2

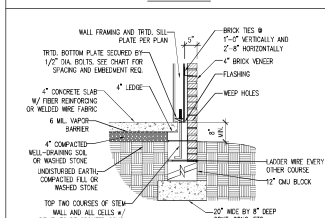


TYPICAL STEM WALL END DETAIL  
w/ BRICK DETAIL

DETAIL 3

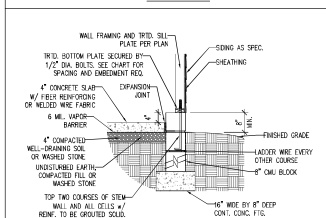


TYPICAL STEM WALL END DETAIL  
w/ CURB @ GARAGE

OPTIONAL DETAIL 3

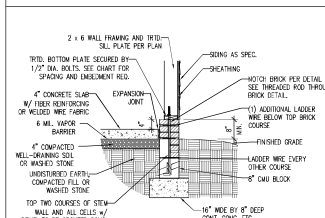


OPTIONAL STEM WALL END DETAIL  
w/ CURB @ GARAGE

DETAIL 4

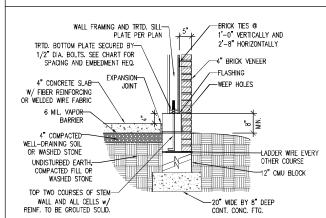

TYPICAL STEM WALL END DETAIL  
w/ BRICK AND CURB @ GARAGE

DETAIL 8

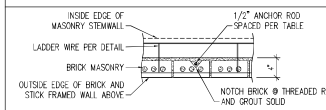

THREADED ROD THROUGH BRICK MASONRY

## MASONRY STEM WALL SPECIFICATIONS

WALL HEIGHT (FEET)	MASONRY WALL TYPE			
	8" CMU	4" BRICK AND 4" CMU	4" BRICK AND 8" CMU	12" CMU
2 AND BELOW	UNGRADED	GRAOUT SOLID	UNGRADED	UNGRADED
3	UNGRADED	GRAOUT SOLID	UNGRADED	UNGRADED
4	GRAOUT SOLID	GRAOUT SOLID w/ #4 REBAR @ 48" O.C.	GRAOUT SOLID	GRAOUT SOLID w/ #4 REBAR @ 64" O.C.
5	GRAOUT SOLID w/ #4 REBAR @ 36" O.C.	NOT APPLICABLE	GRAOUT SOLID w/ #4 REBAR @ 36" O.C.	GRAOUT SOLID w/ #4 REBAR @ 64" O.C.
6	GRAOUT SOLID w/ #4 REBAR @ 24" O.C.	NOT APPLICABLE	GRAOUT SOLID w/ #4 REBAR @ 24" O.C.	GRAOUT SOLID w/ #4 REBAR @ 64" O.C.
7 AND GREATER	ENGINEERED DESIGN BASED ON SITE CONDITIONS			

### STRUCTURAL NOTES:

1. WALL HEIGHT MEASURED FROM TOP OF FOOTING TO TOP OF THE WALL.
2. THE MULTIPLE WYTHES TOGETHER WITH LADDER WIRE AT 16" O.C. VERTICALLY.
3. CHART APPLICABLE FOR HOUSE FOUNDATION ONLY. CONSULT ENGINEER FOR DESIGN OF GARAGE FOUNDATION NOT COMMON TO HOUSE.
4. BACKFILL OF CLEAN #57 / #67 WASHED STONE IS ALLOWABLE.
5. BACKFILL OF WELL DRAINED OR SAND - GRAVEL MIXTURE SOLIDS (AS PER #7 BELOW GRADE) CLASSIFIED AS GROUP 1 ACCORDING TO UNITED STATES CLASSIFICATION SYSTEM IN ACCORDANCE WITH TABLE 802.1.1 OF THE 2015 INTERNATIONAL RESIDENTIAL CODE ARE ALLOWABLE.
6. PREP. SLAB PER 802.2.1 AND 802.2.2 BASE OF THE 2015 INTERNATIONAL RESIDENTIAL CODE.
7. MINIMUM 24" LAP SPlice LENGTH.
8. LOCATE REBAR IN CENTER OF FOUNDATION WALL.
9. WHERE REQUIRED, FILL BLOCK SOLID WITH TYPE 1ST WORTH OR 3000 PSI GROUT, USE OF 10M LIFT "GROUTING" METHOD REQUIRED WHEN FILLING WALLS WITH GROUT AT HEIGHTS OF 5' AND GREATER.

## ANCHOR SPACING AND EMBEDMENT

WIND ZONE	120 MPH	130 MPH
	6"-8" O.C. INSTALL MIN. (2) ANCHORS PER PLATE SECTION AND (1) ANCHOR WITHIN 12" OF CORNERS	4"-6" O.C. INSTALL MIN. (2) ANCHORS PER PLATE SECTION AND (1) ANCHOR WITHIN 12" OF CORNERS
EMBEDMENT	7"	15" INTO MASONRY 7" INTO CONCRETE

### NOTE:

THREADED ROD WITH EPOXY, SIMPSON ITEN HD, OR APPROVED ANCHORS SPACED AS REQUIRED TO PROVIDE EQUIVALENT ANCHORAGE TO 1/2" DIAMETER ANCHOR BOLTS MAY BE USED IN LIEU OF 1/2" ANCHOR BOLTS.



10/4/2024

120 MPH - 130 MPH ULTIMATE DESIGN WIND SPEED  
FOUNDATION DETAILS  
DREAM FINDER HOMES

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FARMINGTON, NC 27834  
PHONE: (919) 889-9921 FAX: (919) 889-9921  
N.C. LICENSE NO. C-171

DATE: NOVEMBER 20, 2022  
SCALE: 3/8"  
DRAWN BY: JBT  
APPROVED BY: JBT

D-1  
FOUNDATION DETAILS

D-2  
BRACED WALL  
NOTES AND DETAILS  
AND PF DETAIL

D-2  
BRACED WALL  
NOTES AND DETAILS  
AND PF DETAIL

## FRAMING NOTES

- ALL FRAMING LUMBER SHALL BE #2 SPF MINIMUM (F<sub>b</sub> = 875 PSI, F<sub>v</sub> = 375 PSI, E = 1600000 PSI) UNLESS NOTED OTHERWISE. (UNO.) ALL TREATED LUMBER SHALL BE #2 SPF MINIMUM (F<sub>b</sub> = 975 PSI, F<sub>v</sub> = 475 PSI, E = 1600000 PSI) UNLESS NOTED OTHERWISE. (UNO.)
2. LAMINATED VENER LUMBER (1x4) SHALL HAVE THE FOLLOWING MINIMUM PROPERTIES: F<sub>b</sub> = 2600 PSI, F<sub>v</sub> = 285 PSI, E = 1900000 PSI. LAMINATED STRAND LUMBER (1x3) SHALL HAVE THE FOLLOWING MINIMUM PROPERTIES: F<sub>b</sub> = 2325 PSI, F<sub>v</sub> = 370 PSI, E = 1550000 PSI. PARALLEL STRAND LUMBER (PSL) UP TO 7" DEPTH SHALL HAVE THE FOLLOWING MINIMUM PROPERTIES: F<sub>b</sub> = 2500 PSI, E = 1800000 PSI. PARALLEL STRAND LUMBER (PSL) MORE THAN 7" DEPTH SHALL HAVE THE FOLLOWING MINIMUM PROPERTIES: F<sub>b</sub> = 2900 PSI, E = 2000000 PSI. INSTALL ALL CONNECTIONS PER MANUFACTURER'S SPECIFICATIONS.
3. STRUCTURAL STEEL SHALL CONFORM TO THE FOLLOWING ASTM SPECIFICATIONS
- |    |                             |                                 |
|----|-----------------------------|---------------------------------|
| A. | W AND WT SHAPES:            | ASTM A992                       |
| B. | CHANNELS AND ANGLES:        | ASTM A36                        |
| C. | PLATES AND SHEETS:          | ASTM A36                        |
| D. | HOLLOW STRUCTURAL SECTIONS: | ASTM A500 GRADE B               |
| E. | STEEL PIPE:                 | ASTM A53, GRADE 65, TYPE O OR S |
4. STEEL BEAMS SHALL BE SUPPORTED AT EACH END WITH A MINIMUM BEARING LENGTH OF 3 1/2" AND FULL FLANGE WIDTH (UNO). PROVIDE SLOTTING FROM BEAM SUPPORT TO FOUNDATION. BEAMS SHALL BE ATTACHED AT THE BOTTOM FLANGE TO EACH SUPPORT AS FOLLOWS (UNO):
- |                            |  |  |
|----------------------------|--|--|
| A. WOOD FRAMING            | (1) 2" DIA. x 4" LONG LAG SCREWS             |  |
| B. CONCRETE                | (1) 2" DIA. x 4" WEDGE ANCHORS               |  |
| C. MASONRY (FULLY GROUTED) | (1) 2" DIA. x 4" LONG SMPSION TIE HD ANCHORS |  |
| D.                         | STEEL PIPE COLUMN                            | (1) 3/4" DIA. A335 BOLTS OR 3/8" FILD NUTS |
- LATERAL SUPPORT IS CONSIDERED ADEQUATE PROVIDED THE JOISTS ARE TOE NAILLED TO THE 2x STUD NAILER ON TOP OF THE STEEL BEAM, AND THE 2x NAILER IS SECURED TO THE TOP OF THE STEEL BEAM. (2) ROWS OF SELF TAPPING SCREWS @ 16" O.C. OR (2) ROWS OF 1/2" DIA. BOLTS @ 16" O.C. 1/2" BOLTS ARE USED TO FASTEN THE NAILER. THE STEEL BEAM SHALL BE FABRICATED w/ (2) ROWS OF 9/8" DIA. HOLES @ 16" O.C.
5. SQUARES DENOTE POINT LOADS WHICH REQUIRE SLOTTING BLOCKING TO ORDER OR FOUNDATION. SHADED SQUARES DENOTE POINT LOADS FROM ABOVE WHICH REQUIRE SLOTTING BLOCKING TO SUPPORT MEMBER BELOW.
6. ALL LOAD BEARING HEADERS TO CONFORM TO TABLE 602.7.1(1) AND 602.7.2(2) OF THE NIRC, 2018 EDITION OR BE (2) x 6" WITH (1) JACK AND (1) KING STUD EACH END (UNO), WHOEVER IS GREATER. ALL HEADERS TO BE SECURED TO EACH STUD STUD WITH (4) 8d NAILS. ALL BEAMS TO BE SUPPORTED WITH (2) STUDS AT EACH BEARING POINT (UNO). INSTALL KING STUDS PER SECTION 602.7.5 OF THE NORTH CAROLINA RESIDENTIAL CODE, 2018 EDITION.
- ALL BEAMS, HEADERS, OR ORDER TRUSSES PARALLEL TO WALLS ARE TO BEAR FULLY ON (1) JACK OR (2) STUDS MINIMUM OR THE NUMBER OF JACKS OR STUDS NOTED. ALL BEAMS OR ORDER TRUSSES PERPENDICULAR TO WALL AND SUPPORTED BY (1) STUD OR LESS ARE TO HAVE 1 1/2" MINIMUM BEARING (UNO). ALL BEAMS OR ORDER TRUSSES PERPENDICULAR TO WALL AND SUPPORTED BY MORE THAN (1) STUD OR (2) OTHER NUTS COLUMN ARE TO BEAR FULLY ON SUPPORT COLUMN FOR ENTIRE NAIL DEPTH (UNO). BEAM ENDS THAT BUTT INTO ONE ANOTHER ARE TO HAVE EACH BEAR EQUAL LENGTHS (UNO).
7. FITCH BEAMS SHALL BE BOLTED TOGETHER USING 1/2" DIA. BOLTS (ASTM A307) WITH WASHERS PLACED AT THREADED END OF BOLT. BOLT SHAVE SPACES AT 24" CENTERS (MINIMUM), AND STAGGERED AT TOP AND BOTTOM OF BEAM (2" EDGE DISTANCE), WITH (2) BOLTS LOCATED AT 4" FROM EACH END (UNO).
- ALL 1-1/2" OR TRUSS LAYOUTS ARE TO BE IN COMPLIANCE WITH THE OVERALL DESIGN SPECIFIED ON THE PLANS. ALL DEVIATIONS ARE TO BE BROUGHT TO THE ATTENTION OF THE ENGINEER OF RECORD PRIOR TO INSTALLATION.
8. BRACED WALL PANELS SHALL BE CONSTRUCTED ACCORDING TO THE NORTH CAROLINA RESIDENTIAL CODE 2018 EDITION WALL BRACING CRITERIA. THE MATERIAL, LENGTH, AND LOCATION OF BRACING SHALL COMPLY WITH ALL APPLICABLE TABLES IN SECTION 602.10.
9. PROVIDE DOUBLE JOIST UNDER ALL WALLS PARALLEL TO FLOOR JOISTS. PROVIDE SUPPORT UNDER ALL WALLS PARALLEL TO FLOOR TRUSSES OR 1-1/2" PER MANUFACTURER'S SPECIFICATIONS. INSTALL BLOCKING BETWEEN JOISTS OR TRUSSES FOR POINT LOAD SUPPORT FOR ALL POINT LOADS ALONG OFFSET LOAD LINES.
10. FOR ALL HEADERS SUPPORTING BROCK VENEER THAT ARE LESS THAN 6'-0" IN LENGTH, REST A 6" x 4" x 5/16" STEEL ANGLE WITH 6" MINIMUM EMBEDMENT AT SIDS FOR BROCK SUPPORT (UNO). FOR ALL HEADERS 6'-0" AND GREATER IN LENGTH, BOLT A 6" x 4" x 5/16" STEEL ANGLE TO HEADER WITH 1/2" LAG SCREWS AT 12" O.C. STAGGERED FOR BROCK SUPPORT. FOR ALL BROCK SUPPORT AT ROOF LINES, BOLT A 6" x 4" x 5/16" STEEL ANGLE WITH (2) 2 x 10 BLOCKING INSTALLED W/ (1) 12x12S NAIL IN FLY BETWEEN WALL STUDS WITH (2) ROWS OF 1/2" LAG SCREWS AT 12" O.C. STAGGERED AND IN ACCORDANCE WITH SECTION 703.8.2.1 OF THE NIRC, 2018 EDITION.
11. FOR STICK FRAMED ROOFS: CHOLETS DENOTE (3) 2 x 4 POSTS FOR ROOF MEMBER SUPPORT. HP SPICES ARE TO BE SLOTTED TO PROVIDE A MINIMUM OF 6'-2" SPACING MEMBERS WITH THREE ROWS OF 12x12S NAIL AT 16" O.C. FRAME JOINER WALLS ON TOP OF DOUBLE OR TRIPLE PARTIALS AS SHOWN (UNO).
12. FOR TRUSSED ROOFS: FRAME DOWNER WALLS ON TOP OF 2 x 4 LADDER FRAMING AT 24" O.C. BETWEEN ADJACENT ROOF TRUSSES. STICK FRAME OVER-FRAMED ROOF SECTIONS WITH 2 x 6 RIDGES, 2 x 6 BRATERS AT 16" O.C. AND FLAT 2 x 10 VALLEYS (UNO).
13. ALL 4 x 4 AND 6 x 6 POSTS TO BE INSTALLED WITH 700 LB CAPACITY UPLIFT CONNECTORS TOP AND BOTTOM (UNO). POSTS MAY BE SECURED USING ONE SMPSION H6 OR 12132 UPLIFT CONNECTOR FASTENED TO THE BAND AT THE BOTTOM AND THE BEAM AT THE TOP OF EACH POST. ONE 6'-2" SECTION OF SMPSION CS-1000 C/W STANCHION WITH (8) 8d HD NAILS AT EACH END MAY BE USED IN LIEU OF EACH TRIM STAP. DESIGNED FOR MASSORY OF CONSTRUCTION.

FOUNDATION DESIGN BASED ON A MINIMUM ALLOWABLE BEARING CAPACITY OF 2000 PSF. CONTACT GEOTECHNICAL ENGINEER IF BEARING CAPACITY IS NOT ACHIEVED.

2. FOR ALL CONCRETE SLABS AND FOOTINGS, THE AREA WITHIN THE PERIMETER OF THE BUILDING ENVELOPE SHALL HAVE ALL VEGETATION, TOP SOIL AND FOREIGN MATERIAL REMOVED. FILL MATERIAL SHALL BE FREE OF VEGETATION AND FOREIGN MATERIAL. THE FILL SHALL BE COMPACTED TO ASSURE UNIFORM SUPPORT OF THE SLAB AND FOOTING. THE FILL SHALL NOT EXCEED 24" FOR CLEAN SAND OR GRAVEL, A 1/2" FOR CLEAN SAND OR GRAVEL, A 1/4" THICK BASED COURSE COMPOSED OF CLEAN GRAVEL SAND OR GRAVEL SHALL BE PLACED. A BASE COURSE IS NOT REQUIRED WHEN A CONCRETE SLAB IS INSTALLED ON WELL-DRAINED OR SAND-DRIVEN MIXTURE SOILS CLASSIFIED AS GROUP 1, ACCORDING TO THE UNITED SOILS CLASSIFICATION SYSTEM IN ACCORDANCE WITH THE DESIGN TABLE PART 4.1.

3. PROPERLY DESIGN EXCAVATION BEFORE TO BE PAVED WITHIN 4 TO 12 HOURS OF WHEN TOP OF CONCRETE SLAB IS AT OR BELOW WATER TABLE. IF APPLICABLE, 3/4" - 1" DEEP CONTOUR DENTS ARE TO BE SPACING WITHIN 4 TO 12 HOURS OF CONCRETE FINISHING AND WALL LOCATIONS HAVE BEEN MARKED. ADJUST WHERE NECESSARY.

4. CONCRETE SHALL CONFORM TO SECTION R102.2 OF THE 2018, 2018 EDITION, CONCRETE REINFORCING STEEL TO ASTM A615 GRADE 60, WELDED WIRE FABRIC TO BE ASTM A615. MAINTAIN A MINIMUM CONCRETE COVER AGAINST REINFORCING STEEL OF 5" IN FOOTINGS AND 1 1/2" IN SLABS. REINFORCING STEEL SHALL BE CONFORMING TO THE CONCRETE REINFORCING STEEL MEASURED FROM THE INSIDE FACE OF THE WALL. SHALL NOT BE LESS THAN 3/4". CONCRETE COVER FOR REINFORCING STEEL MEASURED FROM THE OUTSIDE FACE OF THE WALL, SHALL NOT BE LESS THAN 1 1/2" FOR 5# BARS OR SMALLER, AND NOT LESS THAN 2" FOR #6 BARS OR LARGER.

5. MASSORY WALLS TO CONFORM TO ACI 530/ACSE 5.7/M5 402. WORKER SHALL CONFORM TO ASTM C270.

6. THE UNSUPPORTED HEIGHT OF MASSORY PIERS SHALL NOT EXCEED FOUR TIMES THEIR LEAST DIMENSION FOR UNFILLED HOLLOW CONCRETE MASSORY WALLS AND TEN TIMES THEIR LEAST DIMENSION FOR SOLID OR SOLID FILLED PIERS. PIERS MAY BE FILLED WITH SOLID MASONRY OR TYPE M OR S MORTAR. PIERS SHALL BE CAPPED WITH 8" OF SOLID MASONRY.

7. THE CENTER OF EACH OF THE PIERS SHALL BEAR IN THE MIDDLE THIRD OF ITS RESPECTIVE FOOTING. EACH COURSE SHALL BEAR IN THE MIDDLE THIRD OF THE PIERS.

8. ALL CONCRETE AND MASSORY FOUNDATION WALLS ARE TO BE CONSTRUCTED IN ACCORDANCE WITH THE PROVISIONS OF SECTION R104.4 OF THE NRC 2018 EDITION OR IN ACCORDANCE WITH ACI 318, ACI 302, HOMA TR-604 OR ACI 530/ACSE 5.7/M5 402. MASSORY FOUNDATION WALLS SHALL BE REINFORCED PER TABLE R404.1(1), R404.1(2), R404.1(3), OR R404.1(4) OF THE NRC 2018 EDITION. CONCRETE FOUNDATION WALLS ARE TO BE REINFORCED PER TABLE R404.1(5) OF THE NRC 2018 EDITION. STEP CONCRETE FOUNDATION WALLS TO 2 x 6 FRAMED WALLS AT: 1. REINFORCED PER PERMITS (AND)

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120 MPH - 130 MPH ULTIMATE DESIGN WIND SPEED  
STANDARD STRUCTURAL NOTES  
DREAM FINDERS HOMES

DATE: JUNE 17, 2022
SCALE: NTS
DRAWN BY: JST
ENGINEERED BY: JST

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STRUCTURAL  
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