COLLEX490INVENTORYMARKEDPLAN

SOUTHPORT

SOUTHPORT REVISION LIST - STRUCTURAL:

- COMBINED WILMINGTON AND WILMINGTON II PLANS. (2-18)
- ADDED BRICK OPTION ON SECOND FLOOR. (2-18)
- CALLED OUT SERIES/SPACING OF IJOISTS ON BASEMENT. (2-18)
- 2018 NCRC UPDATE (6-19)
- 5. 2018 SC IRC (2-15-20)
- 6. ADDED ELEVATION A.2 (BRICK WATERTABLE W/ SIDING ABOVE) & ELEVATION A.3 (STONE WATERTABLE W/ SIDING ABOVE). (2-15-20)

SOUTHPORT REVISION LIST - ARCHITECTURAL:

LIGHST 01, 2021

- 1. CREATED ELEVATIONS TO BE IN STANDARDS WITH OTHER PLANS (SEE SHEETS A-1 THROUGH A-3.5)
- CHANGED COLUMNS ON ELEVATIONS TO STANDARD COLUMNS
- 3. CHANGED GARAGE DOORS TO REPRESENT STANDARD GARAGE DOOR FOR EACH ELEVATION
- 4 FIXED COVERED PORCH TO KEEP COLUMNS FROM OVERLAPPING EDGE OF CONCRETE
- 5. REMOVED GRIDS FROM TRANSOMS ABOVE FRONT DOOR
- 5. ADDED NOTE FOR GARAGE DOOR "GARAGE DOOR PER SPECIFICATIONS AND GLASS INSERT (TOP PANEL ONLY)"
- MOVED ROOF PLANS TO SHEETS A-8 & A-8.1
- CREATED SLAB INTERFACE PLAN (SEE SHEET A-4 THROUGH A-4.2)
- 9. MOVED ALL OPTIONS OFF BASE PLAN AND PLACED ON SEPARATE SHEET
- ADDED NOTE FOR FLUSH COUNTERTOP ON ISLAND
- CHANGED PATIO SIZE TO STANDARD 12'X10'
- ADDED OPTIONAL GAS LINE
- CHANGED KITCHEN LAYO
- ADDED 2ND HOSE BIB
- 15. CALLED OUT '45' WALL WITH CAP" AS STANDARD
- CHANGED ALL EXTERIOR WALLS FROM 2X6 TO 2X4 EXCEPT WHERE SHADED
- ADDED NOTE "OPT. REF."
- REMOVED NUMBERS ON STAIRS
- ADDED NOTE 'OPT. W/D'
- 20. ADDED NOTE "WASHER ALWAYS TO BE LOCATED TO THE LEFT OF DRYER
- 11. VERIFIED VENTILATION AND LIGHT REQUIREMENTS AT OWNER'S BEDROOM MEETS CODE (11-01-20)
- 22. SQUARE FOOTAGES ARE UPDATED AND CHANGED DUE TO MOVEMENT OF WALLS FROM 2X6 TO 2X, TO KEEP JOOS IN ROOMS, EXTERIOR WALL MOVED MEANING ROOF LINES HAVE CHANGED
- 23. SQUARE FOOTAGE OF COVERED PORCH CHANGED DUE TO KEEPING COLUMNS FROM OVERLAPPING CONCRETE EDGE
- 24. CREATED PARTIAL PLANS FOR B & C ELEVATIONS (FLOOR, SLAB, & ELECTRICAL)
- 25. REMOVED ALL WALL OUTLETS
- REMOVED ALL PHONE OUTLETS
- 27. REMOVED ALL TV OUTLETS
- 28. PLACED STANDARD 3 BULB LIGHT IN KITCHEN
- 29. VERIFIED COACH LIGHT LOCATIONS (SEE ELEVS. FOR DIMS.)
- 0. PLACED DASHED FANS WHERE APPLICABLE WITH NOTE *STD. LIGHT, OPT. FAN/LT PREWIRE*
- 31. UPDATED ELECTRICAL KEY
- 32. VERIFIED CO2 DETECTOR LOCATIONS
- 33. SHOWED PENDANT LIGHTS AS OPTIONAL
- 4. SHOWED CAN LIGHTS IN KITCHEN AND FAMILY ROOM AS 'OPTIONAL CAN LIGHTS'
- PLACED OPTIONAL FLOOD LIGHTS
- 36. PLACED OPTIONAL FLOOR OUTLET IN FAMILY ROOM
- 37. PLACED CALCULATIONS FOR SOFFIT AND RIDGE VENT REQUIREMENTS
- 38. UPDATED STAIR LAYOUT TO KEEP MAIN WALL AT KITCHEN FROM MOVING WHEN OPTIONAL BASEMENT SELECTED.

CHANGES ON 09-23-24

- 39. WINDOW AT OPTIONAL OWNER'S BATH 3 CHANGED FROM 2040 TO 4010 TRANSOM AND MOVED TO CENTER LINE OF SHOWER
 - CHANGED WORD 'OWNER'S' TO PRIMARY



COVER SHEET


DREAM FINDERS HOMES SOUTHPORT


ATE: SEPTEMBER 16, 2019

REV.: SEPTEMBER 23, 2024 DRAWN BY:

ENGINEERED BY: REVIEWED BY:



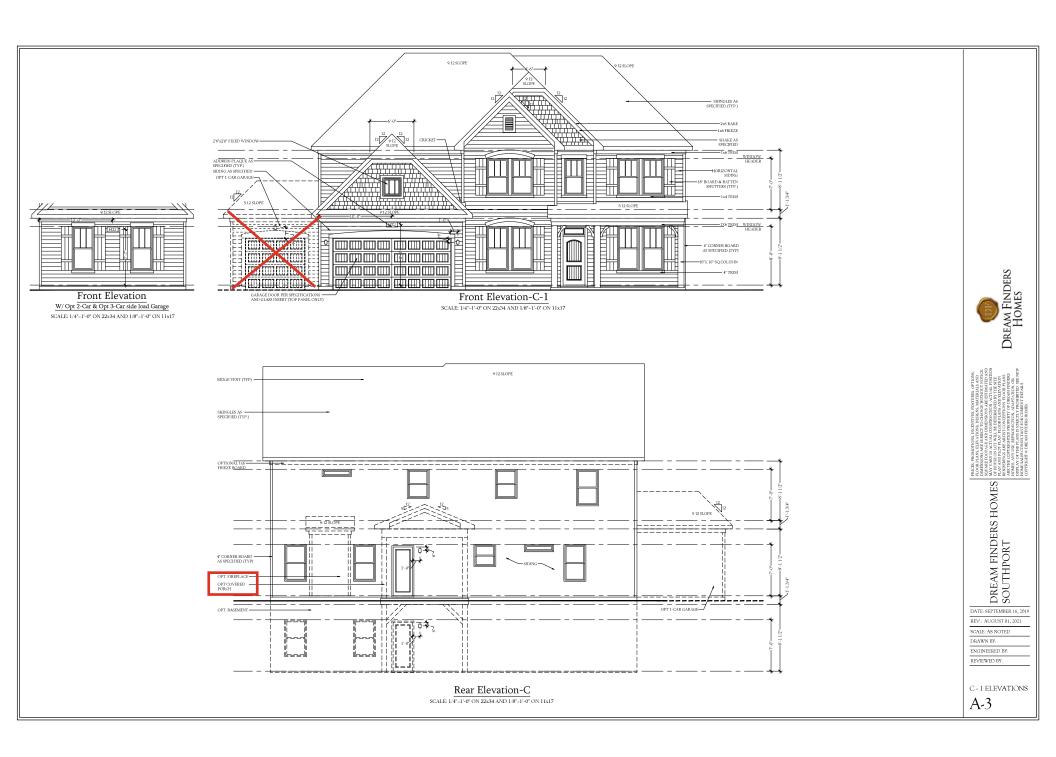

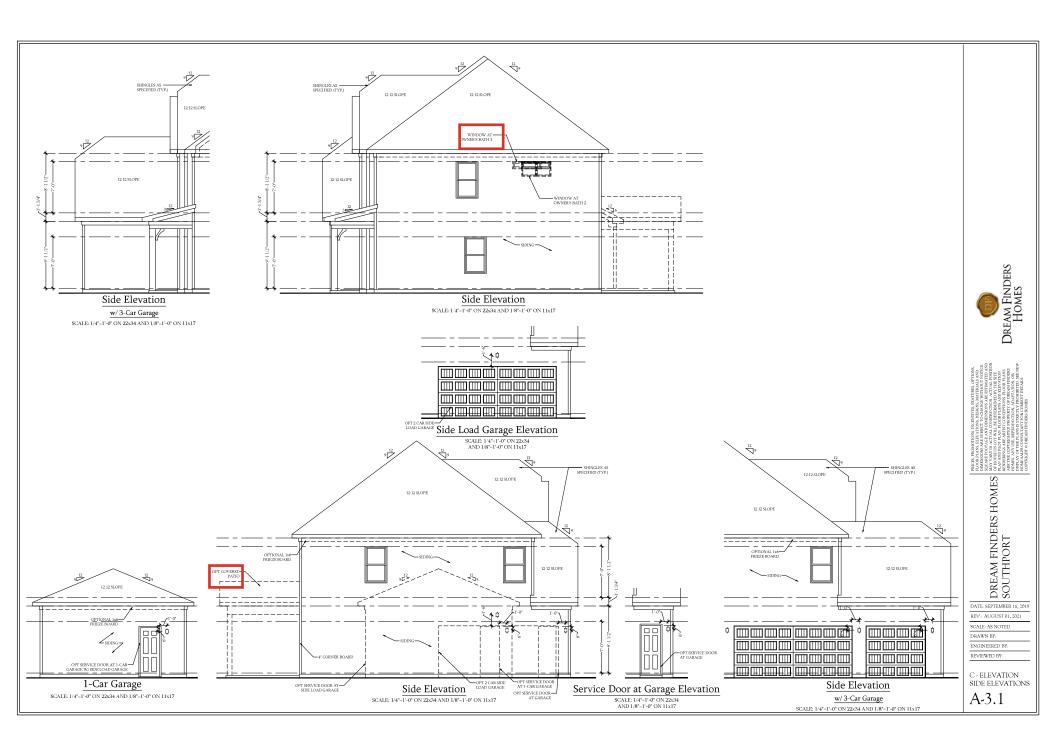

COV PATIO

Slab Interface Plan
SCALE: 1/4"-1'-0" ON 22x34 AND 1.8"-1'-0" ON 11x17

Dream Finders Homes


DREAM FINDERS HOMES SOUTHPORT


DATE: SEPTEMBER 16, 2019
REV.: AUGUST 01, 2021
SCALE: 1/4"-1'0"

DRAWN BY: ENGINEERED BY: REVIEWED BY:

SLAB INTERFACE PLAN

A-4

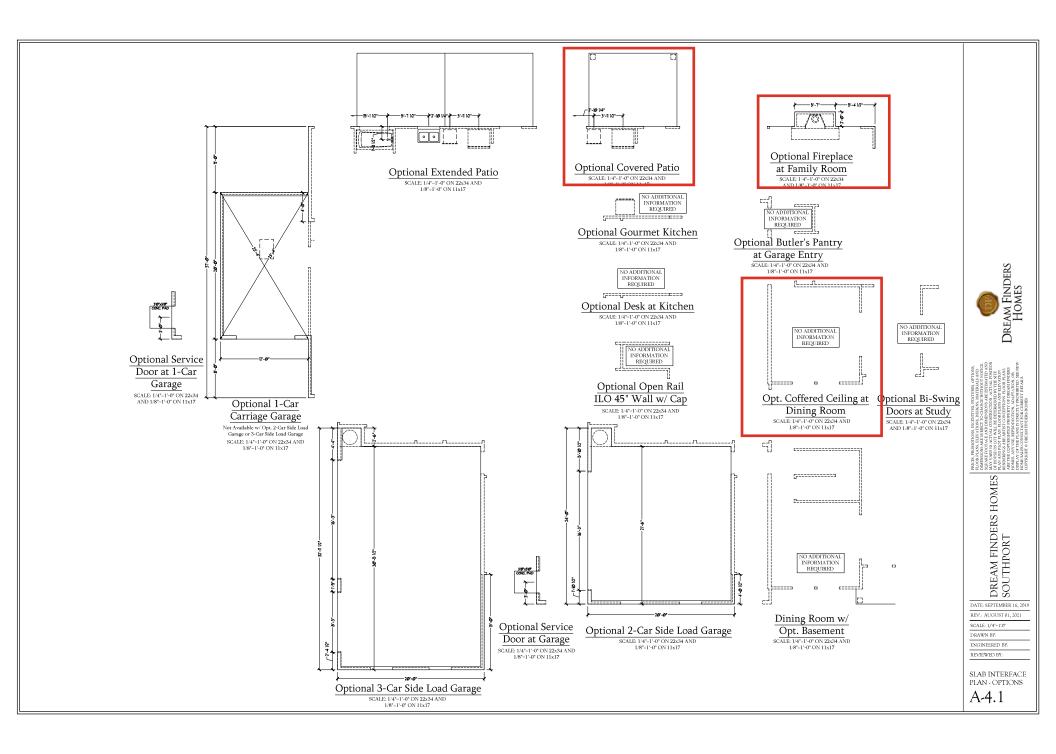


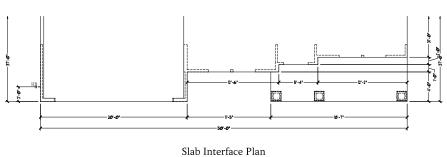

Elevation 'B'

SCALE: 1/4"=1"-0" ON 22x34

AND 1/8"=1"-0" ON 11x17

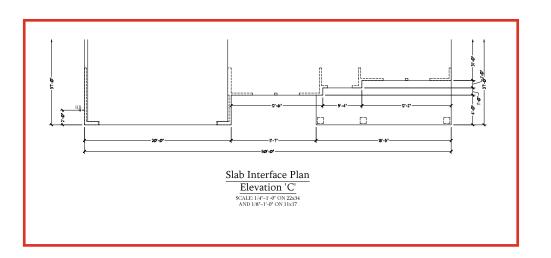



DREAM FINDERS HOMES SOUTHPORT


DATE: SEPTEMBER 16, 2019 REV.: AUGUST 01, 2021


SCALE: 1/4"-1'0"


DRAWN BY: ENGINEERED BY: REVIEWED BY:

SLAB INTERFACE PARTIAL PLANS

A-4.2

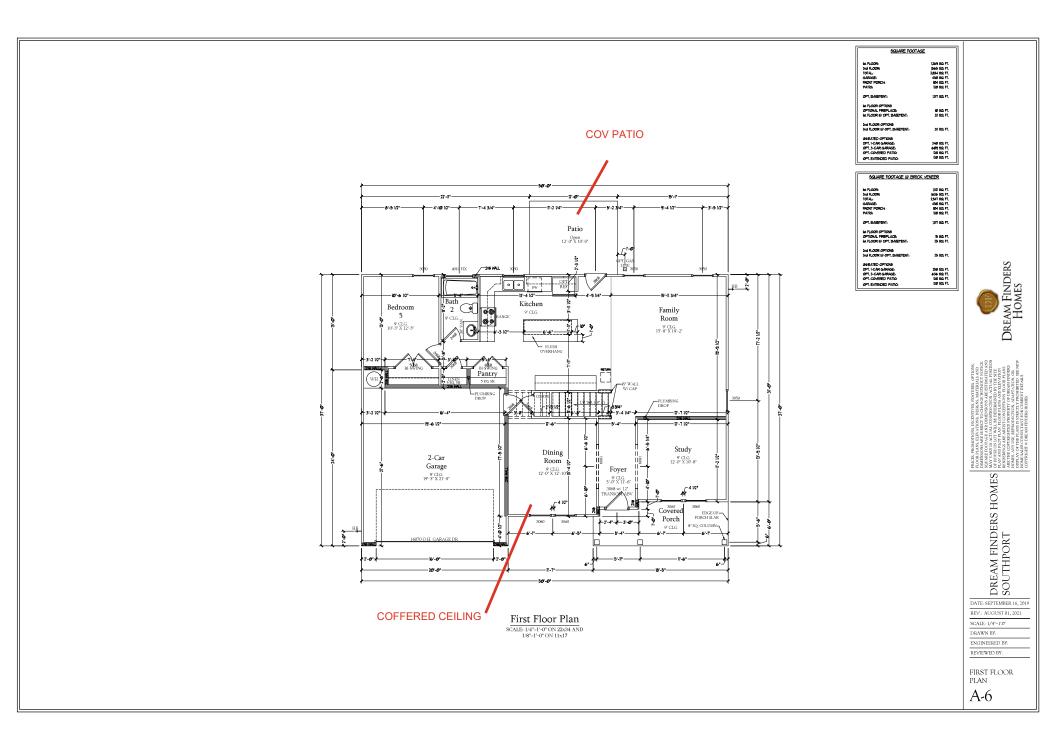

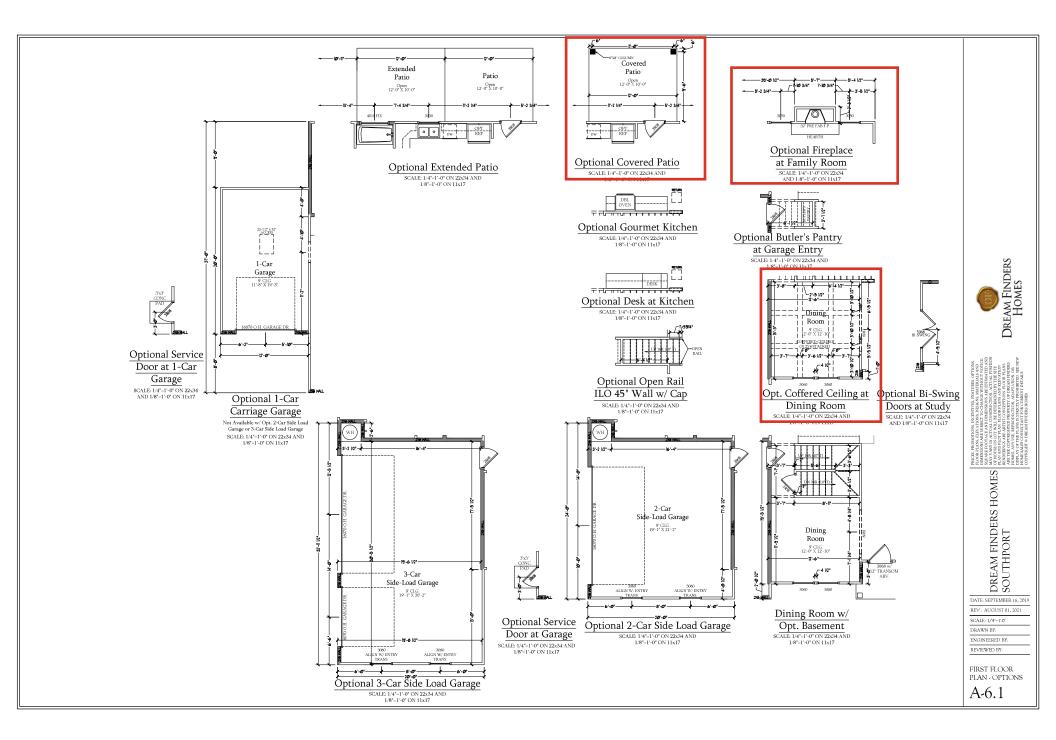

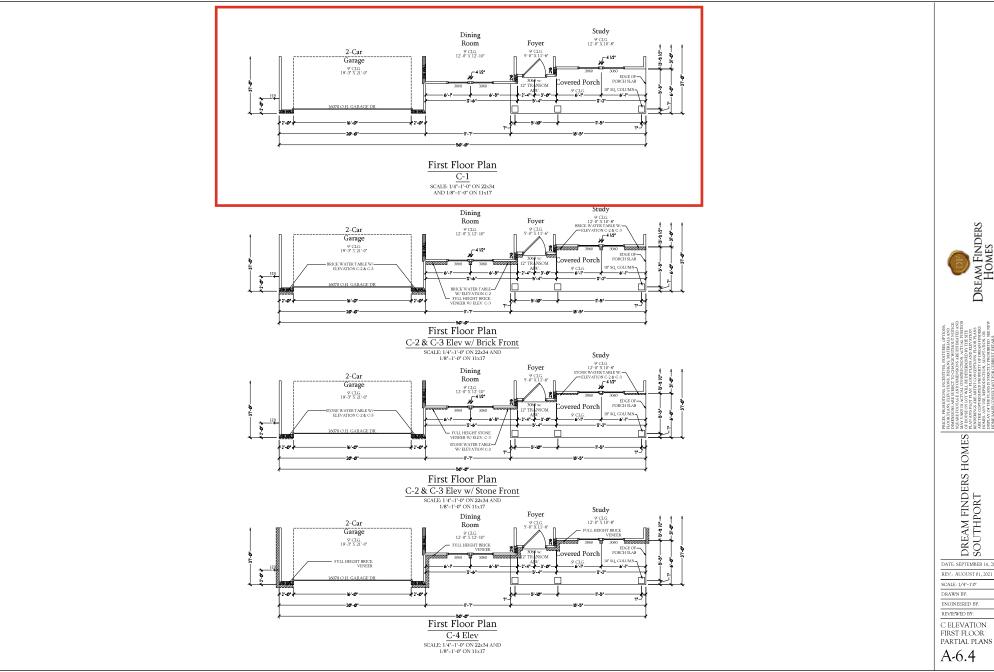




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DREAM FINDERS HOMES SOUTHPORT

DATE: SEPTEMBER 16, 2019 REV.: AUGUST 01, 2021

ENGINEERED BY:

C ELEVATION FIRST FLOOR



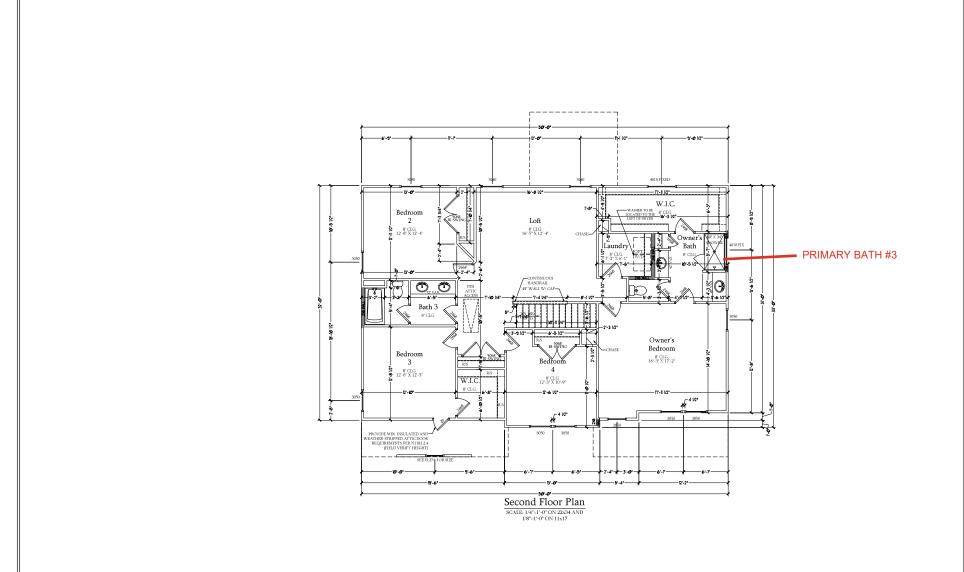

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DREAM FINDERS HOMES SOUTHPORT

DATE: SEPTEMBER 16, 2019 REV:: AUGUST 01, 2021

SCALE: 1/4"-1"0"

DRAWN BY: ENGINEERED BY:

REVIEWED BY:

SECOND FLOOR PLAN

A-7





DREAM FINDERS HOMES SOUTHPORT

DATE: SEPTEMBER 16, 2019


REV.: AUGUST 01, 2021

SCALE: 1/4"-1'-0" DRAWN BY:

ENGINEERED BY: REVIEWED BY:

SECOND FLOOR PLAN - OPTIONS

A-7.1

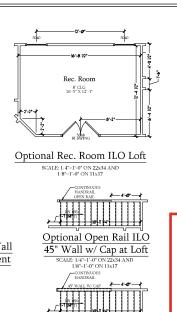

Sitting 8' CLG. 12'-3' X 13'-0"


Optional Sitting Room at


Owner's Bedroom ILO


Bedroom 4 SCALE: 1/4"=1'-0" ON 22x34 AND 1/8"-1'-0" ON 11x17 Optional Primary Bath 2 SCALE: 1/4"=1'-0" ON 22x34 AND 1/8"=1'-0" ON 11x17

Optional Primary Bath 3

SCALE: 1/4"=1'-0" ON 22x34 AND 1/8"=1'-0" ON 11x17

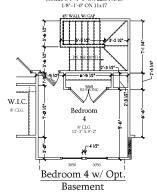

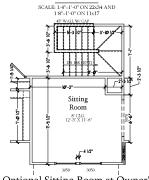

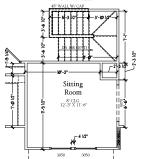

Optional Sitting Room at Owner's Bedroom ILO Bedroom 4 w/ Opt Basement

Optional Open Rail ILO 45" Wall w/ Cap at Loft w/ Opt. Basement SCALE: 1/4"=1'-0" ON 22x34 AND 1/8"=1'-0" ON 11x17

SCALE: 1/4"-1'-0" ON 22x34 AND 1/8"=1'-0" ON 11x17


Bedroom 0 8' CLG. 9 12'-6' X 11'-7' Bath 4 Bedroom

> Opt. Bath 5 w/ Bedroom 3 & Bath 4 SCALE: 1/4"=1'-0" ON 22x34 AND 1/8"=1'-0" ON 11x17

Bedroom W.I.C. 8' CLG. 8' CLG. 12'-6" X 12'-5" PROVIDE MIN. INSULATED AND-WEATHER-STRIPPED ATTIC DOOR REQUIREMENTS PER N1102.2.4 (FIELD VERIFY HEIGHT)

> Opt. 3-Car Side-Load Garage

SCALE: 1/4"=1'-0" ON 22x34 AND 1/8"-1'-0" ON 11x17

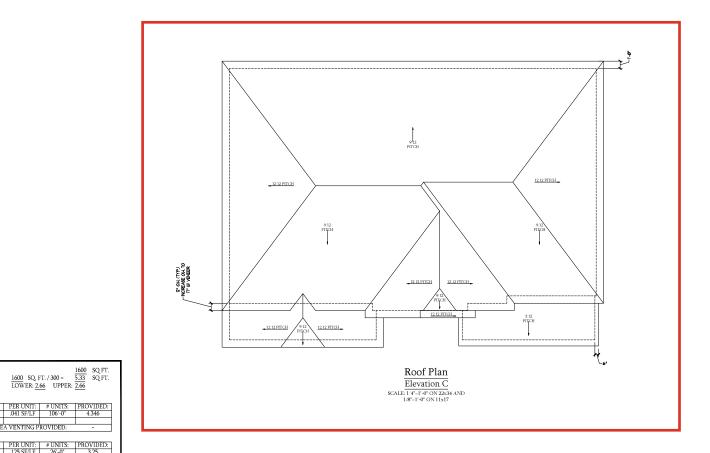

TOTAL UNDER ROOF AREA: VENTING AREA REQUIRED: TOTAL REQUIREMENTS:

LOWER AREA VENTING PROVIDED:

UPPER AREA VENTING PROVIDED:

10.162

LOWER AREA VENTING

UPPER AREA VENTING
RIDGE VENT

TOTAL AREA PROVIDED
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Dream Finders Homes

PRICES, PROMOTIONS, 1 FLOOR PLANS, ELENATI DIMENSIONS ARE SUBI SQUARE PROFACE AND MAY VARY IN ACTUAL PLANS AND PLOY PLAN RENDERINGS ARE ACTUAL ARE THE COPY PLAN RENDERINGS ARE ACTUAL ARE THE COPY RIGHTER HOMES, ANY USE RENE DISPLAY OF THE PLANS DOPPRICHE PLANS DOPPRICHE PLANS DOPPRICHED TO THE PLANS TO THE PLANS THE PLANS TO THE PLANS THE PLANS THE PLANS TO THE PLANS THE PLANS

DREAM FINDERS HOMES SOUTHPORT

DATE: SEPTEMBER 16, 2019

REV.: AUGUST 01, 2021

SCALE: 1/4"-1'-0"

DRAWN BY:


ENGINEERED BY: REVIEWED BY:

C ELEVATIONS ROOF PLAN

A-8.1





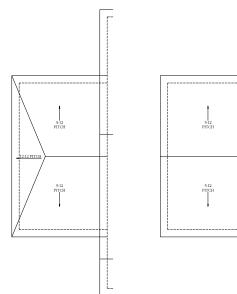




Not Available w/ Opt. 2-Car Side Load Garage or 3-Car Side Load Garage SCALE: 1.4"=1"-0" ON 22x34 AND 1.78"=1"-0" ON 11x17



Not Available w/ Opt, 2-Car Side Load Garage or 3-Car Side Load Garage SCALE: 1/4"=1"-0" ON 22x34 AND 1/8"=1'-0" ON 11x17

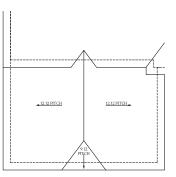

Optional 3-Car Side Load Garage

Elevation C SCALE 14"-1" ON 22:34 AND 18"-1-0" ON 11s17

Optional 3-Car Side Load Garage

Elevation A & B SCALE: 1/4"-1'-0" ON 22x34 AND 1/8"-1'-0" ON 11x17



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DREAM FINDERS HOMES PRINCE SOUTHPORT

DATE: SEPTEMBER 16, 2019 REV.: AUGUST 01, 2021


REV.: AUGUST 01, 20 SCALE: 1/4"-1'0"

DRAWN BY:

ENGINEERED BY: REVIEWED BY:

ROOF PLAN OPTIONS

A-8.2

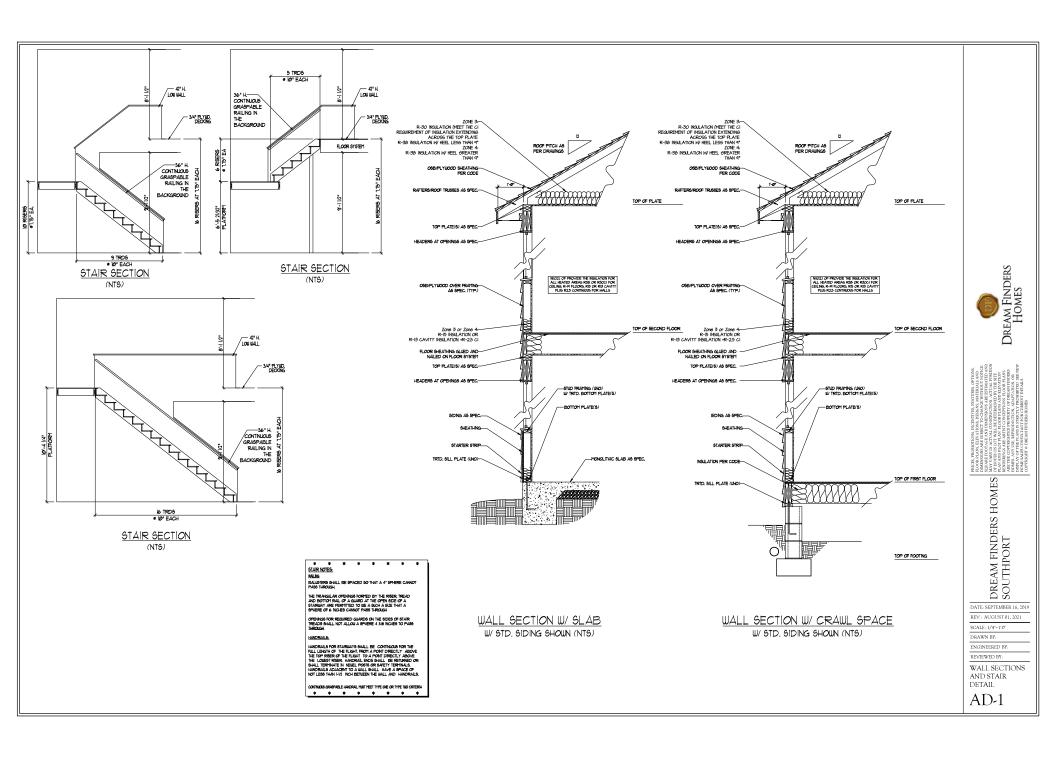

4-PLEX

FLOOR MOUNTED 120V

FLOOR MOUNTED 120V GFI

220V OUTLET

220V DEDICATED CIRCUIT

SPECIAL PURPOSE (240 V, ETC.)

WALL MOUNT LIGHT

CEILING MOUNT LIGHT

PENDANT LIGHT

Ø **⊙** EVERALL LIGHT

FLUORESCENT LIGHT

UNDERCABINET LIGHT
FLOOD LIGHT

SWITCH

3-WAY SWITCH

4-WAY SWITCH

DIMMER SWITCH

TV CONNECTION

SPEAKER

COMBO SMOKE/ CARBON MONOXIDE DETECTOR

110 V SMOKE DETECTOR

EXHAUST FAN



ELECTRICAL NOTES:

PROVIDE AND INSTALL GROUND FAULT CIRCUIT-INTERRUPTERS (G.F.L.) AS INDICATED ON PLANS OR AS ITEM NO. 4 AND 5 BELOW INDICATES.

UNLESS OTHERWISE INDICATED, INSTALL
SWITCHES AND RECEPTACLES AT THE
FOLLOWING HEIGHTS ABOVE FINISHED FLOORSWITCHES ... 42*
OUTLETS ... 14*
COUNTY LEEPHONE ... 14* (UNLESS ABV

COUNTERTOP)
TELEVISION...14°

ALL SMOKE DETECTORS SHALL BE HARDWIRED INTO AN ELECTRICAL POWER SOURCE AND SHALL BE DEJUPPED WITH A MONITORED BATTERY BACKUP PROVIDE AND INSTALL LOCALLY CERTIFIED SMOKE DETECTORS.

ALL 15A AND 20A RECEPTACLES IN SLEEPING ROOMS, FAMILY ROOMS, DINING ROOMS, LIVING ROOMS, DINING ROOMS, LIVING ROOMS, LIVING SECOMS, PARICES, LIBRARIES, DENS, SUNROOMS, RECREATION ROOMS, CLOSETS, HALLWAYS, AND SIMILAR AREAS WILL REQUIRE A GOMBINATION TYPE AF CL. DEVICE AND TAMPER-PROOF RECEPTACLES.


ALL 15A AND 20A 120V RECEPTACLES LOCATED IN THE GARAGE AND UTILITY ROOMS SHALL BE G.F.C.I. PROTECTED (G.F.I).

IT IS THE RESPONSIBILITY OF THE LICENSED ELECTRICIAN TO ENSURE THAT ALL ELECTRICAL WORK IS IN FULL COMPILANCE WITH ALL APPLICABLE LOCAL STANDARDS, CODES, AND ORDINANCES.

EVERY BUILDING HAVING A FOSSIL-FUEL-BURNING HEATER OR APPLIANCE, FIREPLACE, OR AN ATTACHED EARAGE SHALL HAVE AN OPERATIONAL CARBON MONOXIDE DETECTOR INSTALLED WITHIN 10 FEET OF EACH ROOM USED FOR SLEEPING TURPOSES.

ALARAS SHALL RECEIVE THER PRIMARY POWER FROM THE BULLDING WIRING WHEN SUCH FROM THE BULLDING WIRING WHEN SUCH SHALL BULLDING WIRING WHEN SUCH SHALL BULLDING WIRING WHEN SUCH SHALL BULLDING WIRING WI

COV PATIO

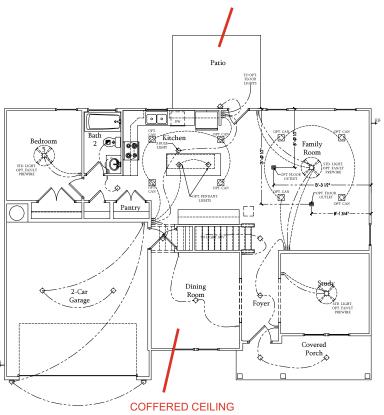

First Floor Plan SCALE: 1/4"=1'-0" ON 22x34 AND 1/8"=1'-0" ON 11x17



IN PRESENT MEMORY SENDENCES REFUTERS, COTONS
TO CORE LANGE IN A VIEW RESENTANCE OF THE SENDENCES AND T

DREAM FINDERS HOMES SOUTHPORT


DATE: SEPTEMBER 16, 2019 REV.: AUGUST 01, 2021

SCALE: 1/4"-1'-0"

DRAWN BY: ENGINEERED BY-REVIEWED BY:

FIRST FLOOR ELECTRICAL

PLAN E-1

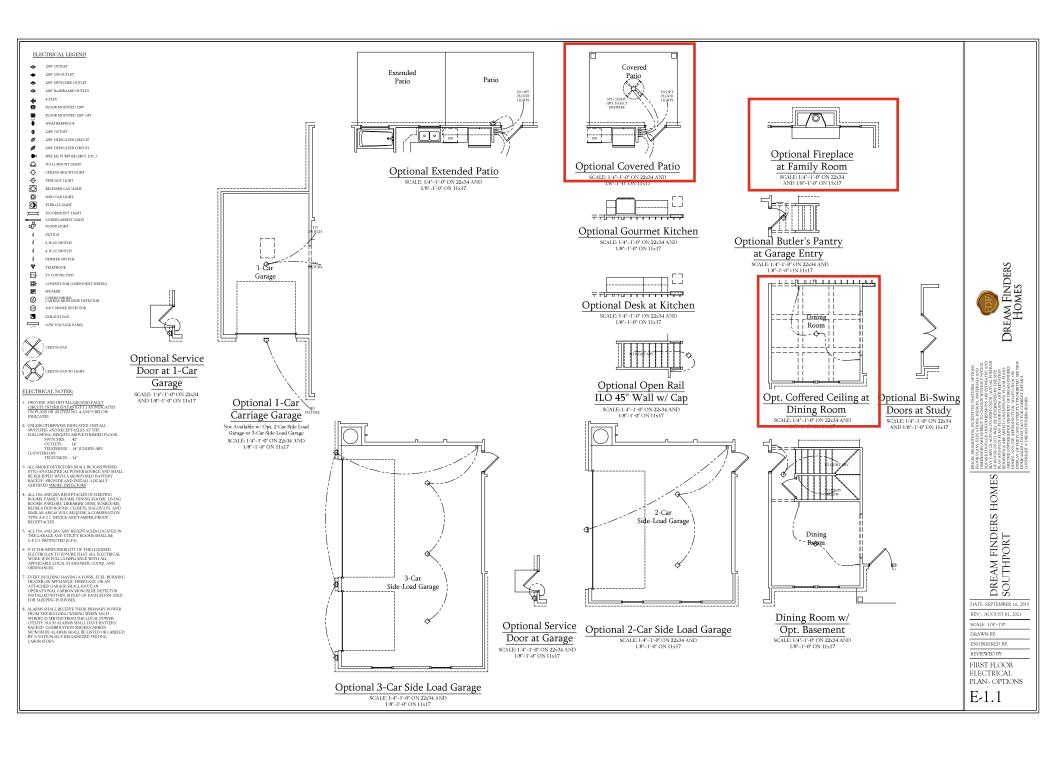

120V BASEBOARD OUTLET

4-PLEX

FLOOR MOUNTED 120V

FLOOR MOUNTED 120V GFI

120V DEDICATED CIRCUIT

220V DEDICATED CIRCUIT

SPECIAL PURPOSE (240 V, ETC.)

WALL MOUNT LIGHT

CEILING MOUNT LIGHT

PENDANT LIGHT

RECESSED CAN LIGHT

MINI CAN LIGHT

EVERALL LIGHT

FLUORESCENT LIGHT \equiv

UNDERCABINET LIGHT
FLOOD LIGHT

SWITCH

3-WAY SWITCH

4-WAY SWITCH

DIMMER SWITCH

TELEPHONE TV CONNECTION

-CONDUIT FOR COMPONENT WIRING SPEAKER

Ø

COMBO SMOKE: CARBON MONOXIDE DETECTOR 110 V SMOKE DETECTOR



ELECTRICAL NOTES:

PROVIDE AND INSTALL GROUND FAULT CIRCUIT-INTERRUPTERS [G.F.L] AS INDICATED ON PLANS OR AS ITEM NO. 4 AND 5 BELOW INDICATES.

UNLESS OTHERWISE INDICATED, INSTALL
SWITCHES AND RECEPTACLES AT THE
FOLLOWING HEIGHTS ABOVE FINISHED FLOORSWITCHES ... 42*
OUTLETS ... 14*
COUNTY LIEEPHONE ... 14* (UNLESS ABV

COUNTERTOP)
TELEVISION . . . 14"

ALL SMOKE DETECTORS SHALL BE HARDWIRED INTO AN ELECTRICAL POWER SOURCE AND SHALL BE EQUIPPED WITH A MONITORED BATTERY BACKUP PROVIDE AND INSTALL LOCALLY CERTIFIED SMOKE DETECTORS.


ALL 15A AND 20A RECEPTACLES IN SLEEPING ROOMS, FAMILY ROOMS, DINING ROOMS, FAMILY ROOMS, DINING ROOMS, LIVENGE ROOMS, PAGES, LIBRARIES, DENS, SUNROOMS, RECREATION ROOMS, CLOSETS, HALLWAYS, AND SIMILAR RAESA WILL REQUIRE A COMBINATION TYPE AF CL. DEVICE AND TAMPER-PROOF RECEPTACLES.

ALL 15A AND 20A 120V RECEPTACLES LOCATED IN THE GARAGE AND UTILITY ROOMS SHALL BE G.F.C.I. PROTECTED (G.F.I).

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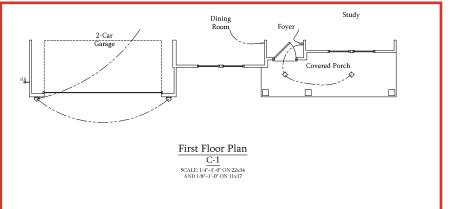
EVERY BUILDING HAVING A FOSSIL-FUEL-BURNING HEATER OR APPLIANCE. FIREPLACE, OR AN ATTACKED GARAGE SHALL HAVE AN OPERATIONAL CARBON MONOXIDE DETECTOR INSTALLED WITHIN 10 FEET OF EACH ROOM USED FOR SLEEPING PURPOSES.

ALARMS SIALL RECEIVE THEIR PRIMARY POWER FROM THE BILLIDING WIRING WHEN SICH WIRING IS SEND THE BILLIDING WIRING WHEN SICH WIRING IS SENDED FROM THE LOCAL POWER UTILITY. SUCH ALARMS SHALL HAVE BATTERY BACKLEP COMBINATION SMOKECK, CARBON MONOXIDE ALARMS SHALL BE LISTED OR LABELED BY A NATIONALLY RECOGNIZED TESTING LABORATORY.

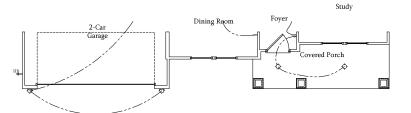

First Floor Plan B-1

SCALE: 1/4"=1'-0" ON 22x34 AND 1/8"=1'-0" ON 11x17





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DREAM FINDERS HOMES SOUTHPORT

DATE: SEPTEMBER 16, 2019

REV.: AUGUST 01, 2021 SCALE: 1/4"-1'-0"

DRAWN BY:

ENGINEERED BY-REVIEWED BY:

FIRST FLOOR ELECTRICAL PARTIAL PLANS

E-1.2



SCALE: 1/4"=1'-0" ON 22x34 AND 1/8"=1'-0" ON 11x17 Dream Finders Homes

IN PRESENT MEMORY SENDENCES REFUTERS, COTONS
TO CORE LANGE IN A VIEW RESENTANCE OF THE SENDENCES AND T

DREAM FINDERS HOMES

DATE: SEPTEMBER 16, 2019

REV.: AUGUST 01, 2021

SCALE: 1/4"-1'.0" DRAWN BY:

ENGINEERED BY:

REVIEWED BY:

SECOND FLOOR ELECTRICAL PLAN

E-2

7. EVERY BUILDING HAVING A FOSSIL-FUEL-BURNING HEATER OR APPLIANCE, FIREPLACE OR AN ATTACHED GARAGE SHALL HAVE AN OPERATIONAL CARBON MONOXIDE DETECTOR INSTALLED WITHIN 10 FEET OF EACH ROOM USED FOR SLEEPING PURPOSES.

ALARMS SHALL RELETVE THEIR PRIMARY POWER FROM THE BILLIDING WIRING WHEN SUCHE WIRING IS SERVED FROM THE LOCAL POWER FROM THE BILLIDING WIRING WHEN SUCHE WIRING IS SERVED FROM THE LOCAL POWER FOR THE WIRING IS SERVED FROM THE LOCAL POWER FROM THE WIRING IS SERVED FROM THE WIRING IS SERVED FROM THE WIRING WIRIN

4-PLEX

FLOOR MOUNTED 120

FLOOR MOUNTED 128V GFI

220V OUTLET

SPECIAL PURPOSE (240 V, ETC.)

WALL MOUNT LIGHT CEILING MOUNT LIGHT

ф О PENDANT LIGHT

Ø

EVERALL LIGHT

FLUORESCENT LIGHT \equiv 烃

UNDERCABINET LIGHT FLOOD LIGHT

SWITCH

3-WAY SWITCH

4-WAY SWITCH DIMMER SWITCH

CONDUIT FOR COME

₽-

SPEAKER COMBO SMOKE/ CARBON MONOXIDE DETECTOR

Ø

110 V SMOKE DETECTOR

EXHAUST FAN



ELECTRICAL NOTES:

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OUTLETS ... 14*
COUNTY ELEPHONE ... 14* (UNLESS ABV

COUNTERTOP) TELEVISION...14"

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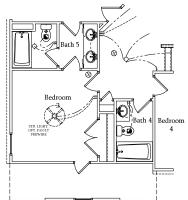
ALL 15A AND 20A RECEPTACLES IN SLEEPING ROOMS, FAMILY ROOMS, DINING ROOMS, LIVING ROOMS, DINING ROOMS, LIVING ROOMS, DENS, SUNROOMS, RECREATION ROOMS, CLOSETS, HALLWAYS, AND SIMILAR RAEAS WILL REQUIRE A GOMBINATION TYPE A F.C.I. DEVICE AND TAMPER-PROOF RECEPTACLES.

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EVERY BUILDING HAVING A FOSSIL-FUEL-BURNING HEATER OR APPLIANCE, FIREPLACE, OR AN ATTACHED CARAGE SHALL HAVE AN OPERATIONAL CARBON MONOXIDE DETECTOR INSTALLED WITHIN 16 FEET OF EACH ROOM USED FOR SLEEPING TURPOSES.


ALARMS SHALL RECEIVE THEIR PRIMARY POWER FROM THE BUILDING WHENS WHEN SUCH WIRING SESSEVED FROM THE LOCAL POWER UTILITY. SUCH ALARMS SHALL HAVE BATTERY BACKUP. COMMINATION SMOKEABON MOXOMIE ALARMS SHALL BE LISTED OR LABELED BLANK ALLY RECONSIDED TESTING. LABORATORY



Opt. Bath 5 w/ Bedroom 3

& Bath 4


SCALE: 1/4"=1'-0" ON 22x34 AND 1/8"=1'-0" ON 11x17

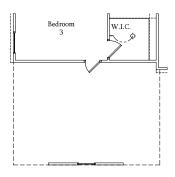


Opt. 3-Car Side-Load

Garage

SCALE: 1/4*=1'-0* ON 22x34 AND 1/8*-1'-0* ON 11x17

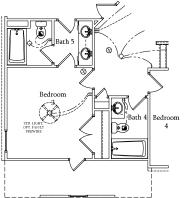


Optional Open Rail ILO 45" Wall w/ Cap at Loft w/ Opt. Basement SCALE: 1/4"=1'-0" ON 22x34 AND 1/8"=1'-0" ON 11x17

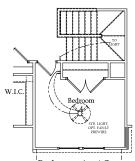


Bedroom 4 w/ Opt. Basement

SCALE: 1/4"=1'-0" ON 22x34 AND

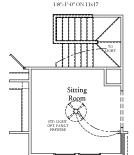

Optional Sitting Room at Owner's Bedroom ILO Bedroom 4 w/ Opt Basement

SCALE: 1/4"-1'-0" ON 22x34 AND 1/8"=1'-0" ON 11x17

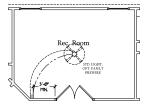


Optional Rec. Room ILO Loft

SCALE: 1/4"=1'-0" ON 22x34 AND 1/8"=1'-0" ON 11x17



Optional Open Rail ILO 45" Wall w/ Cap at Loft SCALE: 1/4"=1'-0" ON 22x34 AND 1/8"=1'-0" ON 11x17

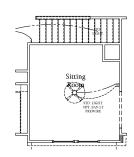

Optional Sitting Room at Owner's Bedroom ILO Bedroom 4

SCALE: 1/4"=1"-0" ON 22x34 AND 1/8"-1"-0" ON 11x17



Dream Finders Homes

PRICES, I PLOOR P DIMENSI SQUARE MAY VA OF HOUS PLAN AN RENDERI ARE THE HOMES, HOMES, DREAM FINDERS HOMES SOUTHPORT

DATE: SEPTEMBER 16, 2019

REV.: AUGUST 01, 2021 SCALE: 1/4"-1'-0"

DRAWN BY: ENGINEERED BY-

REVIEWED BY: SECOND FLOOR

ELECTRICAL PLAN - OPTIONS

E-2.1

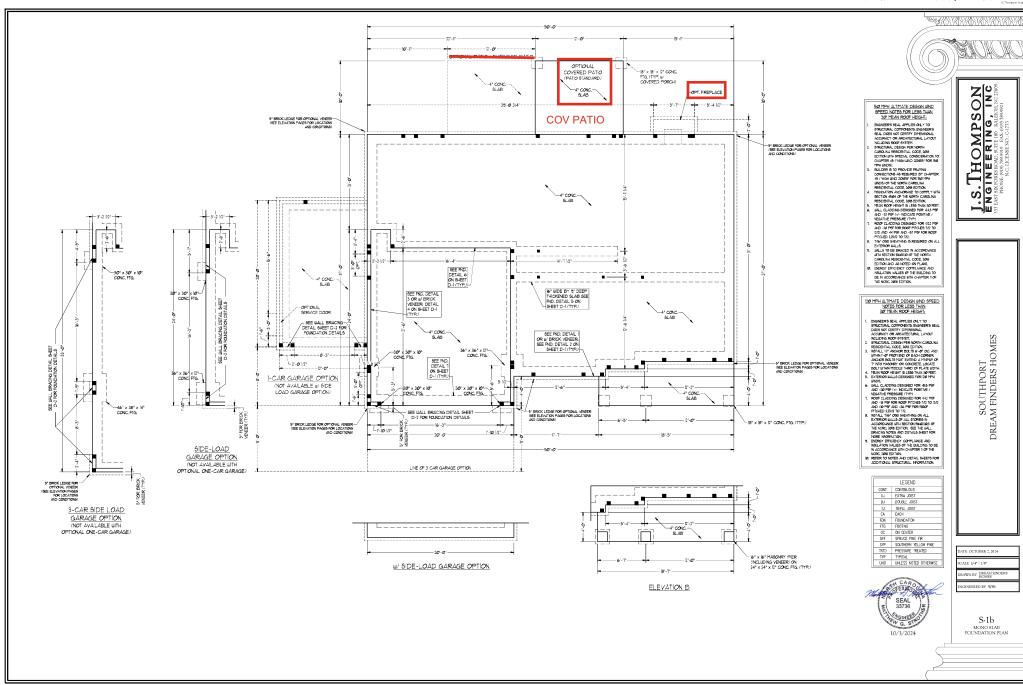




TABLE R602.7.5 MINIMUM NUMBER OF FULL HEIGHT KING STUDS AT EACH END OF HEADERS IN EXTERIOR WALLS

HEADER SPAN	MINIMUM NUMBER OF FU
(FEET)	HEIGHT STUDS (KINGS)
UP TO 3'	1
> 3' TO 6'	2
> 6' TO 9'	3
> 9' TO 12'	4
> 12' TO 15'	5

BRACED WALL DESIGN NOTES:

OPTIONAL COVERED PORCH (DECK STANDARD)

COV PATIO

H' TJI TØ • 16' OC. (OR EGLAL) BELOU KITCHEN

(I) 1 3/4" x 14" L9L FLUSH OR (2) 2 x 10 DROPPED

H* TJI 100 • 192* O.C. (OREGUAL) EXTRA EXTRA JOIST JOIST

(2) | 3/4" x 14" LSL FLUSH OR (2) | 3/4" x 9 1/4" LVL DROPPED

-

(2) 2 x 10 TRTD. (TYP.)

(3) 2 x 10

H" TJI 100 e 16" O.C. (OR EQUAL)

.

-(1) 2 x 4 u/ SIMPSON CSIG STRAPS • 16* O.C.

6 x 6 TRTD. P06T-

(3) 2 x 4 OR-(3) 2 x 6 ELEV C

7(2) 2 x 10 TRTD. (TYP.)

4" BEAM POCKET W/ DROPPED BEAM

-4" CONC.-SLAB

SEE WALL BRACING DETAIL SHEET D-2 FOR FOUNDATION DETAILS

LINE OF 3-CAR GARAGE OPTION

OPTIONAL SERVICE DOOR

6 x 6 TRTD, P06T (MINJ (TYP.)

(3) 2 x 6-

OPT, FIREPLACE

4312×6

- REACED MALL DESIGN NOTE: SECTION RROZINS. **MALL BRACING BY INMERED RESIGN FOR SECTION RROZINS. **MALL BRACING BY INMERISAS, AND METROS LESTED IN THESE REQUITA, MADON MET MATERIAS, AND METROS LESTED IN THE RESIGNATION OF THE DIMERISM PROPERTIES REACH AND MALL DESIGN IS NOT PRESENTED INMERISM PROPERTIES. **MALL DESIGN IS NOT PRESENTED IN SECRETAR HALL DEFENDER MALL SECTION FOR PROMISE CO-SEP MALL REACHER HALL DEFENDE THE STRUCTURE FOR ALL LATERAL LOADS AS SOLUTION OF THE METOLOGY 2015 EXTRINS.
- SCALIES OF THE MICE, 2018 EDITION.

 S. CS-MSF PETES TO CONTINUOUSLY SPEAKED MICE OS STRUCTIONAL MANAGEMENT OF THE MICE TO SERVICE TO THE MICE TO THE M

STRUCTURAL NOTES:

- ALL FRAMING LIMBER TO BE 12 SPF (UNO), ALL TREATED LIMBER TO BE 12 SYP (UNO.)
 INSTALL AN EXTRA JOIST UNDER WALLS PARALLEL TO FLOOR

- 2. NOTIFY, AN EXPERA MOST WORSE WALLS PARALLEL TO FLOOR
 ONDS SHEED ROPE OF THE FLAME
 . SHOOLING ADD CONTROL OF THE PARALLEL TO FLOOR
 . SHOOLING ADD CONTROL OF THE PARALLEL THAN IT AND TH
- FIELD.
 FOR HIGH WIND ZONES, SECURE ALL EXTERIOR WALL SHEATHING
 PANELS TO DOUBLE TOP PLAITES, BANDS, JOISTS, AND GIRDERS
 WITH (2) ROUSE OF BANLS STAGGERED AT 3" OC. PANELS
 SHALL EXTEND 2" BEYOND CONSTRUCTION, JOINTS AND SHALL
 OVER, AP GIRDERS AND DOUBLE SILL FLATES THEIR RILL
- OVER, AP GINDERS AND DOUBLE SILL. PLATES THEIR RILL.

 ALL 4 × 4 POSTS SHALL BE ANCLORED TO SLAPS UP SITTSON
 ABUSE POST BASES FOR EQUAL JAND 6 × 6 POSTS W ABUSE
 POST BASES FOR EQUAL JAND.

 ALL 4 × 4 AND 6 × 6 POSTS TO
 BE INSTALLED WITH YISO ID GAPACITY UPLET CONNECTIONS AT
- TOP (INO.)
 REFER TO NOTES AND DETAIL SHEETS FOR ADDITIONAL STRUCTURAL INFORMATION.

	LEGEND
CONT	CONTINUOUS
ΧJ	EXTRA JOIST
DJ	DOUBLE JOIST
TJ	TRIPLE JOIST
EA	EACH
FDN	FOUNDATION
FTG	FOOTING
00	ON CENTER
SPF	SPRUCE PINE FIR
SYP	SOUTHERN YELLOW PINE
TRTD	PRESSURE TREATED
TYP	TYPICAL
UNO	UNLESS NOTED OTHERWISE

LINTEL SCHEDULE FOR BRICK/NATURAL STONE SUPPORT				
LENGTH (FT.)	SIZE OF LINTEL			
UP TO 4 FT.	L 3 1/2 x 3 1/2 x 1/4			
4-8	L 5 x 3 1/2 x 5/16 LLV			
8 AND GREATER	L 6 x 4 x 5/16 LLV			

BRICK SUPPORT NOTES:

- BBOX_SEPORT MOTES.

 INTEL SCROBLE PAPILES TO ALL OFFENDOS IN
 BROX UREXTE CHAIGS, SEE ARRIVE DIESS, FOR SIZE
 AND LOCATION OF EMPORATION OF SIZE
 AND LOCATION OF COMPANIENT "LOCI SIDE INTEL
 SIDENTE CLADE OFFENDOM, "LOCI SIDE INTEL
 METER TO PROMOTE BERNOW,
 "STORAL HEADERS OF "AND DEATHER IN
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 LIBERTY ATTICAL STEEL ANGLE TO BEAGUE ANY
 LIBERTY ATTICAL STEEL ANGLE TO BEAGUE ANY
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 LIBERTY AND STEEL ANGLE TO LOCATE ANY
 STEEL ANGLE TO (2) 2 x 10 BEDOOMS of /(2)
 LIVER AND LOCATE ANY LIBERTY AND LIBERTY ANY
 STEEL ANGLE TO (2) 2 x 10 BEDOOMS of /(2)
 LIVER AND LIBERTY AND AS A ST CALL STATE
 LIBERTY AND LIBERTY AND LIBERTY AS A STATE
 STEEL ANGLE TO (2) 2 x 10 BEDOOMS of /(2)
 LIVER AND LIBERTY AND LIBERTY AS A STATE
 LIBERTY AND LIB
- SIEEL ANGLE 10 (2) 2 x 10 BULGONIO W/ (2) 1/2" LAG SCHEISS ® 12" O.C. STAGGERGE VEE ESCETION R703.8.2.1 OF THE 2018 NORC FOR ADDITIONAL BROCK SUPPORT INFORMATION. PRECAST REINFORCED CONCRETE LINTELS ENGINEERED BY OTHERS MAY BE USED IN LIEU OF STEEL INVIELS.



NOTE:


BCI 45006-18 JOISTS MAY BE USED IN LIEU OF TJI TO JOISTS AT THE DEPTH AND SPACING NOTED ON THE PLAN.

SOUTHPORT DREAM FINDERS HOMES

GINEERED BY: WFB

ATE OCTOBER 2, 2024

S-2 FIRST FLOOR FRAMING PLAN

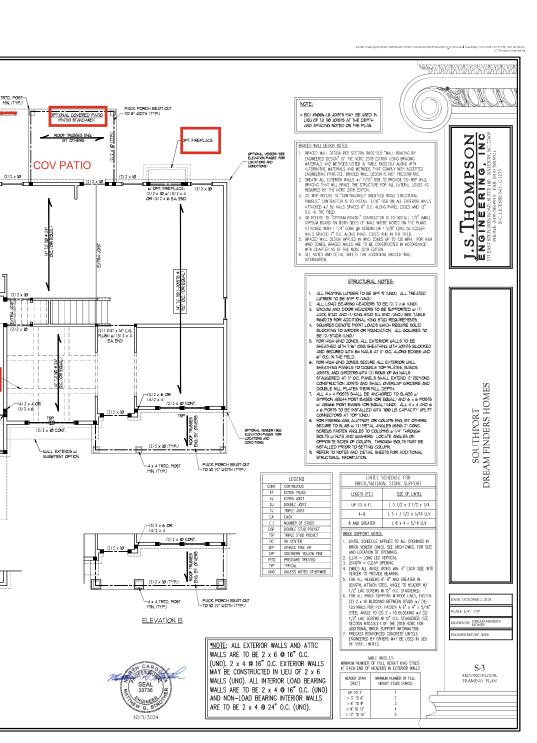

OPTIONAL VENEER (SEE ELEVATION PAGES FOR LOCATIONS AND CONDITIONS)

(3) 2 x 12 CONT. FROM CORNER TO CORNER W (2) 2 x 6 EA BEARING POINT.

- PORTAL FRAME, SEE -

METHOD PF MALL BRACING DETAIL ON SHEET D-2

OPTIONAL VENEER (SEE ELEVATION PAGES -FOR LOCATIONS AND CONDITIONS)

I-CAR GARAGE OPTION

(NOT AVAILABLE W/ SIDE LOAD GARAGE OPTION)

ENG. BY OTHERS W/ ELEVATION C

PORTAL RAYE SEE METHOD PE WALL
BRACING DETALL ON SHEET D-2

(3) 134" x NE "LAL CONT ROY RONT
CORRER W. (4) 2 x 6 EA. BEARNG PONT Q

WEIGHT ABOVE. (3) 134" x 24" LAL

LONG ABOVE. (4) 134" x 2

SIDE-LOAD

GARAGE OPTION

(NOT AVAILABLE WITH OPTIONAL ONE-CAR GARAGE)

72) 2 x 16 CONT.

DINING ROOM W/ OPTIONAL BASEMENT

(4) 2 x 4 OR-(3) 2 x 6

2)2 x 10

3/4" × 16" LVL u/ V BRICK ABOVE:

3-CAR SIDE LOAD GARAGE OPTION

(NOT AVAILABLE WITH OPTIONAL ONE-CAR GARAGE)

FILL BETUEEN HEADERS
SOLID W/KING STUDS.
STRAP HEADERS TOGETHER
W/(1) STRAPS INFOON CSIG.
STRAPS INSTALLED TOP 4
BOTTOM ON THE INSIDE
FACE OF THE HEADERS.

ORTAL FRAME, SEE METHOD FF WALL BRACNS DETAIL ON SHEET D-2 (2) 2 x 10

(3) 2 x 4 OR (3) 2 x 6 ELEV C

2) 2 x 1Ø

g ...

(2) 2 x 10

CANTILEVER 1-JOISTS BENEATH
BATHROOM AND ATT, TO RIM w/
(2) 8d NAILS FACE-NAILED
THROUGH THE RIM BOARD INTO
THE TOP AND BOTTOM FLANGES.

(3) I 3/4" \times 20" LVL SET TOP FLUSH u/ TOP OF JOISTS


(3) 13/4" x 11 7/8" LVL CONT, FROM CORNER TO CORNER w/ (2) 2 x 6 EA BEARING POINT w/ BRICK ABOVE; (3) 13/4" x 14" LVL CONT, FROM

> PORTAL FRAME. SEE METHOD FF WALL BRACING DETAIL ON SHEET D-2

3-CAR GARAGE OPTION

OPT. COFFERED -CELING

(6)2 x 4 OR (4)2 x 6-

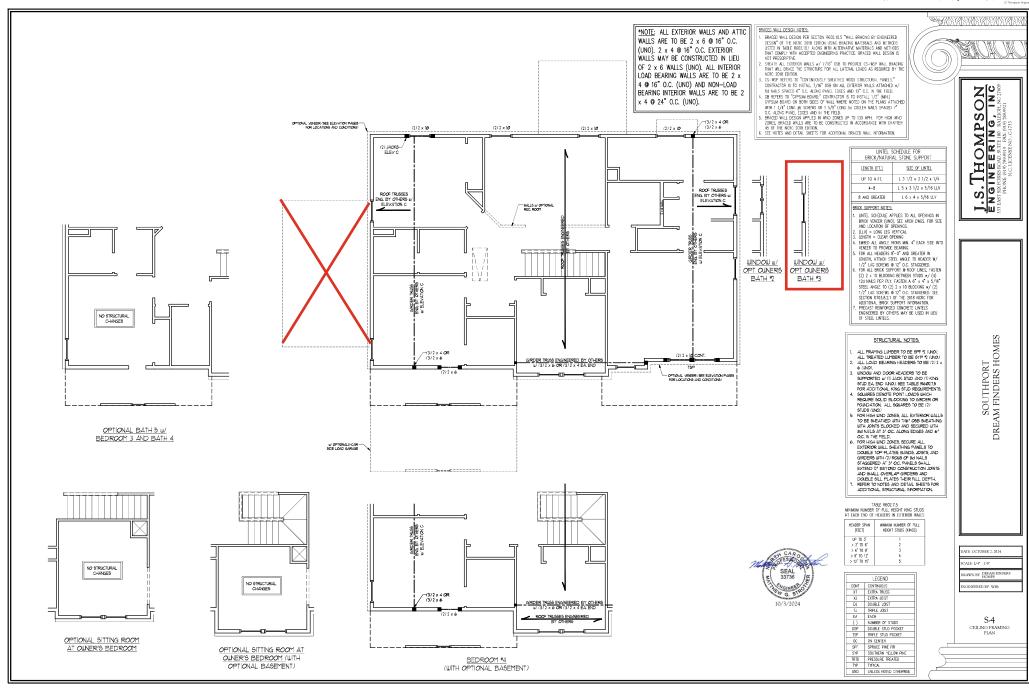



BRICK SUPPORT NOTE:

FASEN (7) 2 (4) BLOOKNO BERIER MALL STUDE 41 (4) Tof MALLS FIETR PL, TASTEN A. 91 AF 2 (4) PEEL MALES TO (7) 2 (4) BLOOKNO BE 70 TO (2) 2 BLOOKNO BE 70 TOF LAGS TO (7) 2 (4) BLOOKNO BE 70 TO (2) 4 BLOOKNO BE 70 TOF LAGS TO (7) 2 (4) BLOOKNO BE 70 TO (7) TO (7) BLOOKNO BE 70 TO (7) BLOOKNO BE 70 TO (7) BLOOKNO BE 70 BLOOKNO BE 70 TO (7) BLOOKNO BE 70 TO (7) BLOOKNO BE 70 TO (7) BLOOKNO BE 70 BLOOKNO BE 70

STRUCTURAL NOTES:

- STELLTURAL NOTES:

 ALL PANINS LIVERS TO BE 1/2
 APPROVING LIVERS TO BE 5/4/2
 APPROVING LIVERS TO BE 5/4/2
 APPROVING LIVERS LIVERS TO BE 5/4/2
 APPROVING LIVERS LIVERS TO BE 5/4/2
 APPROVING LIVERS LIVERS

	LEGEND
XR	EXTRA RAFTER
XT	EXTRA TRUSS
DR	DOUBLE RAFTER
TR	TRIPLE RAFTER
RS	RAFTER SUPPORT
TS	TRUSS SUPPORT
CONT	CONTINUOUS
EA	EACH
00	ON CENTER
SPF	SPRUCE PINE FIR
SYP	SOUTHERN YELLOW PINE
TYP	TYPICAL
UNO	UNLESS NOTED OTHERWISE


SEAL 33736

DATE OCTOBER 2, 2024

SOUTHPORT DREAM FINDERS HOMES

NOINEERED BY: WFB

S-5b ROOF FRAMING PLAN

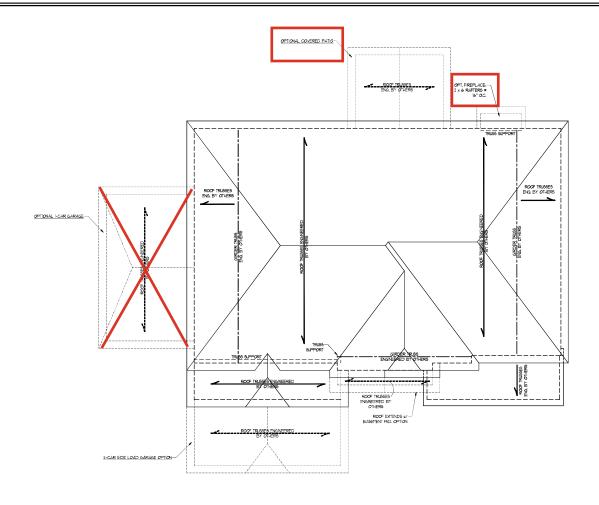

ELEVATION C




RAWN BY: JST

ENGINEERED BY: JST





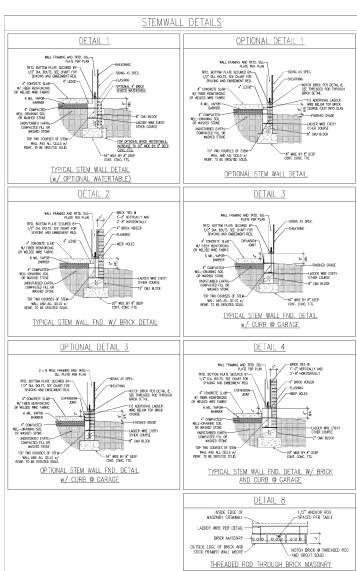

MONOLITHIC SLAB DETAILS

DETAIL 2

BRICK VENEER DETAIL

DETAIL 4

GARAGE CURB BRICK LEDGE DETAIL

DETAIL 6

STEP IN GARAGE DETAIL

TRID. BOTTOM PLATE SECURED BY— 1/2" DIA. BOLTS. SEE CHART FOR SPACING AND EMBEDMENT REQ.

4" CONCRETE SLAB

4" CONCRETE SLAB-

COMPACTED MELL-DRAINING SOIL OR WASHED STONE

UNDISTURBED EARTH, COMPACTED—
FILL OR WASHED STONE

4" CONCRETE SLAB-

W/ FIBER REINFORCING OR WELDED WIFE FABRIC

-BRICK TES 0
11-0 VERTICALLY AND
2-8 HORIZONTALLY
-C BRICK VENEER
-FLASHING
-WEEP HOLES

-5" LEDGE -FINISHE

FLASHING
FLA

DETAIL 1

TYPICAL SLAB DETAIL

DETAIL 3

-SDNG AS SPEC

CHAPTED STORE

WALL FRAMING AND TRTD. SILL— PLATE PER PLAN

GARAGE CURB DETAIL

DETAIL 5

THICKENED SLAB DETAIL

DETAIL 7

SLAB AT GARAGE DOOR DETAIL

SLOPE SLAB 1/8" PER FOOT

CARAGE DOOR JAMB ---

TRTD. BOTTOM PLATE SECURED BY-1/2" DIA. BOLTS, SEE CHART FOR SPACING AND EMBEDMENT REQ.

4" CONCRETE SLAR

6 ML VAPOR BARRER

4" COMPACTED WELL-DRAINING— SOIL OR WASHED STONE

UNDISTURBED EARTH, COMPACTED-

4" CONCRETE SLAB-W/ FIBER REINFORCING OR WELDED WIRE FABRIC

6 MIL VAPOR BARRIER 4" COMPACTED WELL-DRAINING-SOIL OR WASHED STONE

UNDISTURBED EARTH, COMPACTED— FILL OR WASHED STONE

WALL FRAMING AND TRTD. SILL— PLATE PER PLAN

4" CONCRETE SLAB-

UNDISTURBED EARTH, COMPACTED—FILL OR WASHED STONE

	MASONRY	STEMWALL SPE	CIFICATIONS			
WALL HEIGHT	MASONRY WALL TYPE					
(FEET)	8" CMU	4" BRICK AND 4" CMU	4" BRICK AND 8" CMU	12" CMU		
2 AND BELOW	UNGROUTED	GROUT SOLID	UNGROUTED	UNGROUTED		
3	UNGROUTED	GROUT SOLID	UNGROUTED	UNGROUTED		
4	GROUT SOLID GROUT SOLID w/ #4 REBAR 19 48" O.C.				GROUT SOLID	CROUT SOLID w/ #4 REBAR @ 64" O.C.
5	GROUT SOLID w/ #4 REBAR @ 36" O.C.	NOT APPLICABLE	GROUT SOLID w/ #4 REBAR @ 36" O.C.	GROUT SOLID #/ #4 REBAR @ 64" O.C.		
6	6 GROUT SOLID w/ #4 REBAR @ 24" O.C.		GROUT SOLID w/ #4 REBAR @ 24" O.C.	GROUT SOLID #/ #4 REBAR @ 64" O.C.		
7 AND CREATER	ENGINEERED DESIGN BASED ON SITE CONDITIONS					

- WALL HEIGHT MEASURED FROM TOP OF FOOTING TO TOP OF THE WALL.
 TIE MULTIPLE WYTHES TIGGTHER WITH LADDER WIFE AT 16" O.C. VERTICALLY.
 CHART APPLICABLE FOR HOUSE FOUNDATION ONLY. CONSULT ENGINEER FOR DESIGN OF GARAGE
 FOUNDATION NOT COMMON TO HOUSE.
- FOUNDATION NOT COMMON TO MOUSE. BOOKELS STORE IS ALLOWAGE. BOOKEL OF CREEK $J \neq J$ FOR MONEY STORE IS ALLOWAGE. BOOKEL OF WILL DEPARTED OR SAID GRAVE, MICTURE SOLS (46 FSF/T BELOW GRAVE) CLASSFELD AS GROUP I-ACCORDANCE WITH 1921E FEMOLI OF THE CORD WITEFAMILTON, AS EXPLAINED NOT THE CONTROL WITH 1921E FEMOLI OF THE CORD WITEFAMILTON, AS EXPLAINED NOT THE CONTROL WITH 1921E FEMOLI OF THE CORD WITEFAMILTONIAL RESIDENTIAL CODE.

- MINIMUM 24" LAP SPLICE LENGTH.
 LOCATE REBAR IN CENTER OF FOLKNATION WALL.
 WHERE REQUIRED, FILL BLOCK SOLID WITH TYPE "S" WORTAR OR 3000 PS GROUT, USE OF "LOW LIFT."
- GROUTING" METHOD REQUIRED WHEN FILLING WALLS WITH GROUT AT HEIGHTS OF 5' AND GREATER.


	ANCHOR SPACING AND	EMBEDMENT
WIND ZONE	120 MPH	130 MPH
SPACING	6"-0" O.C. INSTALL MIN. (2) ANCHORS PER PLATE SECTION AND (1) ANCHOR WITHIN 12" OF CORNERS	4'-0" O.C. INSTALL MIN. (2) ANCHORS PER PLATE SECTION AND (1) ANCHOR WITHIN 12" OF CORNERS
EMBEDMENT	7'	15" INTO MASONRY


NOTE:


Threaded rod with epoxy, simpson titen HD, or approved anchors spaced as required to provide equivalent anchorage to $1/2^\circ$ diameter anchor bolts may be used in Lieu of $1/2^\circ$ anchor bolts.



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	ANCHOR SPACING AND	NOTE:		
WIND ZONE	120 MPH	130 MPH	THREADED ROD WITH EPOXY,	
SPACING	6'-0" O.C. INSTALL MIN. (2) ANCHORS PER PLATE SECTION AND (1) ANCHOR WITHIN 12" OF CORNERS	4'-0" O.C. INSTALL MIN. (2) ANCHORS PER PLATE SECTION AND (1) ANCHOR WITHIN 12" OF CORNERS	SIMPSON TITEN HD, OR APPROVED ANCHORS SPACED AS REQUIRED T PROVIDE EQUIVALENT ANCHORAGE TO 1/2" DIAMETER ANCHOR BOLTS	
EMBEDMENT	7*	15" INTO MASONRY 7" INTO CONCRETE	MAY BE USED IN LIEU OF 1/2" ANCHOR BOLTS.	

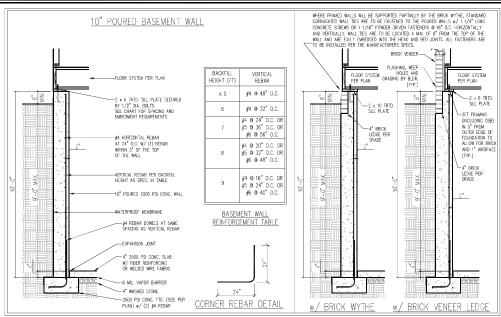IMPORTANT NOTE:

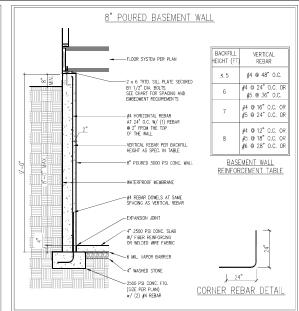FOUNDATIONS AS DENOTED IN THESE DETAILS ARE NOT SUITABLE FOR SUPPORT OF ADDITIONAL SURCHARGE LOADING FROM ADJACENT STRUCTURES OR DRIVEWAYS. FOUNDATIONS WITH EXTRA LATERAL LOADING IN THESE SCENARIOS WILL REQUIRE LOT SPECIFIC DESIGN ON A CASE BY CASE BASIS. CONSULT THE ENGINEER OF RECORD WHEN PLANNING TO BUILD IN CLOSE PROXIMITY TO THE FOUNDATION AS WE WILL NOT BE HELD LIABLE FOR FOUNDATION FAILURE. SEE R403.1.9 OF THE 2018 NCRC FOR ADDITIONAL INFORMATION.

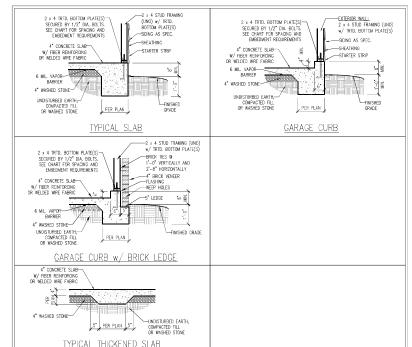STRUCTURAL NOTES:

- FOR #4 REBAR, 24" MINIMUM REBAR LAP SPLICE LENGTH, FOR #5 REBAR, 32" MINIMUM REBAR LAP SPLICE


- PLACED IN 12" LIFT'S AND CAREFULLY TAMPED.

 4 "LEDGE IS TO BE PROVIDED FOR THE PORCH SLAB. THE WALLS ARE REQUIRED TO BE BONDED TO THE SLABS USING 4" LA" BEFARE DOUBLES 22" O.C. EMBEDDED 4" INTO THE COVIC, USING PROVY, WHERE THE FLOOR JUSTS ARE PARALLEL TO THE WALLS, 2 x 4 BLOCKING IS TO BE INSTALLED 24" O.C.
- BETWEEN THE BOTTOM FLANGES OF THE I-JOISTS FOR A MIN OF 6-0" AWAY FROM THE WALL OF DIAGONAL 2 x 6 BLOCKS MAY BE INSTALLED 24" O.C. FROM THE EDGE OF THE SILL PLATE TO THE TOP FLANGE AND SUBFLOORING, ATTACHED W/ (3) 12d NAILS EACH END.

NOTE TO FOUNDATION CONTRACTOR:

ALTERNATE REINFORCED CONCRETE POURED WALL DESIGNS ENGINEERED BY OTHERS MAY BE CONSTRUCTED. NO CONTINUOUS FOOTINGS OR LUG FOOTINGS MAY BE REDUCED IN SIZE

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NCT OF THE PROPERTY OF THE PRO S HOMPS

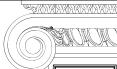FERING

KROAD, SUTE 180 RALE

ROAD STATE 180 RALE

KOLUCKSE NO. CITTAL

KOLUCKSE NO. CITTAL S. TE

> 130 MPH ULTIMATE DESIGN WIND SPEED WALL BASEMENT FOUNDATION DETAILS DREAM FINDERS HOMES 120 MPH - POURED

DATE: NOVEMBER 29, 2022

RAWN BY: JST ENGINEERED BY: JST

SEAL 33736

10/3/2024

FOUNDATION DETAILS D-3

TE: NOVEMBER 28, 2022

OWNEERED BY IST

D-2 BRACED WALL NOTES AND DETAILS AND PF DETAIL

GENERAL WALL BRACING NOTES:

I MALL BRACING DESIGNED IN ACCORDANCE WITH CHAPTER 6 OF THE 2018 NOT RESIGNATION AS NETBER.

AS PRINCES SETTERANCO ARE FROM THE 2018 NOTE.

SEE THIS SETTERANCO ARE FROM THE 2018 NOTE.

SEE THIS SETTERANCO ARE FROM THE 2018 NOTE.

SEE THIS SETTER CRIENTAL DEFENS. SETTER TO THE 2018 NOTE OF ACCORDANCE NOTIONAL NOTIONAL NOT AS NETBER.

3. SPACED ECTEROR WALLS SEPPORTION FROM THE 2018 NOTE OF ACCOUNTING STORES EDUCY THE TOP FLOOR, HAVE BEEN DESCRIPTED THE ROCKES IN ACCORDANCE WITH ACCOPTED ENMORTED PARAMETER. PAGE EDIT DESCRIPTED TO RESIST CONTROL UNITS OF ACCORDANCE WITH ACCOPTED ENMORTED PARAMETER.

WITH WALL DESIGN SAMANEY OF SCRIPTION FROM THE ACCORDANCE WITH SECTION ROCKES. SPACED WILL LIKE KEY WITH WALL DESIGN SAMANEY OF SCRIPTION FROM THE ACCORDANCE WITH SECTION ROCKES.

5. ALL EXTERIOR MALLS ARE TO BE SHEAR THE WIND CS-MEP IN ACCORDANCE WITH SECTION ROCKES. OF SOSIAL DISCUSSION OF THE ACCORDANCE WITH SECTION ROCKES.

6. ALL EXTERIOR MALLS ARE TO BE SHEAR THE WIND CS-MEP IN ACCORDANCE WITH SECTION ROCKES. OF SOSIAL DISCUSSION OF THE CONTROL OF HEAT THE ACCORDANCE WITH SECTION ROCKES.


5. CHEFFER TO THE CONTROLOGE TO BE FASTEDED PRIT THEE ROCKES.


5. CHEFFER TO THE TO POSTAID BOOKES WILL BROCK METHOD. 1/2 (MALL) PAGE MALL STREED OR BOTH STATES OF THE STREET OR TO STREET THE ACCORDANCE STREET STATES OF THE STREET OR TO ROTH SOCKES OF THE BRACED WALL FASTED WITH THE SOCKES OR 1.5% NAILS SPACED TO CA. ADMORPHICE DOES INCLINED FOR AND BOTH ACLTS AND THE TOPICAL DISCUSSION SEED AS PROCEDED TO CARDON PLATES AND THE STREET OF STREET SHAPE SHOULD SEE THE RESIDE OF THE STREET OF THE STREET OF THE STREET SHAPE SHOULD.

SOOTAL). ECTENIO GE TO BE INSTALLED VERDIOALY.

SOURCE DISACTOR MULTICATE TO GET ONE SECTION OF CONTINUES ARE INTERPOLATED FOR TABLE REGO. 10.3.


METHOD CS-MEP CONTRIBUTES ITS ACTUAL, LEWISH, METHOD GE CONTRIBUTES 5. ITS ACTUAL LEWISH, AND METHOD FOR CONTRIBUTES 5. THEM IS ACTUAL LEWISH.

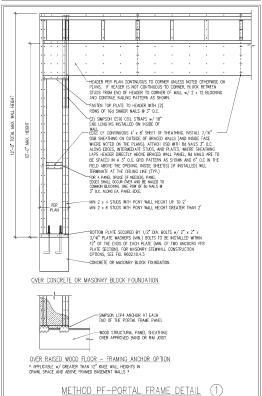


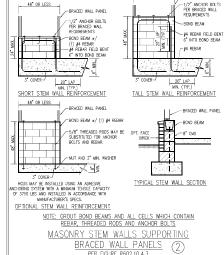

48° OR LESS __

-BRACED WALL PANEL

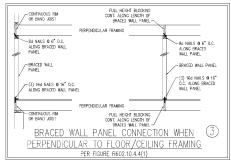

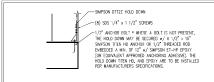


HOLD DOWN DETAIL FOR MASONRY FOUNDATION OR MONOLITHIC SLAB * APPLICABLE ONLY WHERE SPECIFIED ON PLAN *


CONTINUOUS WOOD

BRACED WALL LINE -

(c) GARAGE DOOR CORNER DETAIL (SEE PLAN FOR ADDITIONAL

STRUCTURAL INFORMATION OR ALTERNATE CONFIGURATIONS)

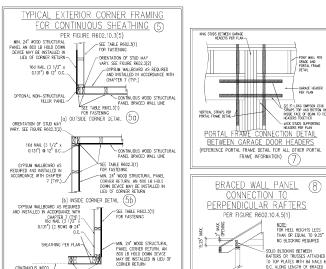

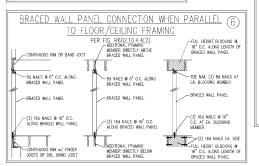



TO TOP PLATES WITH 8d NAILS 6

O.C. ALONG LENGTH OF BRACED WALL PANEL



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Statune § 89C23

ATE: JUNE 17, 2022

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S-0 STRUCTURAL NOTES

GENERAL NOTES

- 1. ENGINEER'S SEAL APPLIES ONLY TO STRUCTURAL COMPONENTS INCLUDING ROOF RAFTERS, HIPS, VALLEYS, RIDGES, FLOORS, WALLS, BEAMS, HEADERS, COLUMNS, CANTILEVERS, OFFSET LOAD BEARING WALLS, PIERS, GIRDER SYSTEM AND FOOTING. ENGINEER'S SEAL DOES NOT CERTIFY DIMENSIONAL ACCURACY OF ARCHITECTURAL LAYOUT INCLUDING ROOF. ENGINEER'S SEAL DOES NOT APPLY TO 1-JOIST OR FLOOR/ROOF TRUSS LAYOUT DESIGN AND
- 2. ALL CONSTRUCTION SHALL CONFORM TO THE LATEST REQUIREMENTS OF THE NORTH CARQUINA RESIDENTIAL CODE (NORC), 2018 EDITION, PLUS ALL LOCAL CODES AND REQULATIONS. THE STRUCTURAL ENGINEER IS NOT RESPONSIBLE FOR, AND WILL NOT HAVE CONTROL OF, CONSTRUCTION MEANS, METHODS, TECHNOLISS, SEQUENCES OR PROCEDURES A SHETTY PRECAUTIONS AND PROCEASES IN CONNECTION WITH THE CONSTRUCTION WORK. MACROCHARGE PROCESSES AND A SHEET PROCESSES.
- 3. STRUCTURAL DESIGN BASED ON THE PROVISIONS OF THE NORC, 2018 EDITION (R301.4 R301.7)

DESIGN CRITERIA:	LIVE LOAD (PSF)	DEAD LOAD (PSF)	DEFLECTION (IN)
ATTIC WITH LIMITED STORAGE	20	10	L/240 (L/360 w/ BRITTLE FINISHES)
ATTIC WITHOUT STORAGE	10	10	L/360
DECKS	40	10	L/360
EXTERIOR BALCONIES	40	10	L/360
FIRE ESCAPES	40	10	L/360
HANDRAILS/GUARDRAILS	200	10	L/360
PASSENGER VEHICLE GARAGE	50	10	L/360
ROOMS OTHER THAN SLEEPING ROOM	40	10	L/360
SLEEPING ROOMS	30	10	L/360
STAIRS	40	10	L/360
WIND LOAD	(BASED ON TABLE R301,	2(4) WIND ZONE AND EXPOSURE)	
GROUND SNOW LOAD: Pa	20 (PSF)	.,	

- JOIST SYSTEMS DESIGNED WITH 12 PSF DEAD LOAD AND DEFLECTION (IN) OF L/480
- 4. FOR 115 AND 120 MPH WIND ZONES, FOUNDATION ANCHORAGE IS TO COMPLY WITH SECTION R403.1.6 OF THE NORC, 2018 EDITION. FOR 130 MPH, 140 MPH, AND 150 MPH WIND ZONES, FOUNDATION ANCHORAGE IS TO COMPLY WITH SECTION 4504 OF THE NCRC, 2018 EDITION.
- 5. ENERGY FERGENCY COMPLIANCE AND INSULATION VALUES OF THE BUILDING TO BE IN ACCORDANCE WITH CHAPTER 11 OF THE NORC 2018 EDITION

FOOTING AND FOUNDATION NOTES

- 1. FOUNDATION DESIGN BASED ON A MINIMUM ALLOWABLE BEARING CAPACITY OF 2000 PSF. CONTACT GEOTECHNICAL ENGINEER IF BEARING CAPACITY IS NOT ACHIEVED.
- 2. FOR ALL CONCERT IS ABS AND FOOTINGS, THE AREA WITHIN THE PREDICTER OF THE BUILDING ENVELOPE SHALL HAVE ALL VIGETATION, TOP SOIL AND FOREIGN MATTERNAL PRODUCTS. THE VARIANCE HALL BE FORE OF FEETINGS AND FOREIGN MATERIAL THE FILL SHALL BE COMPACIED TO ASSERT THIS ASSERT AND CONCESSION OF GLAN OFFICIAL BETWEEN THE FILL SHALL BE COMPACIED AND ASSERT AND ASSERT AND CONCESSION OF GLAN OFFICIAL BETWEEN AND ASSERT AND ASSERT AND ASSERT ASSET AND ASSERT ASSET AND ASSERT ASSET AND ASSET ASSET
- 3. PROPERLY DEWATER EXCAVATION PRIOR TO POURING CONCRETE WHEN BOTTOM OF CONCRETE SLAB IS AT OR BELOW WATER TABLE. IF APPLICABLE, 1° DEEP CONTROL JOINTS ARE TO BE SAWED WITHIN 4 TO 12 HOURS OF CONCRETE FINISHING AND WALL LOCATIONS HAVE BEEN MARKED 3/4" - 1" DEEP CONTROL ADJUST WHERE NECESSARY.
- 4. CONCRETE SHALL CONFORM TO SECTION R402.2 OF THE NORG, 2018 EDITION. CONCRETE REINFORCING STEEL TO BE ASTM A615 GRADE 60. WELDED CONTROL OF THE WAS ASSOCIATED AND A CONTROL OF THE WAS ASSOCIATED
- 5. MASONRY UNITS TO CONFORM TO ACE 530/ASCE 5/TMS 402. MORTAR SHALL CONFORM TO ASTM C270.
- 6. THE UNSUPPORTED HEIGHT OF MASONRY PIERS SHALL NOT EXCEED FOUR TIMES THEIR LEAST IMMERSON FOR UNFILLED HOLLOW CONCRETE MASONRY UNITS AND THE TIMES THERE LEAST IMMERSON FOR SOLID OR SOLID RESD FILED FIELS FEES WAY ER ELLED SOLID WITH CONCRETE OR TYPE M OR S MORTAR. PIERS AND WALLS SHALL BE CAPPED WITH 8" OF SOLID MASONRY
- THE CENTER OF EACH OF THE PIERS SHALL BEAR IN THE MIDDLE THIRD OF ITS RESPECTIVE FOOTING, EACH GROER SHALL BEAR IN THE MIDDLE THIRD OF THE PIERS.
- 8. ALL CONCRETE AND MASSINRY FOUNDATION WALLS ARE TO BE CONSTRUCTED IN ACCORDANCE WITH THE PROVISIONS OF SECTION RIGHD OF THE MORE, 2018 EDITION OF IN ACCORDANCE WITH ACID SIA, DAI, 20, MORE TREPA OR CE \$53/ASC \$5, TANS \$5, TANS \$42, MASSINRY TOWNSHOW MISS. ARE TO BE REMOVERED PER TABLE REVALUE), REMOVED, 103, FOR REMOVED OF THE MORE, 2018 BERTON, CONCRETE FORMATION, AND ALL TO BE REMOVED FOR THE TABLE. R404.1.1(5) OF THE NORC, 2018 EDITION. STEP CONCRETE FOUNDATION WALLS TO 2 x 6 FRAMED WALLS AT 16" O.C. WHERE CRADE PERMITS (UNO).

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- FRAMING NOTES 1. ALL FRAMING LUMBER SHALL BE #2 SPF MINIMUM (Fb = 875 PSI, Fv = 375 PSI, E = 1600000 PSI) UNLESS NOTED OTHERWISE (UNO). ALL TREATED LUMBER SHALL BE 42 SYP MINIMUM (Fb = 975 PSI, Fv =175 PSI, E = 1600000 PSI) UNLESS NOTED OTHERWISE (UNO).
- 2. LAMINATED VENEER LUMBER (LVL) SHALL HAVE THE FOLLOWING MINIMUM PROPERTIES: Fb =2600 PSI, Fv = 285 PSI, E = 1900000 PSI, LAMINATED STRAND LUMBER (LSL) SHALL HAVE THE FOLLOWING MINIMUM PROPERTIES: Fb = 2325 PSI, Fv = 310 PSI, E = 1550000 PSI. PARALLEL STRAND HUMBER (PSI) UP TO 7" DEPTH SHALL HAVE THE FOLLOWING MINIMUM PROPERTIES: Fo. = 2500 PSI. F.=1800000 PSI. PARALLEL STRAND LIMBER (PSL) MORE THAN 7" DEPTH SHALL HAVE THE FOLLOWING MINIMUM PROPERTIES: Fo = 2900 PSL, E = 2000000 PSL. INSTALL ALL CONNECTIONS
- 3. STRUCTURAL STEEL SHALL CONFORM TO THE FOLLOWING ASTM SPECIFICATIONS

A.	W AND WT SHAPES:	ASTM	A992
В.	CHANNELS AND ANGLES:	ASTM	A36
C.	PLATES AND BARS:	ASTM	A36
D.	HOLLOW STRUCTURAL SECTIONS:	ASTM	A500 GRADE B
E.	STEEL PIPE:	ASTM	A53, GRADE B. TYPE E OR S

4. STEEL BEAMS SHALL BE SUPPORTED AT EACH END WITH A MINIMUM BEARING LENGTH OF 3 1/2" AND FULL FLANGE WIDTH (UNO). PROVIDE SOLID BEARING FROM BEAM SUPPORT TO FOUNDATION, BEAMS SHALL BE ATTACHED AT THE BOTTOM FLANGE TO EACH SUPPORT AS FOLLOWS (UNC):

B. CONCRETE (2) 1/2" DIA. x 4" WEDGE ANCHORS (2) 1/2" DIA. x 4" LONG SIMPSON TITEN HD ANCHORS (4) 3/4" DIA. A325 BOLTS OR 3/16" FILLET WELD C. MASONRY (FULLY GROUTED) D. STEEL PIPE COLUMN

LATERAL SUPPORT IS CONSIDERED ADEQUATE PROVIDING THE JOISTS ARE TOE NAILED TO THE 2x NAILER ON TOP OF THE STEEL BEAM, AND THE 2x NAILER IS SECURED TO THE TOP OF THE STEEL BEAM w/(2) ROWS OF SELF TAPPING SCREWS 0 16" O.C. OR (2) ROWS OF 1/2" DIAMETER BOLTS 0 16" O.C. IF 1/2" BOLTS ARE USED TO FASTEN THE NAILER, THE STEEL BEAM SHALL BE FABRICATED w/(2) ROWS OF 9/16" DIAMETER HOLES 0

- 5. SQUARES DENOTE POINT LOADS WHICH REQUIRE SOLID BLOCKING TO GROER OR FOUNDATION, SHADED SQUARES DENOTE POINT LOADS FROM ABOVE WHICH REQUIRE SOLID BLOCKING TO SUPPORTING MEMBER BELOW.
- 6. ALL LOAD BEARING HEADERS TO CONFORM TO TABLE R602.7(1) AND R602.7(2) OF THE NCRC, 2018 EDITION OR BE (2) 2 x 6 WITH (1) JACK AND (1) KING STUD EACH END (UND), WHICHEVER IS GREATER ALL HEADERS TO BE SECURED TO EACH JACK STUD WITH (4) 8d NAILS. ALL BEAMS TO E SUPPORTED WITH (2) STUDS AT EACH BEARING POINT (UNO). INSTALL KING STUDS PER SECTION R602.7.5 OF THE NORTH CAROLINA
- 7. ALL BEAMS, HEADERS, OR GIRDER TRUSSES PARALLEL TO WALL ARE TO BEAR FULLY ON (1) JACK OR (2) STUDS MINIMUM OR THE NUMBER OF JACKS OR STUDS NOTED. ALL BEAMS OR GROER TRUSSES PERPENDICULAR TO WALL AND SUPPORTED BY (3) STUDS OR LESS ARE TO HAVE 1 $1/2^n$ minimum bearing (und). All beams or groer trusses perpendicular to wall and supported by more than (3) studs or other NOTED COLUMN ARE TO BEAR FULLY ON SUPPORT COLUMN FOR ENTIRE WALL DEPTH (UNO). BEAM ENDS THAT BUTT INTO ONE ANOTHER ARE TO
- 8. FUTCH BEAMS SHALL BE BOLTED TOGETHER USING 1/2" DIAMETER BOLTS (ASTM A307) WITH WASHERS PLACED AT THREADED END OF BOLT. BOLTS SHALL BE SPACED AT 24" CENTERS (MAXIMUM), AND STAGGERED AT TOP AND BOTTOM OF BEAM (2" EDGE DISTANCE), WITH (2) BOLTS LOCATED AT
- ALL I—JOIST OR TRUSS LAYOUTS ARE TO BE IN COMPLIANCE WITH THE OVERALL DESIGN SPECIFIED ON THE PLANS. ALL DEMATIONS ARE TO BE BROUGHT TO THE ATTENTION OF THE ENGINEER OF RECORD PRIOR TO INSTALLATION.
- 10. BRACED WALL PANELS SHALL BE CONSTRUCTED ACCORDING TO THE NORTH CAROLINA RESIDENTIAL CODE 2018 EDITION WALL BRACING CRITERIA. THE AMOUNT, LENGTH, AND LOCATION OF BRACING SHALL COMPLY WITH ALL APPLICABLE TABLES IN SECTION R602.10.
- 11. PROMOE DOUBLE JOIST LINDER ALL WALLS PARALLEL TO ELOOR JOISTS. PROMOE SUPPORT LINDER ALL WALLS PARALLEL TO ELOOR TRUSSES OR ISTS PER MANUFACTURER'S SPECIFICATIONS. INSTALL BLOCKING BETWEEN JOISTS OR TRUSSES FOR POINT LOAD SUPPORT FOR ALL POINT LOADS ALONG OFFSET LOAD LINES.
- 12. FOR ALL HEADERS SUPPORTING BRICK VENEER THAT ARE LESS THAN 8'-0" IN LENGTH BEST A 6" x 4" x 5/16" STEEL AND E WITH 6" MINIMUM THE MEDICAL PROJECT STATE AND STATE VALUE AND THE STATE OF THE MEDICAL PROJECT AND STATE AND STA STEEL ANGLE TO (2) 2 x 10 BLOCKING INSTALLED w/ (4) 128 HALLS EA. PLY BETWEEN WALL STUDS WITH (2) ROWS OF 1/2" LAG SCREWS AT 12" O.C. STAGGERED AND IN ACCORDANCE WITH SECTION R703.8.2.1 OF THE NCRC, 2018 EDITION.
- 13. FOR STICK FRAMED ROOFS: CIRCLES DENOTE (3) 2 x 4 POSTS FOR ROOF MEMBER SUPPORT. HIP SPLICES ARE TO BE SPACED A MINIMUM OF 8-0". FASTEN MEMBERS WITH THREE ROWS OF 12d NAILS AT 16" O.C. FRAME DORMER WALLS ON TOP OF DOUBLE OR TRIPLE RAFTERS AS SHOWN
- 14. FOR TRUSSED ROOFS: FRAME DORMER WALLS ON TOP OF 2 x 4 LADDER FRAMING AT 24" O.C. BETWEEN ADJACENT ROOF TRUSSES. STICK FRAME OVER-FRAMED ROOF SECTIONS WITH 2 x 8 RIDGES 2 x 6 RAFTERS AT 16" O.C. AND FLAT 2 x 10 VALLEYS (LIND)
- ALL 4×4 and 6×6 Posts to be installed with 700 LB capacity upuft connectors for and bottom (uno.) Posts may be secured using one simpson h6 or lts12 uplift connector fastened to the band at the bottom and the beam at the top of each post. One 16" SECTION OF SIMPSON CS16 COIL STRAPPING WITH (8) 8d HDG NAILS AT EACH END MAY BE USED IN LIEU OF EACH TWIST STRAP IF DESIRED. FOR MASONRY OR CONCRETE FOUNDATION USE SIMPSON POST BASE.

