Residence for

Gammon Construction The Armstrong - Delude Residence Lot 18, Harnett County North Carolina

INDEX TO DRAWINGS:

COVER SHEET

FRONT ELEVATION LEFT SIDE ELEVATION RIGHT SIDE ELEVATION REAR ELEVATION FIRST FLOOR PLAN SECOND FLOOR PLAN FIRST FLOOR ELECTRICAL PLAN

ROOF PLAN

D1

CRAWL SPACE FOUNDATION PLAN **S1** S2 CRAWL SPACE FRAMING PLAN **S3** FIRST FLOOR CEILING FRAMING PLAN **S4** SECOND FLOOR CEILING FRAMING PLAN **S5** ROOF FRAMING PLAN SD1 STRUCTURAL DETAILS & SPECIFICATIONS

GENERAL NOTES:

SECOND FLOOR ELECTRICAL PLAN

CONSTRUCTION DETAILS

- ALL WORK IS TO BE DONE IN STRICT ACCORDANCE WITH NORTH CAROLINA STATE RESIDENTIAL BUILDING CODE, 2018 EDITION (HEREWITH SHOWN AS N.C.S.R.B.C.).
- 2. DIMENSIONS SHOWN ON DRAWINGS GOVERN OVER SCALE..
- STUD WALL DESIGN SHALL CONFORM TO ALL N.C.S.R.B.C. REQUIREMENTS.
- CONTRACTOR SHALL USE TEMPERED SAFETY GLASS IN ALL LOCATIONS AS REQUIRED BY N.C.S.R.B.C., SECTION R308.4
- ANY HABITABLE ROOM SHALL MEET ALL LIGHT/VENTILATION AND EGRESS AS REQUIRED BY N.C.S.R.B.C., SECTIONS R-303.1 AND R-310.1
- ALL WALLS SHOWN ON FLOOR PLANS ARE 2x4 FRAME UNLESS NOTED OTHERWISE.
- ALL ANGLED WALLS SHOWN ON FLOOR PLANS ARE 45° UNLESS NOTED
- ALL WINDOWS SHALL HAVE A MINIMUM DPI RATING OF 25. BUILDER SHALL VERIFY WITH WINDOW MANUFACTURER THAT UNITS INSTALLED MEET THESE REQUIREMENTS AS PER N.C.S.R.B.C., TABLE 301.2(6).
- ENERGY EFFICIENCY REQUIREMENTS FOR THE SPECIFIC CLIMATE ZONE WHERE STRUCTURE IS BEING BUILT SHALL BE IN ACCORDANCE WITH CHAPTER II OF THE NORTH CAROLINA RESIDENTIAL BUILDING CODE, AS SHOWN IN TABLES NIIOL2 AND NIIO2.I.
- 10. TERMITE TREATMENT BORATE APPLIED TO ALL FRAME MEMBERS WITHIN 24" AFF.

MATERIALS LEGEND

EARTH/COMPACT FILL	FINISH WOOD
CONCRETE	ROUGH MOOD
BRICK	BLOCKING
CONCRETE BLOCK/STONE	PLYWOOD
STEEL	BATT INSULATION
ALUMINUM	RIGID INSULATION

TOILET ACCESSORIES LEGEND

PROVIDE 2×4 BLOCKING IN THE WALL FOR THE FOLLOWING:

TOWEL BAR TOILET PAPER HOLDER TOWEL RING

MEDICINE CABINET MAGAZINE RACK

THE PURPOSE OF THESE DRAWINGS IS TO SHOW THE INTENT OF THE DESIGN AND CONSTRUCTION OF THIS HOME. ANY ERRORS AND/OR OMISSIONS FOUND IN THIS SET SHOULD IMMEDIATELY BE REPORTED TO HOMES UNIQUE FOR CLARIFICATION OR CORRECTION. THE CONTRACTOR SHOULD VERIFY ALL CONDITIONS AND DIMENSIONS <u>PRIOR</u> TO CONSTRUCTION. ONCE A PERMIT HAS BEEN ISSUED FOR CONSTRUCTION, THE CONTRACTOR SHALL ASSUME ALL

MADE BY THE CONTRACTOR AND/OR THE OWNER. DUE TO VARYING LOCAL AND STATE CODES, HOMES UNIQUE CANNOT BE HELD RESPONSIBLE FOR ANY REQUIREMENTS THAT EXISTING SITE CONDITIONS

RESPONSIBILITY AS TO THE ACCURACY OF THE PLANS AND TO ANY CHANGES

RESIDENTIAL BUILDING CODE SUMMARY

- PLANS ARE DESIGNED TO THE 2018 NORTH CAROLINA RESIDENTIAL BUILDING CODE.
- 2. HOUSE IS DESIGNED FOR 130 MPH, 3 SECOND GUST (IOI MPH FASTEST WIND), EXPOSURE B.
- 3. ANCHOR BOLTS SHALL BE MIN. 1/2" DIAMETER WITH STANDARD WASHER AND NUT AND SHALL EXTEND 7" MIN. INTO MASONRY OR CONCRETE. BOLTS TO BE NO MORE THAN 6' O.C. AND WITHIN 12" OF CORNERS. ALTERNATE ANCHOR STRAPS CAN BE USED INSTEAD OF ANCHOR BOLTS SPACED AT THE EQUIVALENT SPACING AND INSTALLED PER MANUFACTURER'S SPECIFICATION'S EXCEPT AT GARAGE LUG FTG.
- 4. MEAN ROOF HEIGHT: 26'-10"

ZONE 5

- 5. COMPONENT & CLADDING DESIGNED FOR THE FOLLOWING LOADS: MEAN ROOF HGT: UP TO 30' 30'-1"TO 35' 35'-1"TO 40' 40'-1"TO 45' 16.5, -18.0 17.3, -18.9 18.0, -19.6 16.5, -21.0 17.3, -22.1 18.0, -22.9 18.5, -23.5 ZONE 3 16.5, -21.0 17.3, -22.1 ZONE 4 18.0, -19.5 18.9, -20.5 19.6, -21.3 20.2, -21.8
- 6. MINIMUM VALUES FOR ENERGY COMPLIANCE:
- 7. MAXIMUM GLAZING U-FACTOR: 0.35
- 8. INSULATING VALUES: CEILING: R-30* / WALLS: R-15 / FLOOR: R-19 / SLABS: R-O. CODE REFERENCE: TABLE NIIO2.I (*R-30 ONLY IF UNCOMPRESSED, R-38 REQUIRED IF COMPRESSED)

18.0, -24.1 18.9, -25.3 19.6, -26.3 20.2, -27.0

- 9. FLASHING SHALL BE INSTALLED IN ACCORDANCE WITH SECTION R703.8 OF THE N.C.R.B.C.
- IO. FIREBLOCKING SHALL BE INSTALLED IN ACCORDANCE WITH SECTION R602.8 OF THE N.C.R.B.C.
- DRAFTSTOPPING SHALL BE INSTALLED IN ACCORDANCE WITH SECTION R302.12 OF THE N.C.R.B.C.

AREA CALCULATIONS

<u> </u>		LOULATION	
HEATE	D:	UNHEATED	:
IST FLOOR:	1063	GARAGE:	504
2ND FLOOR:	1413	FRONT PORCH:	ાાઠ
REC ROOM:	0	REAR DECK:	144
TOTAL:	2476	TOTAL:	766
MIDTH:	40'-0"		
DEPTH:	55'-4"		

FOUNDATION VENTING CALCULATIONS

(REFERENCE: N.C.S.R.B.C., 2018 EDITION, SECTION R408) THE MINIMUM NET AREA OF VENTILATION OPENINGS SHALL BE NOT LESS THAN ONE (1) SQUARE FOOT FOR EACH 150 SQUARE FEET OF CRAWL SPACE GROUND AREA AND ONE FOUNDATION VENT SHALL BE WITHIN THREE (3) FEET OF EACH CORNER OF THE

EXCEPTION: THE TOTAL AREA OF VENTILATION OPENINGS MAY BE REDUCED TO 1/1500 OF THE UNDER-FLOOR AREA WHERE THE SROUND SURFACE IS TREATED WITH AN APPROVED VAPOR RETARDER MATERIAL AND THE REQUIRED OPENINGS ARE PLACED SO AS TO PROVIDE CROSS-VENTILATION.

> 1063 SQUARE FEET OF CRAWL SPACE AREA / 150 = 7.09 SQUARE FEET OF NET FREE AREA REQUIRED

ATTIC VENTILATION REQUIREMENTS


	NATURAL ROOF VENTILATION
85	5Q. FT.
	= 11.23 SQ. FT. VENT REQ'D.

1685 SQ. FT. -= 5.62 SQ. FT. VENT REQ'D.

MECHANICAL ROOF VENTILATOR

BUILDER TO PROVIDE APPROPRIATE VENTILATING AS REQUIRED PER CODE



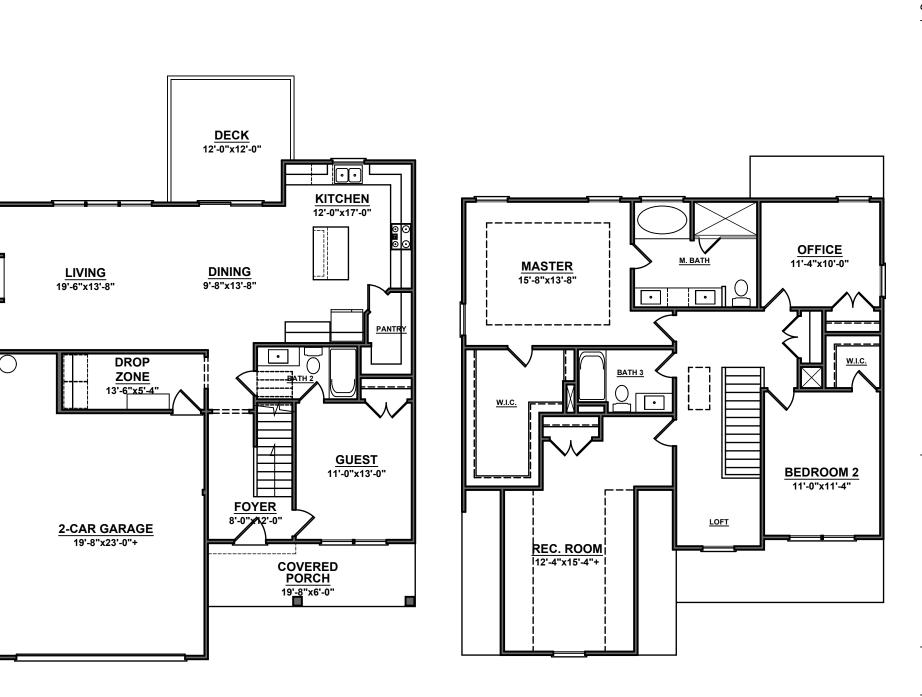



1027 Hwy 70 West Suite 223

Garner, NC 27529 919-779-6005

www.homesunique.com

This document is the property of HOMES UNIQUE, INC. and may be used for above titled project. All rights reserved and protected under federal law Copyright © 2024

The purpose of these drawings is to show the intent of the design and construction of this home. Contractor should verifu all conditions and dimensions prior to construction. Once a permit has been issued contractor shall assume all responsibility to the accuracy of the plans and any changes made during construction.

Construction ammon

O

PROJECT NUMBER: 6633 DRAWN BY: J.A.D.

CHECKED BY: J.T.S. REVISIONS:

DATE: 9/18/2024



NOTE - SLOPE ALL GRADES AWAY FROM HOUSE FOR POSITIVE DRAINAGE



1027 Hwy 70 West Suite 223 Garner, NC 27529 919-779-6005

www.homesunique.com

This document is the property of HOMES UNIQUE, INC. and may be used for above titled project. All rights reserved and protected under federal law. Copyright © 2024

The purpose of these drawings is to show the intent of the design and construction of this home. Contractor should verify all conditions and dimensions prior to construction. Once a permit has been issued, contractor shall assume all responsibility to the accuracy of the plans and any changes made during construction.

Gammon Construction The Armstrong

Delude Residence 18, Harnett County NC

PROJECT INFO:

Elevations


PROJECT NUMBER:
6633
DRAWN BY:

J.A.D.

CHECKED BY:

J.T.S.
REVISIONS:

DATE: 9/18/2024

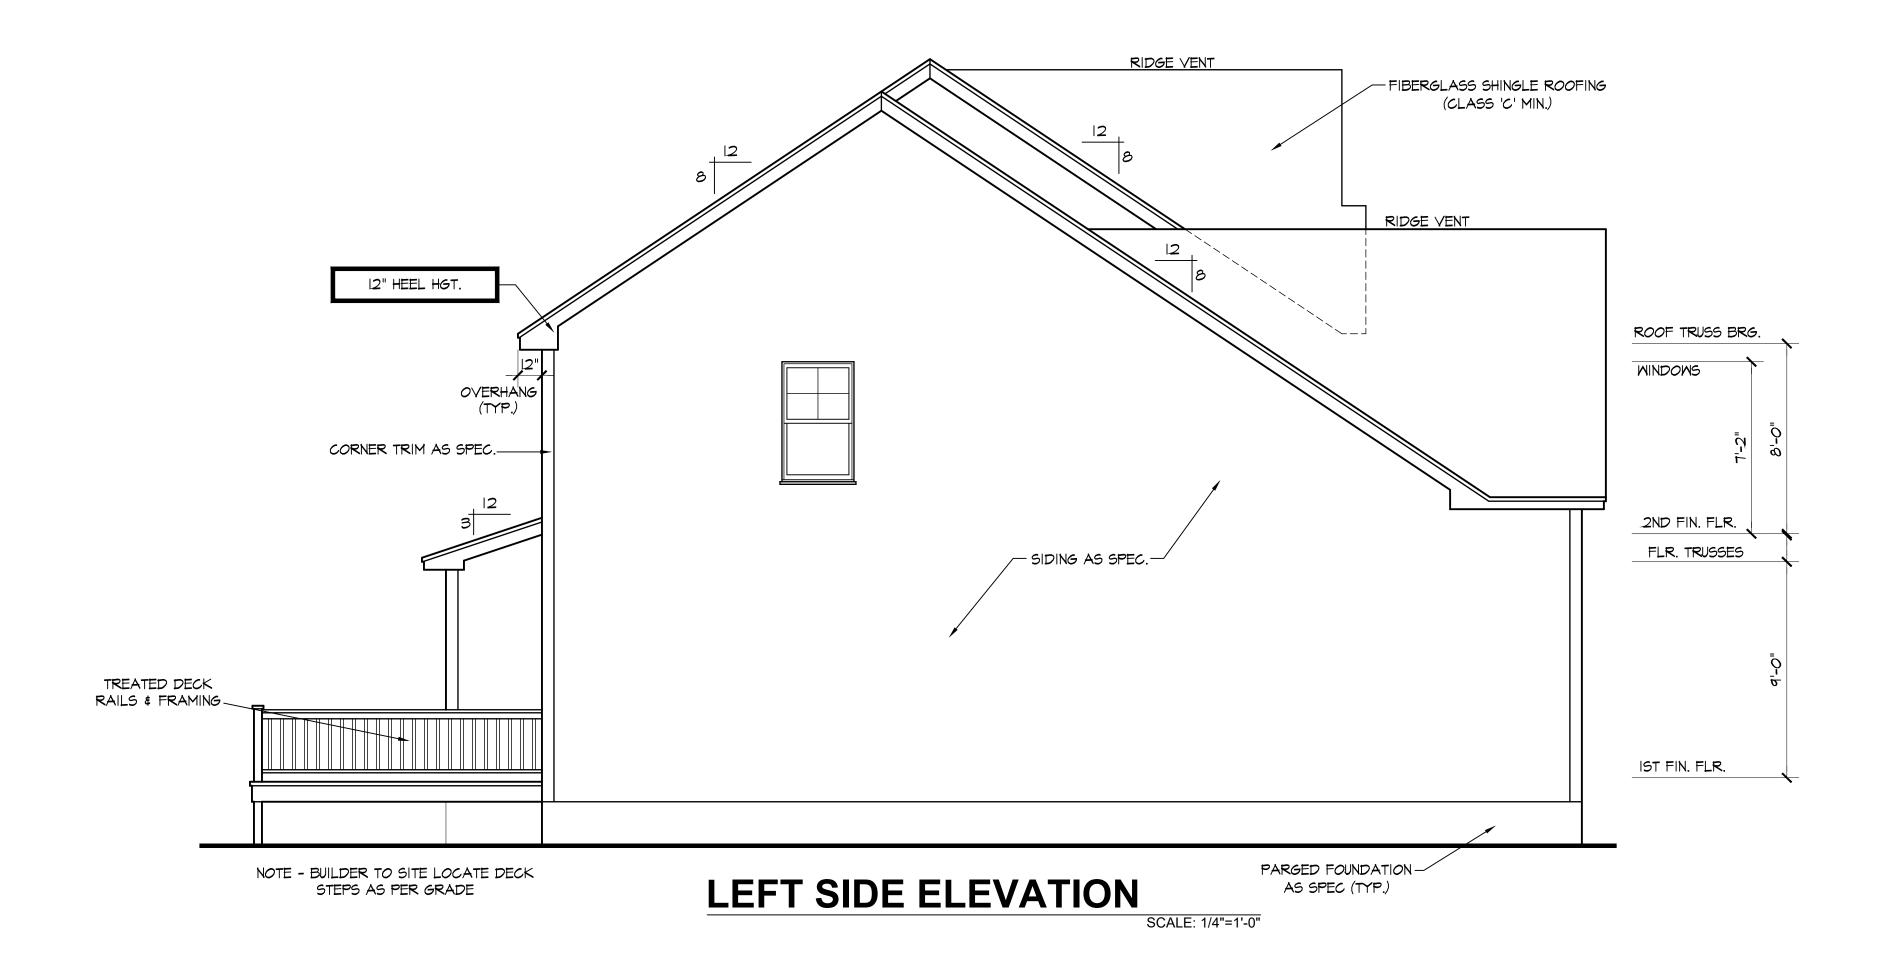



1027 Hwy 70 West Suite 223 Garner, NC 27529 919-779-6005

www.homesunique.com

This document is the property of HOMES UNIQUE, INC. and may be used for above titled project. All rights reserved and protected under federal law. Copyright © 2024

The purpose of these drawings is to show the intent of the design and construction of this home. Contractor should verify all conditions and dimensions prior to construction. Once a permit has been issued, contractor shall assume all responsibility to the accuracy of the plans and any changes made during construction.

non Construction The Armstrong

18, Harnett County NC

Delude Residence

ROJECT INFO:

Gammon

Elevations

PROJECT NUMBER: 6633


DRAWN BY:

J.A.D.

CHECKED BY

CHECKED BY:
J.T.S.
REVISIONS:

DATE: 9/18/2024

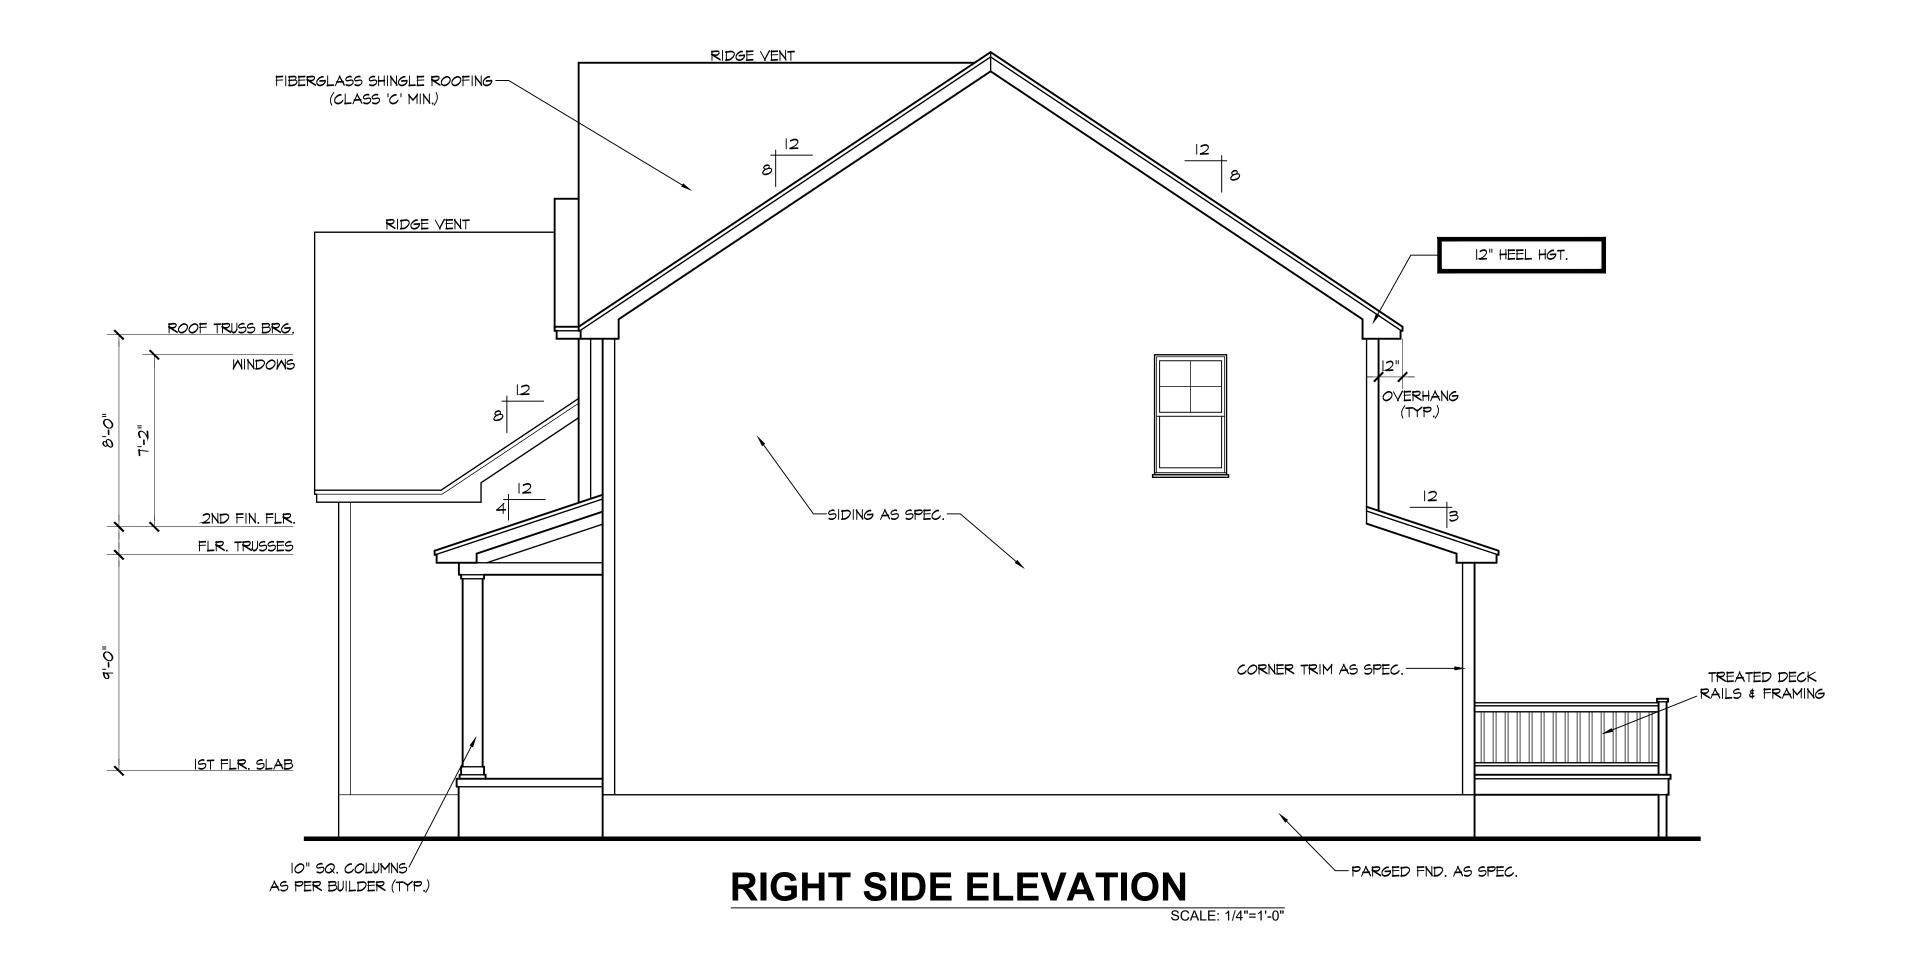



1027 Hwy 70 West Suite 223 Garner, NC 27529 919-779-6005

www.homesunique.com

This document is the property of HOMES UNIQUE, INC. and may be used for above titled project. All rights reserved and protected under federal law. Copyright © 2024

The purpose of these drawings is to show the intent of the design and construction of this home. Contractor should verify all conditions and dimensions prior to construction. Once a permit has been issued, contractor shall assume all responsibility to the accuracy of the plans and any changes made during construction.

non Construction The Armstrong

18, Harnett County NC

Delude Residence

ROJECT INFO: Gammon

Elevations

PROJECT NUMBER:
6633
DRAWN BY:


J.A.D.

CHECKED BY:

J.T.S.

REVISIONS:

DATE: 9/18/2024

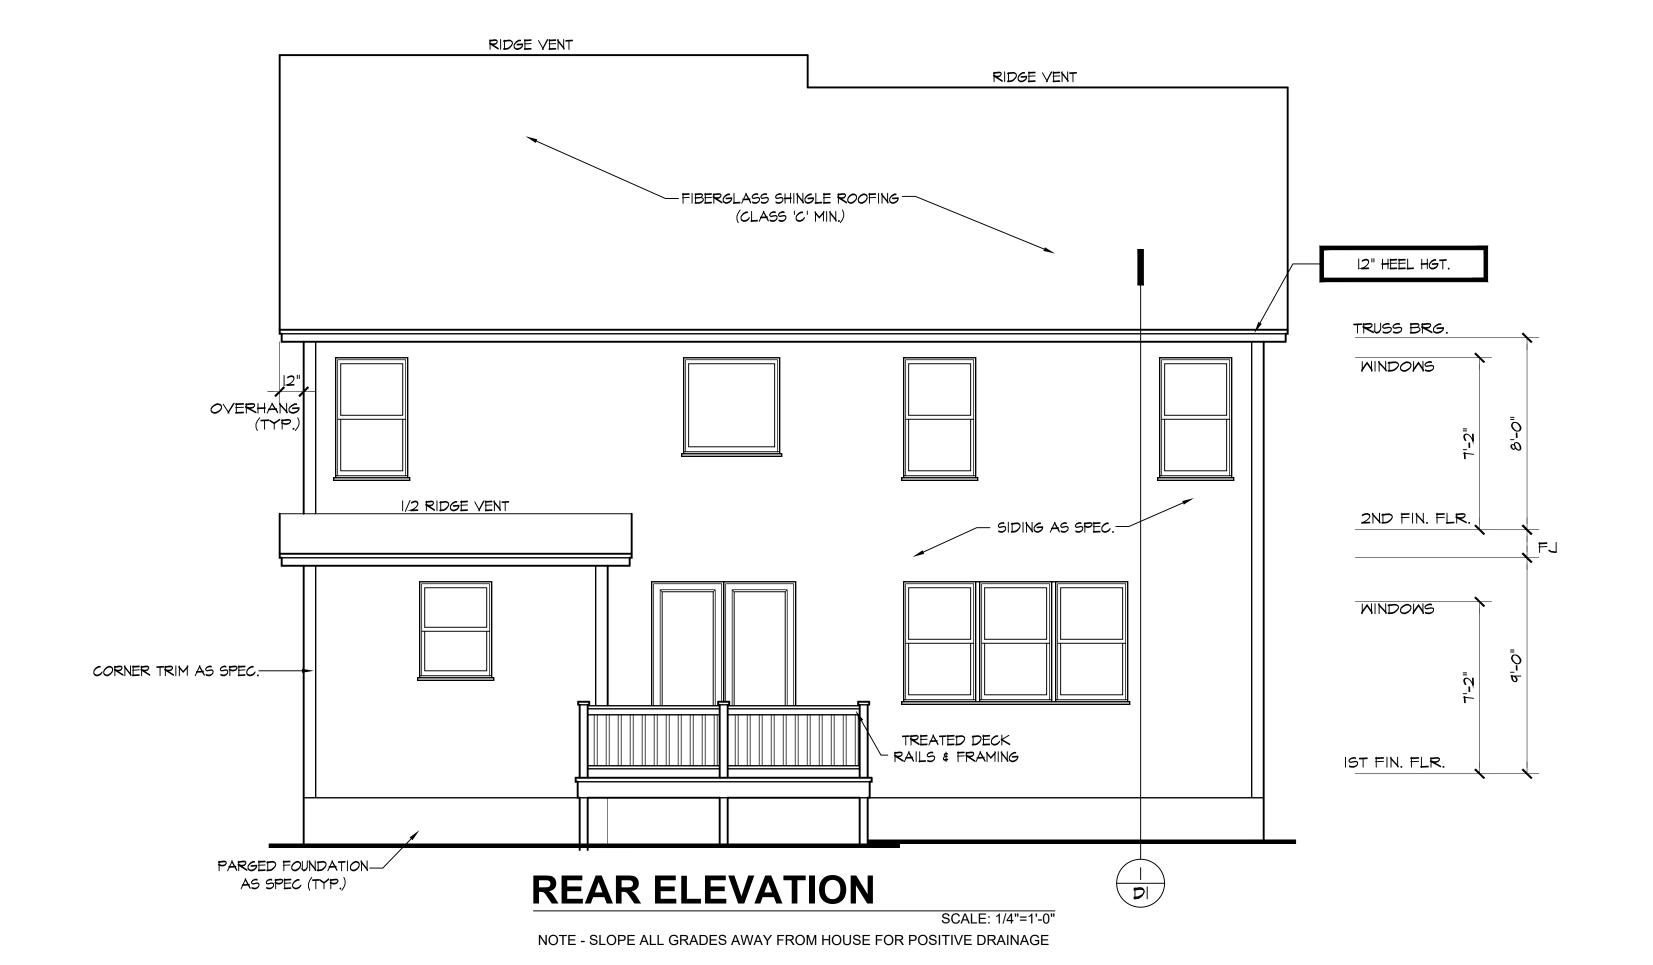

homes unique incresidential design

1027 Hwy 70 West Suite 223 Garner, NC 27529 919-779-6005

www.homesunique.com

This document is the property of HOMES UNIQUE, INC. and may be used for above titled project. All rights reserved and protected under federal law. Copyright © 2024

The purpose of these drawings is to show the intent of the design and construction of this home. Contractor should verify all conditions and dimensions prior to construction. Once a permit has been issued, contractor shall assume all responsibility to the accuracy of the plans and any changes made during construction.

non Construction The Armstrong

18, Harnett County NC

Delude Residence

ROJECT INFO:

Gammon

Elevations


PROJECT NUMBER: 6633

DRAWN BY:

J.A.D.

CHECKED BY:
J.T.S.
REVISIONS:

DATE: 9/18/2024

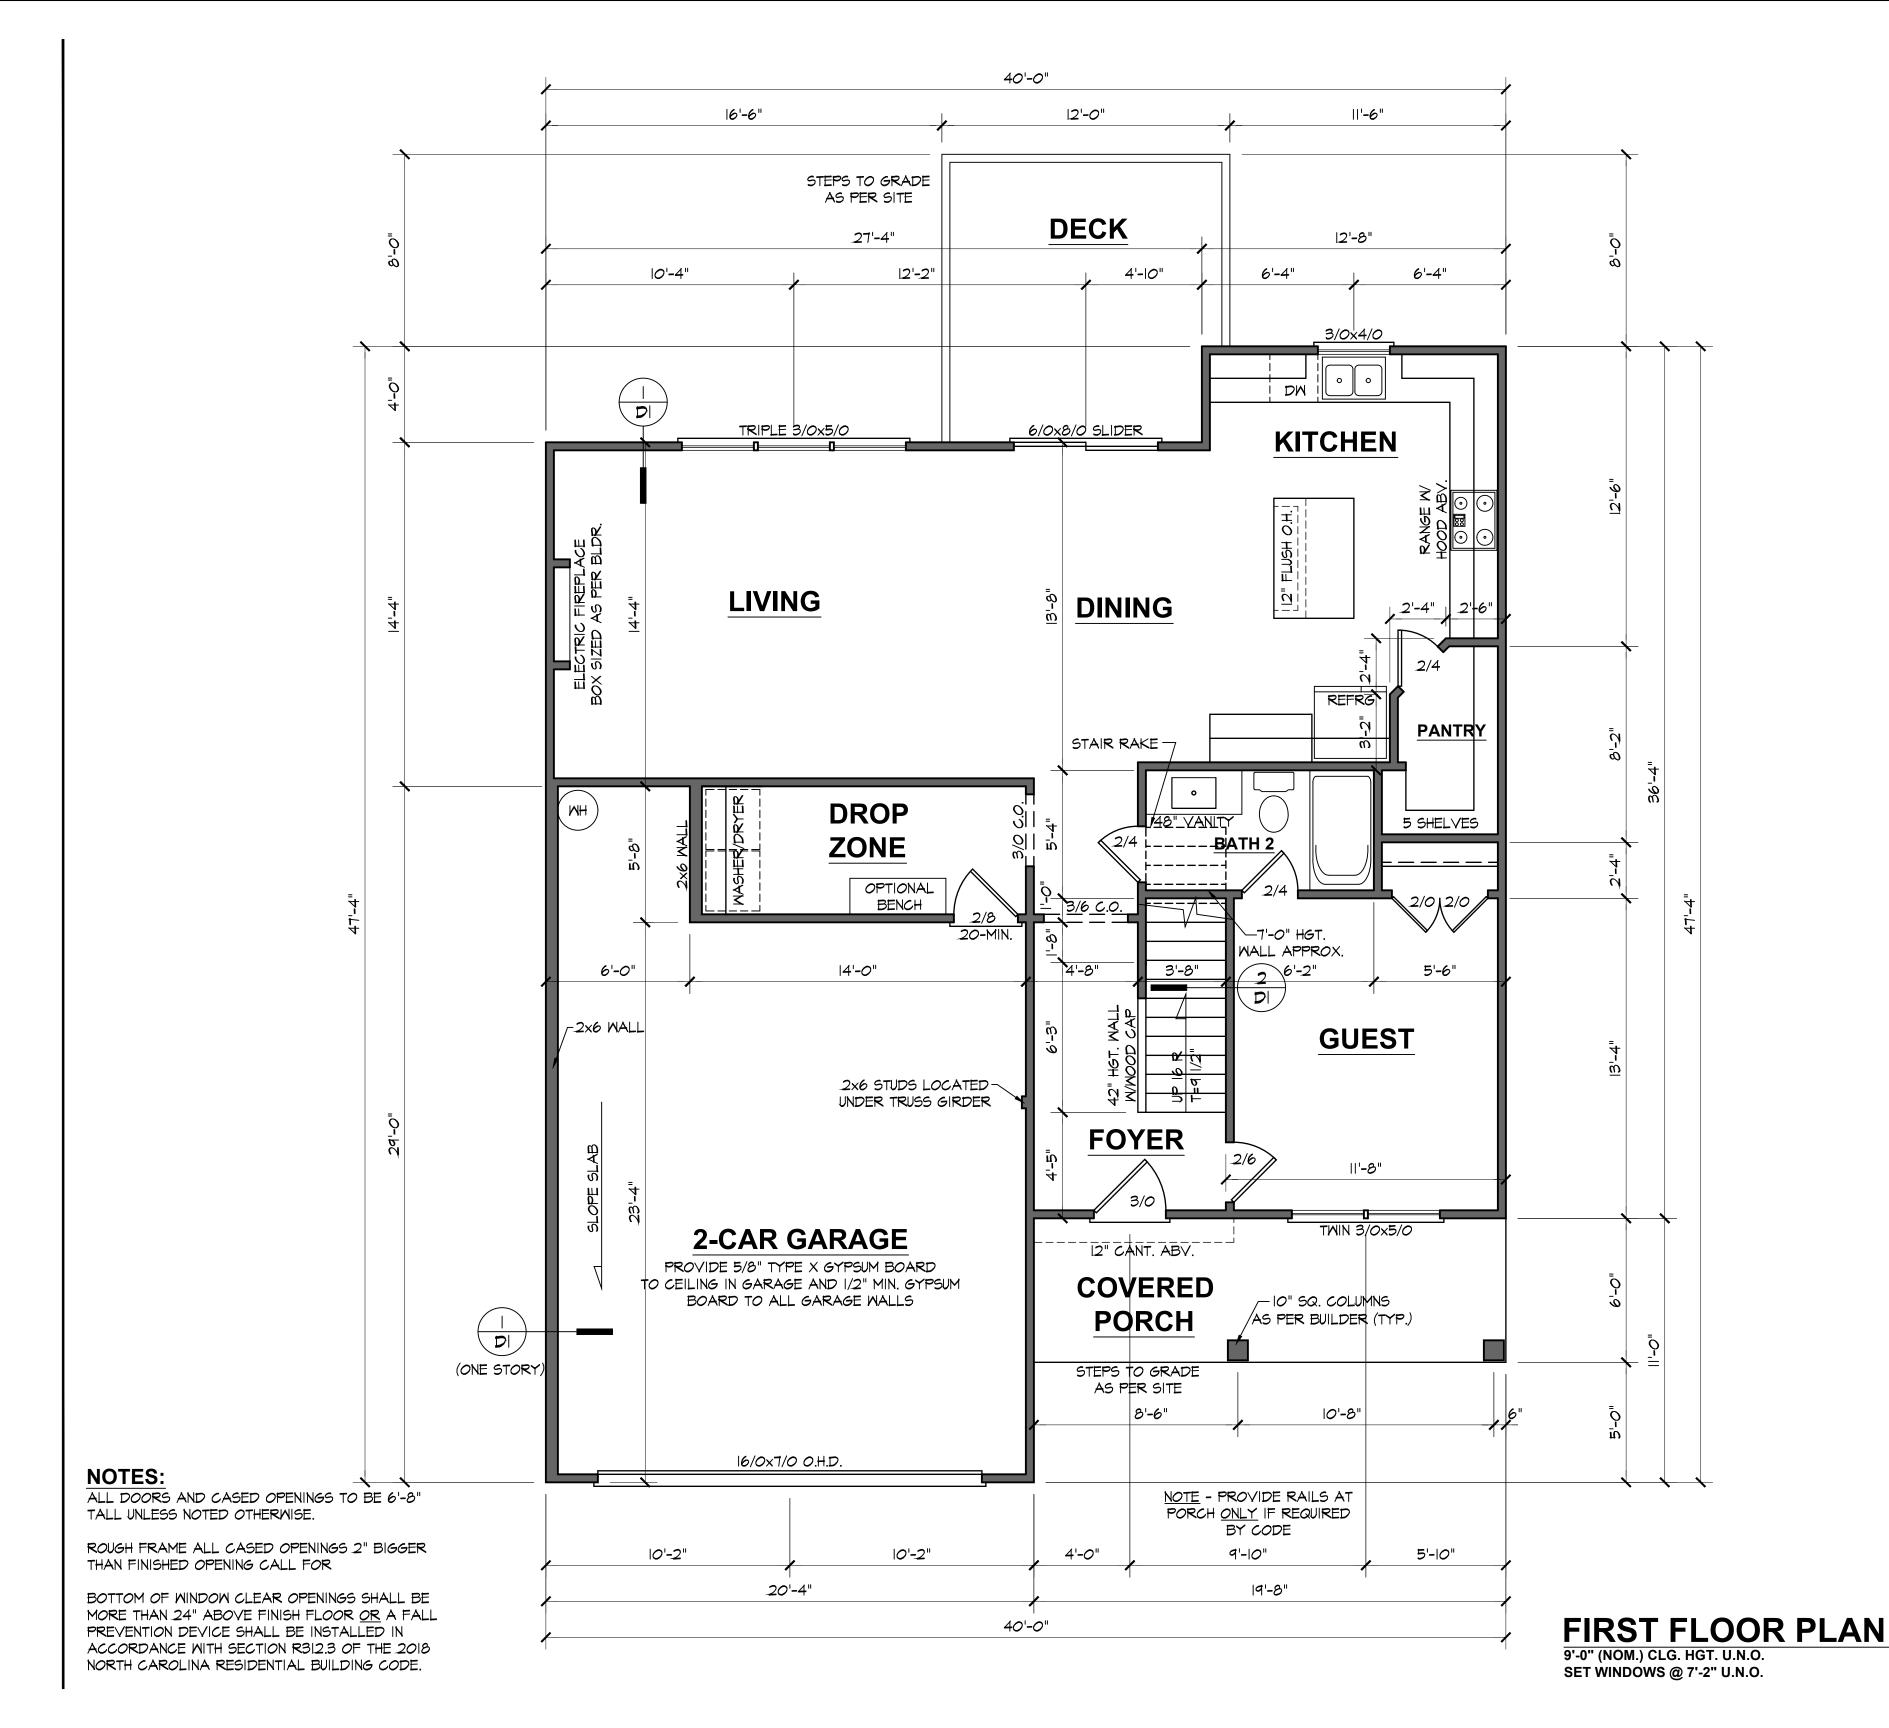



1027 Hwy 70 West Suite 223 Garner, NC 27529 919-779-6005

www.homesunique.com

This document is the property of HOMES UNIQUE, INC. and may be used for above titled project. All rights reserved and protected under federal law.

Copyright © 2024

The purpose of these drawings is to show the intent of the design and construction of this home. Contractor should verify all conditions and dimensions prior to construction. Once a permit has been issued, contractor shall assume all responsibility to the accuracy of the plans and any changes made during construction.

Gammon Construction The Armstrong Delude Residence

18, Harnett County NC

PROJECT INFO:

Floor Plan

PROJECT NUMBER:
6633
DRAWN BY:

J.A.D.

CHECKED BY:


J.T.S.

REVISIONS:

DATE: 9/18/2024 SHEET:

5

SCALE: 1/4"=1'-0"

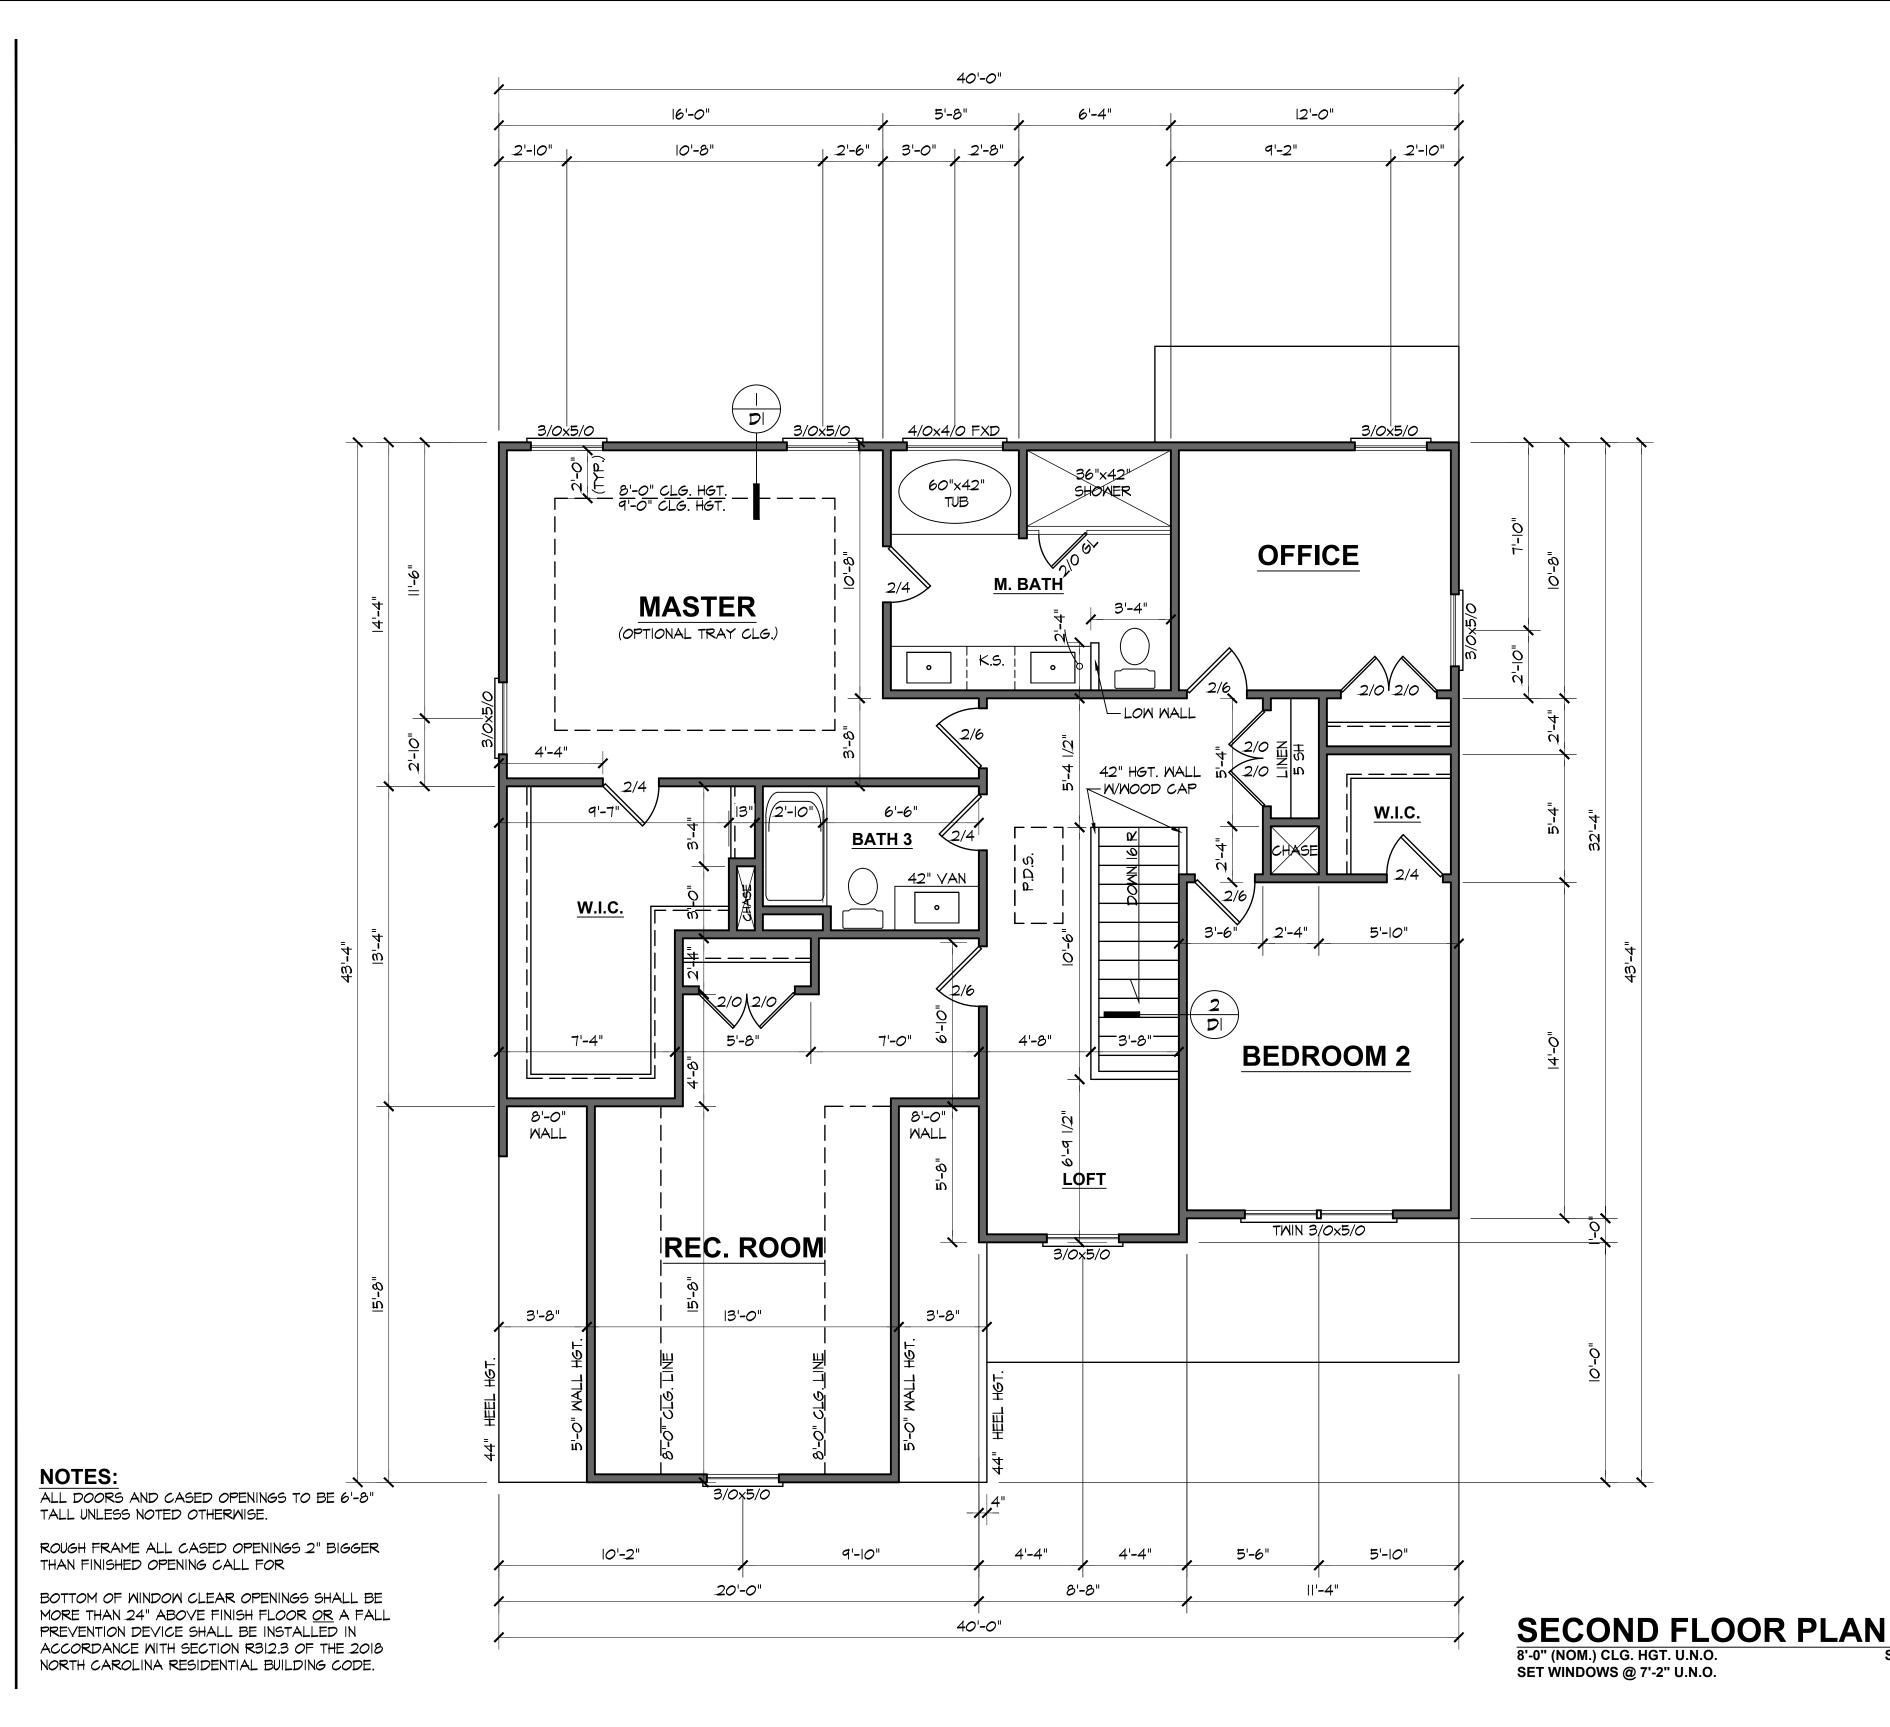



1027 Hwy 70 West Suite 223 Garner, NC 27529

919-779-6005 www.homesunique.com

This document is the property of HOMES UNIQUE, INC. and may be used for above titled project. All rights reserved and protected under federal law.

Copyright © 2024

The purpose of these drawings is to show the intent of the design and construction of this home. Contractor should verify all conditions and dimensions prior to construction. Once a permit has been issued, contractor shall assume all responsibility to the accuracy of the plans and any changes made during construction.

Gammon Construction The Armstrong Delude Residence

18, Harnett County NC

PROJECT INFO:

Floor Plan

PROJECT NUMBER: 6633

DRAWN BY:


J.A.D.

CHECKED BY:

J.T.S.
REVISIONS:

DATE: 9/18/2024 SHEET:

SCALE: 1/4"=1'-0"

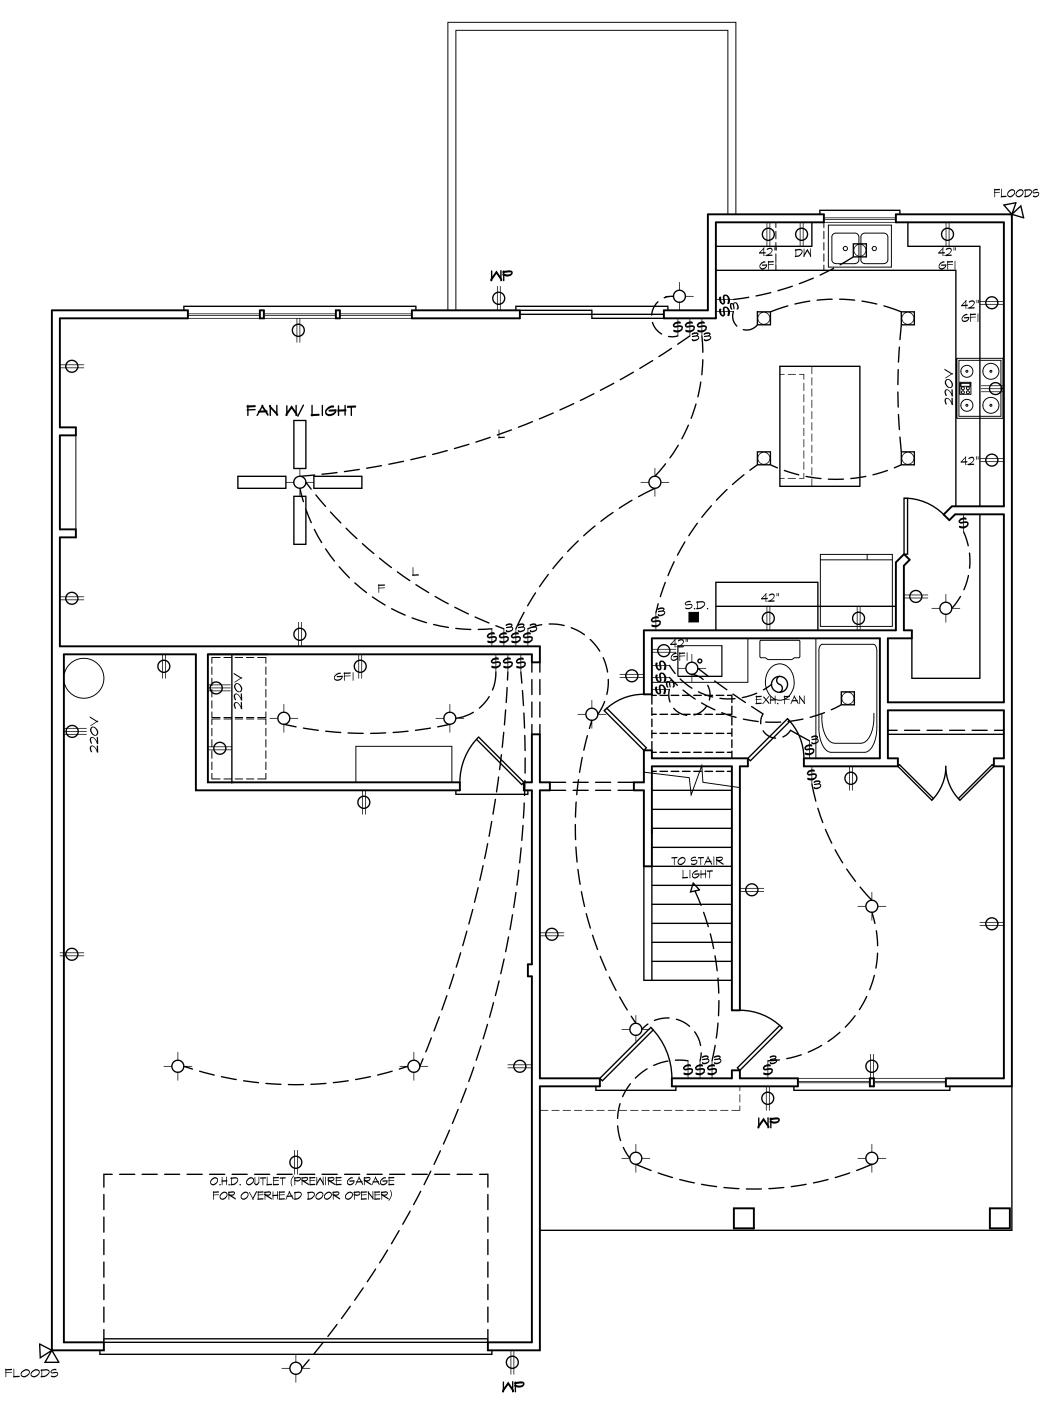

FIRST FLOOR ELECTRICAL PLAN

NOTE - ELECTRICAL RECEPTACLE AND SMITCH QUANTITIES AND LOCATIONS SHOWN ON PLAN ARE FOR ILLUSTRATION PURPOSES ONLY. ACTUAL NUMBER AND LOCATIONS SHALL BE FIELD DETERMINED AS PER CLIENT AND BUILDER EXCEPT WHERE CODE REQUIREMENTS APPLY.

ELECTRICAL LEGEND

- - LIGHT FIXTURE

S - FAN/LIGHT

WP WATERPROOF OUTLET

- RECESSED LIGHTING

- SINGLE PULL SWITCH

- 3-WAY SWITCH

 $\frac{1}{4}$ - 4-MAY SMITCH

\$ - DIMMER SWITCH

- SMOKE DETECTOR

A - FLOOD LIGHTS


7 - EYEBALL SPOTS

- DUPLEX RECEPTACLE (IIOV)

- 220 VOLT RECEPTACLE

- SMITCHED RECEPTACLE (TOP WIRE ONLY)

\$\\ \chi_{\text{GFI}}\$ - GROUND FAULT CIRCUIT INTERRUPTOR

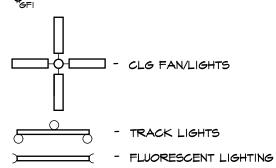

O - CABLE OUTLET

- TELEPHONE OUTLET

- COMPUTER DATA OUTLET

🛛 - BURGLAR ALARM

- INTERCOM

NOTE: ALL ELECTRICAL TO BE VERIFIED BY OWNER/BUILDER BEFORE ROUGH-IN. homes unique inc residential design

1027 Hwy 70 West Suite 223

Garner, NC 27529 919-779-6005

www.homesunique.com

This document is the property of HOMES UNIQUE, INC. and may be used for above titled project. All rights reserved and protected under federal law.

Copyright © 2024

The purpose of these drawings is to show the intent of the design and construction of this home. Contractor should verify all conditions and dimensions prior to construction. Once a permit has been issued, contractor shall assume all responsibility to the accuracy of the plans and any changes made during construction.

Imon Construction The Armstrong Delude Residence

18, Harnett County NC

Gammon

Flectrical


PROJECT NUMBER:

6633 DRAWN BY: J.A.D.

CHECKED BY: J.T.S.

REVISIONS:

DATE: **9/18/2024** SHEET:

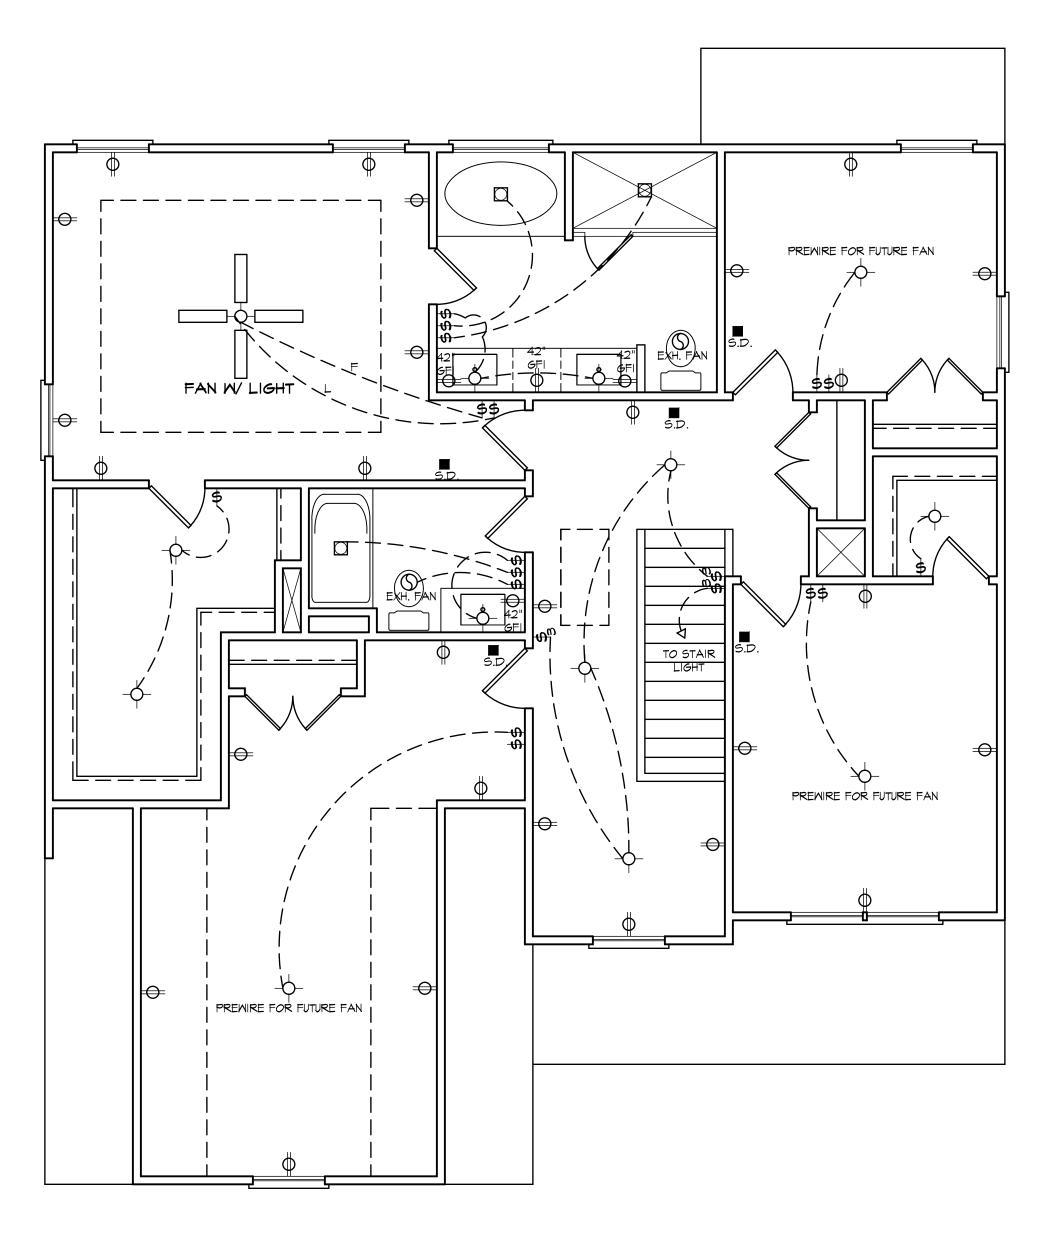

SECOND FLOOR ELECTRICAL PLAN

NOTE - ELECTRICAL RECEPTACLE AND SMITCH QUANTITIES AND LOCATIONS SHOWN ON PLAN ARE FOR ILLUSTRATION PURPOSES ONLY. ACTUAL NUMBER AND LOCATIONS SHALL BE FIELD DETERMINED AS PER CLIENT AND BUILDER EXCEPT WHERE CODE REQUIREMENTS APPLY.



- - LIGHT FIXTURE

S - FAN/LIGHT

WP WATERPROOF OUTLET

- RECESSED LIGHTING

- SINGLE PULL SMITCH

- 3-MAY SMITCH

\$ - 4-WAY SMITCH

D - DIMMER SWITCH■ - SMOKE DETECTOR

A - FLOOD LIGHTS


7 - EYEBALL SPOTS

- DUPLEX RECEPTACLE (IIOV)

- 220 VOLT RECEPTACLE

- SWITCHED RECEPTACLE (TOP WIRE ONLY)

- GROUND FAULT CIRCUIT INTERRUPTOR

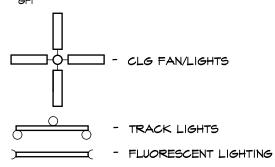

O - CABLE OUTLE

- TELEPHONE OUTLET

△ - COMPUTER DATA OUTLET

🛛 - BURGLAR ALARM

- INTERCOM

NOTE: ALL ELECTRICAL TO BE VERIFIED BY OWNER/BUILDER BEFORE ROUGH-IN. homes unique inc residential design

1027 Hwy 70 West Suite 223

Garner, NC 27529 919-779-6005

www.homesunique.com

This document is the property of HOMES UNIQUE, INC. and may be used for above titled project. All rights reserved and protected under federal law.

Copyright © 2024

The purpose of these drawings is to show the intent of the design and construction of this home. Contractor should verify all conditions and dimensions prior to construction. Once a permit has been issued, contractor shall assume all responsibility to the accuracy of the plans and any changes made during construction.

non Construction The Armstrong

18, Harnett County NC

Delude Residence

Gammon

Flectrical

PROJECT NUMBER: 6633

DRAWN BY:


J.A.D.

CHECKED BY:

J.T.S.
REVISIONS:

DATE: 9/18/2024

SHEET:

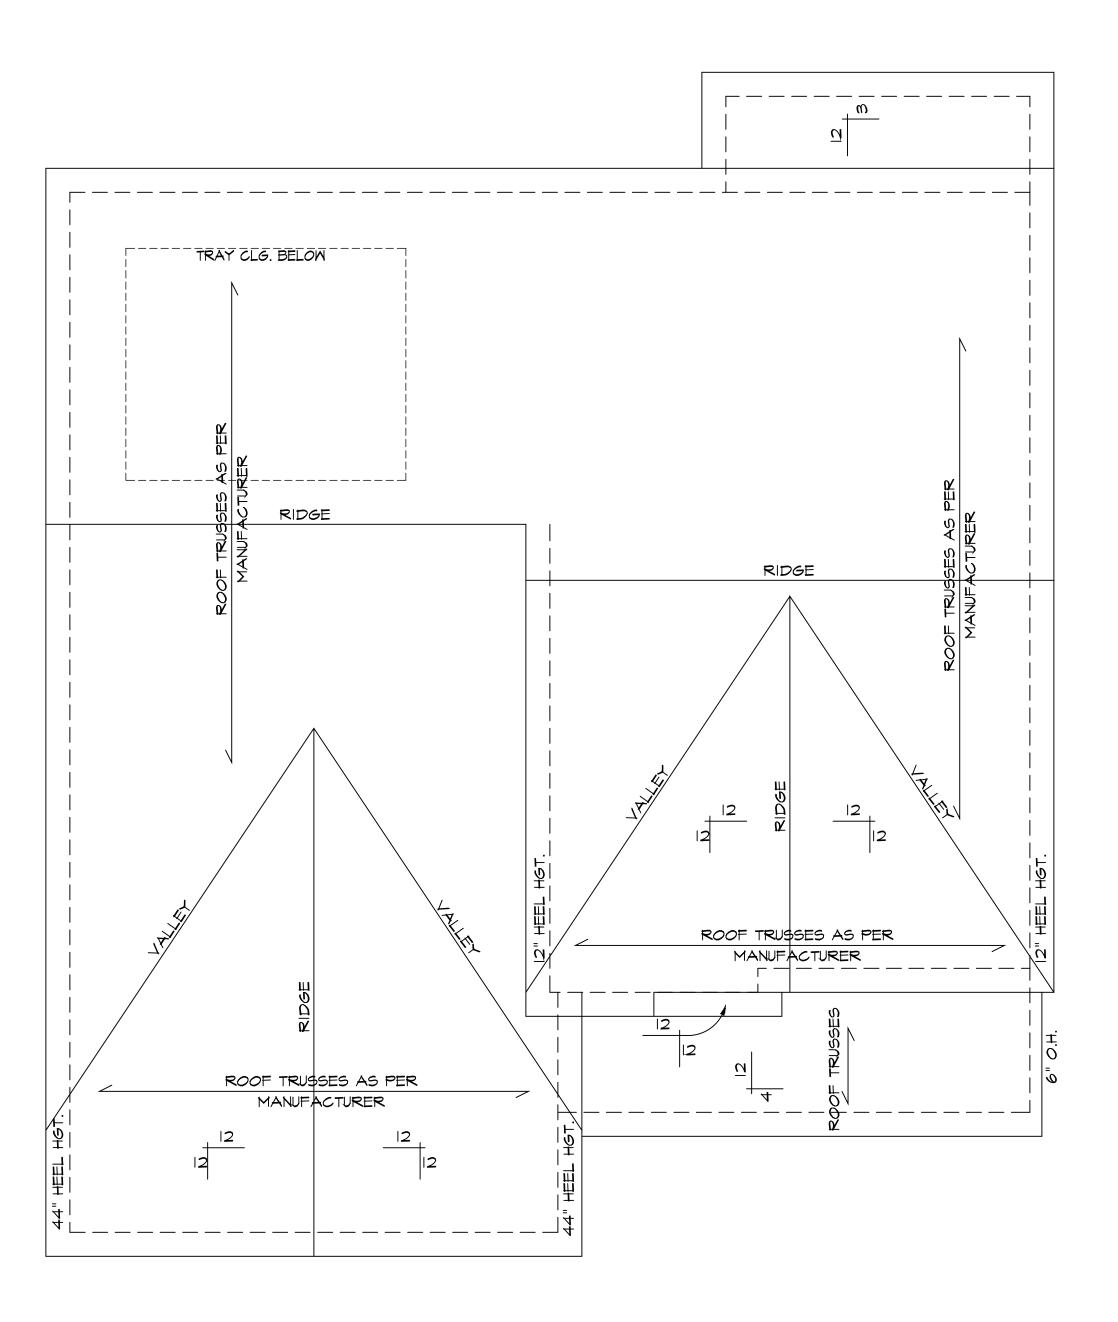



SCALE: 1/4"=1'-0"

NOTE I - ALL ROOF PITCHES TO BE 8/12 U.N.O.

NOTE 2 - ALL ROOF OVERHANGS TO BE 12" U.N.O.



1027 Hwy 70 West Suite 223 Garner, NC 27529 919-779-6005

www.homesunique.com

This document is the property of HOMES UNIQUE, INC. and may be used for above titled project. All rights reserved and protected under federal law.

Copyright © 2024

The purpose of these drawings is to show the intent of the design and construction of this home. Contractor should verify all conditions and dimensions prior to construction. Once a permit has been issued, contractor shall assume all responsibility to the accuracy of the plans and any changes made during construction.

Gammon Construction The Armstrong Delude Residence

18, Harnett County NC

ROJECT INFO:

Roof Plan

PROJECT NUMBER: 6633

DRAWN BY:


J.A.D.


CHECKED BY:

J.T.S.
REVISIONS:

DATE: 9/18/2024

SHEET:

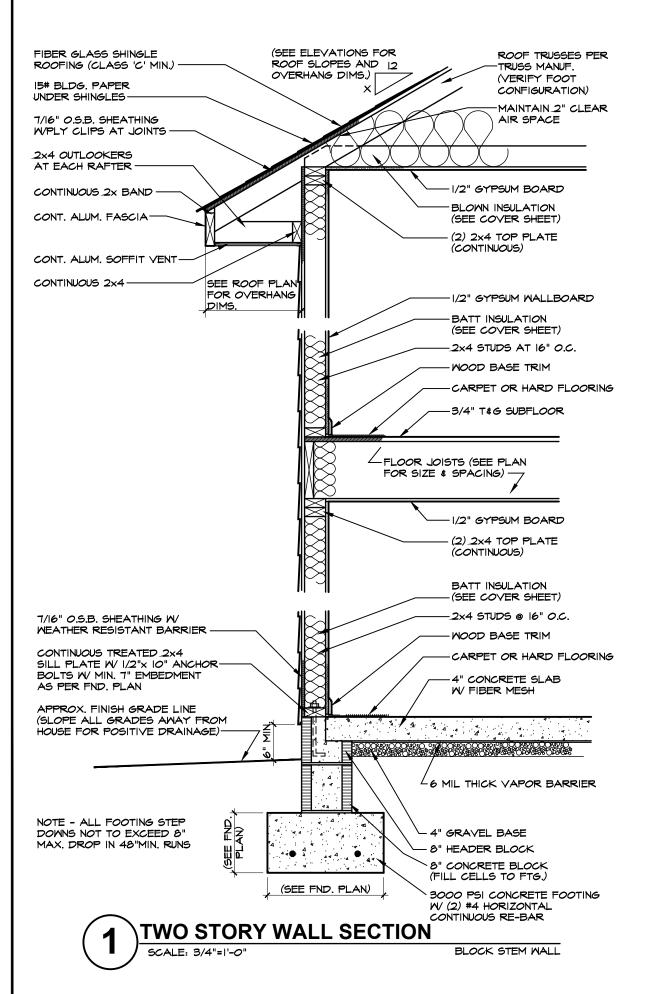

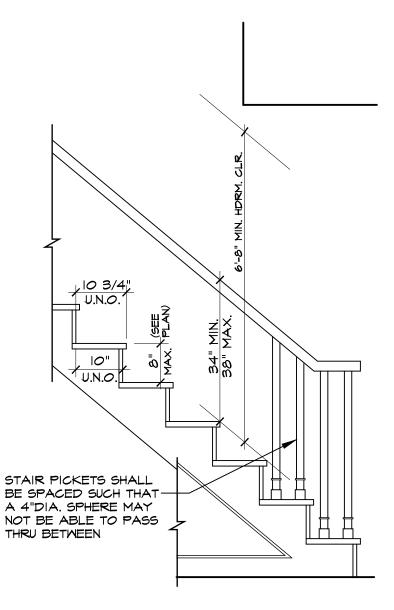

2 TYPICAL STAIR DETAIL

SCALE: 3/4"=1'-0"



1027 Hwy 70 West Suite 223 Garner, NC 27529 919-779-6005

www.homesunique.com

This document is the property of HOMES UNIQUE, INC. and may be used for above titled project. All rights reserved and protected under federal law.

Copyright © 2024

The purpose of these drawings is to show the intent of the design and construction of this home. Contractor should verify all conditions and dimensions prior to construction. Once a permit has been issued, contractor shall assume all responsibility to the accuracy of the plans and any changes made during construction.

ammon Construction The Armstrong

S

18, Harnett County

Delude Residence

PROJECT INFO: Gamm

Details

PROJECT NUMBER: 6633


DRAWN BY:
J.A.D.
CHECKED BY:

J.T.S.
REVISIONS:

DATE.

DATE: **9/18/2024** SHEET:

D1

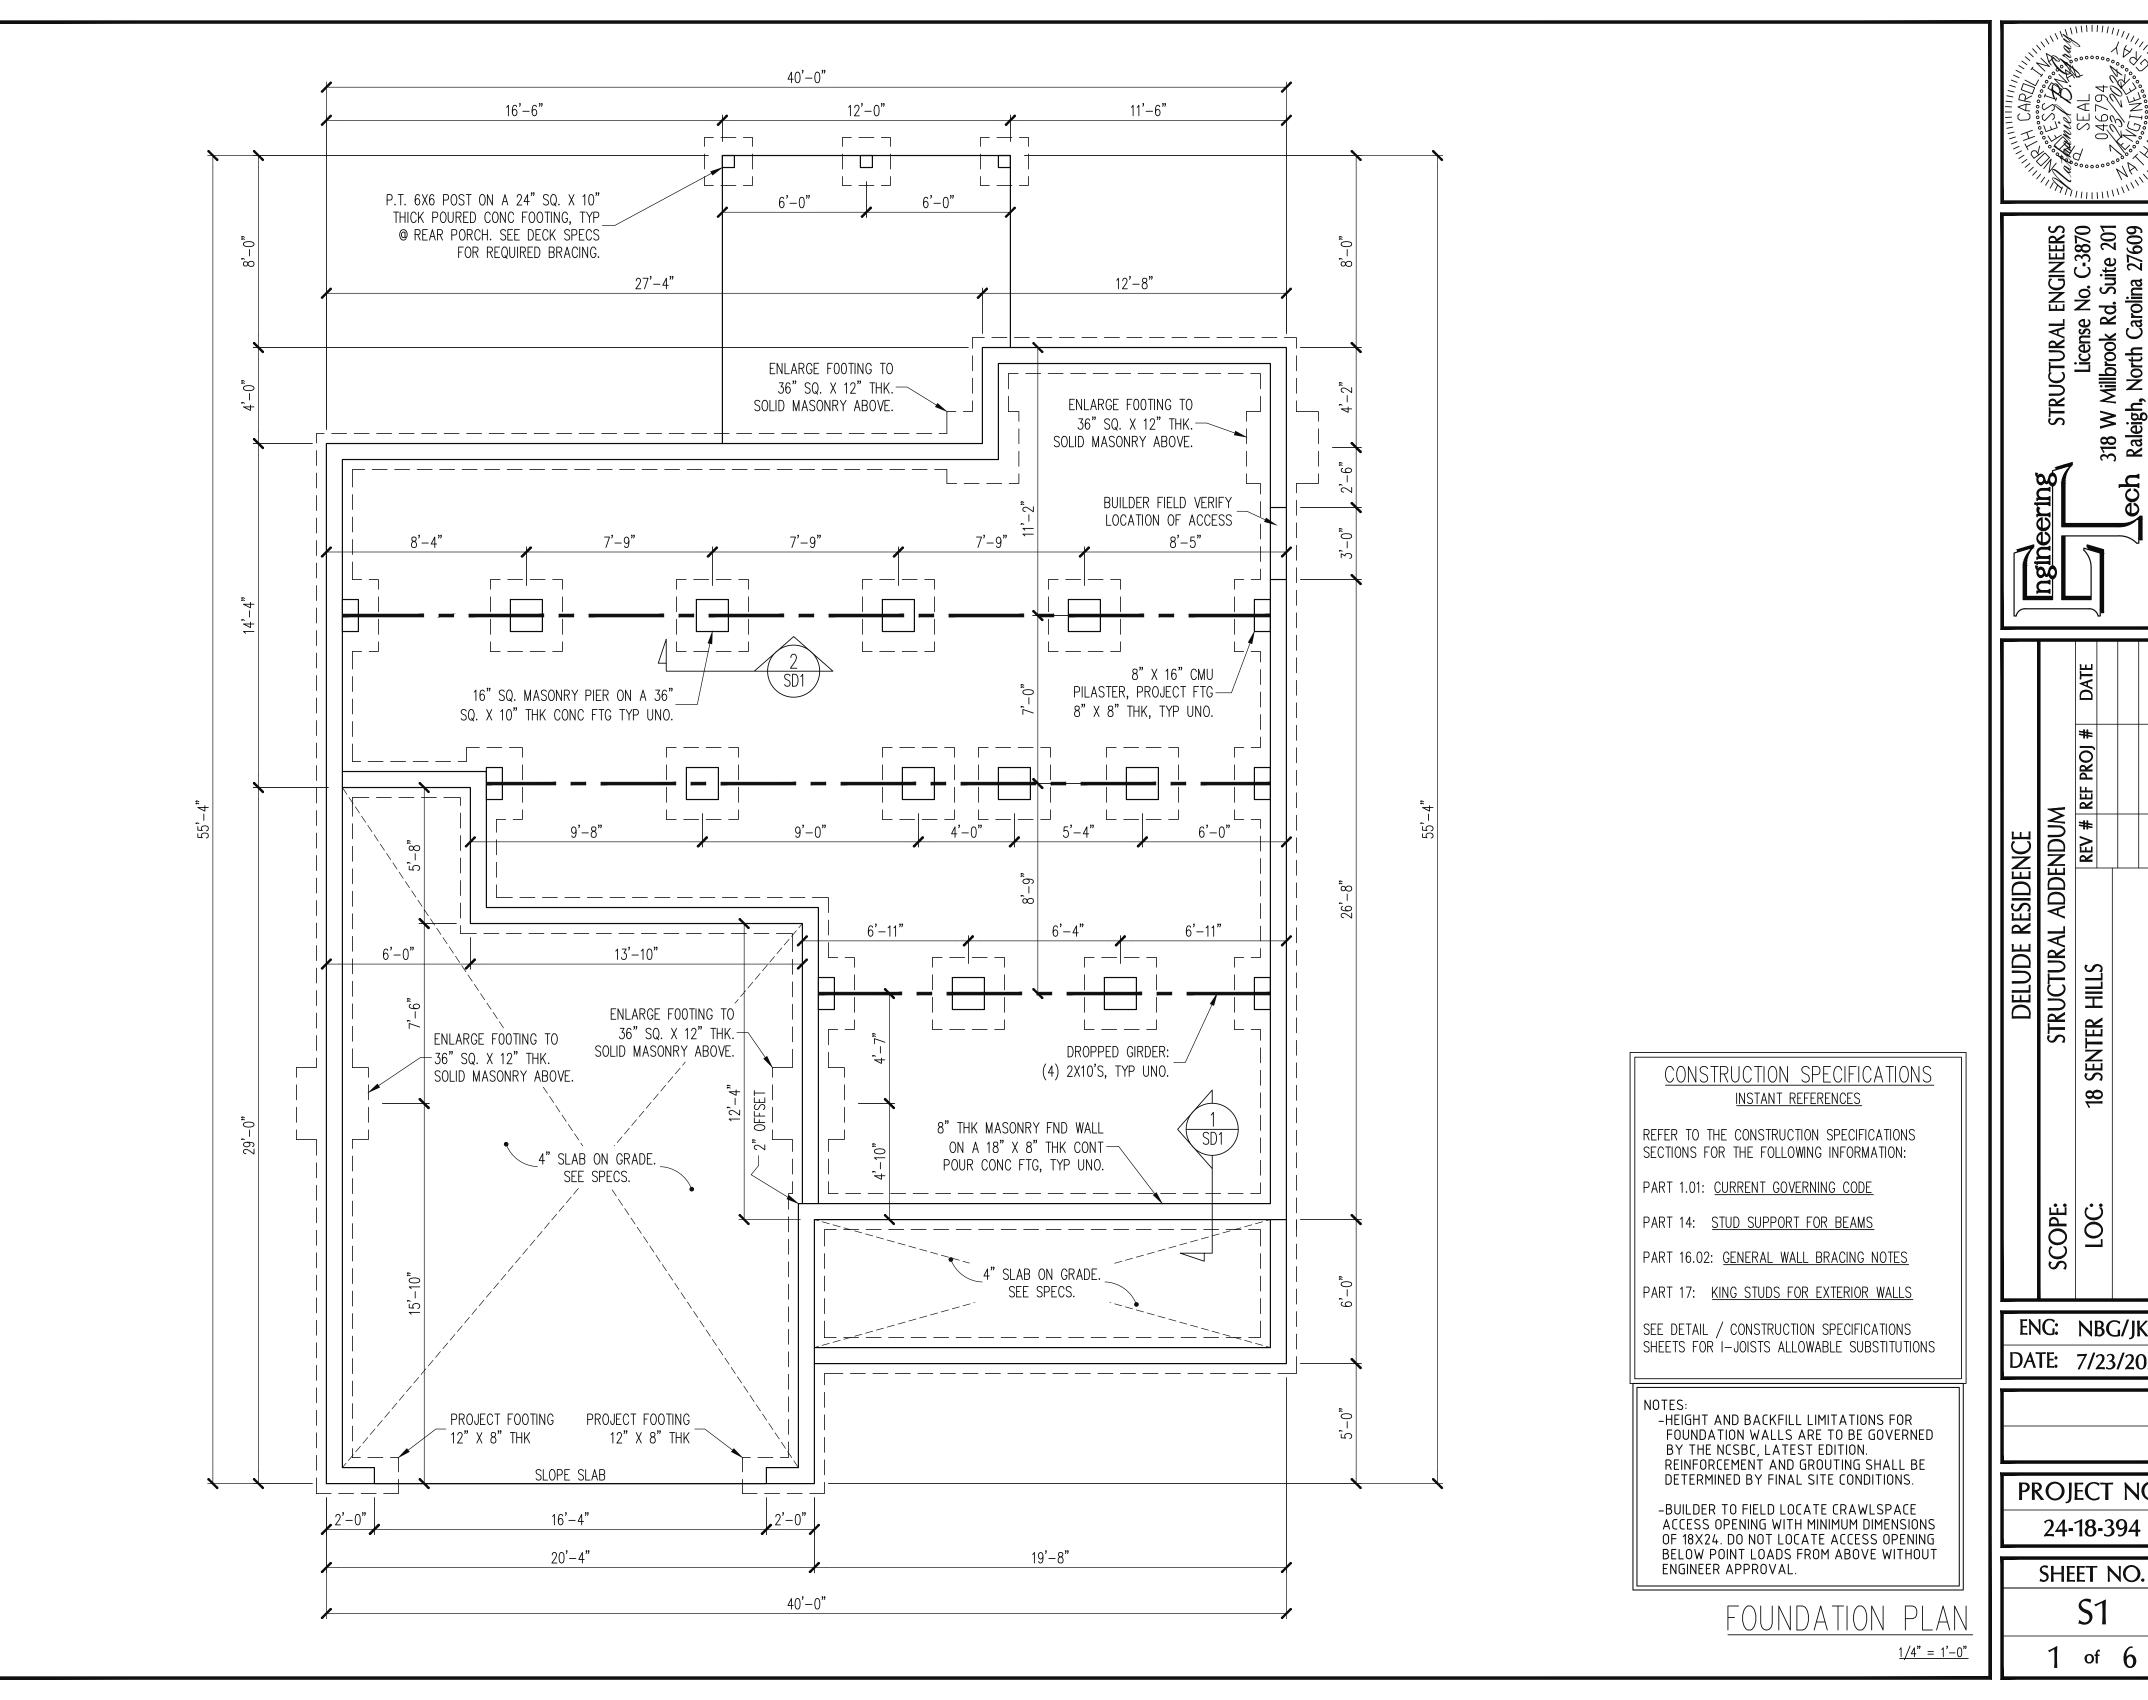

STRUCTURAL ENGINEERS
License No. C-3870
318 W Millbrook Rd. Suite 201
Raleigh, North Carolina 27609
A. Phone (919) 844-1661


eering ech ASSOCIATES, P.A ngin


REV # REF PROJ STRUCTURAL ADDENDUM SENTER HILLS <u>8</u> SCOPE: LOC:


ENG: NBG/JKM DATE: 7/23/2024

PROJECT NO.

SHEET NO. **S1**

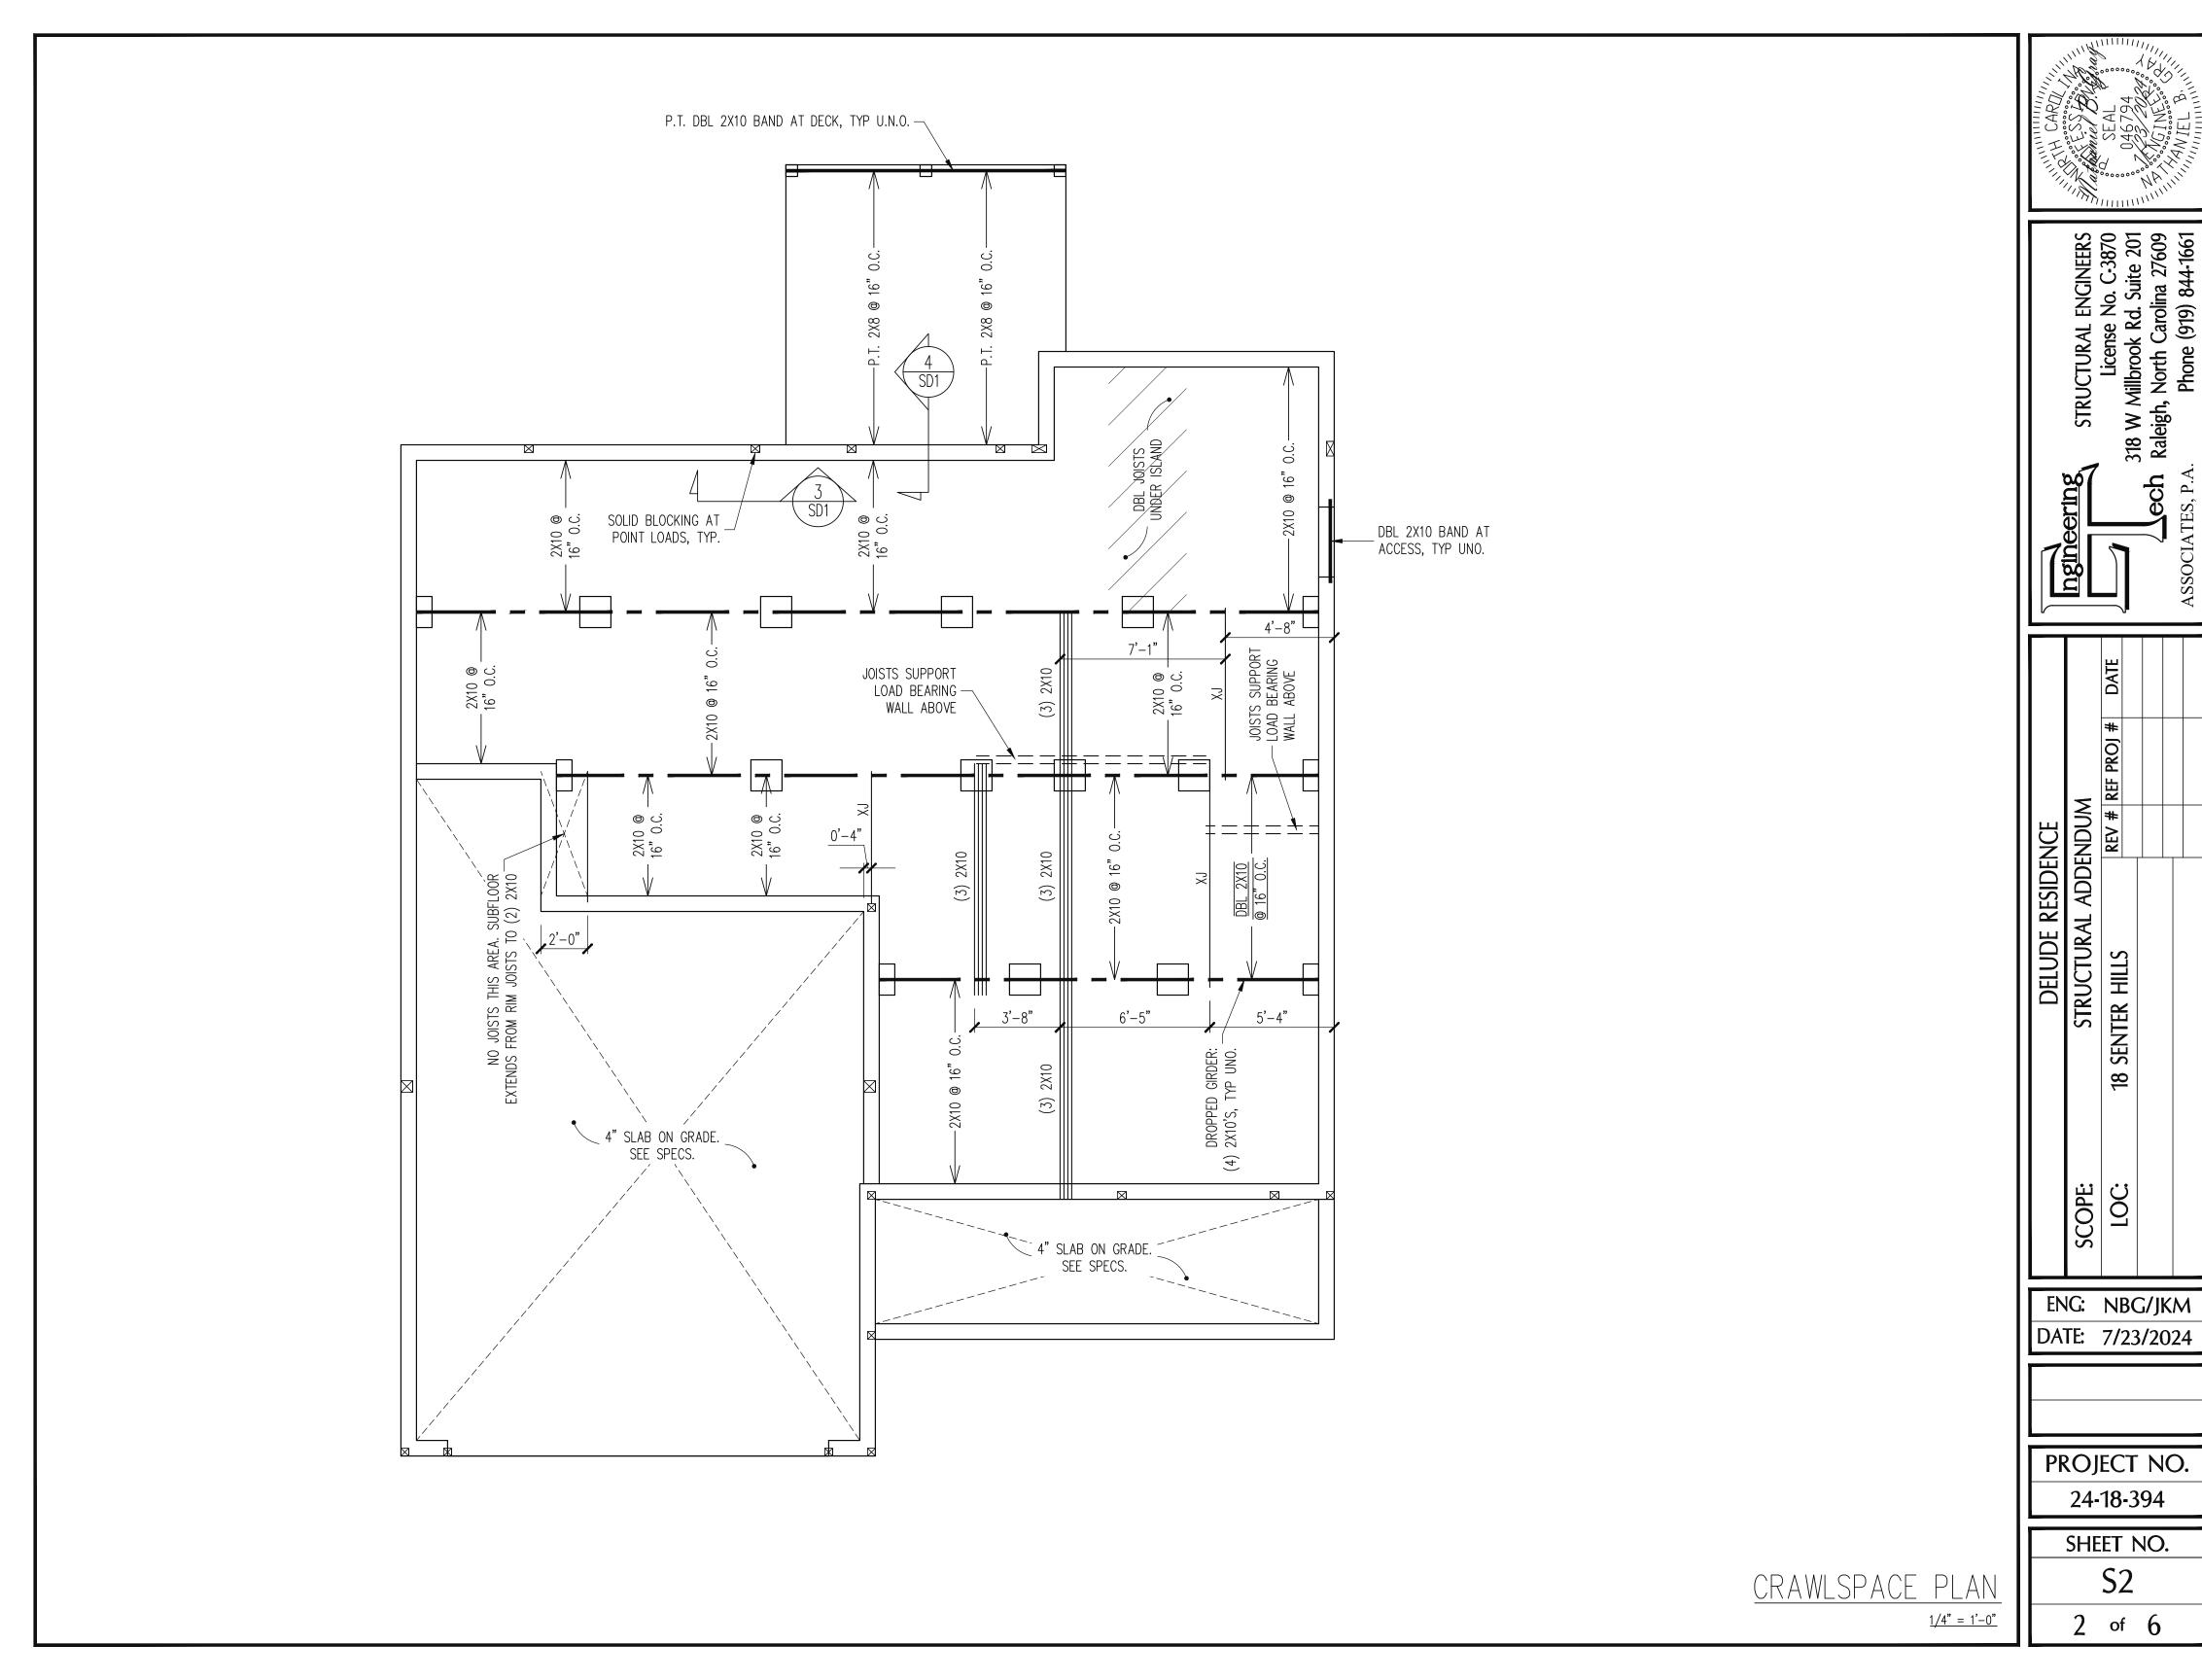

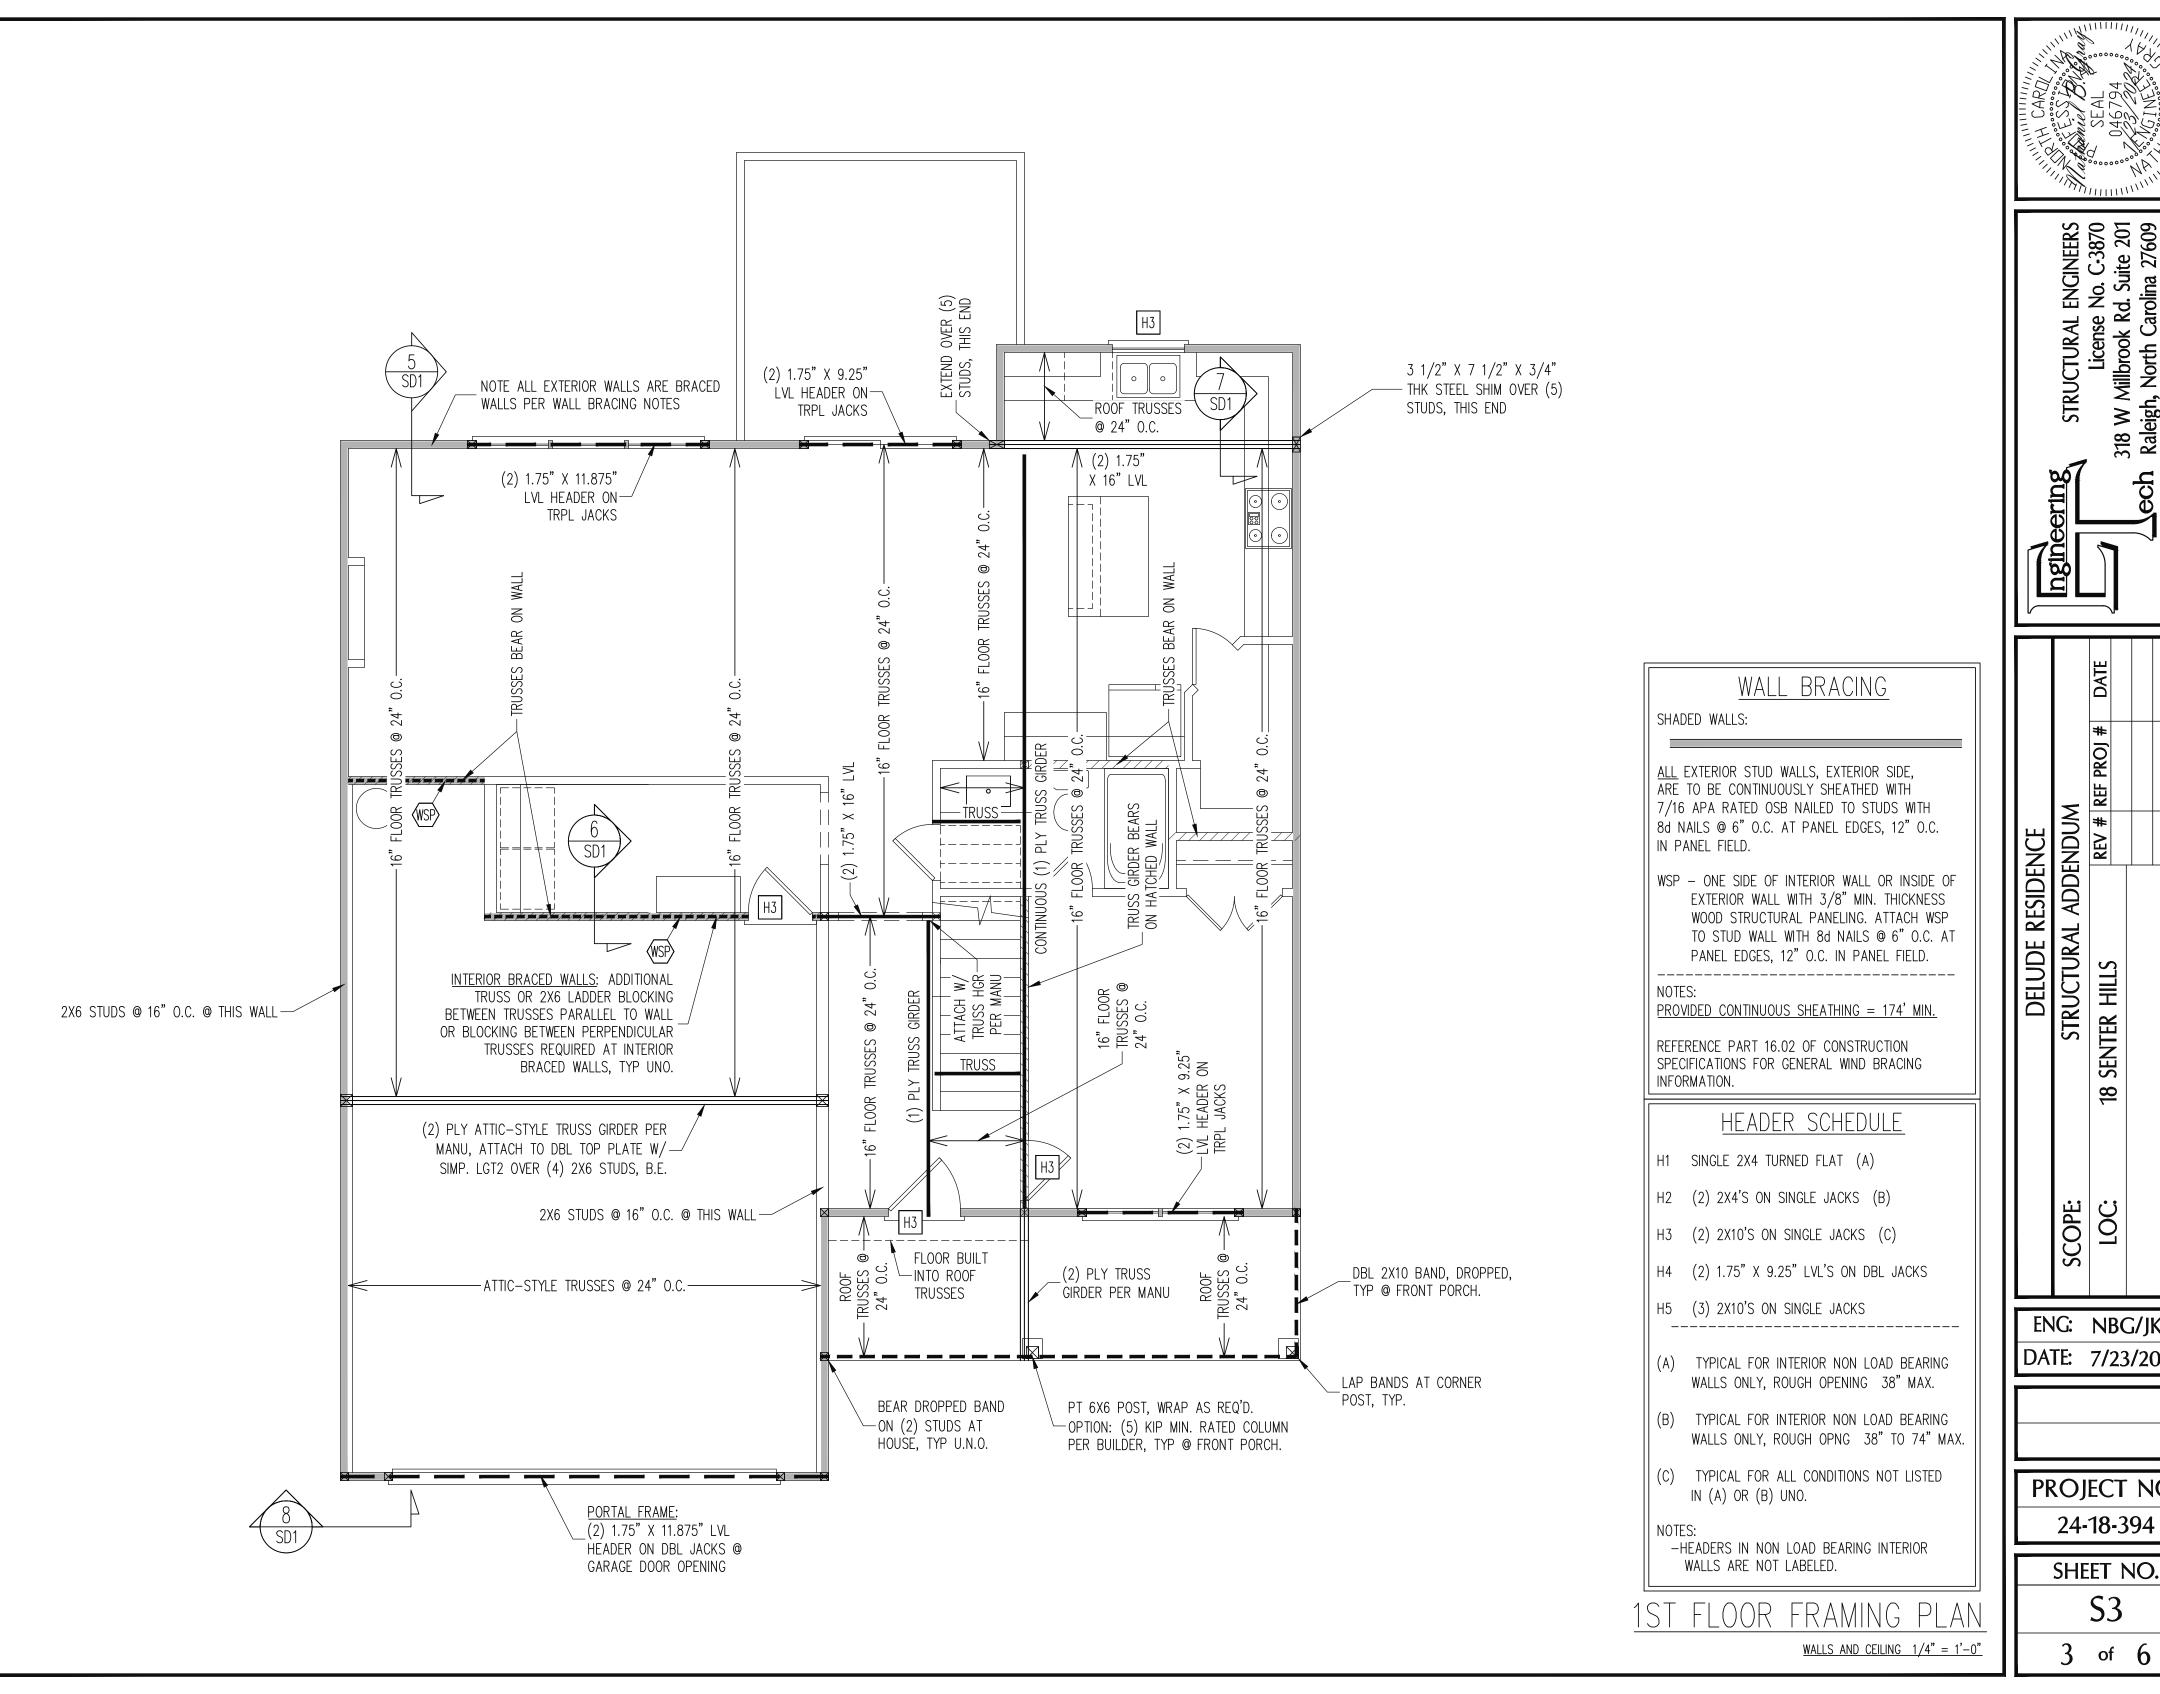

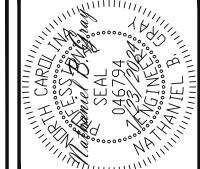

STRUCTURAL ENGINEERS
License No. C-3870
318 W Millbrook Rd. Suite 201
Raleigh, North Carolina 27609
A. Phone (919) 844-1661

ngineering ech


REV # REF PROJ

SENTER HILLS

ENG: NBG/JKM DATE: 7/23/2024

PROJECT NO.

SHEET NO. **S**3

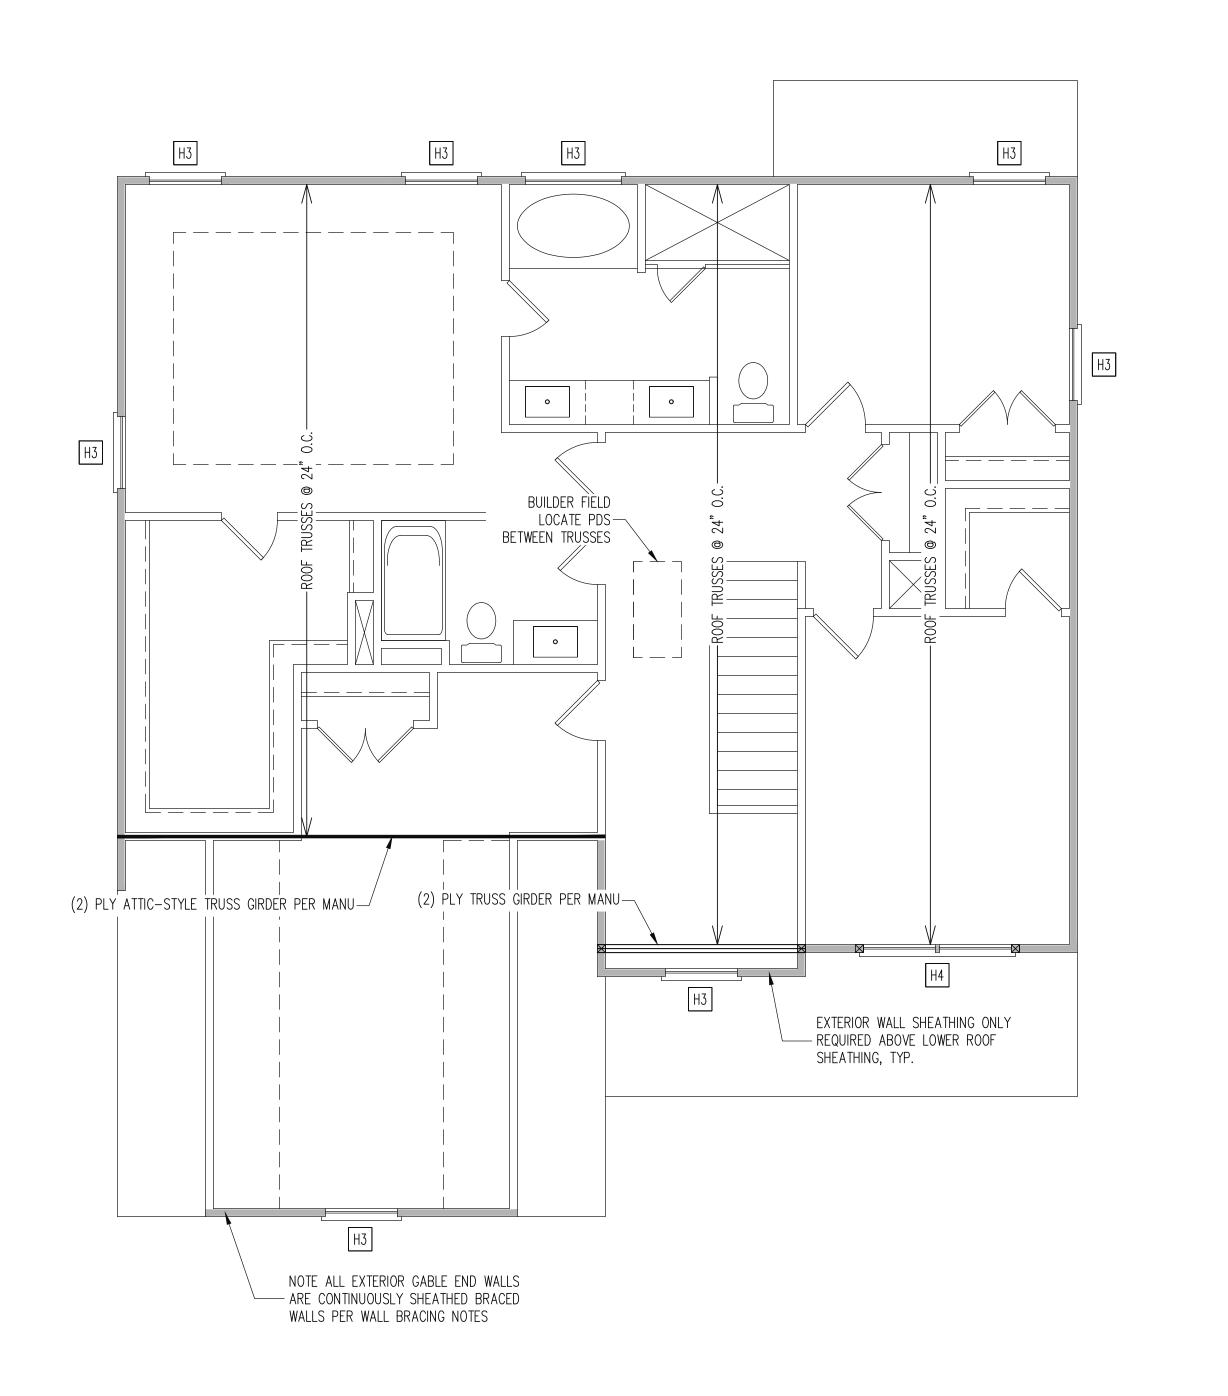



SHADED WALLS:

ALL EXTERIOR STUD WALLS, EXTERIOR SIDE, ARE TO BE CONTINUOUSLY SHEATHED WITH 7/16 APA RATED OSB NAILED TO STUDS WITH 8d NAILS @ 6" O.C. AT PANEL EDGES, 12" O.C. IN PANEL FIELD.

NOTES:

PROVIDED CONTINUOUS SHEATHING = 142' MIN.

REFERENCE PART 16.02 OF CONSTRUCTION SPECIFICATIONS FOR GENERAL WIND BRACING INFORMATION.

HEADER SCHEDULE

- H1 SINGLE 2X4 TURNED FLAT (A)
- H2 (2) 2X4'S ON SINGLE JACKS (B)
- H3 (2) 2X10'S ON SINGLE JACKS (C)
- H4 (2) 1.75" X 9.25" LVL'S ON DBL JACKS
- H5 (3) 2X10'S ON SINGLE JACKS
- (A) TYPICAL FOR INTERIOR NON LOAD BEARING WALLS ONLY, ROUGH OPENING 38" MAX.
- (B) TYPICAL FOR INTERIOR NON LOAD BEARING WALLS ONLY, ROUGH OPNG 38" TO 74" MAX.
- (C) TYPICAL FOR ALL CONDITIONS NOT LISTED IN (A) OR (B) UNO.

|| NOTE:

-HEADERS IN NON LOAD BEARING INTERIOR WALLS ARE NOT LABELED.

1ST FLOOR FRAMING PLAN

WALLS AND CEILING 1/4" = 1'-0"

|--|

STRUCTURAL ENGINEERS
License No. C-3870
318 W Millbrook Rd. Suite 201
h Raleigh, North Carolina 27609
.A. Phone (919) 844-1661

<u>sring</u>	33	Sech Ra	4 6 01
Ingineerin			A G RELATIONS A
	1 1		

STRUCTURAL ADDENDUM
SENTER HILLS

REV # REF PROJ # DATE

ENG: NBG/JKM


3


DATE: 7/23/2024

PROJECT NO. 24-18-394

SHEET NO.

S4

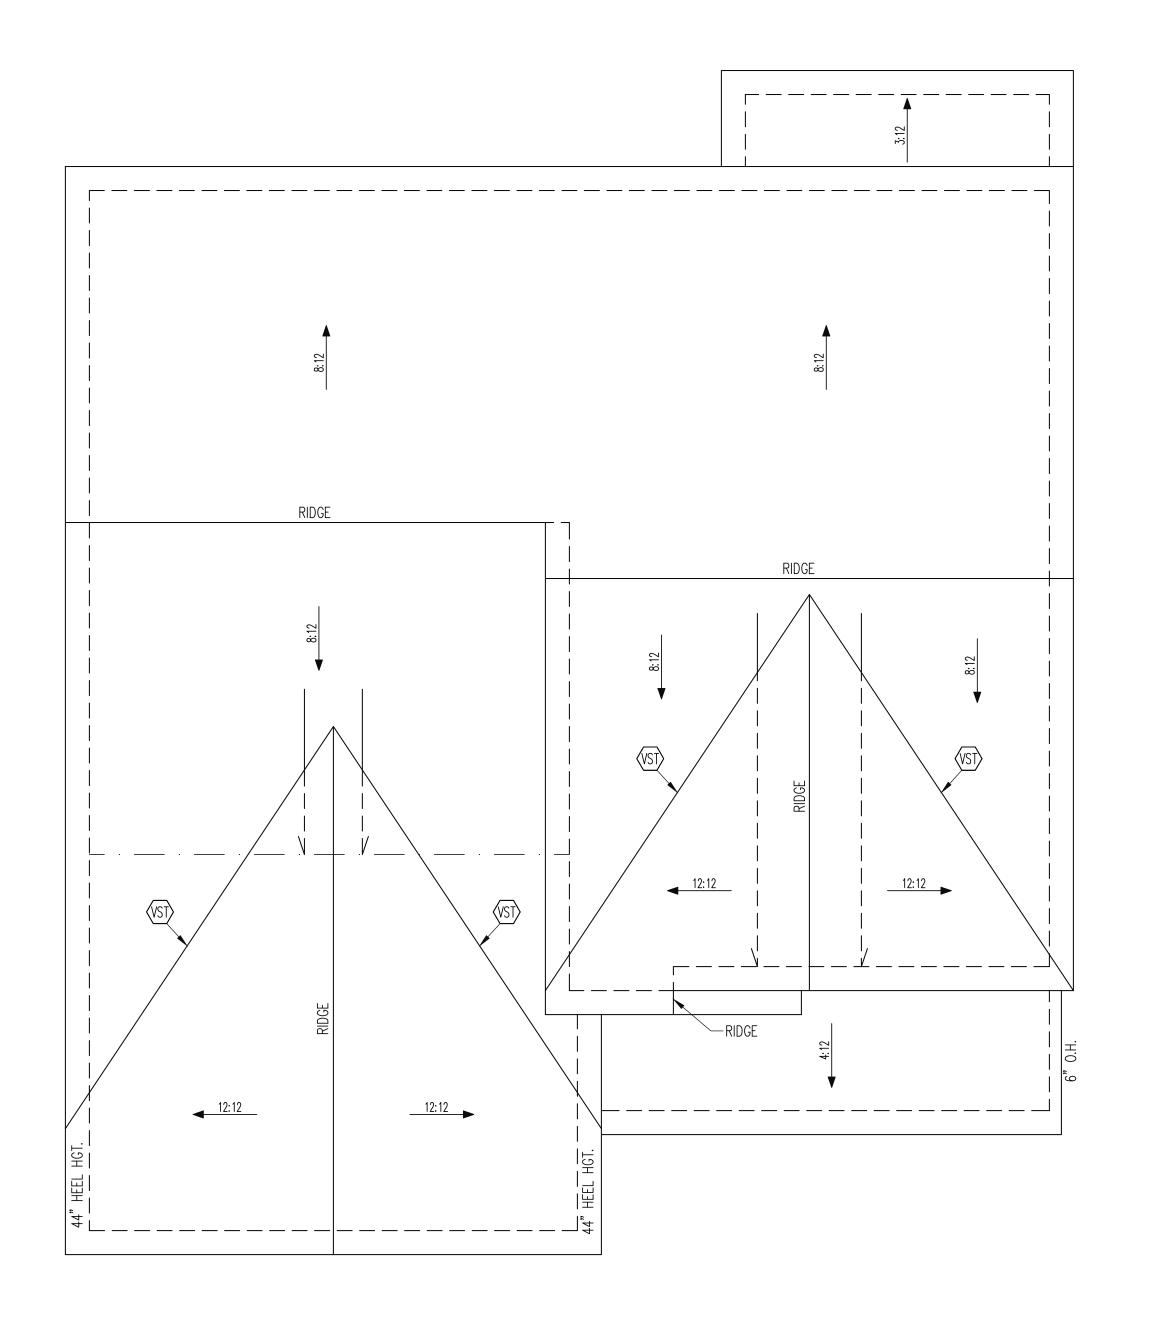

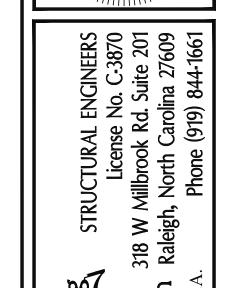

ech

DELUDE RESIDENCE	NCE		
STRUCTURAL ADDENDUM	NDON	V	
SENTER HILLS	REV #	REV # REF PROJ #	DATE

TRUSS UPLIFT CONNECTORS

EXPOSURE B, 120 MPH, ANY PITCH 24" O.C. MAX ROOF TRUSS SPACING

TRUSSES SHALL BE ATTACHED TO SUPPORT WALL FOR UPLIFT RESISTANCE. CONTINUOUS OSB WALL SHEATHING BELOW PROVIDES CONTINUOUS UPLIFT RESISTANCE TO FOUNDATION. ALL TRUSSES SUPPORTED BY INTERMEDIATE SUPPORT WALLS, KNEEWALLS OR BEAMS SHALL BE ATTACHED TO SUPPORTING MEMBER PER SCHEDULE BELOW.

ROOF SPAN IS MEASURED HORIZONTALLY BETWEEN FURTHEST SUPPORT POINTS.

ROOF SPAN UP TO 18'

NAILING PER TABLE 602.3(1) NCRBC 2018 EDITION

OVER 18'

(1) SIMPSON H2.5A HURRICANE CLIP TO DBL TOP PLATE OR BEAM

FRAMING NOTES

ROOF ONLY

-ROOF TRUSSES PER MANU. TYPICAL U.N.O. -VERIFY ALL HEEL HEIGHTS, ROOF PITCHES, AND ARCHITECTURAL OVERHANGS PRIOR TO CONSTRUCTION

FRAMING SCHEDULE

ROOF ONLY

VST VALLEY SET TRUSSES PER MANU

ROOF FRAMING PLAN 1/4" = 1'-0"


PROJECT NO. 24-18-394


SCOPE

ENG: NBG/JKM

DATE: 7/23/2024

SHEET NO. **S5**

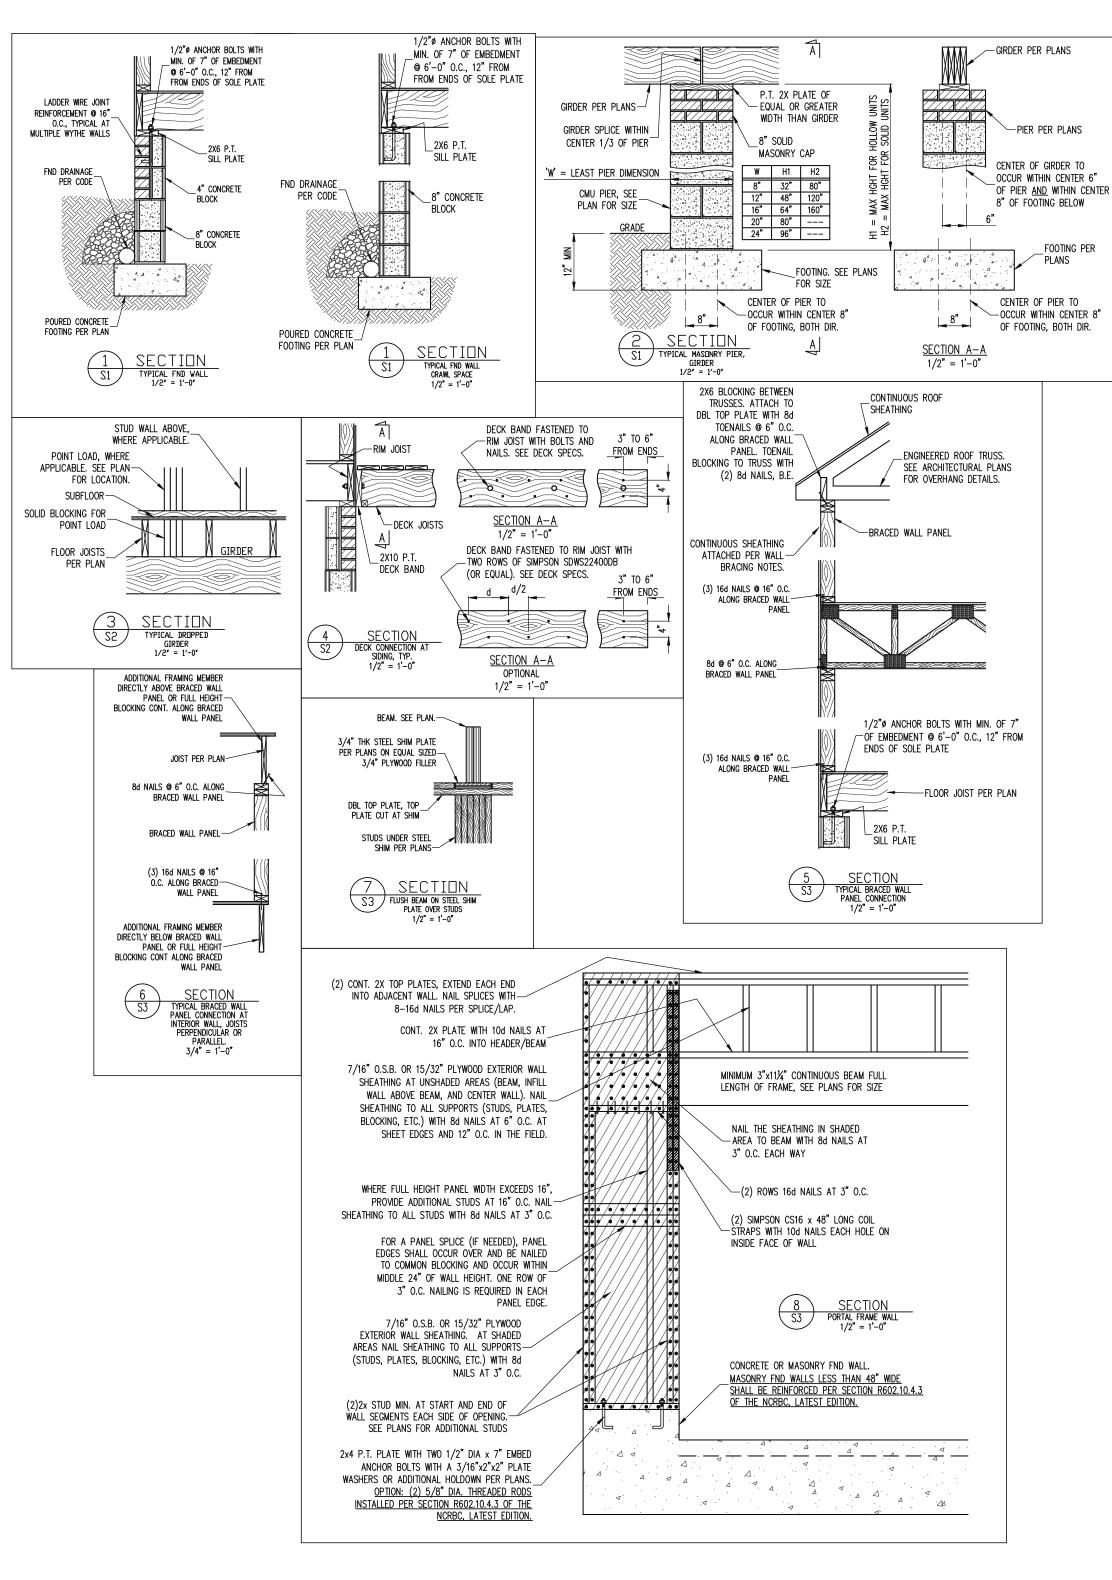

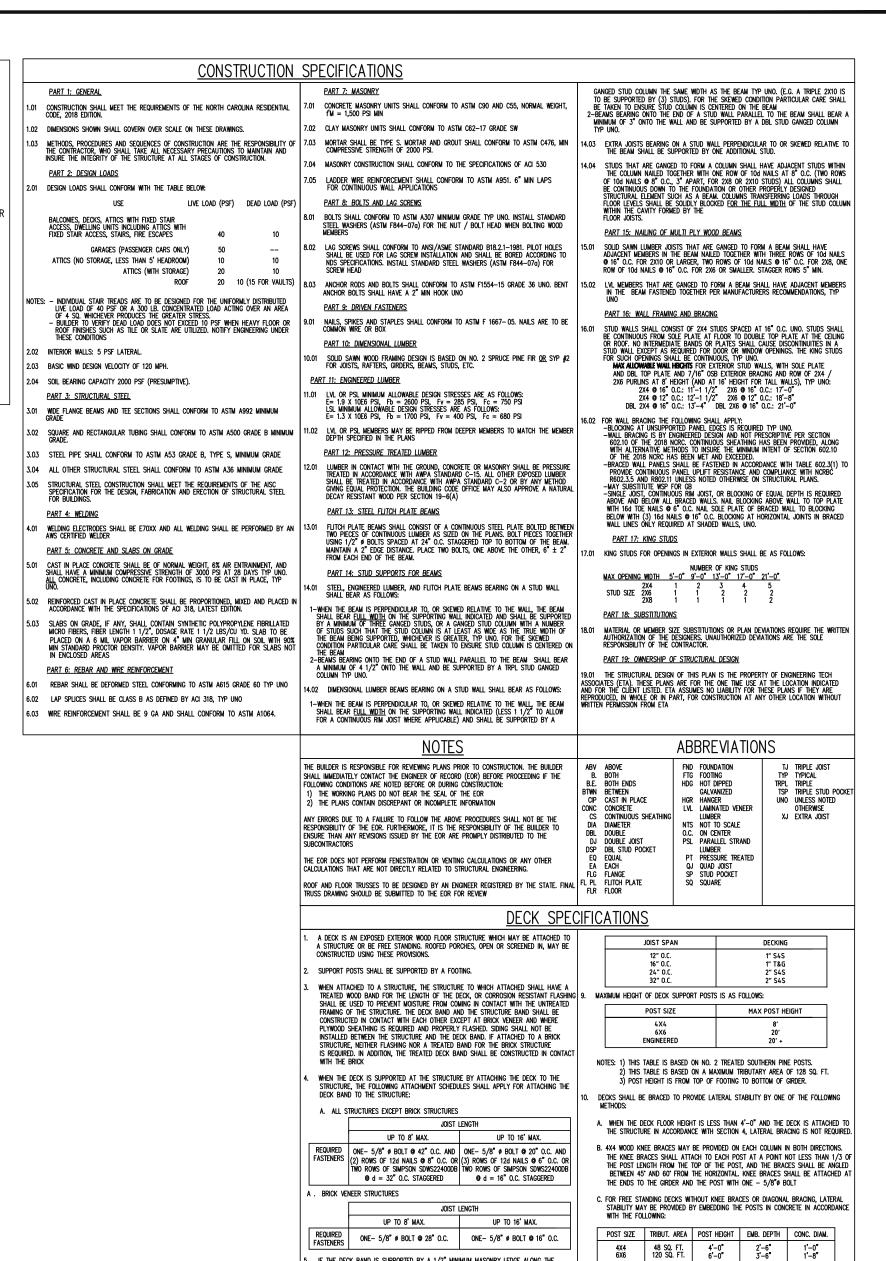

if the deck band is supported by a 1/2" minimum masonry ledge along the foundation wall, 5/8" ø bolts spaced Φ 48" o.C. May be used for support.

OTHER MEANS OF SUPPORT, SUCH AS JOIST HANGERS, MAY BE USED TO CONNECT DECK JOISTS TO A TREATED STRUCTURE BAND

GIRDERS SHALL BEAR DIRECTLY ON POSTS OR BE BE CONNECTED TO THE SIDES OF POSTS

Floor decking shall be no. 2 grade treated southern pine or equivalent. The minimum floor decking thickness shall be as follows:

C-3870 uite 201 27609 **ENGINEERS** No. C-3d d. Suite Carolina Ö North (

844-1661

(919)

License prook Ro STRUCTURAL Millbrook ≥ 318

Raleigh ech ASSOCIATES ngu

REF **ADDENDUM** RESIDENCE STRUCTURAL DELUDE SENTER 8 SCOPE: LOC:

ENG: NBG/JKM DATE: 7/23/2024

D. 2X6 DIAGONAL VERTICAL CROSS BRACING SHALL BE PROVIDED IN TWO PERPENDICULAR DIRECTIONS FOR FREE STANDING DECKS OR PARALLEL TO THE STRUCTURE AT THE EXTERIOR COLUMN LINE FOR ATTACHED DECKS. THE BRACES SHALL BE ATTACHED TO

3) NAILS MUST PENETRATE THE SUPPORTING STRUCTURE BAND A MINIMUM OF 1 1/2".

THE POSTS WITH ONE – $5/8\ensuremath{^{\prime\prime}}$ ø bolt at each end of the brace.

Notes: 1) all nails and bolts are to be hot dipped galvanized.

2) MINIMUM EDGE DISTANCE FOR BOLTS IS 2 1/2".

PROJECT NO.

24-18-394

SHEET NO. SD1