


DESIGN IS BASED ON THE 2018 NORTH CAROLINA RESIDENTIAL CODE

WOOD NOTES

1. LOG HOME STRUCTURAL MEMBERS SHALL BE NO. 1 EASTERN WHITE PINE.
2. DIMENSIONAL LUMBER SHALL BE NO. 2 SYP EXCEPT THAT STUDS SHALL BE NO. 1 SPF.
3. LVL MEMBERS SHALL BE GRADE 2.0E UNLESS NOTED OTHERWISE.
4. INTERIOR WALLS SHALL BE 1/2" GYPSUM BOARD EACH SIDE W/5d NAILS @ 7" O.C. ON EDGES & 7" O.C. INTERIOR (MIN.).

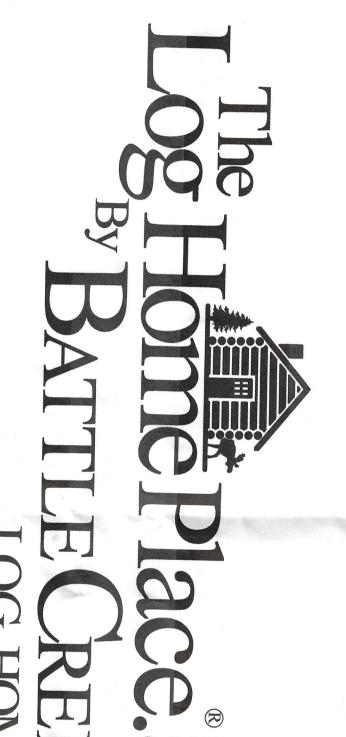

BUILDING RISK CATEGORY = 2

ROOF DEAD LOAD = 20 PSF

ROOF LIVE LOAD = 20 PSF

SNOW LOAD

GROUND SNOW LOAD (ASCE 7-16)= 10 PSF


HOUSE SNOW LOAD (HEATED) = 7 PSF


PORCH ROOF (w/ SLIDING) = 15 PSF

FLOOR LOADS: SLEEPING = 30 PSF OTHER = 40 PSF



ALLOWABLE SOIL BEARING PRESSURE ASSUMED: 2500 PSF FROST DEPTH (HARRETT CO.): 12"

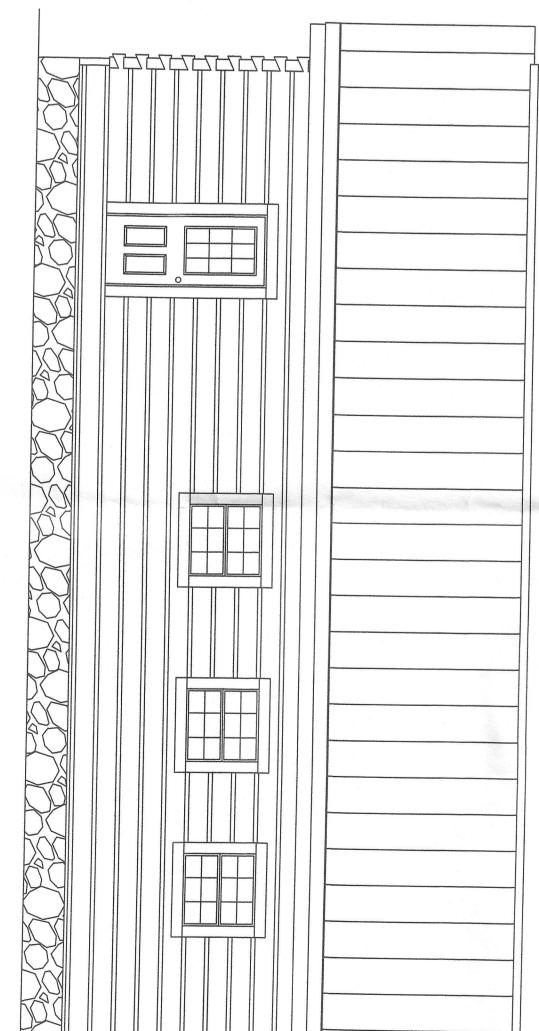

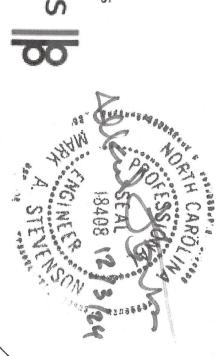

NORRIS RESIDENCE

GENERAL NOTES

WHERE A DETAIL IS SHOWN FOR ONE CONDITION IT SHALL APPLY FOR ALL LIKE OR OR SIMILAR CONDITIONS EVEN THOUGH NOT SPECIFICALLY MARKED ON THE DRAWINGS.
 DETAILS SHOWN ARE TYPICAL AND APPLY TO SIMILAR CONDITIONS UNLESS NOTED OTHERWISE.
 THESE DRAWINGS DO NOT INCLUDE NECESSARY COMPONENTS FOR CONSTRUCTION SAFETY.
 BRACE STRUCTURE AS REQUIRED FOR CONSTRUCTION AND WIND LOADS UNTIL ALL STRUCTURAL ELEMENTS NEEDED FOR STABILITY ARE INSTALLED.

FOUNDATION AND SOIL PREPARATION NOTES 1. BACKFILL AGAINST WALLS SHALL BE DEPOSITED EVENLY AGAINST BOTH SIDES OF THE WALL UNTIL THE LOWER FINAL GRADE IS REACHED. DO NOT BACKFILL WALLS UNTIL FLOOR FRAMING IS COMPLETE.

2. CONTRACTOR SHALL PROVIDE ADEQUATE BRACING OR SHORING FOR ALL WORK DURING THE CONSTRUCTION PERIOD.

3. THE FOUNDATION DESIGN IS BASED ON THE ASSUMED ALLOWABLE SOIL BEARING PRESSURE OF 2,500 POUNDS PER SQUARE FOOT. BEARING STRATUM FOR FOOTINGS SHALL BE VERIFIED IN FIELD BEFORE PLACING CONCRETE FOOTINGS.

4. BOTTOM OF ALL FOOTINGS SHALL BE A MINIMUM OF 12 INCHES BELOW FINAL FINISHED GRADE.


CAST-IN-PLACE CONCRETE NOTES 2. REINFORCING STEEL SHALL BE DOMESTIC DEFORMED BILLET STEEL CONFORMING TO ASTIM A-615 GRADE 60. #4 REINFORCEMENT BARS AND SMALLER SHALL BE COLD BENT WHENEVER BENDING IS REQUIRED. IN THE FIELD. REINFORCEMENT GREATER THEN A #4 BAR MAY NOT BE BENT IN THE FIELD WITHOUT APPROVAL.


3. WELDED WIRE FABRIC SHALL CONFORM TO ASTM A82 AND A185

4. PROVIDE CORNER BARS IN STRIP FOOTINGS. THE SAME SIZE AND NUMBER AS CONTINUOUS


5. WHERE REQUIRED, STEP NEW FOOTINGS UP OR DOWN IN RATIO OF THE TWO HORIZONTALS TO ONE VERTICAL TO JOIN EXISTING FOOTINGS, CAST STEPPED FOOTINGS MONOLITHICALLY.


6. DOWEL CONCRETE WALLS AND PEIRS INTO FOOTINGS WITH DOWELS THE SAME SIZE AND SPACING AS VERTICAL REINFORCEMENT. EXTEND DOWELS TO WITHIN 3" OF BOTTOM OF FOOTING, TERMINATED WITH ACT STD. 90 DEGREE HOOK, UNLESS OTHERWISE NOTED. 1. CONCRETE FOR FOOTINGS, SLABS, AND WALLS SHALL HAVE A 28 DAY DESIGN COMPRESSIVE STRENGTH OF 3,000 PSI. BASEMENT WALLS & FOUNDATIONS BY SUPPERIOR WALLS. 5. BEAR ALL FOOTINGS ON COMPACTED STRUCTURAL FILL OR NATIVE UNDISTURBED SOIL. 6. INSPECT AND CONFIRM EXISTING FOUNDATIONS AND WALLS ARE ACCEPTABLE CONDITION.

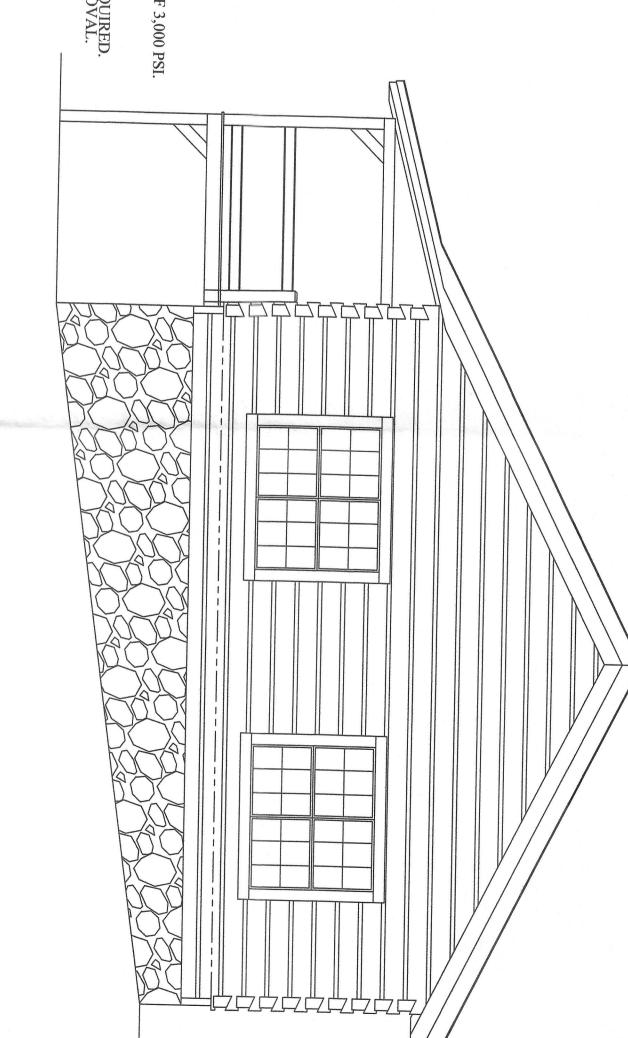


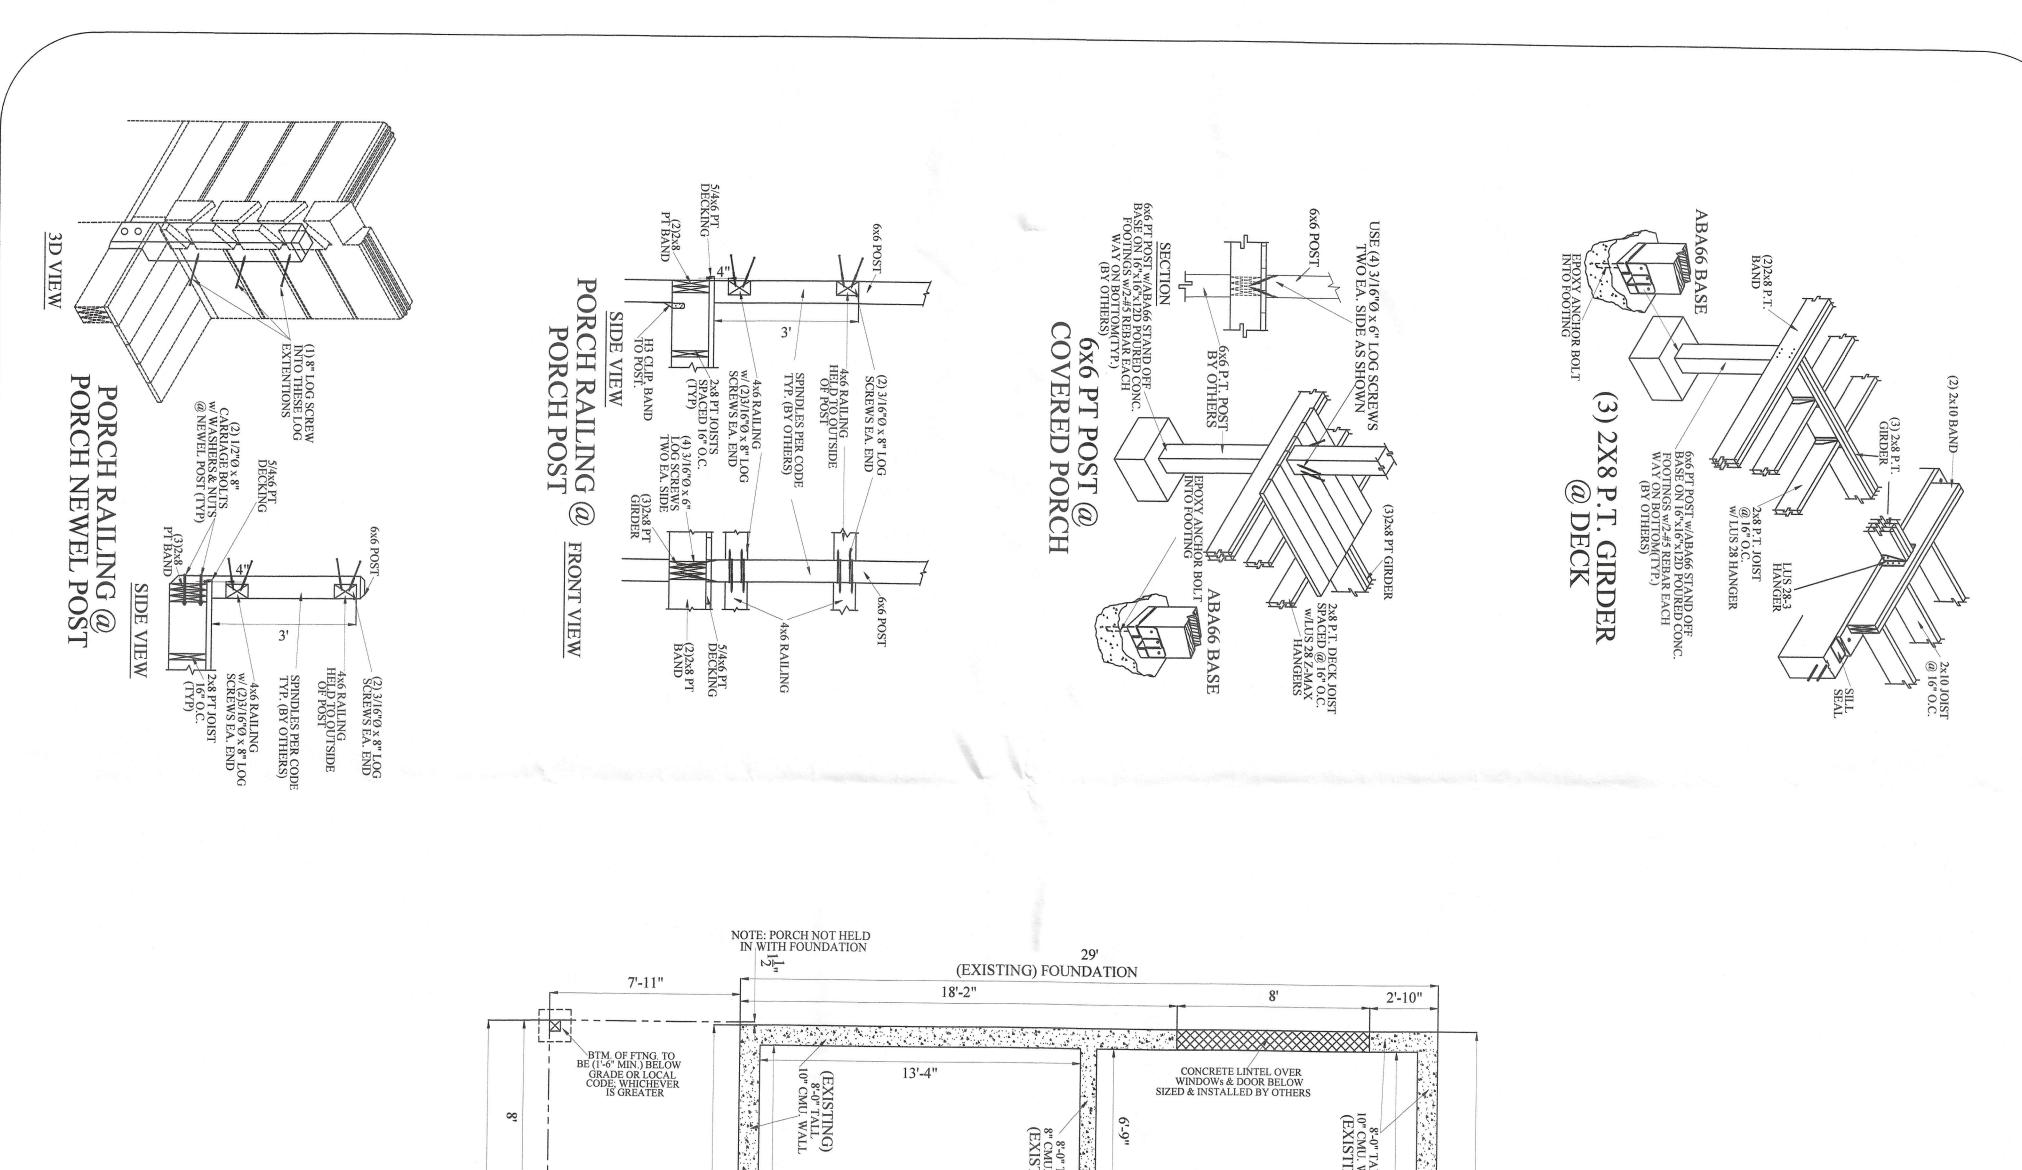

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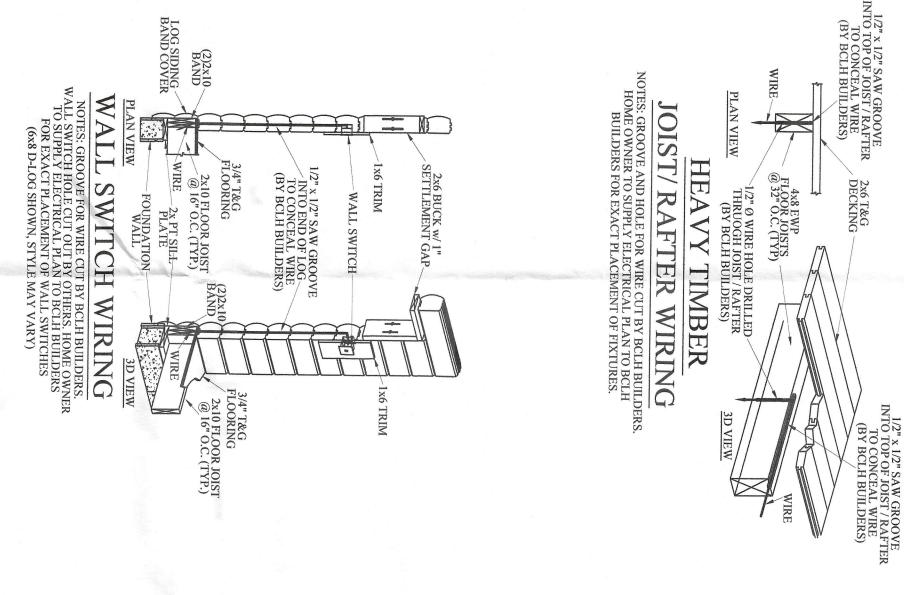
AFFIXED IS APPLICABLE FOR STRUCTURAL DESIGN

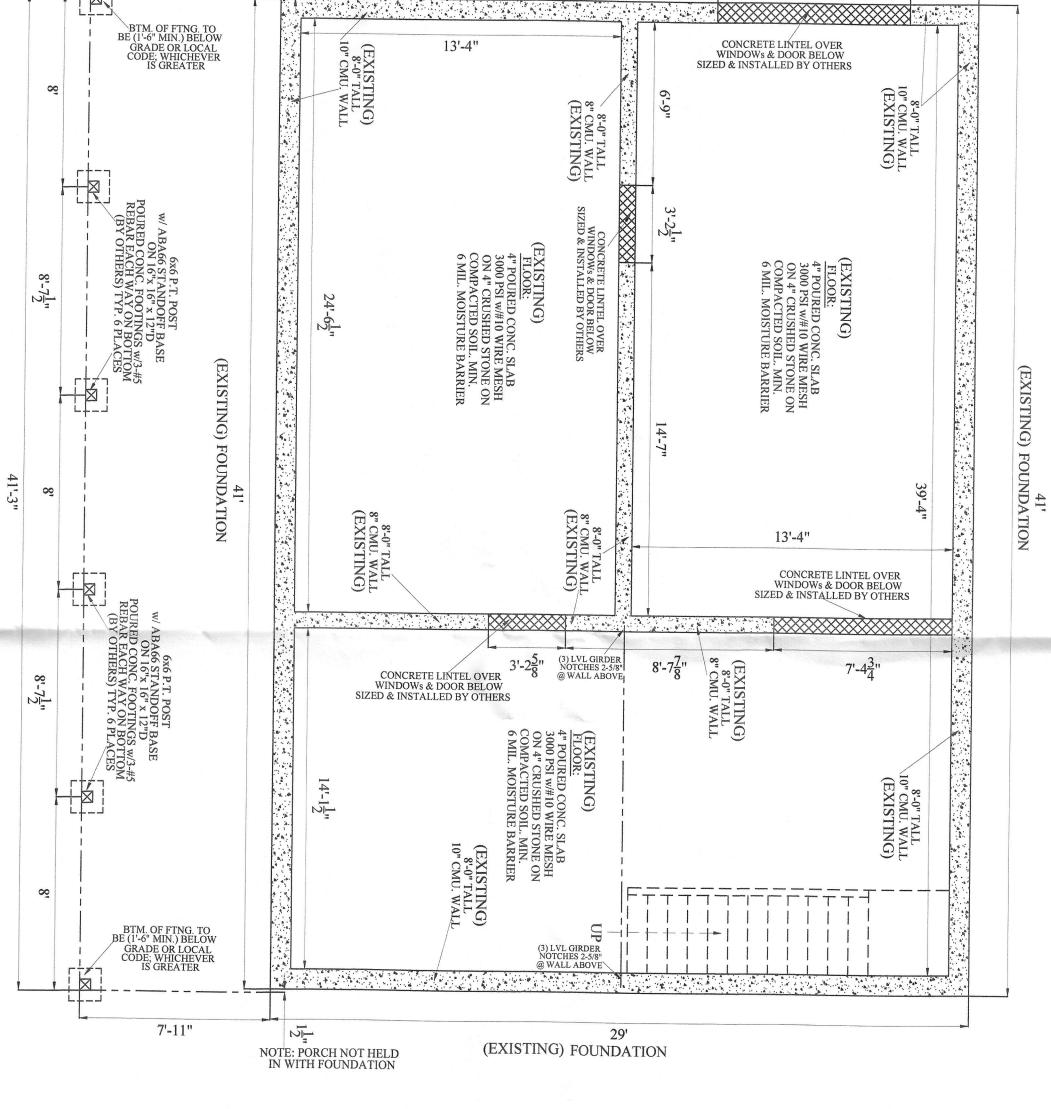& SIGNATURE

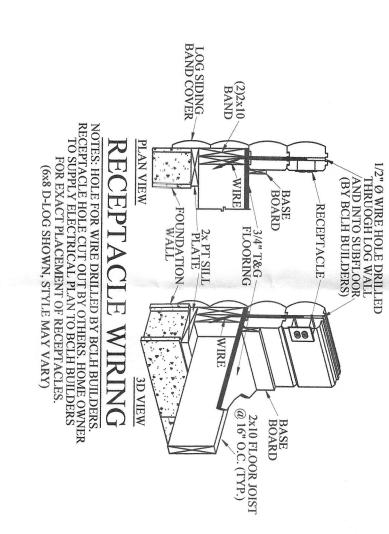FRAMING & NEW FOUNDATIONS

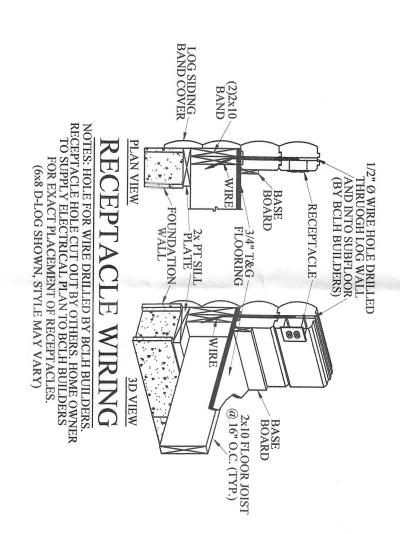nett&pless

		6								
DATE:		NAME:			(EXIS			#		
	(PLEASE PROVIDE HAND-WRITTEN SIGNATURE)		CUSTOMER APPROVAL:	SHEET NUMBER: 1 OF 5	(EXISTING) FOUNDATION PLAN	SHEET NAME:		REVISION / ISSUE DATE	SCALE: 1/4"= 1'-0"	12/03/24



WHILE EVERY EFFORT HAS BEEN MADE
TO PREVENT ERRORS OR OMISSIONS WHILE
PREPARING THIS PLAN, THE CONTRACTOR
MUST RECHECK ALL NOTES, DETAILS AND
DIMENSIONS AND BE RESPONSIBLE FOR SAME THESE DRAWINGS ARE THE PROPERTY OF BCLH. ANY USE, REUSE, REPRODUCTION, DISPLAY, OR SALE OF THESE DRAWINGS WITHOUT THE EXPRESS WRITTEN CONSENT OF BCLH IS STRICTLY PROHIBITED. RESIDENCE FOR: DISCLAIMER: COPYRIGHT LINDEN, NC DRAWN BY: LOG HOMES

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