LONGLEAF WAY **ABBREVIATIONS** A A PRESSURE TREATED WD HWD HARDWOOD (FL R&M RANGE W/MICROWAY LIV LIVING LTL LINTEL LVR LOUVER MAX MAXIMUM DRY DRYER MACHINE TEMP TEMPERED (GLASS U.N.O. UNLLGGOTHERWISE OA F.F. FINISH FLOOR (LINE OBS OBSCURE (GLA WH WATER HEATER FLR FLOOR(ING FP FIREPLACE OPT OPTIONAL WIC WALK-IN CLOSE FURRED(ING) PEDESTAL (SINK) W/W/O WITH or WITHOUT ROHND FAIL TERPROOF(ING) CIRCUIT INTERRU

GENERAL NOTES

1 - GENERAL BUILDING & DESIGN REQUIREMENTS

1) THE ATTACHED PLANS & SPECIFICATIONS ARE THE SOLE PROPERTY OF TRI POINTE HOMES ANY UNAUTHORIZED USE OF THESE PLANS WITHOUT PRIOR WRITTEN CONSENT OF TRI POINTE HOMES IS STRICTLY

2) TRI POINTE HOMES DESIGNS & BUILDS HOUSING AS SET FORTH BY THE FORMAT AND PROVISIONS OF TH INTERNATIONAL RESIDENTIAL CODE (IRC), AND THE NATIONAL ELECTRIC CODE (NEC). ANY NON-CONFORMING DOCUMENTS DISCOVERED BY THE CONTRACTOR OR HIS AGENTS SHALL BE CALLED TO THE IMMEDIATE ATTENTION OF TRI POINTE HOMES BY CALLING (469)329-0470.

). THESE PLANS ARE SUBJECT TO MODIFICATIONS TO MEET CODE REQUIREMENTS AND/OR TO FACILITATE MECHANICAL/ ELECTRICAL/ PLUMBING INSTALLATION AND/ OR TO IMPLEMENT DESIGN IMPROVEMENTS. ANY

INTENTION TO MODIFY THESE PLANS MUST BE APPROVED IN WRITING BY TRI POINTE HOMES
4) CONTRACTOR SHALL BE RESPONSIBLE FOR VERIFYING ALL DIMENSIONS AFFECTING CONTRACTOR'S PRODUCTS, INSTALLATIONS, OR FABRICATIONS IN THE FIELD PRIOR TO EXPEDITING THE CONSTRUCTION OF SUCH WORK. FIELD VERIFY ALL DIMENSIONS — DO NOT SCALE DRAWINGS! CONTRACTOR IS RESPONSIBLE FOR SURVEYING THE PROJECT AND BECOMING FAMILIAR WITH THE EXISTING CONDITIONS AND SCOPE OF WORK INCLUDING BUT NOT LIMITED TO SITE AND SOIL BEARING CONDITIONS.
5) ERRORS AND OMISSIONS WHICH MAY OCCUR IN THE CONTRACT DOCUMENTS SHALL BE BROUGHT TO THE

ATTENTION OF THE ARCHITECT, IN WRITING, AND WRITTEN INSTRUCTION SHALL BE OBTAINED PRIOR TO PROCEEDING WITH CONSTRUCTION. THE CONTRACTOR SHALL BE HELD RESPONSIBLE FOR ANY ERRORS, DISCREPANCIES, OR OMISSIONS FOR WHICH THE CONTRACTOR FAILED TO NOTIFY THE ARCHITECT PRIOR TO

2 - SITE CONSTRUCTION

BACK FILL SHALL BE FREE FROM VEGETATION AND CONSTRUCTION DEBRIS

) BACK FILL SHALL BE PLACED IN LIFTS AND COMPACTED IN SUCH A MANNER AS BACKFILL TO NOT DAN THE FOUNDATION WALLS OR ANY WATERPROOFING/ DAMPPROOFING MATERIALS.

3 - CONCRETE

1) SLOPE ON GARAGE SLAB SHALL BE 1/8" PER FOOT TOWARDS VEHICLE DOOR. SLOPE ON PORCH AND

4 - MASONRY

ALL EXTERIOR BRICK MUST MEET ASTM C-216 FOR "SW" CONDITIONS

) MASONRY VENEER SHALL BE ATTACHED TO SUPPORTING WALLS w/ CORRUGATED METAL TIES IN CCORDANCE WITH R703.7.4.1 - I.R.C. OR LOCAL CODE REQUIREMENTS

) WEEPHOLES SHALL BE PROVIDED ALONG THE OUTSIDE WYTHE OF EXTERIOR MASONRY WALLS AT 33" O.C. MAX, SHALL BE A MIN. OF 3/16" IN DIAMETER, AND LOCATED IMMEDIATELY ABOVE THE FLASHING PER 18703.7.6 – LR.C.

5 - METALS

6 - WOOD AND PLASTICS

7 - THERMAL & MOISTURE PROTECTION

) Fire stopping and/ or draft stopping shall meet the requirements of IRC R602.8. 2) Attic ventilation shall be provided at 1/300 th of the Area of the Space ventilated. Cross VANILATION WITH HALF OF THE VENTILATED AREA SHALL BE PROVIDED BY ROOF VENTS AND THE OTHER HALF BY SOFFIT VENTS. VENTS SHALL BE PLACED SO AS TO NOT ALLOW INFILTRATION OF RAIN OR SNOW.) PROVIDE APPROVED TILE BACKER DRYWALL FOR ALL SHOWER AND BATH SPACE) PROVIDE ATTIC VENTILATION PER IRC-R806.1

8 - DOORS AND WINDOWS

-) REVIEW ALL WINDOW HDR HEIGHTS PER PLATE HT. AND VERIFY W/ ELEVATIONS AND CORNICE DETAILS TEMPERED GLASS SHALL BE USED IN HAZARDOUS AREAS AS DESCRIBED IN SECTION R308.4 - LR.C.
- FRONT DOOR WIDTH PER IRC-R311.3
- GARAGE DOOR PER IRC-R309.1

FMERGENCY EGRESS SHALL MEET REQUIREMENTS OF SECTION R310 - LR C 2018 - SLEEPING ROOMS HALL HAVE AT LEAST ONE EGRESS OPENING OF NOT LESS THAN 5.7 SF AND A CLEAR OPENING OF NOT IFSS THAN 20" WIDE X 24" HIGH AND SHALL NOT BE MORE THAN 44" ABOVE THE FLOOR

15 - MECHANICALS

WOOD BUILT CHIMNEYS AND FIREPLACES SHALL BE INSTALLED PER MANUFACTURER'S INSTRUCTIONS AND RE SUBJECT TO MECHANICAL INSPECTION PER IRC SECTION R1002.1) EXTERIOR AIR INTAKE FOR COMBUSTION AIR PER IRC SECTION AS REQUIRED BY LOCAL MUNICIPALITY

16 - ELECTRICAL

ALL FLECTRICAL INSTALLATION SHALL MEET THE REQUIREMENTS OF THE NATIONAL ELECTRIC CODE (NEC). MATERIAL AND EQUIPMENT SHALL BEAR THE LABEL OF APPROVAL OF THE UNDERWRITERS ABORATORIES, INC.

) ELECTRICAL CONTRACTOR SHALL VERIFY SPACE REQUIRED FOR METER INSTALLATION BEFORE ONSTRUCTION AND SHALL NOTIFY GENERAL CONTRACTOR OF ANY DISCREPANCIES.

VERIFY LOCATION OF ALL RECEPTACLES FOR APPLIANCES WITH MANUFACTURER SPECIFICATIONS.

GROUND FAULT INTERRUPTS SHALL BE LOCATED PER THE NEC ALL SWITCHES SHALL BE INSTALLED AT 3'-6" ABOVE FINISHED FLOOR TO CENTERLINE OF SWITCH

VLESS NOTED OTHERWISE) ALL CONVENIENCE OUTLETS SHALL BE INSTALLED W/ CENTERLINE OF OUTLET LOCATED 1'-3" ABOVE

INISHED FLOOR UNLESS NOTED OTHERWISE ALL CONVENIENCE OUTLETS WITH SWITCHES TO BE SWITCH AT TOP ONLY.

ALL EXTERIOR WALL BRACKET FIXTURES SHALL BE INSTALLED AS NOTED ON PLANS.

APPROVED SMOKE DETECTORS SHALL BE LOCATED ON EVERY STORY OF THE DWELLING UNIT AS PER IRC CTION R317 (SEE SHEET B1.1 FOR LOCATIONS). WHERE MORE THAN ONE DETECTOR IS REQUIRED THEY SHALL BE INTERCONNECTED. POWER SOURCE SHALL BE BUILDING POWER w/ BATTERY BACKUP.)) CONDUCTORS SHALL BE OF COPPER.

GENERAL FRAMING SPECS AND CONSTRUCTION NOTES STAIRS:

) THE MAXIMUM RISER HEIGHT SHALL BE 7 3/4 INCHES AND THE MINIMUM TREAD DEPTH SHALL BE 10 CHES IN ACCORDANCE WITH SECTION I.R.C.

HANDRAILS HAVING MINIMUM AND MAXIMUM HEIGHTS OF 34 INCHES AND 38 INCHES SHALL BE OVIDED ON AT LEAST. ONE SIDE OF STAIRWAYS IN ACCORDANCE WITH SECTION R315.1 — I.R.C HANDRAIL AND BALUSTRADE (WHERE PRESENT) SHALL BE CONSTRUCTED. ACCORDING TO IRC. ALL REQUIRED HAND RAILS SHALL BE CONTINUOUS THE FULL LENGTH OF THE STAIRS W/ 2 OR MORE SERS FROM A POINT ABOVE THE THE TOP RISER OF A FLIGHT TO A POINT ABOVE THE LÓWEST RISER OF THE FLIGHT. ENDS SHALL BE RETURNED OR SHALL TERMINATE AT NEWEL POSTS OR SAFETY TERMINALS. ANDRAILS ADJACENT TO A WALL SHALL HAVE A SPACE OF NOT LESS THAN 1.5" BETWEEN THE WALL

WALLS:

) ALL DIMENSIONS ARE FROM FACE OF STUD TO FACE OF STUD. ALL STUDS ARE 3 1/2" UNLESS NOTED. LL DIMENSIONS PRESENTED HERE ARE FRAME DIMENSIONS ONLY.

I SEPARATION BETWEEN THE RESIDENCE AND THE GARAGE SHALL BE MAINTAINED BY INSTALLATION OF $rac{1}{2}"$ GYPSUM BOARD ON ALL COMMON WALLS. 2-STORY HOMES REQUIRE 5/8" TYPE X GYPSUM BOARD AT CARAGE CEILINGS WHERE HABITABLE ROOMS ARE PRESENT ABOVE.

FLOORS:

STRUCTURAL FLOOR MEMBERS SHALL NOT BE CUT, BORED, OR NOTCHED IN EXCESS OF THE LIMITATIONS ECIFIED IN IRC

) THE ENDS OF EACH JOIST, BEAM, OR GIRDER SHALL HAVE NOT LESS THAN 1.5 INCHES OF BEARING ON WOOD OR METAL AND NOT LESS THAN 3 INCHES ON MASONRY OR CONCRETE OR AS OTHERWISE SPECIFIED

) ALL DIMENSIONAL FLOOR JOISTS TO BE PER ENGINEER STRUCTURAL PLANS.

FRAMING:

ALL FRAMING DIMENSIONS TO FACE OF MEMBER.

ALL BEARING HEADERS TO BE PER ENGINEERING PLANS. FIRE STOPPING AND / OR DRAFT STOPPING SHALL MEET THE REQUIREMENTS OF IRC R602.8.

ROOF

HIP AND VALLEY RAFTERS SHALL BE SUPPORTED AT RIDGE DOWN TO BEARING PARTITION, CUT ENDS OF AFTERS SHALL BE FULLY SUPPORTED WALL AND RIDGE

REQUIRED VENTILATION AREAS CALCULATED AT 1/300 RATIO

SQUARE FOOTAGE

Elevation "B"

(Slab S.F.)	
Slab Area	Sq. Ft
FIRST FLOOR	1867
2 BAY GARAGE	433
PORCH	55
COVERED OUTDOOR LIVING	210
Total Slab Area	2565

(Outside of Frame S.F.)

A/C Area	Sq. Ft
FIRST FLOOR	186
Total A/C Area	1867
Non-A/C Area	Sq. Ft
2 BAY GARAGE	433
PORCH	55
COVERED OUTDOOR LIVING	210
Total Non-A/C Area	698

(Inside of Frame S.F.)

A/C Area	1810
FIRST FLOOR	1810

NOTE: ALL OPTIONAL SQUARE FOOTAGES LISTED ARE INDEPENDENT OF AND IN ADDITION TO BASE SQUARE FOOTAGES

BUILDING CODE COMPLIANCE

FLECTRICAL PLANS DESIGNED TO MEET OR EXCEED MINIMUM

CONSTRUCTION PLANS DESIGNED TO MEET OR EXCEED

MINIMUM CODE REQUIREMENTS OF 2018 LR (

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SHEET LEGEND	
SHEET NO.	TYPE OF SHEET/LAYOUT
"G0.01"	COVER SHEET & GEN. NOTES
"G0.11"	REVISIONS & SYMBOLS
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"A1.10B"	FIRST FLOOR PLAN - ELEVATION 'B'
"01.A10"	FLOOR PLAN OPTIONS
"01.A20"	2ND FLOOR PLAN OPTION
"A2.01B"	EXTERIOR ELEVATIONS — 'B'
"A2.02B"	EXTERIOR ELEVATIONS — 'B'
"A2.03B"	EXTERIOR ELEVATIONS - OPTIONS - 'B'
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"E1.11B"	1ST FLR. ELECTRICAL PLAN UPGRADE OPTIONS — ELEVATION 'B'
"01.E10"	1ST FLR. ELECTRICAL PLAN OPTIONS
"01.E11"	1ST FLR. ELECTRICAL PLAN UPGRADE OPTIONS
"01.E20"	2ND FLR. ELECTRICAL PLAN OPTION
"01.E21"	2ND FLR. ELECTRICAL PLAN UPGRADE OPTION

Serenity - Lot 281 - 5920-05 (Longleaf Way) - Elevation B

- *Loft Option
- *Gourmet Kitchen Layout
- *Primary Bath 1 w/ Shower Seat
- *Flex Space at Great Room
- *9080 Sliding Glass Door at Great Room
- *9080 Sliding Glass Door at Dinning Room
- *Primary Suite Tray Ceiling

*Open Rail at 1st to 2nd Floor

- *Bath 2 Shower ILO Tub
- *Outdoor Fireplace

SYMBOLS

++

SHOWER CONTROLS



DOINTEHOMES

BWd Business Operation 5440 Wade Park Blv Suite 400 Raleigh, NC 27607

GENERAL ઝ

SHEETSUBDIVISION:

09-30-24 Issue Date: ACC

ADDRESS: LOT:

5920-05

LONGLEAF WAY

G0.01

STONE VENEER

REVISION INDEX REL. # DESCRIPTION DATE DRAWN BY			DRAWN BY
5920-05	NEW PLAN	09/30/2024	ACC
	1 (MACC) 1 (MACC)	,,	
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1	

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HOMES

5440 WADE PARK BLVD, SUITE 400, RALEIGH, NG 27607

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REVISIONS & SYMBOLS
SUBDIVISION:
ADDRESS:
LOT:


Issue Date: 09-30-24

Drawn By: ACC

5920-05

PLAN NAME:
LONGLEAF WAY

G0.11

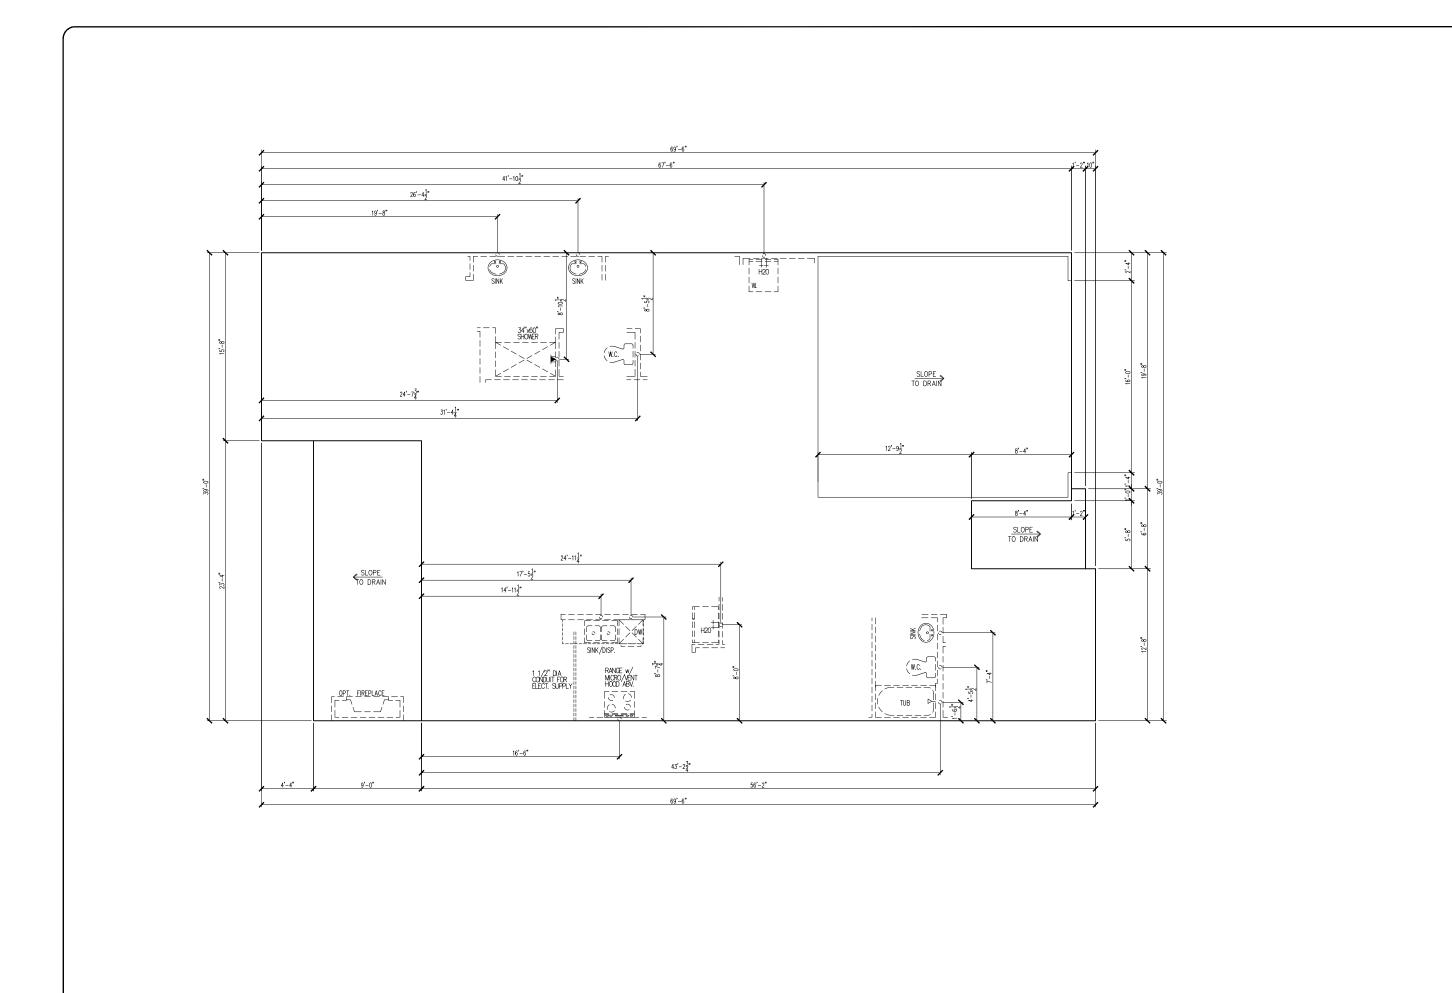

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H o M E S
5440 WADE PARK BLVD, SUITE 400, RALFIGH, NC 27607

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BASE FOUNDATION PLAN
SUBDIVISION:
ADDRESS:
LOT: BLOCK:

Date: 09-30

Issue Date: 09-30-24

Drawn By: ACC

5920-05


PLAN NAME:
LONGLEAF WAY

S1.10B

MAIN FLOOR NOTES

EXPLANATION

- ALL NON-DIMENSIONED PARTITIONS ARE 3-1/2" ROUGH
- ALL ANGLED PARTITIONS ARE 45 DEGREES UNLESS NOTED
- PROVIDE MIN. 2-2x12's w/ 1/2" PLYWD. FLITCH PLATE AT ALL EXTERIOR WALL OPENINGS & INTERIOR BEARING WALL OPENINGS
- ALL EXTERIOR DIM'S ARE TO FACE OF STUDS U.N.O.
- ALL TRUSSES TO BEAR ON EXTERIOR WALLS AND/OR GIRDER TRUSS U.N.O.
- TRUSS MFG. TO SIZE MEMBERS, FASTENERS, HANGERS & SET SPACING FOR ALL TRUSSES
- WINDOW SUPPLIER TO VERIFY AT LEAST ONE WINDOW IN ALL BEDROOMS TO HAVE A CLEAR EGRESS OPENING OF 5.7 SQ. FT. w/MIN DIM'S OF 24" IN HT AND 20" IN WIDTH; SILL HT NOT TO EXCEED 44" AFF
- ALL BALUSTER TO BE SPACED SUCH THAT A 4" SPHERE CANNOT PASS BETWEEN BALUSTER
- ALL ELEC. & MECH. EQUIPMENT & METERS ARE SUBJECT TO RELOCATION DUE TO FIELD CONDITIONS; CONTRACTOR TO VERIFY
- FOR ADDITIONAL NOTES, SEE GENERAL NOTES ON TITLE SHEET & DETAILS
- ALL TYP. WINDOWS 6'-0" IN HT AND SMALLER, THE HEAD HEIGHT SHALL BE 8'-10" ABOVE FINISHED FLOOR (U.N.O.)
- STRUCTURAL ENGINEERING PROVIDED BY OTHERS
- REFER TO INTERIOR ELEVATIONS SHEET TO VIEW BUBBLE
- INTERIOR DOOR HEIGHTS ARE PER SPEC FRONT & REAR PATIO DOOR TO BE 8'

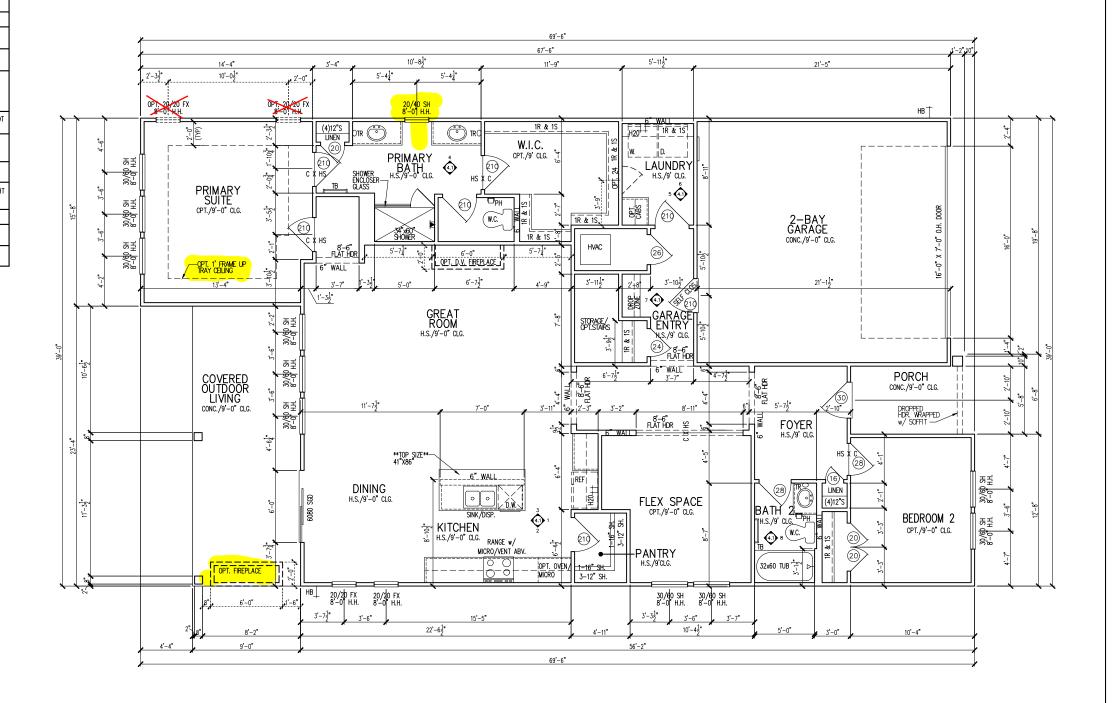



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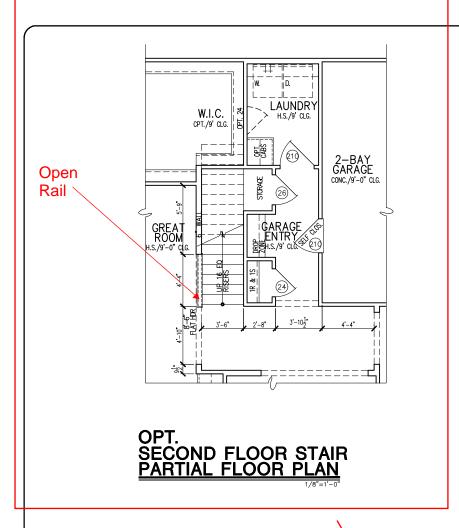
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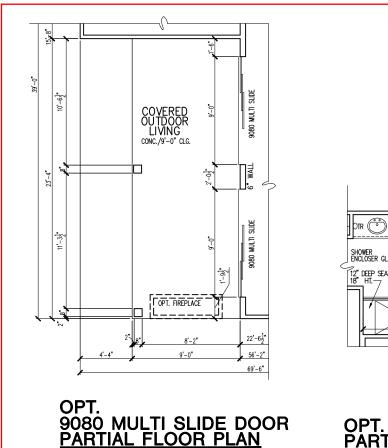
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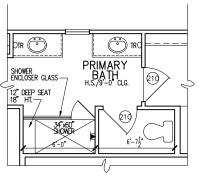
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LONGLEAF WAY


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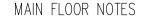






OPT. PRIMARY BATH PARTIAL FLOOR PLAN



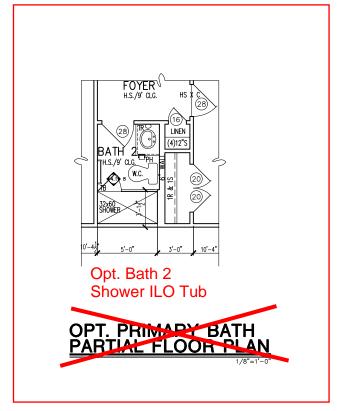

EXPLANATION

1. ALL NON-DIMENSIONED PARTITIONS ARE 3-1/2" ROUGH ALL ANGLED PARTITIONS ARE 45 DEGREES UNLESS NOTED

OTHERWISE (U.N.O.) PROVIDE MIN. 2-2x12's w/ 1/2" PLYMD. FLITCH PLATE AT ALL EXTERIOR WALL OPENINGS & INTERIOR BEARING WALL OPENINGS

ALL EXTERIOR DIM'S ARE TO FACE OF STUDS U.N.O.

ALL TRUSSES TO BEAR ON EXTERIOR WALLS AND/OR GIRDER TRUSS U.N.O.

TRUSS MFG. TO SIZE MEMBERS, FASTENERS, HANGERS & SET SPACING FOR ALL TRUSSES WINDOW SUPPLIER TO VERIFY AT LEAST ONE WINDOW IN ALL

BEDROOMS TO HAVE A CLEAR EGRESS OPENING OF 5.7 SQ. FT. w/MIN DIM's OF 24" IN HT AND 20" IN WIDTH; SILL HT NOT TO

ALL BALUSTER TO BE SPACED SUCH THAT A 4" SPHERE CANNO PASS BETWEEN BALUSTER

ALL ELEC. & MECH. EQUIPMENT & METERS ARE SUBJECT TO RELOCATION DUE TO FIELD CONDITIONS; CONTRACTOR TO

FOR ADDITIONAL NOTES, SEE GENERAL NOTES ON TITLE SHEET

ALL TYP. WINDOWS 6'-0" IN HT AND SMALLER, THE HEAD HEIGH SHALL BE 8'-10" ABOVE FINISHED FLOOR (U.N.O.)


STRUCTURAL ENGINEERING PROVIDED BY OTHERS

REFER TO INTERIOR ELEVATIONS SHEET TO VIEW BUBBLE CALLOUTS

INTERIOR DOOR HEIGHTS ARE PER SPEC - FRONT & REAR PATIO DOOR TO BE 8'


EXTENDED COVERED OUTDOOR LIVING OPT. FIREPLACE 13'-4" 56'-2"

OPT. EXTENDED COVERED OUTDOOR LIVING PARTIAL FLOOR PLAN

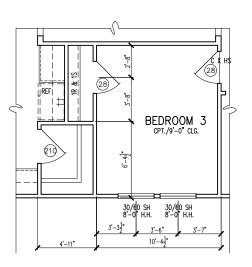


BEDROOM 3
PARTIAL FLOOR PLAN

69'-6"

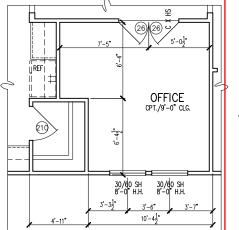

OPT. OFFICE PARTIAL FLOOR PLAN

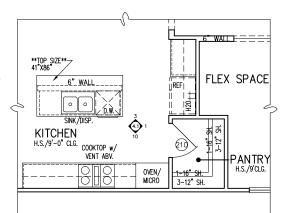

OPT. GOURMET KITCHEN - PARTIAL PARTIAL FLOOR PLAN

OPTIONS 1 PLAN FLOOR

Dointe S HOME S

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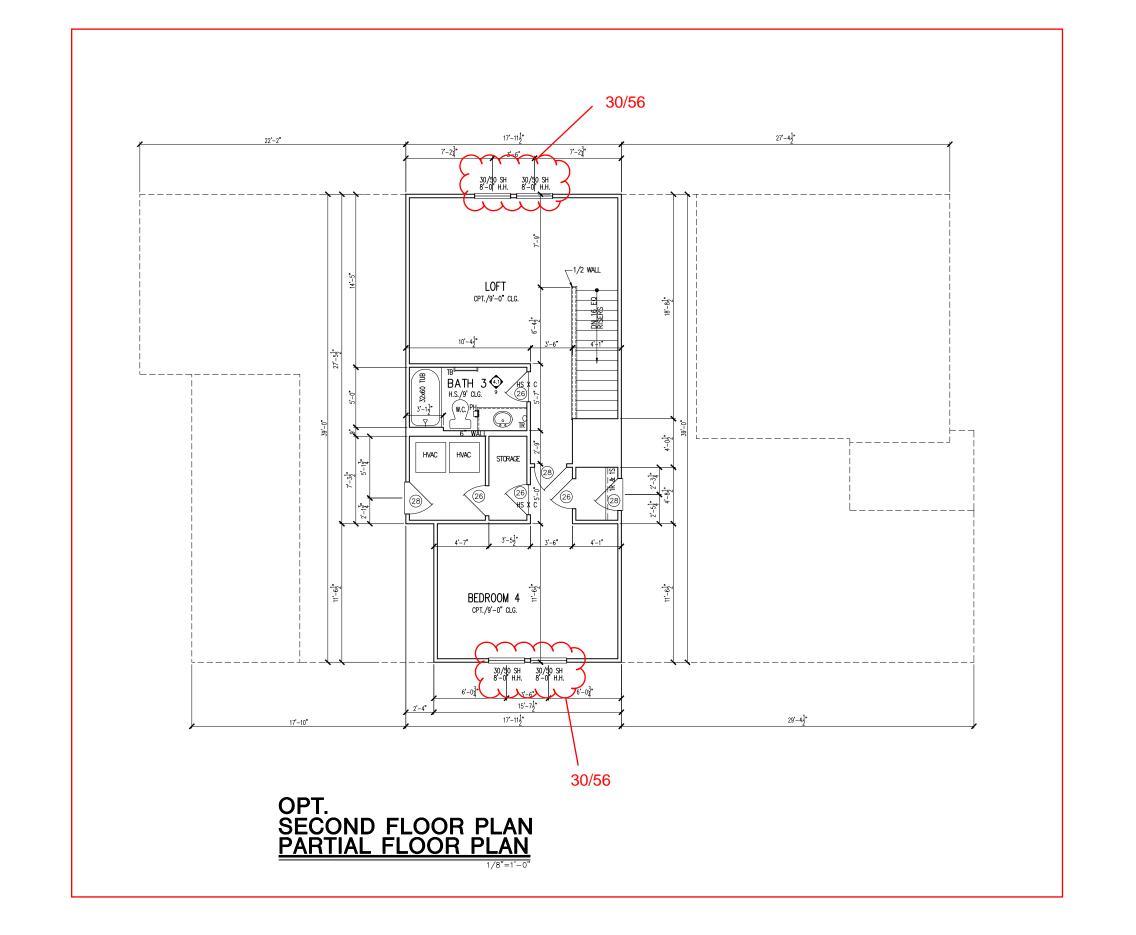
09-30-24 Issue Date: ACC

5920-05

LONGLEAF WAY

01.A10

MAIN FLOOR NOTES # EXPLANATION ALL NON-DIMENSIONED PARTITIONS ARE 3-1/2" ROUGH ALL ANGLED PARTITIONS ARE 45 DEGREES UNLESS NOTED OTHERWISE (U.N.O.) PROVIDE MIN. 2-2x12's w/ 1/2" PLYWD. FLITCH PLATE AT ALL EXTERIOR WALL OPENINGS & INTERIOR BEARING WALL OPENINGS 4. ALL EXTERIOR DIM'S ARE TO FACE OF STUDS U.N.O. ALL TRUSSES TO BEAR ON EXTERIOR WALLS AND/OR GIRDER TRUSS U.N.O. TRUSS MFG. TO SIZE MEMBERS, FASTENERS, HANGERS & SET SPACING FOR ALL TRUSSES WINDOW SUPPLIER TO VERIFY AT LEAST ONE WINDOW IN ALL BEDROOMS TO HAVE A CLEAR ECRESS OPENING OF 5.7 SQ. FT. w/MIN DIM's OF 24" IN HT AND 20" IN WIDTH; SILL HT NOT TO EXCEED 44" AFF ALL BALUSTER TO BE SPACED SUCH THAT A 4" SPHERE CANNOT PASS BETWEEN BALUSTER ALL ELEC. & MECH. EQUIPMENT & METERS ARE SUBJECT TO RELOCATION DUE TO FIELD CONDITIONS; CONTRACTOR TO VERIFY FOR ADDITIONAL NOTES, SEE GENERAL NOTES ON TITLE SHEET & DETAILS ALL TYP. WINDOWS 6'-0" IN HT AND SMALLER, THE HEAD HEIGHT SHALL BE 8'-10" ABOVE FINISHED FLOOR (U.N.O.) 12. STRUCTURAL ENGINEERING PROVIDED BY OTHERS REFER TO INTERIOR ELEVATIONS SHEET TO VIEW BUBBLE CALLOUTS INTERIOR DOOR HEIGHTS ARE PER SPEC - FRONT & REAR 14. INTERIOR DOOR HEIGHTS PATIO DOOR TO BE 8'



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HOMES

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2ND FLOOR PLAN – OPTION

3DIVISION:

SUBDIVISION:
ADDRESS:
LOT: BLOCK:

SUE ADD


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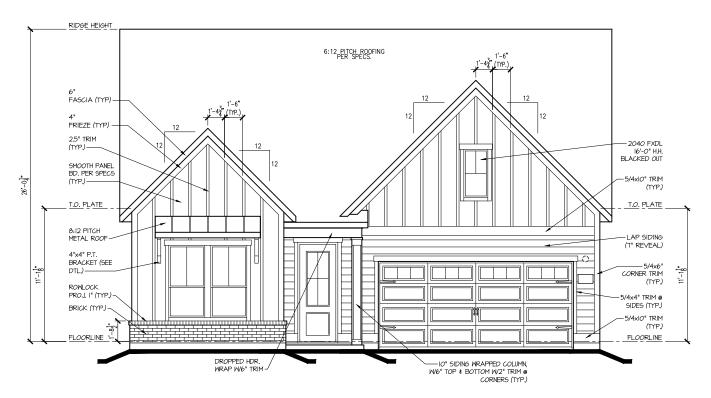
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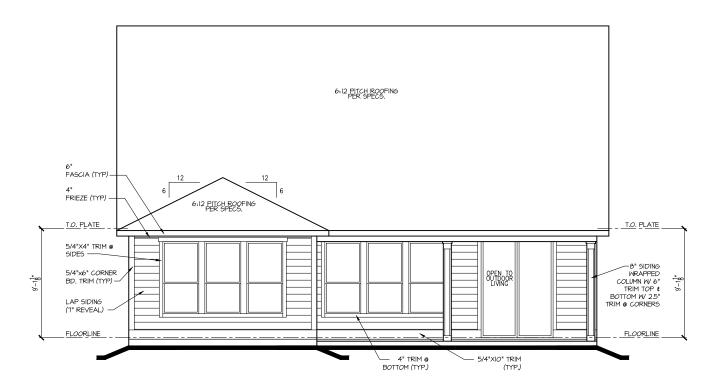
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BRACKET DETAIL



FRONT ELEV. "B"



REAR ELEV. "B"
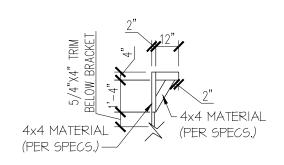
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EXTERIOR ELEVATIONS SUBDIVISION: ADDRESS: LOT: BI


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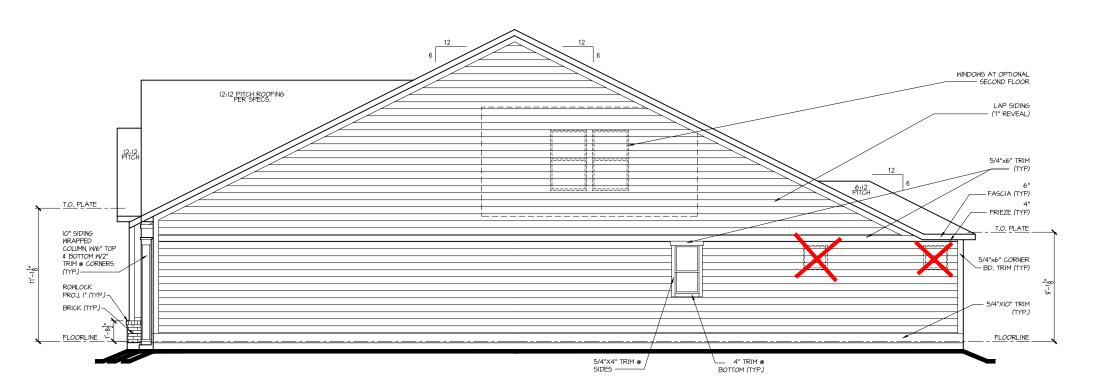
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LONGLEAF WAY

A2.01B



LEFT ELEV. "B"

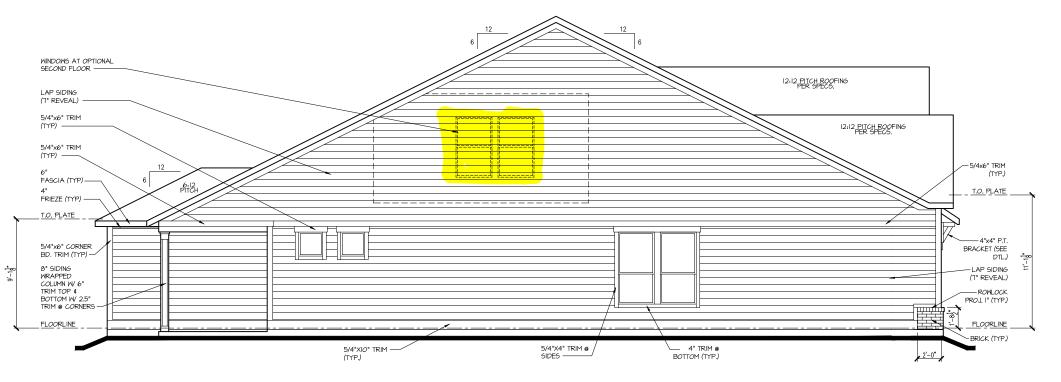

RIGHT ELEV. "B"

Dointe HOMES RR BLW, SUITE 400, RALEIGH, NG 27607

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EXTERIOR ELEVATIONS SUBDIVISION: ADDRESS: LOT: BI


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LONGLEAF WAY

A2.02B



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Business Operations 5440 Wade Park Blvd Suite 400 Raleigh, NC 27607


EXTERIOR ELEVATIONS – OPTIONS
SUBDIVISION:
ADDRESS:
LOT: BLOCK:

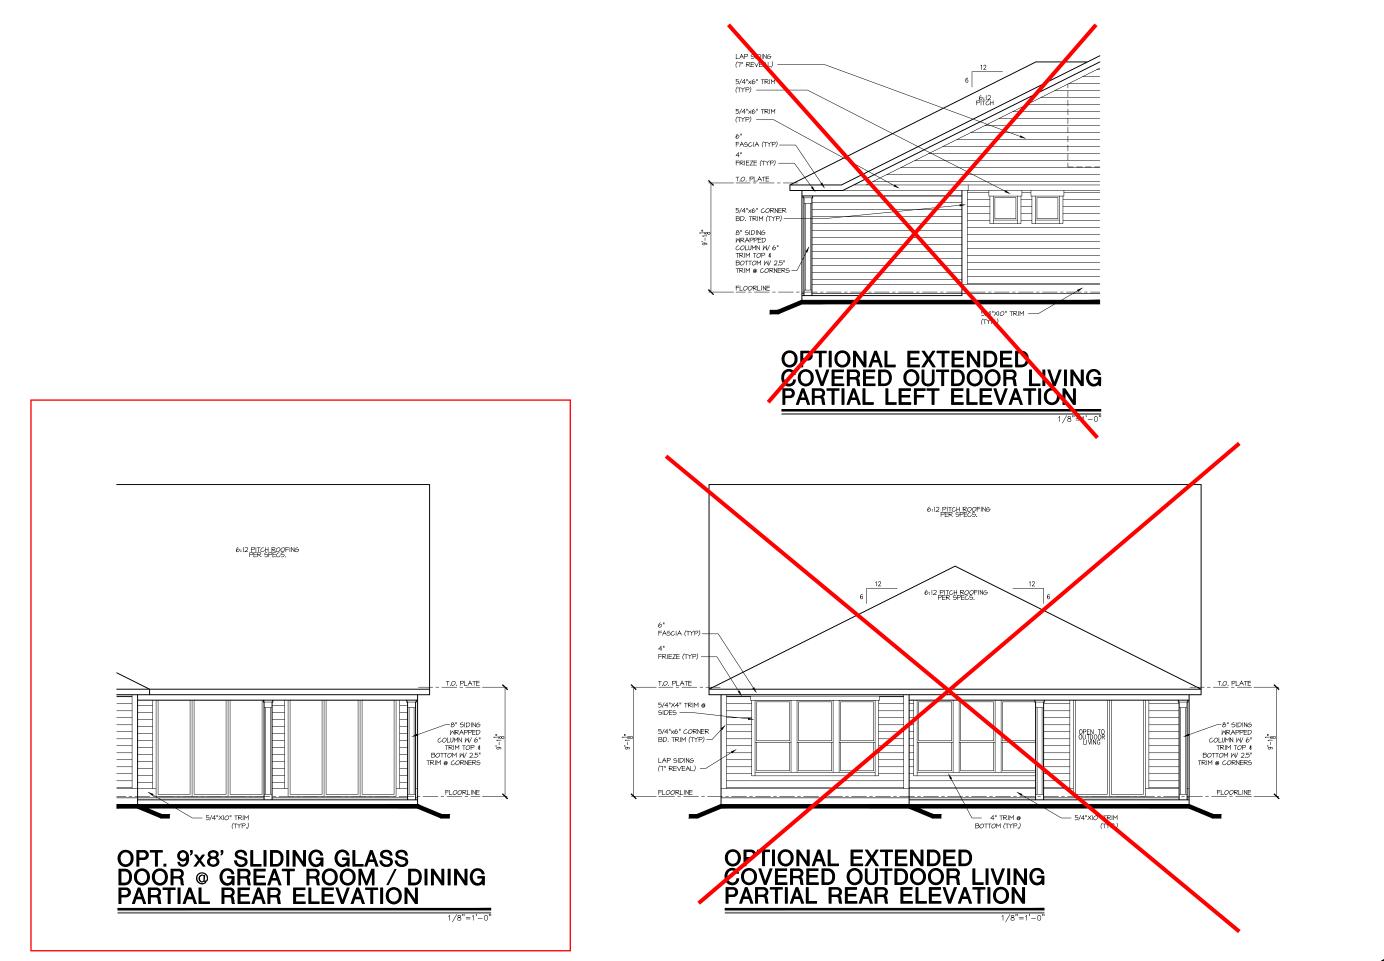issue Date: 09-30-24
Drawn By: ACC

PLAN #: 5920-05

LONGLEAF WAY

(A2.03B

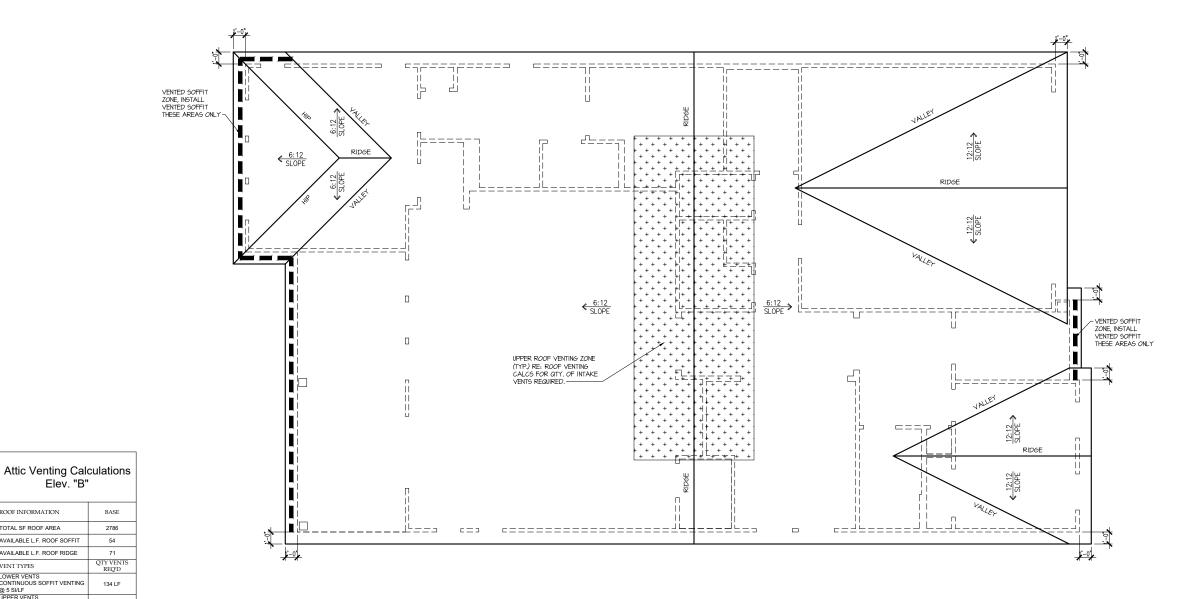

ROOF INFORMATION BASE 2786 TOTAL SF ROOF AREA AVAILABLE L.F. ROOF SOFFIT 54 71 QTY VENTS AVAILABLE L.F. ROOF RIDGE VENT TYPES VENT TYPES
LOWER VENTS
CONTINUOUS SOFFIT VENTING
@ 5 SILF
UPPER VENTS
SLANT 150 VENTS @ 150
SIVENT
UPPER VENTS
RIDGE VENTS @ 72 SI/VENT 134 LF

NOTE: QTY OF UPPER VENTS SHOWN COVERS 100% OF UPPER VENTING. NO MIXING OF VENT TYPES FOR UPPER VENTING IS FIGURED FOR IN THIS TABLE.



Dointe HOMES ** BLYD, SALEGH, NG 27807

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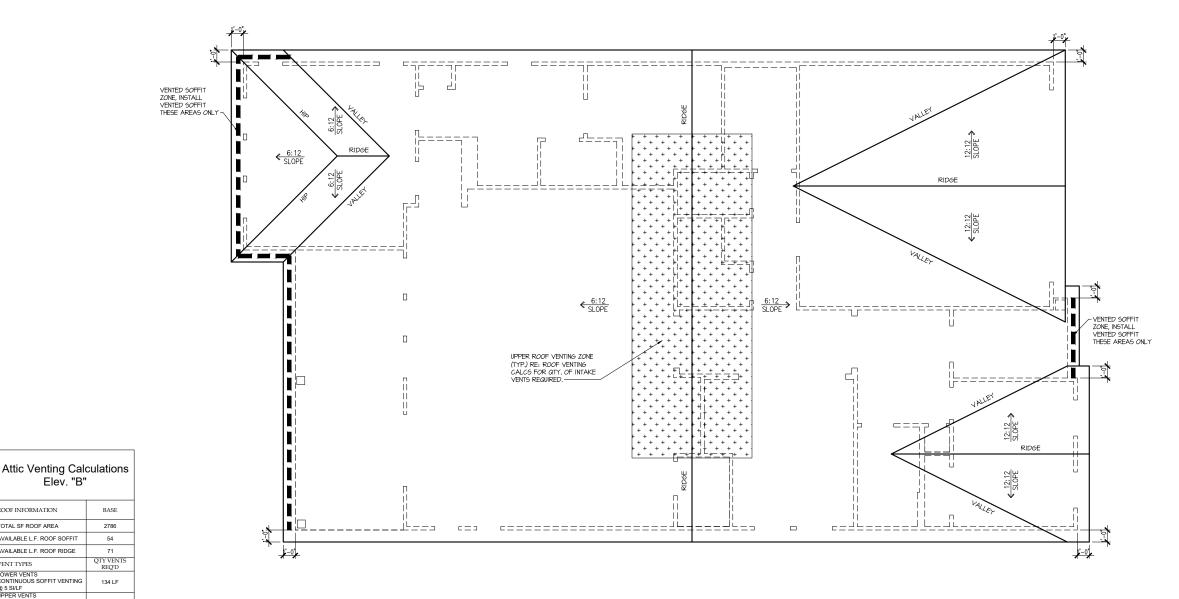
ROOF PLAN BLOCK: SUBDIVISION: ADDRESS: LOT: BI

Issue Date: 09-30-24 Drawn By: ACC

5920-05

LONGLEAF WAY

A3.01B





NOTE: QTY OF UPPER VENTS SHOWN COVERS 100% OF UPPER VENTING. NO MIXING OF VENT TYPES FOR UPPER VENTING IS FIGURED FOR IN THIS TABLE.



Dointe HOMES KRUD, SUITE 400, RALEIGH, NG 27607

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OPTION ROOF PLAN SUBDIVISION: ADDRESS: LOT: BI


Issue Date: 09-30-24 Drawn By: ACC

BLOCK:

5920-05

LONGLEAF WAY

A3.02B

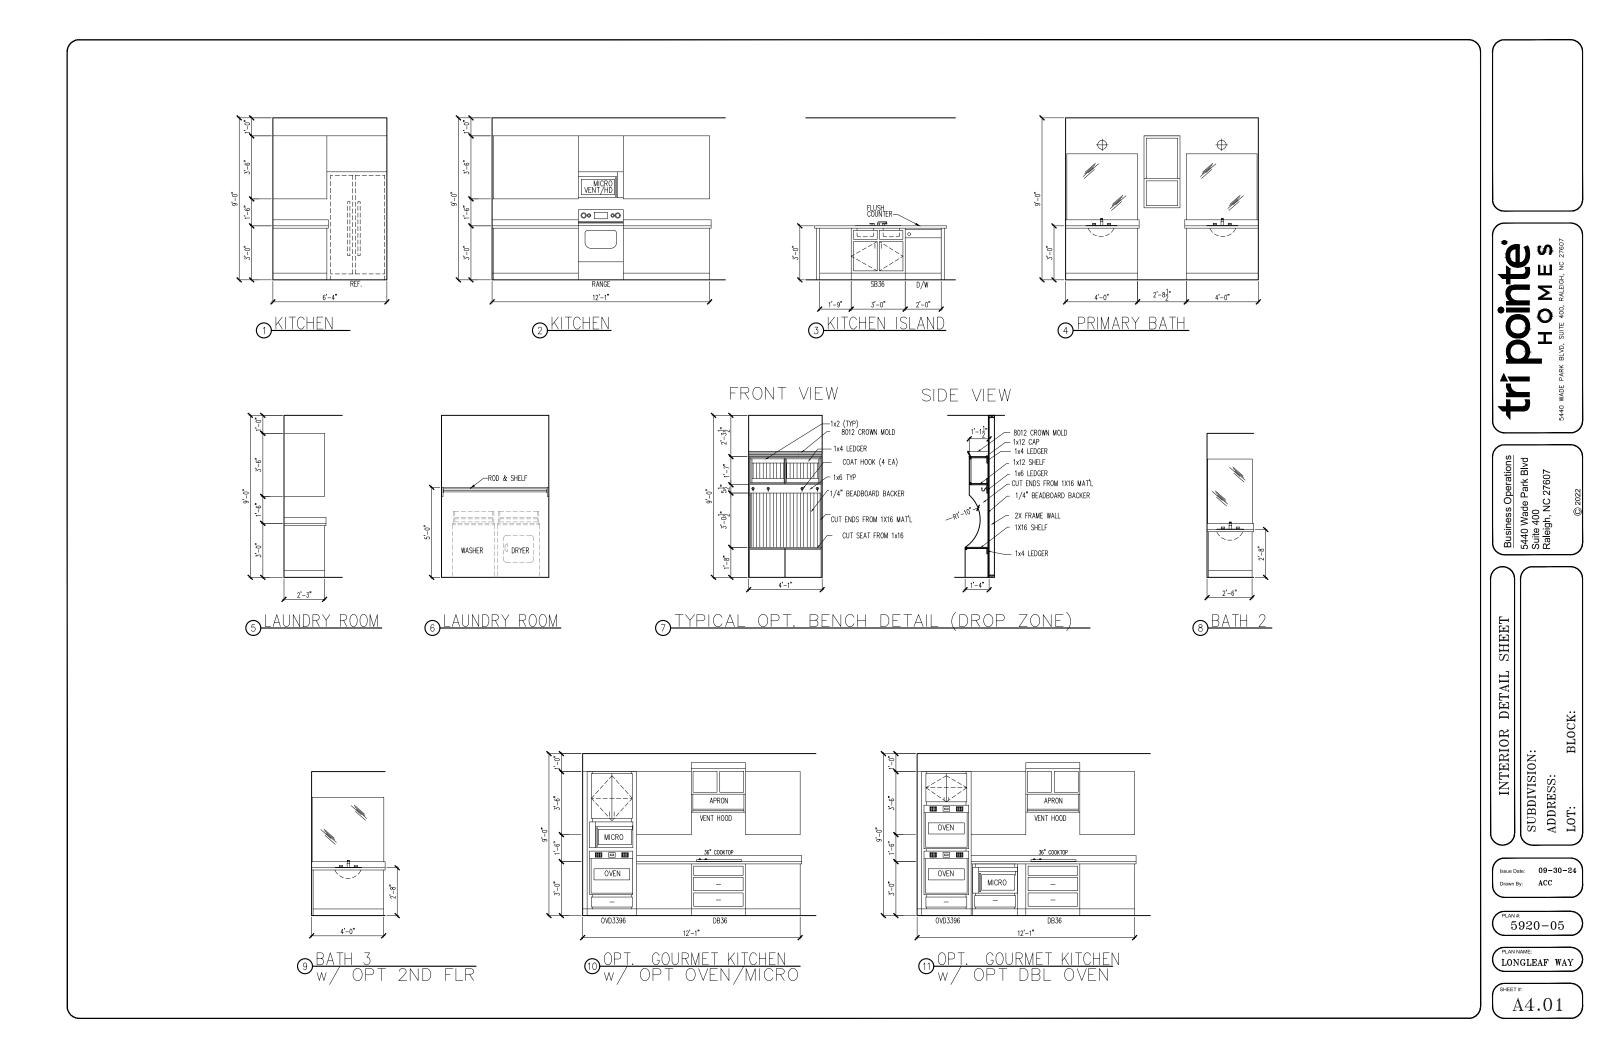

ELECTRICAL I SCHEDU	FIXTURE LE
DESCRIPTION	SYMBOL
110V OUTLET	Ф
220V OUTLET	₩ \$ 220
1/2 HOT OUTLET	₩ 220
GFI OUTLET	₩ GFI
WP GFI OUTLET	St WP/GFI
GARAGE DOOR OPENER OUTLET	Ø GDO
SECURITY SYSTEM	♦ SEC SYS
DISHWASHER	⊕ DW
JUNCTION BOX	D
CEILING MOUNTED LIGHT	
CEILING FAN w/ LIGHT KIT	BRAYING
RECESSED CEILING LIGHT	Ø
RECESSED WATER PROOF LIGHT	⊠ WP
WALL MOUNTED LIGHT	0
WALL MOUNTED PUSH BUTTON	₫ PB
TWO WAY SWITCH	\$
THREE WAY SWITCH	³\$
FOUR WAY SWITCH	\$
DIMMER SWITCH	\$ ^{DIM}
EXHAUST VENTS	O VENT TO EXT
LOW VOLTAGE PANEL	
PHONE OUTLET	● PH
TV OUTLET	⊕ TV
DATA & RG6 COMBO BOX	•
SMOKE DETECTOR	(G)
CARBON MONOXIDE SMOKE DETECTOR COMBO	⊚ CM/SD
DOOR CHIMES	CHIMES
ELECTRICAL PANEL	
SURFACE MOUNT LED	•
EXTERIOR WALL MOUNT UPLIGHT	88
SOFFIT MOUNT FLOOD LIGHT	4
UNDER COUNTER LIGHTING	-coo- UCL
SMURF TUBE	

ELECTRICAL NOTES:

- PROVIDE AND INSTALL LOCALLY CERTIFIED SMOKE AND CARBON MONOXIDE DETECTORS REQUIRED BY NATIONAL FIRE PROTECTION ASSOCIATION (NFPA) AND MEETING THE REQUIREMENTS OF ALL GOVERNING CODES.

 PROVIDE AND INSTALL GROUND FAULT (IRQUIT-INTERRUPTERS (GF)) AS REQUIRED BY NATIONAL ELECTRIC CODE (NEC) AND MEETING THE REQUIREMENTS OF ALL GOVERNING CODES.


 LECETRICAL CONTRACTOR TO PROVIDE REQUIRED DIRECT HOOK—UPS/CUTOFFS.

 HVAC CONTRACTOR TO VERIFY THERMOSTAT LOCATIONS.

 ALL ELECTRICAL AND MECHANICAL EQUIPMENT (I.E. FURNACES, A/C UNITS, ELECTRICAL PANELS, SANITARY SUMP PITS, DRAIN TILLE SUMP, AND WATER HEATERS) ARE SUBJECT TO RELOCATION WATER HEATERS) ARE SUBJECT TO RELOCATION

SANITARY SUMP PITS, DRAIN TILE SUMP, AND
WATER HEATERS) ARE SUBJECT TO RELOCATION DUE TO FIELD CONDITIONS.
ELECTRICAL DEVICES: ABOVE FINISHED FLOOR:
SWITCHES OVER COUNTER
WALL OUTLETS OVER COUNTER
+42" TO BOTTOM OF HORIZONTAL OUTLET(TYP. @ COUNTER)
REMAINING SWITCHES
WALL OUTLETS
BATH VANITY BRACKET OUTLET 1,2 (1° ABOVE TOP OF VANITY)
WATER SOFTENER AND SUMP OUTLETS 48" TO CL
EXTERIOR GFI OUTLETS
GARAGE GFI (ABOVE GARAGE FLOOR) 48" TO CL
FRONT DOOR COACH LIGHT
GARAGE DOOR COACH LIGHT, (ABOVE GARAGE FLOOR)
THERMOSTAT
DOORBELL CHIMES
DOORBELL BUTTON
KITCHEN HOOD FAN "WHIP"
KITCHEN WALL HUNG MICROWAVE OUTLET 72" TO CL
KITCHEN DISHWASHER RECEPTACLE UNDER SINK
KITCHEN RANGE
KITCHEN REFRIGERATOR
WASHER/DRYER OUTLET

CL = CENTER LINE 1 = FIELD VERIFY 2 = MASTER BATH STANDARD 30" HIGH VANITY TO BE RAISED 4"

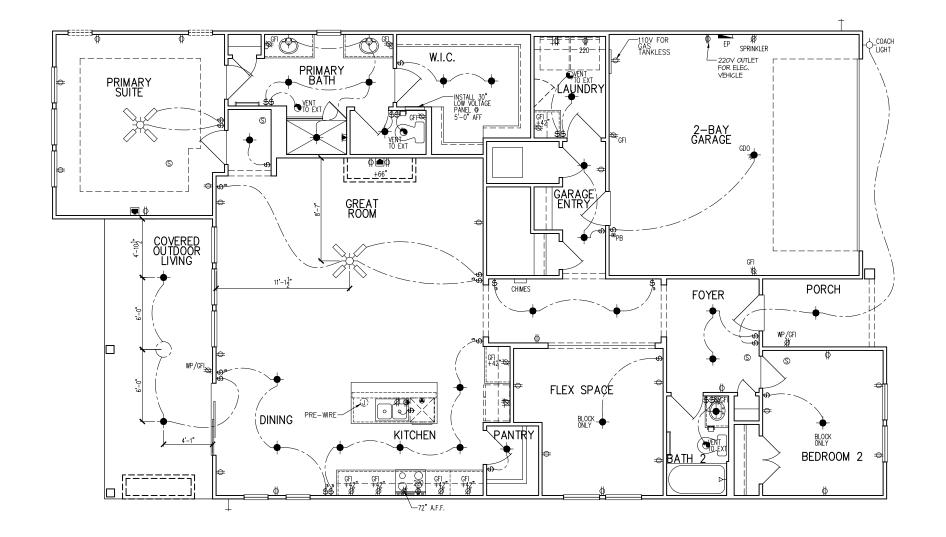

Dointe HOMES RR BLVD. SUITE 400, RALEGOH, NG 27/607

Business Operations 5440 Wade Park Blvd Suite 400 Raleigh, NC 27607

ELECTRICAL PLAN

1st FLOOR SUBDIVISION:
ADDRESS:
LOT: BI

Issue Date: 09-30-24 Drawn By: ACC

5920-05

LONGLEAF WAY

E1.10B

ELECTRICAL I SCHEDU	FIXTURE LE
DESCRIPTION	SYMBOL
110V OUTLET	Ф
220V OUTLET	Ф 220
1/2 HOT OUTLET	♦
GFI OUTLET	∜\$ GFI
WP GFI OUTLET	₩P/GFI
GARAGE DOOR OPENER OUTLET	Ø GDO
SECURITY SYSTEM	ΦSEC SYS
DISHWASHER	⊕DW
JUNCTION BOX	Ū
CEILING MOUNTED LIGHT	-
CEILING FAN w/ LIGHT KIT	BRACING
RECESSED CEILING LIGHT	Ø
RECESSED WATER PROOF LIGHT)m(WP
WALL MOUNTED LIGHT	φ
WALL MOUNTED PUSH BUTTON	e PB
TWO WAY SWITCH	\$
THREE WAY SWITCH	³\$
FOUR WAY SWITCH	⁴ \$
DIMMER SWITCH	\$ ^{DIM}
EXHAUST VENTS	SVENT TO EXT
LOW VOLTAGE PANEL	
PHONE OUTLET	● PH
TV OUTLET	● TV
DATA & RG6 COMBO BOX	
SMOKE DETECTOR	<u>\$</u>
CARBON MONOXIDE SMOKE DETECTOR COMBO	⊚ CM/SD
DOOR CHIMES	CHIMES
ELECTRICAL PANEL	EP EP
SURFACE MOUNT LED	•
EXTERIOR WALL MOUNT UPLIGHT	8
SOFFIT MOUNT FLOOD LIGHT	448
UNDER COUNTER LIGHTING	-coc- UCL
SMURF TUBE	

ELECTRICAL NOTES:


- 1. PROVIDE AND INSTALL LOCALLY CERTIFIED SMOKE AND CARBON MONOXIDE DETECTORS AS REQUIRED BY NATIONAL FIRE PROTECTION ASSOCIATION (NFPA) AND MEETING THE REQUIREMENTS OF ALL GOVERNING CODES
 2. PROVIDE AND INSTALL GROUND FAULT (IRCUITE-INTERRUPITERS (GF) AS REQUIRED BY NATIONAL ELECTRIC CODE (NEC) AND MEETING THE REQUIREMENTS OF ALL GOVERNING CODES.
 3. ELECTRICAL CONTRACTOR TO PROVIDE REQUIRED DIRECT HOOK—UPS/CUTOFFS.
 4. HVAC CONTRACTOR TO VERIFY THERMOSTAT LOCATIONS.
 5. ALL ELECTRICAL AND MECHANICAL EQUIPMENT (I.E. FURNACES, A/C UNITS, ELECTRICAL PANELS, SANITARY SUMP PITS, DRAIN TILE SUMP, AND WATER HEATERS) ARE SUBJECT TO RELOCATION DUE TO FIELD CONDITIONS.

WATER HEATERS) ARE SUBJECT TO RELOCATION DUE TO FIELD CONDITIONS.
ELECTRICAL DEVICES: ABOVE FINISHED FLOOR:
SWITCHES OVER COUNTER
WALL OUTLETS OVER COUNTER
REMAINING SWITCHES
WALL OUTLETS
BATH VANITY BRACKET OUTLET 1,2 (1" ABOVE TOP OF VANITY)
WATER SOFTENER AND SUMP OUTLETS 48" TO CL
EXTERIOR GFI OUTLETS
GARAGE GFI (ABOVE GARAGE FLOOR) 48" TO CL FRONT DOOR COACH LIGHT 80". JO CL
GARAGE DOOR COACH LIGHT, (ABOVE GARAGE FLOOR)
THERMOSTAT
DOORBELL BUTTON
KITCHEN HOOD FAN "WHIP"
KITCHEN WALL HUNG MICROWAVE OUTLET 72" TO CL
KITCHEN DISHWASHER RECEPTACLE JNDER SINK
KITCHEN RANGE
KITCHEN REFRIGERATOR
WASHER/DRYER OUTLET
CL = CENTER LINE

CL = CENTER LINE

1 = FIELD VERIFY

2 = MASTER BATH STANDARD 30" HIGH
VANITY TO BE RAISED 4"

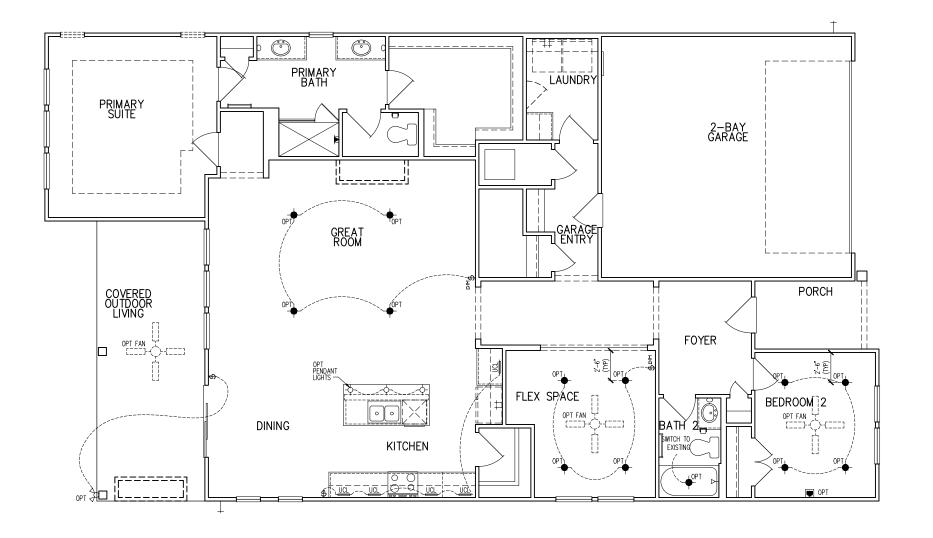

Dointe HOMES RR BLVD. SUITE 400. RALEGGH, NG 27/607

Business Operations 5440 Wade Park Blvd Suite 400 Raleigh, NC 27607

OPITONS 1st FLOOR ELEC. PLAN

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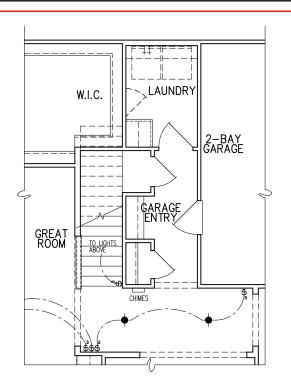
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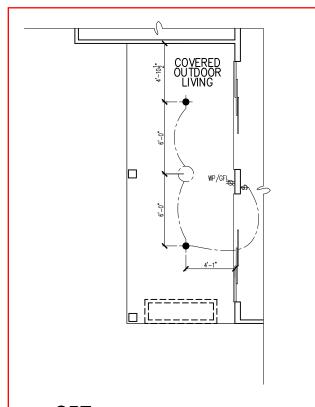
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LONGLEAF WAY


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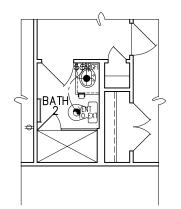
OPT. SECOND FLOOR STAIR PARTIAL ELECTRICAL PLAN



9080 MULTI SLIDE DOOR PARTIAL ELECTRICAL PLAN



OPT. PRIMARY BATH PARTIAL ELECTRICAL PLAN

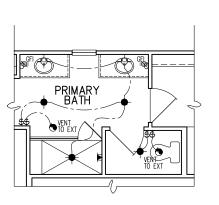

OPT. SHOWER ILO TUB PARTIAL ELECTRICAL PLAN

ELECTRICAL FIXTURE SCHEDULE DESCRIPTION SYMBOL 110V OUTLET 220V OUTLE 1/2 HOT OUTLET GFI OUTLET WP GFI OUTLET ₩P/GFI Ø GDO DISHWASHER JUNCTION BOX CEILING MOUNTED LIGHT BRACINE CEILING FAN w/ LIGHT KIT RECESSED WATER PROOF WALL MOUNTED LIGHT TWO WAY SWITCH THREE WAY SWITCH DIMMER SWITCH EXHAUST VENTS LOW VOLTAGE PANE TV OUTLET DATA & RG6 COMBO BOX CARBON MONOXIDE SMOR ⊚ CM/SE CHIMES DOOR CHIMES ELECTRICAL PANEL EP EP SURFACE MOUNT LE EXTERIOR WALL MOUNT
UPLIGHT
SOFFIT MOUNT FLOOD LIGH

ELECTRICAL NOTES:


PROVIDE AND INSTALL LOCALLY CERTIFIED SMOCK AND CARBON MONOMID DETECTORS REQUIRED BY AMONAL RIFE PROTECTION ASSOCIATION (NFP.) AND METING THE ST. PROVIDE AND INSTALL GROUND FAULT GROUT—INTERRUPTERS (GP) AS REQUIRED BY AN

HVAC CONTRACTOR TO VERIFY THERMOSTAT
LOCATIONS. TO VERIFY THERMOSTAT
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LOC GARAGE DOOR COACH LIGHT, (ABOVE GARAGE FLOOR).... . 84". TO CL LEVEL W/ DR HANDLE .66". TO CL .72" TO CL .UNDER SINK .24". TO CL .48". TO CL .48". TO CL DOORBELL BUTTON.
KITCHEN HOOD FAN "WHIP".
KITCHEN HOOD FAN "WHIP".
KITCHEN WALL HUNG MICROWAYE OUTLET.
KITCHEN IN BANKSHER RECEPTACLE.
KITCHEN RANGE.
KITCHEN REFRIGERATOR.
WASHER/DRYER OUTLET.

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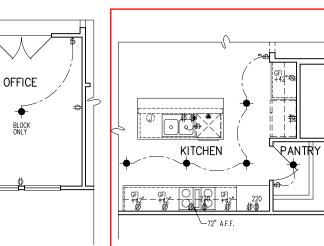
EXTENDED COVERED OUTDOOR LIVING

OPT EXTENDED
COVERED OUTDOOR LIVING
PARTIAL ELECTRICAL PLAN

BEDROOM 3 - PARTIAL ELECTRICAL PLAN

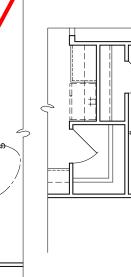BEDROOM 3

OPT. OFFICE - PARTIAL ELECTRICAL PLAN



OPT. GOURMET KITCHEN - PARTIAL ELECTRICAL PLAN

Dointe S H O M E S


Business Operations 5440 Wade Park Blvd Suite 400 Raleigh, NC 27607

OPTIONS PLAN SUBDIVISION:
ADDRESS:
LOT: B1 ELEC.

09-30-24 Issue Date: ACC

5920-05

LONGLEAF WAY

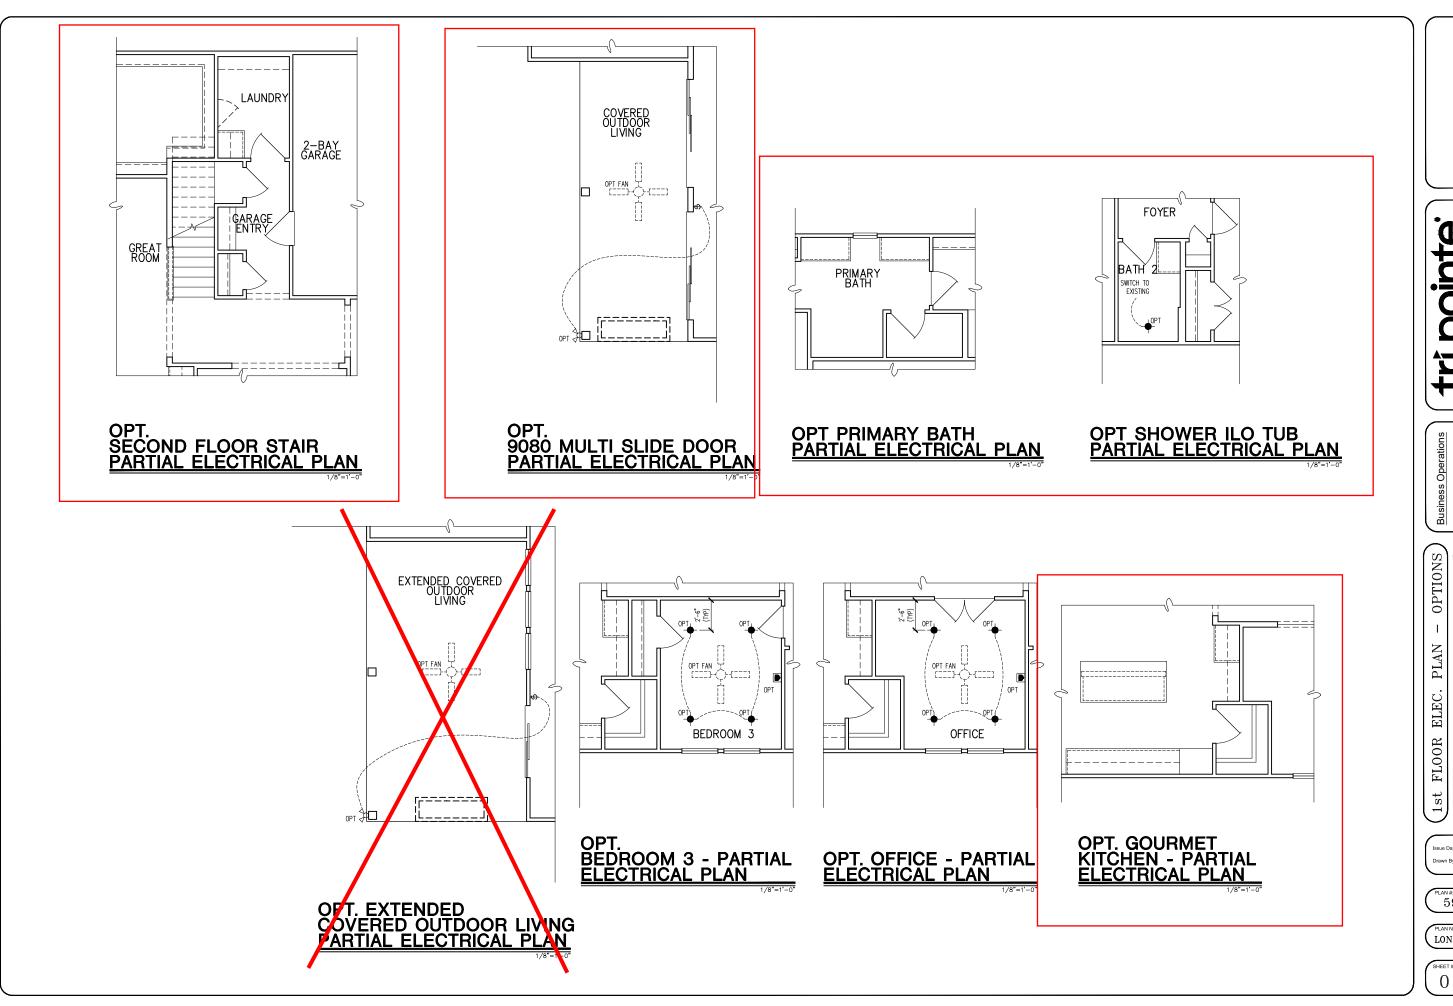

Dointe HOMES RR BLVD, SUITE 400, RALEIGH, NG 27607 4

Business Operations 5440 Wade Park Blvd Suite 400 Raleigh, NC 27607

SUBDIVISION:
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09-30-24 Issue Date: ACC

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LONGLEAF WAY


ELECTRICAL I SCHEDU	FIXTURE LE
DESCRIPTION	SYMBOL
110V OUTLET	ф
220V OUTLET	Ф 220
1/2 HOT OUTLET	•
GFI OUTLET	∜ GFI
WP GFI OUTLET	₩P/GFI
GARAGE DOOR OPENER OUTLET	Ø GDO
SECURITY SYSTEM	♦ SEC SYS
DISHWASHER	⊕DW
JUNCTION BOX	(I)
CEILING MOUNTED LIGHT	-
CEILING FAN w/ LIGHT KIT	BRACING
RECESSED CEILING LIGHT	Ø
RECESSED WATER PROOF LIGHT) ⊠ WP
WALL MOUNTED LIGHT	Ŷ
WALL MOUNTED PUSH BUTTON	å PB
TWO WAY SWITCH	\$
THREE WAY SWITCH	* \$
FOUR WAY SWITCH	* \$
DIMMER SWITCH	\$ ^{DIM}
EXHAUST VENTS	S VENT TO EXT
LOW VOLTAGE PANEL	
PHONE OUTLET	● PH
TV OUTLET	⊗ TV
DATA & RG6 COMBO BOX	
SMOKE DETECTOR	\$
CARBON MONOXIDE SMOKE DETECTOR COMBO	⊚ CM/SD
DOOR CHIMES	CHIMES
ELECTRICAL PANEL	EP EP
SURFACE MOUNT LED	•
EXTERIOR WALL MOUNT UPLIGHT	8
SOFFIT MOUNT FLOOD LIGHT	44 ⁵
UNDER COUNTER LIGHTING	UCL
SMURF TUBE	

ELECTRICAL NOTES:

PROVIDE AND INSTALL LOCALLY CERTIFIED SMOKE AND CARBON MONOXIDE DETECTORS A REQUIRED BY NATIONAL FIRE PROTECTION ASSOCIATION (NFPA) AND MEETING THE REQUIREMENTS OF ALL GOVERNING CODES PROVIDE AND INSTALL GROUND FAULT (IRCUIT-INTERRUPTERS (GFI) AS REQUIRED BY NATIONAL ELECTRIC CODE (NEC) AND MEETING THE REQUIREMENTS OF ALL GOVERNING CODES. ELECTRICAL CONTRACTOR TO PROVIDE REQUIRED DIRECT HOOK—UPS/CUTOFFS.

HVAC CONTRACTOR TO VERIFY THERMOSTAT LOCATIONS.
ALL ELECTRICAL AND MECHANICAL EQUIPMENT (I.E. FURNACES, A/C UNITS, ELECTRICAL PANELS, SANITARY SUMP PITS, DRAIN TILE SUMP, AND WATER HEATERS) ARE SUBJECT TO RELOCATION DUE TO FIELD CONDITIONS.

ELECTRICAL DEVICES. ABOVE FINISHED FLOOR. +42" TO BOTTOM OF HORIZONTAL OUTLET(TYP. @ COUNTER) REMAINING SWITCHES. 48³. TO. CL
WALL OUTLETS. 12." TO CL
BATH VANITY BRACKET OUTLET. J.2
(1' ABOVE TOP OF VANITY) GARAGE DOOR COACH LIGHT, (ABOVE GARAGE FLOOR). . . . THERMOSTAT LEVEL W/ DR .HANDLE DOORBELL BUTTON. . . . CL = CENTER LINE 1 = FIELD VERIFY 2 = MASTER BATH STANDARD 30" HIGH VANITY TO BE RAISED 4"

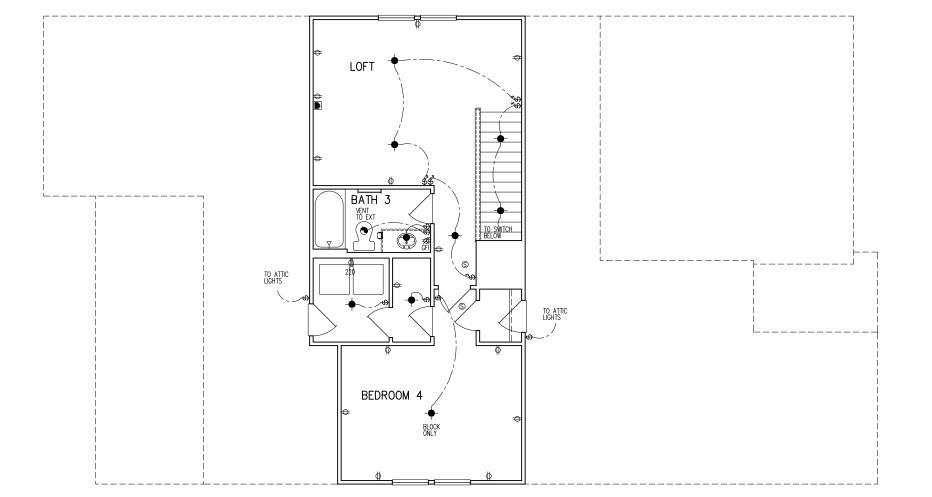

OPT. SECOND FLOOR PLAN PARTIAL ELECTRICAL PLAN tribointe.

HOMES

S440 WADE PARK BLVD. SUITE 400, RALEIGH, NC 27607

Business Operations 5440 Wade Park Blvd Suite 400 Raleigh, NC 27607

PLAN - OPTION

FLR ELEC.


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Issue Date: 09-30-24
Drawn By: ACC

5920-05

PLAN NAME:
LONGLEAF WAY



OPT. SECOND FLOOR PLAN PARTIAL ELECTRICAL PLAN
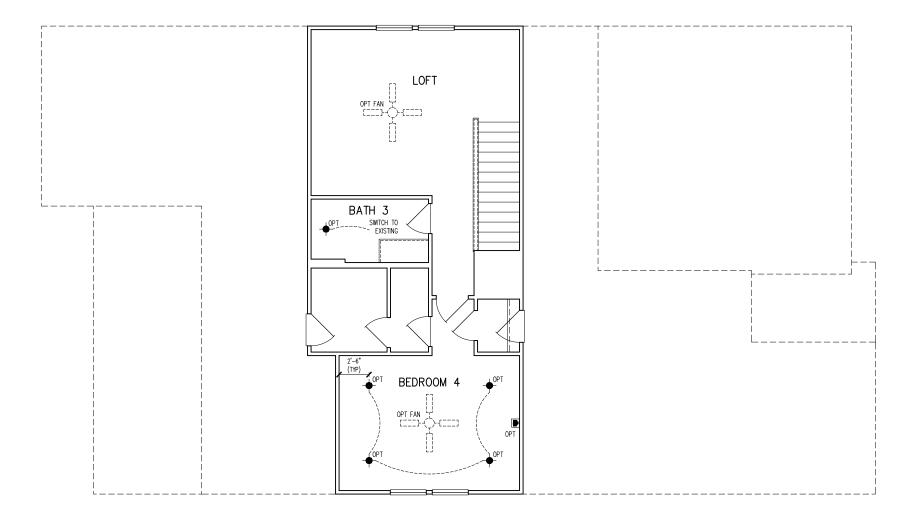
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HOMES

540 WADE PARK BLVD, SUITE 400, RALEIGH, NG 27807

Business Operations 5440 Wade Park Blvd Suite 400 Raleigh, NC 27607

OPTION 2ND FLOOR ELEC. PLAN

SUBDIVISION:
ADDRESS:
LOT:
BI

Issue Date: 09-30-24 Drawn By: ACC

5920-05

PLAN NAME:
LONGLEAF WAY

GENERAL STRUCTURAL NOTES

FLOOR FRAMING

- L- IOISTS/TRUSSES SHALL BE DESIGNED BY MANUE TO MEET OR EXCEED L/480 LIVE LOAD DEFLECTION CRITERIA. (EXCLUDES STONE/MARBLE OR WET BED CONSTRUCTED FLOORS - CONTACT M&K FOR EXCLUDED FLOOR DESIGNS)
- PER THE GUIDELINES OF THE TILE COUNCIL OF NORTH AMERICA (TCNA HANDBOOK), IT SHALL BE THE FLOOR FINISH INSTALLER'S RESPONSIBILITY TO VERIEY THAT THE FINISHES TO BE INSTALLED MATCH THE DESIGN CRITERIA NOTED ABOVE (UNDER "DESIGN
- FLOOR SYSTEMS & SHEATHING HAVE BEEN DESIGNED TO SUPPORT ADDITIONAL DEAD LOAD FROM CERAMIC TILE (EXCLUDING MARBLE OR STONE). HOWEVER, IT SHALL BE THE FLOOR FINISH INSTALLER'S RESPONSIBILITY TO PROVIDE PROPER UNDERLAYMENT, UNCOUPLING MEMBRANE AND MORTAR/GROUT PER THE ASSEMBLY DESIGNATIONS IN THE TONA HANDBOOK (TILE COUNCIL OF NORTH AMERICA).
- AT I-JOIST FLOORS, PROVIDE I 1/8" MIN. 05B RIM BOARD.
- METAL HANGERS SHALL BE SPECIFIED BY MANUFACTURER, U.N.O.
- I-JOIST/TRUSS SHOP DWGS. SHALL BE SUBMITTED TO ARCH. & ENG. FOR REVIEW AND APPROVAL PRIOR TO FABRICATION OR DELIVERY
- FLOOR SHEATHING SHALL BE 23/32" A.P.A. RATED 'STURD-I-FLOOR' 24" O.C, EXPOSURE I (OR APPROVED EQUAL) WITH TONGUE AND GROOVE EDGES. FASTEN TO FRAMING MEMBERS W GLUE AND
- 2 ½" x 0.131" NAILS @ 6"o.c. @ PANEL EDGES € @ 12"o.c. FIELD.
- 2 3 × 0.120 NAILS 4 O.C. PANEL EDGES € 8 O.C. FIELD.
- 2 3 × 0.113" NAILS @ 3" O.C. @ PANEL EDGES \$ @ 6" O.C. IN FIELD

ROOF FRAMING

- ROOF SHEATHING SHALL BE 1/16" A.P.A. RATED SHEATHING 24/16 EXPOSURE I (OR APPROVED EQUAL). FASTEN TO FRAMING MEMBERS
- W/ 2 1 × 0.131" NAILS @ 6"O.C. @ PANEL EDGES \$ @ 12" O.C. FIELD.
- · w/ 2 🖁 × 0.120" NAILS 👁 4"o.c. 👁 PANEL EDGES 🕏 🕫 8" O.C. FIELD. - w/ 2 🖁 × 0.113" NAILS @ 3"o.c. @ PANEL EDGES \$ @ 6" O.C. FIELD.
- ♦ WITHIN 48" OF ALL ROOF FDGES RIDGES & HIPS FASTEN ROOF SHEATHING FIELDS PER EDGE NAILING SPEC.
- FASTEN FACH ROOF TRUSS TO TOP PLATE W/ SIMPSON H25T CLIP (OR APPROVED EQUAL) • ALL BEARING POINTS. PROVIDE (2) H2.51 CLIPS AT 2-PLY GIRDER TRUSSES, (3) H2.5T CLIPS AT 3-PLY GIRDER TRUSSES & ROOF BEAMS - AT ALL BEARING POINTS.
- METAL HANGERS SHALL BE SPECIFIED BY THE MANUFACTURER, U.N.O.
- ROOF TRUSS SHOP DWGS SHALL BE SUBMITTED TO ARCH & ENG. FOR REVIEW AND APPROVAL PRIOR TO FABRICATION OR DELIVERY
- ERECT AND INSTALL ROOF TRUSSES PER WTCA & TPI'S BCSI I "GUIDE TO GOOD PRACTICE FOR HANDLING, INSTALLING & BRACING
- OF METAL PLATE CONNECTED WOOD TRUSSES." SUPPORT SHORT SPAN ROOF TRUSSES w/2x4 LEDGER FASTENED TO

FRAMING w/(2) 3" x 0.120" NAILS @ 16" O.C. (UP TO 7' SPAN).

CONNECTION SPECIFICATIONS (TYP. U.N.O.)

DESCRIPTION OF BLDG. ELEMENT	3"x0.131" NAIL5	3"x0.120" NAILS	
JOIST TO SOLE PLATE	(3) TOENAILS	(3) TOENAILS*	
SOLE PL. TO JOIST/RIM OR BLK'G	NAILS @ 4" o.c.	NAILS @ 4" o.c.	
STUD TO PLATE	(4) TOENAILS/ (3)END NAILS	(4) TOENAILS/ (4)END NAILS*	
RIM TO TOP PLATE	TOENAILS @ 6" o.c.	TOENAILS @ 4" o.c.*	
BLK'G. BTWN. JOISTS TO TOP PL.	(3) TOENAILS EA. END	(3) TOENAILS EA. END*	
DOUBLE STUD	NAILS @ 16" O.C.	NAILS @ 16" o.c.	
DOUBLE TOP PLATE	NAILS @ 12" o.c.	NAILS @ 8" O.C.	
DOUBLE TOP PLATE LAP SPLICE	(12) NAILS IN LAPPED AREA (24" MIN.)	(15) NAILS IN LAPPED AREA (24" MIN.)	
TOP PLATE LAP @ CORNERS & INTERSECTING WALLS	(3) NAILS	(3) NAILS	
RAFTER/TRUSS TO TOP PLATE	(4) TOENAILS +	(4) TOENAILS +	
	(I) SIMPSON H2.5T	(I) SIMPSON H2.5T	
GAB, END TRUSS TO DBL, TOP PL.	TOENAILS @ 8" o.c.	TOENAILS @ 6" o.c.	
R.T. w/ HEEL HT. 9 1/4" TO 12"	2xIO BLK EVERY 3RD BAY FASTENED TO DBL. TOP PLATE w/ TOENAILS @ 6" O.C.	2xIO BLK EVERY 3RD BAY FASTENED TO DBL. TOP PLATE W/ TOENAILS @ 4" O.C.	
R.T. w/ HEEL HT. 12" TO 16"	2XI2 BLK EVERY 3RD BAY FASTENED TO DBL. TOP PLATE w/ TOENAILS @ 6" O.C.	2xI2 BLK EVERY 3RD BAY FASTENED TO DBL. TOP PLATE w/ TOENAILS @ 4" O.C.	
R.T. w/ HEEL HT. UP TO 24"	LAP WALL SHTG. W/ DBL. TOP PL. \$ INSTALL ON TRUSS VERT FASTEN W/ NAILS @ 6" O.C.	LAP WALL SHTG, W/ DBL, TOP PL. \$ INSTALL ON TRUSS VERT FASTEN W/ NAILS @ 6" O.C.*	
R.T. w/ HEEL HT. 24" TO 48"	LAP WALL SHTG, W/ DBL, TOP PL. & INSTALL ON TRUSS VERT FASTEN W/ NAILS @ 6" O.C. PROVIDE 2x BLK @ EA, BAY AT TOP OF HEEL	LAP WALL SHTG, W DBL. TOP PL. \$ INSTALL ON TRUSS VERT FASTEN W NAILS @ 6" O.C. PROVIDE 2x BLK @ EA. BAY AT TOP OF HEEL*	
WALL TO FOUNDATION	WALL SHTG. LAP W/ SILL PL. \$ FASTENED PER SHEAR WALL FASTENING SPEC.		
 ½/x0.ii3 is an acceptable alternative to a 3*x0.i20*, same spacing or number of nails. (ONLY ACCEPTABLE WHERE * ARE SHOWN) 			

GENERAL STRUCTURAL NOTES

DESIGN LOADING

- DESIGN IS BASED ON 2018 NORTH CAROLINA STATE BUILDING CODE: RESIDENTIAL CODE.
- WOOD FRAME ENGINEERING IS BASED ON NDS, "NATIONAL DESIGN SPECIFICATION FOR WOOD CONSTRUCTION" - LATEST EDITION
- DESIGN LOADS ROOF

SNOW = 15 PSF (12 PSF GROUND SNOW, TRUSSES) LIVE = 20 PSF (REDUCIBLE BASED ON ROOF PITCH) DEAD = 7 PSE TG. TO PSE BG. LOAD DURATION FACTOR = 1.25

LIVE = 40 PSE (30 PSE @ SLEEPING AREAS)

DEAD = 10 PSF (I-JOISTS), 15 PSF (FLOOR TRUSSES) ADD'L TO PSE @ CERAMIC TILE IN KITCHEN. SUNROOMS, BATHS, FOYER, LAUND, & MUDRIN

2,000 PSF ASSUMED ALLOWABLE BEARING PRESSURE (TO BE VERIFIED BY BUILDER)

115 MPH, EXPOSURE B

GENERAL FRAMING

- ALL TYP. NAIL FASTENER REQUIREMENTS ARE NOTED IN STANDARD CONNECTIONS TABLE (IRC TABLE R602.3(I)) OR ON PLANS. ALL NAILS SPECIFIED ARE MIN DIAMETER AND LENGTH REQUIRED FOR CONNECTION. ALL HANGER NAILS SHALL BE INSTALLED PER MANUFACTURER'S REQUIREMENTS FOR MAX CHARTED CAPACITY NOTE: HANGERS USE COMMON NAIL DIAMETERS NOT TYPICAL FRAMING GUN NAILS.
- EXT. & INT. BEARING WALLS SHALL BE 2x4 OR 2x6 (AS SHOWN ON PLANS) @ 16" O.C. SPF/SP #2 GRADE LUMBER, OR BETTER, U.N.O.. . WALLS OVER 12' TALL SHALL BE PER PLAN.
- ALL INTERIOR BEARING WALLS ARE ASSUMED TO BE SHEATHED W/ GYP WALL BOARD (ONE SIDE MIN.) OR PROVIDE MID HT. BLOCKING.
- ALL HEADERS, BEAMS & OTHER STRUCTURAL MEMBERS SHALL BE SPRUCE-PINE-FIR #2 (SPE) OR SOUTHERN PINE #2 (SP) LUMBER OR BETTER, SUPPORT ALL HEADERS/ BEAMS W/ (1)2x JACK STUD & (1)2x KING STUD MINIMUM
- THE NUMBER OF STUDS SPECIFIED AT A SUPPORT INDICATES THE NUMBER OF JACK STUDS REQUIRED, U.N.O.,
- ALL NON-BEARING INTERIOR STUD WALLS SHALL BE CONSTRUCTED WITH 2x 'STUD' GRADE MEMBERS SPACED € 24" O.C. (MAX., U.N.O.)

 ◆ HEADERS IN NON-LOAD BEARING WALLS SHALL BE: (1)2x4/6 FLAT @ OPENINGS UP TO 4', (2)2x4/6 FLAT UP TO 8'.
- ALL FRAMING LUMBER SHALL BE DRIED TO 15% MC (KD-15).
- ENGINEERED LUMBER BEAMS TO MEET OR EXCEED THE FOLLOWING: • 'LVL' - Fb=2600 psi; Fv=285 psi; E=2.0xl0^6 psi
- ENGINEERED LUMBER POSTS TO MEET OR EXCEED THE FOLLOWING 'LVL' - Fb=2400 psi; FcII=2500 psi; E=I.8xI0^6 psi
- FOR 2 \$ 3 PLY BEAMS OF EQUAL 134" MAX, WIDTH, FASTEN PLIES TOGETHER WITH 3 ROWS OF 3"X0.120" NAILS @ 8" O/C OR 2 ROWS K"x3K" SIMPSON SDS SCREWS (OR 3K" TRUSSI OK SCREWS) @ 16" GREATER APPLY EASTENING AT BOTH FACES FOR 3-PLY CONDITION. LOCATE TOP & BOTTOM NAILS/SCREWS 2" FROM EDGE. SOLID 31/3" OR 51/4" BEAMS ARE ACCEPTABLE, USE 2 ROWS OF NAILS FOR 2x6 \$ 2x8 MEMBERS
- FOR 4 PLY BEAMS OF FOUAL 13/4" MAX, WIDTH, FASTEN PLIES TOGETHER WITH 3 ROWS OF 1/2 x6" SIMPSON SDS SCREWS (OR 6 3/4" TRUSSLOK SCREWS) @ 16" O/C. USE A MINIMUM OF 4 ROWS FOR BEAM DEPTHS OF 14" OR GREATER, APPLY EASTENING AT BOTH FACES (ONE SIDE ONLY FOR TRUSSLOK SCREWS). LOCATE TOP AND BOTTOM SCREWS 2" FROM EDGE, A SOLID 7" BEAM IS ACCEPTABLE
- PROVIDE SOLID BLOCKING IN FLOOR SYSTEM UNDER ALL POSTS CONTINUOUS TO FND./BEARING, BLOCKING TO MATCH POST ABOVE.
- ALL EXTERIOR 4x4 WOOD POSTS SHALL HAVE SIMPSON BCS2-2/4
- CORROSION NOTES
- BUILDER RESPONSIBLE TO DETERMINE CORROSION-RESISTANCE REQUIREMENTS AND COMPATIBILITY OF HARDWARE FASTENERS AND CONNECTORS FOR ENVIRONMENTAL EXPOSURE AND IN CONTACT W/ PRESERVATIVE-TREATED WOOD OF ACTUAL FINAL CONDITIONS AND SOURCED MATERIALS. CONTACT LUMBER \$ HARDWARE SUPPLIERS TO COORD.

GENERAL STRUCTURAL NOTES

FOUNDATION

- DESIGN IS BASED ON 2018 NORTH CAROLINA STATE BUILDING CODE:
- FOOTING DESIGN 2,000 PSF ALLOWABLE SOIL BEARING PRESSURE IS ASSUMED. BUILDER/CONTRACTOR MUST VERIFY.
- FASTEN 2x4/6 SILL PLATES TO CONC FND WITH A MINIMUM OF 2
- ANCHORS PER PLATE 12" MAX FROM PLATE ENDS UTIL 17ING I/2" DIA. ANCHOR BOLTS 6'-0" O.C,7" MIN. EMBEDMENT
- I/2" DIA. x 6" LONG SIMPSON TITEN HD @ 6'-0" O.C. • SIMPSON MASA ANCHOR STRAPS @ 6'-0" O.C. (CONCRETE)
- ALL LUMBER EXPOSED TO WEATHER OR IN CONTACT W/ PERIMETER FOUNDATION SHALL BE PRESERVATIVE TREATED SOUTHERN PINE #2.
- BUILDER TO VERIEY CORROSION-RESISTANCE COMPATIBILITY OF HARDWARE & FASTENERS IN CONTACT W/ PRESERVATIVE-TREATED WOOD, CONTACT LUMBER & HARDWARE SUPPLIERS TO COORD.
- FOOTINGS SHALL BE PLAIN CONCRETE, U.N.O.
- CONCRETE DESIGN BASED ON ACL 318, CONCRETE SHALL ATTAIN THE FOLLOWING MIN, COMPRESSIVE STRENGTHS IN 28 DAYS, U.N.O. f'c = 3,000 psi: FOOTINGS & INTERIOR SLABS ON GRADE 3,500 psi: GARAGE & EXTERIOR SLABS ON GRADE fu = 60.000 psi
- ALL CONCRETE EXPOSED TO THE WEATHER SHALL NOT HAVE LESS THAN 5% OR MORE THAN 7% AIR ENTRAINMEN
- ALL FOOTINGS SHALL BEAR BELOW FROST LINE (TYP.) OR 12" MIN I REGIONS WHERE CODE FROST DEPTH IS NOT APPLICABLE. CONSULT SOILS REPORT OR BUILDING DEPT. FOR MINIMUM DEPTH BELOW GRADE
- FOOTINGS AND SLABS ON GRADE SHALL BEAR ON VIRGIN SOIL OR
- PROVIDE CONTROL JOINTS AT ALL INSIDE CORNERS OF SLAB EDGES, AND OTHER LOCATIONS WHERE SLAB CRACKS ARE LIKELY TO DEVELOP
- JOINTS SHALL BE LOCATED @ IO'-O" O.C. (RECOMMENDED) OR 15'-0" O.C. (MAXIMUM)
- LOINT GRID PATTERN SHALL BE AS CLOSE TO SQUARES AS POSSIBLE (I:I RATIO), WITH A MAXIMUM OF I:I.5 RATIO
- · CONTROL JOINTS SHALL NOT BE INSTALLED IN STRUCTURAL
- DIMENSIONS BY OTHERS, BUILDER TO VERIFY.

MEANS & METHODS NOTES

THE STRUCTURE IS DESIGNED TO BE SELF SUPPORTING AND STABLE AFTER THE BUILDING IS FINISHED AND ALL PLAN, DETAIL, AND NOTE SPECIFICATIONS HAVE BEEN COMPLETED. IT IS THE CONTRACTOR'S SOLE RESPONSIBILITY TO DETERMINE THE ERECTION PROCEDURES AND SEQUENCE TO THE SAFETY OF THE BUILDING AND ITS COMPONENTS DURING CONSTRUCTION. THIS INCLUDES BUT IS NOT LIMITED TO, THE ADDITION OF NECESSARY SHORING, SHEETING, TEMPORARY BRACING, GUYS, AND TIE-DOWNS. CONTRACTOR SHALL BE RESPONSIBLE FOR ALL SHORING AND BRACING REQUIRED TO STABILIZE AND PROTECT EXISTING AND ADJACENT STRUCTURES AND SYSTEMS DURING COURSE OF DEMOLITION AND CONSTRUCTION OF THE PROJECT

STRUCTURAL DESIGN AND SPECIFICATIONS ASSUME THAT ALL SUPPORTING AND NON-SUPPORTING ELEMENTS IN CONTACT WITH FLOOR FRAMING ARE LEVEL, INCLUDING, BUT NOT LIMITED TO: FOUNDATIONS. SLABS ON GRADE, BEAMS, WALLS, AND NON-BEARING ELEMENTS. IT IS THE CONTRACTOR'S RESPONSIBILITY TO VERIEY LEVELNESS AND MAKE ADJUSTMENTS AS NECESSARY, INCLUDING CONSIDERATION OF THOSE AREAS THAT MAY BE WITHIN CONTRACTUAL, INDUSTRY OR WARRANTY TOLERANCES

VENEER LINTEL SCHEDULE

SPAN (MAX)	HEIGHT OF VENEER ABOVE LINTEL	STEEL ANGLE SIZE
3'-0"	20 FT. MAX	L3"x3"x¼"
6'-0"	3 FT. MAX	L3"x3"x¼"
	I2 FT. MAX	L4"x3"x¼"
	20 FT. MAX	L5"x3½"x¾"
B'-0"	3 FT. MAX	L4"x4"x¼" *
	I2 FT. MAX	L5"x3½"x%;"
	I6 FT. MAX	L6 ' x∄⁄2"x¾6"
9'-6"	I2 FT. MAX	L6"x3½"x%6"
16'-0"	2 FT. MAX	L7"x4"x½" **
l	3 FT MAY	1 8"\4"\6" **

- IL LINTELS

 \$40LL SIPPORT 2 %* 3 ½" YINDEER W 40 POF MAXIMIM MEIGHT.

 169 SHALL HAVE 4" MN. BEARING

 169 SHALL HAVE 9" MN. BEARING

 169 SHALL HAVE 9" MN. BEARING

 169 SHALL BAT SET PASTINED PACK TO HEADER IN WALL 4049" oz. w/ ½" DIA. x 3 ½"

 LONG LAG 50/ENPG IN 2" LONG YERTICALLY \$LOTTED HALES.

 MAX. YEBER IN APPLIES TO ANY FORTION OF PROKO CAPE THE OPENING.

 ALL INITES 99 SHALL BE LONG LEG YERTICAL.

 MAY BEC OF IN THE PIELD TO BE 3½" MIDE OVER THE BEARING LISGITH ONLY. THIS

 SET STRUCTUREN ANY FOR SOME THE EXTIRGAT TOE OF THE HORIZONTAL LEG

 MAY BEC OF IN THE PIELD TO BE 3½" MIDE OVER THE BEARING LISGITH ONLY. THIS

 SET STRUCTUREN ANY FOR SOME THE ANY ELGONOMY ONLY THE BEARING LISGITH ONLY. THE

 ABOVE PARAMETERS.
- FOR QUEEN VENEER USE L4X3%". FOR 3%" VENEER ONLY, SEE PLAN FOR VENEER SUPPORT IF VENEER < 3½" THICK

ADDITIONAL NOTES FOR TRUSS & I-JOIST MANUFACTURER

ROOF TRUSS, FLOOR TRUSS AND ENGINEERED JOISTS SHALL BE DESIGNED TO MEET THE DEFLECTION CRITERIA BELOW, UNLESS NOTED OTHERWISE ON PLAN, MULHERN & KULP CANNOT BE HELD RESPONSIBLE FOR ANY STRUCTURAL ISSUES
RELATED TO ANY BUILDING COMPONENT IF COMPONENT SHOP DRAWINGS ARE NOT SUBMITTED TO M&K FOR REVIEW PRIOR TO FABRICATION, DELIVERY, OR INSTALLATION.

TRUSSES/LIGISTS SHALL BE DESIGNED SO THAT DIFFERENTIAL DEFLECTION BETWEEN ADJACENT PARALLEL TRUSSES/JOISTS OR GIRDER TRUSSES/FLUS BEAMS DO NOT EXCEED THE FOLLOWING: A ROOF TRUSSES.

- 1/4" DEAD LOAD
- B. FLOOR TRUSSES, ATTIC TRUSSES, \$ 1-JOISTS: 1/8" DEAD LOAD

 ABSOLUTE DEAD LOAD DEFECTION OF FLOOR
- TRUSSES/ATTIC TRUSSES WHEN ADJACENT TO FLOOR FRAMING BY OTHERS SHALL BE LIMITED TO 3/16". (NO DIFFERENTIAL DEFLECTION

FLOOR JOIST NOTES

- ALL FLOOR JOISTS SHALL BE THE DEPTI SPECIFIED ON PLAN - FLOOR JOISTS SERIES & SPACING IS PER THE FLOOR JOIST MANUF.
- SPACING SHALL NOT EXCEED 19.2" O.C. (MAX.) @ LOCATION OF TILE: SPACING SHALL NOT
- EXCEED 16" O.C. (MAX.)

LATERAL/WALL BRACING & WALL SHEATHING SPECIFICATIONS

THIS MODEL HAS BEEN DESIGNED TO RESIST LATERAL FORCES RESULTING FROM:

MPH WIND IN 2018 NCSBC:RC

(115 MPH WIND SPEED IN ASCE 7-10 WIND MAP, PER IRC R301,2,1,1) EXP. B, RISK CAT. 2 & SEISMIC CAT. A/B.

THE DESIGN WAS COMPLETED PER 2015 IBC (SECTION 1609) & ASCE 7-10, AS PERMITTED BY R301,1,3 OF THE 2018 NCSBC:RC, ACCORDINGLY, THIS MODEL, AS DOCUMENTED AND DETAILED HEREWITHIN, IS ADEQUATE TO RESIST THE CODE REQUIRED LATERAL FORCES.

DESIGN WIND UPLIET LOADS HAVE BEEN CALCULATED UTILIZING ASCE 7-10 (ACCEPTED ENGINEERING PRACTICE) AS ALLOWED PER 2018 NCSBC:RC SECTION R802.II.I.I. THIS MODEL HAS BEEN DETAILED WHERE REQUIRED & ENGINEERED TO RESIST THE WIND UPLIET LOAD PATH PER SECTIONS R602.3.5\$ R802.II.

EXT. WALL SHEATHING SPECIFICATION

- 7/16" OSB OR 15/32" PLYWOOD: FASTEN SHEATHING W/ 2 (\$10,013) NAILS @ 61 O.C. AT EDGES & @ 121 O.C. IN THE PANEL FIELD. (TYP, U.N.O.) ALL SHEATHING PANELS SHALL BE ORIENTED
- VERTICALLY (LONG DIRECTION PARALLEL TO STUDS) AND INSTALLED FULL HEIGHT OF SHEAR WALL - OR 2x HORIZONTAL BLOCKING SHALL BE PROVIDED TO SUPPORT ALL UNSUPPORTED PANEL EDGES & EDGE
- ALL EXT. WALLS SHALL BE CONTINUOUSLY SHEATHED AND ARE CONSIDERED SHEAR WALLS.
- ALT. STAPLE CONNECTION SPEC: 1 3/4" 16 GA STAPLES (1/6" CROWN) @ 3" O.C. AT EDGES \$ @ 6" O.C IN FIELD.


3" O.C. EDGE NAILING

AT DESIGNATED AREAS - FASTEN PANEL EDGES OF WOOD STRUCTURAL WALL SHEATHING TO FRAMING W 2 3" × 0.113" NAILS @ 3" O.C. AND 12" O.C. IN THE PANEL FIELD NO STAPLE ALTERNATIVE AVAILABLE AT THIS SPEC. ALL SHEATHING PANELS SHALL BE ORIENTED VERTICALLY (LONG DIRECTION PARALLEL TO STUD) AND INSTALLED FULL HEIGHT OF SHEAR WALL - OR - 2x HORIZONTAL BLOCKING SHALL BE PROVIDED TO SUPPORT UNSUPPORTED PANEL EDGES AND 3" O.C. EDGE FASTENING.

TYP. UNIT SEPARATION WALL SHEATHING SPECIFICATION

1/2" OR 5/8" GYPSUM WALL BOARD: FASTEN GMB SHEATHING TO FRAMING W/ I \$"X0.086" COOLER NAILS OR I 1/4" DRYWALL SCREWS @ 7" O.C. PANEL EDGES & PANEL FIELD (INCLUDING T&B PLATES

- SEE CONNECTION SPECIFICATIONS CHART FOR STANDARD SHEAR TRANSFER DETAILING. IF ADDITIONAL CAPACITY IS REQUIRED BY DESIGN. T WILL BE SPECIFICALLY NOTED ON PLAN.
- DESIGN ASSUMES 16" O.C MAX. STUD SPACING, U.N.O.
- ALL STRUCTURAL PANELS ARE TO BE DIRECTLY APPLIED TO STUD FRAMING.
- PRE-MANUFACTURED PANELIZED WALLS: FASTEN TOGETHER END STUDS OF WALL PANELS SHEATHED W/ OSB OR PLYWOOD W/ 3" x 0.120" NAILS @ 4" O.C. (THRU ONE SIDE ONLY)

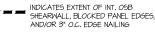

NDIGATES HOLDOWN



MULHERN+KULP
RESIDENTIAL STRUCTURAL ENGINEERINS



Mulhern+Kulp project number

243-2403

SMI drawn by SMN ssue date: 08-16-24

REVISIONS

initial: 1/08/2024 SMM NAME, OPT. EXT. COVID. PORCH,

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NOTES MODE

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MASTER SE
RALEIGH, 5920-

GENERAL

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SEE PARISIONAL STAUCTURAL ENSINESRING
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PTATTOGRA - MEDICAL STATE
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Mulhern+Kulp project number:

243-2403

SMK SMM

drawn by: issue date: 08-16-24

REVISIONS:

initial: II/08/2024 SMM WPDATED MODEL NAME, OPT. EXT. COV'D. PORCH, OPT. OFFICE

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FOUNDATION PLAN

• IIIIII INTERIOR BEARING WALL

• —-- BEAM / HEADER

EXTENT OF VALLEY TRUSS OVERFRAMING

221 0. (MAX.)

REFER TO SO.O FOR TYPICAL STRUCTURAL NOTES # SCHEDULES



SDI.0

46'-4 1/2"

6" DEEP x 16" WIDE THICKENED SLAB

31'-10 3/4"

SLAB-ON-GRADE: SEE TYPICAL DETAILS

14'-5 3/4"

-16"x16"x12" FOOTING UNDER P.A. (TYP. OF 2)

21'-1 1/2"

GARAGE SLAB: SEE TYPICAL DETAILS

LEGEND

• ==== BEARING WALL ABOVE (B.W.A.)

12" WIDE TURNDOWN x 12" BELOW GRADE

SDI.0

INDICATES EXTENT OF INT.

OSB SHEARWALL AND/OR
3" O.C. EDGE NAILING

EXTENT OF FLOOR SYSTEM TO BE DESIGNED FOR TILE

NDICATES HOLDOWN


* INDICATES POST ABOVE. PROVIDE SOLID BLOCKING UNDER POST OR JAMB ABOVE.

S1.0

5920-05 MODEL

SERENITY MASTER SET RALEIGH, NC

Reference S2.1 for Elevation Specific Details

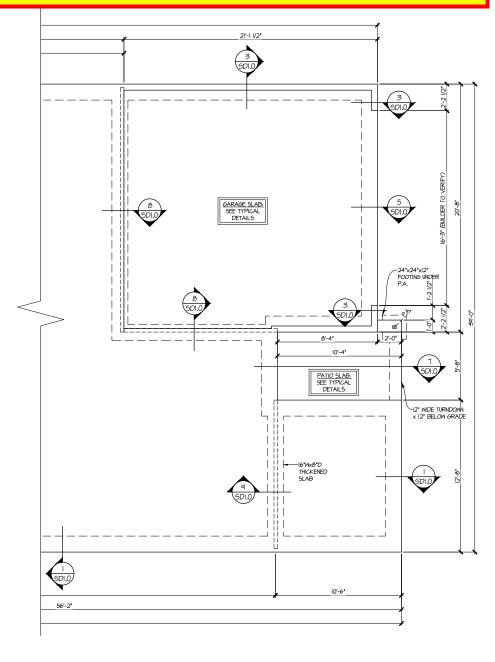

PARTIAL SLAB FOUNDATION PLAN SCALE: 1/4"=1'-0" (22x24 SHEET) ELEV. C OPT. BEDROOM 3 SIM. SEE ELEV. A FOR MORE INFO 1/8"=1'-0" (IIxI7 SHEET)

> REFER TO SO.O FOR TYPICAL STRUCTURAL NOTES & SCHEDULES

MULHERN+KULP

RESIDENTIAL STRUCTURAL ENSINEERING

WEST DENSITY OF THE STRUCTURAL ENSINEERING

PTO-TIT-6074 - RESIDENSITY

N. Licence # C-2025



Mulhern+Kulp project number:

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SMK drawn by: SMM issue date: 08-16-24

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5920-05 MODEL SERENITY MASTER SET RALEIGH, NC

FOUNDATION PLAN

EXTENT OF VALLEY TRUSS OVERFRAMING

24" O.C. (MAX.)

LEGEND

INTERIOR BEARING WALL • □===□ BEARING WALL ABOVE (B.W.A.)

INDICATES EXTENT OF INT.

OSB SHEARWALL AND/OR
3" O.C. EDGE NAILING


BEAM / HEADER

EXTENT OF FLOOR SYSTEM TO BE DESIGNED FOR TILE

NDICATES HOLDOWN

JL METAL HANGER

* INDICATES POST ABOVE. PROVIDE SOLID BLOCKING UNDER POST OR JAMB ABOVE.

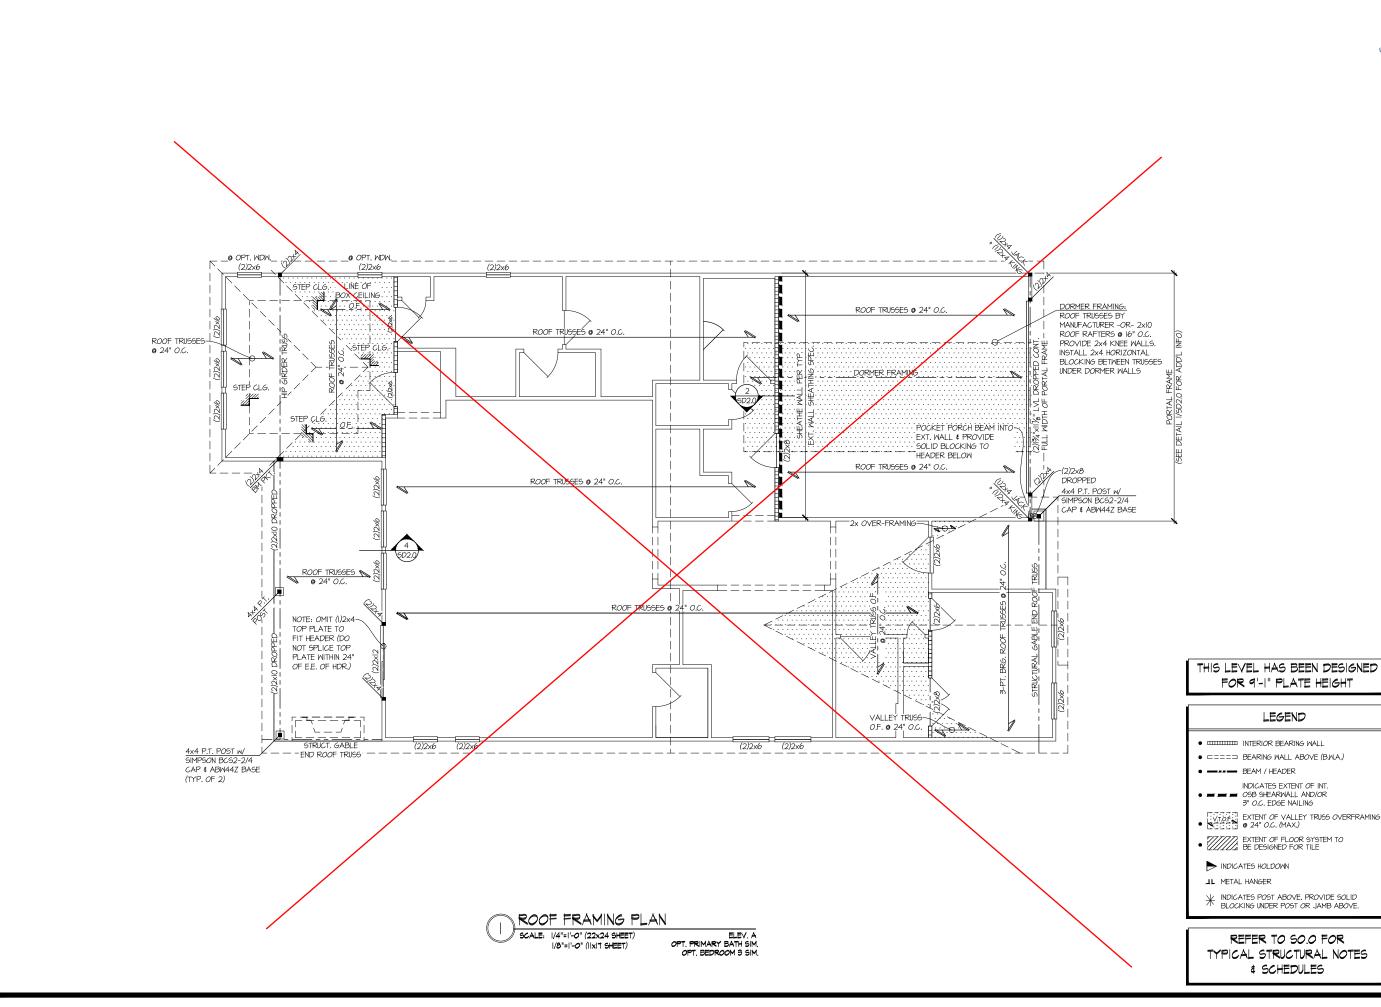

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WE Invident V. Manual SA WAZ
PTO-TIT-6004 V. Manual SA WAZ
PTO-TIT-6004 V. Manual SA WAZ
N. Licence & C. 2825

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SMN

08-16-24 issue date:

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THIS LEVEL HAS BEEN DESIGNED FOR 9'-1" PLATE HEIGHT

- IIIIIII INTERIOR BEARING WALL
- □===□ BEARING WALL ABOVE (B.W.A.)

- | INDICATES POST ABOVE. PROVIDE SOLID | BLOCKING UNDER POST OR JAMB ABOVE.


REFER TO SO.O FOR TYPICAL STRUCTURAL NOTES & SCHEDULES

ROOF FRAMING PLAN 5920-05 MODEI

S2.0

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Elevation B



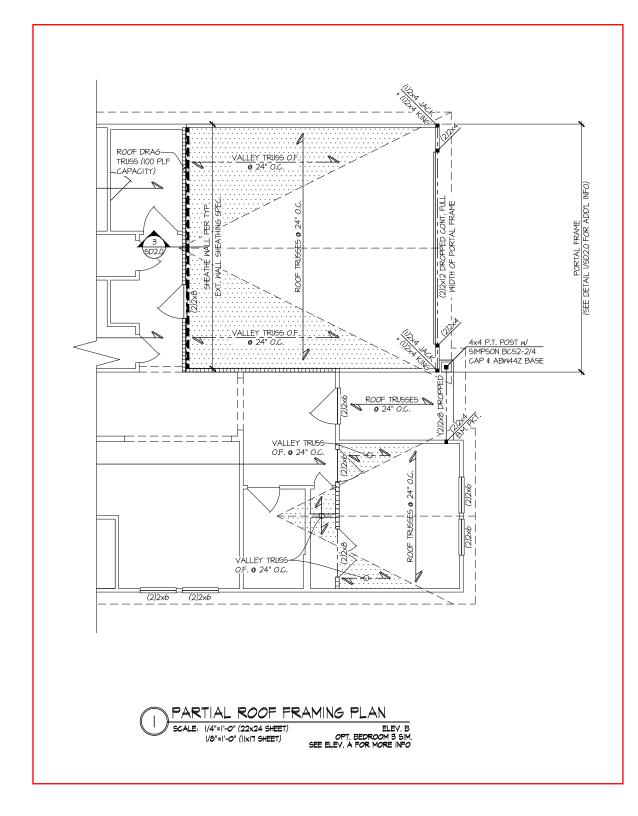

THIS LEVEL HAS BEEN DESIGNED FOR 9'-I" PLATE HEIGHT

REFER TO SO.O FOR TYPICAL STRUCTURAL NOTES # SCHEDULES

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WE Invident V. Manual SA WAZ
PTO-TIT-6004 V. Manual SA WAZ
PTO-TIT-6004 V. Manual SA WAZ
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ROOF FRAMING PLAN

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• □===⊐ BEARING WALL ABOVE (B.W.A.)

INDICATES EXTENT OF INT.

OSB SHEARWALL AND/OR
3" O.C. EDGE NAILING EXTENT OF VALLEY TRUSS OVERFRAMING • 24" O.C. (MAX.)


LEGEND

EXTENT OF FLOOR SYSTEM TO BE DESIGNED FOR TILE

NDICATES HOLDOWN

| INDICATES POST ABOVE. PROVIDE SOLID BLOCKING UNDER POST OR JAMB ABOVE.

Reference S2.1 for Elevation Specific Details

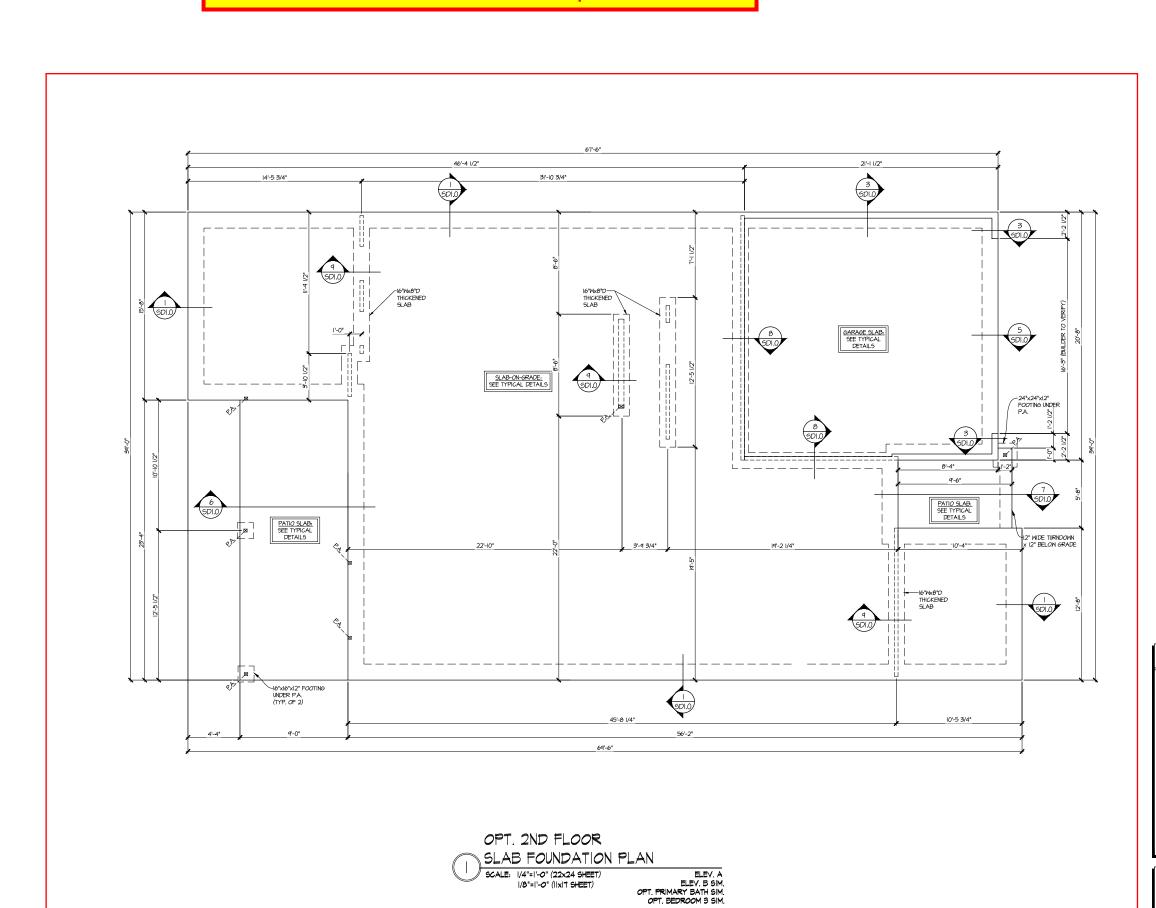

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RESIDENTIAL STRUCTURAL ENSINERING
WE Invident V. Manual SA WAZ
PTO-TIT-6004 V. Manual SA WAZ
PTO-TIT-6004 V. Manual SA WAZ
N. Licence & C. 2825



Mulhern+Kulp project number:

243-2403

drawn by: issue date:

SMM 08-16-24

SMK

REVISIONS:

OPTIONS

STRUCTURAL

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- INTERIOR BEARING WALL
- ==== BEARING WALL ABOVE (B.W.A.)
- INDICATES EXTENT OF INT.

 OSB SHEARWALL AND/OR
 3" O.C. EDGE NAILING

REFER TO SO.O FOR TYPICAL STRUCTURAL NOTES # SCHEDULES

LEGEND

BEAM / HEADER

EXTENT OF VALLEY TRUSS OVERFRAMING

221 0. (MAX.)

EXTENT OF FLOOR SYSTEM TO
 BE DESIGNED FOR TILE


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STRUCTURAL OPTIONS

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S3.1

LEGEND

- IIIIIII INTERIOR BEARING WALL
- ==== BEARING WALL ABOVE (B.W.A.)
- ---- BEAM / HEADER
- INDICATES EXTENT OF INT.

 OSB SHEARWALL AND/OR
 3" O.C. EDGE NAILING
- EXTENT OF VALLEY TRUSS OVERFRAMING

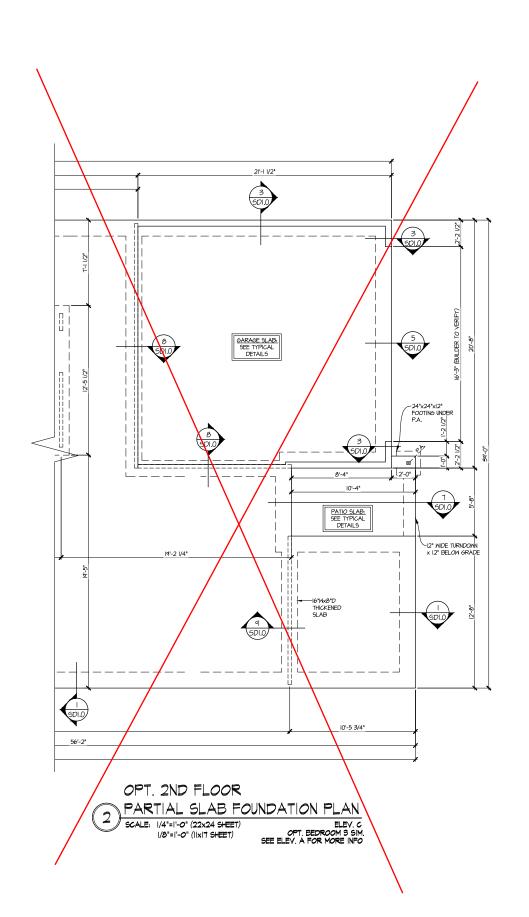
 24" O.C. (MAX.)
- EXTENT OF FLOOR SYSTEM TO BE DESIGNED FOR TILE
- INDICATES HOLDOWN

REFER TO SO.O FOR TYPICAL STRUCTURAL NOTES

& SCHEDULES

| INDICATES POST ABOVE. PROVIDE SOLID BLOCKING UNDER POST OR JAMB ABOVE.

Reference S3.3 for Elevation Specific Details

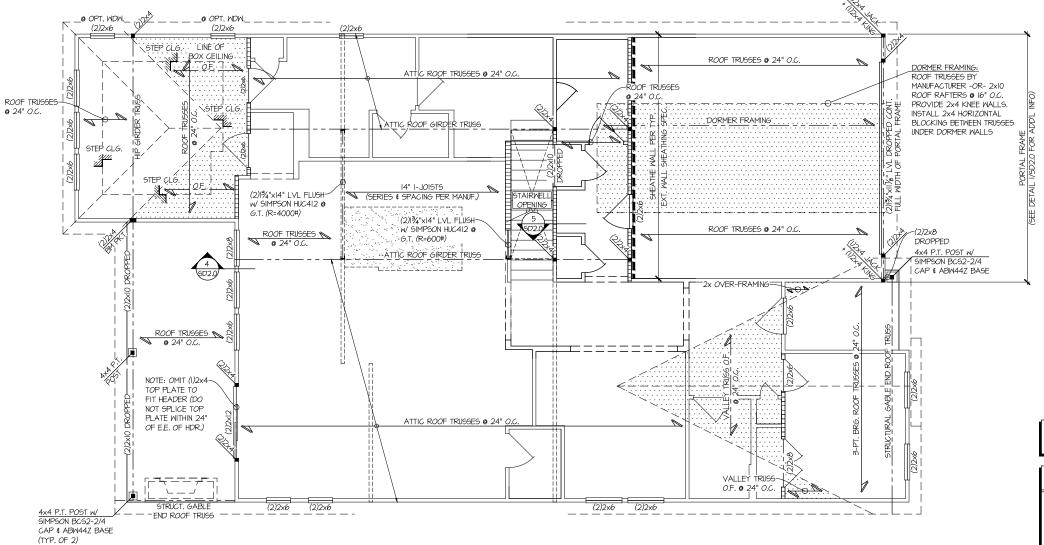

OPT. 2ND FLOOR

LOW ROOF FRAMING PLAN

SCALE: |/4"=1"-0" (22x24 SHEET) | ELEV. A OPT. PRIMARY BATH SIM. OPT. BEDROOM 3 SIM.

SEAL PROFILE OF STRUCTURE Engineering, Inc.

MULHERN+KULP
RESIDENTIAL STRUCTURAL ENGINERBING



Mulhern+Kulp project number:

243-2403

project mgr: SMK drawn by: SMN issue date: O8-16-24

REVISIONS:

date: initial: II/08/2024 SMM updated model name, opt. ext. covd. porch, opt. optice

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THIS LEVEL HAS BEEN DESIGNED FOR 9'-1" PLATE HEIGHT

LEGEND

- INTERIOR BEARING WALL
- □===□ BEARING WALL ABOVE (B.W.A.)
- --- BEAM / HEADER
- INDICATES EXTENT OF INT.

 SE SHEARWALL AND/OR
 3" O.C. EDGE NAILING
- EXTENT OF VALLEY TRUSS OVERFRAMING

 24" O.C. (MAX.)
- 7777777 EXTENT OF ELOOP SYSTEM TO
- 2/1/2/2 BE DESIGNED FOR TILE
- ► INDICATES HOLDOWN
- JL METAL HANGER
- INDICATES POST ABOVE. PROVIDE SOLID BLOCKING UNDER POST OR JAMB ABOVE.


REFER TO SO.O FOR
TYPICAL STRUCTURAL NOTES
\$ SCHEDULES


STRUCTURAL OPTIONS

S3.2

5920-05 MODEI

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THIS LEVEL HAS BEEN DESIGNED FOR 9'-I" PLATE HEIGHT

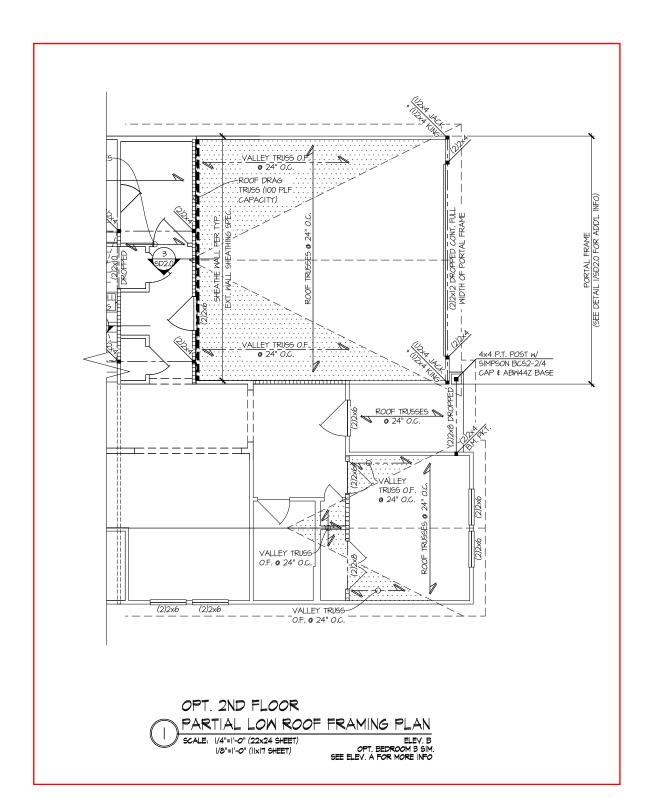REFER TO SO.O FOR TYPICAL STRUCTURAL NOTES \$ SCHEDULES

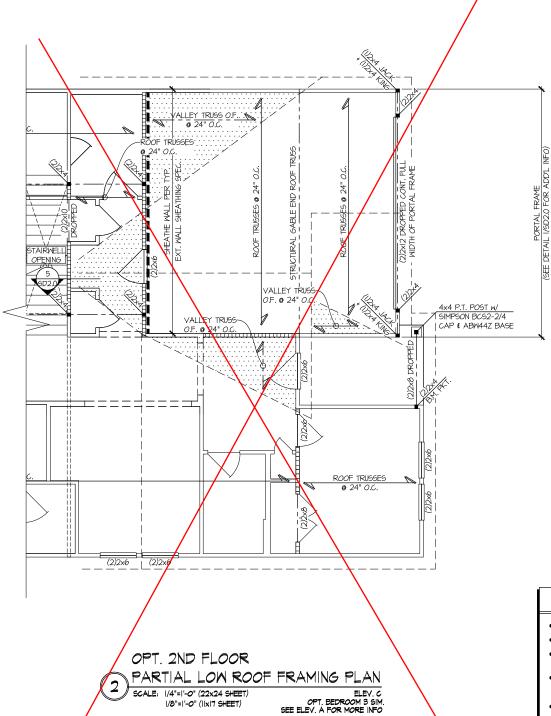LEGEND

- INTERIOR BEARING WALL
- □===⊐ BEARING WALL ABOVE (B.W.A.)
- BEAM / HEADER
- INDICATES EXTENT OF INT.

 OSB SHEARWALL AND/OR

 O.C. EDGE NAILING
- EXTENT OF VALLEY TRUSS OVERFRAMING

 24" O.C. (MAX.)
- EXTENT OF FLOOR SYSTEM TO BE DESIGNED FOR TILE
- INDICATES HOLDOWN
- | INDICATES POST ABOVE. PROVIDE SOLID BLOCKING UNDER POST OR JAMB ABOVE.

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243-2403

SMN 08-16-24 issue date:

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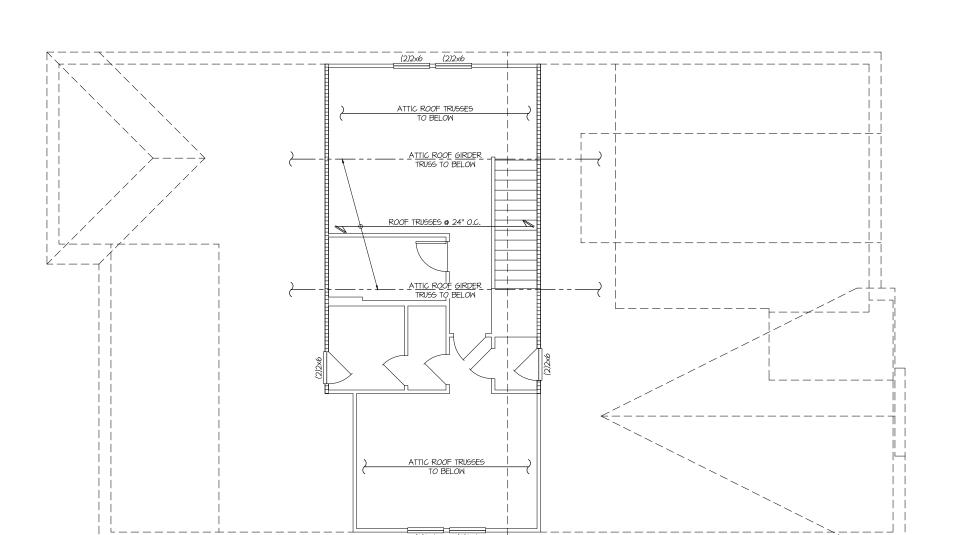
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OPTIONS 5920-05 MODEI STRUCTURAL

SERENITY MASTER SET RALEIGH, NC

S3.3



OPT. 2ND FLOOR

HIGH ROOF FRAMING PLAN

SCALE: 1/4"=1'-0" (22x24 SHEET) ELEV. A ALL ELEV. SM.

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 ${\it Mulhern+Kulp\ project\ number:}$

243-2403

project mgr: SMK drawn by: SMN issue date: 08-16-24

REVISIONS:

date: initial: II/08/2024 SMM UPDATED MODEL NAME, OPT. EXT. COVID. PORCH, OPT. OFFICE

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THIS LEVEL HAS BEEN DESIGNED FOR 9'-1" PLATE HEIGHT

LEGEND

- INTERIOR BEARING WALL
- □==== BEARING WALL ABOVE (B.W.A.)
- BEAM / HEADE
- INDICATES EXTENT OF INT.

 OSB SHEARWALL AND/OR
 3" O.C. EDGE NAILING
- EXTENT OF VALLEY TRUSS OVERFRAMING
 24" O.C. (MAX.)
- EXTENT OF FLOOR SYSTEM TO BE DESIGNED FOR TILE
- NDICATES HOLDOWN
- JL METAL HANGER
- | INDICATES POST ABOVE. PROVIDE SOLID BLOCKING UNDER POST OR JAMB ABOVE.

REFER TO SO.O FOR
TYPICAL STRUCTURAL NOTES

\$ SCHEDULES


STRUCTURAL OPTIONS


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project mgr: SMM drawn by: SMM issue date: O8-1 6-24

REVISIONS:

date: initial: III/08/2024 SMM uPDATED MODEL NAME, OPT, EXT, COVID, PORCH, OPT, OFFICE

tri pointe

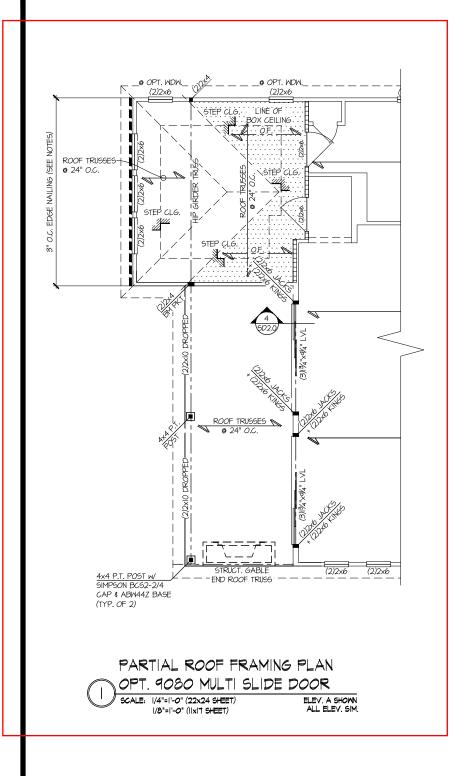THIS LEVEL HAS BEEN DESIGNED FOR 9'-1" PLATE HEIGHT

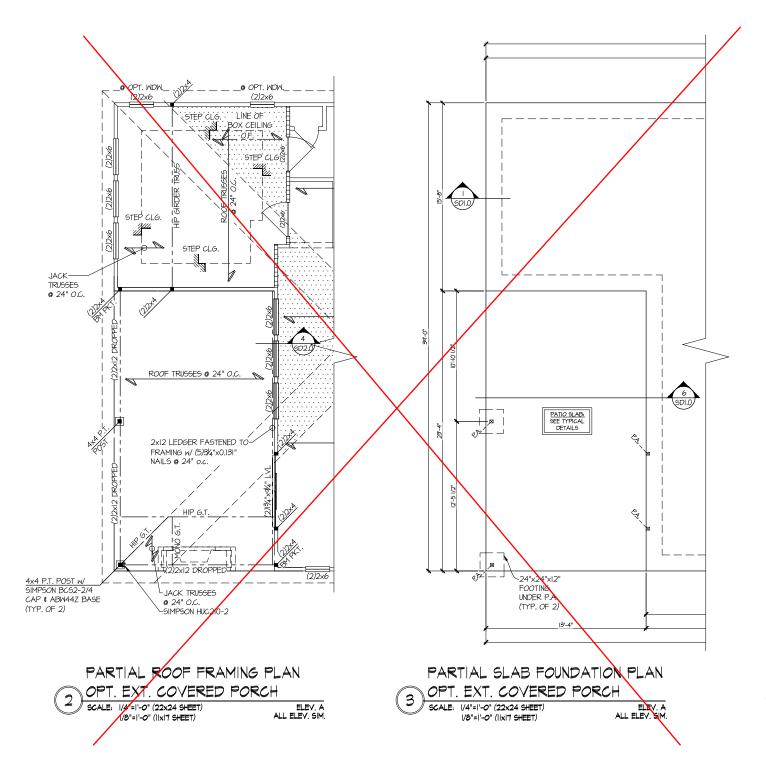LEGEND

- INTERIOR BEARING WALL
- □□□□□ BEARING WALL ABOVE (B.W.A.)
- BEAM / HEADER
- INDICATES EXTENT OF INT.

 OSB SHEARWALL AND/OR

 S" O.C. EDGE NAILING
- EXTENT OF VALLEY TRUSS OVERFRAMING
 24" O.C. (MAX.)
- EXTENT OF FLOOR SYSTEM TO
 BE DESIGNED FOR TILE
- ► INDICATES HOLDOWN
- INDICATES POST ABOVE. PROVIDE SOLID BLOCKING UNDER POST OR JAMB ABOVE.

REFER TO SO.O FOR
TYPICAL STRUCTURAL NOTES


\$ SCHEDULES

SNOITHO

STRUCTURAL OPT 5920-05 MODEI

SERENITY MASTER SET RALEIGH, NC

S3.5

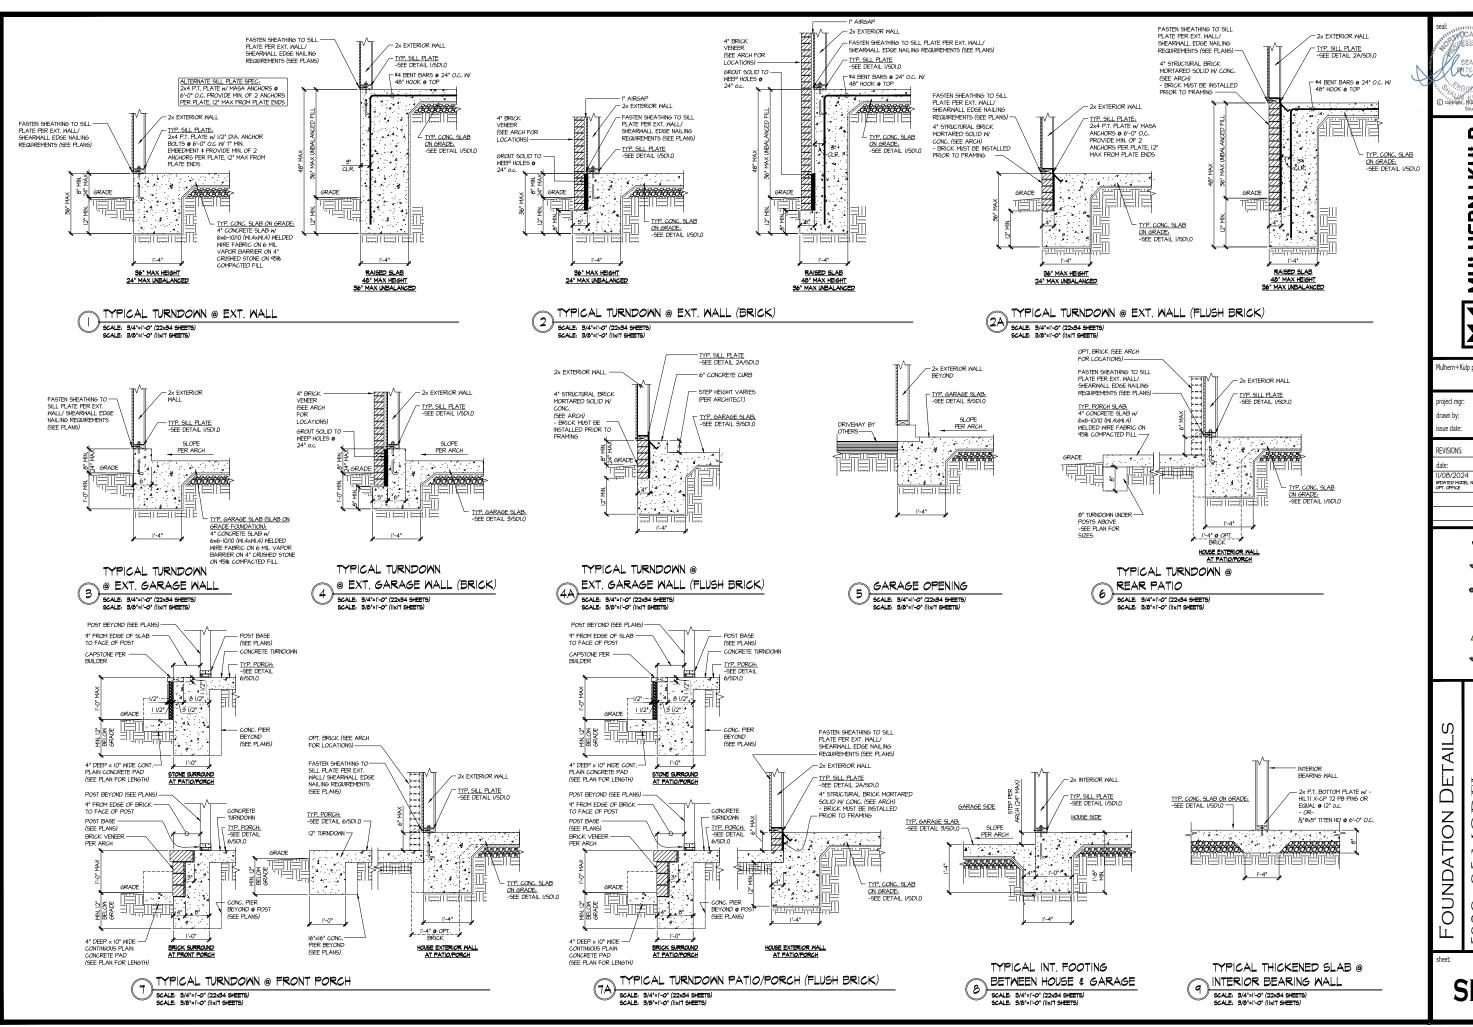

MULHERN+KULP RESIDENTIAL STRUCTURAL ENSINEERINS

Mulhern+Kulp project number 243-2403

SMK SMN 08-16-24


initial: 24 SMM DEL NAME, OPT. EXT. COVID. PORCH,

pointe HOMES

MODI -05 5920-

MASTER SET RALEIGH, NC SERENITY

SD1.0

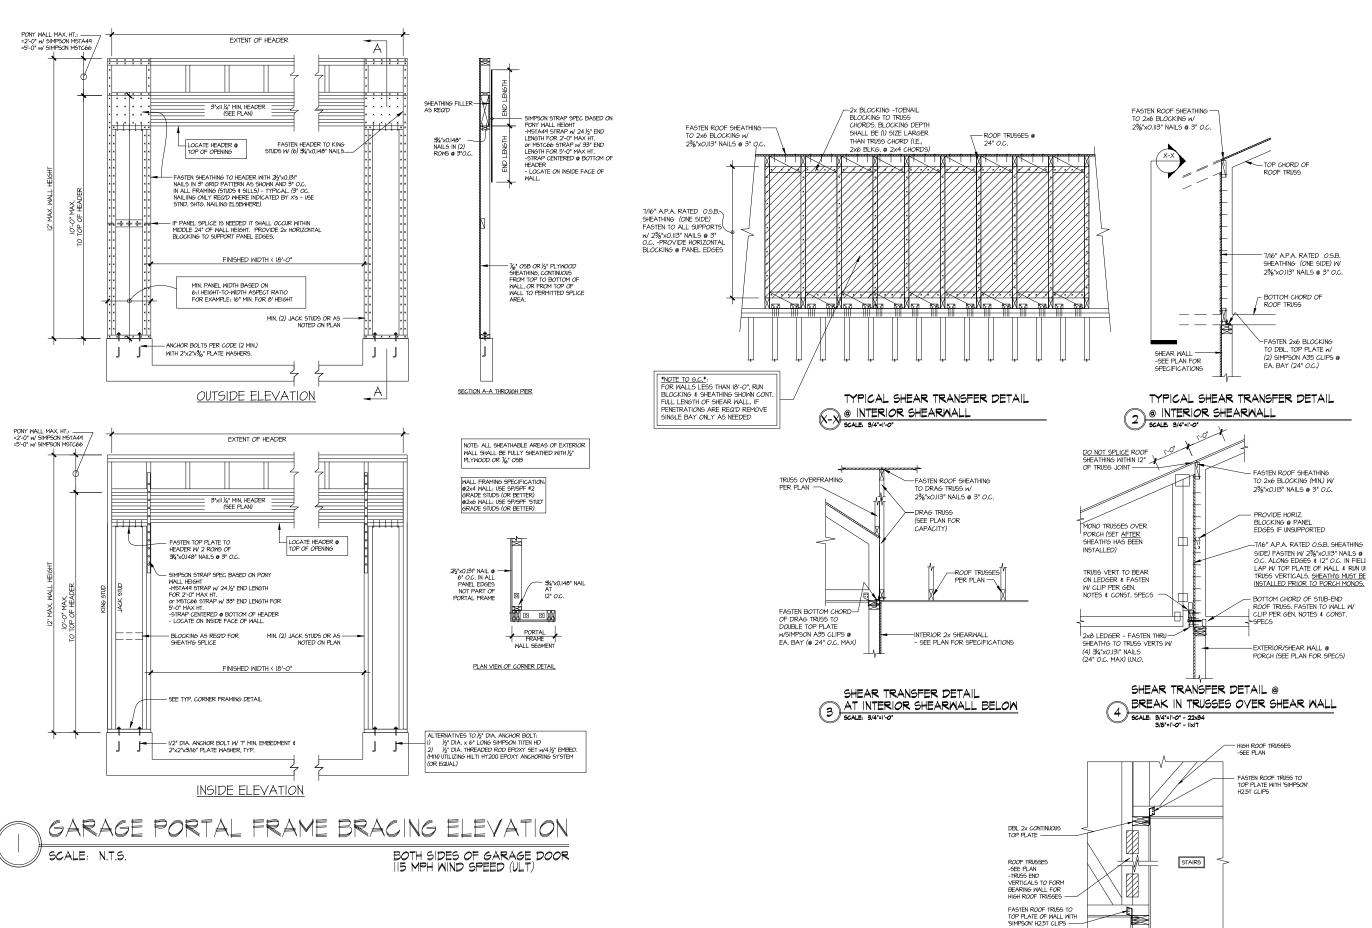

MULHERN+KULP
RESIDENTIAL STRUCTURAL ENGINEERING



Mulhern+Kulp project number

243-2403

SMK Irawn by: SMN ssue date: 08-16-24

REVISIONS:


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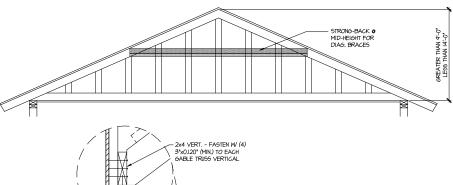
pointe. HOMES


Ŋ DETAIL MODE FRAMING -02

SERENITY MASTER SET RALEIGH, NC 5920-

SD2.0




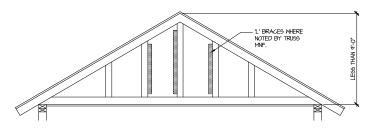

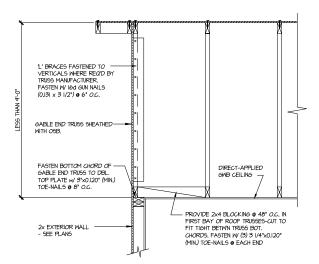

TYPICAL GABLE END BRACING DETAIL SCALE: NONE REQUIRED TRUSS REQ'D @ GABLE END TRUSS HEIGHT UP TO 4'-O"

BRACE GABLE END TRUSSES PER ABOVE DETAIL WHEN GABLE HEIGHT IS LESS THAN 9-0". "L" BRACES REQUIRED WHERE NOTED BY TRUSS MANUFACTURER.

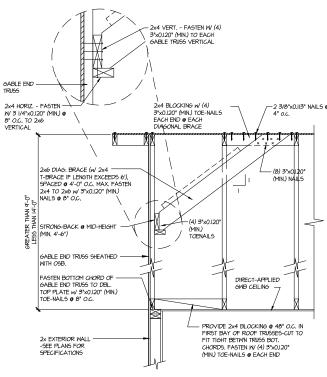

BRACE GABLE END TRUSSES PER ABOVE DETAIL WHEN GABLE HEIGHT EXCEEDS 9'-0'. L' BRACES NOT REQUIRED.

TYPICAL GABLE END BRACING DETAIL SCALE: NONE READ & GABLE END TRUSS

REQ'D & GABLE END TRUSS HEIGHT BETWIN 4'-0" TO 14'-0"

MULHERN+KULP
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SEE BRUSIG FAKING, SIR 250 - Aphrets, SA 3022
p.776-777-694 - ambreviations
NC License # C-3625



Mulhern+Kulp project number:

243-2403

SMK SMM drawn by: issue date: 08-16-24

REVISIONS:


initial: UI/O8/2024 SMM
UPDATED MODEL NAME, OPT. EXT. COV'D. PORCH,
OPT. OFFICE

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FRAMING DETAILS 5920-05 MODEL


SERENITY MASTER SET RALEIGH, NC

SD2.1

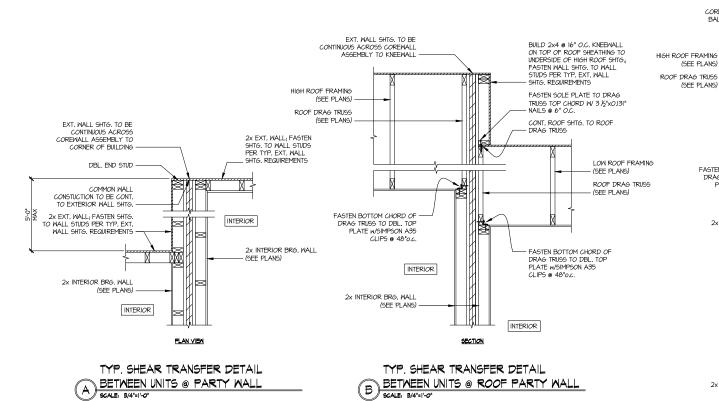

BETWEEN UNITS @ PARTY WALL
9CALE: 3/4"=1"-0"

ROOF SHTG. TO BE CONTINUOUS ACROSS COREWALL ASSEMBLY TO BALLOON FRAMED WALL -(SEE PLANS) -(SEE PLANS) -TOP OF WALL
PLATE HEIGHT @
ADJACENT UNIT FASTEN BOTTOM CHORD OF -DRAG TRUSS TO DBL. TOP PLATE W/SIMPSON A35 CLIPS @ 48"o.c. INTERIOR 2x INTERIOR BRG, WALL -(SEE PLANS) EXTERIOR TOP OF WALL
PLATE HEIGHT @ ADJACENT UNIT FLOOR SYSTEM (SEE PLANS) 2x EXT. WALL; FASTEN SHTG. TO WALL STUDS PER TYP. EXT. WALL SHTG. REQUIREMENTS INTERIOR 2v INTERIOR BRG WALL SECTION.

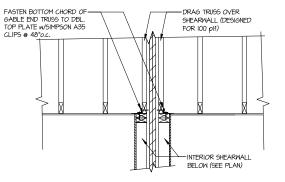

SHEAR TRANSFER DETAIL @ D GABLE END PARTY WALL

TYP. SHEAR TRANSFER DETAIL BETWEEN UNITS @ EXT. PARTY WALL

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243-2403

SMK

drawn by: SMN issue date: 08-16-24

REVISIONS:

initial: II/08/2024 SMM

UPDATED MODEL NAME, OPT. EXT. COV'D. PORCH, OPT. OFFICE

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DETAILS 5920-05 MODEI PARTY WALL SERENITY MASTER SET RALEIGH, NC

SD2.2