

## OPTIONS

House Plan	Development	Lot #	Address	Garage Side	Total HSF	Total Under Roof
Janville	Oakmont	352	270 Travelers Way	Left	2130.74	2720.13

### EXTERIOR:

X	Elevation STD or A
	Elevation B
	Elevation C
	Cement Siding
X	Vinyl Siding
	Lap siding only
X	Board and Batten
	Trellis
	Shutters
	3 Car Garage
	Side Load
	Garage Window Panels
	Garage door from double car to single car garage
	Garage Door to Back Yard
	Covered Back Porch
	Extended Porch
	Side Lite
	Stone Skirt
X	Stem
	Crawl

### INTERIOR:

	Extra windows in living room
	Optional Kitchen Layout
	1st Floor Guest Suite
	1st Floor Flex Room
X	Standard Electric Fireplace
	Gas Fireplace
	Shiplap Electric Fireplace
	Shiplap Gas Fireplace
	Bookshelves
	Under Cab Lighting
	Bonus Room
	2nd Vanity in Secondary bathroom
	Linen Room Door (Argyle Owner Suite Only)
	Open Railing
	Attic Stairs
	Laundry Sink

### ELECTRICAL:

	Under Cab Lights
	Second Vanity - Upstairs bathroom

# Janville Model Garage LEFT

STANDARD ELEVATIONS

WITH OPTIONS

AUGUST 16th, 2024



ORIGINAL SKETCH FRONT ELEVATION

### BUILDING AREAS:

HEATED AREAS:	
FIRST FLOOR	± 1,273.49 SQ FT
SECOND FLOOR	± 857.25 SQ FT
TOTAL HEATED	± 2,130.74 SQ FT
SECOND FLOOR (OPT)	± 1,053.16 SQ FT
OPT. TOTAL HEATED	± 2,331.65 SQ FT


UNHEATED AREAS:	
PORCHES	± 221.82 SQ FT
GARAGE	± 367.57 SQ FT
TOTAL UNHEATED	± 589.39 SQ FT

TOTAL AREA UNDER ROOF:	± 2,720.13 SQ FT
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OPT. TOTAL AREA UNDER ROOF:	± 2,921.04 SQ FT
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E1.3	ELECTRICAL / TRUSS MAIN FLOOR OVERLAY



STANDARD SIDE ELEVATION

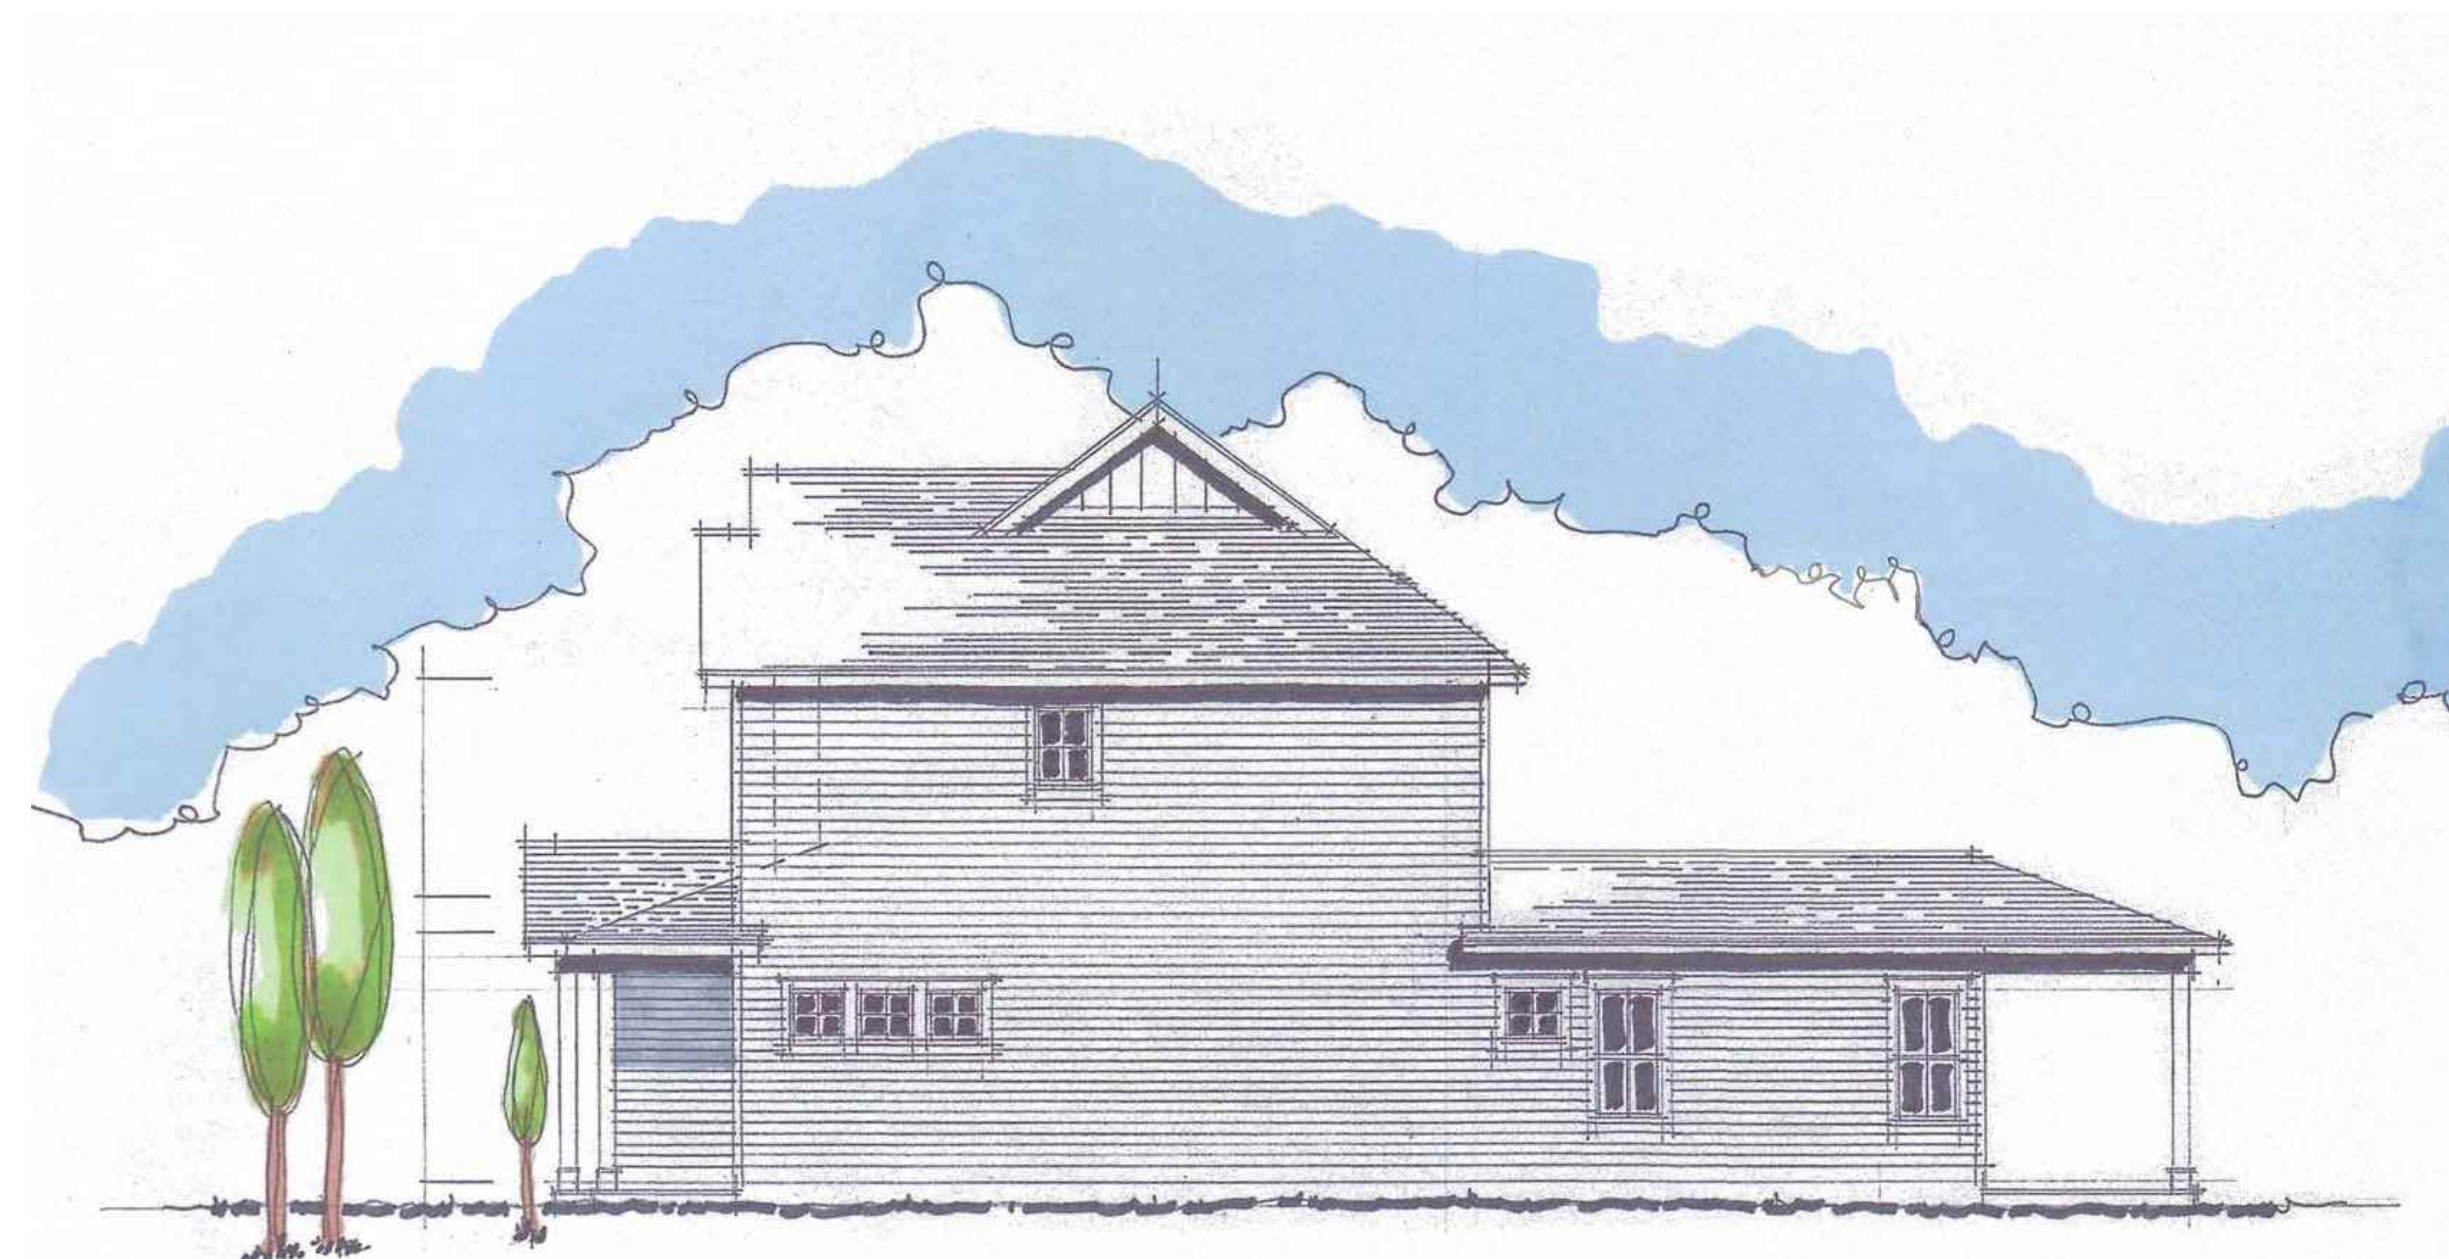

OPTIONAL SIDE ELEVATION

REVISIONS:

**J.S. THOMPSON**  
ENGINEERING, INC.  
333 E. SIX FORKS RD., SUITE 180  
RALEIGH, NC 27609  
PHONE: (919) 789-9919  
FAX: (919) 789-9921  
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THE JANVILLE


COVER SHEET

DATE: 2024-16-08  
DRAWN BY: JST  
ENGINEER: JST  
CHECKED BY: NS  
Q.C. BY: NS  
SCALE:


SHEET NUMBER#:

**A0**



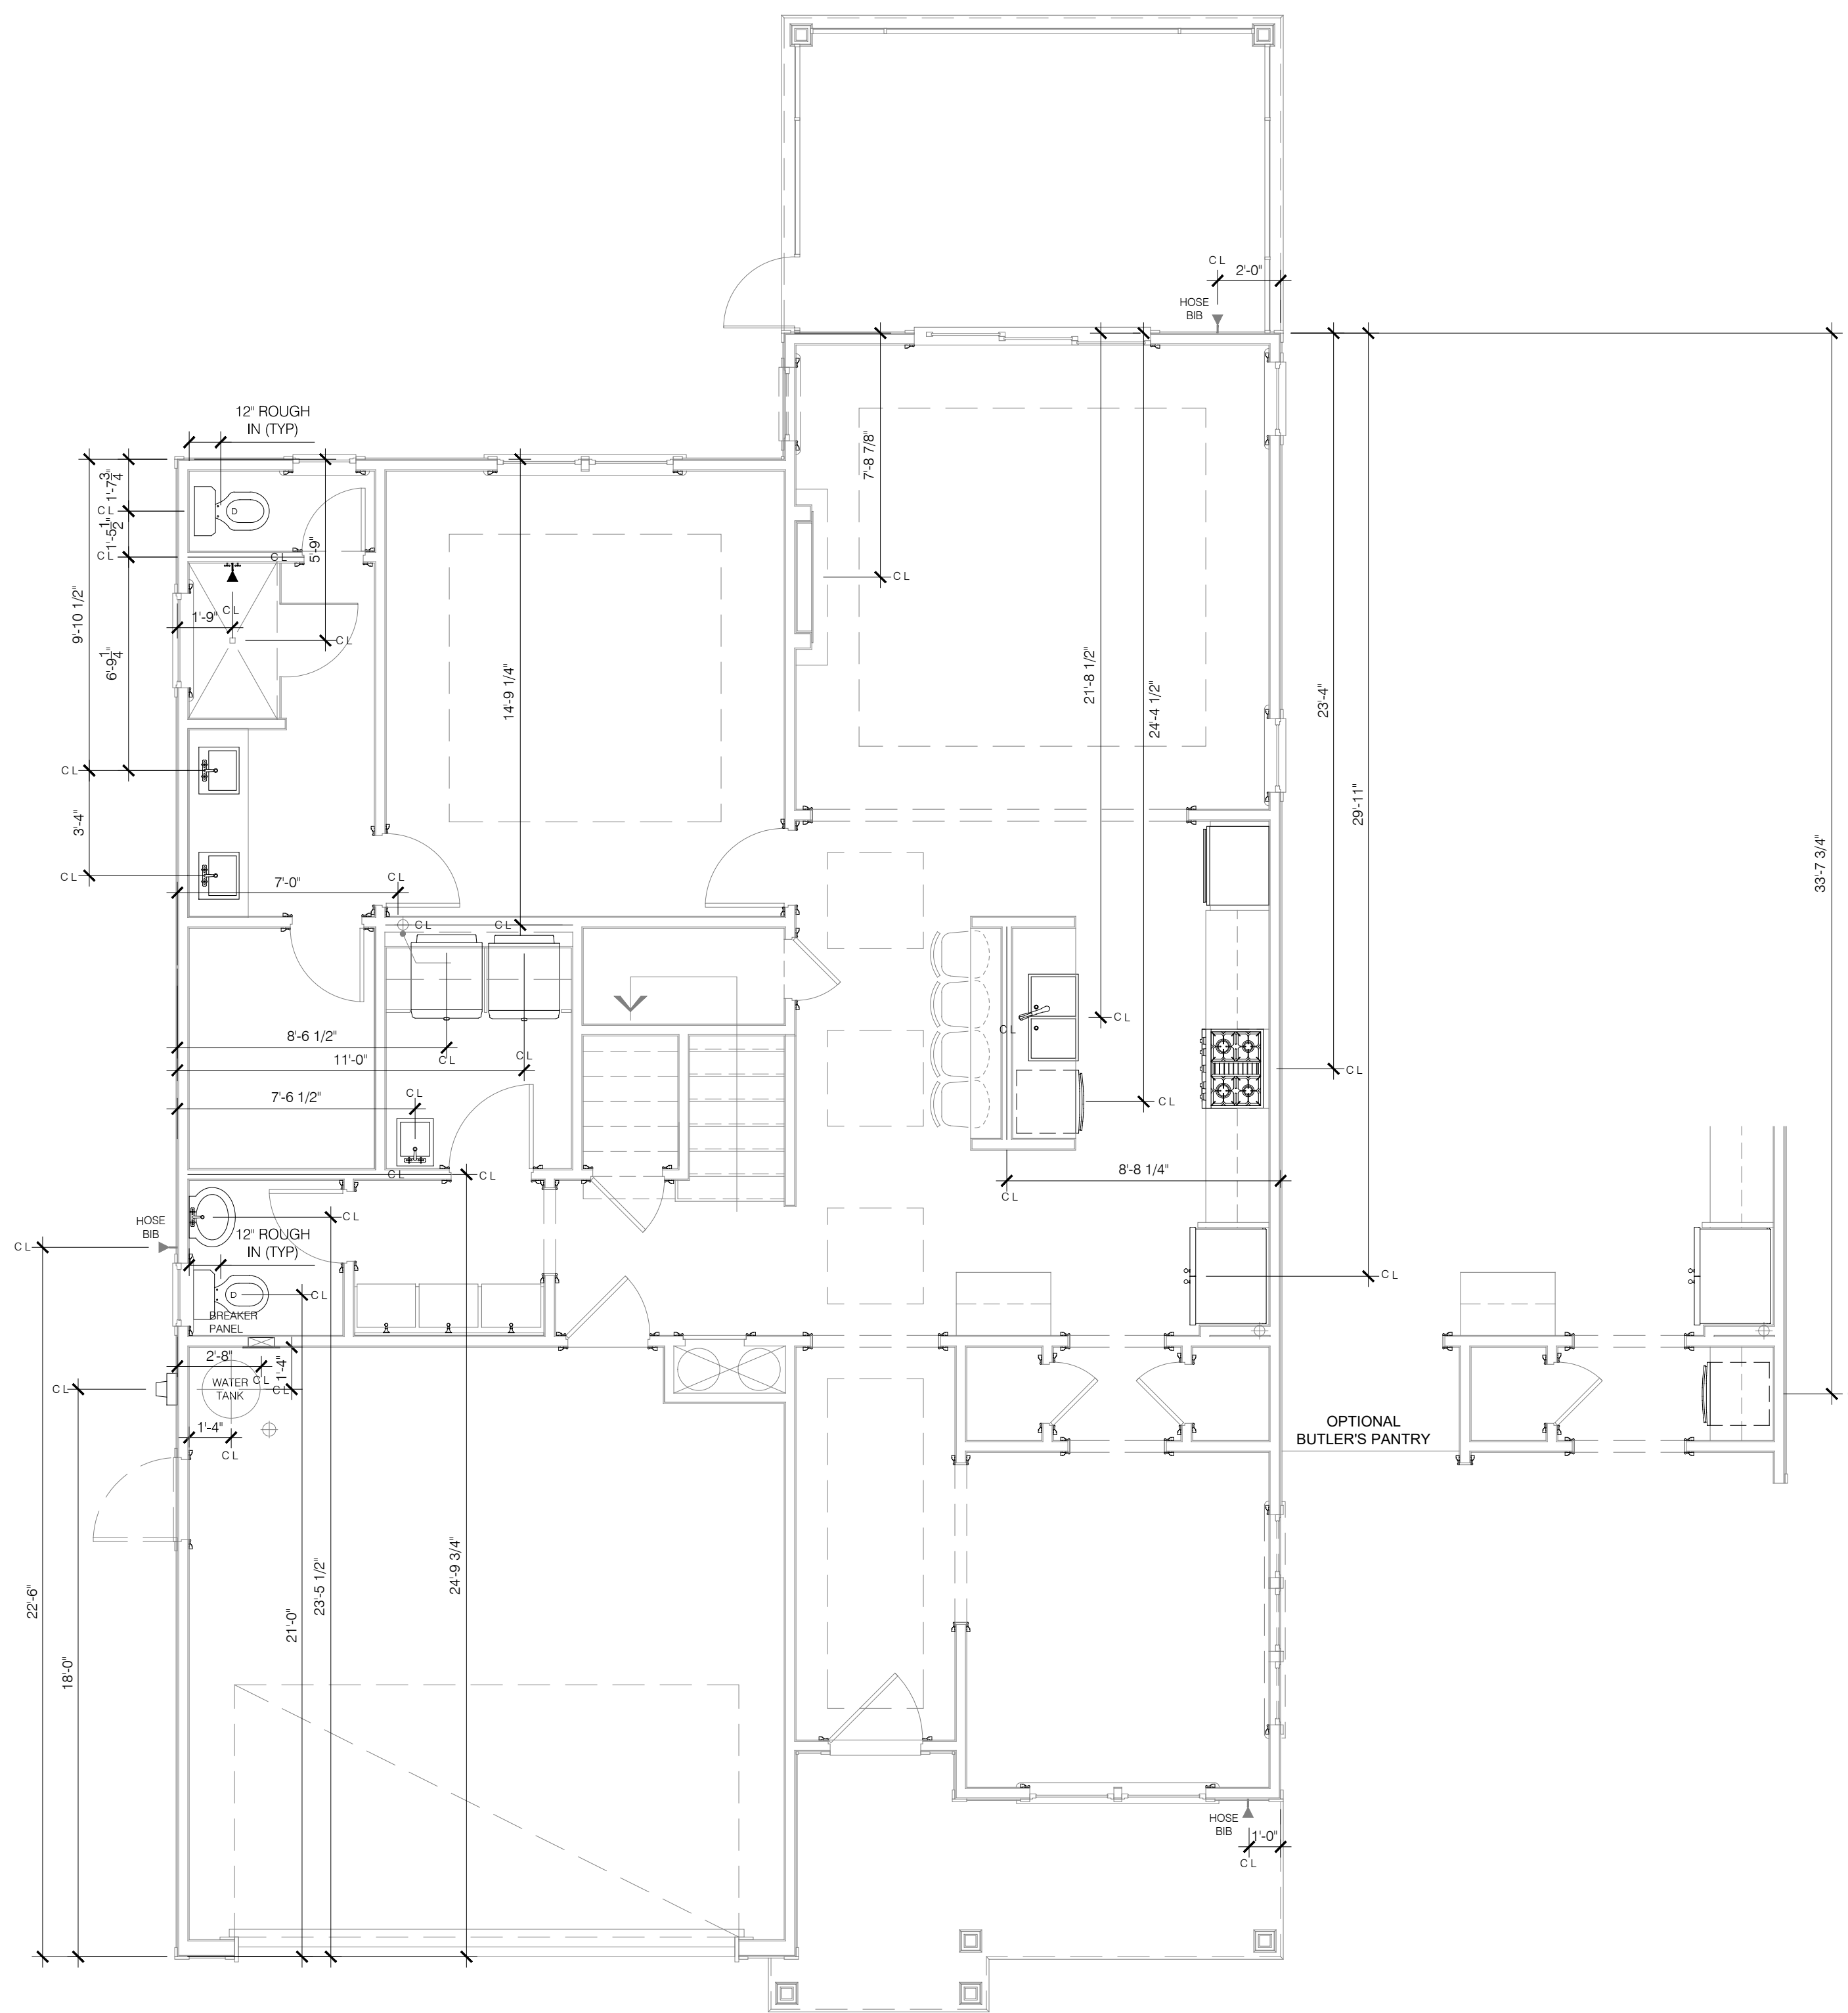

MAIN FLOOR LEVEL

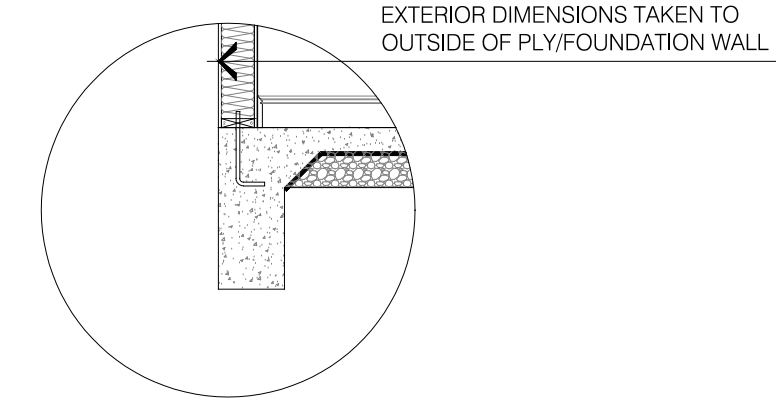

PLUMBING FIXTURE LOCATIONS PLANS - STANDARD WITH OPTIONS  
SCALE: 1/4" = 1'-0"

REVISIONS:


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RALEIGH, NC 27609  
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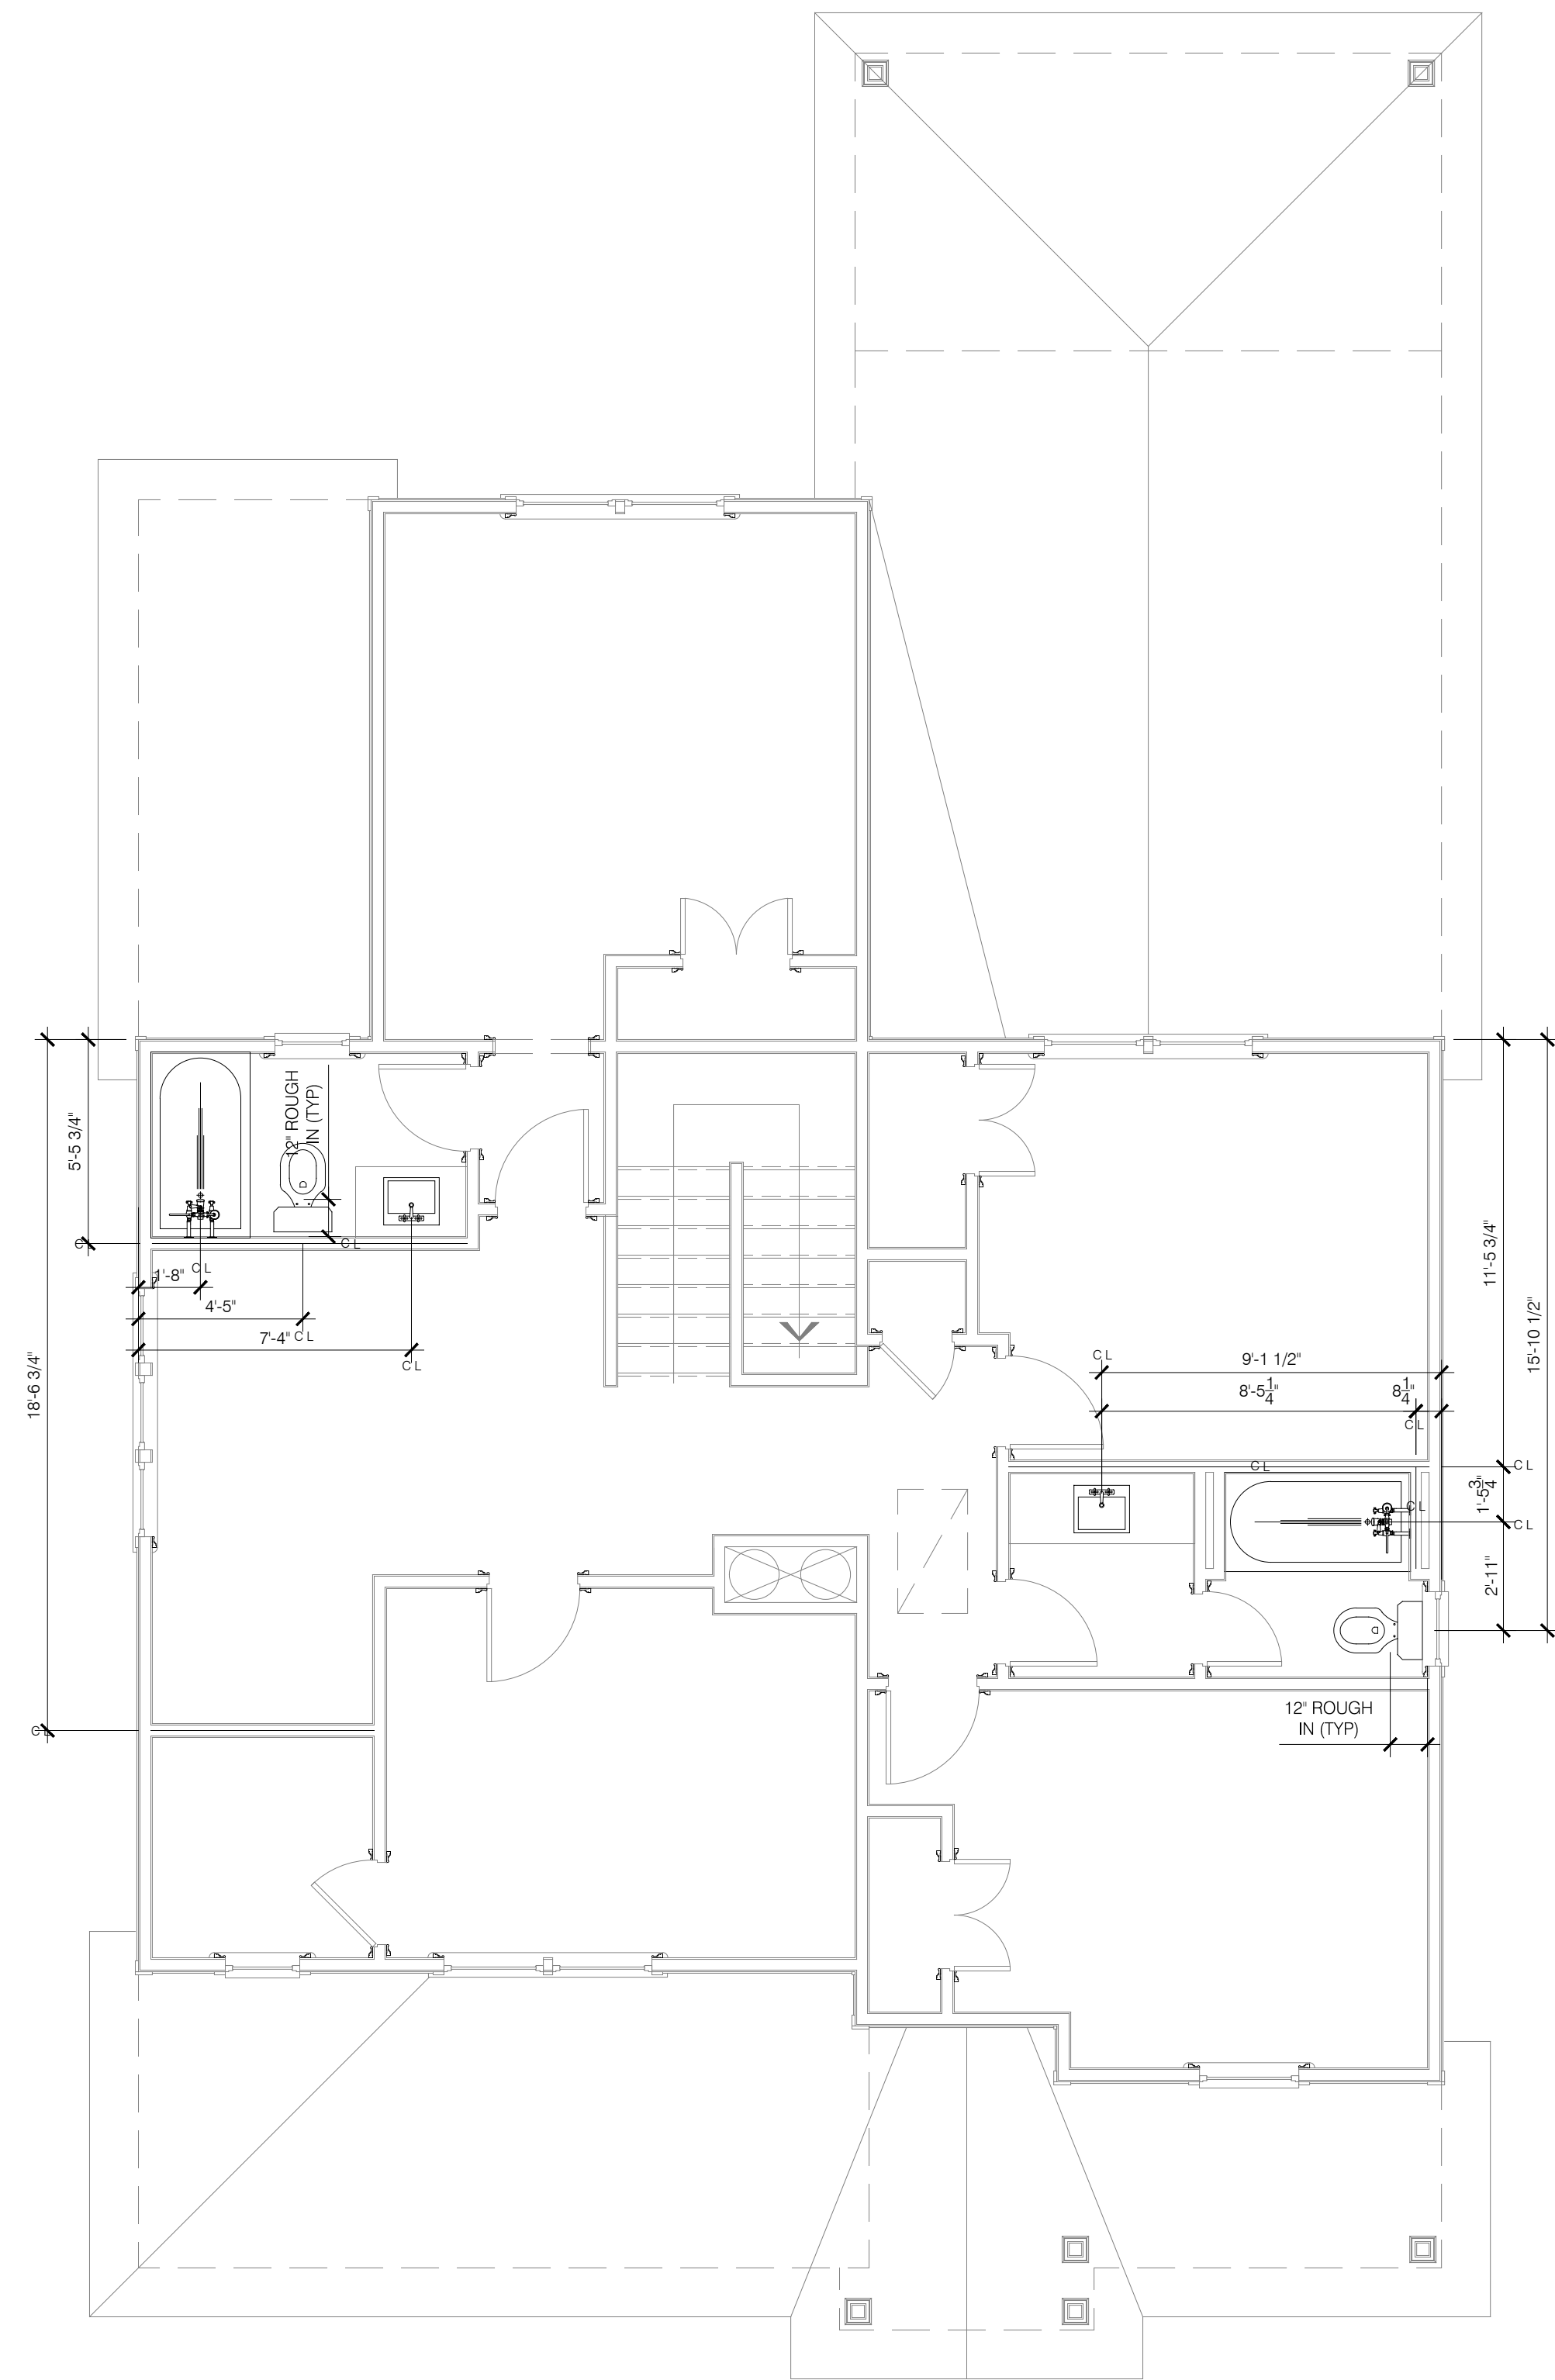
**THE JANVILLE**  
MAIN FLOOR PLAN  
PLUMBING LOCATIONS

DATE: 2024-16-08  
DRAWN BY: JST  
ENGINEER: NS  
CHECKED BY: NS  
SCALE:  
SHEET NUMBER:  
**P1**


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UPPER FLOOR LEVEL "STANDARD"



UPPER FLOOR LEVEL OPTION "B"

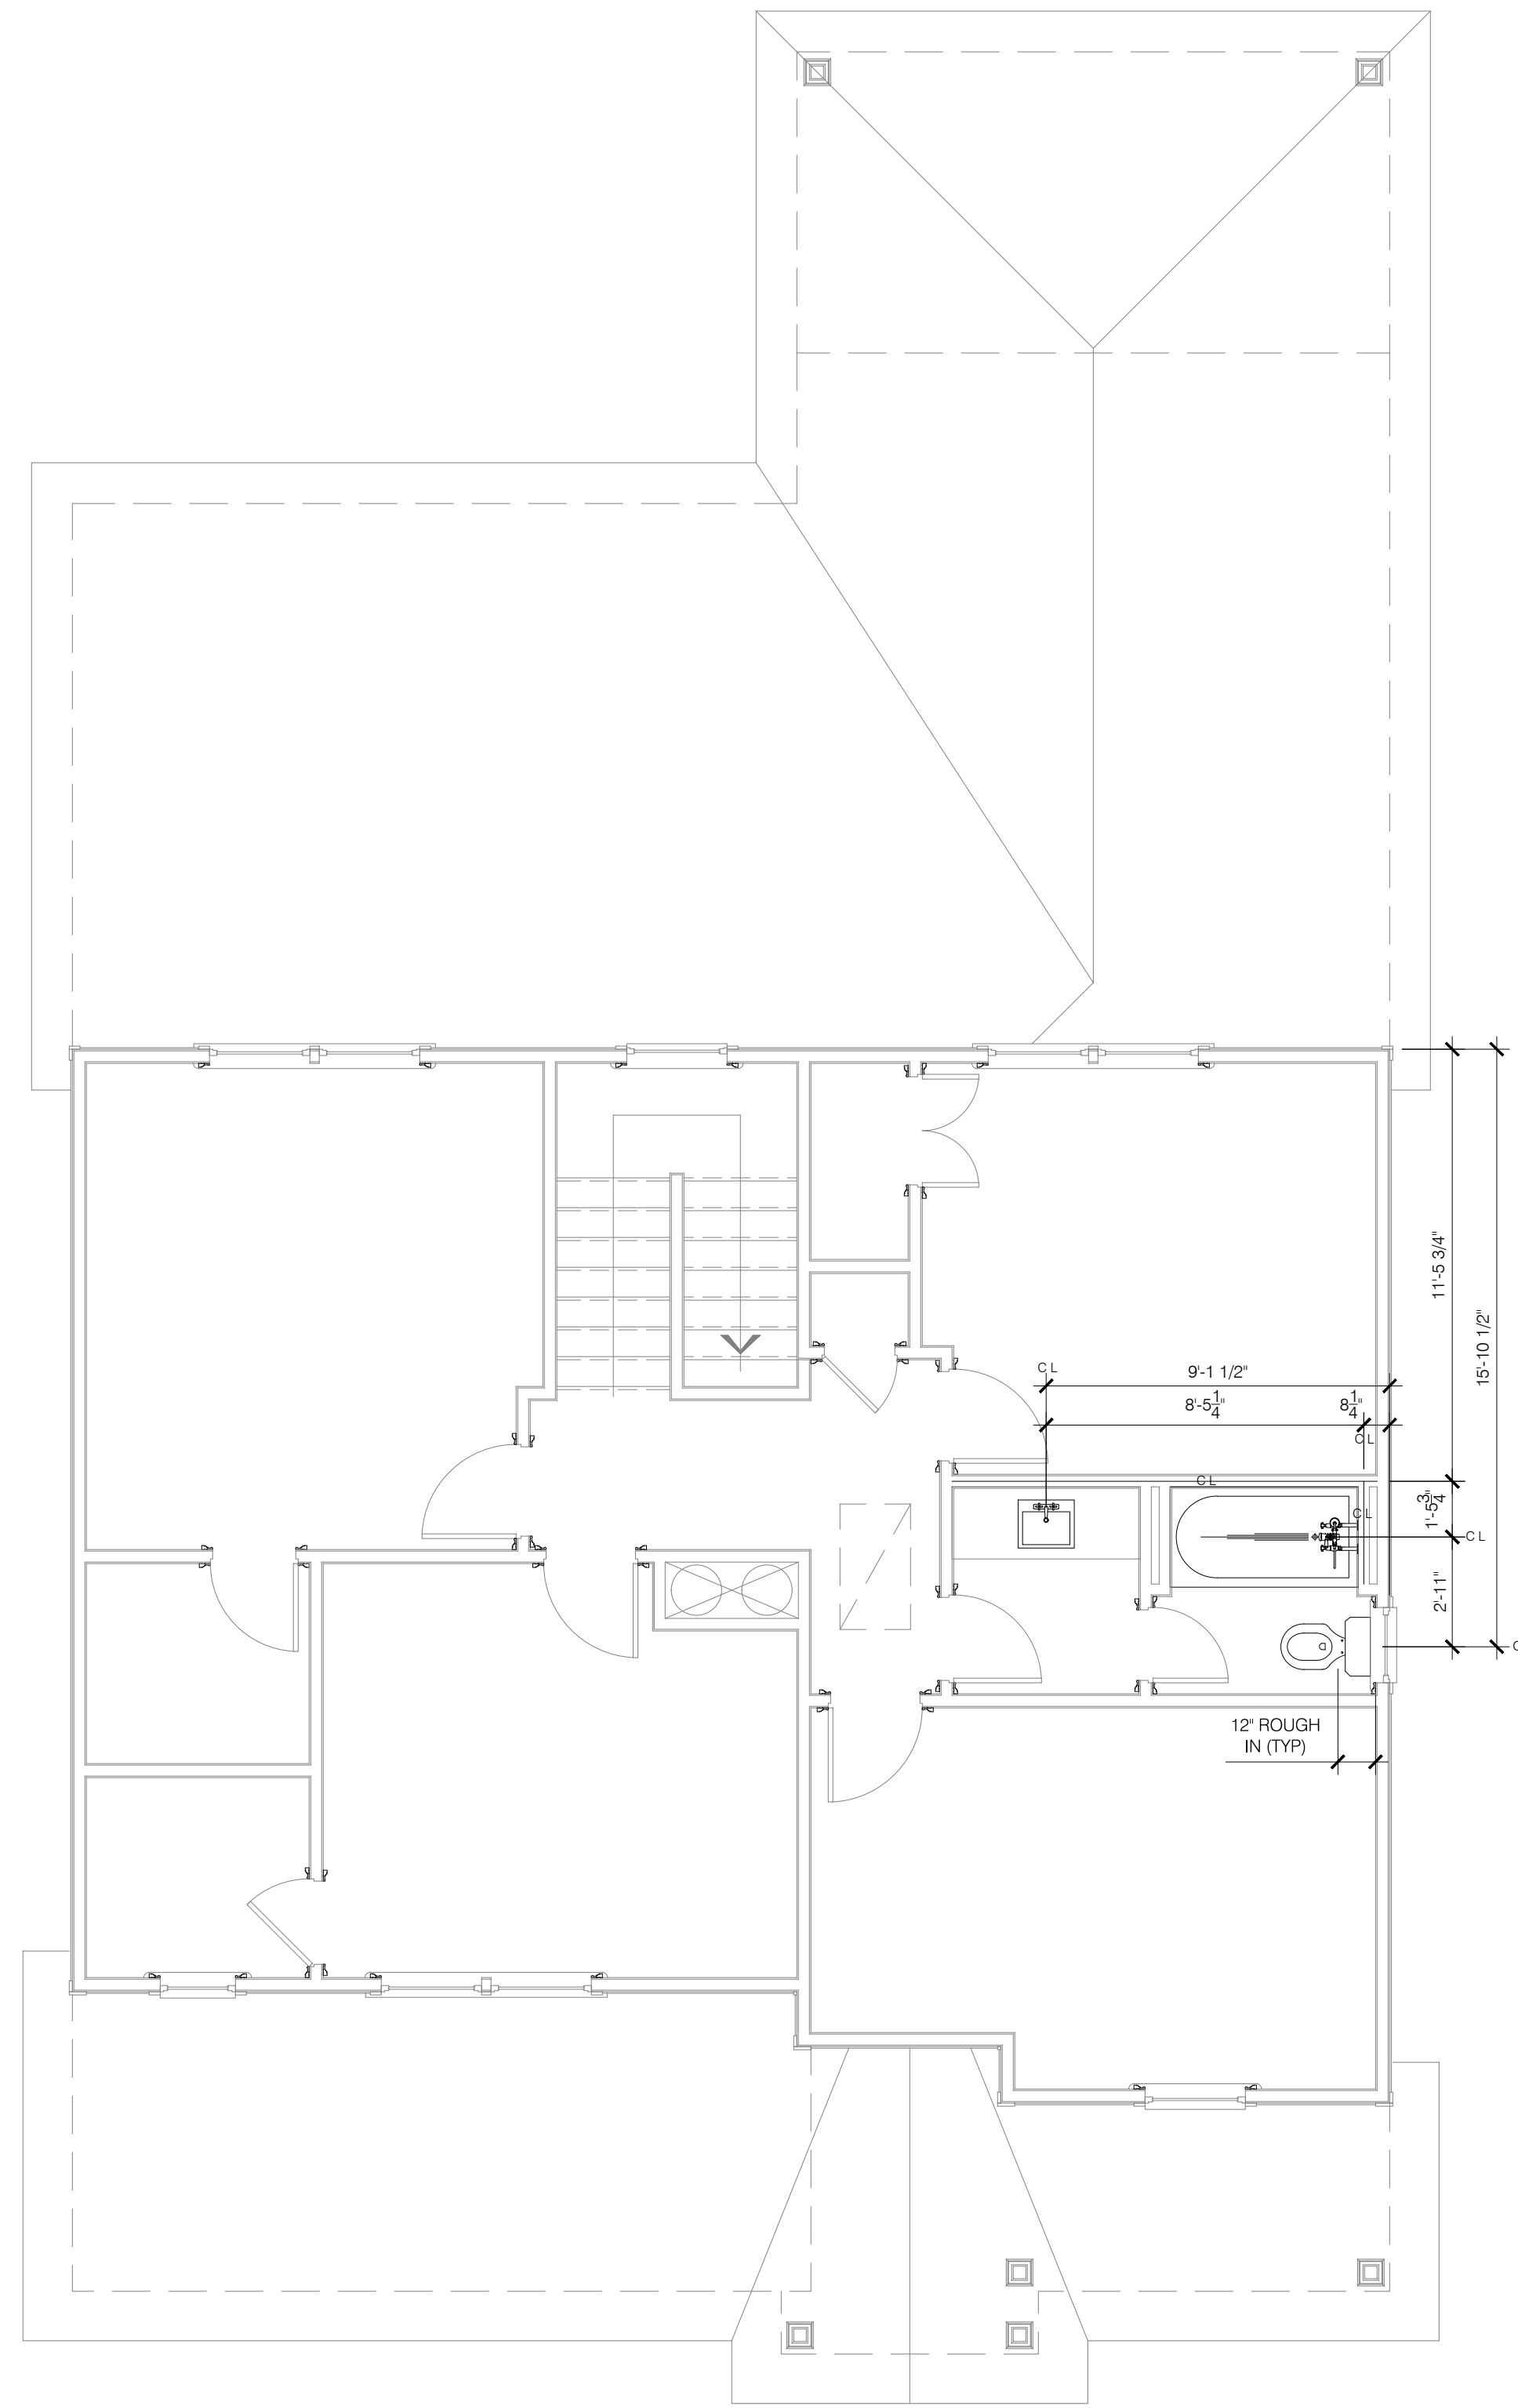

PLUMBING FIXTURE LOCATIONS PLANS - WITH OPTIONS  
SCALE: 1/4" = 1'-0"

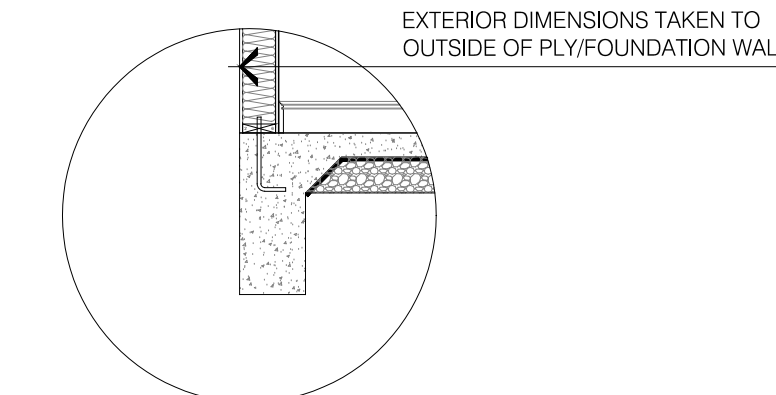REVISIONS:

**J.S. THOMPSON**  
ENGINEERING, INC.  
333 E. SIX FORKS RD., SUITE 180  
RALEIGH, NC 27609  
PHONE: (919) 789-9919  
FAX: (919) 789-9921  
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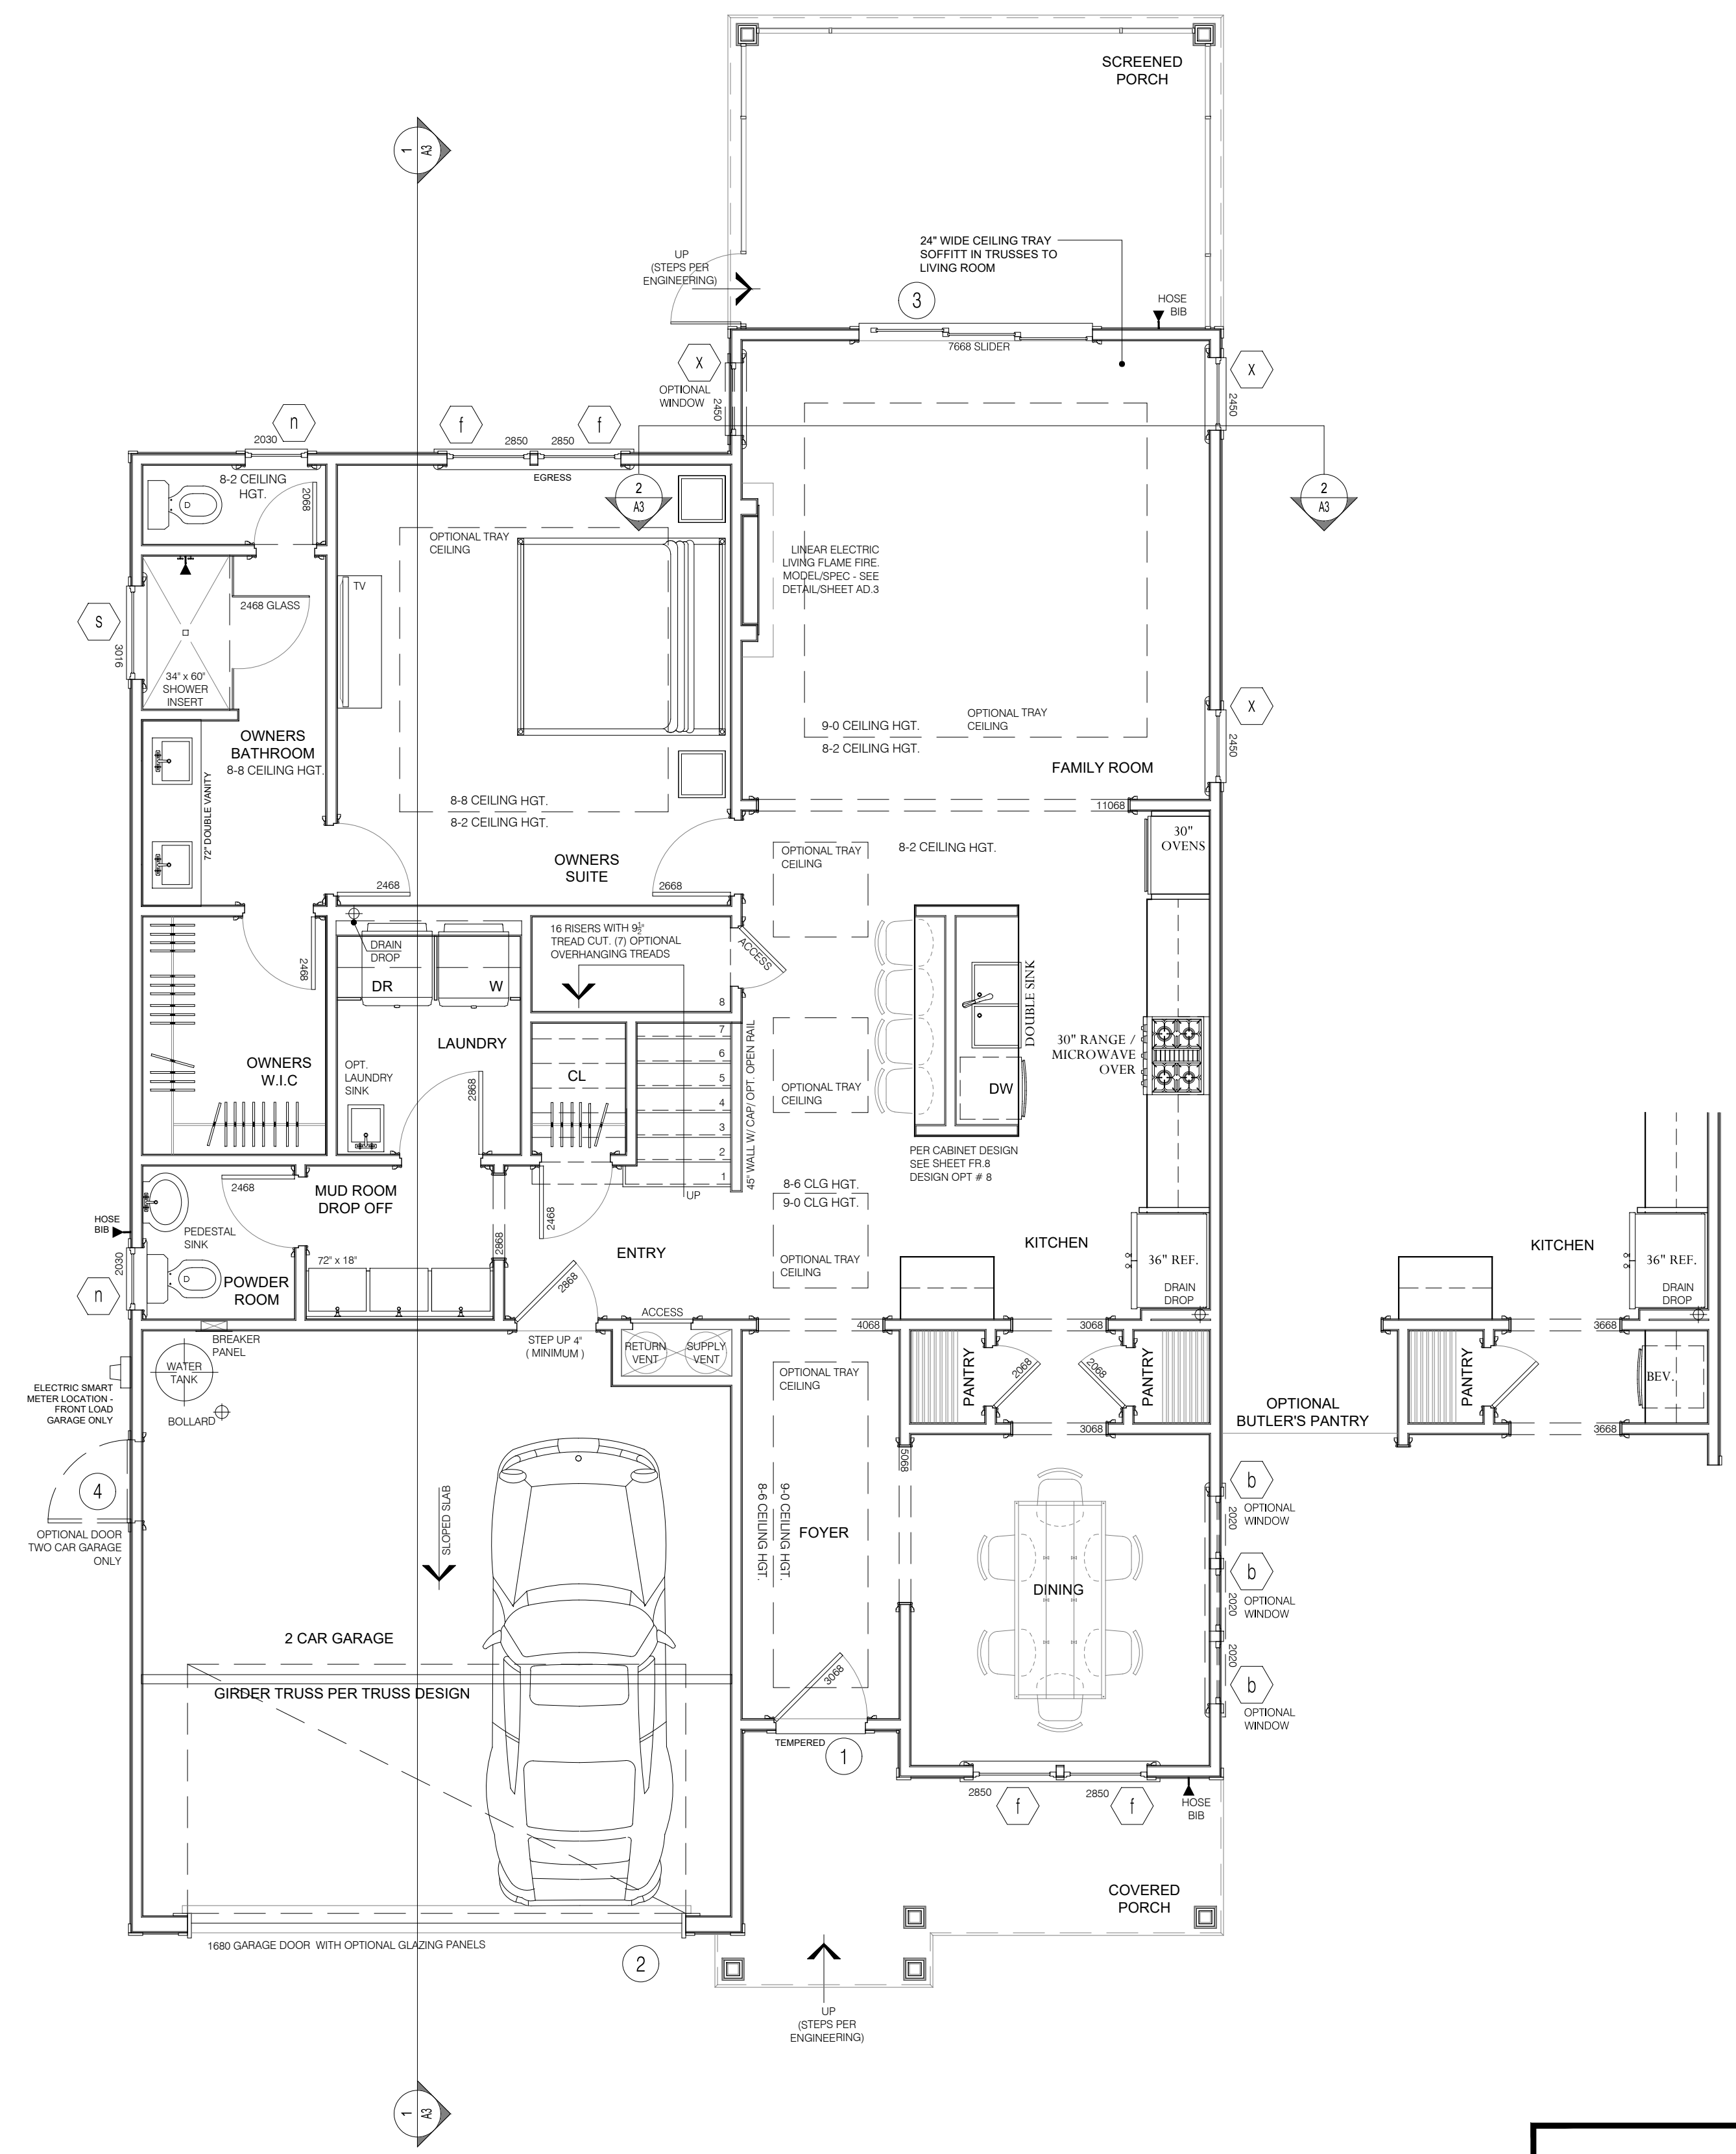
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UPPER FLOOR PLAN  
PLUMBING LOCATIONS

DATE: 2024-16-08  
DRAWN BY: JST  
ENGINEER: NS  
CHECKED BY: NS  
SCALE:  
SHEET NUMBER:  
**P1.1**

**BUILDING AREAS:**

<b>HEATED AREAS:</b>	
FIRST FLOOR	± 1,273.49 SQ FT
SECOND FLOOR	± 857.25 SQ FT
<b>TOTAL HEATED</b>	<b>± 2,130.74 SQ FT</b>
<b>UNHEATED AREAS:</b>	
SECOND FLOOR (OPT)	± 1,053.16 SQ FT
<b>OPT. TOTAL HEATED</b>	<b>± 2,331.65 SQ FT</b>
<b>UNHEATED AREAS:</b>	
PORCHES	± 221.82 SQ FT
GARAGE	± 367.57 SQ FT
<b>TOTAL UNHEATED</b>	<b>± 589.39 SQ FT</b>
<b>TOTAL AREA UNDER ROOF:</b>	<b>± 2,720.13 SQ FT</b>
<b>OPT. TOTAL AREA UNDER ROOF:</b>	<b>± 2,921.04 SQ FT</b>



**NOTES:**  
ALL CASED OPENINGS SHOWN  
ARE OPTIONAL.

MAIN FLOOR PLAN - WITH OPTIONS  
SCALE: 1/4" = 1'-0"


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ENGINEERING, INC.  
333 E. SIX FORKS RD., SUITE 180  
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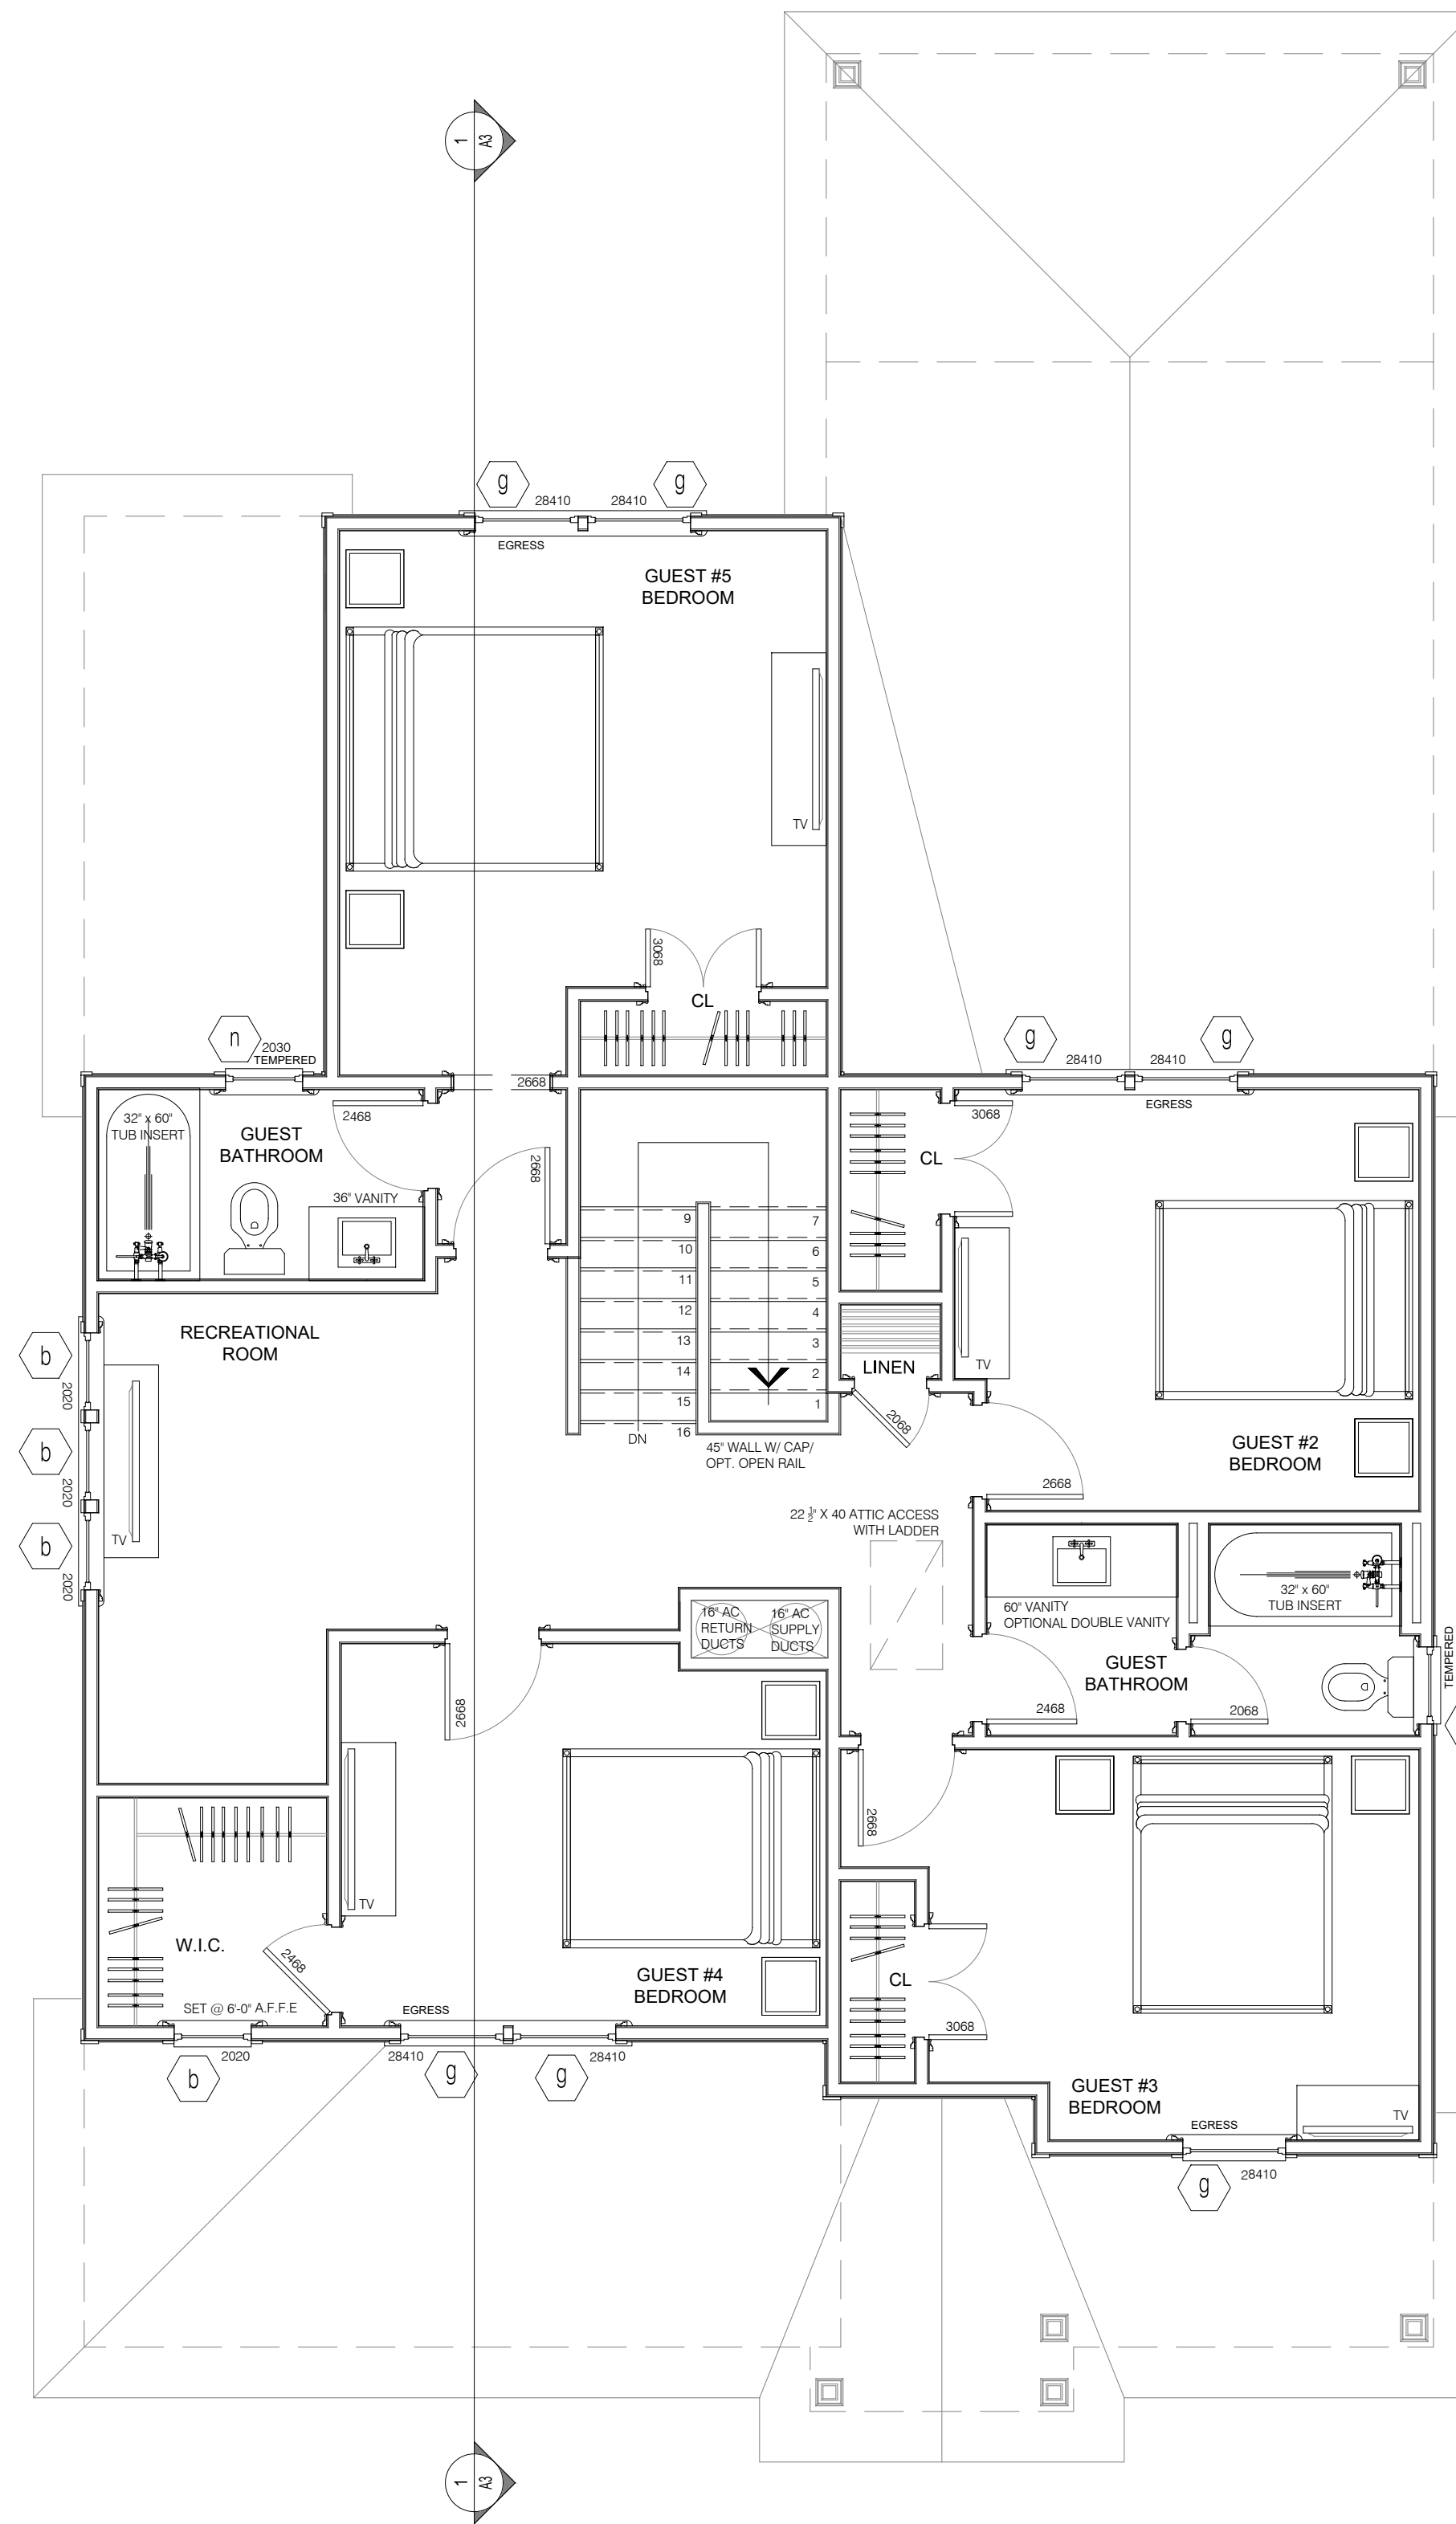
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MAIN FLOOR PLAN

DATE: 2024-16-08  
DRAWN BY: JST  
ENGINEER: NS  
CHECKED BY: NS  
O.C. BY: NS  
SCALE:  
SHEET NUMBER: **A1**



UPPER FLOOR LEVEL "STANDARD"

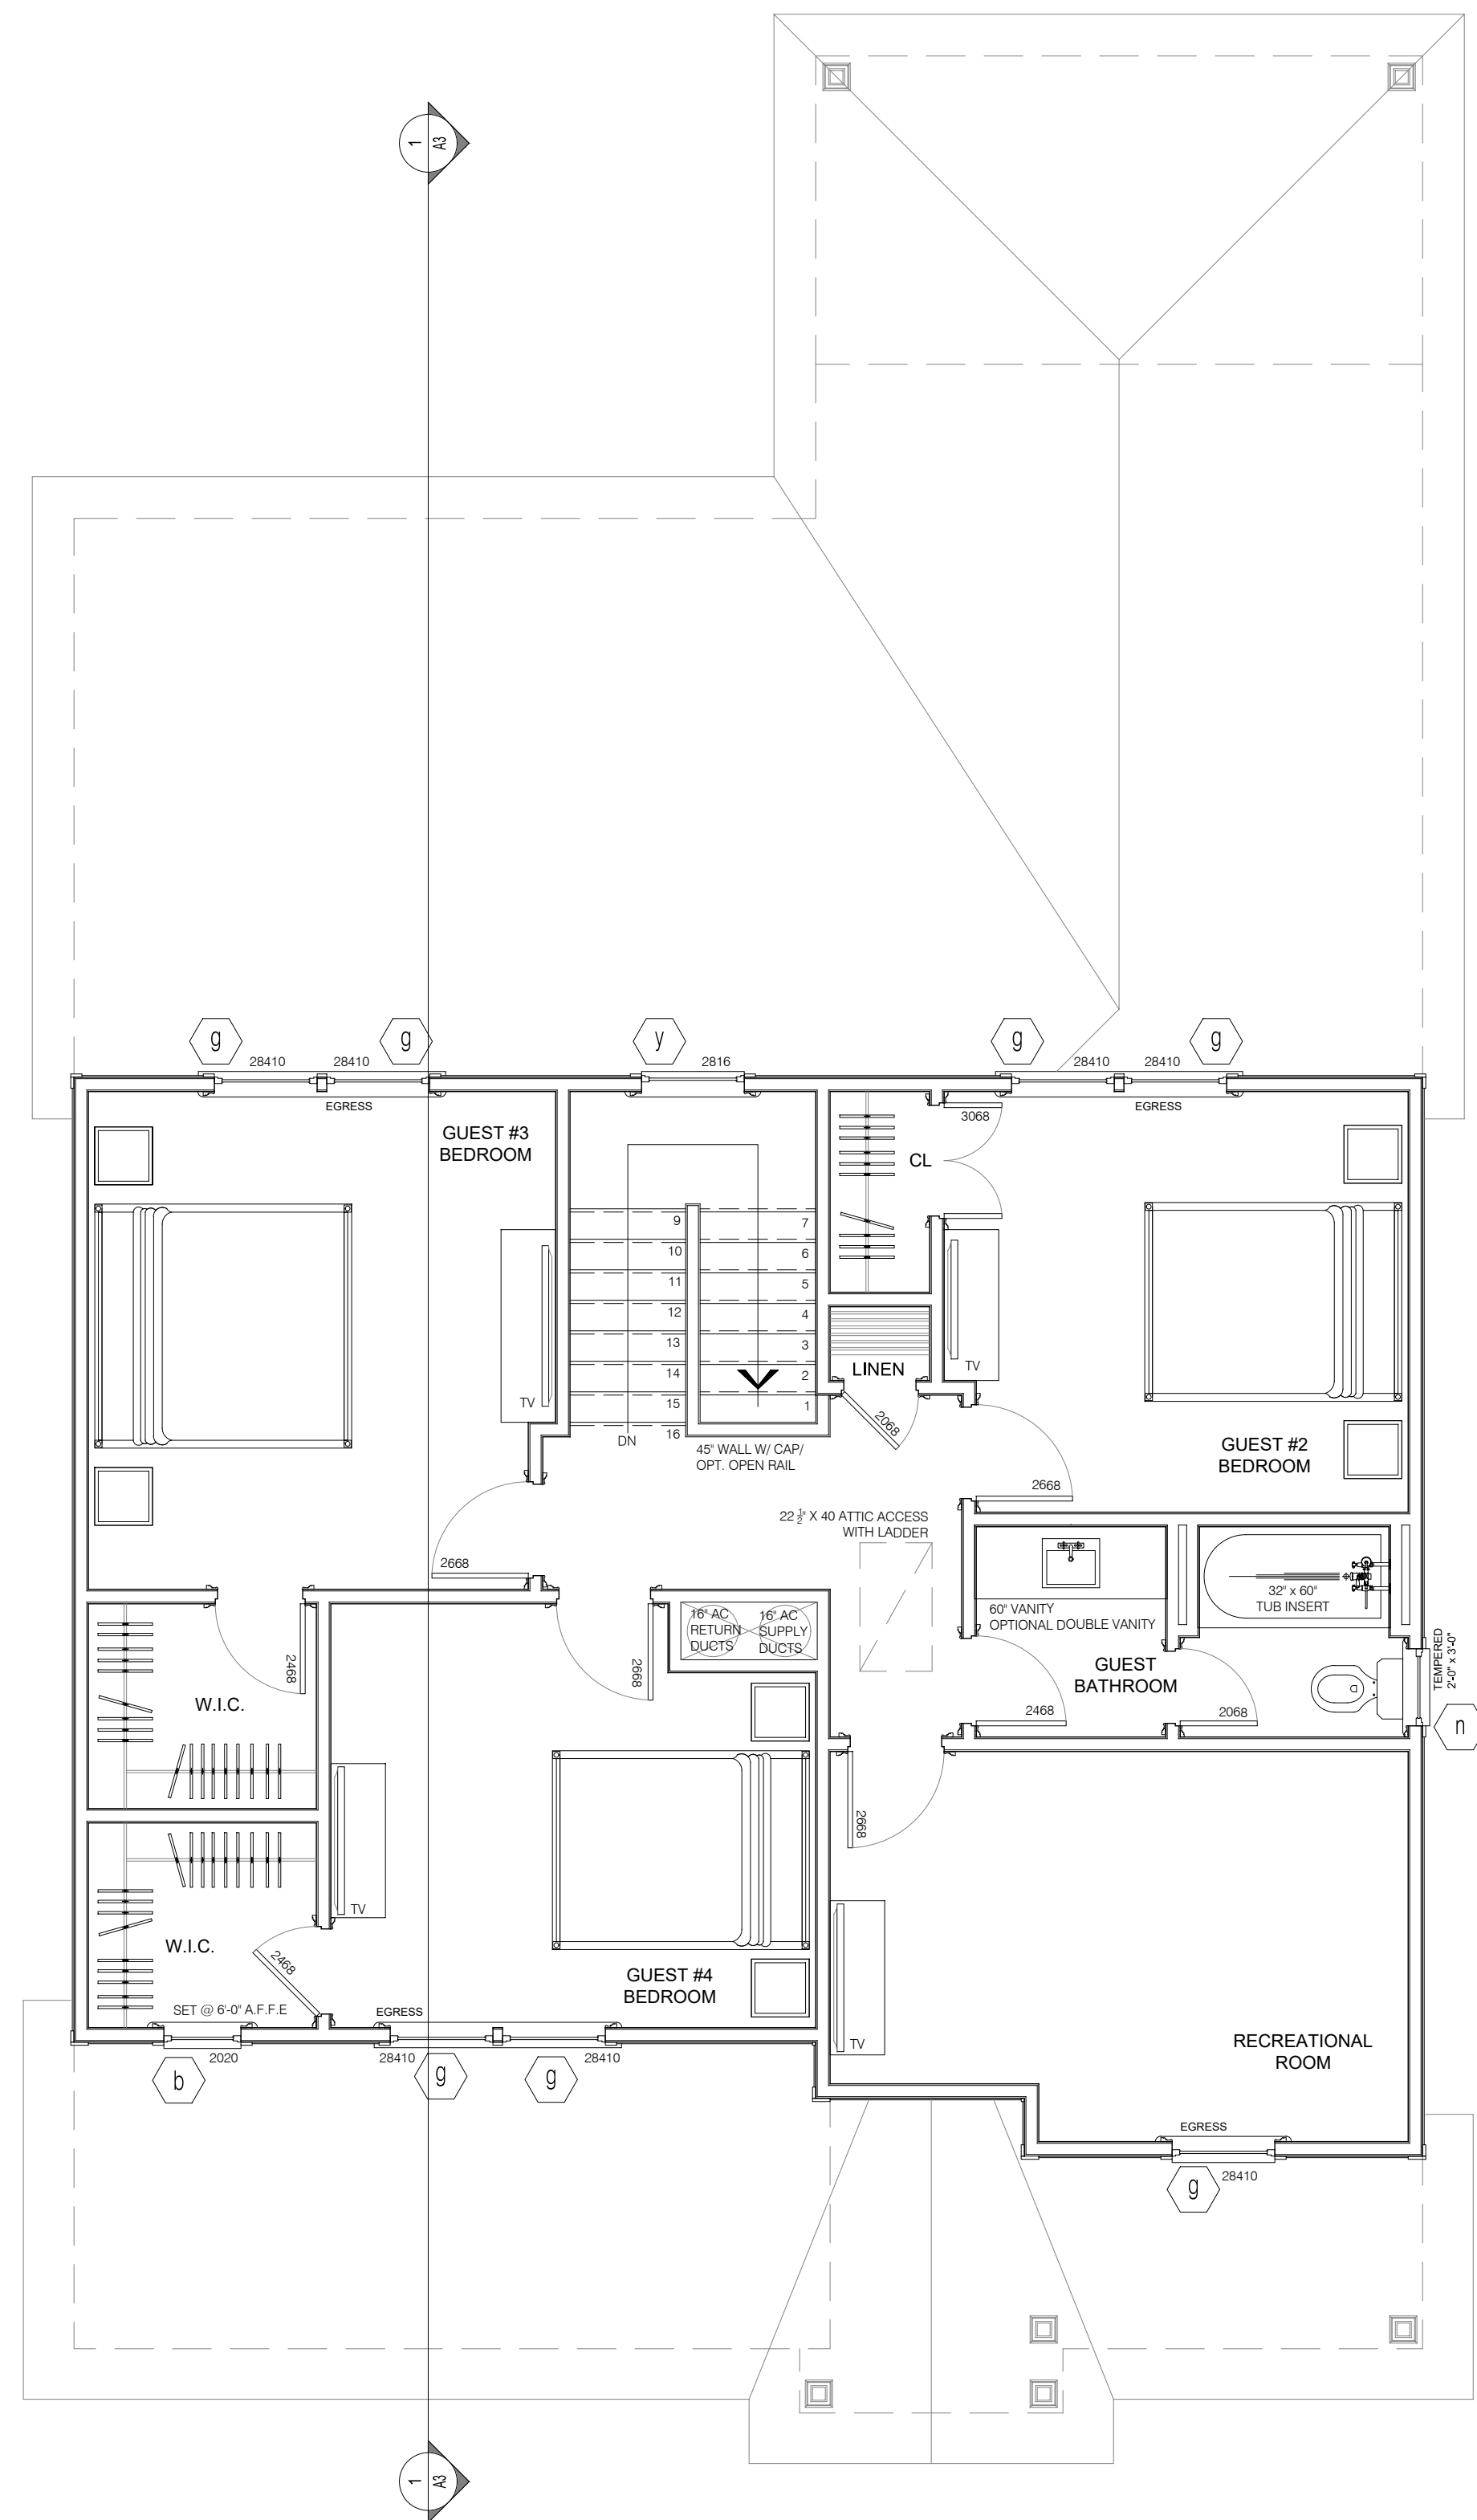

UPPER FLOOR LEVEL OPTION "B"

BUILDING AREAS:	
<b>HEATED AREAS:</b>	
FIRST FLOOR	± 1,273.49 SQ FT
SECOND FLOOR	± 857.25 SQ FT
<b>TOTAL HEATED</b>	<b>± 2,130.74 SQ FT</b>
<b>UNHEATED AREAS:</b>	
SECOND FLOOR (OPT)	± 1,053.16 SQ FT
<b>OPT. TOTAL HEATED</b>	<b>± 2,311.65 SQ FT</b>
<b>UNHEATED AREAS:</b>	
PORCHES	± 221.82 SQ FT
GARAGE	± 367.57 SQ FT
<b>TOTAL UNHEATED</b>	<b>± 589.39 SQ FT</b>
<b>TOTAL AREA UNDER ROOF:</b>	<b>± 2,720.13 SQ FT</b>
<b>OPT. TOTAL AREA UNDER ROOF:</b>	<b>± 2,921.04 SQ FT</b>

REVISIONS:


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UPPER FLOOR PLAN

DATE: 2024-16-08  
DRAWN BY: JST  
ENGINEER: NS  
CHECKED BY: NS  
O.C. BY: NS  
SCALE:  
SHEET NUMBER#:  
**A1.1**





**NOTES:**  
ALL CASED OPENINGS SHOWN  
ARE OPTIONAL.

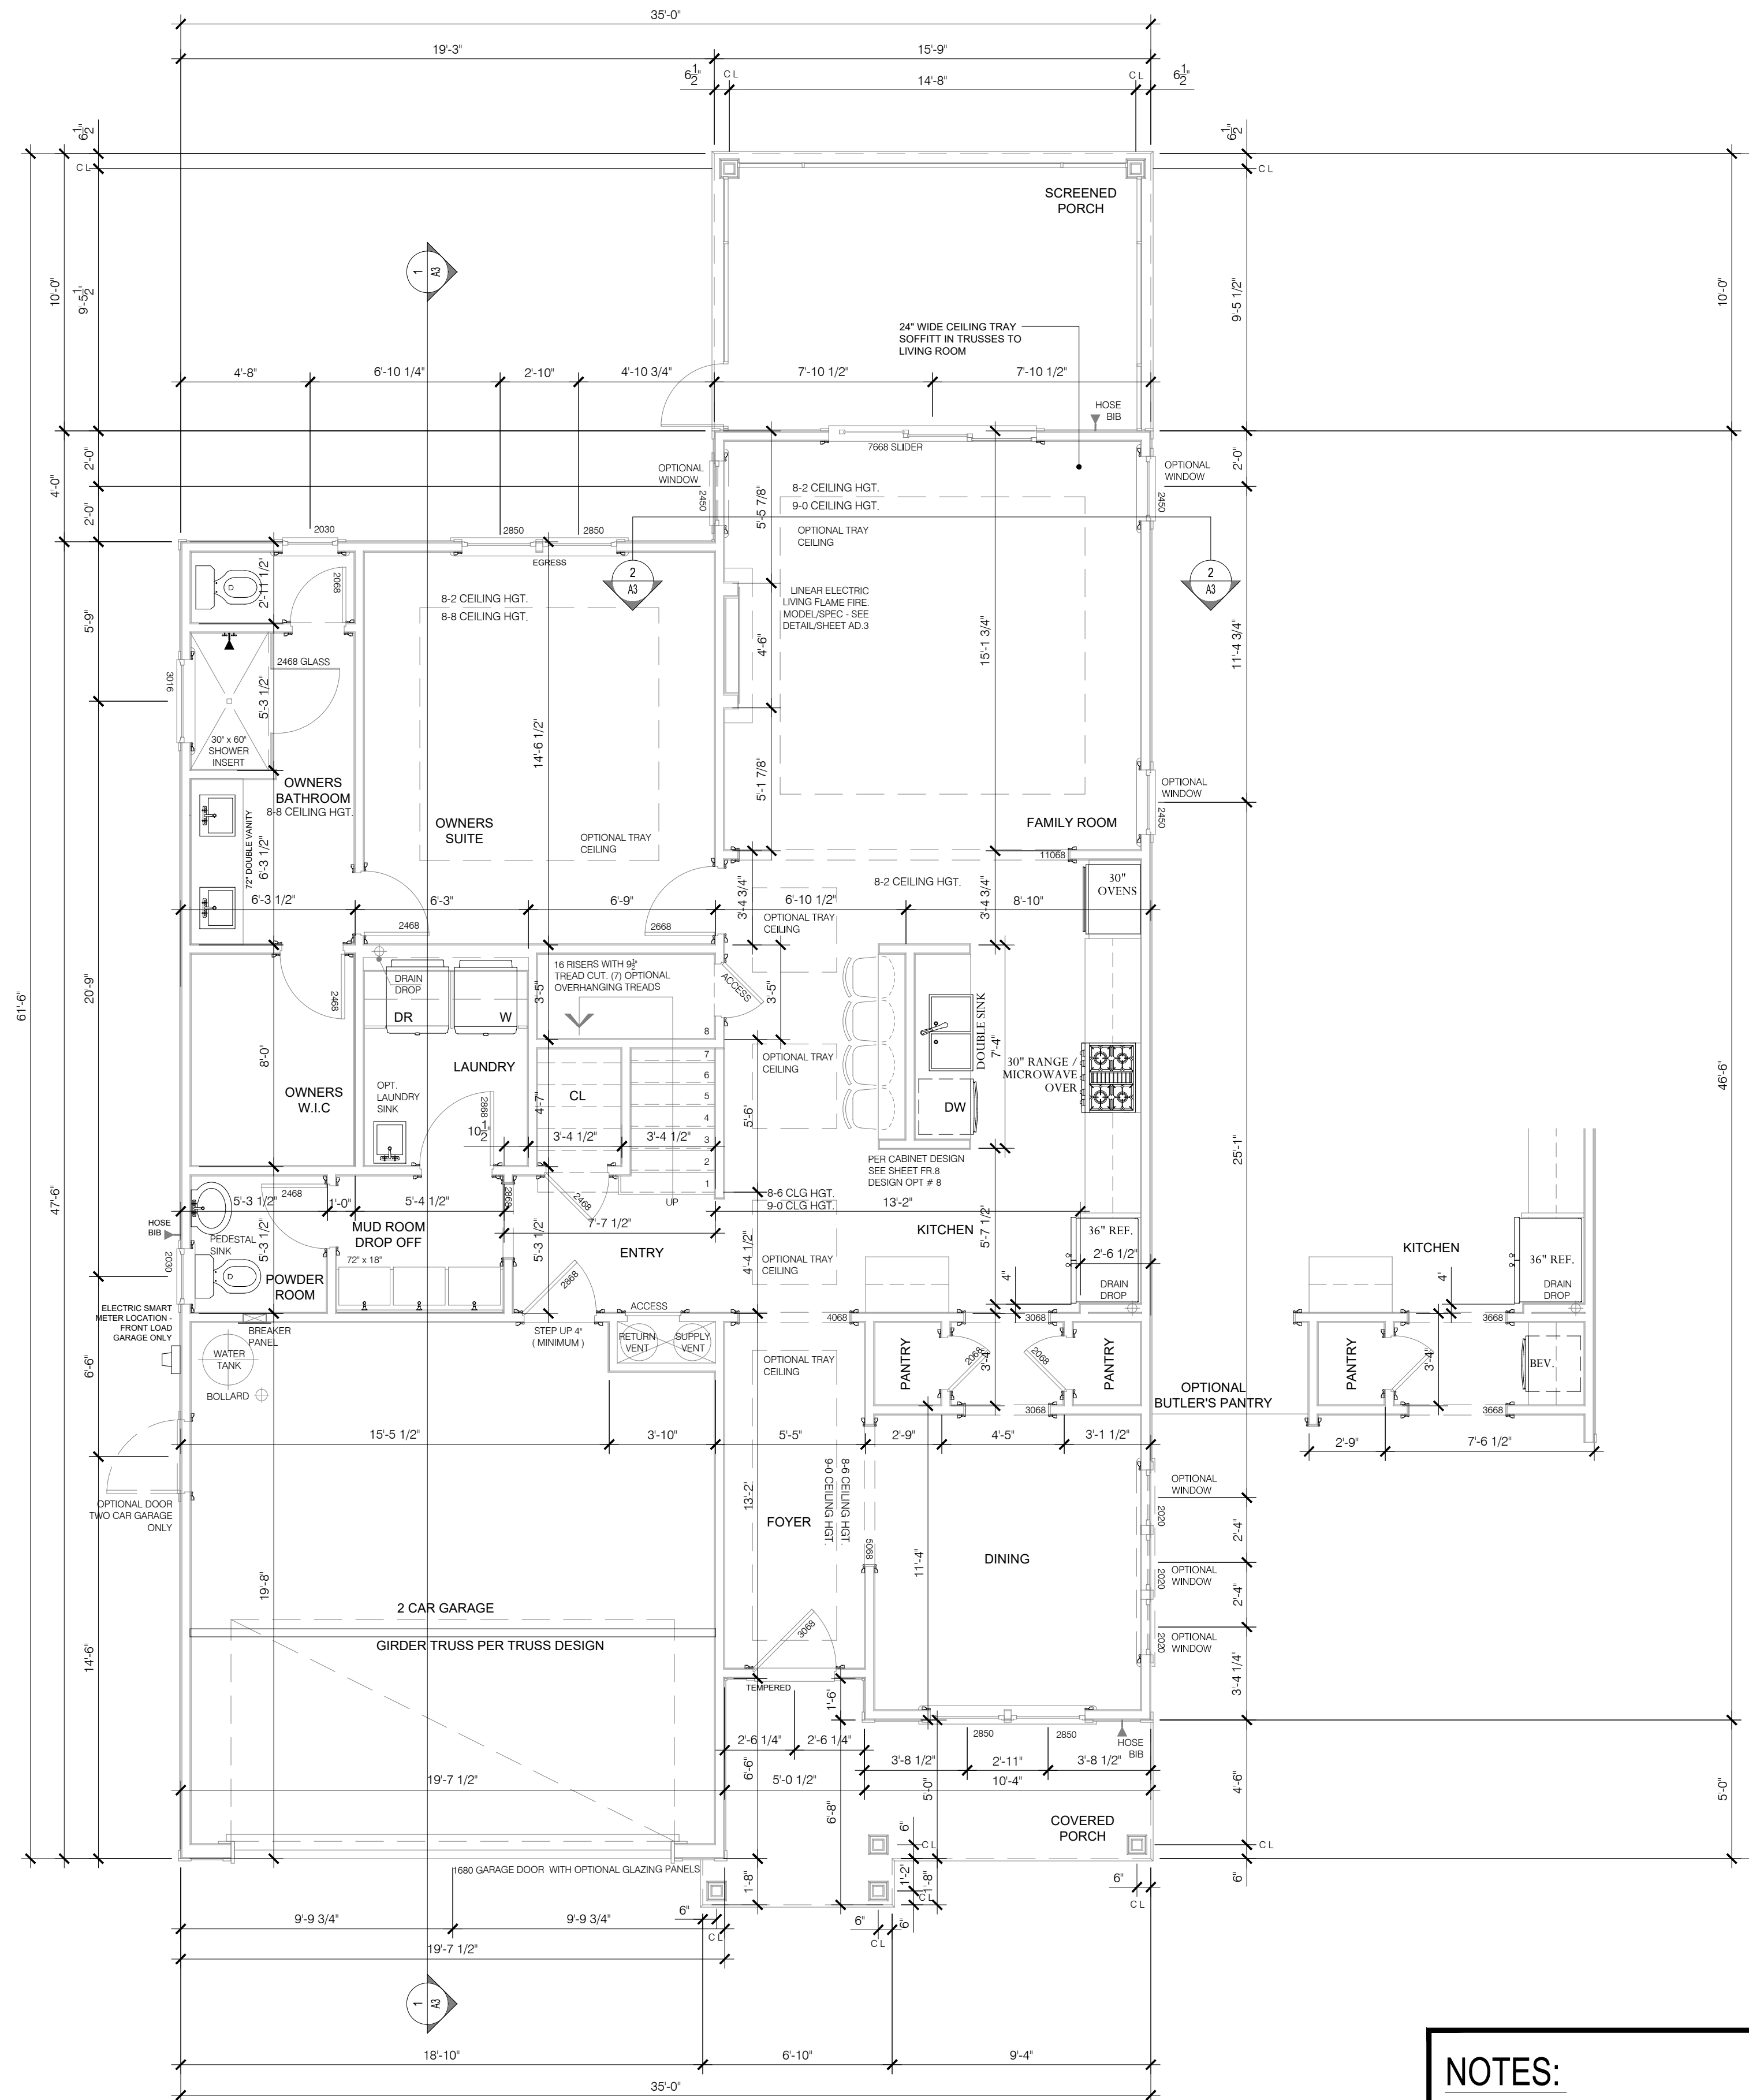**BUILDING AREAS:**

<b>HEATED AREAS:</b>	
FIRST FLOOR	± 1,273.49 SQ FT
SECOND FLOOR	± 857.25 SQ FT
<b>TOTAL HEATED</b>	<b>± 2,130.74 SQ FT</b>
<b>UNHEATED AREAS:</b>	
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<b>OPT. TOTAL AREA UNDER ROOF:</b>	<b>± 2,921.04 SQ FT</b>


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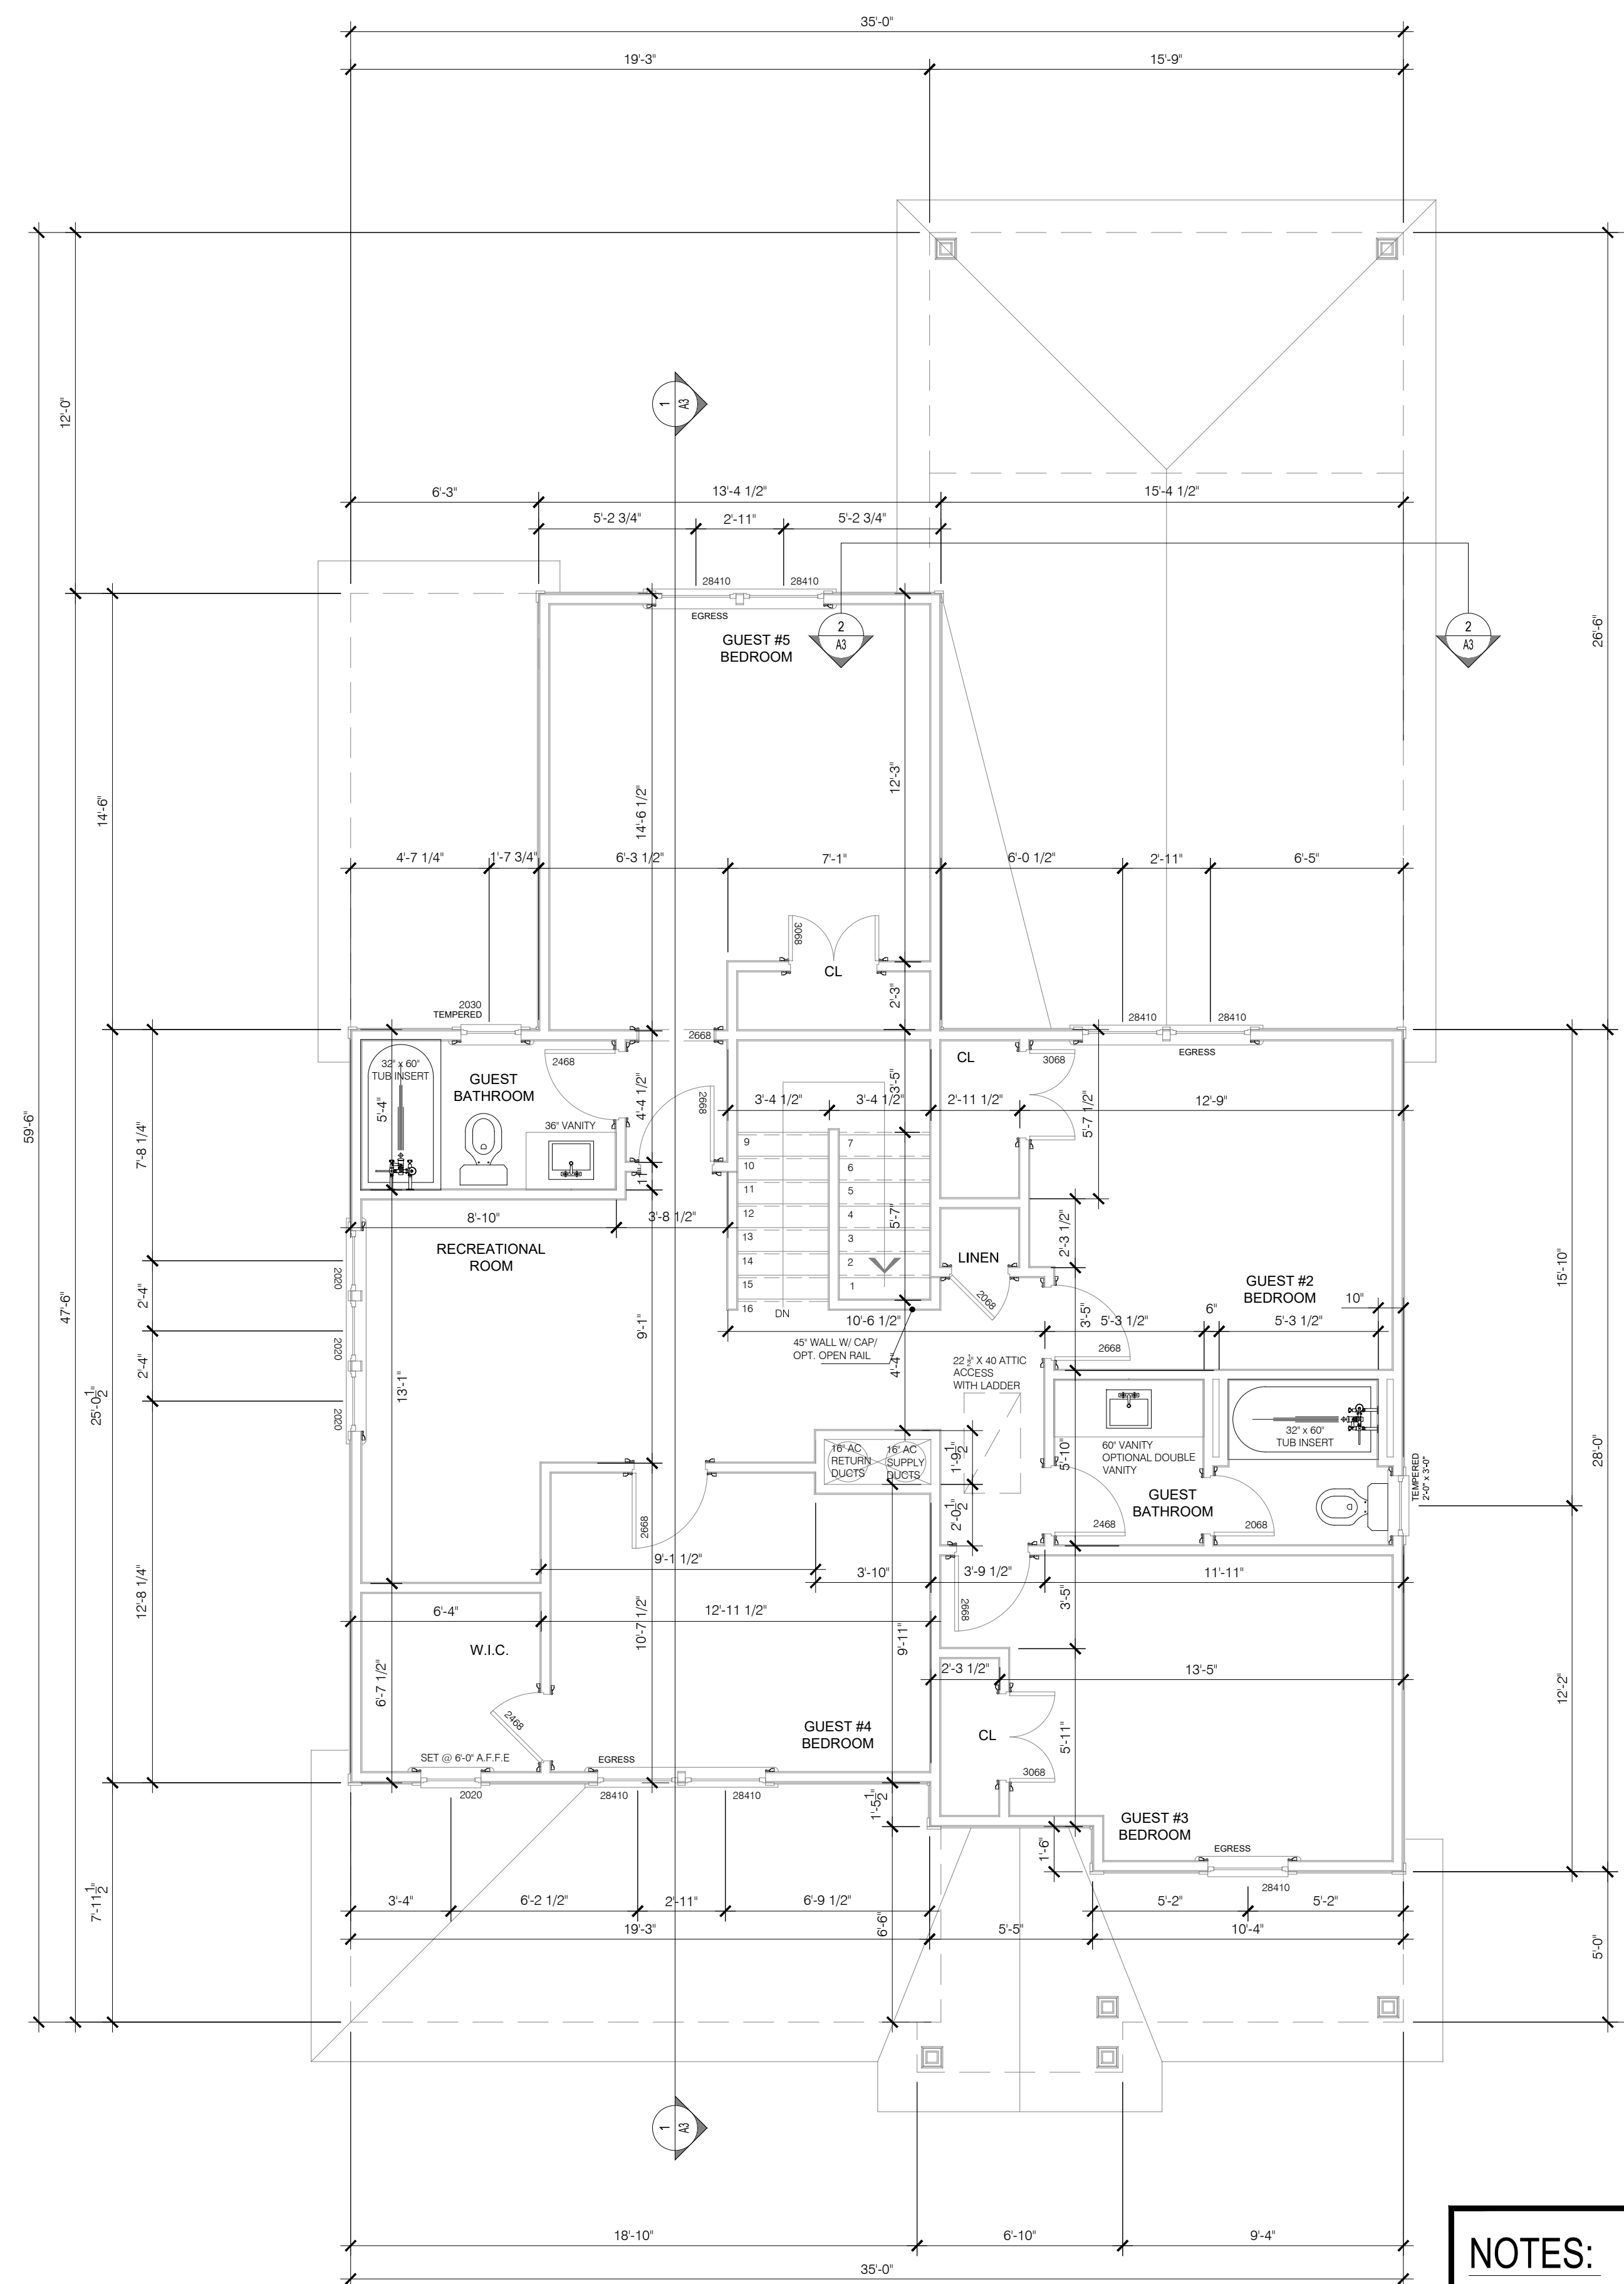
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**THE JANVILLE**  
MAIN FLOOR PLAN  
DIMENSIONED

DATE: 2024-16-08  
DRAWN BY: JST  
ENGINEER: NS  
CHECKED BY: NS  
O.C. BY: NS  
SCALE:  
SHEET NUMBER:  
**A1.2**



UPPER FLOOR LEVEL "STANDARD"

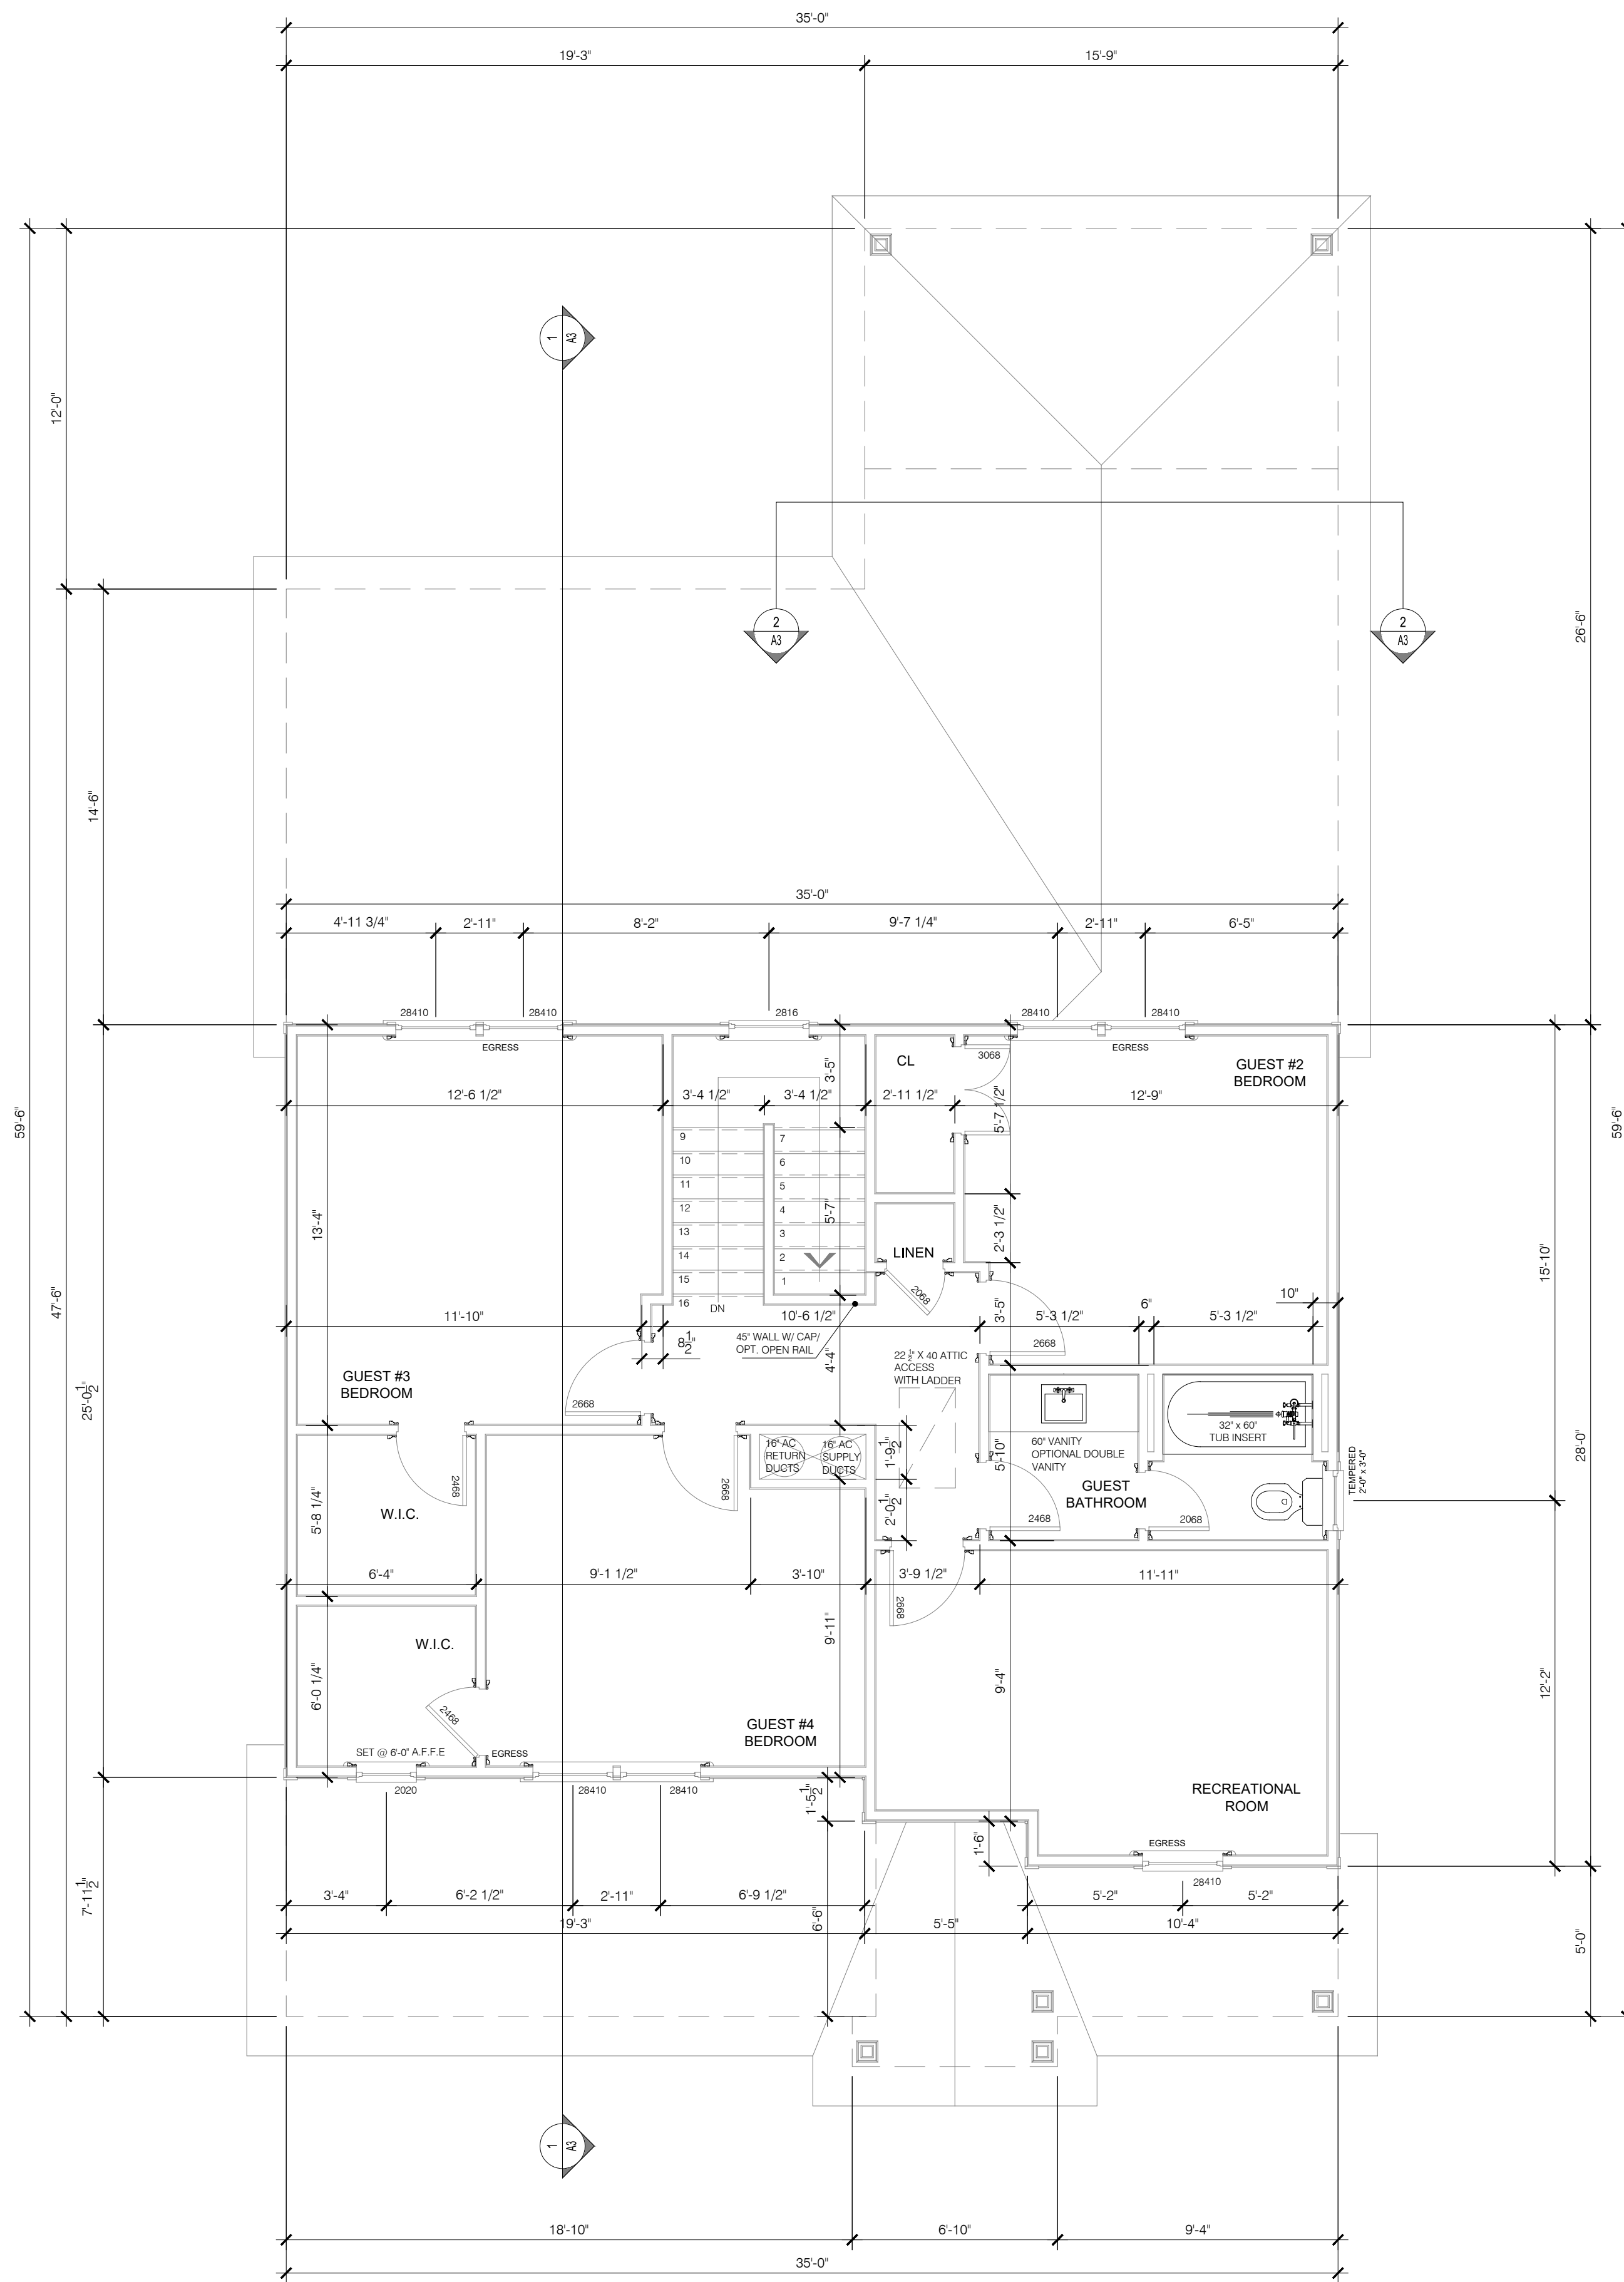

UPPER FLOOR LEVEL OPTION "B"

**NOTES:**  
ALL CASED OPENINGS SHOWN  
ARE OPTIONAL.

UPPER FLOOR PLAN - WITH OPTIONS  
SCALE: 1/4" = 1'-0"


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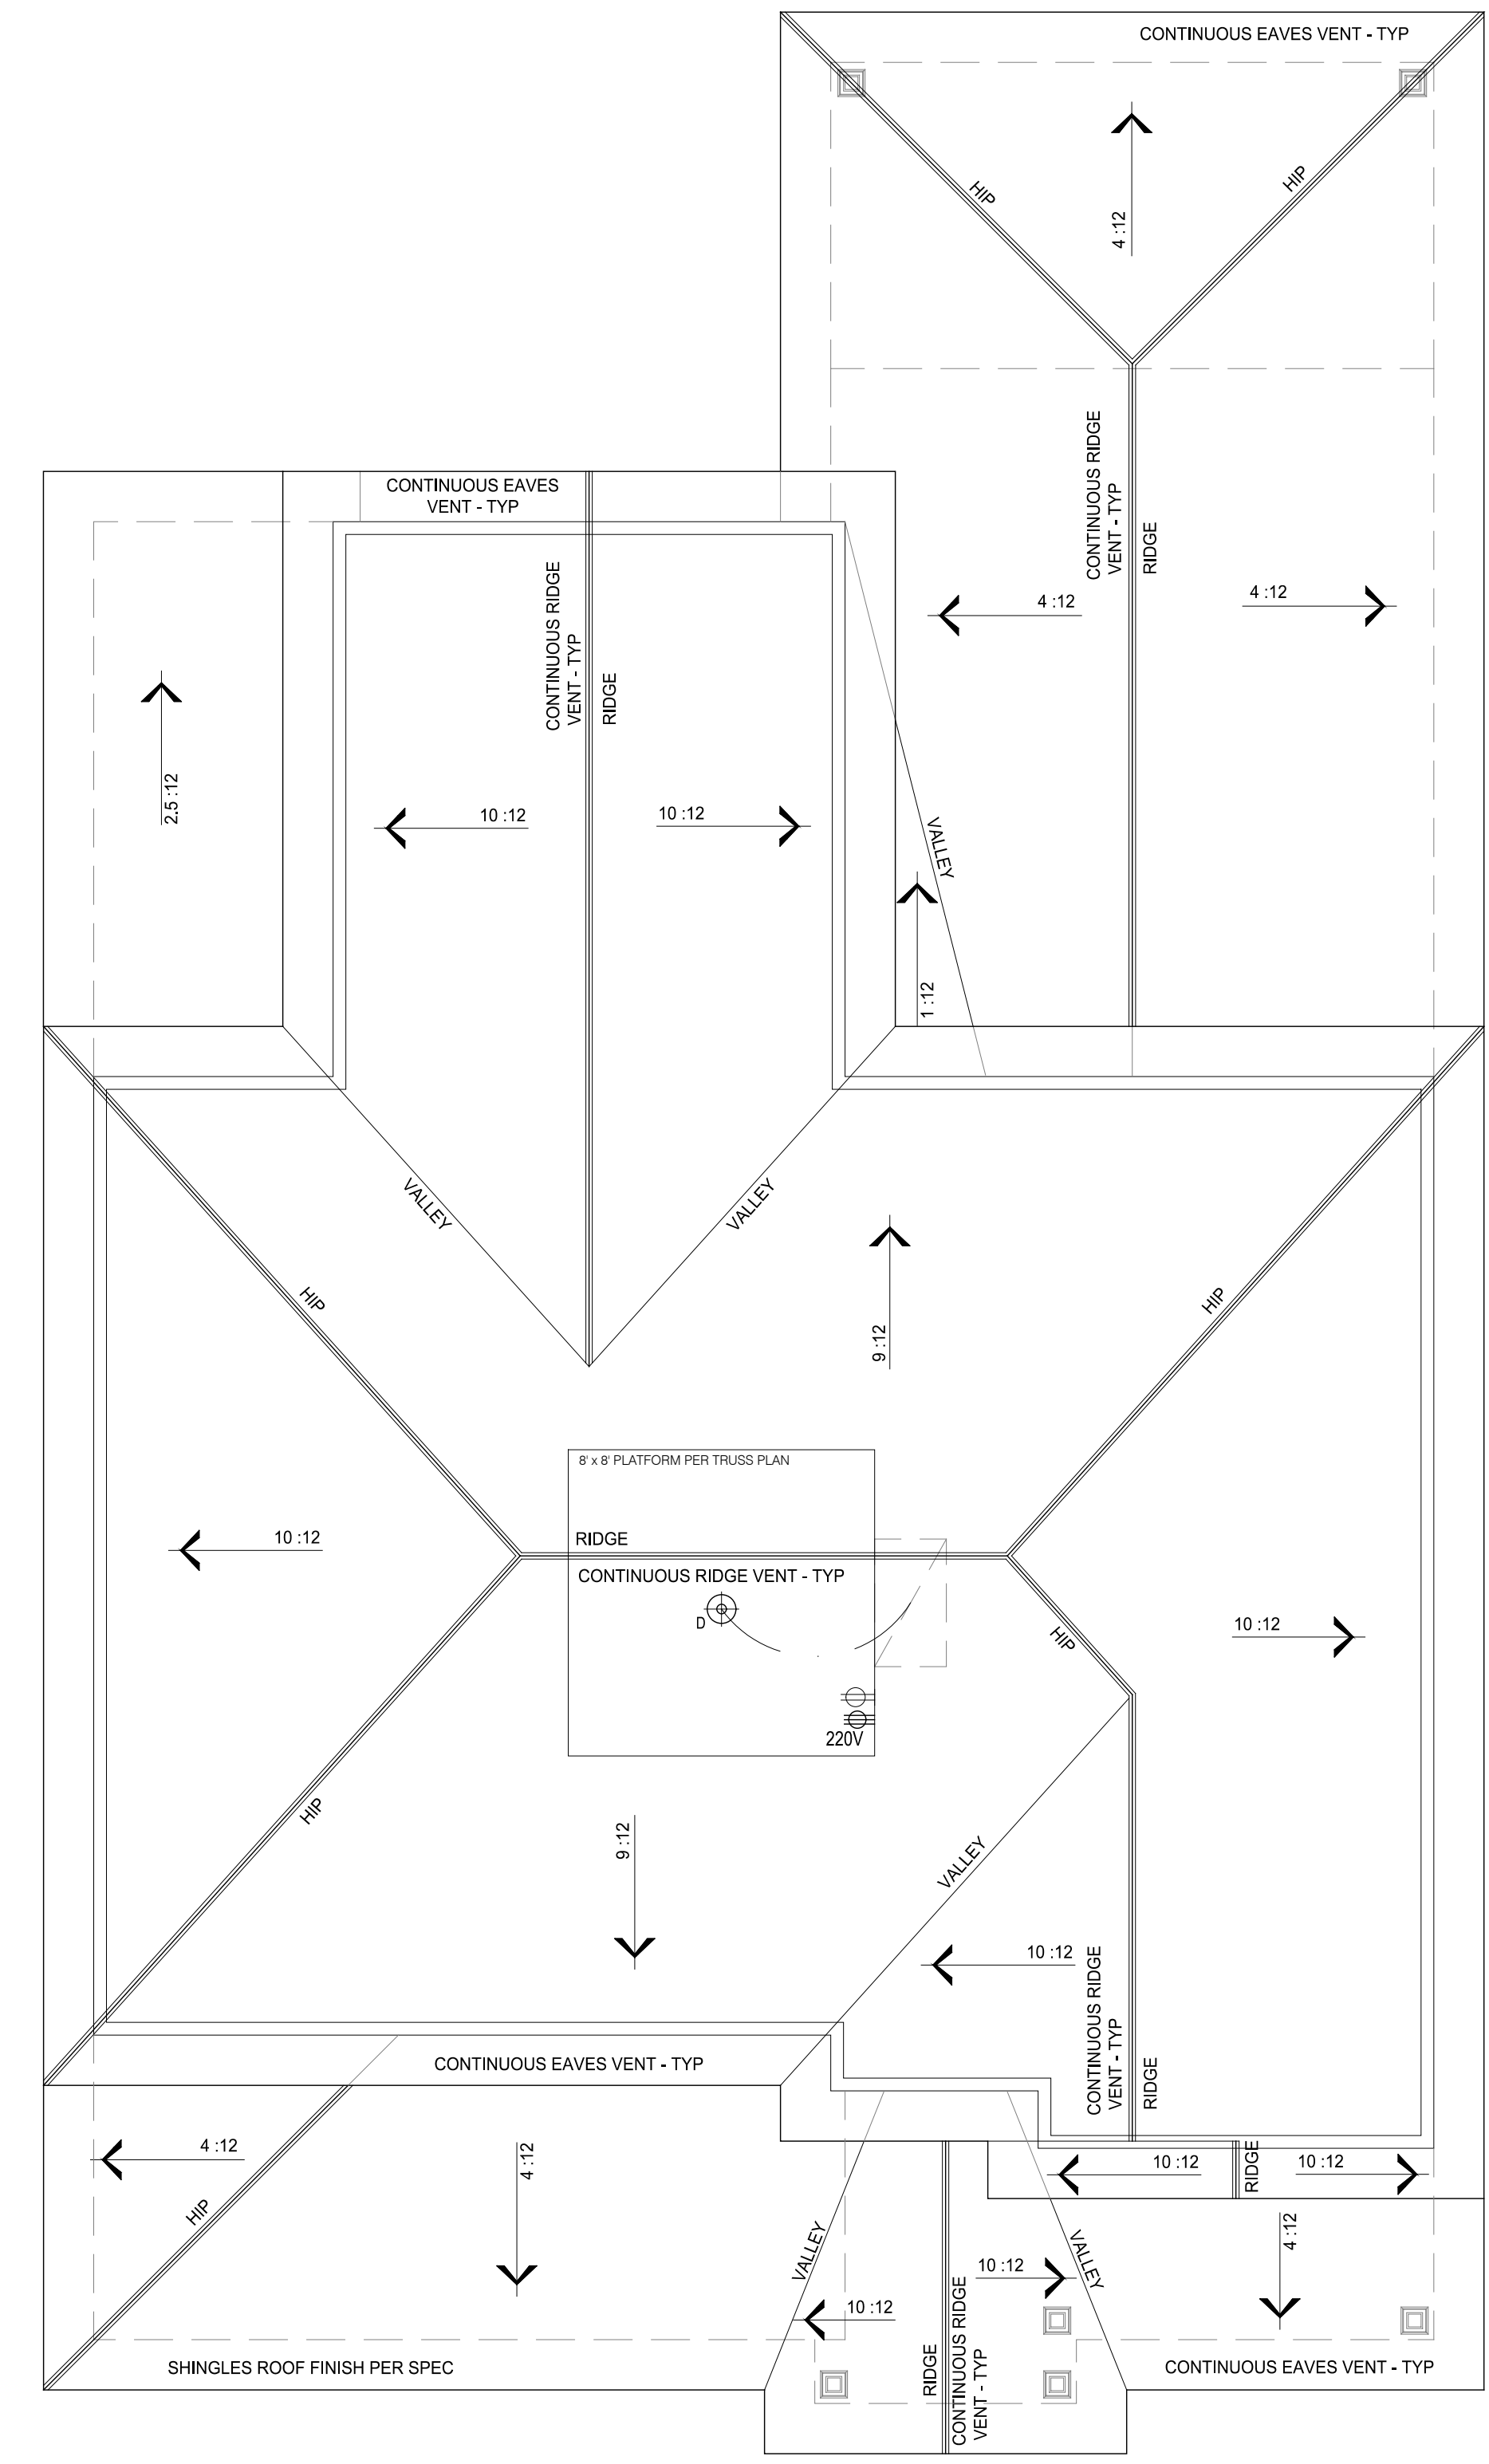
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UPPER FLOOR PLAN  
DIMENSIONED

DATE: 2024-16-08  
DRAWN BY: JST  
ENGINEER: NS  
CHECKED BY: NS  
O.C. BY: NS  
SCALE:  
SHEET NUMBER:  
**A1.3**



STANDARD

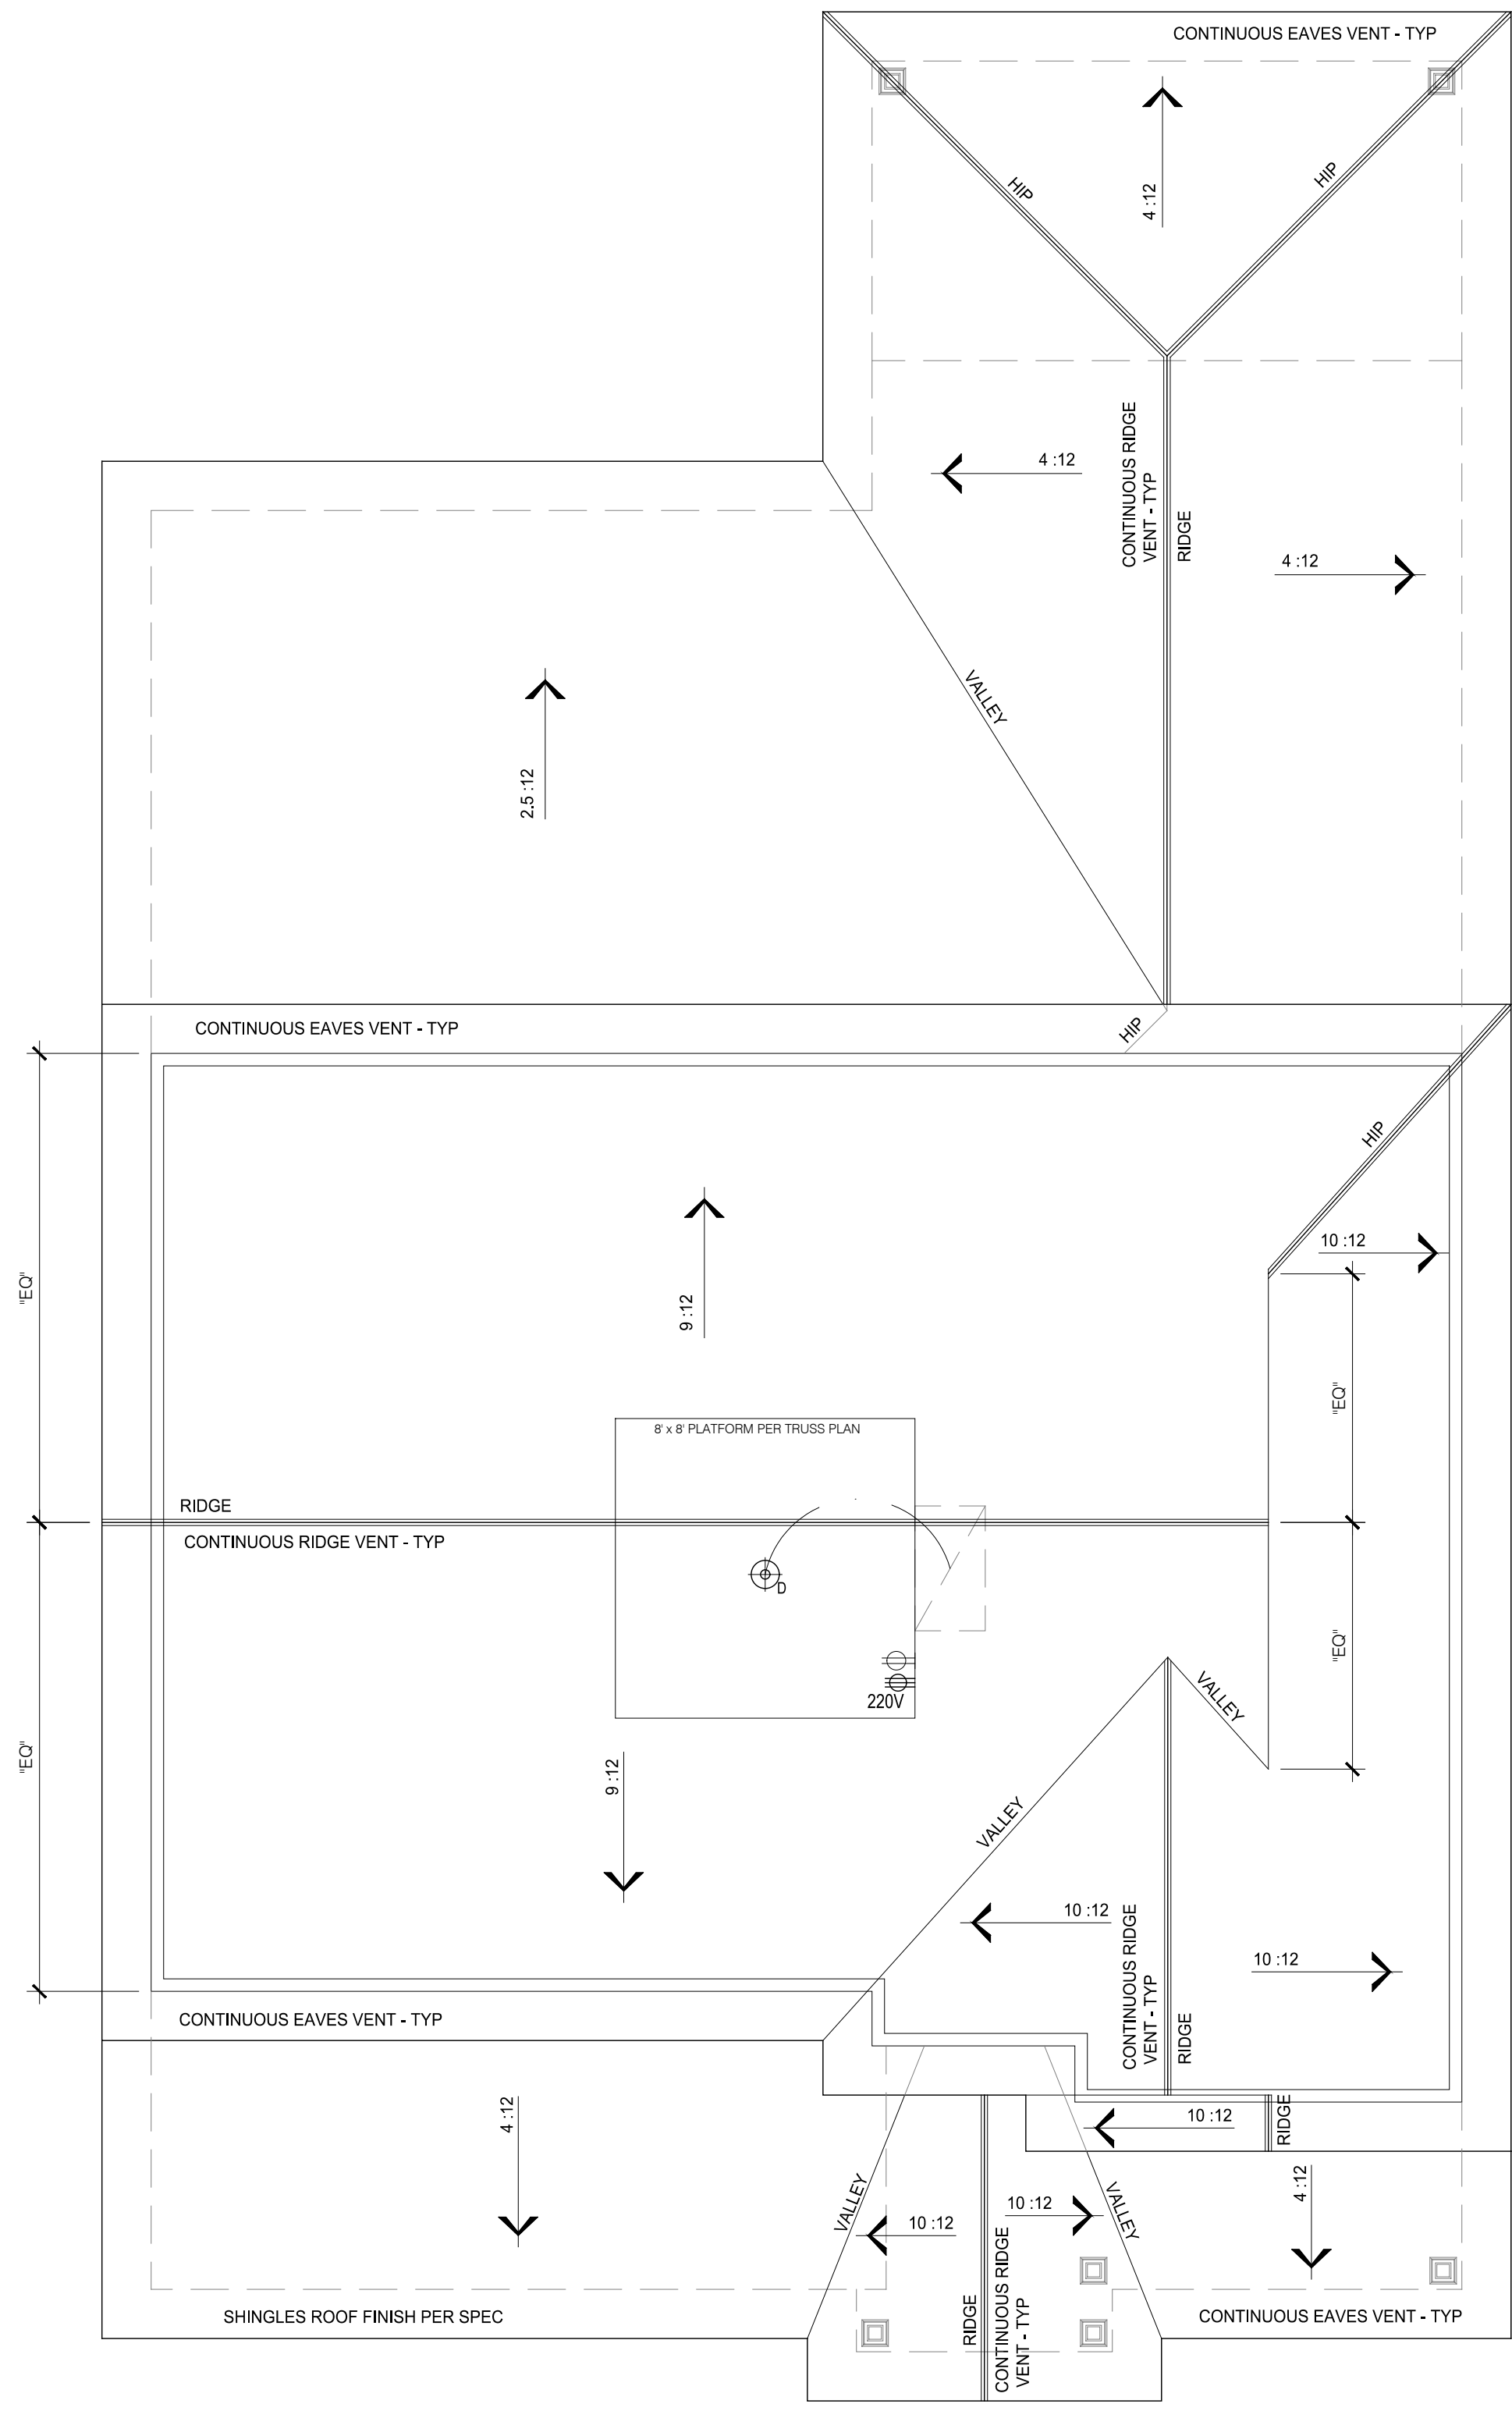

OPTION "B"

ROOF PLAN - PRE TRUSS DESIGN  
SCALE: 1/4" = 1'-0"

REVISIONS:

**J.S. THOMPSON**  
ENGINEERING, INC.  
333 E. SIX FORKS RD., SUITE 180  
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THE JANVILLE  
ROOF PLAN


DATE: 2024-16-08  
DRAWN BY: JST  
ENGINEER: JST  
CHECKED BY: NS  
Q.C. BY: NS  
SCALE:  
SHEET NUMBER:  
**A1.4**

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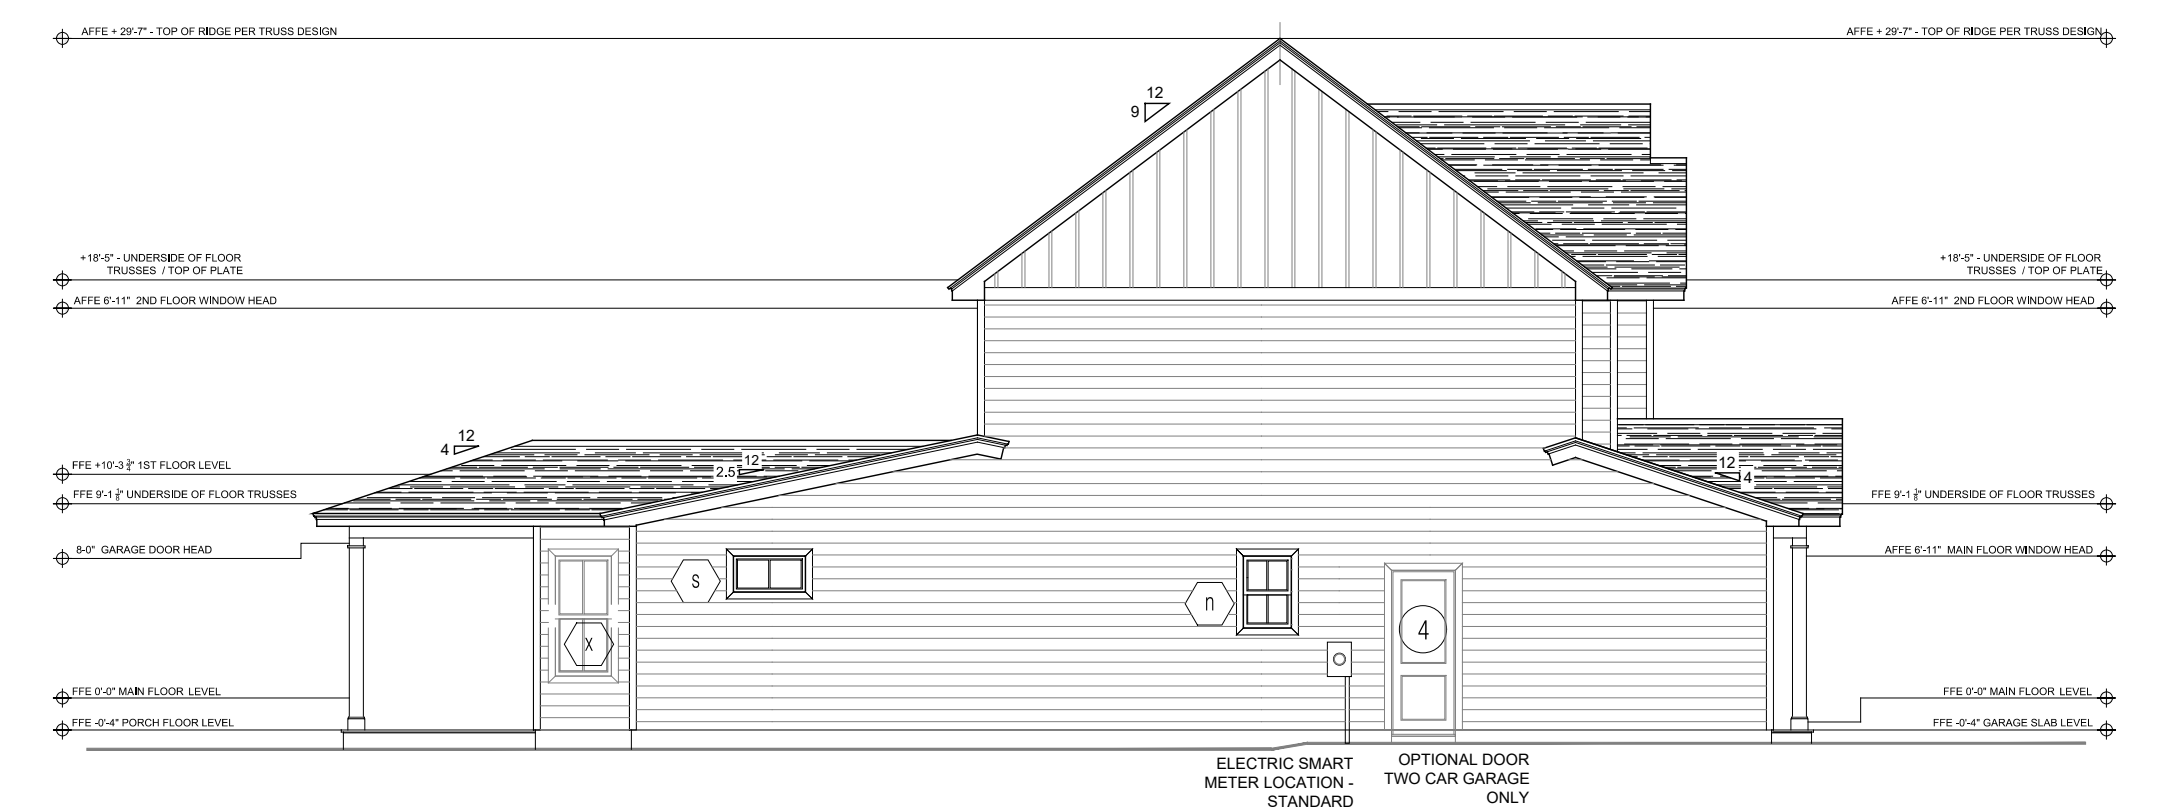
FRONT ELEVATION - STANDARD OPTION  
SCALE: 1/4" = 1'-0"



RIGHT SIDE ELEVATION - STANDARD OPTION  
SCALE: 1/8" = 1'-0"

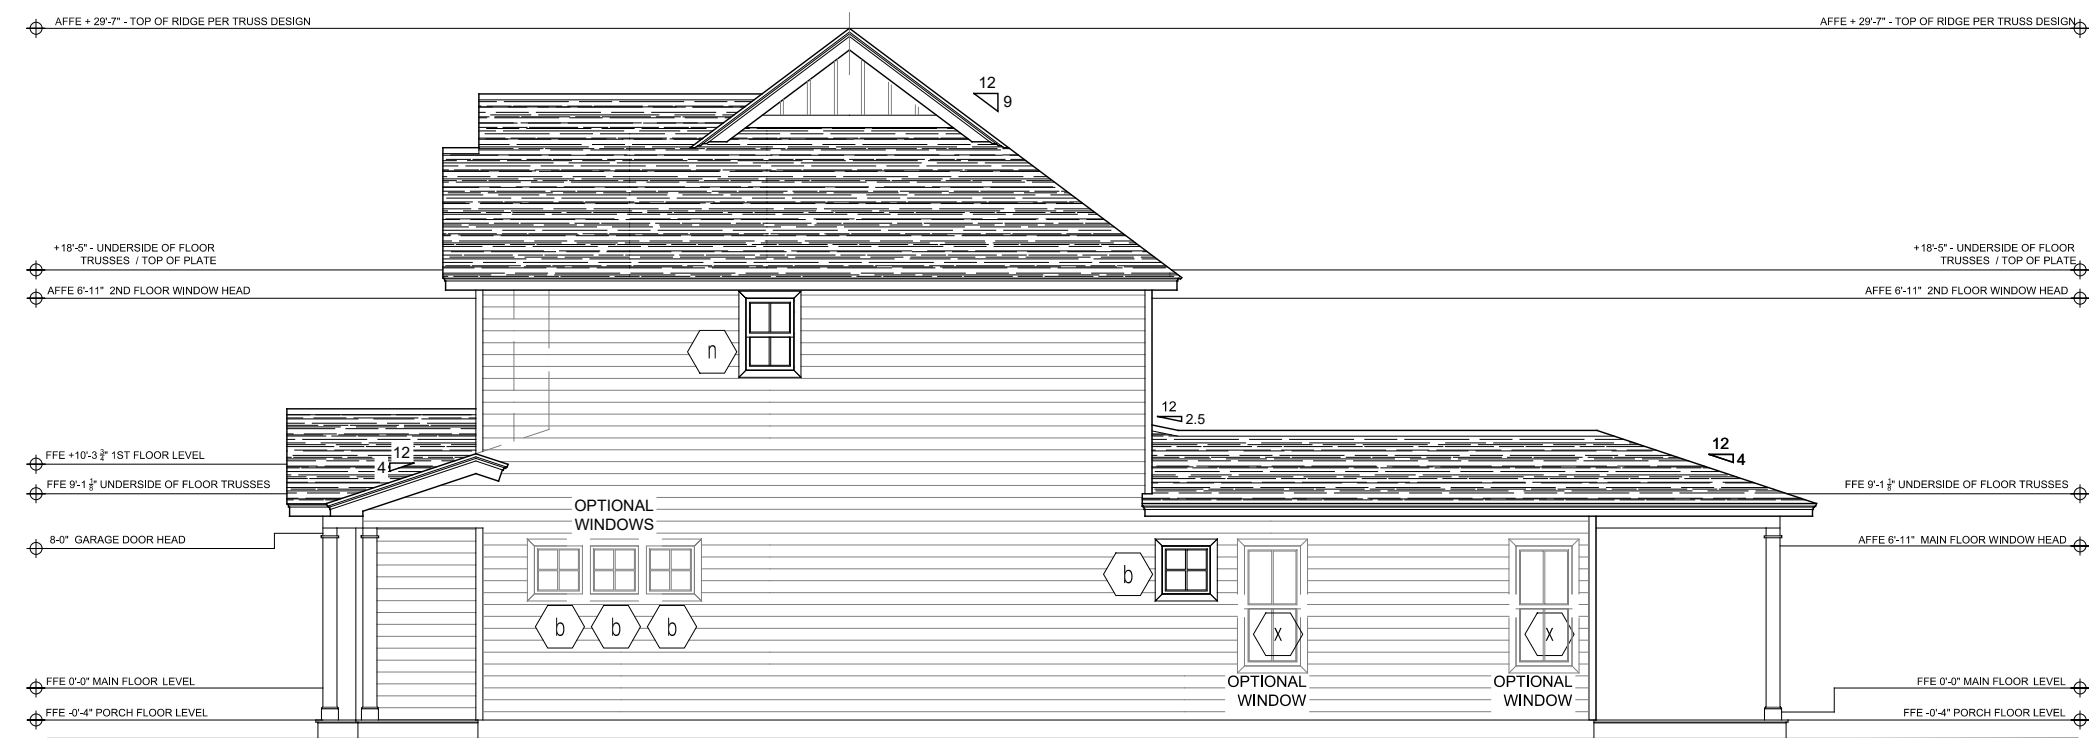

REAR ELEVATION - STANDARD OPTION  
SCALE: 1/8" = 1'-0"



LEFT SIDE ELEVATION - STANDARD OPTION  
SCALE: 1/8" = 1'-0"

REVISIONS:

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ENGINEERING, INC.  
333 E. SIX FORKS RD., SUITE 180  
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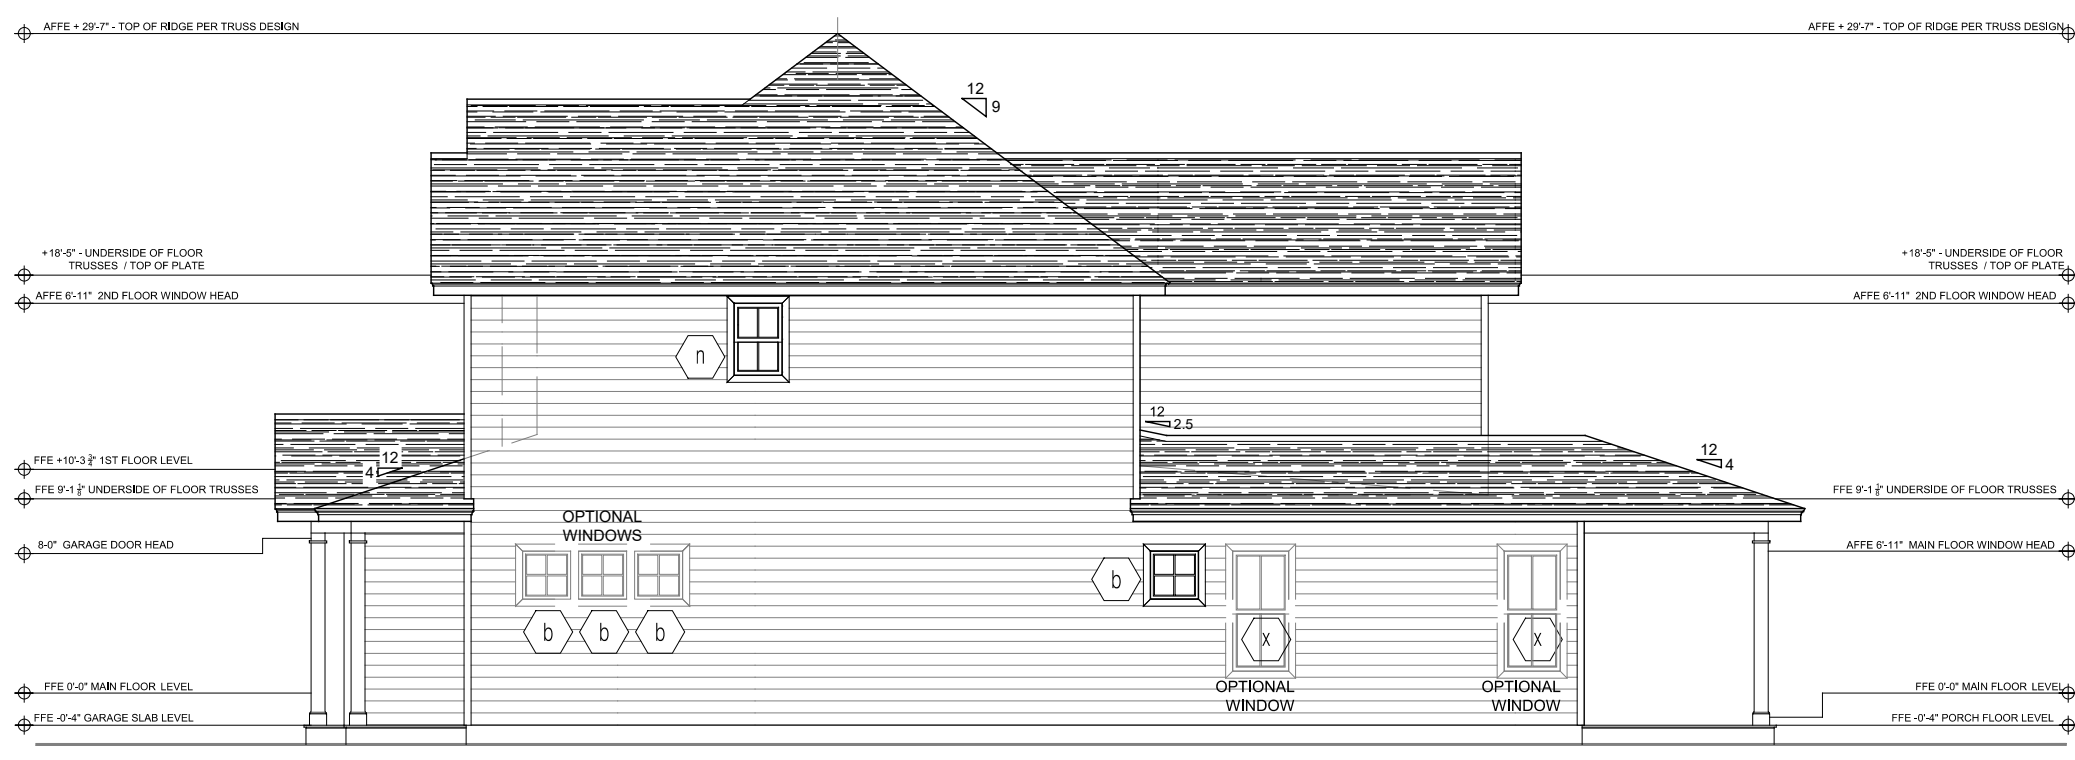
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THE JANVILLE  
ALL EXTERNAL ELEVATIONS

DATE: 2024-16-08  
DRAWN BY: JST  
ENGINEER: JST  
CHECKED BY: NS  
Q.C. BY: NS  
SCALE:  
SHEET NUMBER: #  
**A2**



FRONT ELEVATION - OPTION "B"  
SCALE: 1/4" = 1'-0"



RIGHT SIDE ELEVATION - OPTION "B"  
SCALE: 1/8" = 1'-0"



REAR ELEVATION - OPTION "B"  
SCALE: 1/8" = 1'-0"



LEFT SIDE ELEVATION - OPTION "B"  
SCALE: 1/8" = 1'-0"

REVISIONS:


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THE JANVILLE  
ALL EXTERNAL ELEVATIONS  
OPTION "B"

DATE: 2024-16-08  
DRAWN BY: JST  
ENGINEER: NS  
CHECKED BY: NS  
Q.C. BY: NS  
SCALE:  
SHEET NUMBER:  
**A2.1**






DETAIL A  
SCALE: 3/4" = 1'-0"

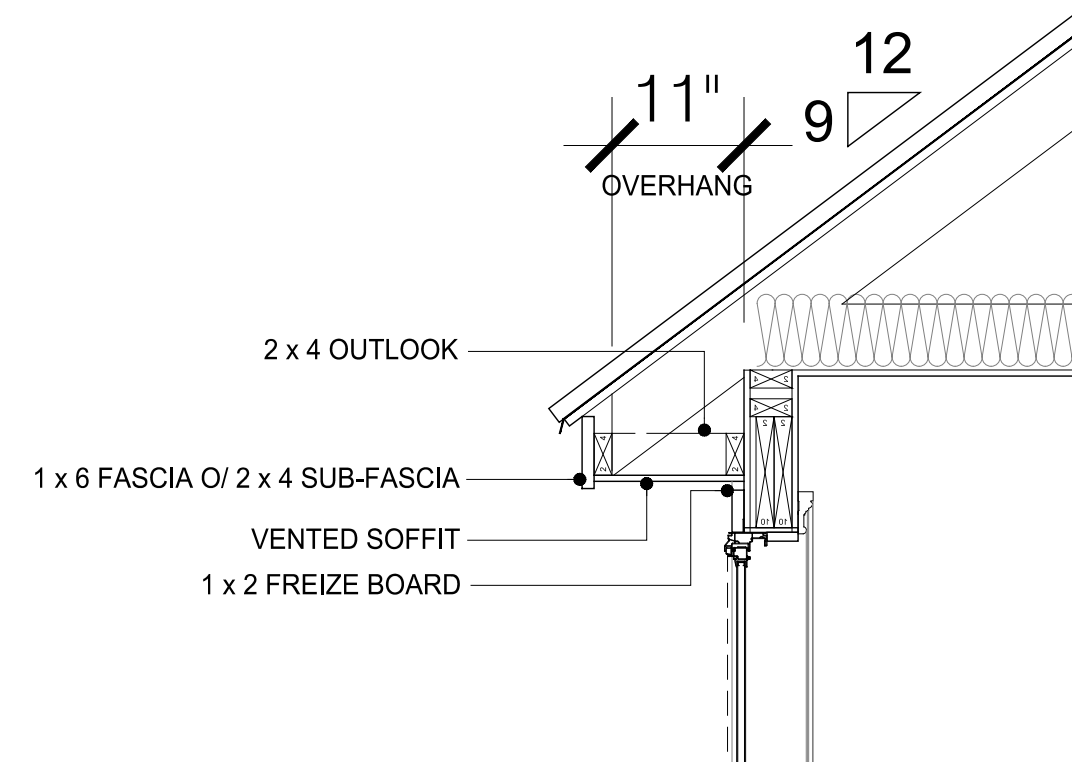

BUILDING SECTION (SEE STANDARD FLOOR PLAN) - 2  
SCALE: 1/4" = 1'-0"

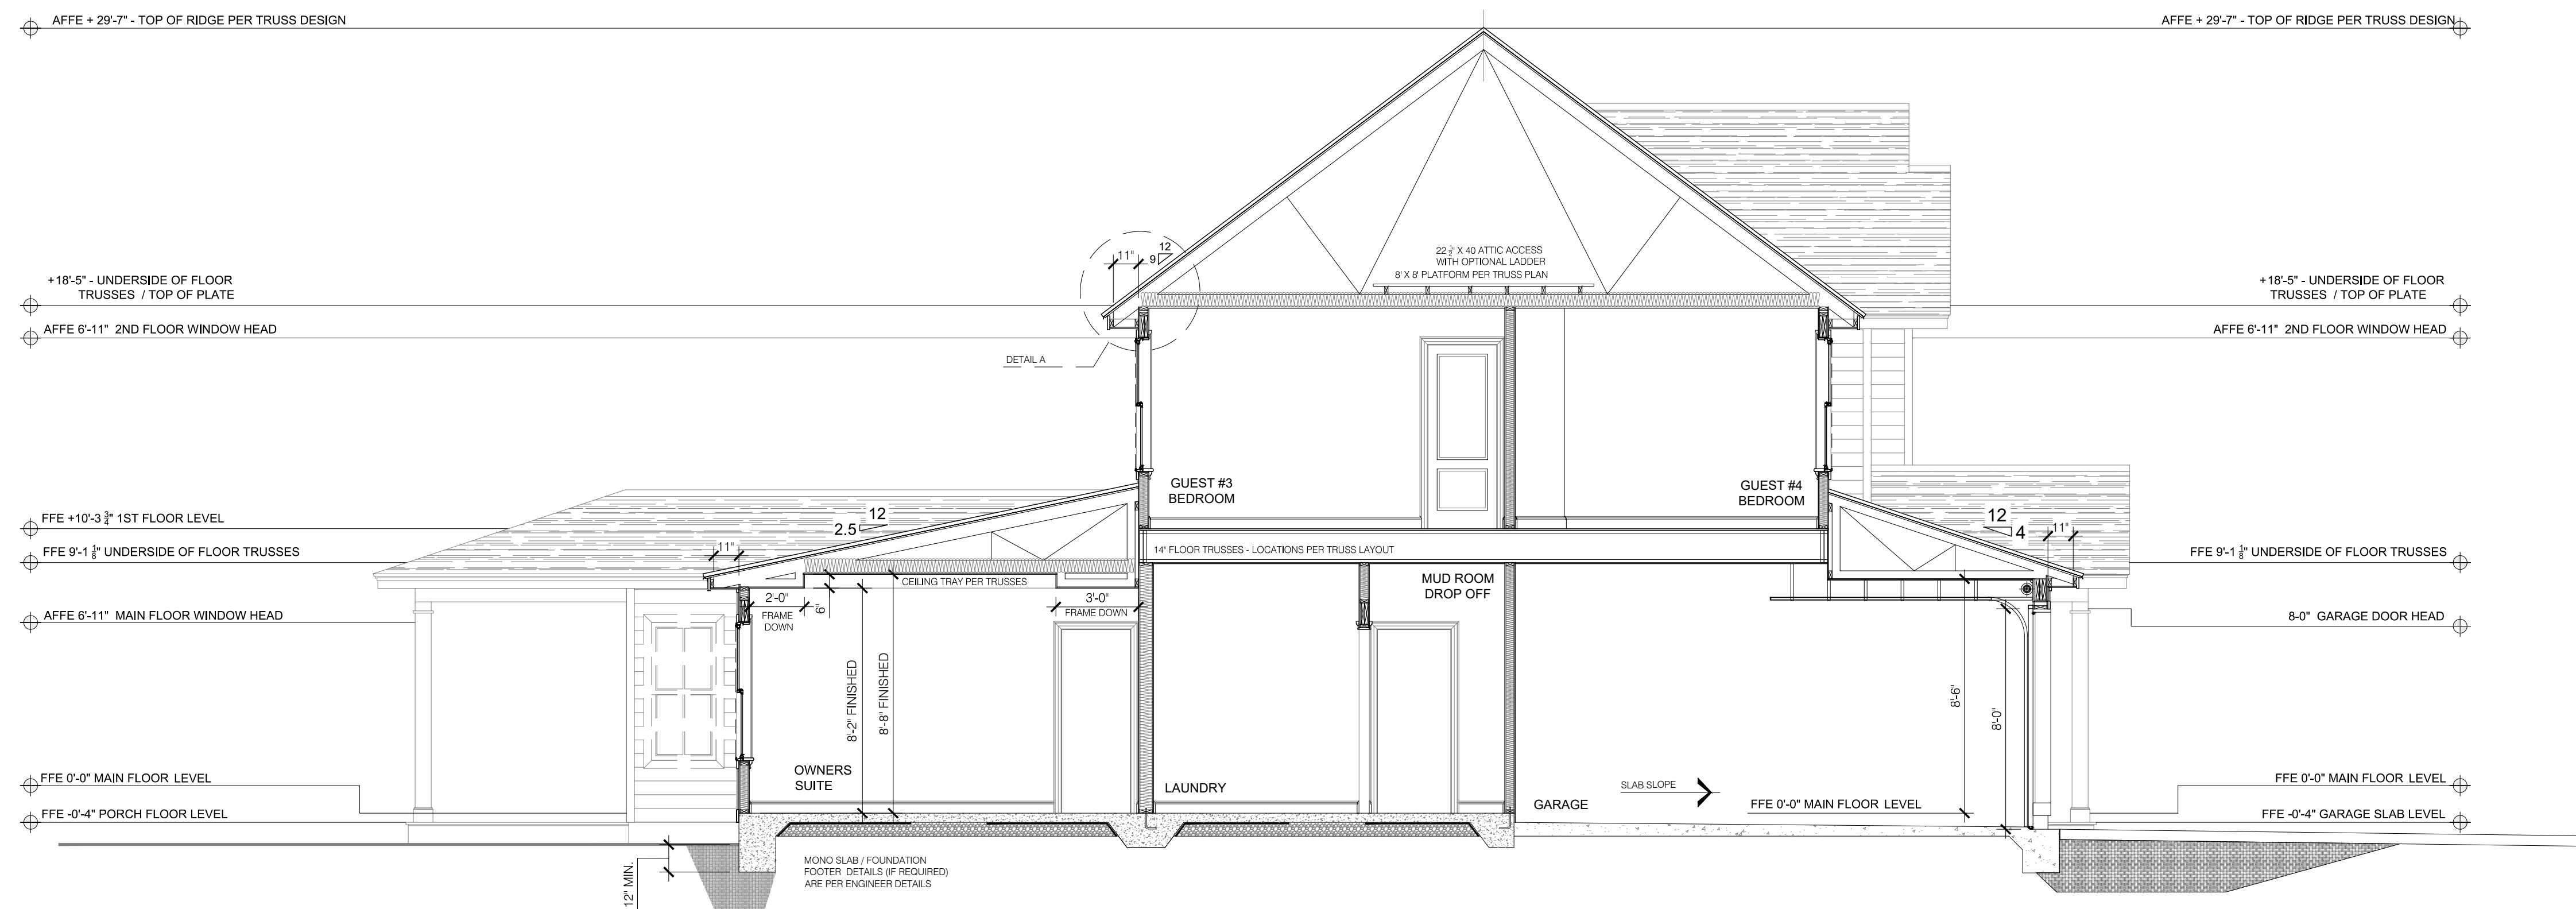

BUILDING SECTION (SEE STANDARD FLOOR PLAN) - 1  
SCALE: 1/4" = 1'-0"

REVISIONS:

**J.S. THOMPSON**  
ENGINEERING, INC.  
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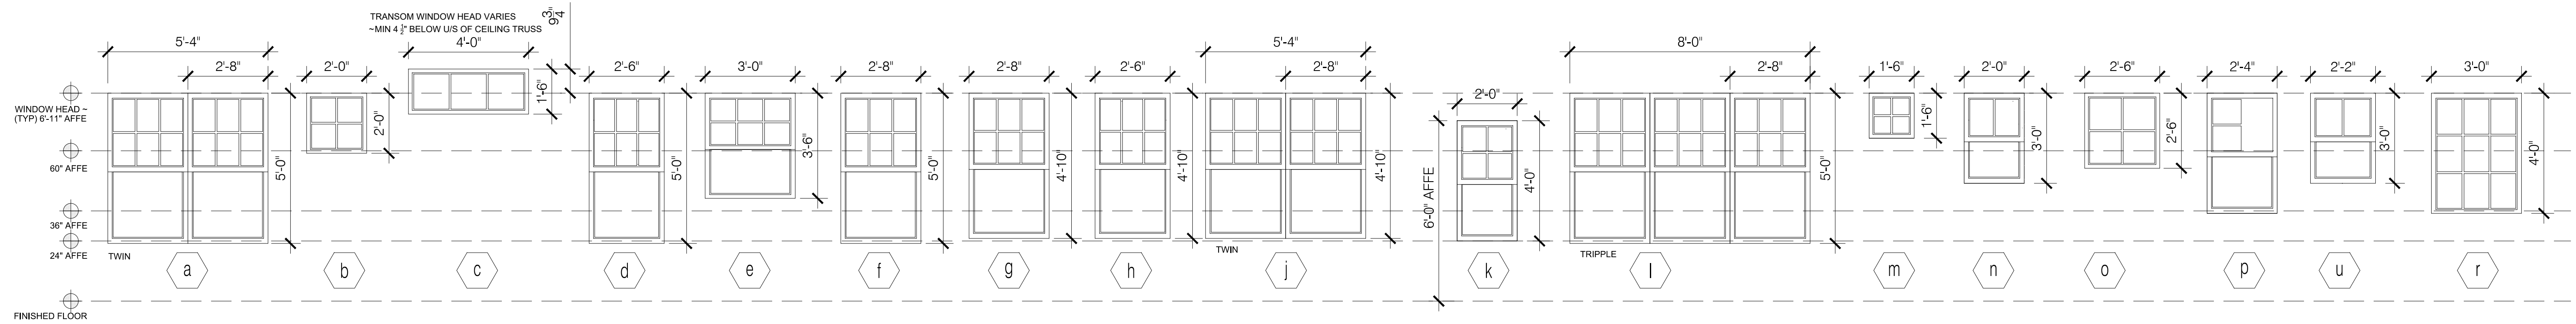
THE JANVILLE

CONSTRUCTION  
SECTIONS & DETAILS

DATE: 2024-16-08  
DRAWN BY: JST  
ENGINEER: NS  
CHECKED BY: NS  
Q.C. BY: NS  
SCALE:  
SHEET NUMBER#:

A3

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WINDOW & DOOR GLAZING PATTERNS  
SCALE: 3/8" = 1'-0"

- NOTES:**
- ALL WINDOWS SHALL BE IN DOUBLE GLAZED INSULATED LOW 'E' GLAZING
  - ALL HARDWARE TO BE PER CLIENT/ASCOT SELECTIONS
  - DETAIL SHOP DRAWINGS FOR ALL WINDOW TYPES SHALL BE APPROVED
  - ALL PROFILES TO BE APPROVED BY ASCOT
  - WINDOW DIMENSIONS AND GLAZING PATTERN ARE PER NOMINATED VINYL SIZE DOCUMENTATION COLORED VINYL SINGLE HUNG TILT & SLIDE & FIXED WINDOWS
  - WINDOWS NOTED AS EGRESS SHALL COMPLY WITH THE RELEVANT BUILDING CODE REFERENCE. ALL WINDOWS SILLS LOWER THAN 24" ABOVE FINISHED FLOOR ELEVATIONS SHALL BE PROVIDED WITH FALL PREVENTATIVE DEVICES OR RESTRICTED TO ONLY ALLOW A 4" DIAMETER SPHERE TO PASS. NO WINDOW SILL SHALL BE HIGHER THAN 72" ABOVE ADJACENT GRADE.
  - EGRESS WINDOWS SHALL HAVE A NET OPENING AREA OF NOT LESS THAN 5.0 SQFT (20 X 24) - (NORTH CAROLINA) FOR GRADE FLOOR EGRESS OR 5.7 SQFT TO UPPER EGRESS FLOORS. NO WINDOW SILL SHALL BE HIGHER THAN 44" ABOVE FINISHED FLOOR ELEVATION OR BELOW A MIN OF 24 ABOVE THE FINISHED FLOOR.
  - CONTRACTOR/ASCOT SUPERINTENDENT SHALL VERIFY ALL MASONRY & FRAME OPENINGS BUILT ON SITE PRIOR TO WINDOW INSTALLATION.
  - TEMPERED GLAZING SHALL BE PROVIDED AND INSTALLED WITH CRITICAL HAZARDOUS LOCATIONS PER LOCAL AND STATE CODES, AND AS NOTED ON PLANS AND ELEVATIONS HEREIN, UNLESS OTHERWISE AGREED WITH CODE OFFICIALS.

GENERAL NOTES  
SCALE: NTS


**NOTES:**  
GLAZING IN WET AREAS WHEN A BATH TUB OR SHOWER IS INSTALLED SHALL BE TEMPERED GLASS WHEN THE BOTTOM EXPOSED EDGE OF THE GLAZING IS LESS THAN 60" MEASURED VERTICALLY ABOVE THE FINISHED FLOOR ELEVATION - PER CODE: R308.4.5.

WHERE THE BOTTOM EXPOSED EDGE OF THE GLAZING IS BELOW 24" MEASURED VERTICALLY ABOVE THE FINISHED FLOOR ELEVATION TEMPERED GLASS SHALL COMPLY WITH EITHER ~ PREVENTATIVE FALL DEVICES SHALL BE INSTALLED OR THE WINDOW OPENING SHALL BE RESTRICTED TO A 4" OPENING DIMENSION NOT ALLOWING A 4" SPHERE TO PASS, PER CODE: R312.2.1.

GLAZING WHERE THE BOTTOM EXPOSED EDGE OF THE GLAZING IS LESS THAN 36" ABOVE THE PLANE OF AN ADJACENT WALKING SURFACE OF STAIRWAYS, LANDING, BETWEEN FLIGHTS AND RAMPS SHALL BE CONSIDERED A HAZARDOUS LOCATION, PER CODE: R308.4.6

WHERE GLAZING IS WITHIN 24" OF EITHER SIDE OF A DOOR IN A CLOSED POSITION SHALL BE CONSIDERED A HAZARDOUS LOCATION, PER CODE: R308.4.2

GLAZING ADJACENT TO A LANDING AT THE BOTTOM OF A STAIRWAY WHERE GLAZING IS LESS THAN 36" ABOVE THE LANDING AND WITHIN 60" HORIZONTAL ARC LESS THAN 180 DEGREES FROM THE BOTTOM STAIR NOSING IS CONSIDERED A HAZARDOUS LOCATION, PER CODE: 308.4.7

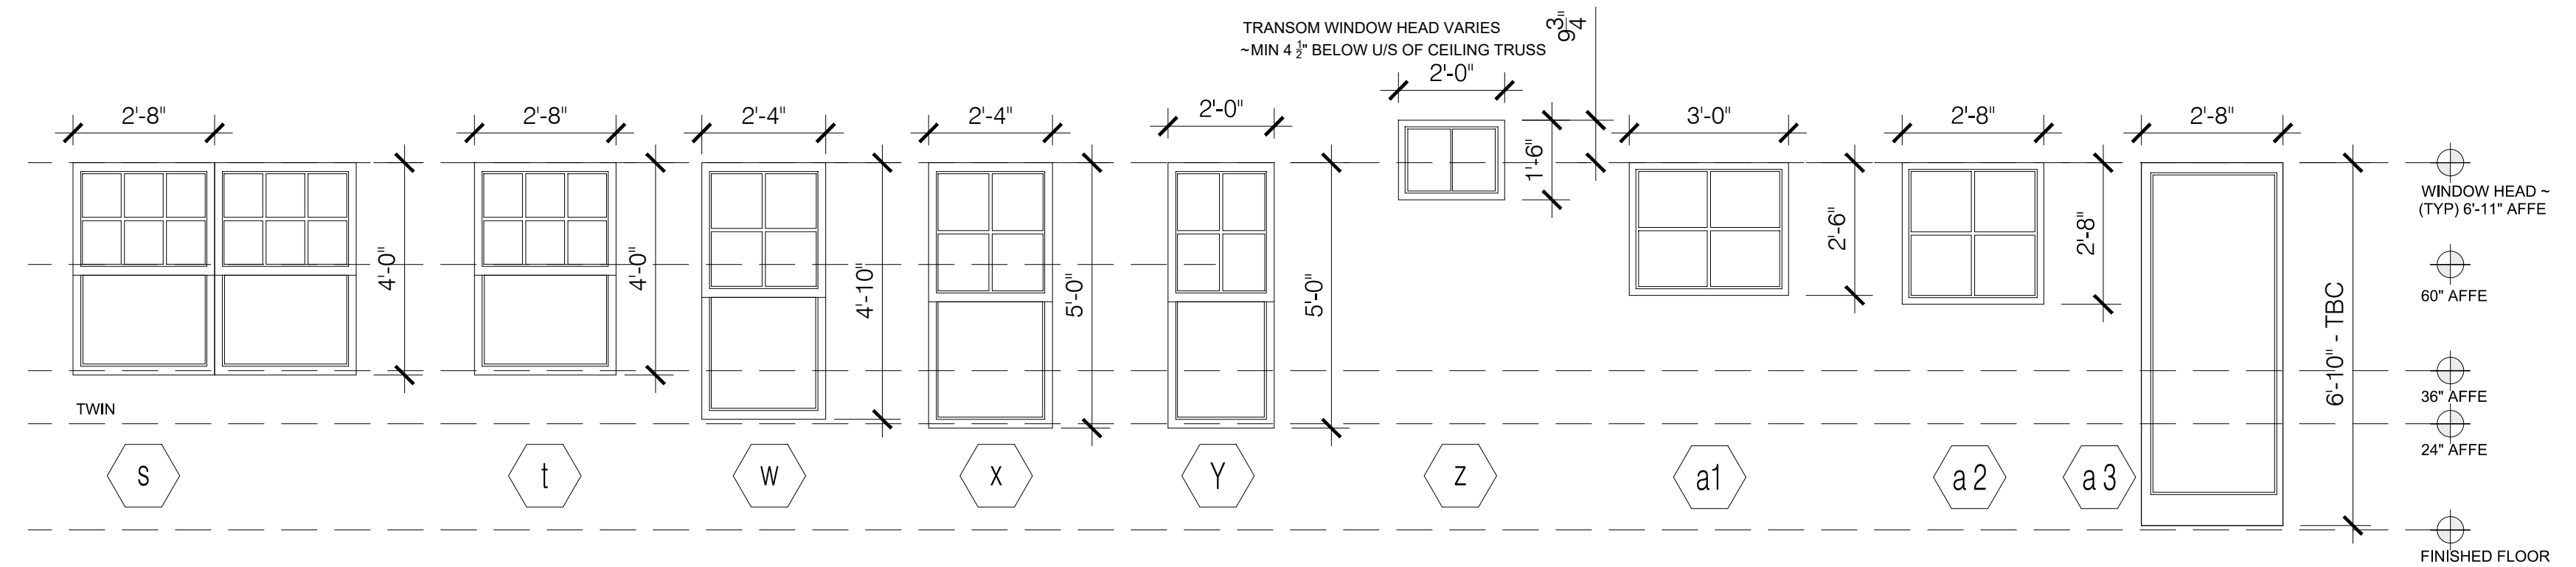

WINDOW & DOOR GLAZING PATTERNS  
SCALE: 3/8" = 1'-0"

EXTERNAL DOOR SCHEDULE		
MARK	SIZE (WxH)	LOCATION
1	3'-0" X 6'-8"	FRONT ENTRANCE - TEMPERED GLASS
2	16'-0" X 8'-0"	GARAGE DOOR WITH OPTIONAL GLAZING PANELS
3	7'-6" X 6'-8"	FAMILY ROOM - TEMPERED GLASS
4	*2'-8" X 6'-8"	*OPTIONAL GARAGE SERVICE ENTRY DOOR

INTERNAL DOOR SCHEDULE			
SIZE	QUANTITY	DOOR TYPE	NOTES
2'-0" X 6'-8"	3	SINGLE	PANTRY / 2ND FLOOR LINEN CLOSET / GUEST BATHROOM
2'-4" X 6'-8"	8	SINGLE	GUEST BATHRMS / OWNERS BATHRM / OWNERS CLOSET / GUEST BED 3 & 4 W.I.C. / POWDER RM
2'-6" X 6'-8"	5	SINGLE	BEDROOM ENTRIES / REC. ROOM / OPT. GUEST BEDROOM
2'-8" X 6'-8"	1	SINGLE	LAUNDRY
2'-8" X 6'-8"	1	SINGLE	GARAGE FIRE DOOR - 20 MINUTE MIN
3'-0" X 6'-8"	1 DOOR SET (*2)	BI-SWING PAIR	GUEST BEDROOM #2 / OPT. GUEST BEDROOM #3 & #5 CLOSETS
*5'-0" X 6'-8"	*1 DOOR SET	BI-SWING PAIR	*OPTIONAL OFFICE

WINDOW SCHEDULE					
MARK	RO SIZE (WxH)	WINDOW TYPE	LOCATION	QUANTITY	NOTES
a	NOT USED				
b	2'-0" X 2'-0"	PICTURE	BEDROOM #4 W.I.C. / DINING ROOM / OPT REC.	1 * (6)	* OPTIONAL DINING ROOM / OPTIONAL REC. ROOM
c	NOT USED				
d	NOT USED				
f	2'-8" X 5'-0"	SINGLE HUNG	DINING, OWNERS SUITE	4	EGRESS TO OWNERS SUITE
g	2'-8" X 4'-10"	SINGLE HUNG	GUEST BEDROOM #2/ #3/ #4 / REC. ROOM	7	EGRESS TO GUEST BEDROOMS / REC. ROOM
n	2'-0" X 3'-0"	SINGLE HUNG	GUEST BATHRM / POWDER ROOM / OWNER'S BATHRM	4 * (1)	* OPTIONAL GUEST BATHROOM
s	3'-0" X 1'-6"	PICTURE	OWNERS BATHROOM	1	
x	*2'-4" X 5'-0"	SINGLE HUNG	FAMILY ROOM	3 * (2)	* OPTIONAL FAMILY ROOM / * OPTIONAL OWNERS SUITE
y	2'-8" X 1'-6"	PICTURE	STAIRCASE	1	

SCHEDULES  
SCALE: NTS

REVISIONS:

**J.S. THOMPSON**  
ENGINEERING, INC.  
333 E. SIX FORKS RD., SUITE 180  
RALEIGH, NC 27609  
PHONE: (919) 789-9919  
FAX: (919) 789-9921  
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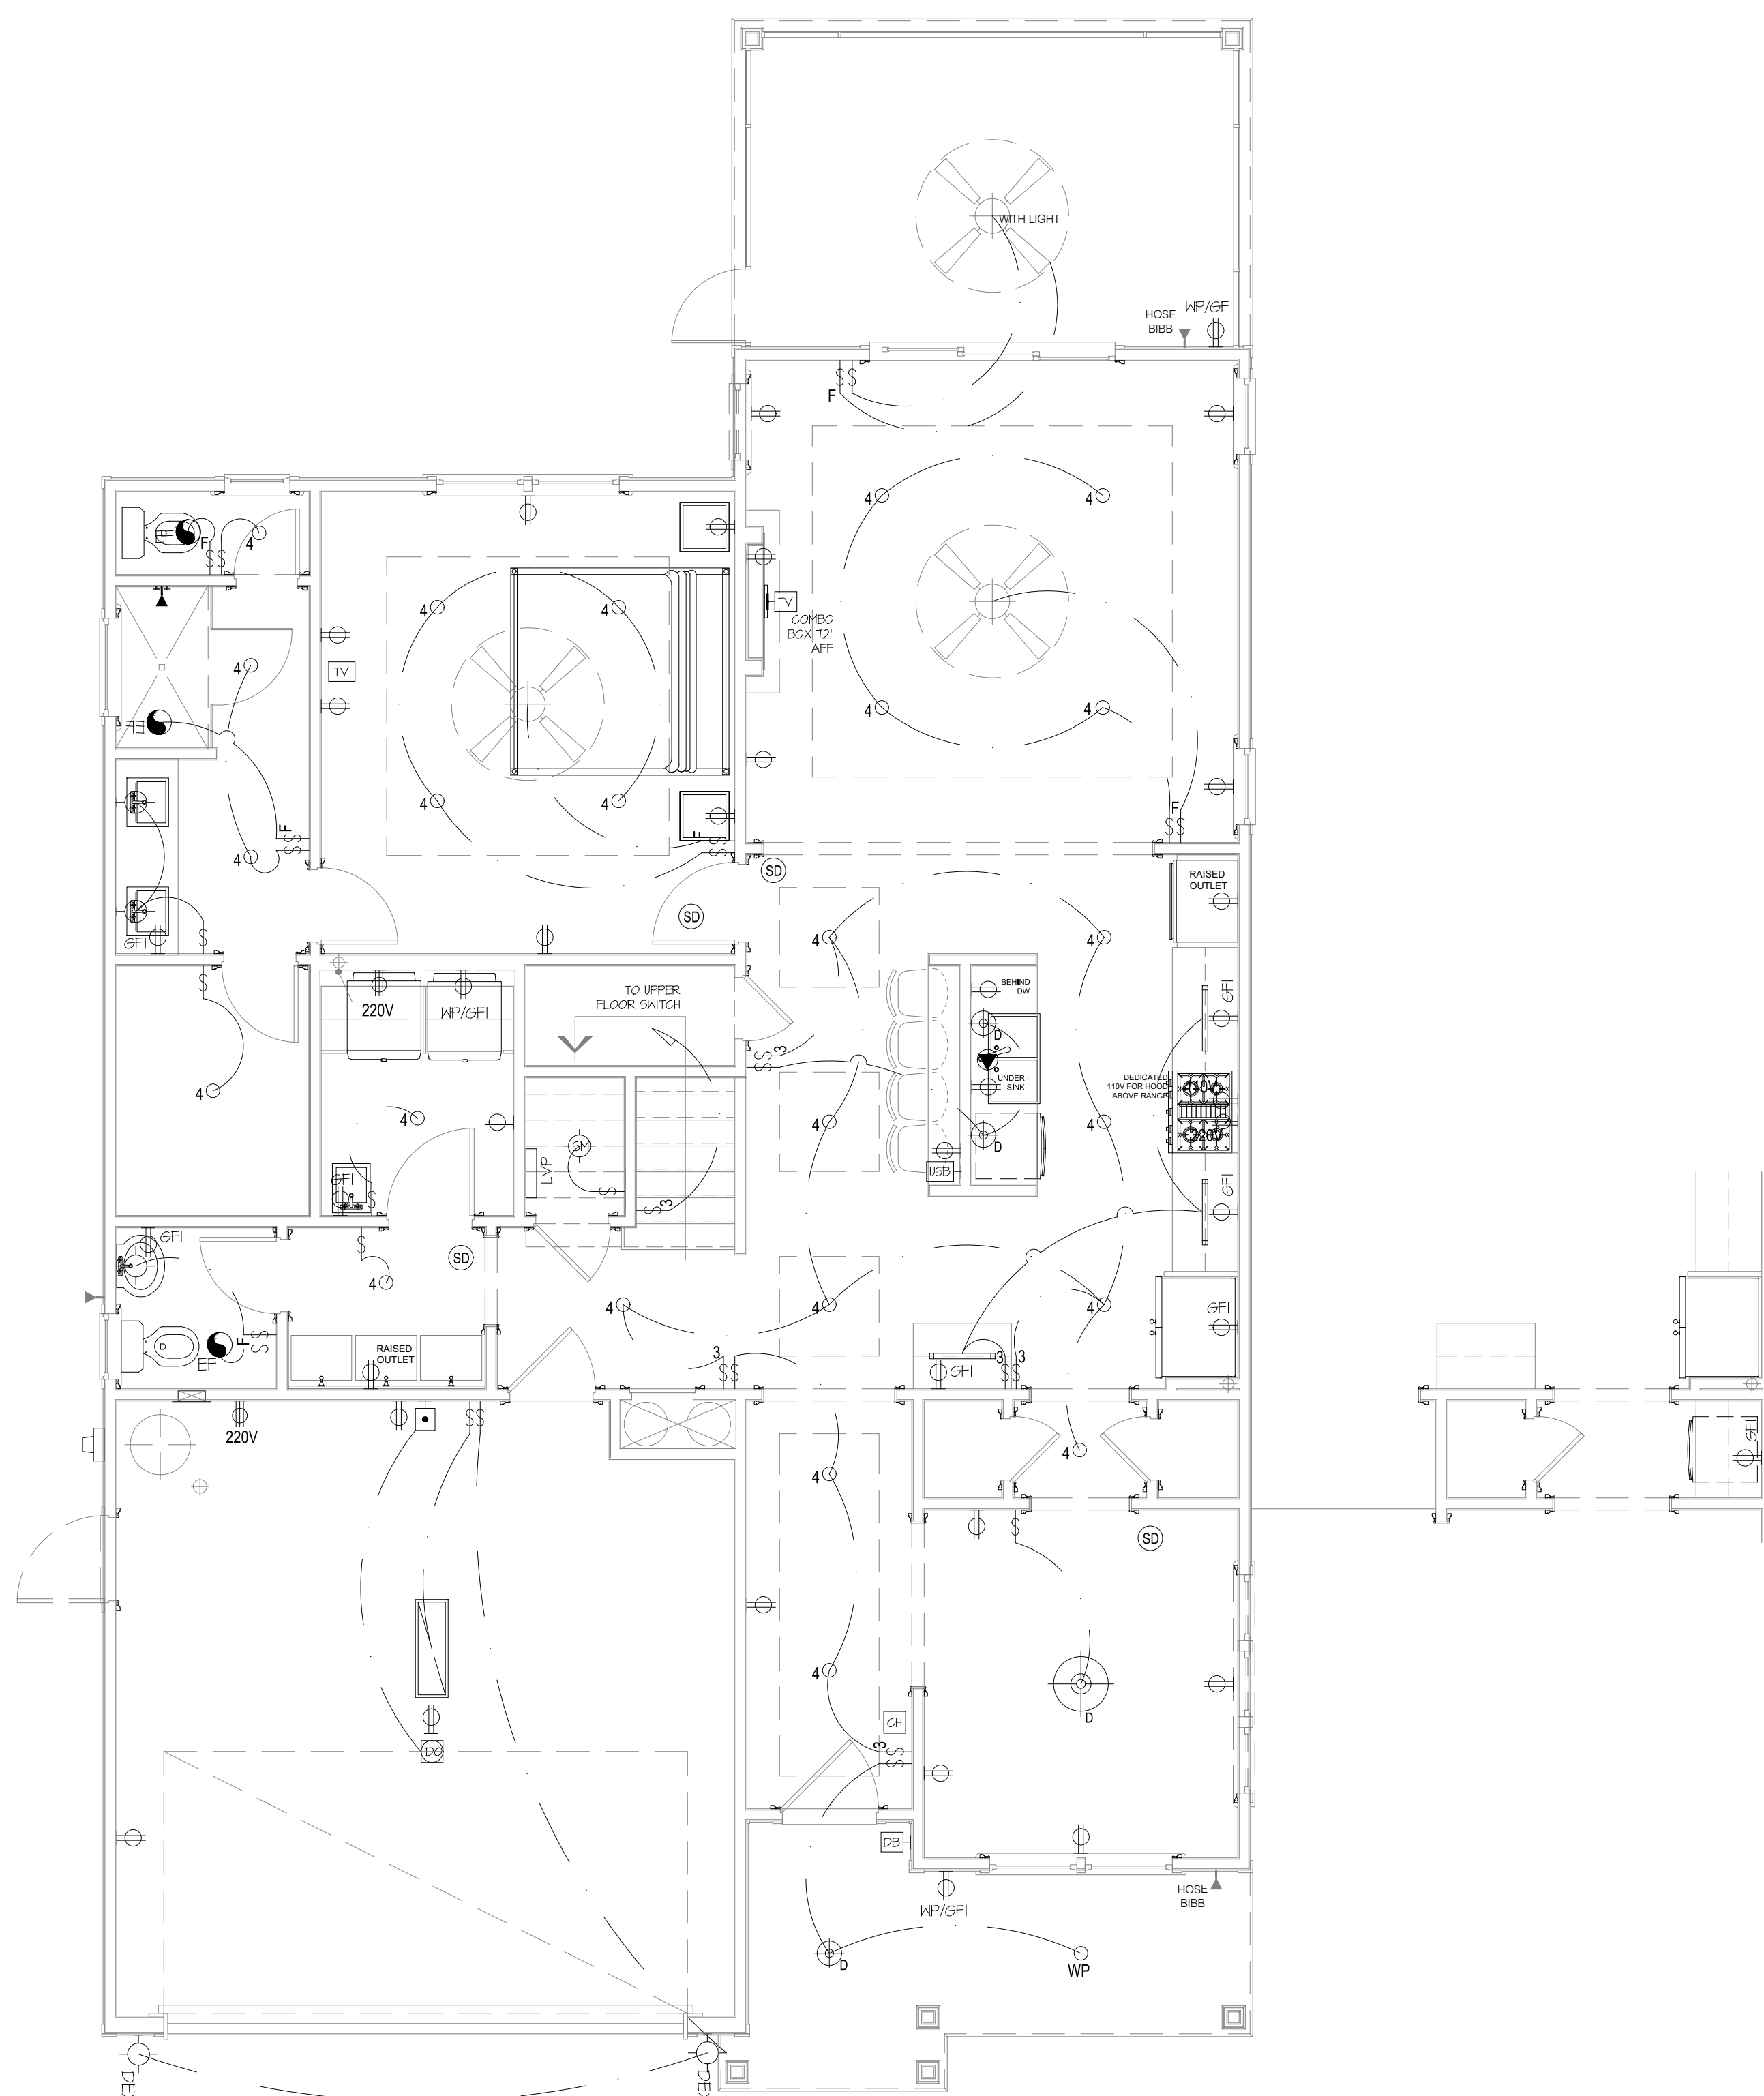
THE JANVILLE

WINDOW & DOOR SCHEDULES

DATE: 2024-16-08  
DRAWN BY: JST  
ENGINEER: NS  
CHECKED BY: NS  
Q.C. BY: NS  
SCALE:  
SHEET NUMBER #:

A4





- ELECTRICAL NOTES:**
1. PROVIDE AND INSTALL CERTIFIED SMOKE DETECTORS AS REQUIRED BY NATIONAL FIRE PROTECTION ASSOCIATION (NFPA) AND MEETING THE REQUIREMENTS OF ALL GOVERNING CODES. ALL SMOKE DETECTORS SHALL NOT BE LOCATED WITHIN THREE FEET OF A BATHROOM OR AN A/C SUPPLY.
  2. PROVIDE AND INSTALL GROUND FAULT CIRCUIT-INTERRUPTERS (GFI) AS REQUIRED BY NATIONAL ELECTRIC CODE (NEC) AND MEETING THE REQUIREMENTS OF ALL GOVERNING CODES.
  3. HVAC CONTRACTOR TO VERIFY THERMOSTAT LOCATIONS.
  4. ALL ELECTRICAL AND MECHANICAL EQUIPMENT (I.E. FURNACES, A/C UNITS, ELECTRICAL PANELS, AND WATER HEATERS) ARE SUBJECT TO RELOCATION PER FIELD CONDITIONS.
  5. PROJECT WALK-THRU WITH SUPERINTENDENT AND ELECTRICAL CONTRACTOR TO BE SCHEDULED PRIOR TO ELECTRICAL ROUGH-IN.
  6. REFER TO CABINET DRAWINGS AND LIGHTING DETAILS FOR POWER STUB-OUT LOCATIONS FOR BUILT-IN AND CABINET LIGHTING.
  7. ALL ELECTRICAL PLANS AND LOCATIONS AS SHOWN ARE TO BE LAID OUT PER LOCAL AND STATE BUILDING CODES AND ANY RELEVANT INSPECTIONS.
  8. ALL LIGHTING LOCATIONS SHALL BE REVIEWED AND COORDINATED WITH APPROVED FLOOR AND ROOF TRUSS LAYOUTS PRIOR TO INSTALLATION IN THE FIELD.

STANDARD ELECTRICAL & LIGHTING KEY	
WIRING CIRCUIT	WHIP FOR LIGHTING
LV WIRING CIRCUIT LOW VOLTAGE	3" RECESSED INCANDESCENT CEILING LIGHT
LIGHTING CONTROL	4" RECESSED INCANDESCENT CEILING LIGHT
WALL SWITCH SINGLE POLE	4" RECESSED LED CEILING CAN LIGHT
THREE-WAY SWITCH	4" VAPOR PROOF LED RECESSED CAN LIGHT
FOUR-WAY SWITCH	JUNCTION BOX REINFORCED CEILING MOUNT
FAN SWITCH	CEILING JUNCTION BOX
DIMMER SWITCH	SURFACE MOUNTED LED CEILING LIGHT
THREE-WAY DIMMER SWITCH	PENDANT LIGHT
DIMMER SWITCH ON SYSTEM	CHANDELIER (REINFORCED CEILING MOUNT)
SINGLE POLE SWITCH ON SYSTEM	WALL MOUNTED INCANDESCENT LIGHT FIXTURE
PUSH BUTTON SWITCH (GARAGE DOOR)	DECORATIVE EXTERIOR SCOFF
MOTORIZED SHADE (INTERIOR)	AIMABLE RECESSED DOWN LIGHT LOW VOLTAGE
MOTORIZED SHUTTERS (EXTERIOR)	LED RECESSED DOWN LIGHT - PHOTO CELL
DOOR BELL	PUCK LIGHT
CHIMES	DOUBLE LAMP CEILING LIGHT (CLOSED)
DUPLEX OUTLET	TRIPLE LAMP CEILING LIGHT (CLOSED)
GROUND FAULT DUPLEX OUTLET ABOVE COUNTER	JAMB LIGHT FIXTURE
GROUND FAULT INTERRUPTER DUPLEX OUTLET	TRACK LIGHT FIXTURE
WEATHERPROOF GROUND FAULT DUPLEX OUTLET	FLUORESCENT FIXTURE-SURFACE MOUNT
HALF-SWITCHED DUPLEX OUTLET	CEILING FAN (Add light where indicated)
DEDICATED OUTLET	SINGLE FLOOD LIGHT
220 VOLT OUTLET	PHOTO CELL DOUBLE FLOOD LIGHT
FLOOR OUTLET	UC STRIP LIGHT
HALF SWITCHED FLOOR OUTLET	STRIP LIGHT ABOVE CABINET
TELEPHONE/DATA-FLOOR	TOE KICK STRIP LIGHT
CLOCK BOX-WALL	UNDER CABINET LIGHT
RECESSED TV COMBINATION BOX	PLUG MOLD
TV CONNECTION	COVE LIGHTING-LINEAR
TELEPHONE/DATA-WALL	TRANSFORMER
ELECTRICAL OUTLET / USB COMBO	DRIVER
DTV SHOWERING SYSTEM	DEMARICATION BOX
KEYPAD-SYSTEM CONTROL	ELECTRIC METER
THERMOSTAT	ELECTRIC PANEL
KEYPAD FOR ALARM	DISCONNECT SWITCH
HEAT DETECTOR	GAS METER
LIGHT & EXHAUST FAN	WATER METER
EXHAUST FAN	GAS VALVE
LANDSCAPE LIGHTING (POWER/SWITCH LEG)	AIR SWITCH
CARBON MONOXIDE/SMOKE DETECTOR COMBINATION UNIT	PIN LIGHT
SPEAKER (OPTIONAL)	LOW VOLTAGE PANEL
GARBAGE DISPOSAL	
ELECTRIC DOOR OPERATOR (GARAGE)	

ELECTRICAL SYMBOLS LEGEND  
SCALE: NTS

MAIN FLOOR PLAN WITH OPTIONS - ELECTRICAL  
SCALE: 1/4" = 1'-0"

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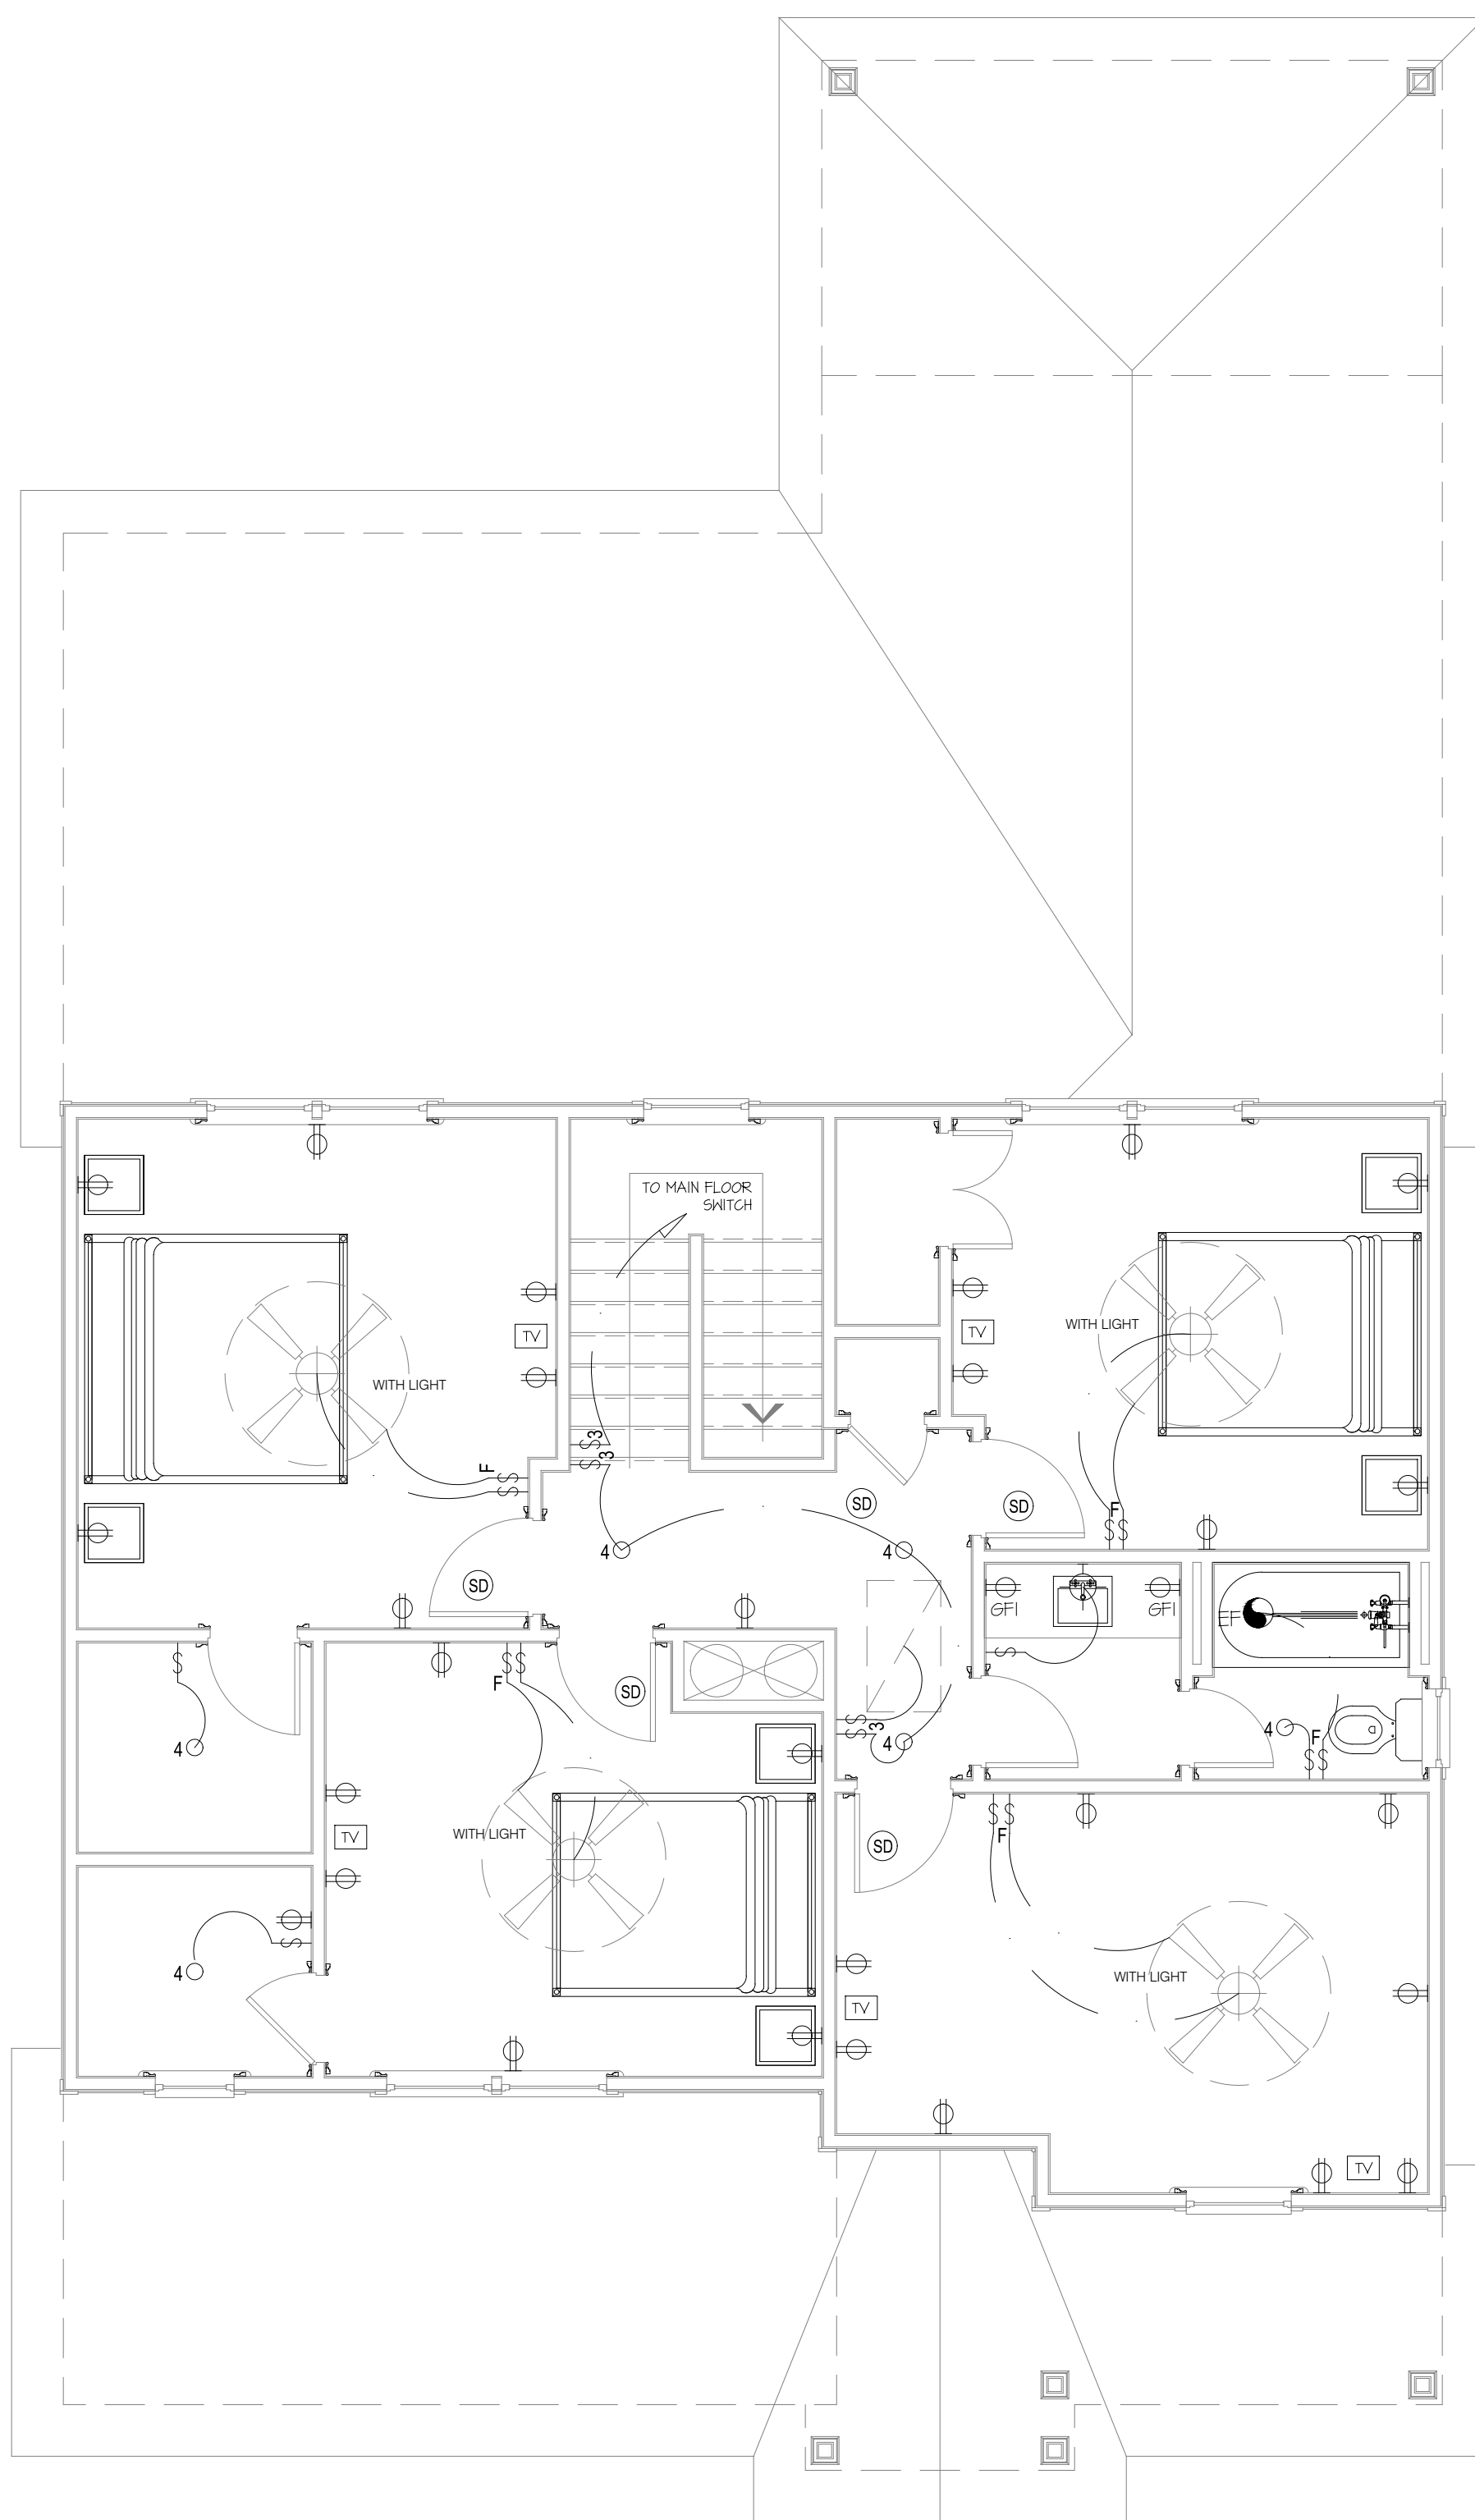
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**THE JANVILLE**


MAIN FLOOR PLAN  
ELECTRICAL

DATE: 2024-16-08  
DRAWN BY: JST  
ENGINEER: NS  
CHECKED BY: NS  
Q.C. BY: NS  
SCALE: NS

SHEET NUMBER:  
**E1**



UPPER FLOOR PLAN - "STANDARD"

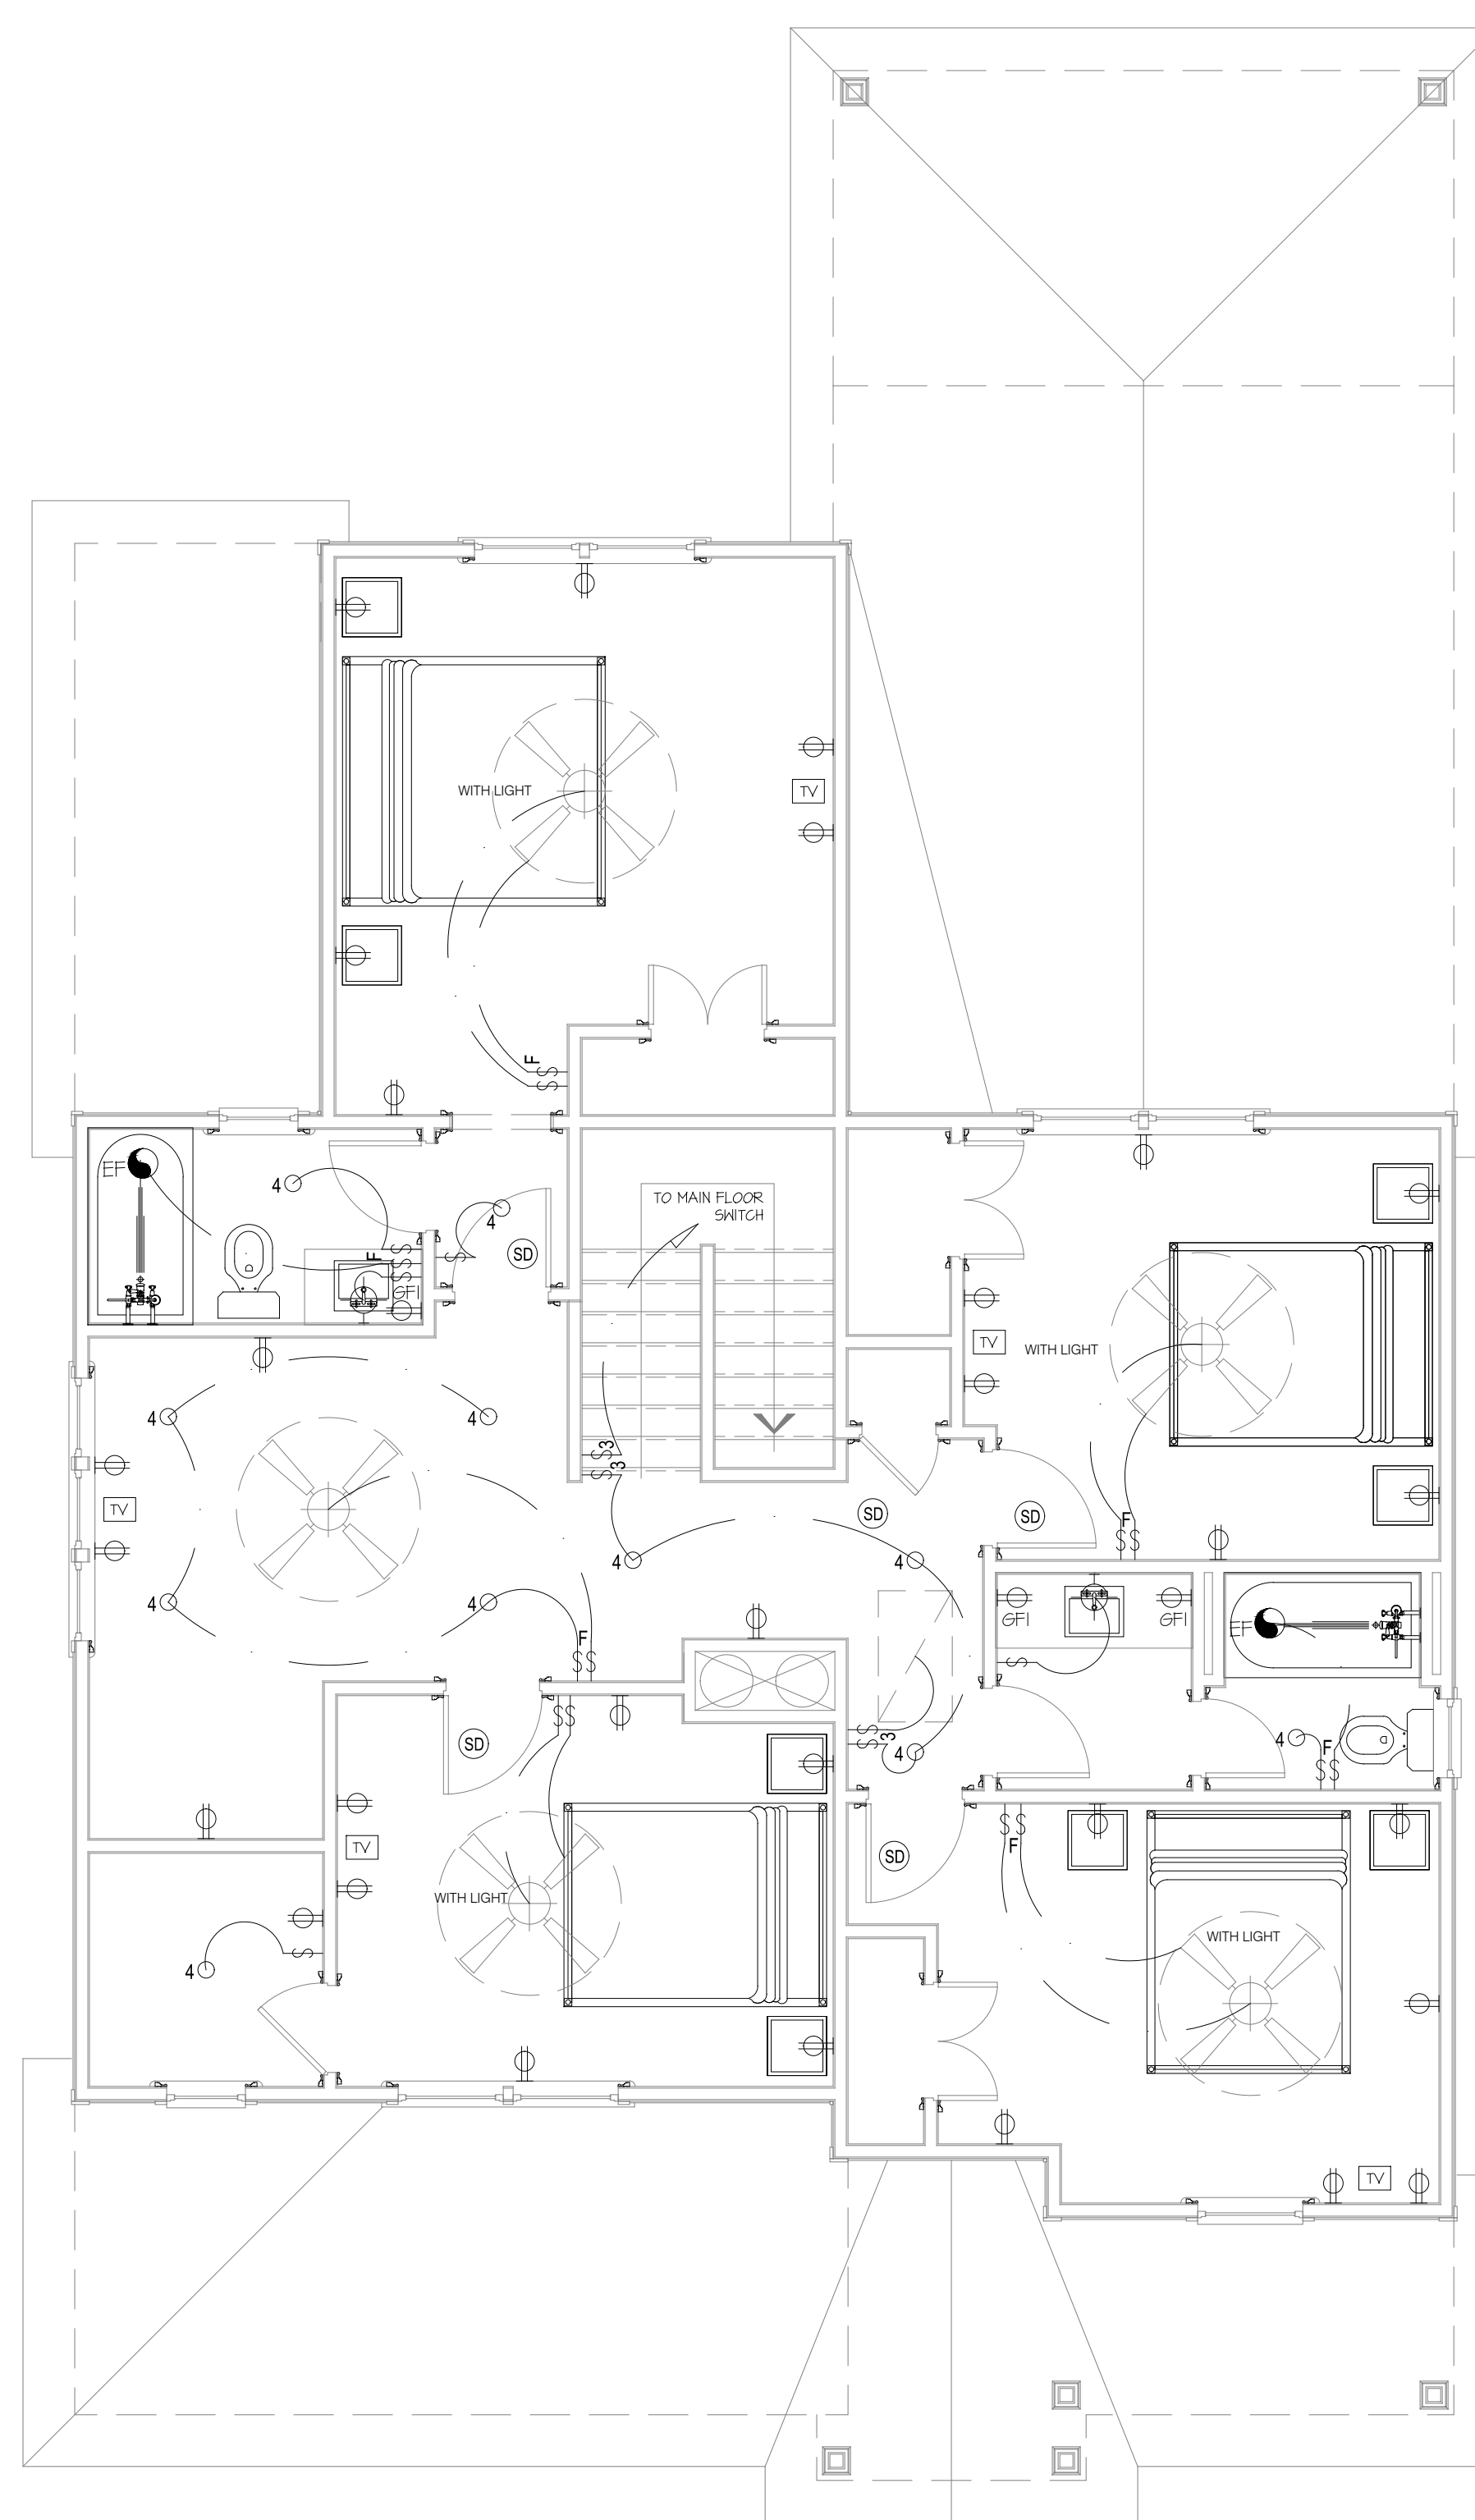

UPPER FLOOR PLAN - OPTION "B"

**ELECTRICAL NOTES:**

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**STANDARD ELECTRICAL & LIGHTING KEY**

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ELECTRICAL SYMBOLS LEGEND  
SCALE: NTS

UPPER FLOOR PLAN WITH OPTIONS - ELECTRICAL  
SCALE: 1/4" = 1'-0"

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THE JANVILLE  
UPPER FLOOR PLAN  
ELECTRICAL

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DRAWN BY: JST  
ENGINEER: JST  
CHECKED BY: NS  
Q.C. BY: NS  
SCALE:  
SHEET NUMBER: #  
**E1.2**