



MONOLITHIC SLAB

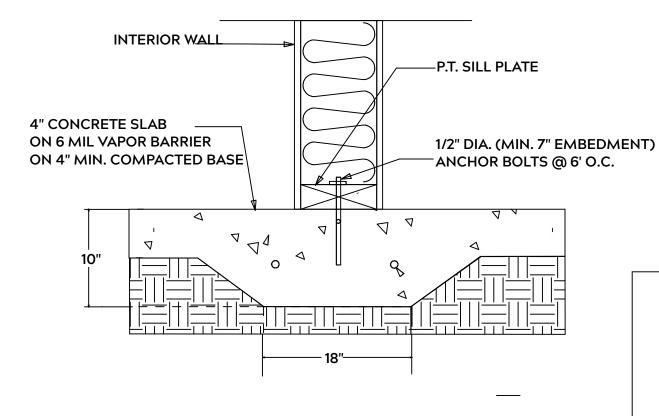

LUG FOOTING

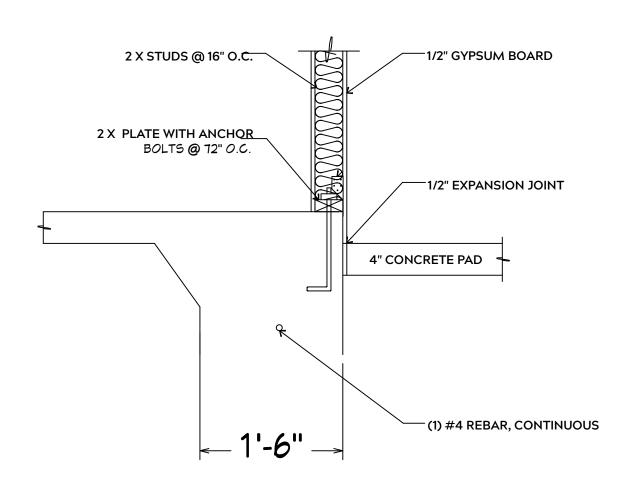

FOUNDATION NOTES:


ALL FOOTINGS SHALL BEAR ON ORIGINAL UNDISTURBED SOIL THE 28 DAY COMPRESSIVE STRENGTH OF ALL **FOOTINGS IS 3000 PSI**

PROVIDE WATER PROOFING AND PERIMTER **DRAINS AS REQUIRED**

FOOTING WIDTHS ARE BASED ON A LOAD **BEARING SOIL CAPACITY OF 2000 PSI**

PROVIDE 6 MIL POLY VAPOR BARRIER TO COVER GROUND IN CRAWL SPACE AND **GROUND UNDER POURED CONCRETE**

ALL ANCHOR BOLTS TO BE 1/2" X 12" LONG. ANCHOR BOLTS SHALL BE SPACED AT A MAXIMUM OF 6' ON CENTER AND NO MORE THEN 1' FROM EACH CORNER

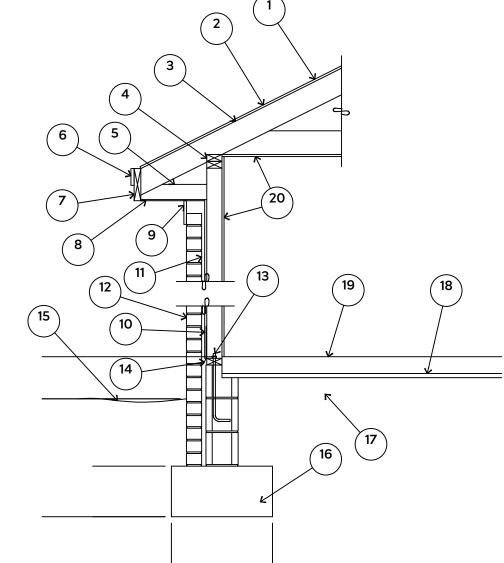


15# FELT UNDERLAYMENT UNDER COMPOSITION SHINGLES.

2. ROOF DECKING.

- 3. 2 X RAFTERS / ENGINEERED TRUSSES
- DOUBLE TOP PLATE.
- 5. 2 X 4 RETURN. 6. 3/4" FASCIA OR PVC TRIM COIL
- 7. 2 X FASCIA
- 1/4" PLYWOOD OR VINYL SOFFIT 9. 1X FREIZE BOARD (TO BE USED WITH **BRICK VENEERS)**
- 10. INSULATION BOARD OR HOUSE WRAP
- 11. AIR SPACE.
- 12 BRICK WITH BRICK TIES PER MANUFACTURER'S SPECIFICATIONS.
- 13. 1/2" X 12" ANCHOR BOLTS, 6'-0" O.C., 12" FROM CORNERS.
- 4. FLASHING WITH WEEP HOLES @ 48" O.C.
- 15. FINISHED GRADE.
- 16. FOOTING
- 17. COMPACTED EARTH FILL
- 18. 6 MIL. VAPOR BARRIER
- 19. 4" CONCRETE SLAB, 3,000 P.S.I. WITH 6" X 6" 10 GA. X 10 GA. WELDED WIRE FABRIC.
- 20. 1/2" GYPSUM BOARD.

EXTERIOR WALL SECTION

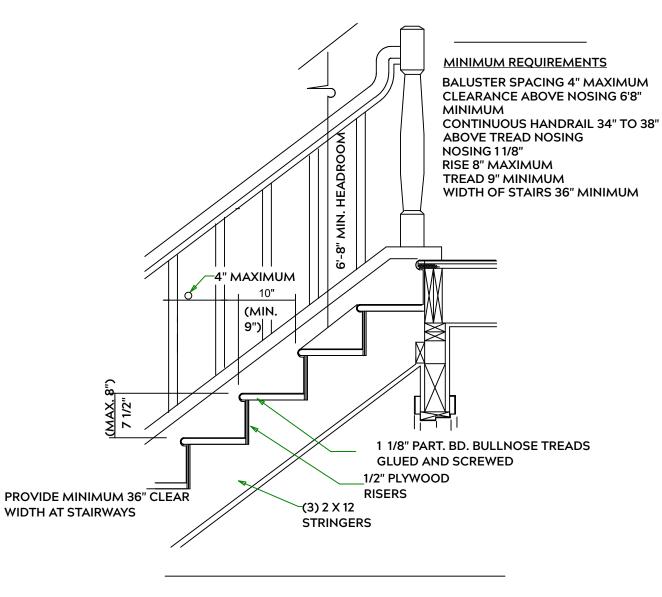

STAIR DETAIL

GENERAL FRAMING NOTES:

ALL LUMBER IN CONTACT WITH CONCRETE OR MASONRY SHALLE BE PRESSURE TREATED

FRAMING LUMBER SHALL BE SYP #2 GRADE AND / OR SPRUCE PINE FIR #1 AND / OR KILN DRIED

WHERE PRE-ENGINEERED JOISTS AND TRUSSES ARE USED, MANUFACTURER SHALL PROVIDE DRAWINGS / SCHEMATICS, WHICH SHALL BEAR OF A N.C. **ENGINEER**

STUDS AND JOISTS SHALL NOT BE CUT TO INSTALL PLUMBING OR WIRING WITHOUT ADDING METAL OR WOOD SIDE PANELS TO STRENGTHEN MEMBER TO ITS ORIGINAL CAPACITY

NAIL MULTIPLE MEMBERS WITH 2 ROWS OF 16d NAILS STAGGERED 32" O.C. AND USE 3 X 16d NAILS 2" IN AT EACH END.

NAIL FLOOR JOISTS TO SILL PLATE WITH WITH 8d TOE NAILS

ALL EXPOSED FRAMING ON PORCHES OR DECKS SHALL BE PRESSURE **TREATED**

PROVIDE WATERPROOFING AND DRAINS AS REQUIRED

ALL FRAMING TO BE 16" O.C. WALL FRAMING DIMENSIONS ARE BASED ON 2X4 OR 2X6 EXTERIOR WALLS AND 2X4 INTERIOR WALLS. DOULBE / TRIPLE JACK STUDS AS NECESSARY UNDER HEADERS AS REQUIRED

LVL'S TO BE SIZED BY OTHERS (TRUSS MANUFACTURER)

INTERIOR WALL @ GARAGE STEP DOWN

PLAN: Rothbard

> SHEETS AIL

E

115 Mahogany Ct. Magnolia Hills Lot 24 PROJECT ADDRESS: 115 Mahogany Ct.

Precision Custom Hor Raeford, NC @PrecisionCustomHor

DATE:


12/12/24

SCALE:


1/4" = 1'

SHEET:

A-3

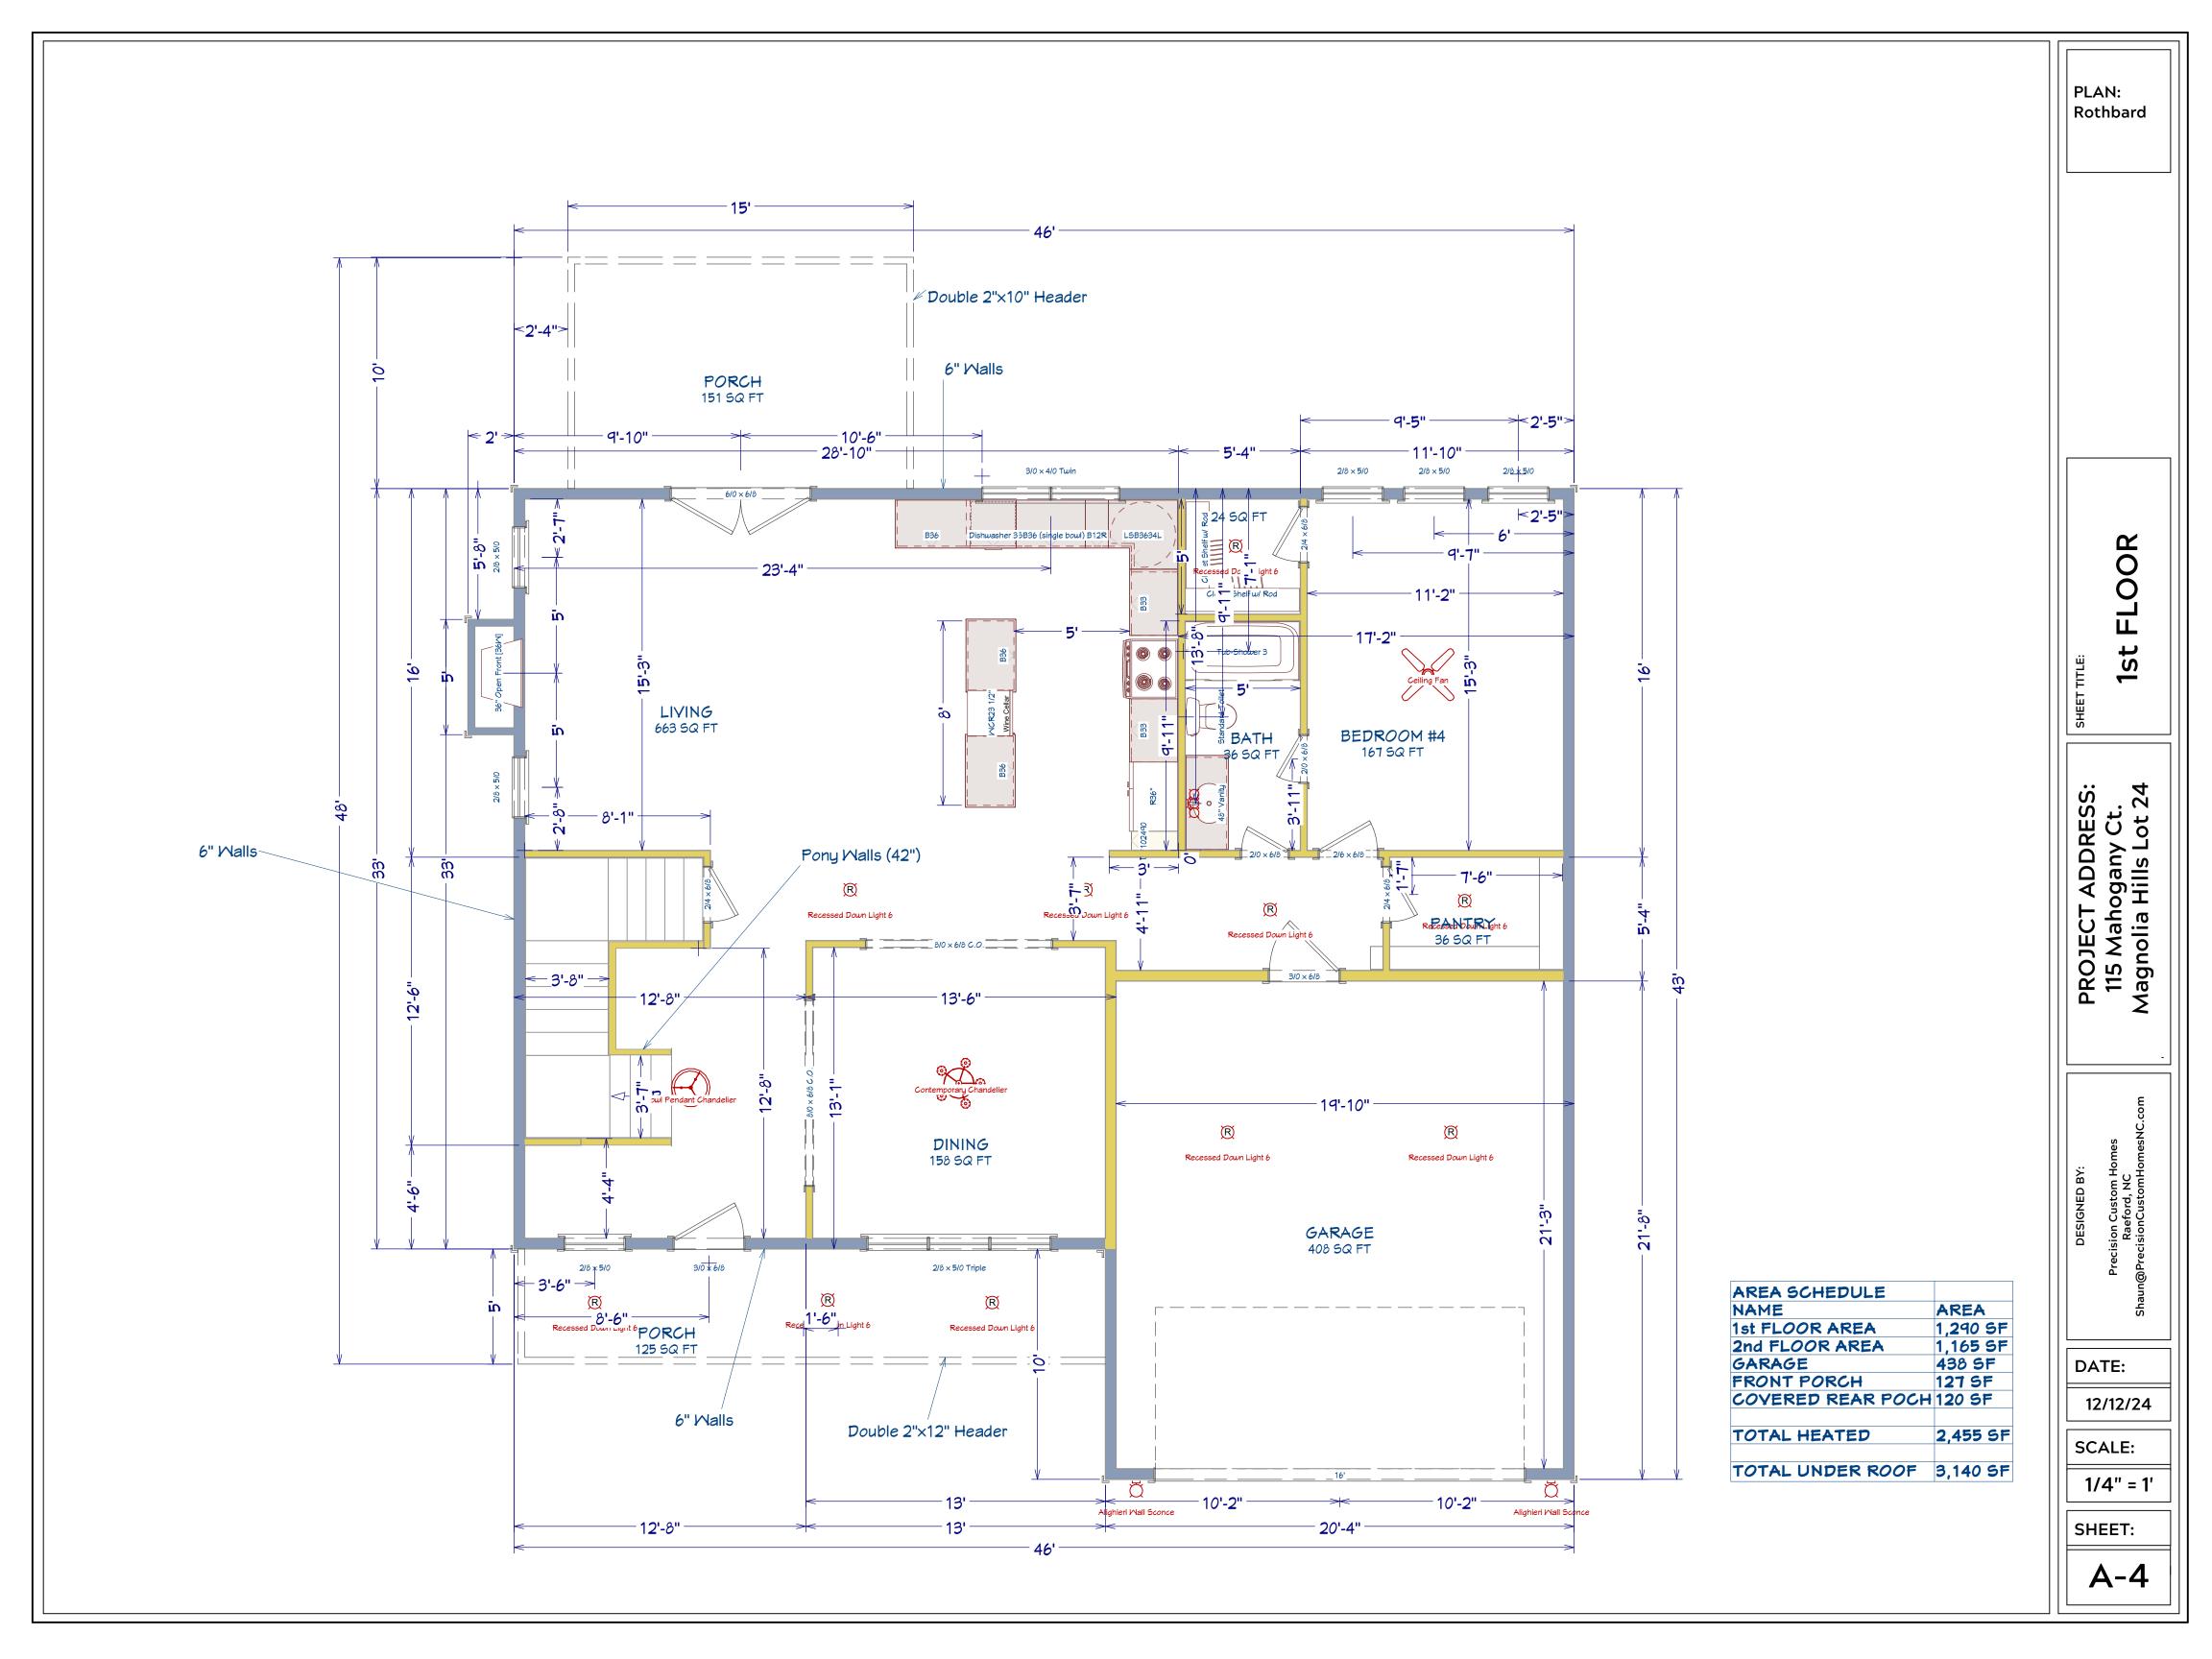



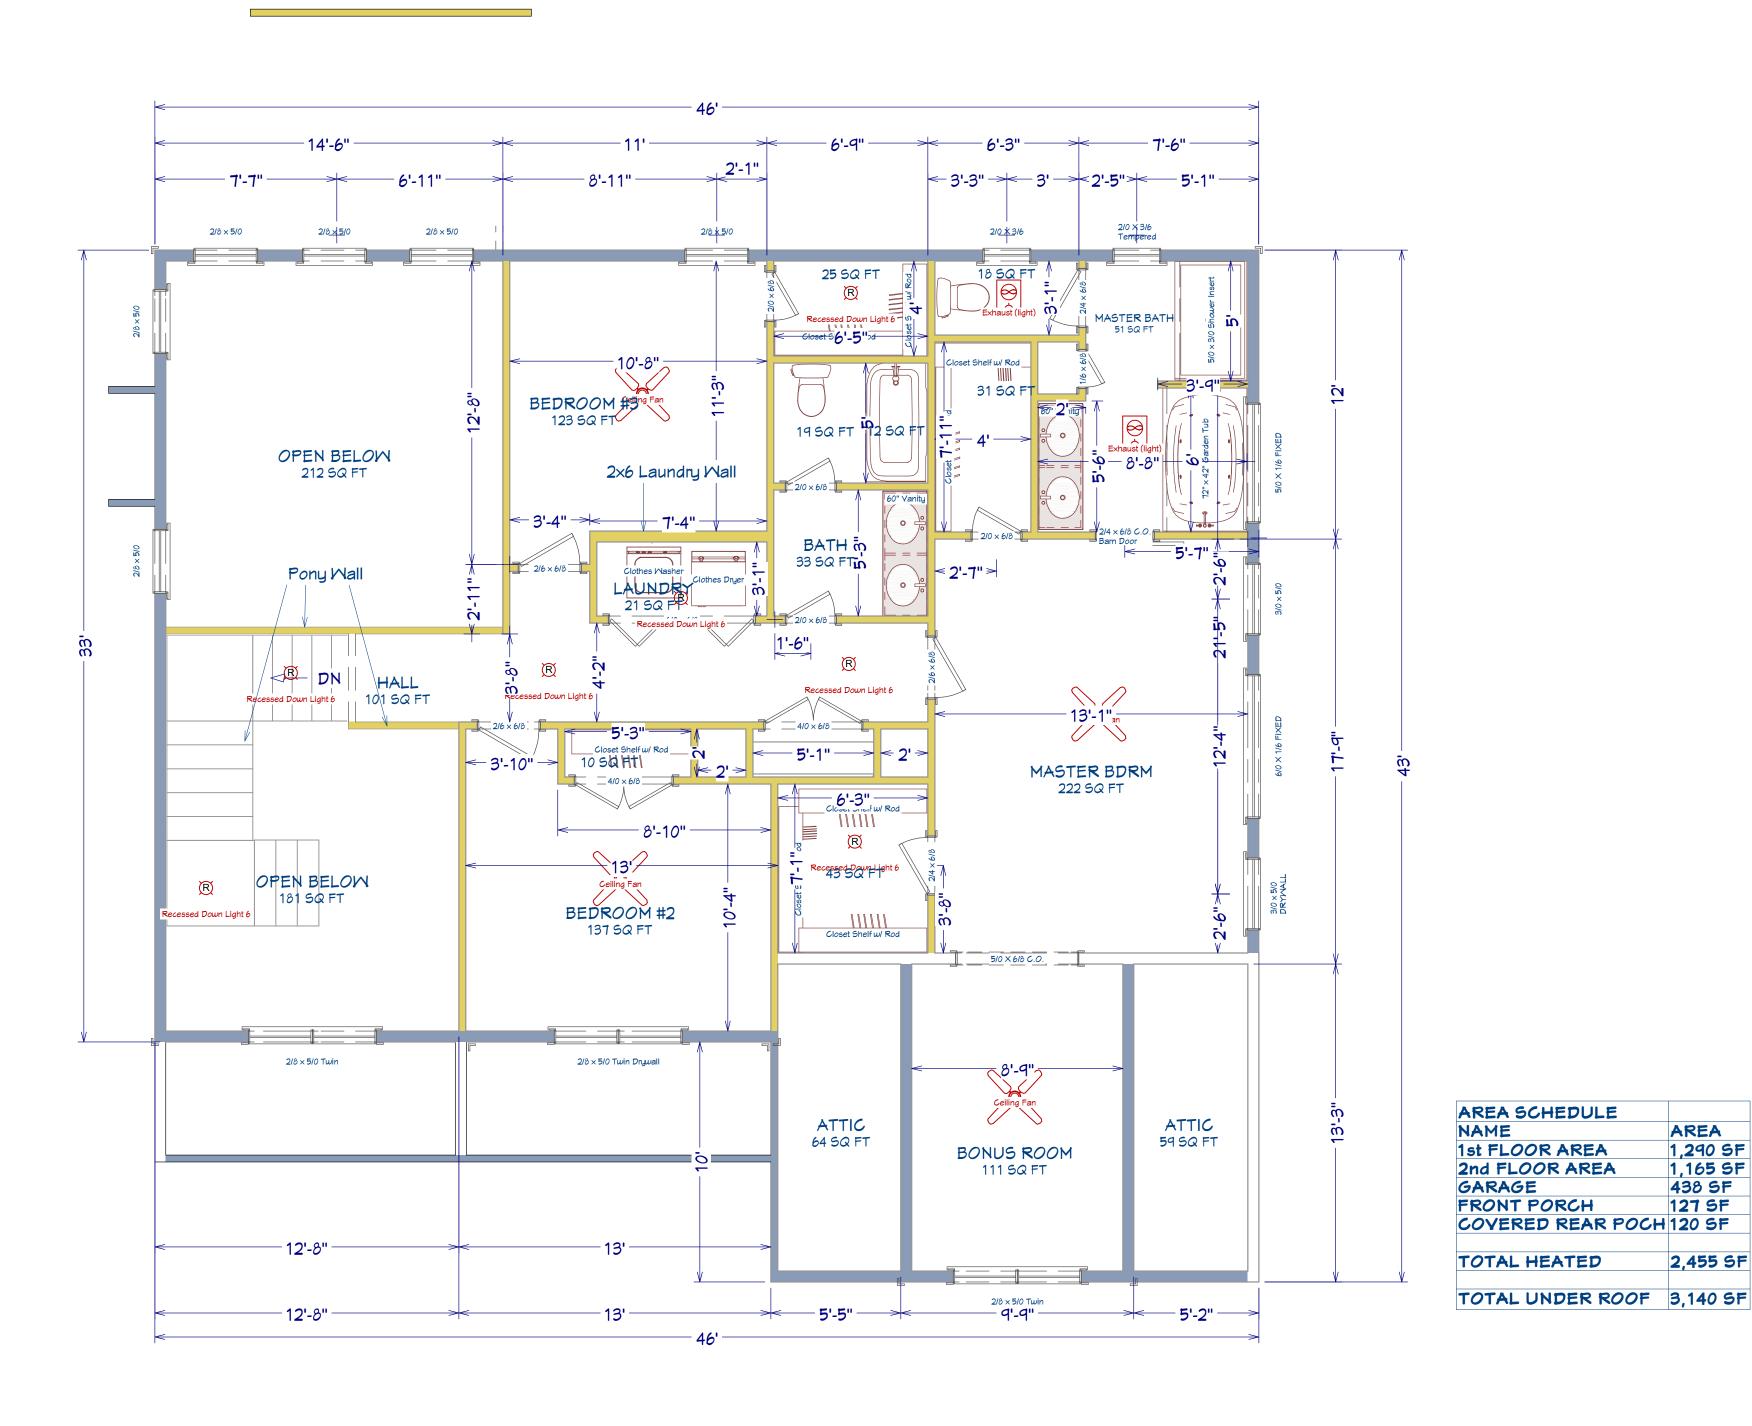

PROJECT ADDRESS: 115 Mahogany Ct. Magnolia Hills Lot 24

Precision Custom Hom Raeford, NC n@PrecisionCustomHom

AREA

1,290 SF

1,165 SF


438 SF

127 SF

2,455 SF

SHEET:

A-5

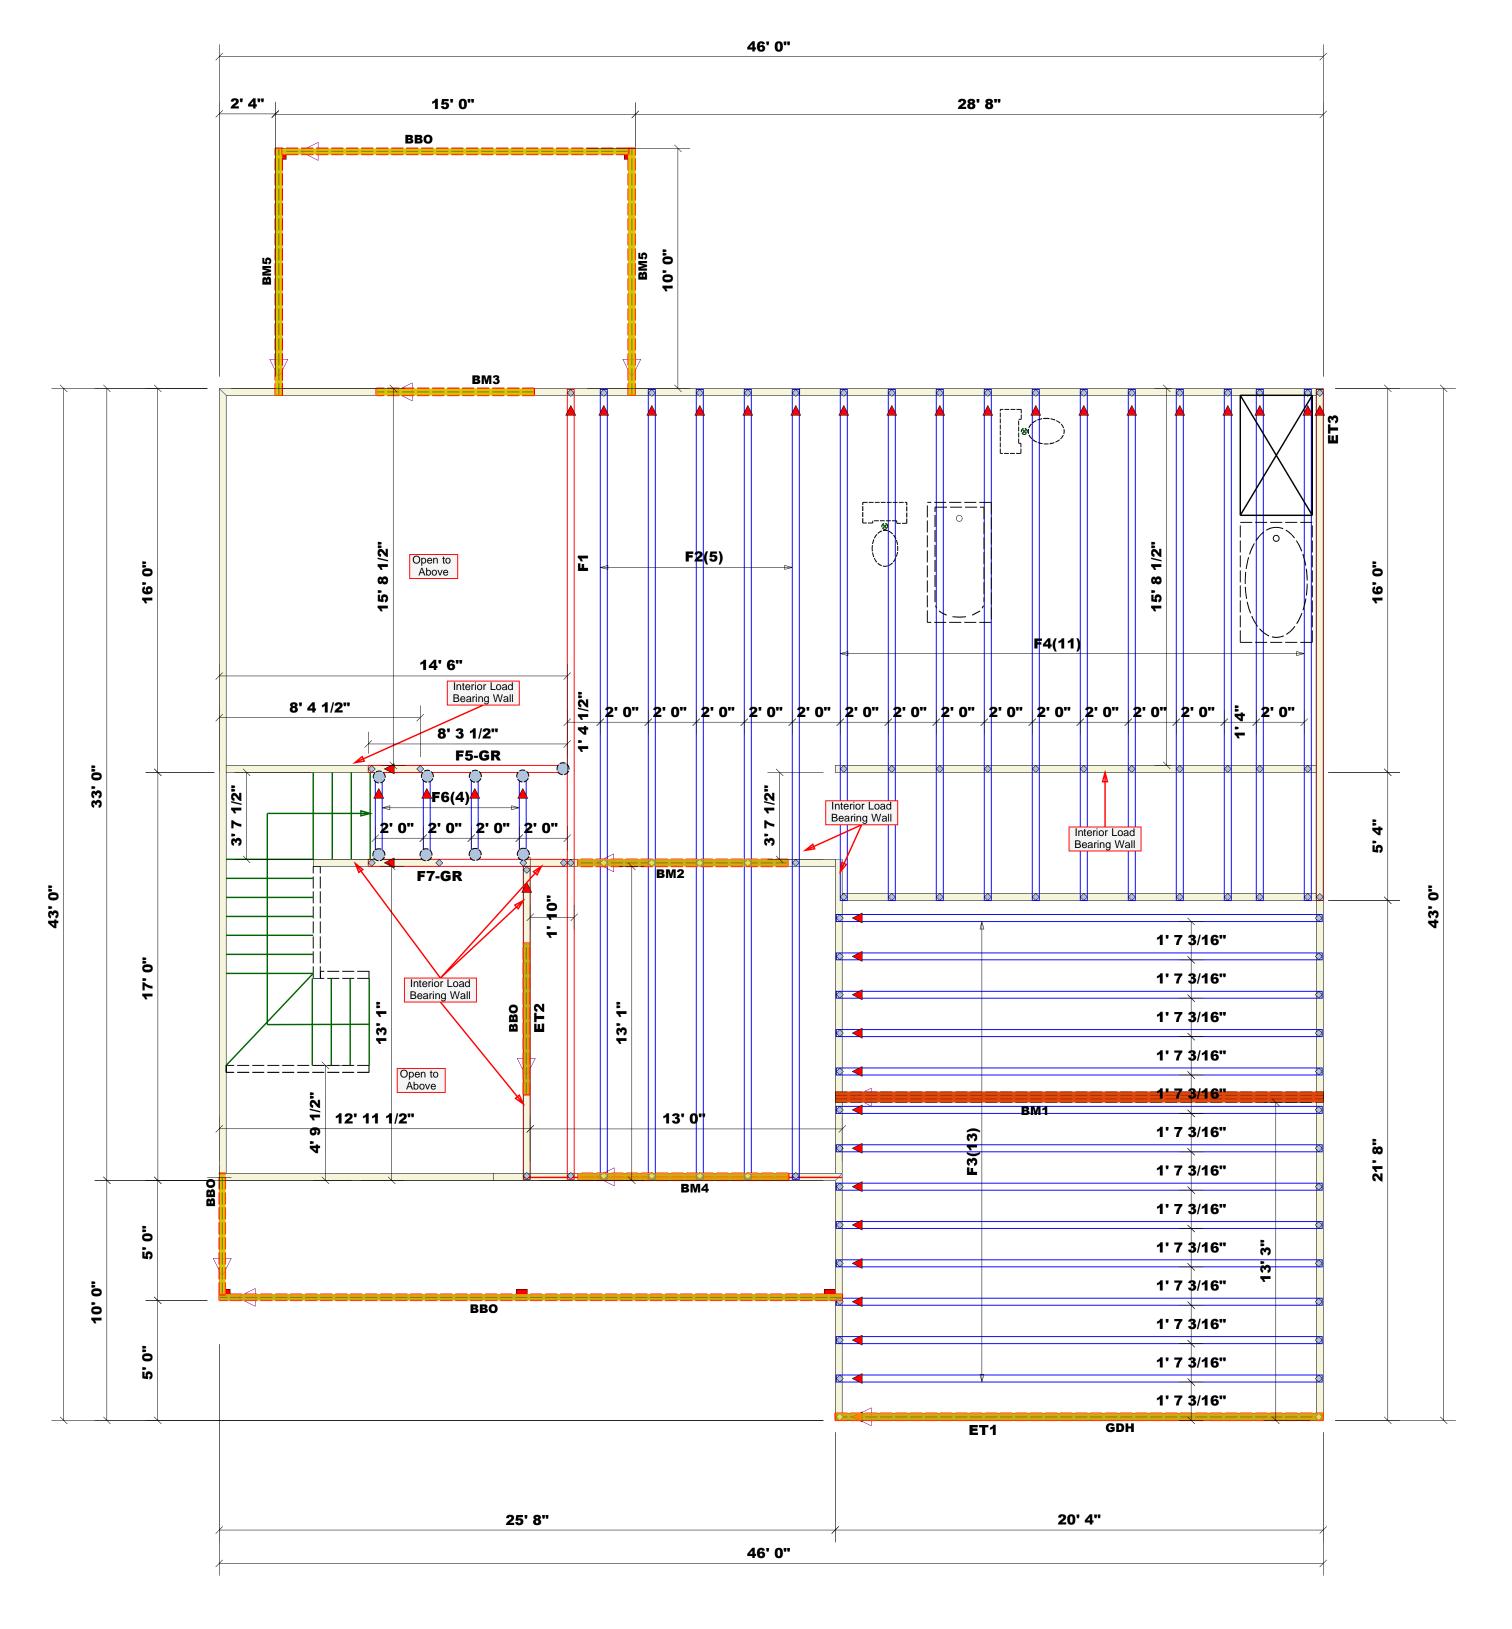

Dimension Notes 1. All exterior wall to wall dimensions are to face of stud unless noted otherwise

2. All interior wall dimensions are to face of stud unless noted otherwise

3. All exterior wall to truss dimensions are to face of stud unless noted otherwise

Roof Area = 2690.59 sq.ft. Ridge Line = 59.33 ft. Hip Line = 0 ft. Horiz. OH = 182 ft.Raked OH = 320.62 ft. Decking = 92 sheets

All Walls Shown Are Considered Load Bearing

= Indicates Left End of Truss (Reference Engineered Truss Drawing) Do Not Erect Trusses Backwards

Plumbing Drop Notes Plumbing drop locations shown are NOT exact.
 Contractor to verify ALL plumbing drop locations prior to setting Floor Trusses.
 Adjust spacing as needed not to exceed 24"oc.

| | Conne | Nail Info | ormation | | | |
|-----|---------|-----------|----------|---------------------|------------|------------|
| Sym | Product | Manuf | Qty | Supported Member | Header | Truss |
| | MSH422 | USP | 9 | Varies | 10d/3" | 10d/3" |
| | JUS26 | USP | 10 | Varies | 10d/3" | 10d/3" |
| | HUS26 | USP | 9 | Varies | 16d/3-1/2" | 16d/3-1/2" |

| | Products | | | |
|--------|---|--|--|--|
| Length | Product | Plies | Net Qty | Fab Type |
| 11' 0" | 1-3/4"x 9-1/4" LVL Kerto-S | 2 | 4 | FF |
| 9' 0" | 1-3/4"x 9-1/4" LVL Kerto-S | 2 | 2 | FF |
| 9' 0" | 1-3/4"x 9-1/4" LVL Kerto-S | 2 | 2 | FF |
| 7' 0" | 1-3/4"x 9-1/4" LVL Kerto-S | 2 | 2 | FF |
| 21' 0" | 1-3/4"x 14" LVL Kerto-S | 3 | 3 | FF |
| 21' 0" | 1-3/4"x 16" LVL Kerto-S | 2 | 2 | FF |
| | 11' 0" 9' 0" 9' 0" 7' 0" 21' 0" | Length Product 11' 0" 1-3/4"x 9-1/4" LVL Kerto-S 9' 0" 1-3/4"x 9-1/4" LVL Kerto-S 9' 0" 1-3/4"x 9-1/4" LVL Kerto-S 7' 0" 1-3/4"x 9-1/4" LVL Kerto-S 21' 0" 1-3/4"x 14" LVL Kerto-S | Length Product Plies 11' 0" 1-3/4"x 9-1/4" LVL Kerto-S 2 9' 0" 1-3/4"x 9-1/4" LVL Kerto-S 2 9' 0" 1-3/4"x 9-1/4" LVL Kerto-S 2 7' 0" 1-3/4"x 9-1/4" LVL Kerto-S 2 21' 0" 1-3/4"x 14" LVL Kerto-S 3 | Length Product Plies Net Qty 11' 0" 1-3/4"x 9-1/4" LVL Kerto-S 2 4 9' 0" 1-3/4"x 9-1/4" LVL Kerto-S 2 2 9' 0" 1-3/4"x 9-1/4" LVL Kerto-S 2 2 7' 0" 1-3/4"x 9-1/4" LVL Kerto-S 2 2 21' 0" 1-3/4"x 14" LVL Kerto-S 3 3 |





Reilly Road Industrial Park Fayetteville, N.C. 28309 Phone: (910) 864-8787 Fax: (910) 864-4444

Bearing reactions less than or equal to 3000# are deemed to comply with the prescriptive Code requirements. The contractor shall refer to the attached Tables (derived from the prescriptive Code requirements) to determine the minimum foundation size and number of wood studs required to support reactions greater than 3000# but not greater than 15000#. A registered design professional shall be retained to design the

Neil Baggett

LOAD CHART FOR JACK STUDS (BASED ON TABLES R502.5(1) & (b))

| NUMBER OF JACK STUDS REQUIRED @ EA END OF HEADER/GIRDER | | | | | | | |
|--|-----------------------------------|--|-------------------------|-----------------------------------|--|----------------------------------|-----------------|
| END REACTION (UP TO) | REQ'D STUDS FOR (2) PLY HEADER | | END REACTION (UP TO) | REQ'D STUDS FOR (3) PLY HEADER | | END RE <i>AC</i> TION (UP TO) | REQ'D STUDS FOR |
| 1700 | 1 | | 2550 | 1 | | 3400 | 1 |
| 3400 | 2 | | 5100 | 2 | | 6800 | 2 |
| 5100 | 3 | | 7650 | 3 | | 10200 | 3 |
| 6800 | 4 | | 10200 | 4 | | 13600 | 4 |
| 8500 | 5 | | 12750 | 5 | | 17000 | 5 |
| 10200 | 6 | | 15300 | 6 | | | |
| 11900 | 7 | | | | | | |
| 13600 | 8 | | | | | | |
| 15300 | 9 | | | | | | |
| | | | | | | | |

| ADDRESS | 115 Mahogany Ct., Cameron, NC |
|-----------|-------------------------------|
| MODEL | Floor |
| DATE REV. | 1/10/2025 |
| DRAWN BY | DRAWN BY Neil Baggett |
| SALESMAN | SALESMAN Neil Baggett |

JOB NAME SEAL DATE QUOTE ; THIS IS A TRUSS PLACEMENT DIAGRAM ONLY.

These trusses are designed as individual building components to be incorporated into the building design at the specification of the building designer. See individual design sheets for each truss design identified on the placement drawing. The building designer is responsible for temporary and permanent bracing of the roof and floor system and for the overall structure. The design of the truss support structure including headers, beams, walls, and columns is the responsibility of the building designer. For general guidance regarding bracing, consult BCSI-B1 and BCSI-B3 provided with the truss delivery package or online @ sbcindustry.com


12/12/2024

Precision Custom Homes & Renov

BUILDER

Rothbard 1.0 w/CP (15'x10')

Lot 24 Magnolia Hills

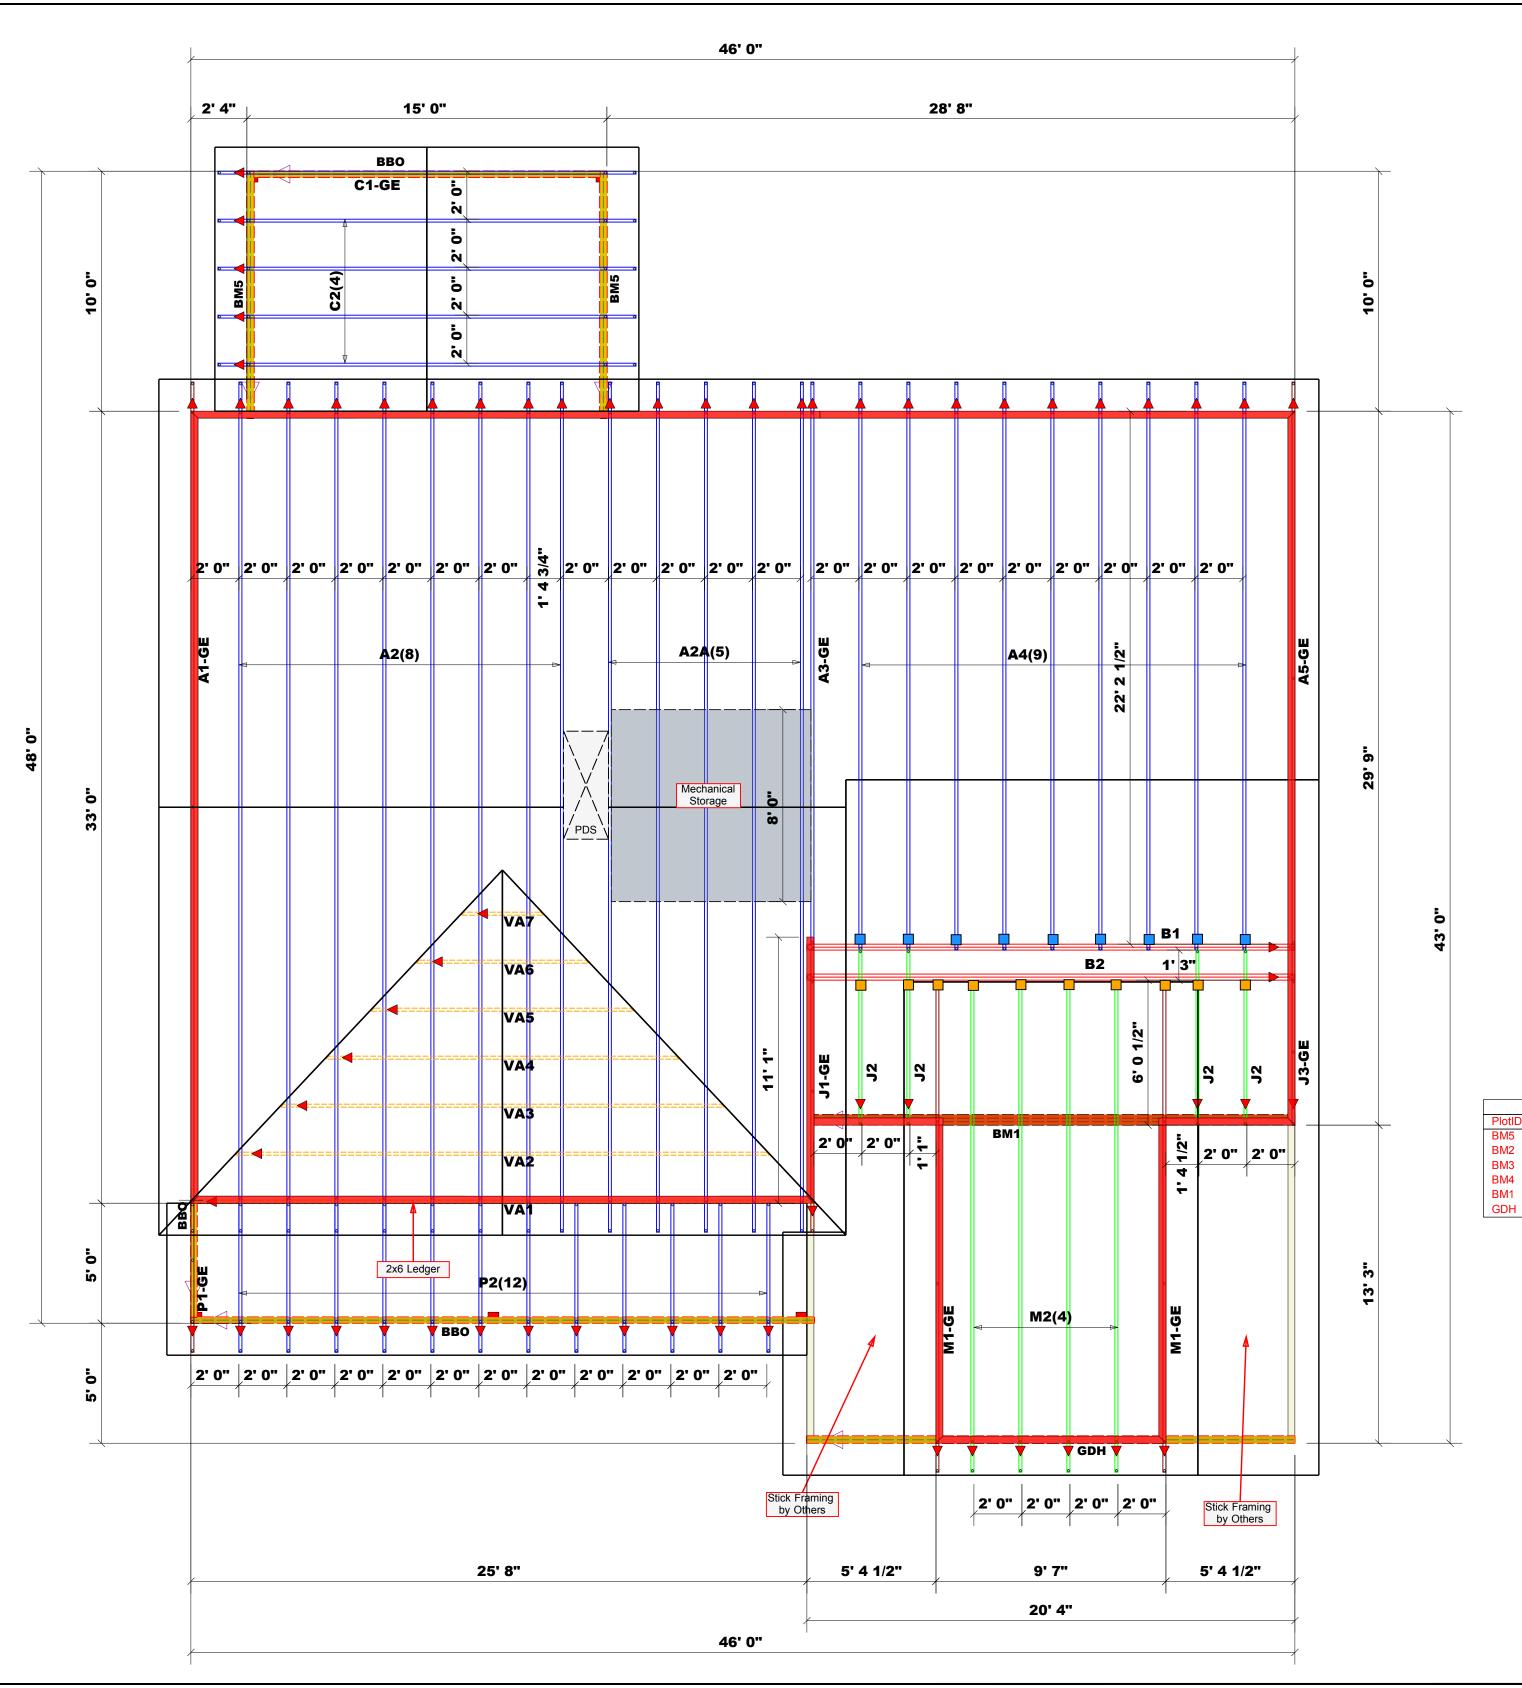



Reilly Road Industrial Parl Fayetteville, N.C. 28309 Phone: (910) 864-8787 Fax: (910) 864-4444

Bearing reactions less than or equal to 3000# are deemed to comply with the prescriptive Code requirements. The contractor shall refer to the attached Tables (derived from the prescriptive Code requirements) to determine the minimum foundation size and number of wood studs required to support reactions greater than 3000# but not greater than 15000#. A registered design professional shall be retained to design the support system for any reaction that exceeds those specified in the attached Tables. A registered design professional shall be retained to design the support system for all reactions that exceed 15000#.

No:I D

Neil Baggett

LOAD CHART FOR JACK STUDS

(BASED ON TABLES R502.5(1) & (b))

| NUMBER OF JACK STUDS REQUIRED @ EA END OF HEADER/GIRDER | | | | | | | | |
|---|-----------------------------------|--|-------------------------|-----------------------------------|--|-------------------------|-----------------------------------|--|
| END REACTION (UP TO) | REQ'D STUDS FOR (2) PLY HEADER | | END REACTION (UP TO) | REQ'D STUDS FOR (3) PLY HEADER | | END REACTION (UP TO) | REQ'D STUDS FOR (4) PLY HEADER | |
| 1700 | 1 | | 2550 | 1 | | 3400 | 1 | |
| 3400 | 2 | | 5100 | 2 | | 6800 | 2 | |
| 5100 | 3 | | 7650 | 3 | | 10200 | 3 | |
| 6800 | 4 | | 10200 | 4 | | 13600 | 4 | |
| 8500 | 5 | | 12750 | 5 | | 17000 | 5 | |
| 10200 | 6 | | 15300 | 6 | | | | |
| 11900 | 7 | | | | | | | |
| 13600 | 8 | | | | | | | |
| 15300 | 9 | | | | | | | |
| | | | | | | | | |

Considered Load Bearing

▲ = Indicates Left End of Truss (Reference Engineered Truss Drawing) Do Not Erect Trusses Backwards

All Walls Shown Are

Dimension Notes

All exterior wall to wall dimensions are to face of stud unless noted otherwise
 All interior wall dimensions are to face of stud unless noted otherwise
 All exterior wall to truss dimensions are to face of stud unless noted otherwise

Roof Area = 2690.59 sq.ft.

Ridge Line = 59.33 ft. Hip Line = 0 ft. Horiz. OH = 182 ft. Raked OH = 320.62 ft. Decking = 92 sheets

Truss Placement Plan
Scale: 1/4"=1'

Plumbing Drop Notes

1. Plumbing drop locations shown are NOT exact.
2. Contractor to verify ALL plumbing drop locations prior to setting Floor Trusses.
3. Adjust spacing as needed not to exceed 24"oc.

| | Conne | Nail Information | | | | |
|-----|---------|------------------|-----|---------------------|------------|------------|
| Sym | Product | Manuf | Qty | Supported Member | Header | Truss |
| | MSH422 | USP | 9 | Varies | 10d/3" | 10d/3" |
| | JUS26 | USP | 10 | Varies | 10d/3" | 10d/3" |
| | HUS26 | USP | 9 | Varies | 16d/3-1/2" | 16d/3-1/2" |

| | | Products | | | |
|--------|--------|----------------------------|-------|---------|----------|
| PlotID | Length | Product | Plies | Net Qty | Fab Type |
| BM5 | 11' 0" | 1-3/4"x 9-1/4" LVL Kerto-S | 2 | 4 | FF |
| BM2 | 7' 0" | 1-3/4"x 9-1/4" LVL Kerto-S | 2 | 2 | FF |
| BM3 | 7' 0" | 1-3/4"x 9-1/4" LVL Kerto-S | 2 | 2 | FF |
| BM4 | 6' 0" | 1-3/4"x 9-1/4" LVL Kerto-S | 2 | 2 | FF |
| BM1 | 21' 0" | 1-3/4"x 14" LVL Kerto-S | 3 | 3 | FF |
| GDH | 21' 0" | 1-3/4"x 16" LVL Kerto-S | 2 | 2 | FF |

| Hatch Legend | | | | |
|--------------|---------------------------------|--|--|--|
| | Mechanical & Light Storage | | | |
| | 2nd Floor Walls @ 8' 1 1/2" UNO | | | |
| | Flush Beam | | | |
| | Drop Beam | | | |
| | | | | |

| / Harnett | S 115 Mahogany Ct., Cameron, | Roof | DATE REV . 1/10/2025 | DRAWN BY Neil Baggett | SALESMAN Neil Baggett | |
|--|-------------------------------------|-----------------------------|-----------------------------|-----------------------|-----------------------|--|
| COUNTY | ADDRESS | MODEL | DATE RE | DRAWN | SALESM | |
| Precision Custom Homes & Renovations | Lot 24 Magnolia Hills | Rothbard 1.0 w/CP (15'X10') | 12/12/2024 | N/A | J1224-6427 | |
| BUILDER | JOB NAME | PLAN | SEAL DATE | QUOTE # | JOB # | |
| THIS IS A TRUSS PLACEMENT DIAGRAM ONLY. These trusses are designed as individual building components to be incorporated into the building design at the specification of the building designer. See individual design sheets for each truss design identified on the placement drawing. The building designer is responsible for temporary and permanent bracing of the roof and floor system and for the overall structure. The design of the truss | | | | | | |

These trusses are designed as individual building components to be incorporated into the building design at the specification of the building designer. See individual design sheets for each truss design identified on the placement drawing. The building designer is responsible for temporary and permanent bracing of the roof and floor system and for the overall structure. The design of the truss support structure including headers, beams, walls, and columns is the responsibility of the building designer. For general guidance regarding bracing, consult BCSI-B1 and BCSI-B3 provided with the truss delivery package or online @ sbcindustry.com

North Carolina 2018 - R402.1.5 Total UA

Property 168 Edes Ct. Cameron, NC 28326 Model: Rothbard

Community: Liberty Meadows

Template - SMG Precision - Liberty Meadows Lot 20 - CZ 4 slab -Liberty Meadows Lot 20 Organization
Southern Energy Manager

Justin Smith

Builder

SMG Precision Properties



This report is based on a proposed design and does not confirm field enforcement of design elements.

Inspection Status

Results are projected

Building UA

| Elements | NC Reference | As Designed |
|---|--------------|-------------|
| Ceilings | 47.3 | 44.9 |
| Above-Grade Walls | 195.7 | 145.3 |
| Windows, Doors and Skylights | 126.2 | 113.8 |
| Slab Floor: | 76.4 | 99.6 |
| Framed Floors | 13.5 | 14.7 |
| Foundation Walls | 0.0 | 0.0 |
| Rim Joists | 8.8 | 7.1 |
| Overall UA (Design must be equal or lower): | 467.9 | 425.4 |

Requirements

| 402.1.5 | Total UA alternative compliance passes by 9.1%. | |
|---------------------|---|---|
| 402.3.2 | Average SHGC: 0.28 Max SHGC: 0.30 | |
| R402.4.2.2 | Air Leakage Testing | Air sealing is 4.80 ACH at 50 Pa. It must not exceed 5.00 ACH at 50 Pa. |
| R402.5 | Area-weighted average fenestration SHGC | |
| R402.5 | Area-weighted average fenestration U-Factor | |
| R404.1 | Lighting Equipment Efficiency | |
| Mandatory Checklist | Mandatory code requirements that are not checked by Ekotrope must be met. | |
| R403.3.1 | Duct Insulation | |
| 403.3.3 | Duct Testing | |

Design exceeds requirements for North Carolina 2018 Prescriptive compliance by 9.1%.

| Name: | Justin Smith | Signature: | Justin Smith |
|---------------|----------------------------|-------------------|--------------------|
| Organization: | Southern Energy Management | Digitally signed: | 9/2/22 at 12:56 PM |

Property 168 Edes Ct. Cameron, NC 28326 Model: Rothbard Community: Liberty Meadows

Template - SMG Precision - Liberty Meadows Lot 20 - CZ 4 slab - ecoSelect Liberty Meadows Lot 20

Organization Southern Energy Manag

Southern Energy Management Justin Smith

Inspection Status

Results are projected

Builder

SMG Precision Properties



| General Building Informati | ion |
|----------------------------------|------------------------|
| Number Of Bedrooms | 4 |
| Number Of Floors | 2 |
| Conditioned Floor Area [sq. ft.] | 2,455 |
| Has Electric Vehicle Ready Space | No |
| Unconditioned, attached garage? | Yes |
| Conditioned Volume [cu. ft.] | 25,604 |
| Total Units in Building | 1 |
| Residence Type | Single family detached |
| Number of Floors in Building | - |
| Floor Number | - |
| Model | Rothbard |
| Community | Liberty Meadows |
| RESNET/IECC 2006 Climate Zone | 4A |
| IECC 2021 Climate Zone | 3A |

Foundation Wall

None Present

Foundation Wall Library List

None Present

| Slab | | | | | | | | | |
|------|------|--------------|-----------|-------------|----------|-------------------------|--------------|------------------|----------------------|
| | Name | Library Type | Perimeter | Floor Grade | Carpet R | Exposed Masonry Area | Surface Area | Location | Enclosing |
| | slab | Uninsulated | 158 | On Grade | 1 | 0 | 1,290.0 ft² | Exposed Exterior | Conditioned Space |

| Slab Library | List | | | | | | |
|--------------|---------------------------|-------------------------------|------------------------------------|------------------------------------|---------------------------------|---------------|-------------------|
| Name | Wall Construction Type | Slab Completely Insulated? | Underslab Insulation Width [ft] | Perimeter Insulation Depth [ft] | Perimeter Insulation R Value | Thermal Break | Effective R-value |
| Uninsulated | Wood Frame / Other | No | 0 | 0 | 0 | No | 0.00 |

Property 168 Edes Ct. Cameron, NC 28326 Model: Rothbard Community: Liberty Meadows

Liberty Meadows Lot 20

Community: Liberty Meadows

Template - SMG Precision - Liberty Meadows Lot 20
- CZ 4 slab - ecoSelect

Organization Southern Energy Management Justin Smith

Builder SMG Precision Properties Inspection Status Results are projected



| | Framed Floo | r | | | | |
|---|-------------|-----------------------|----------|-------------|--------------|--------------------------------|
| | Name | Library Type | Carpet R | Floor Grade | Surface Area | Location |
| ı | | | | | | |
| ı | over garage | R 19, 16"OC G1 Carpet | 0 | Above Grade | 287.0 ft² | Unconditioned, attached garage |

| Framed Floo | or Library List | : |
|-------------|-----------------|-------------------|
| | Name | Effective R-value |
| R 19, 16"OC | G1 Carpet | 19.566 |

| Rim Joist | | | |
|-------------------|----------------|--------------|--------------------------------|
| Name | Library Type | Surface Area | Location |
| 1st floor ambient | R 19 G1, 16"OC | 126.0 ft² | Exposed Exterior |
| 1st floor garage | R 19 G1, 16"OC | 32.0 ft² | Unconditioned, attached garage |

| Rim Joist Library List | | | |
|------------------------|------------------------------|--|--|
| Name | Effective Insulation R-value | | |
| R 19 G1, 16"OC | 17.30 | | |

| Name | Library Type | Surface Color | Surface Area | Locatio |
|-------------------|------------------------------|---------------|--------------|--------------------------------|
| | | | | |
| 1st floor ambient | R 19 Adv. Framing G1 16" O.C | Medium | 1,135.0 ft² | Exposed Exterio |
| 1st floor garage | R 19 Adv. Framing G1 16" O.C | Medium | 287.0 ft² | Unconditioned, attached garage |
| | - | | | |
| 2nd floor ambient | R 19 Adv. Framing G1 16" O.C | Medium | 1,158.0 ft² | Exposed Exterior |
| 2nd floor attic | R 19 Adv. Framing G1 16" O.C | Medium | 322.0 ft² | Atti |

Property 168 Edes Ct. Cameron, NC 28326 Model: Rothbard Community: Liberty Meadows

Template - SMG Precision - Liberty Meadows Lot 20 - CZ 4 slab - ecoSelect Liberty Meadows Lot 20

Organization Southern Energy Management Justin Smith

Builder SMG Precision Properties Inspection Status Results are projected



| Wall Library List | | |
|------------------------------|-------------------|--|
| Name | Effective R-value | |
| | | |
| R 19 Adv. Framing G1 16" O.C | 17.492 | |

| Glazing | | | | | | | | | |
|--------------------|--------------|----------------------|----------------------------------|-------------|-------------------|-------------------------|--------------------------|-------------|--------------|
| Name | Library Type | Wall Assignment | Foundation Wall Assignment | is Operable | Overhang Depth | Overhang Ft To 0 Top | Overhang Ft To Bottom | Orientation | Surface Area |
| front 2nd unshaded | 33/28 | 2nd floor ambient | | Yes | 0 | 0 | 0 | West | 81.0 ft² |
| front shaded | 33/28 | 1st floor ambient | | Yes | 5 | 1 | 6 | West | 27.0 ft² |
| left 2nd unshaded | 33/28 | 2nd floor ambient | | Yes | 0 | 0 | 0 | North | 27.0 ft² |
| left unshaded | 33/28 | 1st floor ambient | | Yes | 0 | 0 | 0 | North | 27.0 ft² |
| rear 2nd unshaded | 33/28 | 2nd floor ambient | | Yes | 0 | 0 | 0 | East | 54.5 ft² |
| rear shaded | 33/28 | 1st floor ambient | | Yes | 10 | 2 | 9 | East | 40.2 ft² |
| rear unshaded | 33/28 | 1st floor ambient | | Yes | 0 | 0 | 0 | East | 29.5 ft² |
| right 2nd unshaded | 33/28 | 2nd floor ambient | | Yes | 0 | 0 | 0 | South | 34.5 ft² |

| Glazing Library List | | | | | |
|----------------------|------|----------|--|--|--|
| Name | Shgc | U-factor | | | |
| 33/28 | 0.28 | 0.330 | | | |

| Skylight | | |
|----------|--------------|--|
| | None Present | |
| | | |
| | | |

None Present

Property 168 Edes Ct. Cameron, NC 28326 Model: Rothbard Community: Liberty Meadows

Organization Southern Energy Management Justin Smith

Builder

SMG Precision Properties

Inspection Status Results are projected



Template - SMG Precision - Liberty Meadows Lot 20 - CZ 4 slab - ecoSelect Liberty Meadows Lot 20

| Opaque Doo | r | | | | | | | |
|--------------|----------------|-------------------|-------------------------------|-----|----------------------|--------|--------------|--------------------------------|
| Name | Library Type | Wall Assignment | Foundation Wall Assignment | | Solar Absorptance | | Surface Area | Location |
| front entry | Fiberglass R-5 | 1st floor ambient | | 0.9 | 0.75 | Medium | 20.0 ft² | Exposed Exterior |
| garage entry | Fiberglass R-5 | 1st floor garage | | 0.9 | 0.75 | Medium | 20.0 ft² | Unconditioned, attached garage |

Opaque Door Library List Effective U-factor Fiberglass R-5 0.200

| Roof Insulation | on | | | | | |
|-----------------|--|---------------------------|--------------------------------|---------------|--------------|----------|
| Name | Library Type | Attic Exterior Area [ft²] | Clay or Concrete Roof Tiles | Surface Color | Surface Area | Location |
| attic | R 38 Attic BLOWN FG G1 2x10 24"OC NO Padiant Barrier | 2,318.19 | No | Dark | 1,577.0 ft² | Attic |

| Roof Insulati | on Library List | |
|---|---------------------|-------------------|
| Name | Has Radiant Barrier | Effective R-value |
| R 38 Attic BLOWN FG G1 2x10 24"OC NO | No | 35.115 |

| Whole House | Infiltration | | |
|-------------------|--------------------|---------------|--|
| Infiltration | Measurement Type | Shelter Class | |
| 2048 CFM at 50 Pa | Blower-door tested | 4 | |

Mechanical Ventilation

None Present

Property 168 Edes Ct. Cameron, NC 28326 Model: Rothbard Community: Liberty Meadows

Template - SMG Precision - Liberty Meadows Lot 20 - CZ 4 slab - ecoSelect Liberty Meadows Lot 20

OrganizationSouthern Energy Management
Justin Smith

Builder





| _ | iberty ineadows Lot 20 | | | | | |
|---|--|-------------------------|------------------------------------|-------------------------|----------------------------------|-----------------------|
| | Lighting % Interior Fluorescent Lighting | % Interior LED Lighting | % Exterior Fluorescent Lighting | % Exterior LED Lighting | % Garage Fluorescent Lighting | % Garage LED Lighting |
| | 0 | 90 | 0 | 0 | 0 | 0 |
| | Onsite Genera | | one Present | | | |
| | | | | | | |
| | Onsite Genera | ation Library List | | | | |
| | | No | one Present | | | |
| | Solar Generat | tion | | | | |
| | | No | one Present | | | |
| | Dehumidifier | | | | | |
| | | No | one Present | | | |
| | Dehumidifier | Library List | | | | |
| | | No | one Present | | | |
| | Whole House | Fan | | | | |
| | | No | one Present | | | |

Property 168 Edes Ct. Cameron, NC 28326 Model: Rothbard Community: Liberty Meadows

Template - SMG Precision - Liberty Meadows Lot 20 - CZ 4 slab - ecoSelect Liberty Meadows Lot 20

Organization Southern Energy Management Justin Smith

Builder

SMG Precision Properties



Whole House Fan Library List

None Present

| Conditioning | Equipment | | | | | |
|---------------------|------------------------|---------------|----------------------|----------------------|---------------------------|----------------------|
| Name | Library Type | Serial Number | Heating Percent Load | Cooling Percent Load | Hot Water Percent Load | |
| 1st floor heat pump | z 24k 14 SEER 8.0hspf | | 52% | 52% | 0% | Attic |
| 2nd floor heat pump | z 24k 14 SEER 8.0hspf | | 48% | 48% | 0% | Attic |
| Water Heating | z 50 gal. 0.95 EF Elec | | 0% | 0% | 100% | Unconditioned Garage |

Inspection Status

Results are projected

| Equipment Type: z 24k 14 SEER 8.0hspf | | | | |
|---------------------------------------|----------------------|--|--|--|
| Equipment Type | Air Source Heat Pump | | | |
| Fuel Type | Electric | | | |
| Distribution Type | Forced Air | | | |
| Motor Type | PSC (Single Speed) | | | |
| Heating Efficiency | 8 HSPF | | | |
| Heating Capacity [kBtu/h] | 24 | | | |
| Backup Fuel Type | Electric | | | |
| Switchover Temperature [°F] | 0 | | | |
| Backup Heating Efficiency | 1 COP | | | |
| Use default Supplemental Heat | Yes | | | |
| Cooling Efficiency | 14 SEER | | | |
| Cooling Capacity [kBtu/h] | 24 | | | |

| Equipment Type: z 24k 14 SEER 8.0hspf | | | | |
|---------------------------------------|----------------------|--|--|--|
| Equipment Type | Air Source Heat Pump | | | |
| Fuel Type | Electric | | | |
| Distribution Type | Forced Air | | | |
| Motor Type | PSC (Single Speed) | | | |
| Heating Efficiency | 8 HSPF | | | |
| Heating Capacity [kBtu/h] | 24 | | | |
| Backup Fuel Type | Electric | | | |
| Switchover Temperature [°F] | 0 | | | |
| Backup Heating Efficiency | 1 COP | | | |
| Use default Supplemental Heat | Yes | | | |
| Cooling Efficiency | 14 SEER | | | |
| Cooling Capacity [kBtu/h] | 24 | | | |

Property 168 Edes Ct. Cameron, NC 28326 Model: Rothbard Community: Liberty Meadows

Template - SMG Precision - Liberty Meadows Lot 20 - CZ 4 slab - ecoSelect Liberty Meadows Lot 20

Organization Southern Energy Management

Justin Smith

Builder





| Equipment Type: z 50 gal. 0.95 EF Elec | | | | |
|--|-----------------------------|--|--|--|
| Equipment Type | Residential Water Heater | | | |
| Fuel Type | Electric | | | |
| Distribution Type | Hydronic Delivery (Radiant) | | | |
| Hot Water Efficiency | 0.95 Energy Factor | | | |
| Tank Capacity (gal.) | 50 | | | |
| Hot Water Capacity [kBtu/h] | 40 | | | |
| Recovery Efficiency | 0.98 | | | |

| D: (!! (! 0 (| |
|------------------------------------|--------------------------------|
| Distribution System | |
| Distribution Type | Forced Air |
| Heating Equipment | 1st floor heat pump |
| Cooling Equipment | 1st floor heat pump |
| Sq. Feet Served | 1,290 |
| # Return Grilles | 2 |
| Supply Duct R Value | 8 |
| Return Duct R Value | 8 |
| Supply Duct Area [ft²] | 348.3 |
| Return Duct Area [ft²] | 129 |
| Leakage to Outdoors | 51 CFM @ 25Pa (3.95 / 100 ft²) |
| Total Leakage | 51 CFM25 |
| Total Leakage Duct Test Conditions | Post-Construction |
| Use Default Flow Rate | Yes |
| Duct 1 | |
| Duct Location | Attic (well vented) |
| Percent Supply Area | 70 |
| Percent Return Area | 70 |
| Duct 2 | |
| Duct Location | Conditioned Space |
| Percent Supply Area | 30 |
| Percent Return Area | 30 |
| Duct 3 | |
| Duct Location | Conditioned Space |
| Percent Supply Area | 0 |
| Percent Return Area | 0 |
| Duct 4 | |
| Duct Location | Conditioned Space |
| Percent Supply Area | 0 |
| Percent Return Area | 0 |
| Duct 5 | |
| Duct Location | Conditioned Space |
| Percent Supply Area | 0 |
| Percent Return Area | 0 |
| Duct 6 | |
| Duct Location | Conditioned Space |
| Percent Supply Area | 0 |
| Percent Return Area | 0 |
| | - |

Property 168 Edes Ct. Cameron, NC 28326 Model: Rothbard Community: Liberty Meadows

Template - SMG Precision - Liberty Meadows Lot 20 - CZ 4 slab - ecoSelect Liberty Meadows Lot 20

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| 2: 12: E = T | E 14: |
|------------------------------------|--------------------------------|
| Distribution Type | Forced Air |
| Heating Equipment | 2nd floor heat pump |
| Cooling Equipment | 2nd floor heat pump |
| Sq. Feet Served | 1,165 |
| # Return Grilles | 2 |
| Supply Duct R Value | 8 |
| Return Duct R Value | 8 |
| Supply Duct Area [ft²] | 314.55 |
| Return Duct Area [ft²] | 116.5 |
| _eakage to Outdoors | 46 CFM @ 25Pa (3.95 / 100 ft²) |
| Total Leakage | 46 CFM25 |
| Total Leakage Duct Test Conditions | Post-Construction |
| Jse Default Flow Rate | Yes |
| Duct 1 | |
| Duct Location | Attic (well vented) |
| Percent Supply Area | 100 |
| Percent Return Area | 100 |
| Duct 2 | |
| Duct Location | Conditioned Space |
| Percent Supply Area | 0 |
| Percent Return Area | 0 |
| Duct 3 | |
| Duct Location | Conditioned Space |
| Percent Supply Area | 0 |
| Percent Return Area | 0 |
| Duct 4 | |
| Duct Location | Conditioned Space |
| Percent Supply Area | 0 |
| Percent Return Area | 0 |
| Duct 5 | |
| Duct Location | Conditioned Space |
| Percent Supply Area | 0 |
| Percent Return Area | 0 |
| Duct 6 | |
| Duct Location | Conditioned Space |
| Percent Supply Area | 0 |
| Percent Return Area | 0 |

| HVAC Grading | |
|----------------------------|--|
| HVAC Grading Not Conducted | |

| Ceiling Fan | | |
|-----------------|-----|--|
| Has Ceiling Fan | No | |
| Cfm Per Watt | 100 | |

Property 168 Edes Ct. Cameron, NC 28326 Model: Rothbard Community: Liberty Meadows

Template - SMG Precision - Liberty Meadows Lot 20 - CZ 4 slab - ecoSelect Liberty Meadows Lot 20

Organization

Southern Energy Management Justin Smith

Inspection Status

Results are projected

Builder



| Water Distribution | |
|--|----------|
| Water Fixture Type | Low-flow |
| Use Default Hot Water Pipe Length | No |
| Hot Water Pipe Length [ft] | 79 |
| At Least R3 Pipe Insulation? | No |
| Hot Water Recirculation System? | No |
| Recirculation System Pipe Loop Length [ft] | 20 |
| Drain Water Heat Recovery? | No |

| Clothes Dryer | |
|------------------------------|----------------|
| Cef | 3.01 |
| Fuel Type | Electric |
| Field Utilization | Timer Controls |
| Is Outside Conditioned Space | No |
| Clothes Dryer Available | Yes |
| Defaults Type | HERS Reference |

| Clothes Washer | |
|------------------------------|--------------|
| Label Energy Rating | 153 kWh/Year |
| Annual Gas Cost | \$12.00 |
| Electric Rate | \$0.11/kWh |
| Gas Rate | \$1.22/Therm |
| Capacity | 3.31 |
| Imef | 2.1547 |
| Defaults Type | Custom |
| Load Type | Front-load |
| Loads Per Week | 6 |
| Is Outside Conditioned Space | No |
| Clothes Washer Available | Yes |

| Dishwasher | |
|------------------------------|--------------|
| Dishwasher Efficiency | 270 kWh |
| Dishwasher Size | Standard |
| Annual Gas Cost | \$22.23 |
| Electric Rate | \$0.12/kWh |
| Gas Rate | \$1.09/Therm |
| Is Outside Conditioned Space | No |

Property 168 Edes Ct. Cameron, NC 28326 Model: Rothbard Community: Liberty Meadows

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Template - SMG Precision - Liberty Meadows Lot 20 - CZ 4 slab - ecoSelect Liberty Meadows Lot 20

Organization

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Inspection Status

Results are projected

Builder

SMG Precision Properties



| Appliances and Controls | |
|---|--------------|
| Thermostat Cooling Setpoint | * * * * 75.0 |
| Thermostat Heating Setpoint | * * * * 70.0 |
| Range/Oven Fuel | Electric |
| Convection Oven? | No |
| Induction Range? | No |
| Range/Oven Outside Conditioned Space? | No |
| Refrigerator Consumption | 538 kWh/Year |
| Refrigerator Outside Conditioned Space? | No |

Notes

Initial Inputs _____JS 09/02/22_____

- -confirm HVAC specs
- -confirm water heater specs
- -confirm ventilation entry
- -modeled to worst case orientation
- -confirm cfl lighting %