SANDY LANE **ABBREVIATIONS** A A PRESSURE TREATED WD H.R. HALF ROUN HWD HARDWOOD (FL R&M RANGE W/MICROWAY LIV LIVING LTL LINTEL LVR LOUVER MAX MAXIMUM DRY DRYER MACHINE TEMP TEMPERED (GLASS U.N.O. OTHERWISE OA F.F. FINISH FLOOR (LINE OBS OBSCURE (GLA WH WATER HEATER FLR FLOOR(ING FP FIREPLACE OPT OPTIONAL WIC WALK-IN CLOSE FURRED(ING) PEDESTAL (SINK) W/ W/O WITH or WITHOUT ROHND FAIL TERPROOF(ING) CIRCUIT INTERRU

GENERAL NOTES

1 - GENERAL BUILDING & DESIGN REQUIREMENTS

1) THE ATTACHED PLANS & SPECIFICATIONS ARE THE SOLE PROPERTY OF TRI POINTE HOMES ANY UNAUTHORIZED USE OF THESE PLANS WITHOUT PRIOR WRITTEN CONSENT OF TRI POINTE HOMES IS STRICTLY

2) TRI POINTE HOMES DESIGNS & BUILDS HOUSING AS SET FORTH BY THE FORMAT AND PROVISIONS OF TH INTERNATIONAL RESIDENTIAL CODE (IRC), AND THE NATIONAL ELECTRIC CODE (NEC). ANY NON-CONFORMING DOCUMENTS DISCOVERED BY THE CONTRACTOR OR HIS AGENTS SHALL BE CALLED TO THE IMMEDIATE TTENTION OF TRI POINTE HOMES BY CALLING (469)329-0470.

). THESE PLANS ARE SUBJECT TO MODIFICATIONS TO MEET CODE REQUIREMENTS AND/OR TO FACILITATE MECHANICAL/ ELECTRICAL/ PLUMBING INSTALLATION AND/ OR TO IMPLEMENT DESIGN IMPROVEMENTS. ANY

INTENTION TO MODIFY THESE PLANS MUST BE APPROVED IN WRITING BY TRI POINTE HOMES
4) CONTRACTOR SHALL BE RESPONSIBLE FOR VERIFYING ALL DIMENSIONS AFFECTING CONTRACTOR'S PRODUCTS, INSTALLATIONS, OR FABRICATIONS IN THE FIELD PRIOR TO EXPEDITING THE CONSTRUCTION OF SUCH WORK. FIELD VERIFY ALL DIMENSIONS — DO NOT SCALE DRAWINGS! CONTRACTOR IS RESPONSIBLE FOR SURVEYING THE PROJECT AND BECOMING FAMILIAR WITH THE EXISTING CONDITIONS AND SCOPE OF WORK INCLUDING BUT NOT LIMITED TO SITE AND SOIL BEARING CONDITIONS.
5) ERRORS AND OMISSIONS WHICH MAY OCCUR IN THE CONTRACT DOCUMENTS SHALL BE BROUGHT TO THE

ATTENTION OF THE ARCHITECT, IN WRITING, AND WRITTEN INSTRUCTION SHALL BE OBTAINED PRIOR TO PROCEEDING WITH CONSTRUCTION. THE CONTRACTOR SHALL BE HELD RESPONSIBLE FOR ANY ERRORS, DISCREPANCIES, OR OMISSIONS FOR WHICH THE CONTRACTOR FAILED TO NOTIFY THE ARCHITECT PRIOR TO

2 - SITE CONSTRUCTION

BACK FILL SHALL BE FREE FROM VEGETATION AND CONSTRUCTION DEBRIS

) BACK FILL SHALL BE PLACED IN LIFTS AND COMPACTED IN SUCH A MANNER AS BACKFILL TO NOT DAM. THE FOUNDATION WALLS OR ANY WATERPROOFING/ DAMPPROOFING MATERIALS.

3 - CONCRETE

1) SLOPE ON GARAGE SLAB SHALL BE 1/8" PER FOOT TOWARDS VEHICLE DOOR. SLOPE ON PORCH AND

4 - MASONRY

ALL EXTERIOR BRICK MUST MEET ASTM C-216 FOR "SW" CONDITIONS

) MASONRY VENEER SHALL BE ATTACHED TO SUPPORTING WALLS w/ CORRUGATED METAL TIES IN CCORDANCE WITH R703.7.4.1 - I.R.C. OR LOCAL CODE REQUIREMENTS

) WEEPHOLES SHALL BE PROVIDED ALONG THE OUTSIDE WYTHE OF EXTERIOR MASONRY WALLS AT 33" O.C. MAX, SHALL BE A MIN. OF 3/16" IN DIAMETER, AND LOCATED IMMEDIATELY ABOVE THE FLASHING PER 18703.7.6 – LR.C.

5 - METALS

6 - WOOD AND PLASTICS

7 - THERMAL & MOISTURE PROTECTION) Fire stopping and/ or draft stopping shall meet the requirements of IRC R602.8. 2) Attic ventilation shall be provided at 1/300 th of the Area of the Space ventilated. Cross VANILATION WITH HALF OF THE VENTILATED AREA SHALL BE PROVIDED BY ROOF VENTS AND THE OTHER HALF BY SOFFIT VENTS. VENTS SHALL BE PLACED SO AS TO NOT ALLOW INFILTRATION OF RAIN OR SNOW.) PROVIDE APPROVED TILE BACKER DRYWALL FOR ALL SHOWER AND BATH SPACE

8 - DOORS AND WINDOWS

) PROVIDE ATTIC VENTILATION PER IRC-R806.1

-) REVIEW ALL WINDOW HDR HEIGHTS PER PLATE HT. AND VERIFY W/ ELEVATIONS AND CORNICE DETAILS TEMPERED GLASS SHALL BE USED IN HAZARDOUS AREAS AS DESCRIBED IN SECTION R308.4 - LR.C.
- FRONT DOOR WIDTH PER IRC-R311.3
- GARAGE DOOR PER IRC-R309.1

FMERGENCY EGRESS SHALL MEET REQUIREMENTS OF SECTION R310 - LR C 2018 - SLEEPING ROOMS HALL HAVE AT LEAST ONE EGRESS OPENING OF NOT LESS THAN 5.7 SF AND A CLEAR OPENING OF NOT IFSS THAN 20" WIDE X 24" HIGH AND SHALL NOT BE MORE THAN 44" ABOVE THE FLOOR

15 - MECHANICALS

WOOD BUILT CHIMNEYS AND FIREPLACES SHALL BE INSTALLED PER MANUFACTURER'S INSTRUCTIONS AND RE SUBJECT TO MECHANICAL INSPECTION PER IRC SECTION R1002.1) EXTERIOR AIR INTAKE FOR COMBUSTION AIR PER IRC SECTION AS REQUIRED BY LOCAL MUNICIPALITY

16 - ELECTRICAL

ALL FLECTRICAL INSTALLATION SHALL MEET THE REQUIREMENTS OF THE NATIONAL ELECTRIC CODE (NEC). MATERIAL AND EQUIPMENT SHALL BEAR THE LABEL OF APPROVAL OF THE UNDERWRITERS ABORATORIES, INC.

) ELECTRICAL CONTRACTOR SHALL VERIFY SPACE REQUIRED FOR METER INSTALLATION BEFORE ONSTRUCTION AND SHALL NOTIFY GENERAL CONTRACTOR OF ANY DISCREPANCIES.

VERIFY LOCATION OF ALL RECEPTACLES FOR APPLIANCES WITH MANUFACTURER SPECIFICATIONS.

GROUND FAULT INTERRUPTS SHALL BE LOCATED PER THE NEC

ALL SWITCHES SHALL BE INSTALLED AT 3'-6" ABOVE FINISHED FLOOR TO CENTERLINE OF SWITCH VLESS NOTED OTHERWISE) ALL CONVENIENCE OUTLETS SHALL BE INSTALLED W/ CENTERLINE OF OUTLET LOCATED 1'-3" ABOVE

INISHED FLOOR UNLESS NOTED OTHERWISE

ALL CONVENIENCE OUTLETS WITH SWITCHES TO BE SWITCH AT TOP ONLY.

ALL EXTERIOR WALL BRACKET FIXTURES SHALL BE INSTALLED AS NOTED ON PLANS.

APPROVED SMOKE DETECTORS SHALL BE LOCATED ON EVERY STORY OF THE DWELLING UNIT AS PER IRC CTION R317 (SEE SHEET B1.1 FOR LOCATIONS). WHERE MORE THAN ONE DETECTOR IS REQUIRED THEY SHALL BE INTERCONNECTED. POWER SOURCE SHALL BE BUILDING POWER w/ BATTERY BACKUP.)) CONDUCTORS SHALL BE OF COPPER.

GENERAL FRAMING SPECS AND CONSTRUCTION NOTES STAIRS:

) THE MAXIMUM RISER HEIGHT SHALL BE 7 3/4 INCHES AND THE MINIMUM TREAD DEPTH SHALL BE 10 CHES IN ACCORDANCE WITH SECTION I.R.C.

HANDRAILS HAVING MINIMUM AND MAXIMUM HEIGHTS OF 34 INCHES AND 38 INCHES SHALL BE OVIDED ON AT LEAST. ONE SIDE OF STAIRWAYS IN ACCORDANCE WITH SECTION R315.1 — I.R.C HANDRAIL AND BALUSTRADE (WHERE PRESENT) SHALL BE CONSTRUCTED. ACCORDING TO IRC. ALL REQUIRED HAND RAILS SHALL BE CONTINUOUS THE FULL LENGTH OF THE STAIRS W/ 2 OR MORE SERS FROM A POINT ABOVE THE THE TOP RISER OF A FLIGHT TO A POINT ABOVE THE LÓWEST RISER OF THE FLIGHT. ENDS SHALL BE RETURNED OR SHALL TERMINATE AT NEWEL POSTS OR SAFETY TERMINALS. ANDRAILS ADJACENT TO A WALL SHALL HAVE A SPACE OF NOT LESS THAN 1.5" BETWEEN THE WALL

WALLS:

) ALL DIMENSIONS ARE FROM FACE OF STUD TO FACE OF STUD. ALL STUDS ARE 3 1/2" UNLESS NOTED. LL DIMENSIONS PRESENTED HERE ARE FRAME DIMENSIONS ONLY.

I SEPARATION BETWEEN THE RESIDENCE AND THE GARAGE SHALL BE MAINTAINED BY INSTALLATION OF $rac{1}{2}"$ GYPSUM BOARD ON ALL COMMON WALLS. 2-STORY HOMES REQUIRE 5/8" TYPE X GYPSUM BOARD AT CARAGE CEILINGS WHERE HABITABLE ROOMS ARE PRESENT ABOVE.

FLOORS:

STRUCTURAL FLOOR MEMBERS SHALL NOT BE CUT, BORED, OR NOTCHED IN EXCESS OF THE LIMITATIONS ECIFIED IN IRC

) THE ENDS OF EACH JOIST, BEAM, OR GIRDER SHALL HAVE NOT LESS THAN 1.5 INCHES OF BEARING ON WOOD OR METAL AND NOT LESS THAN 3 INCHES ON MASONRY OR CONCRETE OR AS OTHERWISE SPECIFIED

) ALL DIMENSIONAL FLOOR JOISTS TO BE PER ENGINEER STRUCTURAL PLANS.

FRAMING:

ALL FRAMING DIMENSIONS TO FACE OF MEMBER.

ALL BEARING HEADERS TO BE PER ENGINEERING PLANS. FIRE STOPPING AND / OR DRAFT STOPPING SHALL MEET THE REQUIREMENTS OF IRC R602.8.

ROOF

HIP AND VALLEY RAFTERS SHALL BE SUPPORTED AT RIDGE DOWN TO BEARING PARTITION. CUT ENDS OF AFTERS SHALL BE FULLY SUPPORTED WALL AND RIDGE

REQUIRED VENTILATION AREAS CALCULATED AT 1/300 RATIO

SQUARE FOOTAGE

Elevation "C"

(Slab S.F.)	
Slab Area	Sq. Ft
FIRST FLOOR	2075
2 BAY GARAGE	428
PORCH	155
COVERED OUTDOOR LIVING	156
Total Slab Area	2814

(Outside of Frame S.F.)		
A/C Area	Sq. Ft.	
FIRST FLOOR	2075	
Total A/C Area	2015	
Non-A/C Area	Sq. Ft.	
2 BAY GARAGE	428	
PORCH	155	
COVERED OUTDOOR LIVING	156	
Total Nov. A/O Aven	494	

(Inside of Frame S.F.)

Total A/C Area	2012
FIRST FLOOR	2012
A/C Area	Sq. Ft.

NOTE: ALL OPTIONAL SQUARE FOOTAGES LISTED ARE INDEPENDENT OF AND IN ADDITION TO BASE SQUARE FOOTAGES

	OPTIONS	
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BUILDING CODE COMPLIANCE

LECTRICAL PLANS DESIGNED TO MEET OR EXCEED MINIMUM

CONSTRUCTION PLANS DESIGNED TO MEET OR EXCEED

MINIMUM CODE REQUIREMENTS OF 2018 LR (

TABLE OF CONTENTS

	SHEET LEGEND		
SHEET NO.	TYPE OF SHEET/LAYOUT		
"G0.01"	COVER SHEET & GEN. NOTES		
"G0.11"	REVISIONS & SYMBOLS		
"S1.10C"	BASE FOUNDATION PLAN - ELEVATION 'C'		
"A1.10C"	FIRST FLOOR PLAN - ELEVATION 'C'		
"01.A10"	FLOOR PLAN OPTIONS		
"01.A20"	FLOOR PLAN OPTIONS		
"01.A30"	2ND FLOOR PLAN OPTION		
"A2.01C"	EXTERIOR ELEVATIONS - 'C'		
"A2.02C"	EXTERIOR ELEVATIONS - 'C'		
"A3.01C"	ROOF PLAN — ELEVATION 'C'		
"A4.01"	INTERIOR DETAIL SHEET		
"E1.10C"	1ST FLR. ELECTRICAL PLAN — ELEVATION 'C'		
"E1.11C"	1ST FLR. ELECTRICAL PLAN UPGRADE OPTIONS - ELEVATION 'C'		
"01.E10"	1ST FLR. ELECTRICAL PLAN OPTIONS		
"01.E11"	1ST FLR. ELECTRICAL PLAN UPGRADE OPTIONS		
"01.E20"	"01.E20" 2ND FLR. ELECTRICAL PLAN OPTION		
"01.E21"	2ND FLR. ELECTRICAL PLAN UPGRADE OPTION		

Serenity - Lot 279 - 5920-06 (Sandy Lane) - Elevation C(R)

*Optional Loft

*Gourmet Kitchen I

*Prep Zone ILO Pantry

*Great Room Fireplace

*Great Room Tray Ceiling

*Sliding Glass Door 9080 at Great Room

*Sliding Glass Door 9080 at Dining Room

*Primary Suite Tray Ceiling

*Primary Bath 2 w/ Shower Seat and Tub

*Bath 2 Shower ILO Tub

*Optional Door to Laundry

*Outdoor Fireplace

*Open Rail Stairs

SYMBOLS PLYWOOD ELEVATION KEY OR SECTION KEY TUB/SHOWER INSULATING SHEATHING CENTERI INF BATT INSULATION CEILING TRANSITION LINE LAVATOR' HOSE BIB (FREEZE PROOF) DBL SINK CONCRETE GAS LINE STUB TOWEL BAR SAND OR GRAVEL LAUNDRY SINK PAPER HOLDER STONE TOWEL RING 2x FRAME PEDESTAL SINK SHOWER HEAD BRICK VENEER WATER CLOSET ++SHOWER CONTROLS STONE VENEER

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Blvd Business Operation 5440 Wade Park Blv Suite 400 Raleigh, NC 27607

NOTES SERENITY GENERAL @ SEF XING ALTIS ઝ

> SUBDIVISION: ADDRESS: LOT: 279

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11-17-24 Issue Date: ACC

5920-06

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REL. #	DESCRIPTION		DATE	DRAWN E	
5920-06	NEW PLAN		10/01/2024	ACC	
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Business Operations 5440 Wade Park Blvd Suite 400 Raleigh, NC 27607

SUBDIVISIONS & SYMBOLS
SUBDIVISION: ALTIS ® SERENITY
ADDRESS: 68 SERENE XING
LOT: 279 BLOCK:


Issue Date: 11-17-24

Drawn By: ACC

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Business Operations 5440 Wade Park Blvd Suite 400 Raleigh, NC 27607

SUBDIVISION: ALTIS ® SERENITY ADDRESS: 68 SERENE XING LOT: 279 BLOCK: BASE FOUNDATION PLAN

Issue Date: 11-17-24

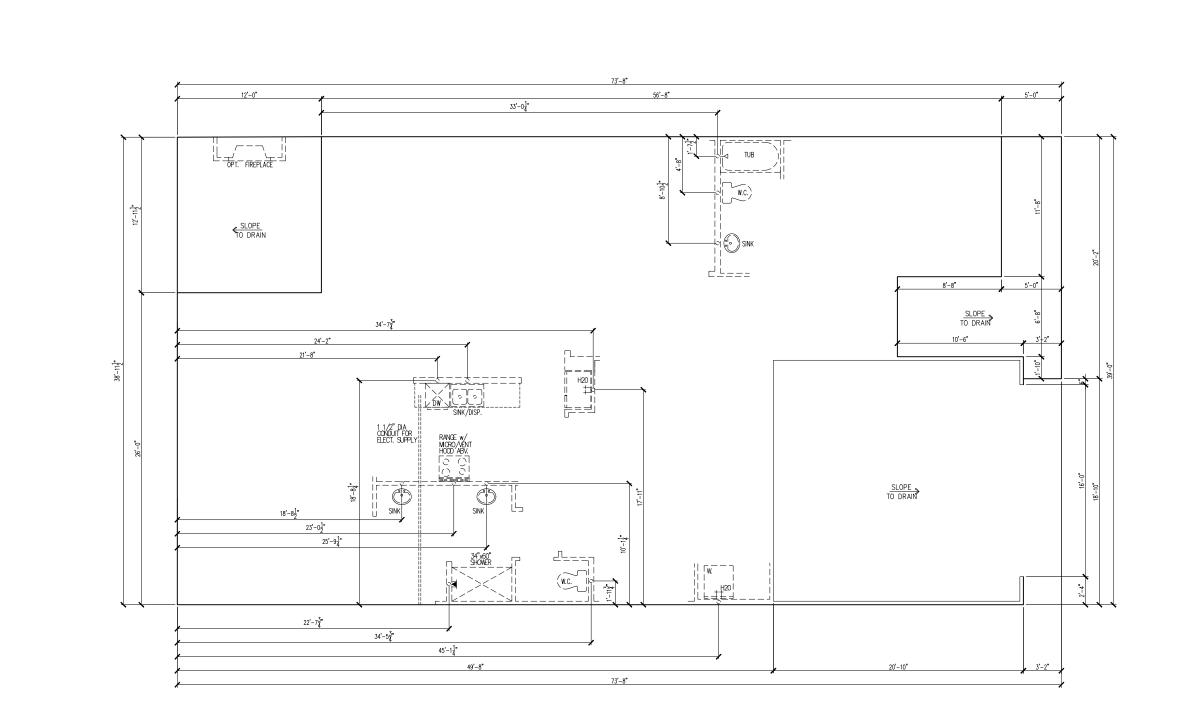Drawn By: ACC

5920-06

SANDY LANE


SHEET#: S1.10C

MAIN FLOOR NOTES

EXPLANATION

- ALL NON-DIMENSIONED PARTITIONS ARE 3-1/2" ROUGH
- ALL ANGLED PARTITIONS ARE 45 DEGREES UNLESS NOTED
- PROVIDE MIN. 2-2x12's w/ 1/2" PLYWD. FLITCH PLATE AT ALL EXTERIOR WALL OPENINGS & INTERIOR BEARING WALL OPENINGS
- ALL EXTERIOR DIM'S ARE TO FACE OF STUDS U.N.O.
- ALL TRUSSES TO BEAR ON EXTERIOR WALLS AND/OR GIRDER TRUSS U.N.O.
- TRUSS MFG. TO SIZE MEMBERS, FASTENERS, HANGERS & SET SPACING FOR ALL TRUSSES
- WINDOW SUPPLIER TO VERIFY AT LEAST ONE WINDOW IN ALL BEDROOMS TO HAVE A CLEAR EGRESS OPENING OF 5.7 SQ. FT. w/MIN DIM'S OF 24" IN HT AND 20" IN WIDTH; SILL HT NOT TO EXCEED 44" AFF
- ALL BALUSTER TO BE SPACED SUCH THAT A 4" SPHERE CANNOT PASS BETWEEN BALUSTER
- ALL ELEC. & MECH. EQUIPMENT & METERS ARE SUBJECT TO RELOCATION DUE TO FIELD CONDITIONS; CONTRACTOR TO VERIFY
- FOR ADDITIONAL NOTES, SEE GENERAL NOTES ON TITLE SHEET & DETAILS
- ALL TYP. WINDOWS 6'-0" IN HT AND SMALLER, THE HEAD HEIGHT SHALL BE 8'-10" ABOVE FINISHED FLOOR (U.N.O.)
- STRUCTURAL ENGINEERING PROVIDED BY OTHERS
- REFER TO INTERIOR ELEVATIONS SHEET TO VIEW BUBBLE

- INTERIOR DOOR HEIGHTS ARE PER SPEC FRONT & REAR PATIO DOOR TO BE 8'

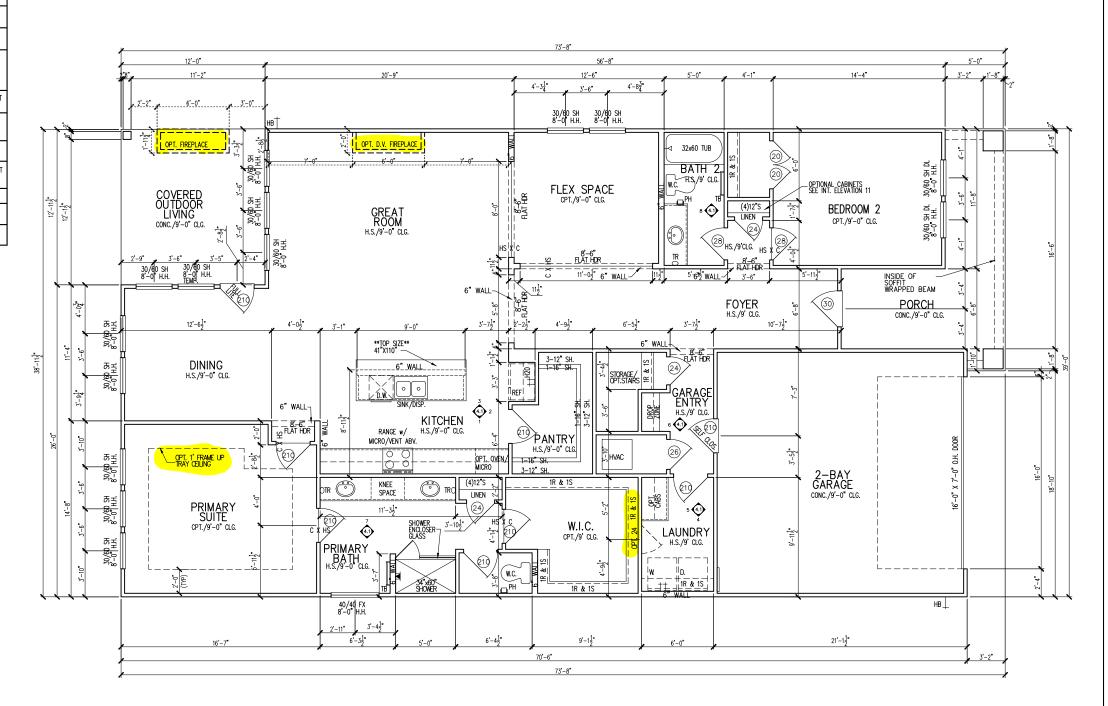



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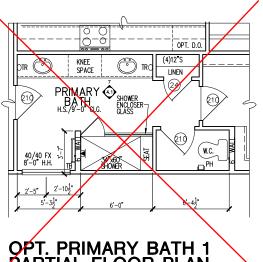
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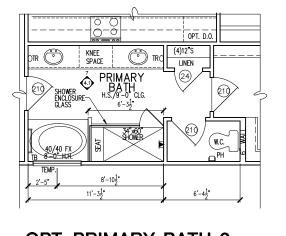
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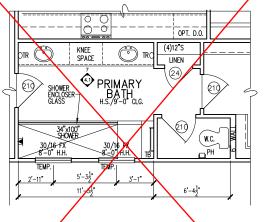
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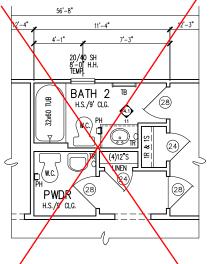
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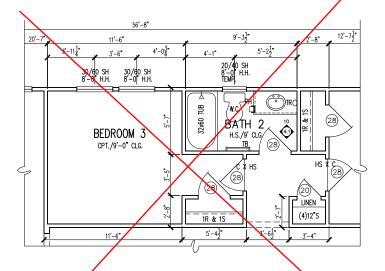
OPT PRIMARY BATH 3 PARTIAL FLOOR PLAN




OPT. PRIMARY BATH 2 PARTIAL FLOOR PLAN



OPT. SHOWER ILO TUB (BATH 2) PARTIAL FLOOR PLAN




OPT. BEDROOM 3 PARTIAL FLOOR PLAN

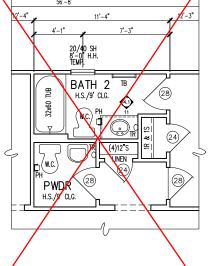

OPT. POWDER PARTIAL

FLOOR PLAN

OPT. SHOWER ILO TUB (BED 3 OPT) PARTIAL **FLOOR PLAN**

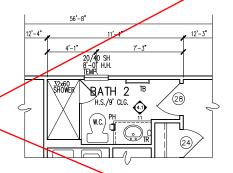

9'-3¹ BATH 2 32x60 PS./9' CLG 28

> OPT. SHOWER ILO TUB (PWDR OPT) PARTIAL **FLOOR PLAN**

PLAN FLOOR

OPTIONS

SUBDIVISION: ADDRESS: LOT: 279

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Issue Date: 11-17-24 ACC

5920-06

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PARTIAL FLOOR PLAN

EXPLANATION ALL NON-DIMENSIONED PARTITIONS ARE 3-1/2" ROUGH ALL ANGLED PARTITIONS ARE 45 DEGREES UNLESS NOTED OTHERWISE (U.N.O.) PROVIDE MIN. 2-2x12's w/ 1/2" PLYMD. FLITCH PLATE AT ALL EXTERIOR WALL OPENINGS & INTERIOR BEARING WALL OPENINGS 4. ALL EXTERIOR DIM'S ARE TO FACE OF STUDS U.N.O. TRUSS U.N.O. TRUSS MFG. TO SIZE MEMBERS, FASTENERS, HANGERS & SET SPACING FOR ALL TRUSSES

MAIN FLOOR NOTES

WINDOW SUPPLIER TO VERIFY AT LEAST ONE WINDOW IN ALL BEDROOMS TO HAVE A CLEAR ECRESS OPENING OF 5.7 SQ. FT. W/MIN DIM's OF 24° in HT and 20° in Width; SILL HT not to

ALL BALUSTER TO BE SPACED SUCH THAT A 4" SPHERE CANNO PASS BETWEEN BALUSTER


ALL ELEC. & MECH. EQUIPMENT & METERS ARE SUBJECT TO RELOCATION DUE TO FIELD CONDITIONS; CONTRACTOR TO VFRIFY


FOR ADDITIONAL NOTES, SEE GENERAL NOTES ON TITLE SHEET & DETAILS


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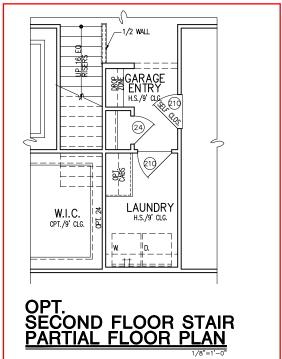
STRUCTURAL ENGINEERING PROVIDED BY OTHERS


INTERIOR DOOR HEIGHTS ARE PER SPEC - FRONT & REAR PATIO DOOR TO BE 8'




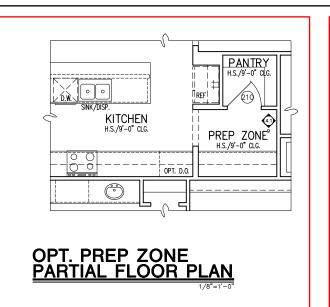

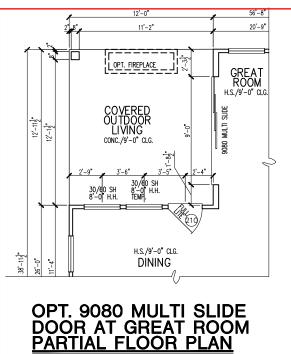

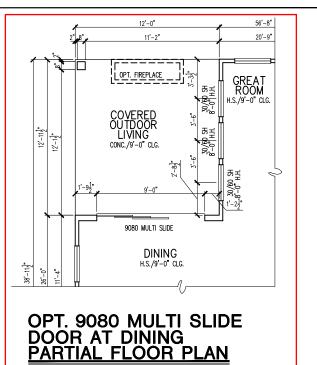

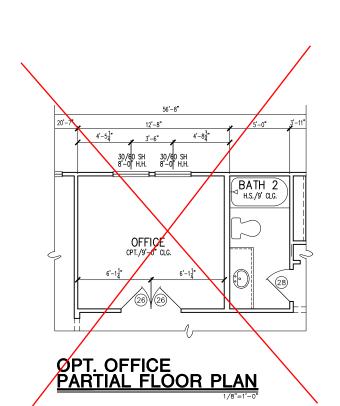

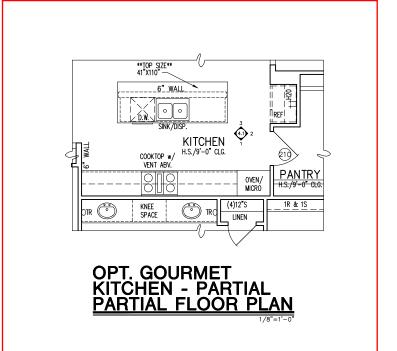



EXPLANATION

ALL NON-DIMENSIONED PARTITIONS ARE 3-1/2" ROUGH

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PROVIDE MIN. 2-2x12's w/ 1/2" PLYMD. FLITCH PLATE AT ALL EXTERIOR WALL OPENINGS & INTERIOR BEARING WALL OPENINGS

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ALL TYP. WINDOWS 6'-0" IN HT AND SMALLER, THE HEAD HEIGHT SHALL BE 8'-10" ABOVE FINISHED FLOOR (U.N.O.)

STRUCTURAL ENGINEERING PROVIDED BY OTHERS

REFER TO INTERIOR ELEVATIONS SHEET TO VIEW BUBBLE CALLOUTS

INTERIOR DOOR HEIGHTS ARE PER SPEC - FRONT & REAR PATIO DOOR TO BE 8'

OPTIONS PLAN FLOOR

N: ALTIS @ SERENITY 68 SERENE XING SUBDIVISION: ADDRESS: LOT: 279

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Business Operations 5440 Wade Park Blvd Suite 400 Raleigh, NC 27607

Issue Date: 11-17-24 ACC

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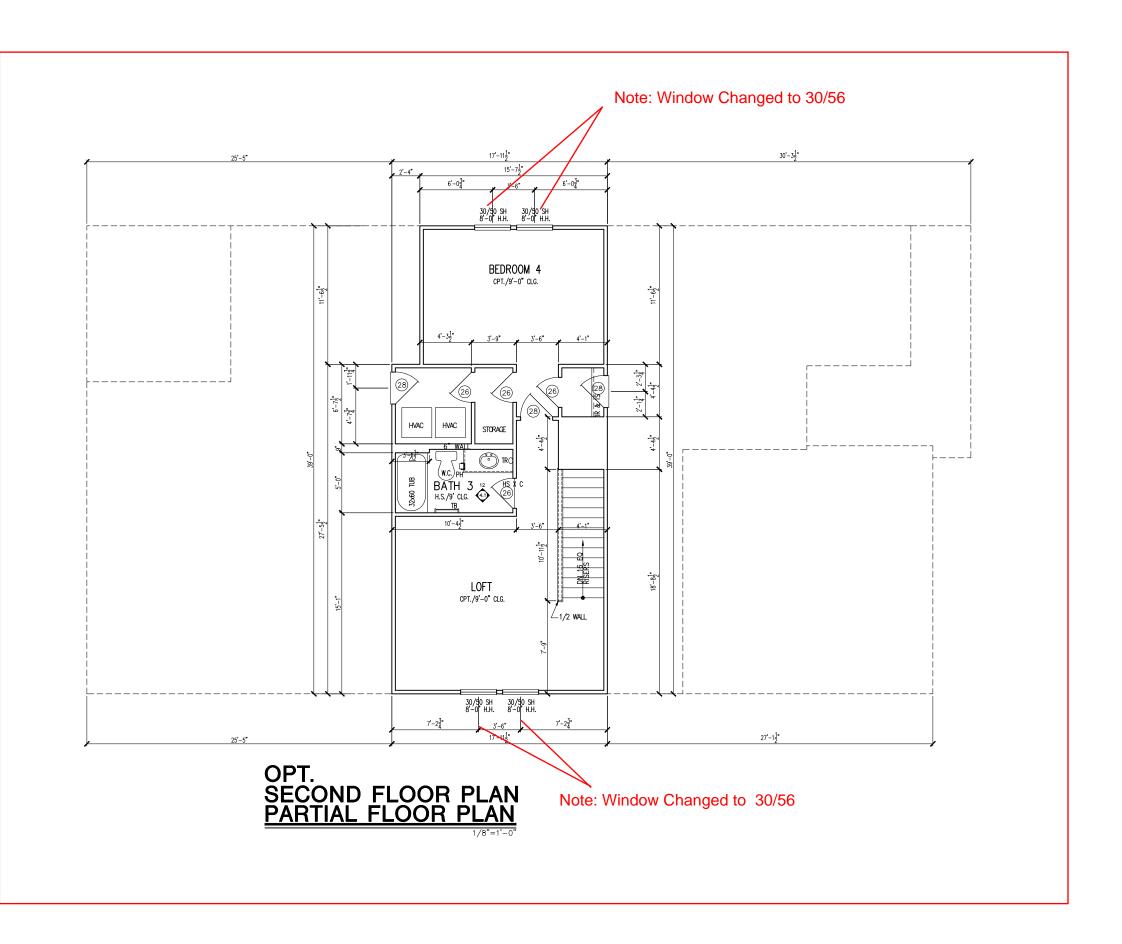
SANDY LANE

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MAIN FLOOR NOTES

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3 SERENE XING OPTION 2ND FLOOR PLAN


SUBDIVISION:
ADDRESS: 68 5
LOT: 279 BLC

Issue Date: 11-17-24 Drawn By: ACC

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Business Operations 5440 Wade Park Blvd Suite 400 Raleigh, NC 27607

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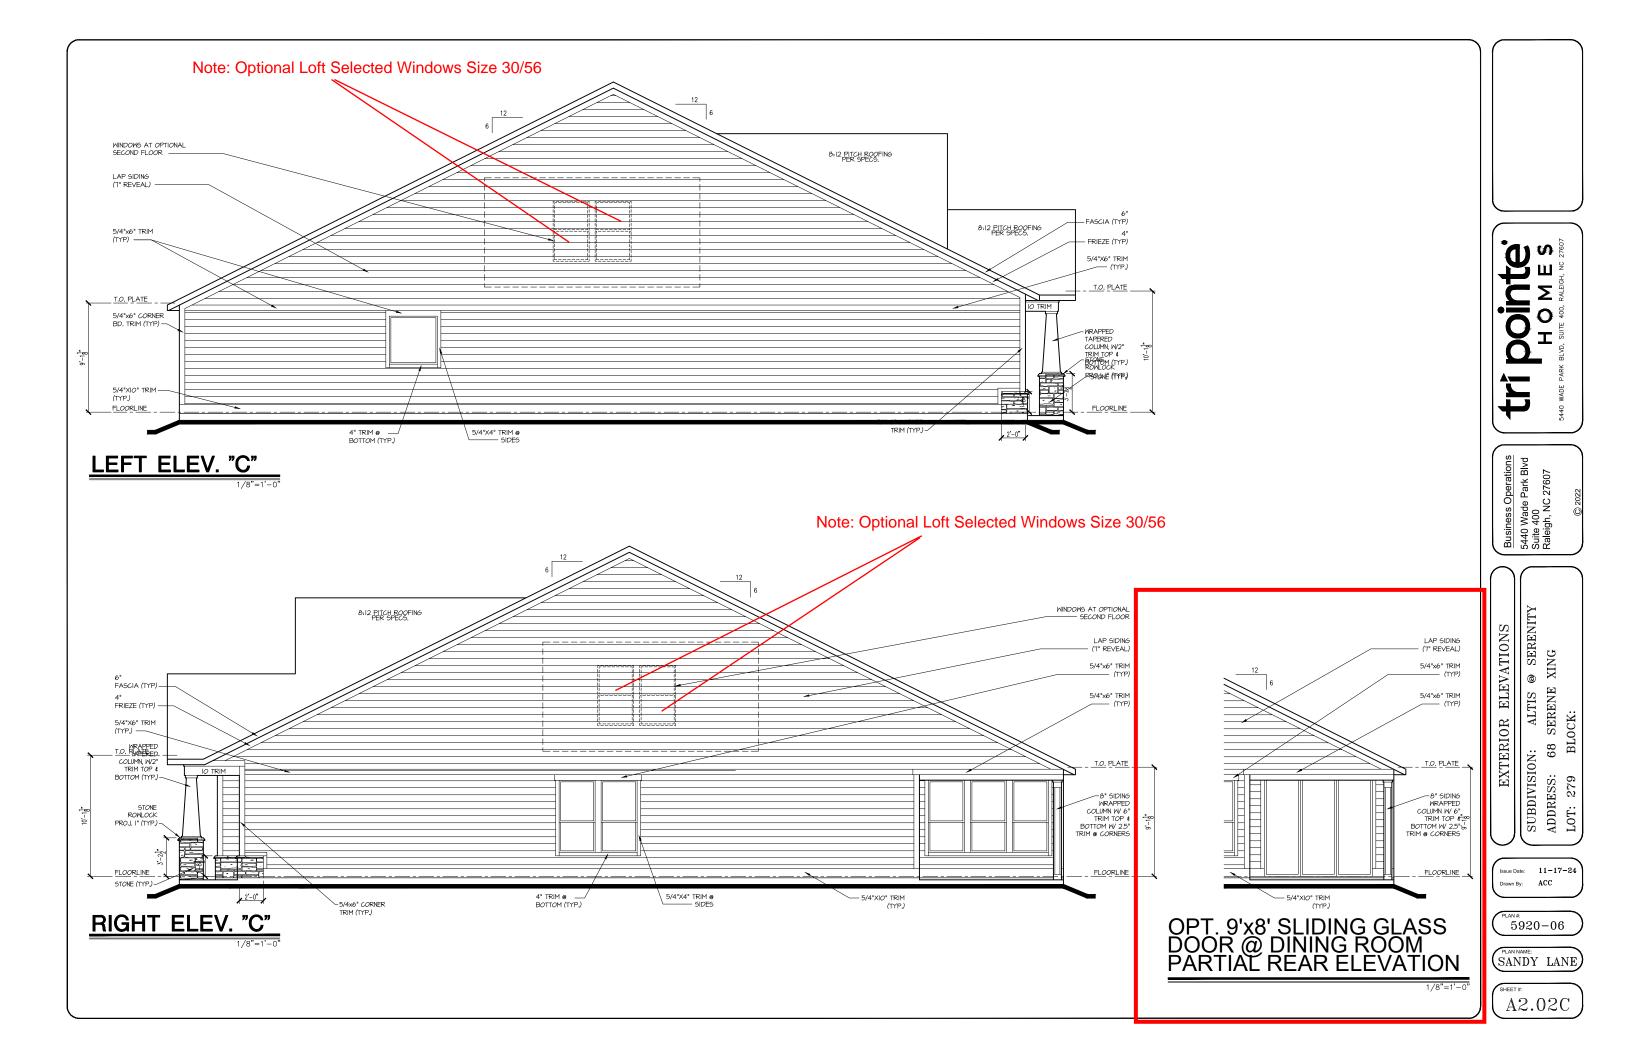
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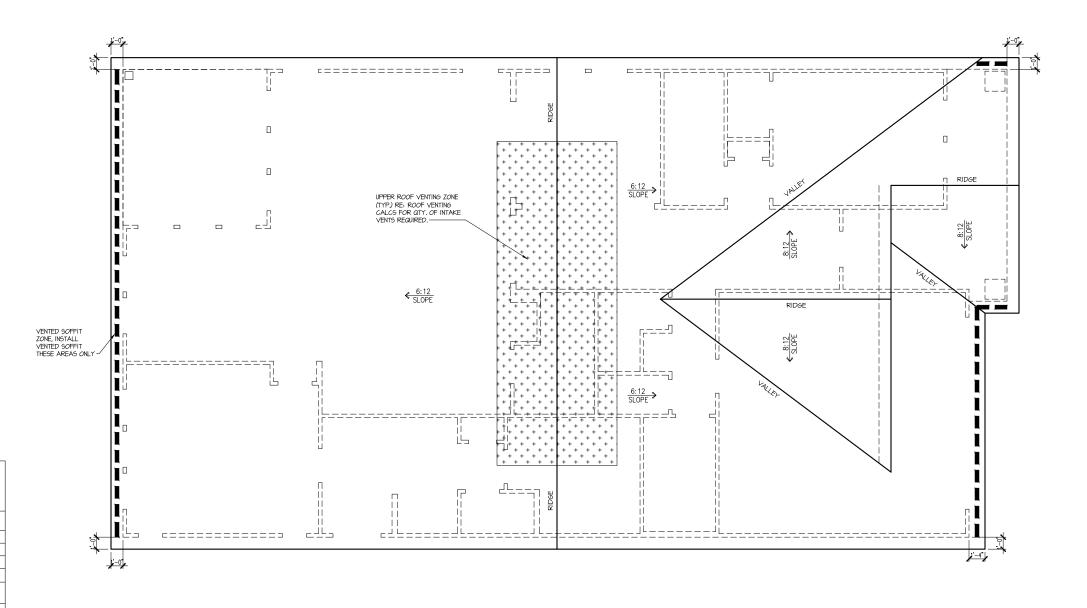
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SANDY LANE

A2.01C

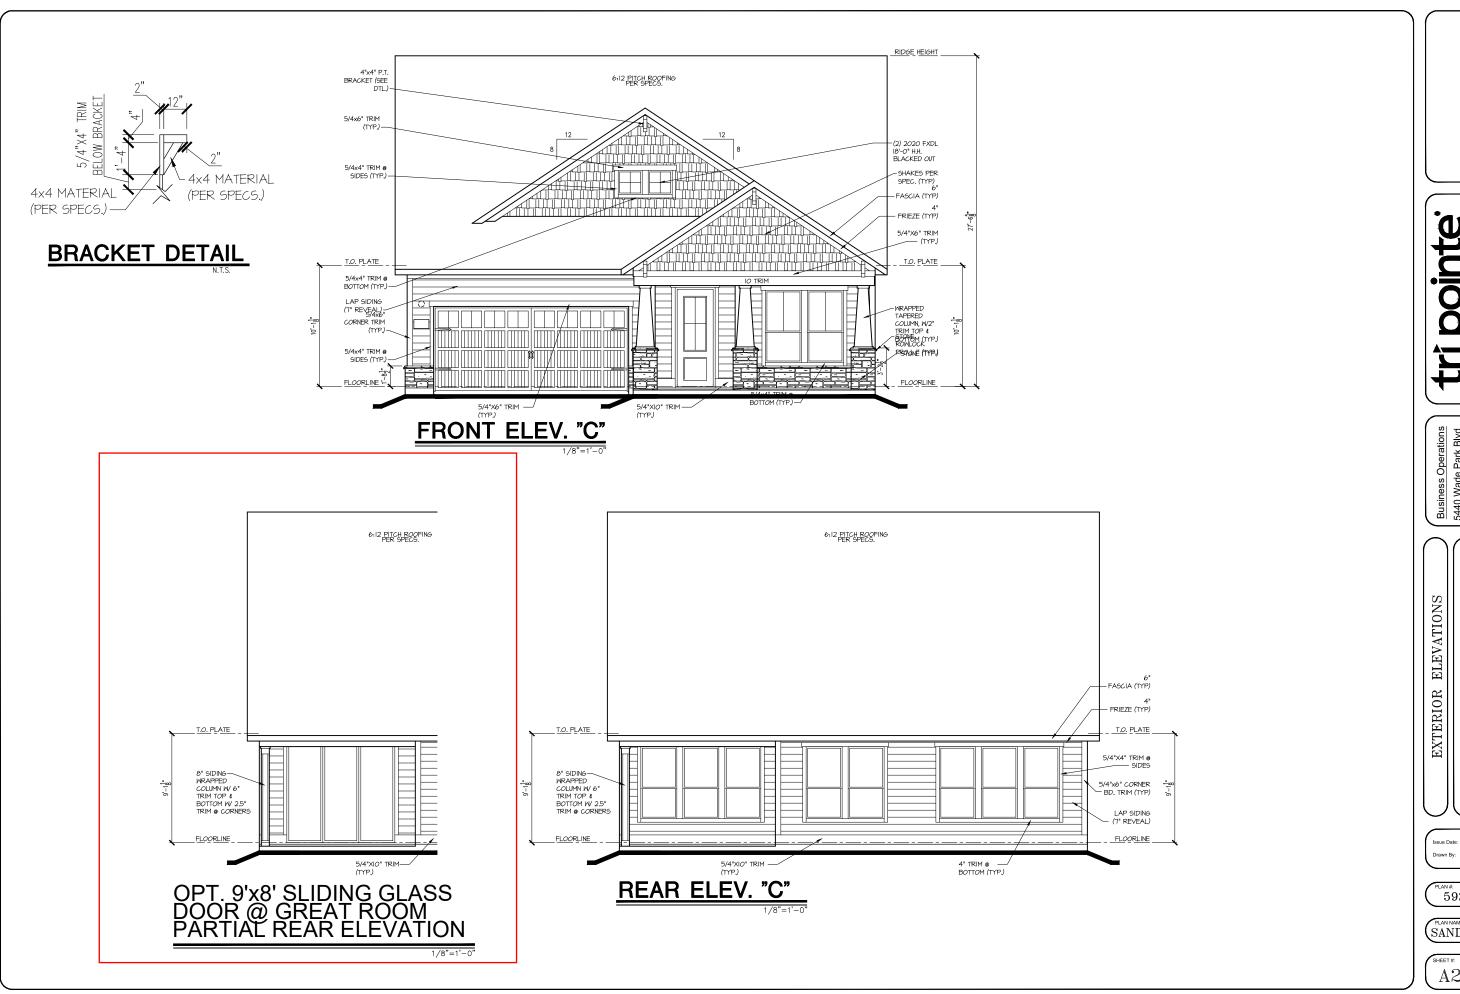



Attic Venting Calculations Elev. "C" ROOF INFORMATION BASE 3043 TOTAL SF ROOF AREA AVAILABLE L.F. ROOF SOFFIT 61 AVAILABLE L.F. ROOF RIDGE OTY VENTS VENT TYPES VENT TYPES
LOWER VENTS
CONTINUOUS SOFFIT VENTING
@ 5 SILF
UPPER VENTS
SLANT 150 VENTS @ 150
SIVENT
UPPER VENTS
RIDGE VENTS @ 72 SI/VENT 146 LF

NOTE: QTY OF UPPER VENTS SHOWN COVERS 100% OF UPPER VENTING. NO MIXING OF VENT TYPES FOR UPPER VENTING IS FIGURED FOR IN THIS TABLE.

ROOF PLAN 'C'

Dointe HOMES RR BLW, SUITE 400, RALEIGH, NG 27607

Business Operations 5440 Wade Park Blvd Suite 400 Raleigh, NC 27607

N: ALTIS @ SERENITY 68 SERENE XING ROOF PLAN


SUBDIVISION:
ADDRESS: 68
LOT: 279 BI

Issue Date: 11-17-24 Drawn By: ACC

5920-06

(SANDY LANE)

A3.01C

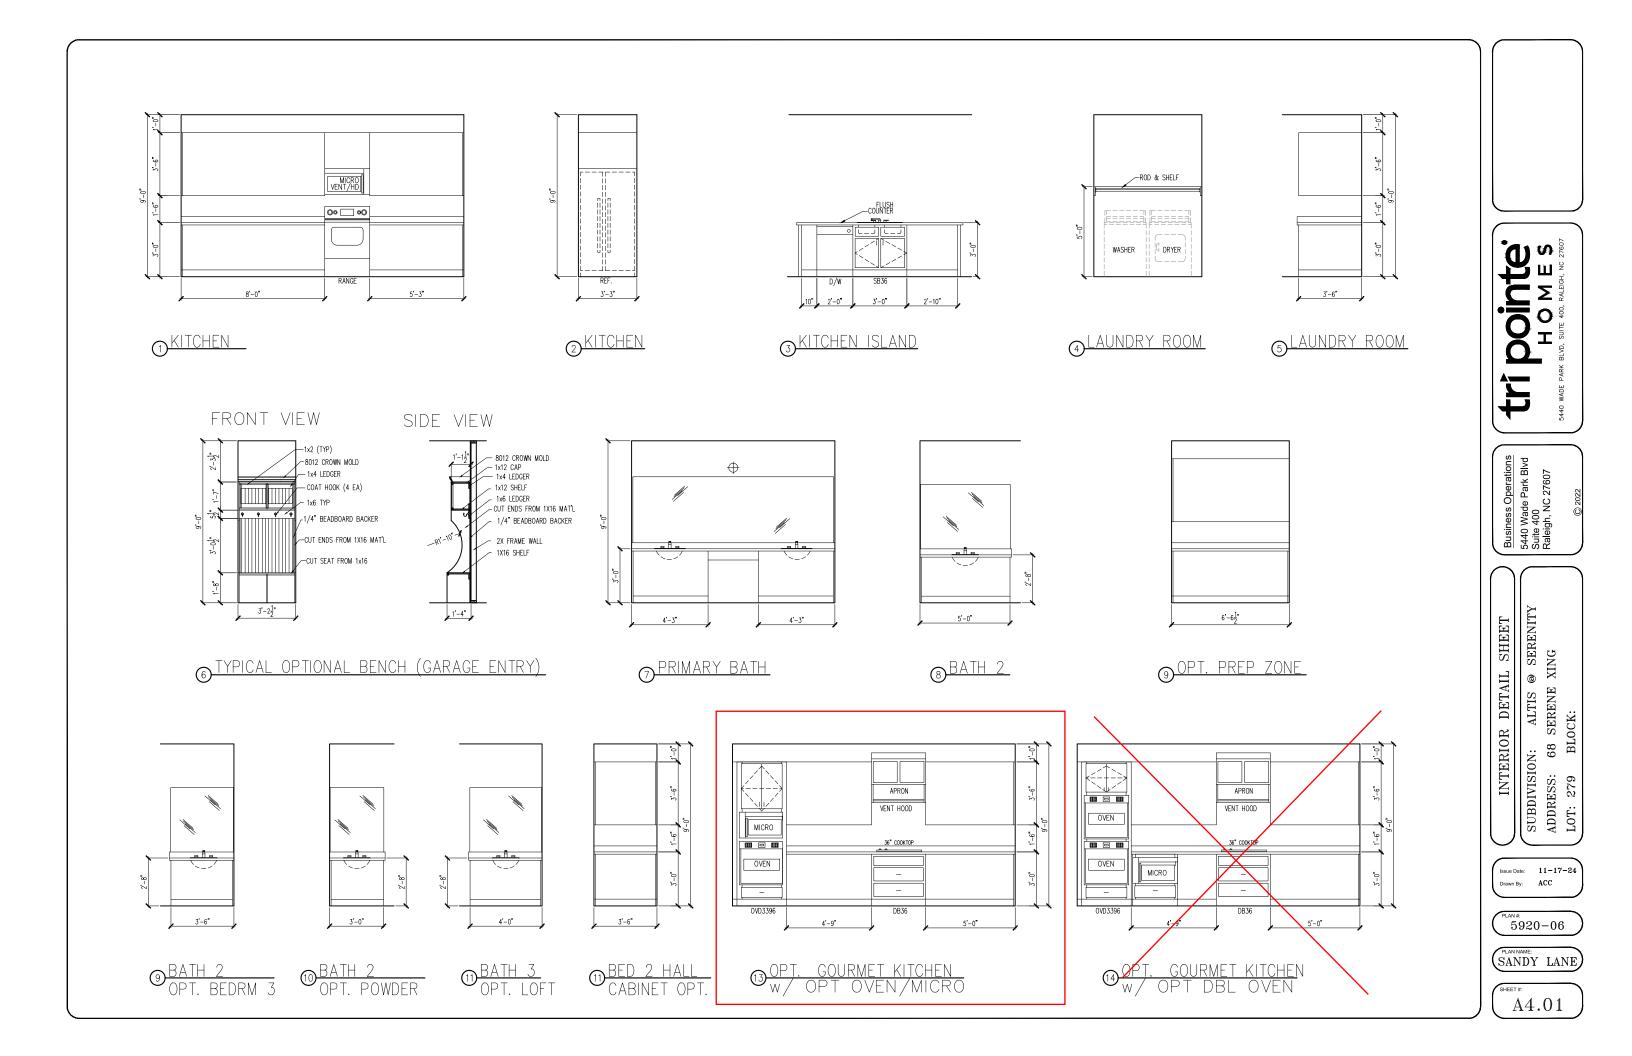

ELECTRICAL I SCHEDU	FIXTURE LE
DESCRIPTION	SYMBOL
110V OUTLET	Ф
220V OUTLET	
1/2 HOT OUTLET	•
GFI OUTLET	% GFI
WP GFI OUTLET	₩P/GFI
GARAGE DOOR OPENER OUTLET	Ø GDO
SECURITY SYSTEM	∯SEC SYS
DISHWASHER	●DW
JUNCTION BOX	9
CEILING MOUNTED LIGHT	
CEILING FAN w/ LIGHT KIT	BRAZINE
RECESSED CEILING LIGHT	Ø
RECESSED WATER PROOF LIGHT)®(WP
WALL MOUNTED LIGHT	9
WALL MOUNTED PUSH BUTTON	₫ PB
TWO WAY SWITCH	\$
THREE WAY SWITCH	3\$
FOUR WAY SWITCH	*\$
DIMMER SWITCH	\$ ^{DIM}
EXHAUST VENTS	SVENT TO EXT
LOW VOLTAGE PANEL	<u></u>
PHONE OUTLET	●PH
TV OUTLET	⊗ TV
DATA & RG6 COMBO BOX	
SMOKE DETECTOR	<u> </u>
CARBON MONOXIDE SMOKE DETECTOR COMBO	⊚ CM/SD
DOOR CHIMES	CHIMES
ELECTRICAL PANEL	EP EP
SURFACE MOUNT LED	•
EXTERIOR WALL MOUNT UPLIGHT	8
SOFFIT MOUNT FLOOD LIGHT	44
UNDER COUNTER LIGHTING	-coo-UCL
SMURF TUBE	


ELECTRICAL NOTES:

- PROVIDE AND INSTALL LOCALLY CERTIFIED PROVIDE AND INSTALL LOCALLY CERTIFIED SMOKE AND CARBON MONOXIDE DETECTORS REQUIRED BY NATIONAL FIRE PROTECTION ASSOCIATION (IPPA) AND MEETING THE REQUIREMENTS OF ALL GOVERNING CODES PROVIDE AND INSTALL GROUND FAULT CIRCUIT—INTERRUPTERS (GFI) AS REQUIRED BY NATIONAL ELECTRIC CODE (NEC) AND MEETING THE REQUIREMENTS OF ALL GOVERNING CODES. ELECTRICAL CONTRACTOR TO PROVIDE REQUIRED DIRECT HOOK—UPS/CUTOFFS. HYAC CONTRACTOR TO VERIFY THERMOSTAT

- REQUIRED DIRECT HOOK—UPS/CUIOFFS.
 HVAC CONTRACTOR TO VERIFY THERMOSTAT
 LOCATIONS.
 ALL ELECTRICAL AND MECHANICAL EQUIPMENT
 (I.E. FURNACES, A/C UNITS, ELECTRICAL PANELS,
 SANITARY SUMP PITS, DRAIN TILE SUMP, AND
 WATER HEATERS) ARE SUBJECT TO RELOCATION
 DUE TO FIELD CONDITIONS.

BATH VANITY BRACKET OUTLET. 1,2 (1" ABOVE TOP OF VANITY) FRONT DOOR COACH LIGHT. GARAGE DOOR COACH LIGHT, (ABOVE GARAGE FLOOR). . . . 84" . TO CL THERMOSTAT. . .54" TO .CL . . .84" TO .CL DOORBELL CHIMES. DR HANDLE .66". TQ CL KITCHEN DISHWASHER RECEPTACLE. JUNDER SINK
KITCHEN RANGE. 24".TD.CL.
KITCHEN REFRIGERATOR. 48". TO CL
WASHER/DRYER OUTLET. 48". TO. CL

CL = CENTER LINE 1 = FIELD VERIFY 2 = MASTER BATH STANDARD 30" HIGH VANITY TO BE RAISED 4"

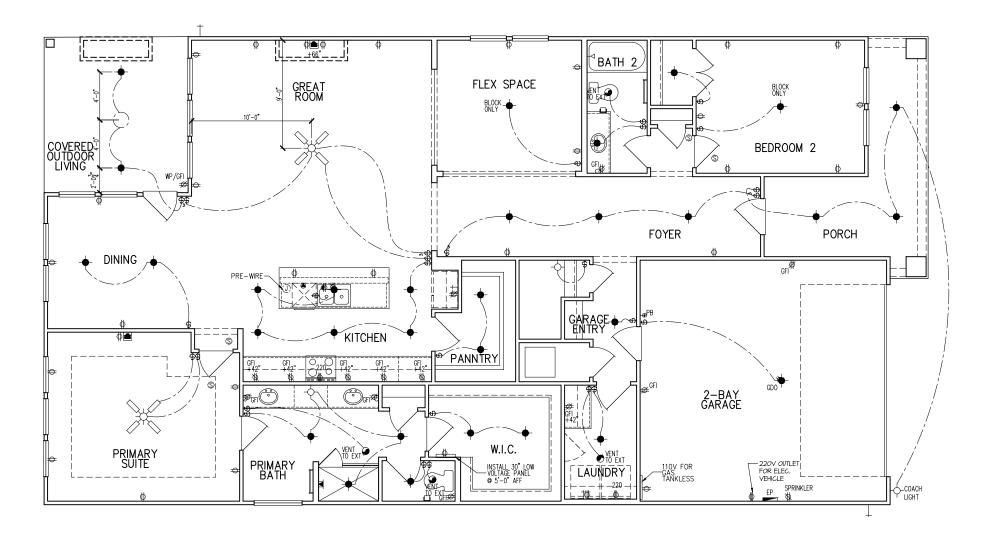

Dointe HOMES RELVO, SUITE 400, RALEIGH, NG 27607

Business Operations 5440 Wade Park Blvd Suite 400 Raleigh, NC 27607

ELECTRICAL PLAN @ SERENITY E XING ALTIS (SERENE 1st FLOOR SUBDIVISION:

ADDRESS: LOT: 279 Issue Date: 11-17-24 Drawn By: ACC

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(SANDY LANE

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ELECTRICAL FIXTURE SCHEDULE DESCRIPTION SYMBOL 110V OUTLET \$ 220V OUTLET \$ 220V OUTLET \$ 220V OUTLET \$ 320V OUTLET \$ 4 FOR OUTLET \$ 5 FOR WAY SWITCH \$ 5 FOUR		
110V OUTLET 220V OUTLET 220V OUTLET \$\infty 220 1/2 HOT OUTLET \$\infty \text{GFI} \text{WP/GFI} \text{GFI} \text{WP/GFI} \text{GFI} \text{WP/GFI} \text{GFI} \text{WP/GFI} \text{GDO} \text{GDO} \text{CHIMES} \text{CHIMES} \text{CHIMES} \text{CHIMES} \text{CHIMES} \text{CHIMES}	ELECTRICAL I SCHEDU	TIXTURE LE
220V OUTLET 1/2 HOT OUTLET GFI OUTLET WP GFI OUTLET GARAGE DOOR OPENER OUTLET SECURITY SYSTEM DISHWASHER JUNCTION BOX CEILING MOUNTED LIGHT CEILING FAN W/ LIGHT KIT RECESSED CEILING LIGHT WALL MOUNTED LIGHT WALL MOUNTED LIGHT WALL MOUNTED PUSH BUTTON TWO WAY SWITCH THREE WAY SWITCH EXHAUST VENTS LOW VOLTAGE PANEL PHONE OUTLET TV OUTLET DATA & RGG COMBO BOX SMOKE DETECTOR CARBON MONOXIDE SMOKE DETECTOR COMBO CHIMES ELECTRICAL PANEL SOFFIT MOUNT FLOOD LIGHT SOFFIT MOUNT FLOOD LIGHT SOFFIT MOUNT FLOOD LIGHT UNDER COUNTER LIGHTING POUR WAY SWITCH TV OUTLET DATA & RGG COMBO CHIMES ELECTRICAL PANEL SOFFIT MOUNT FLOOD LIGHT UNDER COUNTER LIGHTING POUR COUNTER LIGHTING	DESCRIPTION	SYMBOL
1/2 HOT OUTLET GFI OUTLET WP GFI OUTLET WP GFI OUTLET GARAGE DOOR OPENER OUTLET SECURITY SYSTEM DISHWASHER JUNCTION BOX CEILING MOUNTED LIGHT CEILING FAN W/ LIGHT KIT RECESSED CEILING LIGHT WALL MOUNTED LIGHT WALL MOUNTED LIGHT WALL MOUNTED LIGHT THREE WAY SWITCH THREE WAY SWITCH EXHAUST VENTS LOW VOLTAGE PANEL PHONE OUTLET TV OUTLET DATA & RGG COMBO BOX SMOKE DETECTOR CARBON MONOXIDE SMOKE DETECTOR COMBO CHIMES ELECTRICAL PANEL SOFFIT MOUNT FLOOD LIGHT UNDER COUNTER LIGHT SOFFIT MOUNT FLOOD LIGHT UNDER COUNTER LIGHT SOFFIT MOUNT FLOOD LIGHT UNDER COUNTER LIGHTING WP PH TY OUTLET DATA & RGG COMBO CHIMES	110V OUTLET	Ф
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GARAGE DOOR OPENER OUTLET TY OUTLET DATA & RGG COMBO BOX SMOKE DETECTOR CARBON MONOXIDE SMOKE DETECTOR COMBO EXTERDING DOOR CHIMES CHI	GFI OUTLET	∜ GFI
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CEILING FAN W/ LIGHT KIT RECESSED CEILING LIGHT RECESSED WATER PROOF LIGHT WALL MOUNTED LIGHT WALL MOUNTED PUSH BUTTON TWO WAY SWITCH THREE WAY SWITCH EXHAUST VENTS LOW VOLTAGE PANEL PHONE OUTLET TV OUTLET TV OUTLET TV OUTLET TV OUTLET TV OUTLET CARBON MONOXIDE SMOKE DETECTOR COMBO CARBON MONOXIDE SMOKE DETECTOR COMBO CHIMES ELECTRICAL PANEL SUFFACE MOUNT LED EXTERIOR WALL MOUNT UPLIGHT SOFFIT MOUNT FLOOD LIGHT UNDER COUNTER LIGHTING PROVIDED PROVIDED PBRACING BRACING WP WP #PB #PB #PB #PB #PD #PH #TV #PH #TV #PH #TV #TV #TV #TV #TV #TV #TV #T	JUNCTION BOX	9
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TWO WAY SWITCH THREE WAY SWITCH FOUR WAY SWITCH FOUR WAY SWITCH DIMMER SWITCH EXHAUST VENTS LOW VOLTAGE PANEL PHONE OUTLET TV OUTLET DATA & RGG COMBO BOX SMOKE DETECTOR CARBON MONOXIDE SMOKE DOOR CHIMES ELECTRICAL PANEL SUFFACE MOUNT LED EXTERIOR WALL MOUNT UPLIGHT UNDER COUNTER LIGHTING **SOFTI MOUNT FLOOD LIGHT UNDER COUNTER LIGHTING **SOFTI MOUNT SWITCH TOWN TOWN TOWN TOWN TOWN TOWN TOWN TOWN	WALL MOUNTED LIGHT	9
THREE WAY SWITCH FOUR WAY SWITCH DIMMER SWITCH EXHAUST VENTS LOW VOLTAGE PANEL PHONE OUTLET TV OUTLET DATA & RGG COMBO BOX SMOKE DETECTOR CARBON MONOXIDE SMOKE DOOR CHIMES ELECTRICAL PANEL SUFFACE MOUNT LED EXTERIOR WALL MOUNT UPLIGHT UNDER COUNTER LIGHTING **DIM**	WALL MOUNTED PUSH BUTTON	d PB
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DIMMER SWITCH EXHAUST VENTS LOW VOLTAGE PANEL PHONE OUTLET TV OUTLET DATA & RGG COMBO BOX SMOKE DETECTOR CARBON MONOXIDE SMOKE DETECTOR COMBO DOOR CHIMES ELECTRICAL PANEL SUFFACE MOUNT LED EXTERIOR WALL MOUNT UPLIGHT SOFFIT MOUNT FLOOD LIGHT UNDER COUNTER LIGHTING	THREE WAY SWITCH	
EXHAUST VENTS LOW VOLTAGE PANEL PHONE OUTLET TV OUTLET DATA & RG6 COMBO BOX SMOKE DETECTOR CARBON MONOXIDE SMOKE DETECTOR COMBO CHIMES ELECTRICAL PANEL SUFFACE MOUNT LED EXTERIOR WALL MOUNT UPLIGHT UNDER COUNTER LIGHTING VENT TO EXT PPH TV OTV OTV OTV OTV OTV OTV OTV	FOUR WAY SWITCH	
LOW VOLTAGE PANEL PHONE OUTLET TV OUTLET DATA & RG6 COMBO BOX SMOKE DETECTOR CARBON MONOXIDE SMOKE DETECTOR COMBO DOOR CHIMES CHIMES CHIMES ELECTRICAL PANEL SURFACE MOUNT LED EXTERIOR WALL MOUNT UPLIGHT UNDER COUNTER LIGHTING OPPH TV OTV OTV OTV OTV OTV OTV OTV	DIMMER SWITCH	
PHONE OUTLET TV OUTLET DATA & RG6 COMBO BOX SMOKE DETECTOR CARBON MONOXIDE SMOKE DETECTOR COMBO DOOR CHIMES ELECTRICAL PANEL SURFACE MOUNT LED EXTERIOR WALL MOUNT UPLIGHT UNDER COUNTER LIGHTING PH TV OTM OT OTM OT OTM OT OTM OT OT OT		_
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DATA & RG6 COMBO BOX SMOKE DETECTOR CARBON MONOXIDE SMOKE DETECTOR COMBO DOOR CHIMES ELECTRICAL PANEL SURFACE MOUNT LED EXTERIOR WALL MOUNT UPLIGHT SOFFIT MOUNT FLOOD LIGHT UNDER COUNTER LIGHTING		
SMOKE DETECTOR CARBON MONOXIDE SMOKE DETECTOR COMBO COM/SD CM/SD CM		
CARGON_MONOXUE_SMOKE DOOR CHIMES ELECTRICAL PANEL SURFACE MOUNT LED EXTERIOR WALL MOUNT UPLIGHT UNDER COUNTER LIGHTING O CM/SD CHIMES CHIMES EP EP EP EVENTACE MOUNT LED EXTERIOR WALL MOUNT UPLIGHT UNDER COUNTER LIGHTING		
DOOR CHIMES CHIMES ELECTRICAL PANEL SURFACE MOUNT LED EXTERIOR WALL MOUNT UPLIGHT SOFFIT MOUNT FLOOD LIGHT UNDER COUNTER LIGHTING		
ELECTRICAL PANEL SURFACE MOUNT LED EXTERIOR WALL MOUNT UPLIGHT SOFFIT MOUNT FLOOD LIGHT UNDER COUNTER LIGHTING	DETECTOR COMBO	- /
SURFACE MOUNT LED EXTERIOR WALL MOUNT UPLIGHT SOFFIT MOUNT FLOOD LIGHT UNDER COUNTER LIGHTING SURFACE MOUNT LED WHO A COUNTER LIGHTING	DOOR CHIMES	CHIMES
EXTERIOR WALL MOUNT UPLIGHT SOFFIT MOUNT FLOOD LIGHT UNDER COUNTER LIGHTING WOUNTER LIGHTING	ELECTRICAL PANEL	EP EP
SOFFIT MOUNT FLOOD LIGHT UNDER COUNTER LIGHTING WWW-UCL		-
SOFFIT MOUNT FLOOD LIGHT UNDER COUNTER LIGHTING WWW-UCL	EXTERIOR WALL MOUNT UPLIGHT	88
		445
SMURF TUBE		-coo-UCL
	SMURF TUBE	

ELECTRICAL NOTES:

- 1. PROVIDE AND INSTALL LOCALLY CERTIFIED SMOKE AND CARBON MONOXIDE DETECTORS AS REQUIRED BY NATIONAL FIRE PROTECTION ASSOCIATION (NFPA) AND MEETING FIRE REQUIREMENTS OF ALL GOVERNING CODES 2. PROVIDE AND INSTALL GROUND FAULT (IRCUIT-INTERRUPTERS (GF) AS REQUIRED BY NATIONAL ELECTRIC CODE (NEC) AND MEETING THE REQUIREMENTS OF ALL GOVERNING CODES.

 3. ELECTRICAL CONTRACTOR TO PROVIDE REQUIRED DIRECT HOOK—UPS/CUTOFFS.

 4. HVAC CONTRACTOR TO VERIFY THERMOSTAT LOCATIONS.

 5. ALL ELECTRICAL AND MECHANICAL EQUIPMENT (I.E. FURNACES, A/C UNITS, ELECTRICAL PANELS, SANITARY SUMP PITS, DRAIN TILE SUMP, AND WATER HEATERS) ARE SUBJECT TO RELOCATION DIE TO FIELD CONDITIONS.

 ELECTRICAL DEVICES: ABOVE FINISHED FLOORS:

WALL OUTLETS OVER COUNTER.

+42" TO BOTTOM OF HORIZONTAL OUTLET(TYP. © COUNTER)

REMAINING SWITCHES. . 48" TD. CL

WALL OUTLETS. . 12" TO CL


BATH VANITY BRACKET OUTLET. . 1.2

(1" ABOVE TOP OF VANITY) FRONT DOOR COACH LIGHT. THERMOSTAT. 54" TO .CL .
DOORBELL CHIMES. 84" TO .CL

DOORBELL BUTTON. DR HAMBLE
KITCHEN HOOD FAN "WHIP". .66". TO CL
KITCHEN WALL HUNG MICROWAVE OUTLET .72" TO CL
KITCHEN DISHWASHER RECEPTACLE. UNDER SINK
KITCHEN RANGE. .24". TO CL
KITCHEN REFRIGERATOR. .48". TO CL WASHER/DRYER OUTLET.

CL = CENTER LINE 1 = FIELD VERIFY

2 = MASTER BATH STANDARD 30" HIGH VANITY TO BE RAISED 4"

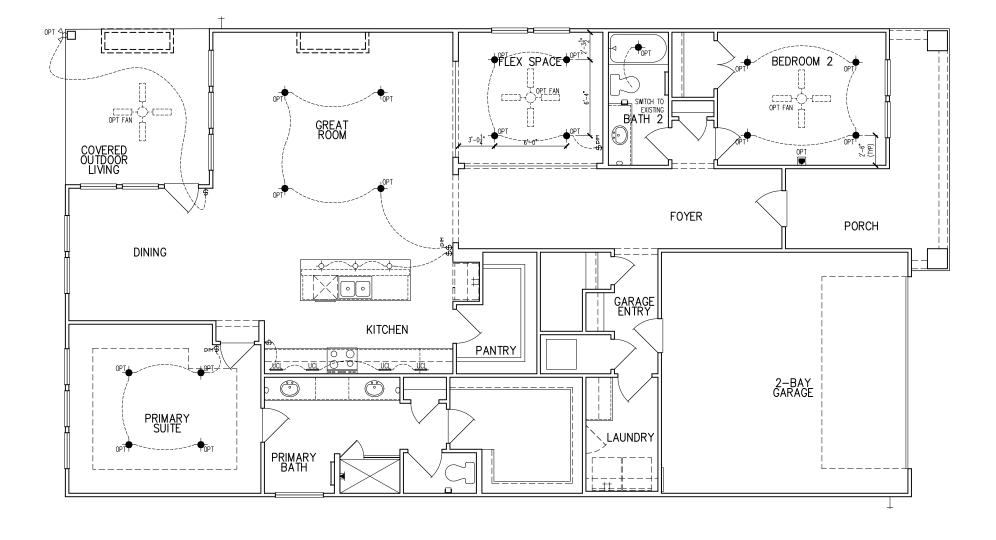

Dointe HOMES RELVO, SUITE 400, RALEIGH, NG 27607

Business Operations 5440 Wade Park Blvd Suite 400 Raleigh, NC 27607

OPITONS ELEC. PLAN – OPITO
ALTIS ® SERENITY

8 SERENE XING 1st FLOOR ELEC.


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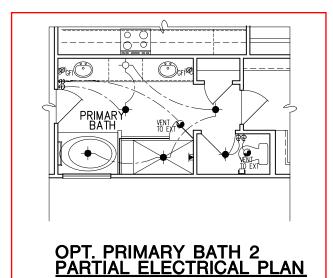
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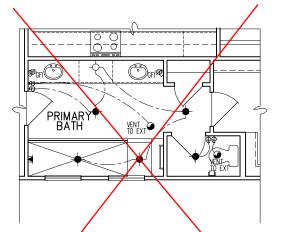
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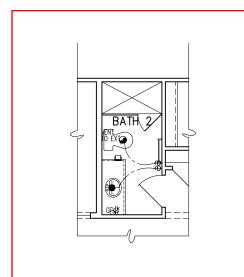
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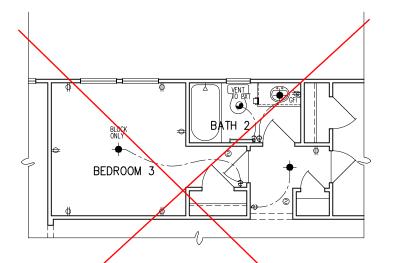







OPT. PRIMARY BATH 3
PARTIAL ELECTRICAL PLAN



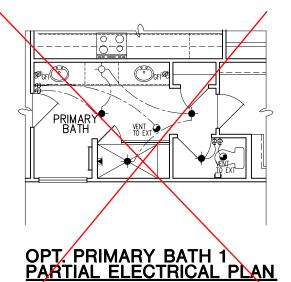

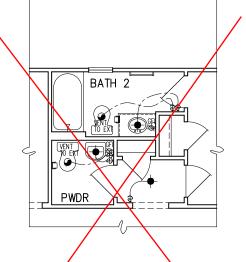

OPT. SHOWER ILO TUB (BATH 2) PARTIAL ELECTRICAL PLAN


OPT. BEDROOM 3
PARTIAL ELECTRICAL PLAN

OPT. POWDER PARTIAL ELECTRICAL PLAN

DESCRIPTION	SYMBOL	
110V OUTLET	Ф	
220V OUTLET	\$ 220	1
1/2 HOT OUTLET	♦	1
GFI OUTLET	V \$ GFI	ELECTRICAL NOTES:
WP GFI OUTLET	WP/GFI	
GARAGE DOOR OPENER OUTLET	Ø GDO	PROVIDE AND INSTALL LOCALLY CERTIFIED SMOKE AND CARBON MONOXIDE DETECTORS AS
SECURITY SYSTEM	Ø SEC SYS	REQUIRED BY NATIONAL FIRE PROTECTION ASSOCIATION (NFPA) AND MEETING THE
DISHWASHER	●DW	REQUIREMENTS OF ALL GOVERNING CODES 2. PROVIDE AND INSTALL GROUND FAULT
JUNCTION BOX	0	CIRCUIT-INTERRUPTERS (GFI) AS REQUIRED BY
CEILING MOUNTED LIGHT	~	NATIONAL ELECTRIC CODE (NÉC) AND MEETING THE REQUIREMENTS OF ALL GOVERNING CODES.
CEILING FAN w/ LIGHT KIT	ERRYING	ELECTRICAL CONTRACTOR TO PROVIDE REQUIRED DIRECT HOOK—UPS/CUTOFFS. HVAC CONTRACTOR TO VERIFY THERMOSTAT LOCATIONS.
RECESSED CEILING LIGHT	Œ	 ALL ELECTRICAL AND MECHANICAL EQUIPMENT (I.E. FURNACES, A/C UNITS, ELECTRICAL PANELS,
RECESSED WATER PROOF LIGHT) E (WP	SANITARY SUMP PITS, DRAIN TILE SUMP, AND WATER HEATERS) ARE SUBJECT TO RELOCATION
WALL MOUNTED LIGHT	Q	DUE TO FIELD CONDITIONS.
WALL MOUNTED PUSH BUTTON	å PB	ELECTRICAL DEVICES: ABOVE FINISHED FLOOR: SWITCHES OVER COUNTER 48°. TO. CL
TWO WAY SWITCH	\$	WALL OUTLETS OVER COUNTER
THREE WAY SWITCH	35	+42" TO BOTTOM OF HORIZONTAL OUTLET(TYP. @ COUNTER)
FOUR WAY SWITCH	*\$	REMAINING SWITCHES
DIMMER SWITCH	\$P™	
EXHAUST VENTS	EVENT TO EXT	BATH VANITY BRACKET OUTLET
LOW VOLTAGE PANEL	- \$-	EXTERIOR GFI OUTLETS
PHONE OUTLET	⊕ PH	GARAGE GFI (ABOVE GARAGE FLOOR) 48" TO CL
TV OUTLET	⊕ TV	FRONT DOOR COACH LIGHT
DATA & RG6 COMBO BOX	₹	GARAGE DOOR COACH LIGHT, (ABOVE GARAGE FLOOR)
SMOKE DETECTOR	<u> </u>	THERMOSTAT
CARBON MONOXIDE SMOKE DETECTOR COMBO	⊚ CM/SD	DOORBELL CHIMES
DOOR CHIMES	CHIMES	KITCHEN HOOD FAN "WHIP"
ELECTRICAL PANEL	EP EP	KITCHEN WALL HUNG MICROWAVE OUTLET 72" TO CL KITCHEN DISHWASHER RECEPTACLE JINDER SINK
SURFACE MOUNT LED	•	KITCHEN RANGE
EXTERIOR WALL MOUNT UPLIGHT	쬬	KITCHEN REFRIGERATOR
COFFEE MOUNT FLOOR MOUT	A A	mnonenybrien objects


--- UCL

ELECTRICAL FIXTURE SCHEDULE

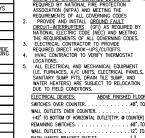


	ELECTRICAL DEVICES: ABOVE FINISHED FLOOR
	SWITCHES OVER COUNTER
	WALL OUTLETS OVER COUNTER
	+42" TO BOTTOM OF HORIZONTAL OUTLET(TYP. @ COUNTER)
-	REMAINING SWITCHES
_	WALL OUTLETS
-	BATH VANITY BRACKET OUTLET
_	WATER SOFTENER AND SUMP OUTLETS 48" TO
	EXTERIOR GFI OUTLETS
	GARAGE GFI (ABOVE GARAGE FLOOR) 48" TO
-	FRONT DOOR COACH LIGHT
	GARAGE DOOR COACH LIGHT, (ABOVE GARAGE FLOOR)
-	THERMOSTAT
4	DOORBELL CHIMES
	DOORBELL BUTTON
	KITCHEN HOOD FAN "WHIP"
	KITCHEN WALL HUNG MICROWAVE OUTLET 72" TO
_	KITCHEN DISHWASHER RECEPTACLE JINDER
	KITCHEN RANGE

CL = CENTER LINE 1 = FIELD VERIFY 2 = MASTER BATH STANDARD 30" HIGH VANITY TO BE RAISED 4"

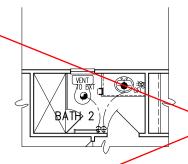

OPT. SHOWER ILO TUB (BED 3 OPT) PARTIAL ELECTRICAL PLAN

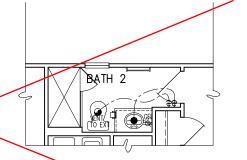

OPT. SHOWER ILO TUB (PWDR OPT) PARTIAL ELECTRICAL PLAN

OPTIONS ELEC. PLAN N: ALTIS @ SERENITY 68 SERENE XING SUBDIVISION:
ADDRESS: 68
LOT: 279 BL

Dointe HOMES RR BLD. SUITE 400, RALEIGH, NC 27607

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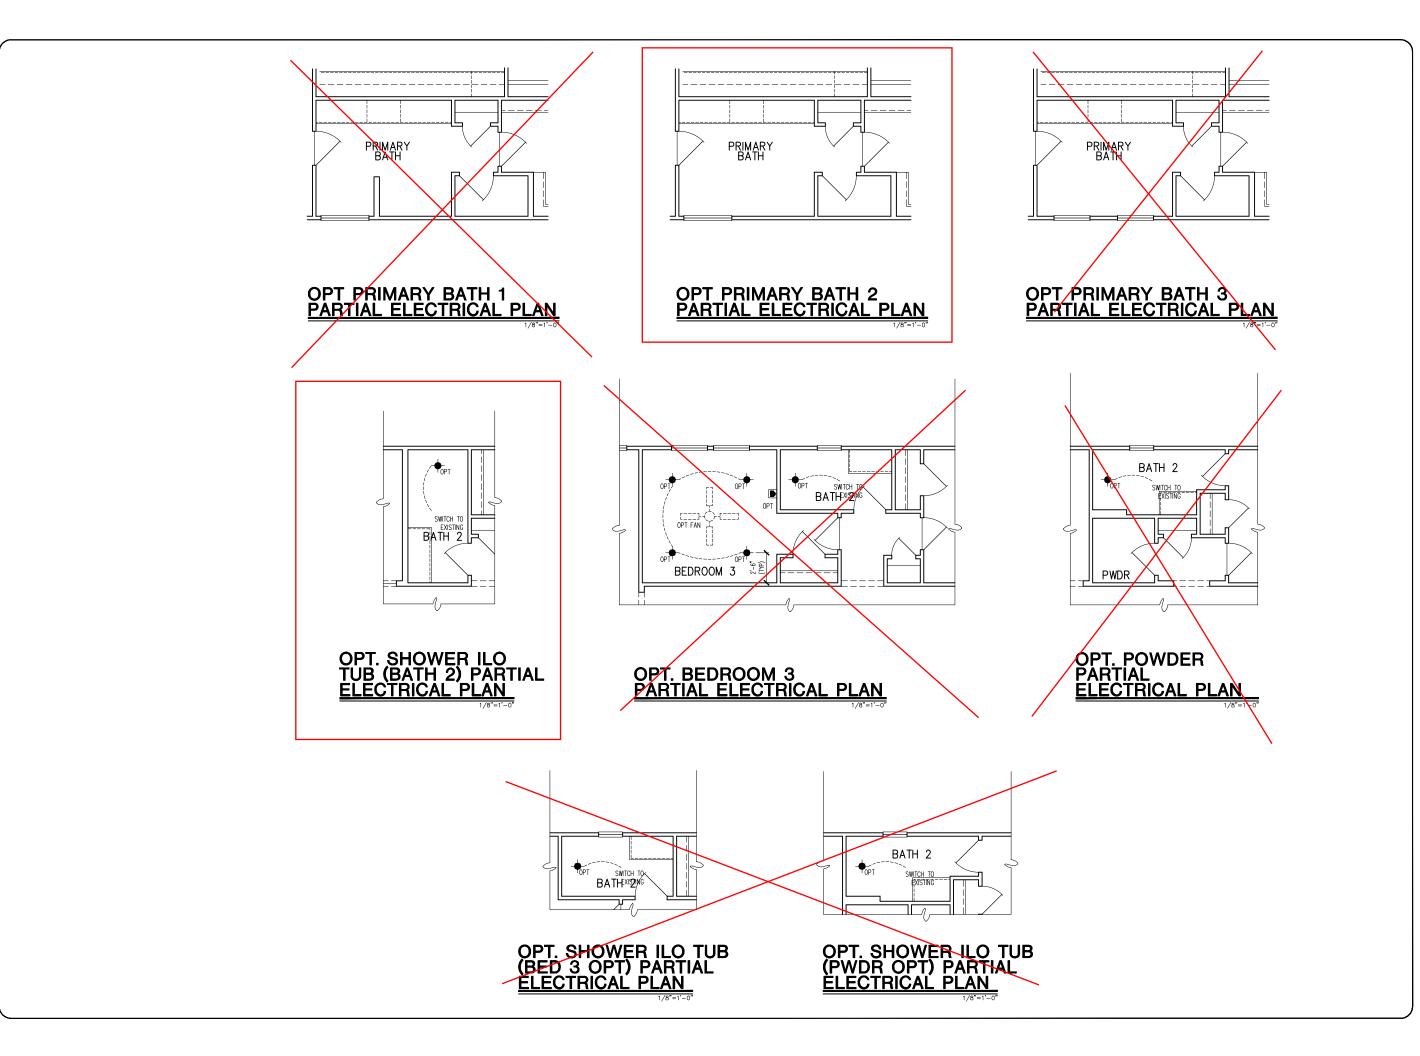
Business Operations 5440 Wade Park Blvd Suite 400 Raleigh, NC 27607

Issue Date: 11-17-24 ACC

5920-06

(SANDY LANE)

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HOMES

5440 WADE PARK BLVD, SUITE 400, RALEIGH, NG 27607

Business Operations 5440 Wade Park Blvd Suite 400 Raleigh, NC 27607

1st FLOOR ELEC. PLAN – OPTIONS
SUBDIVISION: ALTIS ® SERENITY
ADDRESS: 68 SERENE XING

SUBDIVISION:
ADDRESS: 68
LOT: 279 BL

Issue Date: 11-17-24 Drawn By: ACC

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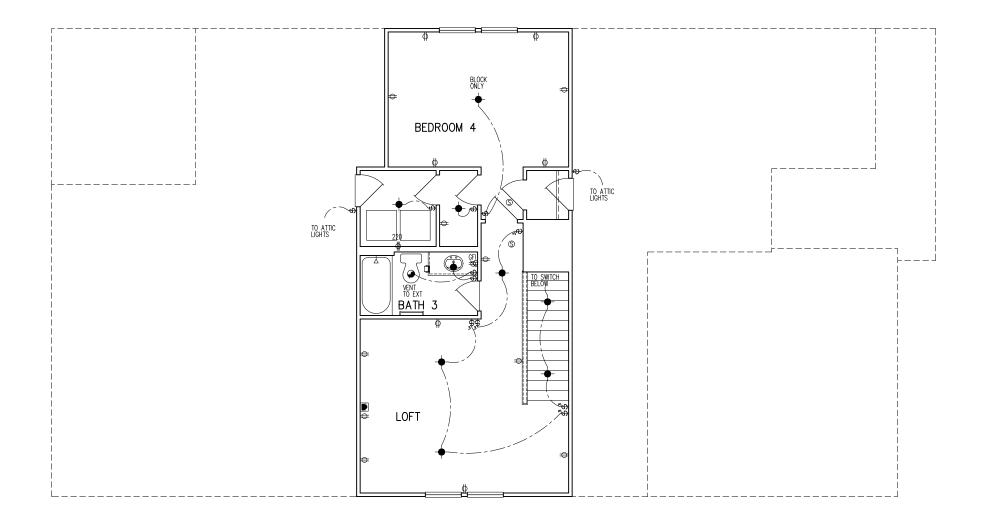
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ELECTRICAL FIXTURE SCHEDULE		
DESCRIPTION	SYMBOL	
110V OUTLET	ф	
220V OUTLET	 220	
1/2 HOT OUTLET	₩	
GFI OUTLET	₩ GFI	
WP GFI OUTLET	₩P/GFI	
GARAGE DOOR OPENER OUTLET	Ø GDO	
SECURITY SYSTEM	∯SEC SYS	
DISHWASHER	⊕ DW	
JUNCTION BOX	0	
CEILING MOUNTED LIGHT	-	
CEILING FAN w/ LIGHT KIT	BRAZIRE	
RECESSED CEILING LIGHT	Ø	
RECESSED WATER PROOF LIGHT	® WP	
WALL MOUNTED LIGHT	Q	
WALL MOUNTED PUSH BUTTON	₫ PB	
TWO WAY SWITCH	\$	
THREE WAY SWITCH	³\$	
FOUR WAY SWITCH	⁴ \$	
DIMMER SWITCH	\$ ^{DIM}	
EXHAUST VENTS	S VENT TO EXT	
LOW VOLTAGE PANEL	\$	
PHONE OUTLET	● PH	
TV OUTLET	⊜ TV	
DATA & RG6 COMBO BOX		
SMOKE DETECTOR	Ŝ	
CARBON MONOXIDE SMOKE DETECTOR COMBO	⊚ CM/SD	
DOOR CHIMES	CHIMES	
ELECTRICAL PANEL	EP.	
SURFACE MOUNT LED	•	
EXTERIOR WALL MOUNT UPLIGHT	8	
SOFFIT MOUNT FLOOD LIGHT	443	
UNDER COUNTER LIGHTING	-coc- UCL	
SMURF TUBE		

ELECTRICAL NOTES:

PROVIDE AND INSTALL LOCALLY CERTIFIED PROVIDE AND INSTALL LOCALLY CERTIFIED SMOKE AND CARSON MONOXIDE DETECTORS A REQUIRED BY NATIONAL FIRE PROTECTION ASSOCIATION (NFPA) AND MEETING THE REQUIREMENTS OF ALL GOVERNING CODES PROVIDE AND INSTALL GROUND FAULT (IRCUIT-INTERRUPTERS (GF)) AS REQUIRED BY NATIONAL ELECTRIC CODE (NEC) AND MEETING THE REQUIREMENTS OF ALL GOVERNING CODES. ELECTRICAL CONTRACTOR TO PROVIDE REQUIRED DIRECT HOOK—UPS/CUTOFFS. HVAC CONTRACTOR TO VERIFY THERMOSTAT LOCATIONS.
ALL ELECTRICAL AND MECHANICAL EQUIPMENT (I.E. FURNACES, A/C UNITS, ELECTRICAL PANELS, SANITARY SUMP PITS, DRAIN TIME SUMP, AND WATER HEATERS) ARE SUBJECT TO RELOCATION DUE TO FIELD CONDITIONS.
ELECTRICAL DEVICES: ABOVE FINISHED FLOOR. +42" TO BOTTOM OF HORIZONTAL OUTLET(TYP. @ COUNTER) GARAGE DOOR COACH LIGHT, (ABOVE GARAGE FLOOR). . . . 84".TO CL . .54" TO CL . . .84" TO CL THERMOSTAT. . DOORBELL CHIMES. . KITCHEN REFRIGERATOR. . . WASHER/DRYER OUTLET. . .

CL = CENTER LINE 1 = FIELD VERIFY 2 = MASTER BATH STANDARD 30" HIGH VANITY TO BE RAISED 4"



OPT. SECOND FLOOR PLAN PARTIAL ELECTRICAL PLAN

Dointe HOMES RR RIAD. SUITE 400, RALEIGH, NG 27607

Business Operations 5440 Wade Park Blvd Suite 400 Raleigh, NC 27607

OPTION @ SERENITY E XING ALTIS @ FLR ELEC.

SUBDIVISION:
ADDRESS: 68
LOT: 279 BL


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Issue Date: 11-17-24 Drawn By: ACC

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(SANDY LANE)

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OPT. SECOND FLOOR PLAN PARTIAL ELECTRICAL PLAN 1/8"=1'-0"

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Homes S

Business Operations 5440 Wade Park Blvd Suite 400 Raleigh, NC 27607

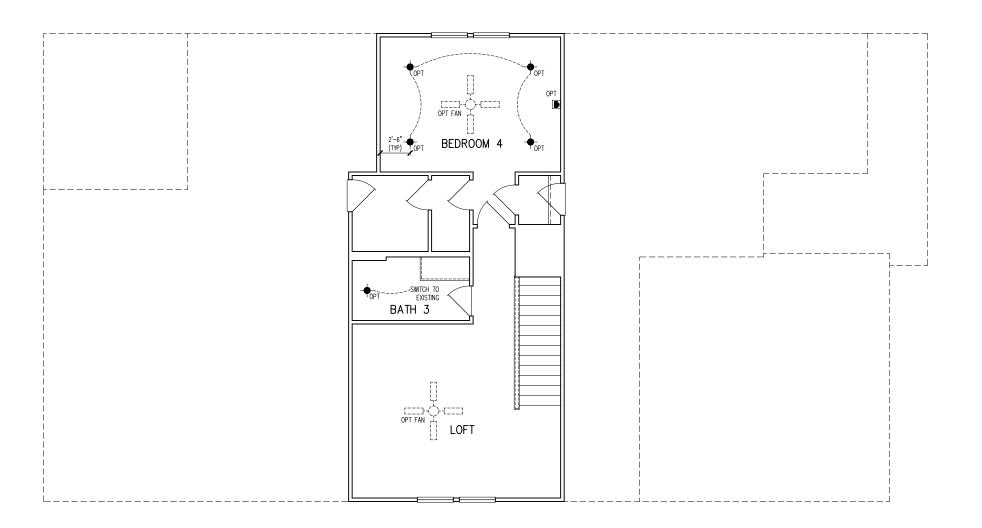SUBDIVISION: ALTIS ® SERENITY
ADDRESS: 68 SERENE XING
LOT: 279 BLOCK:

Issue Date: 11-17-24

Drawn By: ACC

5920-06

SANDY LANE

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GENERAL STRUCTURAL NOTES

FLOOR FRAMING

- L- IOISTS/TRUSSES SHALL BE DESIGNED BY MANUE TO MEET OR EXCEED L/480 LIVE LOAD DEFLECTION CRITERIA. (EXCLUDES STONE/MARBLE OR WET BED CONSTRUCTED FLOORS - CONTACT M&K FOR EXCLUDED FLOOR DESIGNS)
- PER THE GUIDELINES OF THE TILE COUNCIL OF NORTH AMERICA (TCNA HANDBOOK), IT SHALL BE THE FLOOR FINISH INSTALLER'S RESPONSIBILITY TO VERIEY THAT THE FINISHES TO BE INSTALLED MATCH THE DESIGN CRITERIA NOTED ABOVE (UNDER "DESIGN
- FLOOR SYSTEMS & SHEATHING HAVE BEEN DESIGNED TO SUPPORT ADDITIONAL DEAD LOAD FROM CERAMIC TILE (EXCLUDING MARBLE OR STONE). HOWEVER, IT SHALL BE THE FLOOR FINISH INSTALLER'S RESPONSIBILITY TO PROVIDE PROPER UNDERLAYMENT, UNCOUPLING MEMBRANE AND MORTAR/GROUT PER THE ASSEMBLY DESIGNATIONS IN THE TONA HANDBOOK (TILE COUNCIL OF NORTH AMERICA).
- AT I-JOIST FLOORS, PROVIDE I 1/8" MIN. OSB RIM BOARD.
- METAL HANGERS SHALL BE SPECIFIED BY MANUFACTURER, U.N.O.
- I-JOIST/TRUSS SHOP DWGS. SHALL BE SUBMITTED TO ARCH. & ENG. FOR REVIEW AND APPROVAL PRIOR TO FABRICATION OR DELIVERY
- FLOOR SHEATHING SHALL BE 23/32" A.P.A. RATED 'STURD-I-FLOOR' 24" O.C, EXPOSURE I (OR APPROVED EQUAL) WITH TONGUE AND GROOVE EDGES. FASTEN TO FRAMING MEMBERS W GLUE AND
- 2 ½" x 0.131" NAILS @ 6"o.c. @ PANEL EDGES \$ @ 12"o.c. FIELD.
- 2 3 × 0.120 NAILS @ 4 O.C. @ PANEL EDGES \$ @ 8 O.C. FIELD.
- 2 3 × 0.113 NAILS @ 3" O.C. @ PANEL EDGES \$ @ 6" O.C. IN FIELD

ROOF FRAMING

- ROOF SHEATHING SHALL BE 1/16" A.P.A. RATED SHEATHING 24/16 EXPOSURE I (OR APPROVED EQUAL). FASTEN TO FRAMING MEMBERS
- W/ 2 1 × 0.131" NAILS @ 6"O.C. @ PANEL EDGES \$ @ 12" O.C. FIELD.
- w/ 2 🖁 × 0.120" NAILS 4"o.c. PANEL EDGES \$ 8" O.C. FIELD. - w/ 2 🖁 × 0.113" NAILS @ 3"o.c. @ PANEL EDGES \$ @ 6" O.C. FIELD.
- WITHIN 48" OF ALL ROOF FDGES RIDGES & HIPS FASTEN ROOF SHEATHING FIELDS PER EDGE NAILING SPEC.
- FASTEN EACH ROOF TRUSS TO TOP PLATE W/ SIMPSON H25T CLIP (OR APPROVED EQUAL) • ALL BEARING POINTS. PROVIDE (2) H2.51 CLIPS AT 2-PLY GIRDER TRUSSES, (3) H2.5T CLIPS AT 3-PLY GIRDER TRUSSES & ROOF BEAMS - AT ALL BEARING POINTS.
- METAL HANGERS SHALL BE SPECIFIED BY THE MANUFACTURER, U.N.O.
- ROOF TRUSS SHOP DWGS SHALL BE SUBMITTED TO ARCH & ENG. FOR REVIEW AND APPROVAL PRIOR TO FABRICATION OR DELIVERY
- ERECT AND INSTALL ROOF TRUSSES PER WTCA & TPI'S BCSI I "GUIDE TO GOOD PRACTICE FOR HANDLING, INSTALLING & BRACING
- OF METAL PLATE CONNECTED WOOD TRUSSES." SUPPORT SHORT SPAN ROOF TRUSSES w/2x4 LEDGER FASTENED TO

FRAMING w/(2) 3" x 0.120" NAILS @ 16" O.C. (UP TO 7' SPAN).

CONNECTION SPECIFICATIONS (TYP. U.N.O.)

DESCRIPTION OF BLDG, ELEMENT	3"x0.131" NAIL5	3"x0.I20" NAIL5			
JOIST TO SOLE PLATE SOLE PL. TO JOIST/RIM OR BLK'S STUD TO PLATE RIM TO TOP PLATE BLK'G BTWN, JOISTS TO TOP PL. DOUBLE STUD DOUBLE TOP PLATE DOUBLE TOP PLATE LAP SPLICE	(3) TOENAILS NAILS @ 4" O.C. (4) TOENAILS / (3)END NAILS TOENAILS @ 6" O.C. (3) TOENAILS EA, END NAILS @ 16" O.C. NAILS @ 12" O.C. (12) NAILS IN LAPPED AREA (24" MIN.)	(3) TOENAILS* NAILS @ 4" O.C. (4) TOENAILS / (4)END NAILS* TOENAILS @ 4" O.C.* (3) TOENAILS EA. END* NAILS @ 6" O.C. NAILS @ 6" O.C. (15) NAILS IN LAPPED AREA (24" MIN.)			
TOP PLATE LAP @ CORNERS & INTERSECTING WALLS	(3) NAILS	(3) NAILS			
RAFTER/TRUSS TO TOP PLATE	(4) TOENAILS + (I) SIMPSON H2.5T	(4) TOENAILS + (I) SIMPSON H2.5T			
GAB. END TRUSS TO DBL. TOP PL. R.T. w/ HEEL HT. 9 1/4" TO 12"	TOENAILS @ 8" o.c. 2x10 BLK EVERY 3RD BAY FASTENED TO DBL. TOP PLATE W/ TOENAILS @ 6" O.C.	TOENAILS © 6" o.c. 2xIO BLK EVERY 3RD BAY FASTENED TO DBL. TOP PLATE W/ TOENAILS © 4" O.C.			
R.T. w/ HEEL HT. 12" TO 16"	2XI2 BLK EVERY 3RD BAY FASTENED TO DBL. TOP PLATE W/ TOENAILS @ 6" O.C.	2x12 BLK EVERY 3RD BAY FASTENED TO DBL. TOP PLATE W/ TOENAILS @ 4" O.C.			
R.T. w/ HEEL HT. UP TO 24"	LAP WALL SHTG. W/ DBL. TOP PL. \$ INSTALL ON TRUSS VERT FASTEN W/ NAILS @ 6" O.C.	LAP WALL SHTG. W/ DBL. TOP PL. \$ INSTALL ON TRUSS VERT FASTEN W/ NAILS @ 6" O.C.*			
R.T. w/ HEEL HT. 24" TO 48"	LAP WALL SHTG, W/ DBL, TOP PL. & INSTALL ON TRUSS VERT FASTEN W/ NAILS @ 6" O.C. PROVIDE 2x BLK @ EA, BAY AT TOP OF HEEL	LAP WALL SHTG. W/ DBL. TOP PL. & INSTALL ON TRUSS VERT FASTEN W/ NAILS @ 6" O.C. PROVIDE 2x BLK @ EA. BAY AT TOP OF HEEL.			
WALL TO FOUNDATION	WALL SHTG. LAP W/ SILL PL. \$ FASTENED PER SHEAR WALL FASTENING SPEC.				
* 2½"x0.113 IS AN ACCEPTABLE ALTERNATIVE TO A 3"x0.120", SAME SPACING OR NUMBER OF NAILS. (ONLY ACCEPTABLE WHERE * ARE SHOWN)					

GENERAL STRUCTURAL NOTES

DESIGN LOADING

- DESIGN IS BASED ON 2018 NORTH CAROLINA STATE BUILDING CODE: RESIDENTIAL CODE.
- WOOD FRAME ENGINEERING IS BASED ON NDS, "NATIONAL DESIGN SPECIFICATION FOR WOOD CONSTRUCTION" - LATEST EDITION

DESIGN LOADS ROOF

SNOW = 15 PSF (12 PSF GROUND SNOW, TRUSSES) LIVE = 20 PSF (REDUCIBLE BASED ON ROOF PITCH) DEAD = 7 PSE TG. TO PSE BG. LOAD DURATION FACTOR = 1.25

LIVE = 40 PSE (30 PSE @ SLEEPING AREAS)

DEAD = 10 PSF (I-JOISTS), 15 PSF (FLOOR TRUSSES) ADD'L TO PSE @ CERAMIC TILE IN KITCHEN. SUNROOMS, BATHS, FOYER, LAUND. & MUDRMS

2,000 PSF ASSUMED ALLOWABLE BEARING PRESSURE

(TO BE VERIFIED BY BUILDER)

115 MPH, EXPOSURE B

GENERAL FRAMING

- ALL TYP. NAIL FASTENER REQUIREMENTS ARE NOTED IN STANDARD CONNECTIONS TABLE (IRC TABLE R602.3(I)) OR ON PLANS. ALL NAILS SPECIFIED ARE MIN DIAMETER AND LENGTH REQUIRED FOR CONNECTION. ALL HANGER NAILS SHALL BE INSTALLED PER MANUFACTURER'S REQUIREMENTS FOR MAX CHARTED CAPACITY NOTE: HANGERS USE COMMON NAIL DIAMETERS NOT TYPICAL FRAMING GUN NAILS.
- EXT. & INT. BEARING WALLS SHALL BE 2x4 OR 2x6 (AS SHOWN ON PLANS) @ 16" O.C. SPF/SP #2 GRADE LUMBER, OR BETTER, U.N.O.. . WALLS OVER 12' TALL SHALL BE PER PLAN.
- ALL INTERIOR BEARING WALLS ARE ASSUMED TO BE SHEATHED W/ GYP WALL BOARD (ONE SIDE MIN.) OR PROVIDE MID HT. BLOCKING.
- ALL HEADERS, BEAMS & OTHER STRUCTURAL MEMBERS SHALL BE SPRUCE-PINE-FIR #2 (SPE) OR SOUTHERN PINE #2 (SP) LUMBER OR BETTER, SUPPORT ALL HEADERS/ BEAMS W/ (1)2x JACK STUD & (1)2x KING STUD MINIMUM
- THE NUMBER OF STUDS SPECIFIED AT A SUPPORT INDICATES THE NUMBER OF JACK STUDS REQUIRED, U.N.O.,
- ALL NON-BEARING INTERIOR STUD WALLS SHALL BE CONSTRUCTED WITH 2x 'STUD' GRADE MEMBERS SPACED € 24" O.C. (MAX., U.N.O.)

 ◆ HEADERS IN NON-LOAD BEARING WALLS SHALL BE: (1)2x4/6 FLAT @ OPENINGS UP TO 4', (2)2x4/6 FLAT UP TO 8'.
- ALL FRAMING LUMBER SHALL BE DRIED TO 15% MC (KD-15).
- ENGINEERED LUMBER BEAMS TO MEET OR EXCEED THE FOLLOWING: • 'LVL' - Fb=2600 psi; Fv=285 psi; E=2.0x10^6 psi
- ENGINEERED LUMBER POSTS TO MEET OR EXCEED THE FOLLOWING 'LVL' - Fb=2400 psi; FcII=2500 psi; E=I.8xI0^6 psi
- FOR 2 \$ 3 PLY BEAMS OF EQUAL 134" MAX, WIDTH, FASTEN PLIES TOGETHER WITH 3 ROWS OF 3"X0.120" NAILS @ 8" O/C OR 2 ROWS K"x3K" SIMPSON SDS SCREWS (OR 3K" TRUSSI OK SCREWS) @ 16" GREATER APPLY EASTENING AT BOTH FACES FOR 3-PLY CONDITION. LOCATE TOP & BOTTOM NAILS/SCREWS 2" FROM EDGE. SOLID 31/3" OR 51/4" BEAMS ARE ACCEPTABLE, USE 2 ROWS OF NAILS FOR 2x6 \$ 2x8 MEMBERS
- FOR 4 PLY BEAMS OF FOUAL 13/4" MAX, WIDTH, FASTEN PLIES TOGETHER WITH 3 ROWS OF $\frac{1}{4}$ "x6" SIMPSON SDS SCREWS (OR 6 $\frac{3}{4}$ " TRUSSLOK SCREWS) @ 16" O/C. USE A MINIMUM OF 4 ROWS FOR BEAM DEPTHS OF 14" OR GREATER, APPLY EASTENING AT BOTH FACES (ONE SIDE ONLY FOR TRUSSLOK SCREWS). LOCATE TOP AND BOTTOM SCREWS 2" FROM EDGE, A SOLID 7" BEAM IS ACCEPTABLE
- PROVIDE SOLID BLOCKING IN FLOOR SYSTEM UNDER ALL POSTS CONTINUOUS TO FND./BEARING, BLOCKING TO MATCH POST ABOVE.
- ALL EXTERIOR 4x4 WOOD POSTS SHALL HAVE SIMPSON BCS2-2/4
- · CORROSION NOTES
- BUILDER RESPONSIBLE TO DETERMINE CORROSION-RESISTANCE REQUIREMENTS AND COMPATIBILITY OF HARDWARE FASTENERS AND CONNECTORS FOR ENVIRONMENTAL EXPOSURE AND IN CONTACT W/ PRESERVATIVE-TREATED WOOD OF ACTUAL FINAL CONDITIONS AND SOURCED MATERIALS. CONTACT LUMBER \$ HARDWARE SUPPLIERS TO COORD.

GENERAL STRUCTURAL NOTES

FOUNDATION

- DESIGN IS BASED ON 2018 NORTH CAROLINA STATE BUILDING CODE:
- FOOTING DESIGN 2,000 PSF ALLOWABLE SOIL BEARING PRESSURE IS ASSUMED. BUILDER/CONTRACTOR MUST VERIFY.
- FASTEN 2x4/6 SILL PLATES TO CONC FND WITH A MINIMUM OF 2
- ANCHORS PER PLATE 12" MAX FROM PLATE ENDS UTIL 17ING
 - I/2" DIA. ANCHOR BOLTS 6'-0" O.C,7" MIN. EMBEDMENT I/2" DIA. x 6" LONG SIMPSON TITEN HD @ 6'-0" O.C.
 - SIMPSON MASA ANCHOR STRAPS @ 6'-0" O.C. (CONCRETE)
- ALL LUMBER EXPOSED TO WEATHER OR IN CONTACT W/ PERIMETER
- FOUNDATION SHALL BE PRESERVATIVE TREATED SOUTHERN PINE #2.
- BUILDER TO VERIEY CORROSION-RESISTANCE COMPATIBILITY OF HARDWARE & FASTENERS IN CONTACT W/ PRESERVATIVE-TREATED WOOD, CONTACT LUMBER & HARDWARE SUPPLIERS TO COORD.
- FOOTINGS SHALL BE PLAIN CONCRETE, U.N.O.
- CONCRETE DESIGN BASED ON ACL 318, CONCRETE SHALL ATTAIN THE FOLLOWING MIN. COMPRESSIVE STRENGTHS IN 28 DAYS, U.N.O. f'c = 3,000 psi: FOOTINGS & INTERIOR SLABS ON GRADE 3,500 psi: GARAGE & EXTERIOR SLABS ON GRADE fu = 60.000 psi
- ALL CONCRETE EXPOSED TO THE WEATHER SHALL NOT HAVE LESS THAN 5% OR MORE THAN 7% AIR ENTRAINMENT
- ALL FOOTINGS SHALL BEAR BELOW FROST LINE (TYP.) OR 12" MIN IN REGIONS WHERE CODE FROST DEPTH IS NOT APPLICABLE. CONSULT SOILS REPORT OR BUILDING DEPT. FOR MINIMUM DEPTH BELOW GRADE
- FOOTINGS AND SLABS ON GRADE SHALL BEAR ON VIRGIN SOIL OR
- PROVIDE CONTROL JOINTS AT ALL INSIDE CORNERS OF SLAB EDGES, AND OTHER LOCATIONS WHERE SLAB CRACKS ARE LIKELY TO DEVELOP
- . JOINTS SHALL BE LOCATED @ 10'-0" O.C. (RECOMMENDED) OR 15'-0" O.C. (MAXIMUM)
- LOINT GRID PATTERN SHALL BE AS CLOSE TO SQUARES AS POSSIBLE (I:I RATIO), WITH A MAXIMUM OF I:1.5 RATIO
- · CONTROL JOINTS SHALL NOT BE INSTALLED IN STRUCTURAL
- DIMENSIONS BY OTHERS, BUILDER TO VERIFY.

HOLD-DOWN SCHEDULE

SYMB0L	SPECIFICATION	
► HD-I	SIMPSON CSI6 STRAP TIE W/ 14" END LENGTH	
HD-2	SIMPSON MSTC66 STRAP TIE W 24" END LENGTH	
▶ HD-3	SIMPSON HTT4 HOLD-DOWN *	
► HD-4	SIMPSON HDU5-SD52.5 HOLD-DOWN *	
HD-5	SIMPSON STHDI4RJ HOLD-DOWN *	

UTILIZE SIMPSON "SET-3G" FROXY SYSTEM TO EASTEN %" DIA, THREADED ROD INTO CONCRETE FOUNDATION, PROVIDE 12" MIN. EMBEDMENT INTO CONCRETE. INSTALL PER MANUE RECOMMENDATIONS DO NOT LOCATE ANCHORS WITHIN I 3/4" OF EDGE OF FOUNDATION

MEANS & METHODS NOTES

THE STRUCTURE IS DESIGNED TO BE SELF SUPPORTING AND STABLE AFTER THE BUILDING IS FINISHED AND ALL PLAN, DETAIL, AND NOTE SPECIFICATIONS HAVE BEEN COMPLETED. IT IS THE CONTRACTOR'S SOLE RESPONSIBILITY TO DETERMINE THE ERECTION PROCEDURES AND SEQUENCE TO THE SAFETY OF THE BUILDING AND ITS COMPONENTS DURING CONSTRUCTION. THIS INCLUDES BUT IS NOT LIMITED TO, THE ADDITION OF NECESSARY SHORING, SHEETING, TEMPORARY BRACING, GUYS, AND TIE-DOWNS. CONTRACTOR SHALL BE RESPONSIBLE FOR ALL SHORING AND BRACING REQUIRED TO STABILIZE AND PROTECT EXISTING AND ADJACENT STRUCTURES AND SYSTEMS DURING COURSE OF DEMOLITION AND CONSTRUCTION OF THE PROJECT

STRUCTURAL DESIGN AND SPECIFICATIONS ASSUME THAT ALL SUPPORTING AND NON-SUPPORTING ELEMENTS IN CONTACT WITH FLOOR FRAMING ARE LEVEL, INCLUDING, BUT NOT LIMITED TO: FOUNDATIONS. SLABS ON GRADE, BEAMS, WALLS, AND NON-BEARING ELEMENTS. IT IS THE CONTRACTOR'S RESPONSIBILITY TO VERIEY LEVELNESS AND MAKE ADJUSTMENTS AS NECESSARY, INCLUDING CONSIDERATION OF THOSE AREAS THAT MAY BE WITHIN CONTRACTUAL, INDUSTRY OR WARRANTY TOLERANCES

VENEER LINTEL SCHEDULE

п				
		SPAN (MAX)	HEIGHT OF VENEER ABOVE LINTEL	STEEL ANGLE SIZE
		3'-0"	20 FT. MAX	L3"x3"x¼"
l			3 FT. MAX	L3"x3"x¼"
l		6'-0"	I2 FT. MAX	L4"x3"x¼"
			20 FT. MAX	L5"x3½"x¾;"
l		8'-0"	3 FT. MAX	L4"x4"x¼" *
l			I2 FT. MAX	L5"x3½"x¾;"
			l6 FT. MAX	L6"x3½"x³%"
l		9'-6"	I2 FT. MAX	L6"x3½"x%;"
		16'-0"	2 FT. MAX	L7"x4"x½" **
١		I	2 ET MAY	@"\/\"\ K" ##

- IL LINTELS

 \$40LL SIPPORT 2 %* 3 ½" YINDEER W 40 POF MAXIMIM MEIGHT.

 169 SHALL HAVE 4" MN. BEARING

 169 SHALL HAVE 9" MN. BEARING

 169 SHALL HAVE 9" MN. BEARING

 169 SHALL BAT SET PASTINED PACK TO HEADER IN WALL 4049" oz. w/ ½" DIA. x 3 ½"

 LONG LAG 50/ENPG IN 2" LONG YERTICALLY \$LOTTED HALES.

 MAX. YEBER IN APPLIES TO ANY FORTION OF PROKO CAPE THE OPENING.

 ALL INITES 99 SHALL BE LONG LEG YERTICAL.

 MAY BEC OT IN THE PIELD TO BE 3½" MIDE OVER THE BEARING LISGITH ONLY. THIS

 SET STRUCTUREN ANY FOR SOME THE EXTERIOR TOE OF THE HORIZONTAL LEG

 MAY BEC OT IN THE PIELD TO BE 3½" MIDE OVER THE BEARING LISGITH ONLY. THIS

 SET STRUCTUREN ANY FOR SOME THE ANY ELGONOMY.

 ABOVE PRARAMETERS.
- * FOR QUEEN VENEER USE L4x3%;". ** FOR 3½" VENEER ONLY, SEE FLAN FOR VENEER SUPPORT IF VENEER < 3½" THICK

ADDITIONAL NOTES FOR TRUSS & I-JOIST MANUFACTURER

ROOF TRUSS, FLOOR TRUSS AND ENGINEERED JOISTS SHALL BE DESIGNED TO MEET THE DEFLECTION CRITERIA BELOW, UNLESS NOTED OTHERWISE ON PLAN. MULHERN & KULP CANNOT BE HELD RESPONSIBLE FOR ANY STRUCTURAL ISSUES
RELATED TO ANY BUILDING COMPONENT IF COMPONENT SHOP DRAWINGS ARE NOT SUBMITTED TO M&K FOR REVIEW PRIOR TO FABRICATION, DELIVERY, OR INSTALLATION.

TRUSSES/LIGISTS SHALL BE DESIGNED SO THAT DIFFERENTIAL DEFLECTION BETWEEN ADJACENT PARALLEL TRUSSES/JOISTS OR GIRDER TRUSSES/FLUSI BEAMS DO NOT EXCEED THE FOLLOWING: A ROOF TRUSSES.

1/4" DEAD LOAD

B. FLOOR TRUSSES, ATTIC TRUSSES, \$ 1-JOISTS: 1/8" DEAD LOAD

ABSOLUTE DEAD LOAD DEFECTION OF FLOOR

TRUSSES/ATTIC TRUSSES WHEN ADJACENT TO FLOOR FRAMING BY OTHERS SHALL BE LIMITED TO 3/16". (NO DIFFERENTIAL DEFLECTION

FLOOR JOIST NOTES

- ALL FLOOR JOISTS SHALL BE THE DEPTI SPECIFIED ON PLAN - FLOOR JOISTS SERIES & SPACING IS PER THE FLOOR JOIST MANUF.
 - SPACING SHALL NOT EXCEED 19.2" O.C. (MAX.) @ LOCATION OF TILE: SPACING SHALL NOT EXCEED 16" O.C. (MAX.)

LATERAL/WALL BRACING & WALL SHEATHING SPECIFICATIONS

> THIS MODEL HAS BEEN DESIGNED TO RESIST LATERAL FORCES RESULTING FROM:

MPH WIND IN 2018 NCSBC:RC

(115 MPH WIND SPEED IN ASCE 7-10 WIND MAP, PER IRC R301,2,1,1) EXP. B, RISK CAT. 2 & SEISMIC CAT. A/B.

THE DESIGN WAS COMPLETED PER 2015 IBC (SECTION 1609) & ASCE 7-10. AS PERMITTED BY R301,1,3 OF THE 2018 NCSBC:RC, ACCORDINGLY, THIS MODEL, AS DOCUMENTED AND DETAILED HEREWITHIN, IS ADEQUATE TO RESIST THE CODE REQUIRED LATERAL FORCES.

DESIGN WIND UPLIET LOADS HAVE BEEN CALCULATED UTILIZING ASCE 7-10 (ACCEPTED ENGINEERING PRACTICE) AS ALLOWED PER 2018 NCSBC:RC SECTION R802.II.I.I. THIS MODEL HAS BEEN DETAILED WHERE REQUIRED & ENGINEERED TO RESIST THE WIND UPLIFT LOAD PATH PER SECTIONS R602.3.5¢ R802.II.

EXT. WALL SHEATHING SPECIFICATION

- 7/16" OSB OR 15/32" PLYWOOD: FASTEN SHEATHING W/ 2 ₹ "x0.II3 NAIL5 @ 6" O.C. AT EDGES & @ 12" O.C. IN THE PANEL FIELD. (TYP, U.N.O.) ALL SHEATHING PANELS SHALL BE ORIENTED
- VERTICALLY (LONG DIRECTION PARALLEL TO STUDS) AND INSTALLED FULL HEIGHT OF SHEAR WALL - OR 2x HORIZONTAL BLOCKING SHALL BE PROVIDED TO SUPPORT ALL UNSUPPORTED PANEL EDGES & EDGE
- ALL EXT. WALLS SHALL BE CONTINUOUSLY SHEATHED AND ARE CONSIDERED SHEAR WALLS.
- ALT, STAPLE CONNECTION SPEC: 1 3/4" 16 GA STAPLES (1/6" CROWN) @ 3" O.C. AT EDGES \$ @ 6" O.C IN FIELD.


3" O.C. EDGE NAILING

AT DESIGNATED AREAS - FASTEN PANEL EDGES OF WOOD STRUCTURAL WALL SHEATHING TO FRAMING W 2 3" × 0.113" NAILS @ 3" O.C. AND 12" O.C. IN THE PANEL FIELD NO STAPLE ALTERNATIVE AVAILABLE AT THIS SPEC. ALL SHEATHING PANELS SHALL BE ORIENTED VERTICALLY (LONG DIRECTION PARALLEL TO STUD) AND INSTALLED FULL HEIGHT OF SHEAR WALL - OR - 2x HORIZONTAL BLOCKING SHALL BE PROVIDED TO SUPPORT UNSUPPORTED PANEL EDGES AND 3" O.C. EDGE FASTENING.

TYP. UNIT SEPARATION WALL SHEATHING SPECIFICATION

1/2" OR 5/8" GYPSUM WALL BOARD: FASTEN GWB SHEATHING TO FRAMING W/ 1 3"X0.086" COOLER NAILS OR I &" DRYWALL SCREWS @ 7" O.C. PANEL EDGES € PANEL FIELD (INCLUDING T&B PLATES

- SEE CONNECTION SPECIFICATIONS CHART FOR STANDARD SHEAR TRANSFER DETAILING, IF ADDITIONAL CAPACITY IS REQUIRED BY DESIGN. T WILL BE SPECIFICALLY NOTED ON PLAN.
- DESIGN ASSUMES 16" O.C MAX. STUD SPACING, U.N.O.
- ALL STRUCTURAL PANELS ARE TO BE DIRECTLY APPLIED TO STUD FRAMING.
- PRE-MANUFACTURED PANELIZED WALLS: FASTEN TOGETHER END STUDS OF WALL PANELS SHEATHED W/ OSB OR PLYWOOD W/ 3" x 0.120" NAILS @ 4" O.C. (THRU ONE SIDE ONLY)

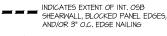

NDICATES HOLDOWN

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lulhern+Kulp project number 243-2403

SMŁ NGC ssue date: 08-16-2024

REVISIONS

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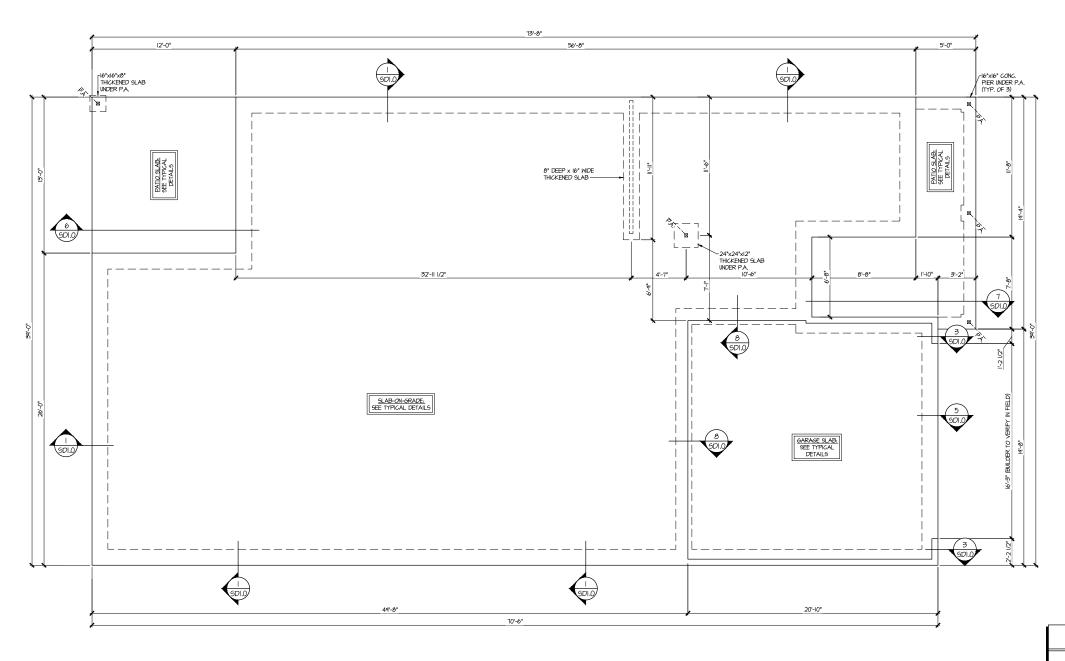
NOTE

90-SERENITY MASTER SET RALEIGH, NC 5920

GENERAL

S0.0

Reference S1.1 for Elevation C Details



SLAB FOUNDATION PLAN SCALE: |/4"=1'-0" (22x24 SHEET) |/8"=1'-0" (||x|1 SHEET) ELEV. A

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NC Licence # C-36.25

Mulhern+Kulp project number: 243-24032

SMK drawn by: NGG issue date: 08-16-2024

REVISIONS:

date: 11/07/2024 ARCH UPDATE initial: SMM

tri pointe

- INTERIOR BEARING WALL
- ==== BEARING WALL ABOVE (B.W.A.)
- BEAM / HEADER
- INDICATES EXTENT OF INT.

 OSB SHEARWALL AND/OR
 3" O.C. EDGE NAILING
- EXTENT OF VALLEY TRUSS OVERFRAMING

 24" O.C. (MAX.)

LEGEND

- NDICATES HOLDOWN
- JL METAL HANGER
- INDICATES POST ABOVE. PROVIDE SOLID BLOCKING UNDER POST OR JAMB ABOVE.


REFER TO SO.O FOR TYPICAL STRUCTURAL NOTES # SCHEDULES


FOUNDATION PLAN 5920-06 MODEL

S1.0

SERENITY MASTER SET RALEIGH, NC

Elevation C

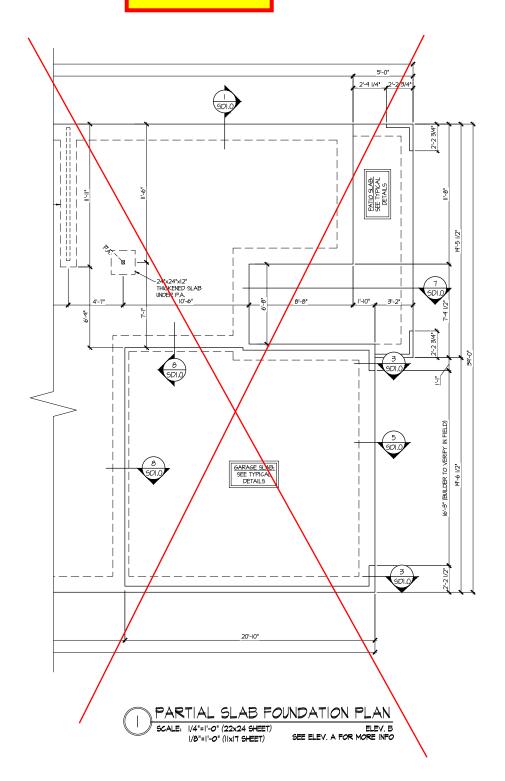

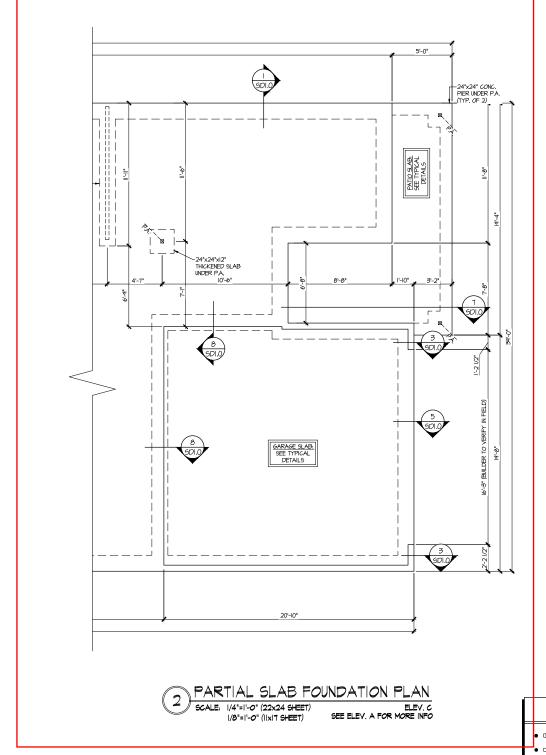

Session Self-

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\$ 770-777-9074 • multiperiority com
NC Licence # C-2925

Mulhern+Kulp project number:

243-24032

project mgr: SMK drawn by: NGC issue date: 08-16-2024

REVISIONS:

date: initial:
II/OT/2024 SMM
ARCH UPDATE

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FOUNDATION PLAN 5920-06 MODEL

LEGEND

■ INTERIOR BEARING WALL
■ □==== BEARING WALL ABOVE (B.W.A.)

• ---- BEAM / HEADER

INDICATES EXTENT OF INT.

OSB SHEARWALL AND/OR
3" O.C. EDGE NAILING

EXTENT OF VALLEY TRUSS OVERFRAMING
24" O.C. (MAX.)

EXTENT OF FLOOR SYSTEM TO BE DESIGNED FOR TILE

NDICATES HOLDOWN

JL METAL HANGER

* INDICATES POST ABOVE. PROVIDE SOLID BLOCKING UNDER POST OR JAMB ABOVE.

REFER TO SO.O FOR
TYPICAL STRUCTURAL NOTES


\$ SCHEDULES

sheet:

S1.1

SERENITY MASTER SET RALEIGH, NC

Reference S2.1 for Elevation C Details

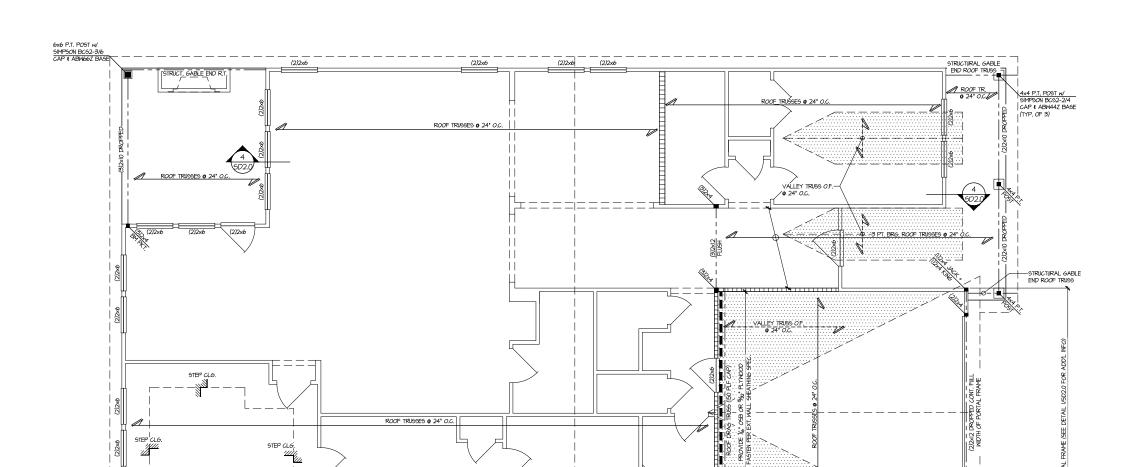

3 5D2.0

OPT. PRIMARY BATH 3

(2)2x6

LINE OF BOX

@ OPT, MDM: (2)2x6

ROOF FRAMING PLAN SCALE: 1/4"=1'-0" (22x24 SHEET) ELEV. A 1/8"=1'-0" (IIxIT SHEET)

THIS LEVEL HAS BEEN DESIGNED FOR 9'-I" PLATE HEIGHT

LEGEND

- IIIIII INTERIOR BEARING WALL
- □===□ BEARING WALL ABOVE (B.W.A.)
- BEAM / HEADER
- INDICATES EXTENT OF INT.

 OSB SHEARWALL AND/OR
 3" O.C. EDGE NAILING
- EXTENT OF VALLEY TRUSS OVERFRAMING

 24" O.C. (MAX.)
- EXTENT OF FLOOR SYSTEM TO BE DESIGNED FOR TILE
- NDICATES HOLDOWN

- INDICATES POST ABOVE. PROVIDE SOLID BLOCKING UNDER POST OR JAMB ABOVE.

REFER TO SO.O FOR TYPICAL STRUCTURAL NOTES # SCHEDULES

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SMK drawn by: NGG issue date: 08-16-2024

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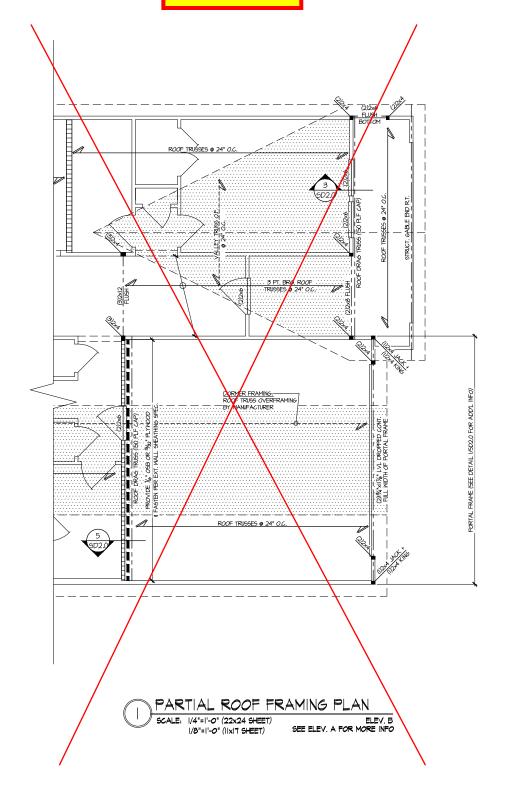
initial: 11/07/2024 ARCH UPDATE SMM


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ROOF FRAMING PLAN

5920-06 MODEI SERENITY MASTER SET RALEIGH, NC

S2.0



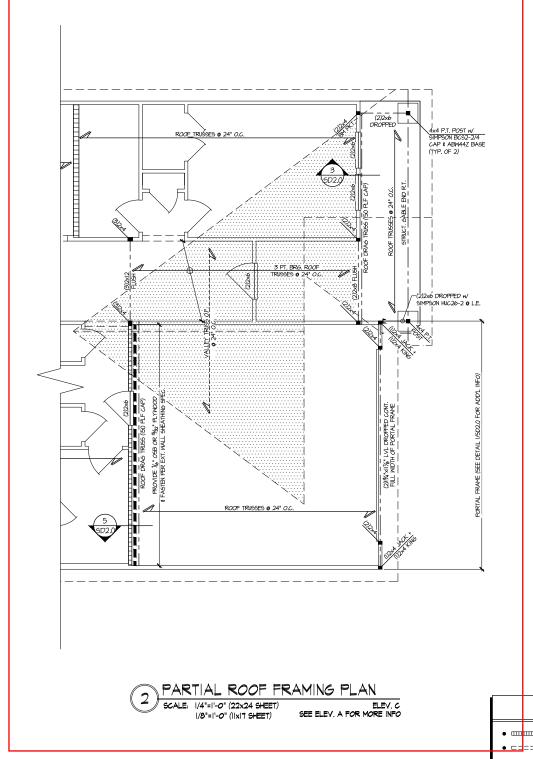

THIS LEVEL HAS BEEN DESIGNED FOR 9'-1" PLATE HEIGHT

REFER TO SO.O FOR TYPICAL STRUCTURAL NOTES # SCHEDULES

• IIII INTERIOR BEARING WALL

LEGEND

• □==== BEARING WALL ABOVE (B.W.A.)

BEAM / HEADER

INDICATES EXTENT OF INT.

OSB SHEARWALL AND/OR
3" O.C. EDGE NAILING

EXTENT OF VALLEY TRUSS OVERFRAMING

2 24" O.C. (MAX.)

EXTENT OF FLOOR SYSTEM TO BE DESIGNED FOR TILE

► INDICATES HOLDOWN

JL METAL HANGER

* INDICATES POST ABOVE. PROVIDE SOLID BLOCKING UNDER POST OR JAMB ABOVE.

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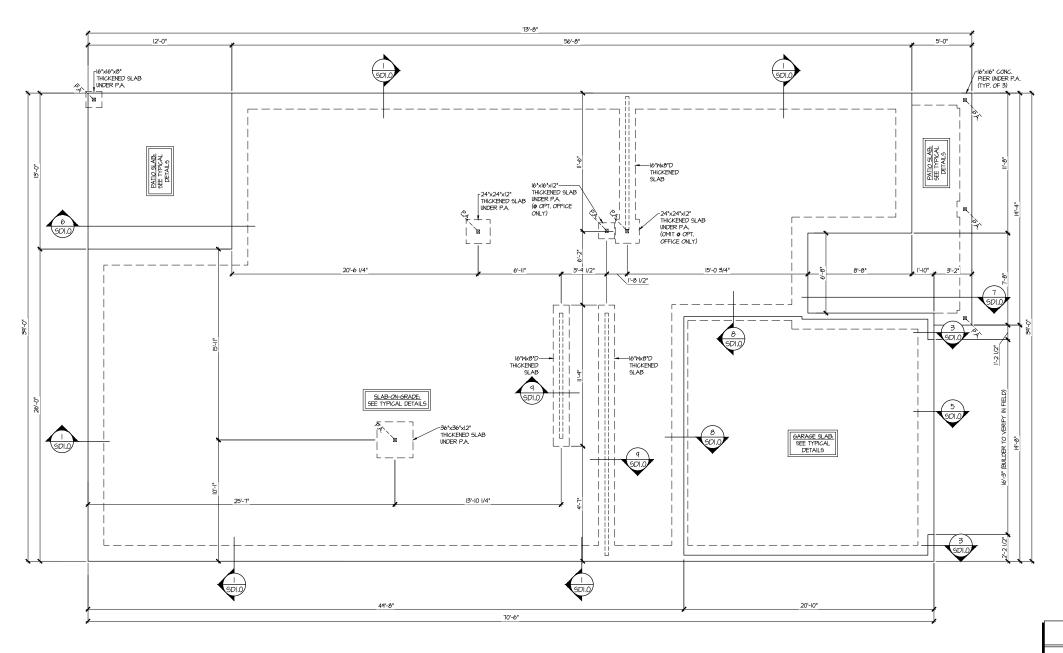
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ROOF FRAMING PLAN 5920-06 MODEI

SERENITY MASTER SET RALEIGH, NC

S2.1

Reference S3.1 for Elevation C Details



OPT. 2ND FLOOR SLAB FOUNDATION PLAN SCALE: 1/4"=1'-0" (22x24 SHEET) ELEV. A 1/8"=1'-0" (IIxIT SHEET)

LEGEND

- INTERIOR BEARING WALL
- ==== BEARING WALL ABOVE (B.W.A.)
- BEAM / HEADER
- INDICATES EXTENT OF INT.

 OSB SHEARWALL AND/OR
 3" O.C. EDGE NAILING
- EXTENT OF VALLEY TRUSS OVERFRAMING

 24" O.C. (MAX.)

- NDICATES HOLDOWN
- JL METAL HANGER
- INDICATES POST ABOVE. PROVIDE SOLID BLOCKING UNDER POST OR JAMB ABOVE.

REFER TO SO.O FOR TYPICAL STRUCTURAL NOTES # SCHEDULES

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Mulhern+Kulp project number:

SMK drawn by: NGG issue date: 08-16-2024

REVISIONS:


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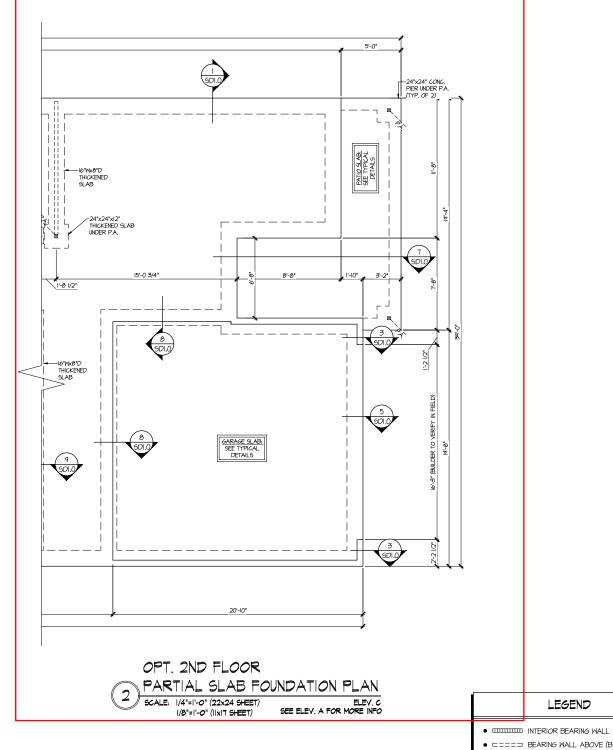
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STRUCTURAL OPTIONS

5920-06 MODEI SERENITY MASTER SET RALEIGH, NC

S3.0



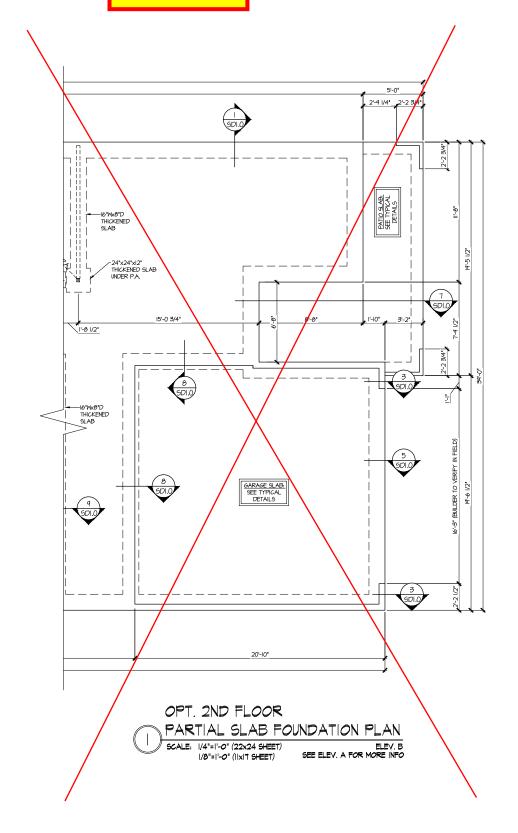

REFER TO SO.O FOR TYPICAL STRUCTURAL NOTES \$ SCHEDULES

LEGEND

• □===□ BEARING WALL ABOVE (B.W.A.)

• ---- BEAM / HEADER

INDICATES EXTENT OF INT.

OSB SHEARWALL AND/OR

3" O.C. EDGE NAILING

EXTENT OF VALLEY TRUSS OVERFRAMING

2 24" O.C. (MAX.)

EXTENT OF FLOOR SYSTEM TO BE DESIGNED FOR TILE

► INDICATES HOLDOWN

JL METAL HANGER

* INDICATES POST ABOVE. PROVIDE SOLID BLOCKING UNDER POST OR JAMB ABOVE.

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243-24032

SMK NGG issue date: 08-16-2024

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STRUCTURAL OPTIONS 5920-06 MODEL

SERENITY MASTER SET RALEIGH, NC

S3.1

Reference S3.3 for Elevation C Details

ATTIC ROOF TRUSSES @ 24" O.C.

SIMPSON HGUS-7,25/10 HANGER

FASTEN PLYS TOGETHER W (4)— ROWS OF 1/4"X6" SIMPSON SDS SCREWS @ 6" O.C. WITHIN 24" OF HANGER (TYP. EA. FACE)

(4)13/4"×14" LVL FLUSH

6x6 P.T. POST w/ SIMPSON BCS2-3/6 CAP & ABM66Z BASEN

ROOF TRUSSES @ 24" O.C.


(2)2x6 (2)2x6 (2)2x6

ROOF TRUSSES @ 24" O.0

STEP CLG.

ROOF TRUSSES @ 24

LINE OF BOX

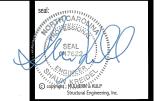

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11/07/2024 ARCH UPDATE

THIS LEVEL HAS BEEN DESIGNED FOR 9'-I" PLATE HEIGHT

LEGEND

- IIIIII INTERIOR BEARING WALL
- □===□ BEARING WALL ABOVE (B.W.A.)
- BEAM / HEADER

— STRUCTURAL GABLE END ROOF TRUSS

ROOF TRUSSES @ 24" O.C

DORMER TRUSS O.F. 24" O.C.

3 PT. BRG. ROOF TRUSSES @ 24" O.C.

2xIO LEDGER FASTENED TO TRUSS END VERTICALS W (3)¼'x3½' SIMPSON SDS SCREW © 24" O.C.

- INDICATES EXTENT OF INT.

 OSB SHEARWALL AND/OR
 3" O.C. EDGE NAILING
- EXTENT OF VALLEY TRUSS OVERFRAMING

 24" O.C. (MAX.)
- EXTENT OF FLOOR SYSTEM TO BE DESIGNED FOR TILE
- NDICATES HOLDOWN
- JL METAL HANGER
- * INDICATES POST ABOVE. PROVIDE SOLID BLOCKING UNDER POST OR JAMB ABOVE.

REFER TO SO.O FOR TYPICAL STRUCTURAL NOTES # SCHEDULES

OPT. 2ND FLOOR LOW ROOF FRAMING PLAN SCALE: 1/4"=1'-0" (22x24 SHEET) ELEV. A 1/8"=1'-0" (IIxIT SHEET)

(2)13/4"×14" LVL FLUSH

END JOIST

ROOF TRUSSES 24" O.C.

3 6D2.0

243-24032

initial: SMM


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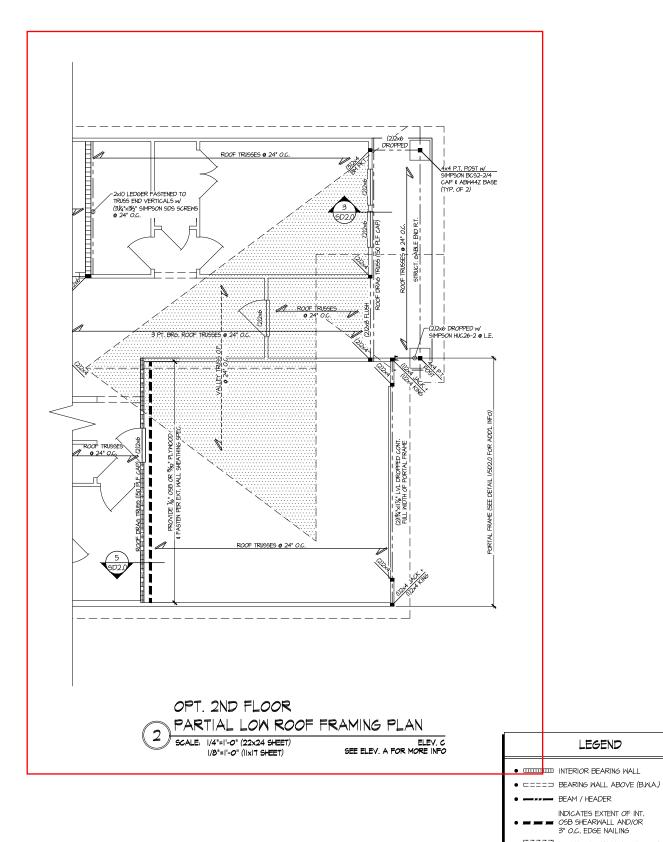
OPTIONS MODEI STRUCTURAL

SERENITY MASTER SET RALEIGH, NC 5920-06

S3.2

Elevation C



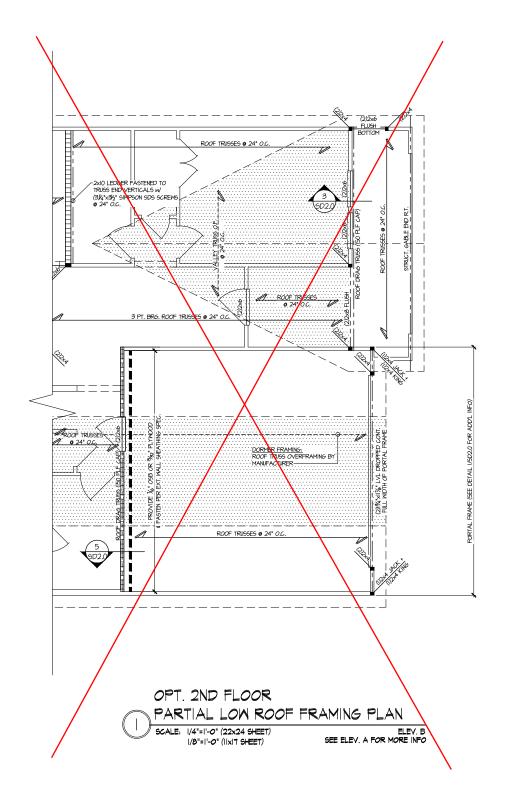

THIS LEVEL HAS BEEN DESIGNED FOR 9'-1" PLATE HEIGHT

TYPICAL STRUCTURAL NOTES # SCHEDULES

REFER TO SO.O FOR

EXTENT OF VALLEY TRUSS OVERFRAMING

24" O.C. (MAX.)

EXTENT OF FLOOR SYSTEM TO BE DESIGNED FOR TILE

► INDICATES HOLDOWN

JL METAL HANGER

* INDICATES POST ABOVE. PROVIDE SOLID BLOCKING UNDER POST OR JAMB ABOVE.

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Mulhern+Kulp project number: 243-24032

SMK NGG issue date: 08-16-2024

REVISIONS:

initial: II/07/2024 Arch update SMM

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STRUCTURAL OPTIONS 5920-06 MODEI

S3.3

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REVISIONS:

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THIS LEVEL HAS BEEN DESIGNED FOR 9'-1" PLATE HEIGHT

- IIIIII INTERIOR BEARING WALL
- ==== BEARING WALL ABOVE (B.W.A.)
- INDICATES EXTENT OF INT.

 OSB SHEARWALL AND/OR
 3" O.C. EDGE NAILING

- NDICATES HOLDOWN

REFER TO SO.O FOR TYPICAL STRUCTURAL NOTES # SCHEDULES

LEGEND

- EXTENT OF VALLEY TRUSS OVERFRAMING

 24" O.C. (MAX.)
- EXTENT OF FLOOR SYSTEM TO BE DESIGNED FOR TILE


- * INDICATES POST ABOVE. PROVIDE SOLID BLOCKING UNDER POST OR JAMB ABOVE.

S3.4

STRUCTURAL OPTIONS

5920-06 MODEL

SERENITY MASTER SET RALEIGH, NC

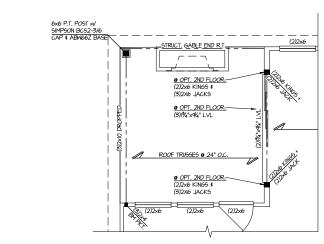


PARTIAL ROOF FRAMING PLAN OPT. 9080 MULTI SLIDE DOOR

@ GREAT ROOM

 SCALE:
 |/4"=|'-0" (22x24 SHEET)
 ELEV. A SHOWN.

 |/8"=|'-0" (IIx17 SHEET)
 ALL ELEV. SIM.

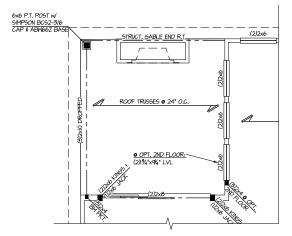


PARTIAL ROOF FRAMING PLAN OPT. 9080 MULTI SLIDE DOOR

@ DINING

96ALE: 1/4"=1'-0" (22x24 SHEET) 1/8"=1'-0" (11x17 SHEET)

ELEV. A SHOWN. ALL ELEV. SIM.

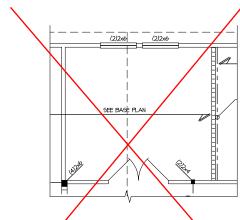

PARTIAL ROOF FRAMING PLAN OPT. OFFICE W/ SECOND FLOOR

3 OPT. OFFICE W/ SECOND 1 SCALE: 1/4"=1'-0" (22x24 SHEET)

E: |/4"=|'-0" (22x24 SHEET |/8"=|'-0" (||x|7 SHEET) ELEV. A SHOWN. ALL ELEV. SIM. THIS LEVEL HAS BEEN DESIGNED FOR 9'-1" PLATE HEIGHT

LEGEND

- INTERIOR BEARING WALL
- □===□ BEARING WALL ABOVE (B.W.A.)
- BEAM / HEADER
- INDICATES EXTENT OF INT.

 OSB SHEARWALL AND/OR

 "O.C. EDGE NAILING
- EXTENT OF VALLEY TRUSS OVERFRAMING
 24" O.C. (MAX.)
- EXTENT OF FLOOR SYSTEM TO
 BE DESIGNED FOR TILE
- ► INDICATES HOLDOWN
- L METAL HANGER
- | INDICATES POST ABOVE. PROVIDE SOLID | BLOCKING UNDER POST OR JAMB ABOVE.

REFER TO SO.O FOR
TYPICAL STRUCTURAL NOTES
\$ SCHEDULES

SEAL SEAL STORY

O copyright Multiplicate Ault Procedure Tourish Ault Procedure Tourish Ault Engineering, Inc.

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project mgr: SMK drawn by: NGC issue date: 08-16-2024

REVISIONS: date:

date: initial:

II/OT/2024 SMM

ARCH UPDATE


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STRUCTURAL OPTIC

5920–06 MODEI Serenity Master set Raleigh, nc

SO1.0



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RESIDENTIAL STRUCTURAL ENGINEERING

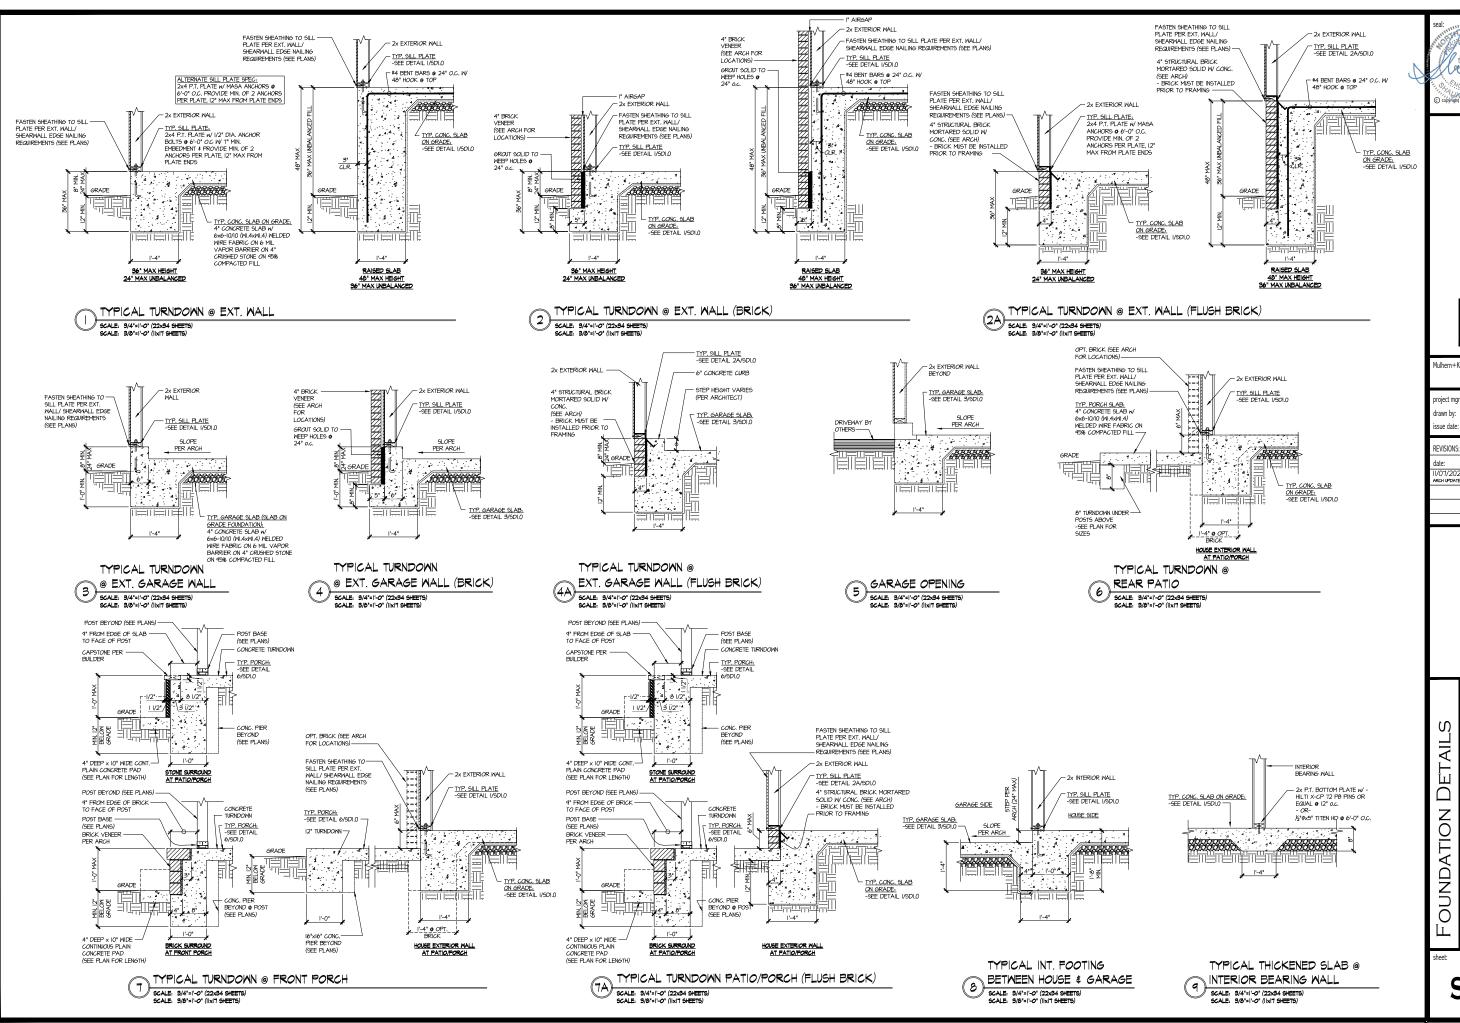Mulhern+Kulp project number 243-2403

SMŁ NGG issue date: 08-16-2024

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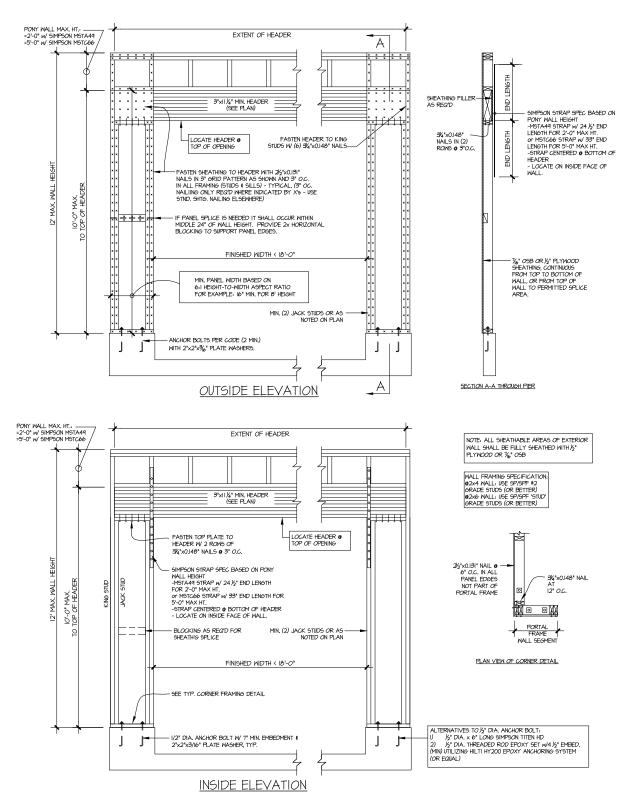
initial: /07/2024 SMM

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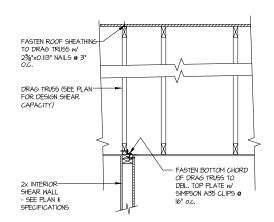
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MASTER SET RALEIGH, NC SERENITY 5920-


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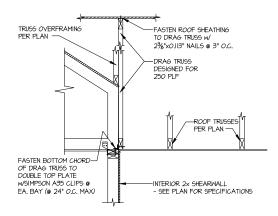







INTERIOR DRAG TRUSS DETAIL



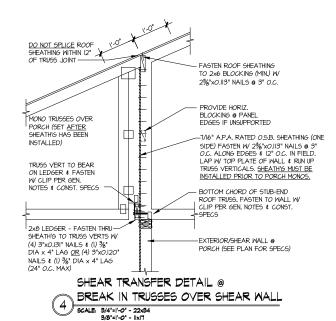

SHEAR TRANSFER DETAIL AT SHEARWALL BELOW

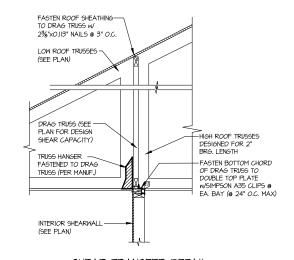

SHEAR TRANSFER DETAIL AT INTERIOR SHEARMALL BELOW

5 SCALE 9/4*=1"-4"



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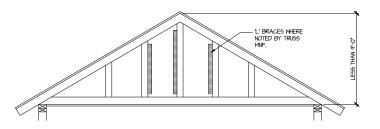
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DETAIL MOD FRAMING SERENITY MASTER SET RALEIGH, NC 5920-06


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L' BRACES FASTENED TO VERTICALS IMPERE REQ'D BY TRUSS MANUFACTURER. FASTEN W 16d GUN NAILS (0.131 x 3 1/2") @ 6" O.C.

GABLE END TRUSS SHEATHED-WITH OSB.

FASTEN BOTTOM CHORD OF — GABLE END TRUSS TO DBL. TOP PLATE w/ 3"XO.120" (MIN.) TOE-NAILS @ 8" O.C.



TYPICAL GABLE END BRACING DETAIL SCALE: NONE REQU & GABLE END TRUSS REQ'D & GABLE END TRUSS HEIGHT UP TO 9'-0"

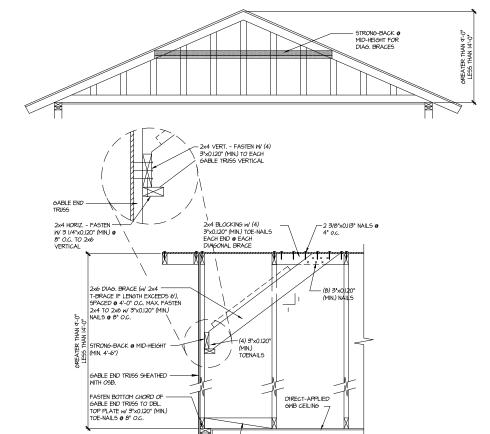BRACE GABLE END TRUSSES PER ABOVE DETAIL WHEN GABLE HEIGHT IS LESS THAN 9-0". "L' BRACES REQUIRED WHERE NOTED BY TRUSS MANUFACTURER.

DIRECT-APPLIED GWB CEILING —

— PROVIDE 2x4 BLOCKING @ 48" O.C. IN FIRST BAY OF ROOF TRUSSES-CUT TO FIT TIGHT BETWN TRUSS BOT. CHORDS, FASTEN W (3) 3 1/4"x0.120" (MIN.) TOE-NAILS @ EACH END

TYPICAL GABLE END BRACING DETAIL
SCALE: NONE REGT & GABLE END TRUSS REQ'D @ GABLE END TRUSS HEIGHT BETW'N 9'-0" TO 14'-0"

- PROVIDE 2x4 BLOCKING @ 48" O.C. IN FIRST BAY OF ROOF TRUSSES-CUT TO FIT TICHIT DETINN TRUSS BOT. CHORDS, FASTEN W (4) 3"x0,120" (MIN.) TOE-NAILS @ EACH END

BRACE GABLE END TRUGGES PER ABOVE DETAIL WHEN GABLE HEIGHT EXCEEDS 9'-0'. "L' BRACES NOT REQUIRED.

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FRAMING DETAILS SERENITY MASTER SET RALEIGH, NC

5920-06 MODEL

SD2.1