#### POPLAR RIDGE **ABBREVIATIONS** A A PRESSURE TREATED WD HWD HARDWOOD (FL R&M RANGE W/MICROWAV LIV LIVING LTL LINTEL LVR LOUVER MAX MAXIMUM DRY DRYER MACHINE TEMP TEMPERED (GLASS U.N.O. UNLESS NOTE OTHERWISE VB VANITY BASE OA F.F. FINISH FLOOR (LIN OBS OBSCURE (GLA WH WATER HEATER FLR FLOOR(ING FP FIREPLACE OPT OPTIONAL WIC WALK-IN CLOSE FURRED(ING) PEDESTAL (SINK) W/W/O WITH or WITHOUT SULIND EVIL TERPROOF(ING)

## **GENERAL NOTES**

#### 1 - GENERAL BUILDING & DESIGN REQUIREMENTS

1) THE ATTACHED PLANS & SPECIFICATIONS ARE THE SOLE PROPERTY OF TRI POINTE HOMES ANY UNAUTHORIZED USE OF THESE PLANS WITHOUT PRIOR WRITTEN CONSENT OF TRI POINTE HOMES IS STRICTLY

- TRI POINTE HOMES DESIGNS & BUILDS HOUSING AS SET FORTH BY THE FORMAT AND PROVISIONS OF TH INTERNATIONAL RESIDENTAL CODE (IRC), AND THE NATIONAL ELECTRIC CODE (NEC). ANY NON-CONFORMING DOCUMENTS DISCOVERED BY THE CONTRACTOR OR HIS AGENTS SHALL BE CALLED TO THE IMMEDIATE TTENTION OF TRI POINTE HOMES BY CALLING (469)329-0470.
- ). THESE PLANS ARE SUBJECT TO MODIFICATIONS TO MEET CODE REQUIREMENTS AND/OR TO FACILITATE MECHANICAL/ ELECTRICAL/ PLUMBING INSTALLATION AND/ OR TO IMPLEMENT DESIGN IMPROVEMENTS. ANY
- INTENTION TO MODIFY THESE PLANS MUST BE APPROVED IN WRITING BY TRI POINTE HOMES
  4) CONTRACTOR SHALL BE RESPONSIBLE FOR VERIFYING ALL DIMENSIONS AFFECTING CONTRACTOR'S PRODUCTS, INSTALLATIONS, OR FABRICATIONS IN THE FIELD PRIOR TO EXPEDITING THE CONSTRUCTION OF SUCH WORK. FIELD VERIFY ALL DIMENSIONS – DO NOT SCALE DRAWINGS!! CONTRACTOR IS RESPONSIBLE FOR SURVEYING THE PROJECT AND BECOMING FAMILIAR WITH THE EXISTING CONDITIONS AND SCOPE OF WORK INCLUDING BUT NOT LIMITED TO SITE AND SOIL BEARING CONDITIONS.
  5) ERRORS AND OMISSIONS WHICH MAY OCCUR IN THE CONTRACT DOCUMENTS SHALL BE BROUGHT TO THE
- ATTENTION OF THE ARCHITECT, IN WRITING, AND WRITTEN INSTRUCTION SHALL BE OBTAINED PRIOR TO PROCEEDING WITH CONSTRUCTION. THE CONTRACTOR SHALL BE HELD RESPONSIBLE FOR ANY ERRORS, DISCREPANCIES, OR OMISSIONS FOR WHICH THE CONTRACTOR FAILED TO NOTIFY THE ARCHITECT PRIOR TO

### 2 - SITE CONSTRUCTION

BACK FILL SHALL BE FREE FROM VEGETATION AND CONSTRUCTION DEBRIS

) BACK FILL SHALL BE PLACED IN LIFTS AND COMPACTED IN SUCH A MANNER AS BACKFILL TO NOT DAM. THE FOUNDATION WALLS OR ANY WATERPROOFING/ DAMPPROOFING MATERIALS.

## 3 - CONCRETE

1) SLOPE ON GARAGE SLAB SHALL BE 1/8" PER FOOT TOWARDS VEHICLE DOOR. SLOPE ON PORCH AND

#### 4 - MASONRY

ALL EXTERIOR BRICK MUST MEET ASTM C-216 FOR "SW" CONDITIONS

2) MASONRY VENEER SHALL BE ATTACHED TO SUPPORTING WALLS W/ CORRUGATED METAL TIES IN ACCORDANCE WITH R703.7.4.1 - I.R.C. OR LOCAL CODE REQUIREMENTS

) WEEPHOLES SHALL BE PROVIDED ALONG THE OUTSIDE WYTHE OF EXTERIOR MASONRY WALLS AT 33" O.C. MAX, SHALL BE A MIN. OF 3/16" IN DIAMETER, AND LOCATED IMMEDIATELY ABOVE THE FLASHING PER 18703.7.6 – LR.C.

#### 5 - METALS

#### 6 - WOOD AND PLASTICS

## 7 - THERMAL & MOISTURE PROTECTION

FIRE STOPPING AND/ OR DRAFT STOPPING SHALL MEET THE REQUIREMENTS OF IRC R602.8. ) ATTIC VENTILATION SHALL BE PROVIDED AT 1/300 to 05 THE AREA OF THE SPACE VENTILATED. CROSS VANILATION WITH HALF OF THE VENTILATED AREA SHALL BE PROVIDED BY ROOF VENTS AND THE OTHER HALF BY SOFFIT VENTS. VENTS SHALL BE PLACED SO AS TO NOT ALLOW INFILTRATION OF RAIN OR SNOW. ) PROVIDE APPROVED TILE BACKER DRYWALL FOR ALL SHOWER AND BATH SPACE ) PROVIDE ATTIC VENTILATION PER IRC-R806.1

#### 8 - DOORS AND WINDOWS

- ) REVIEW ALL WINDOW HDR HEIGHTS PER PLATE HT. AND VERIFY W/ ELEVATIONS AND CORNICE DETAILS TEMPERED GLASS SHALL BE USED IN HAZARDOUS AREAS AS DESCRIBED IN SECTION R308.4 - LR.C.
- FRONT DOOR WIDTH PER IRC-R311.3
- GARAGE DOOR PER IRC-R309.1

) EMERGENCY EGRESS SHALL MEET REQUIREMENTS OF SECTION R310 - LR C 2018 - SLEEPING ROOMS HALL HAVE AT LEAST ONE EGRESS OPENING OF NOT LESS THAN 5.7 SF AND A CLEAR OPENING OF NOT LESS THAN 20" WIDE X 24" HIGH AND SHALL NOT BE MORE THAN 44" ABOVE THE FLOOR

### 15 - MECHANICALS

) WOOD BUILT CHIMNEYS AND FIREPLACES SHALL BE INSTALLED PER MANUFACTURER'S INSTRUCTIONS. AND RE SUBJECT TO MECHANICAL INSPECTION PER IRC SECTION R1002.1 ) EXTERIOR AIR INTAKE FOR COMBUSTION AIR PER IRC SECTION AS REQUIRED BY LOCAL MUNICIPALITY

ALL FLECTRICAL INSTALLATION SHALL MEET THE REQUIREMENTS OF THE NATIONAL ELECTRIC CODE (NEC). MATERIAL AND EQUIPMENT SHALL BEAR THE LABEL OF APPROVAL OF THE UNDERWRITERS ABORATORIES, INC.

- ELECTRICAL CONTRACTOR SHALL VERIFY SPACE REQUIRED FOR METER INSTALLATION BEFORE INSTRUCTION AND SHALL NOTIFY GENERAL CONTRACTOR OF ANY DISCREPANCIES.
- VERIFY LOCATION OF ALL RECEPTACLES FOR APPLIANCES WITH MANUFACTURER SPECIFICATIONS. GROUND FAULT INTERRUPTS SHALL BE LOCATED PER THE NEC
- ALL SWITCHES SHALL BE INSTALLED AT 3'-6" ABOVE FINISHED FLOOR TO CENTERLINE OF SWITCH
- VLESS NOTED OTHERWISE ) ALL CONVENIENCE OUTLETS SHALL BE INSTALLED W/ CENTERLINE OF OUTLET LOCATED 1'-3" ABOVE FÍNISHED ELOOR UNLESS NOTED OTHERWISE
- ALL CONVENIENCE OUTLETS WITH SWITCHES TO BE SWITCH AT TOP ONLY.
- ALL EXTERIOR WALL BRACKET FIXTURES SHALL BE INSTALLED AS NOTED ON PLANS.

  APPROVED SMOKE DETECTORS SHALL BE LOCATED ON EVERY STORY OF THE DWELLING UNIT AS PER IRC
- ECTION R317 (SEE SHEET B1.1 FOR LOCATIONS). WHERE MORE THAN ONE DETECTOR IS REQUIRED THEY SHALL BE INTERCONNECTED. POWER SOURCE SHALL BE BUILDING POWER w/ BATTERY BACKUP. )) CONDUCTORS SHALL BE OF COPPER.

#### GENERAL FRAMING SPECS AND CONSTRUCTION NOTES STAIRS:

) THE MAXIMUM RISER HEIGHT SHALL BE 7 3/4 INCHES AND THE MINIMUM TREAD DEPTH SHALL BE 10

HANDRAILS HAVING MINIMUM AND MAXIMUM HEIGHTS OF 34 INCHES AND 38 INCHES SHALL BE OVIDED ON AT LEAST. ONE SIDE OF STAIRWAYS IN ACCORDANCE WITH SECTION R315.1 - I.R.C HANDRAIL AND BALUSTRADE (WHERE PRESENT) SHALL BE CONSTRUCTED. ACCORDING TO IRC. ALL REQUIRED HAND RAILS SHALL BE CONTINUOUS THE FULL LENGTH OF THE STAIRS W/ 2 OR MORE SERS FROM A POINT ABOVE THE THE TOP RISER OF A FLIGHT TO A POINT ABOVE THE LÓWEST RISER OF THE FLIGHT. ENDS SHALL BE RETURNED OR SHALL TERMINATE AT NEWEL POSTS OR SAFETY TERMINALS. ANDRAILS ADJACENT TO A WALL SHALL HAVE A SPACE OF NOT LESS THAN 1.5" BETWEEN THE WALL

#### WALLS:

ALL DIMENSIONS ARE FROM FACE OF STUD TO FACE OF STUD. ALL STUDS ARE 3 1/2" UNLESS NOTED. LL DIMENSIONS PRESENTED HERE ARE FRAME. DIMENSIONS ONLY.

I SEPARATION BETWEEN THE RESIDENCE AND THE GARAGE SHALL BE MAINTAINED BY INSTALLATION OF  $rac{1}{2}^{n}$ GYPSUM BOARD ON ALL COMMON WALLS. 2-STORY HOMES REQUIRE 5/8" TYPE X GYPSUM BOARD AT CARAGE CEILINGS WHERE HABITABLE ROOMS ARE PRESENT ABOVE.

#### FLOORS:

STRUCTURAL FLOOR MEMBERS SHALL NOT BE CUT, BORED, OR NOTCHED IN EXCESS OF THE LIMITATIONS ECIFIED IN IRC

) THE ENDS OF EACH JOIST, BEAM, OR GIRDER SHALL HAVE NOT LESS THAN 1.5 INCHES OF BEARING ON WOOD OR METAL AND NOT LESS THAN 3 INCHES ON MASONRY OR CONCRETE OR AS OTHERWISE SPECIFIED

) ALL DIMENSIONAL FLOOR JOISTS TO BE PER ENGINEER STRUCTURAL PLANS.

### FRAMING:

- ALL FRAMING DIMENSIONS TO FACE OF MEMBER. L BEARING HEADERS TO BE PER ENGINEERING PLANS.
- FIRE STOPPING AND / OR DRAFT STOPPING SHALL MEET THE REQUIREMENTS OF IRC R602.8.

#### **ROOF**

) HIP AND VALLEY RAFTERS SHALL BE SUPPORTED AT RIDGE DOWN TO BEARING PARTITION. CUT ENDS OF RAFTERS SHALL BE FULLY SUPPORTED WALL AND RIDGE

) REQUIRED VENTILATION AREAS CALCULATED AT 1/300 RATIO.

## SQUARE FOOTAGE

#### Elevation "C"

(Slab S.F.)		
Slab Area	Sq. Ft	
FIRST FLOOR	252	
2 BAY GARAGE	497	
PORCH	73	
COVERED OUTDOOR LIVING	215	
Total Slab Area	3312	

#### (Outside of Frame S.F.)

A/C Area	Sq. Ft.
FIRST FLOOR	2527
Total A/C Area	2521
Non-A/C Area	Sq. Ft.
2 BAY GARAGE	497
PORCH	73
COVERED OUTDOOR LIVING	215
Total Non-A/C Area	785

#### (Inside of Frame S.F.)

Total A/C Area	2447
FIRST FLOOR	2447
A/C Area	Sq. Ft.

NOTE: ALL OPTIONAL SQUARE FOOTAGES LISTED ARE INDEPENDENT OF AND IN ADDITION TO BASE SQUARE FOOTAGES

#### **OPTIONS**

BUILDING CODE COMPLIANCE

ELECTRICAL PLANS DESIGNED TO MEET OR EXCEED MINIMUM

CONSTRUCTION PLANS DESIGNED TO MEET OR EXCEED

XT. COV. OUTDOOR LIVING	+
.OFT	+

## TABLE OF CONTENTS

_		
		SHEET LEGEND
	SHEET NO.	TYPE OF SHEET/LAYOUT
	"G0.01"	COVER SHEET & GEN. NOTES
	"G0.11"	REVISIONS & SYMBOLS
	"S1.10C"	BASE FOUNDATION PLAN - ELEVATION 'C'
	"A1.10C"	FIRST FLOOR PLAN - ELEVATION 'C'
	"01.A10"	FLOOR PLAN OPTIONS
	"01.A20"	2ND FLOOR PLAN OPTION
	"A2.01C"	EXTERIOR ELEVATIONS - 'C'
	"A2.02C"	EXTERIOR ELEVATIONS - 'C'
	"A2.03C"	EXTERIOR ELEVATIONS - 'C' - EXTENDED COVERED OUTDOOR LIVING
	"A3.01C"	ROOF PLAN — ELEVATION 'C'
	"A3.02C"	ROOF PLAN - ELEVATION 'C' - EXTENDED COVERED OUTDOOR LIVING
	"A4.01"	INTERIOR DETAIL SHEET
	"E1.10C"	1ST FLR. ELECTRICAL PLAN — ELEVATION 'C'
	"E1.11C"	1ST FLR. ELECTRICAL PLAN UPGRADE OPTIONS — ELEVATION 'C'
	"01.E10"	1ST FLR. ELECTRICAL PLAN OPTIONS
	"01.E11"	1ST FLR. ELECTRICAL PLAN UPGRADE OPTIONS
	"01.E20"	2ND FLR. ELECTRICAL PLAN OPTION
	"01.E21"	2ND FLR. ELECTRICAL PLAN UPGRADE OPTION
		·

## Serenity - Lot 275 - 5921-09 (Poplar Ridge) - Elevation C

- \*Gourmet Kitchen 2
- \*Prep Zone ILO Pantry
- \*Great Room Fireplace
- \*12080 Sliding Glass Door in Dining Room
- \*Primary Suite Tray Ceiling
- \*Primary Bath 3 (Super Shower)
- \*Bath 3 Shower ILO Tub

SHOWER CONTROLS

\*Outdoor Fireplace

- \*Great Room Tray Ceiling

# SYMBOLS

WATER CLOSET STONE VENEER

POPLAR RIDGE

G0.01

PLYWOOD ELEVATION KEY OR SECTION KEY TUB/SHOWER INSULATING SHEATHING CENTERI INF BATT INSULATION LAVATORY CEILING TRANSITION LINE HOSE BIB (FREEZE PROOF) DBL SINK GAS LINE STUB CONCRETE TOWEL BAR SAND OR GRAVEL LAUNDRY SINK PAPER HOLDER 2x FRAME TOWEL RING PEDESTAL SINK SHOWER HEAD BRICK VENEER

**Dointe**HOMES

Blvd Business Operation 5440 Wade Park Blv Suite 400 Raleigh, NC 27607

SERENITY GENERAL @ ALTIS @ SERENE ઝ

SUBDIVISION: ADDRESS:

SHE

11-17-24 Issue Date: ACC

5921-09

982-33 NR PAN 30(9)2931 ACC 30	REL. #	REVISION INDEX DESCRIPTION	DATE	DRAWN B
	5921-09	NEW PLAN	10/08/2024	ACC
				<del>                                     </del>
				<del>                                     </del>
				<b>†</b>
		+		<del>                                     </del>
				<b>-</b>
		+		<b>1</b>
				<b>†</b>
				<b>†</b>
		+		
		+		<del>                                     </del>
				<del>                                     </del>
		+		
				<b>—</b>
+ +				
		+		<del>                                     </del>


tri pointe.

HOMES

5440 WADE PARK BLVD, SUITE 400, RALEIGH, NG 27607

Business Operations 5440 Wade Park Blvd Suite 400 Raleigh, NC 27607

SUBDIVISIONS & SYMBOLS
SUBDIVISION: ALTIS ® SERENITY
ADDRESS: 36 SERENE XING
LOT: 275 BLOCK:


Issue Date: 11-17-24

Drawn By: ACC

5921-09

PLAN NAME:
POPLAR RIDGE

G0.11

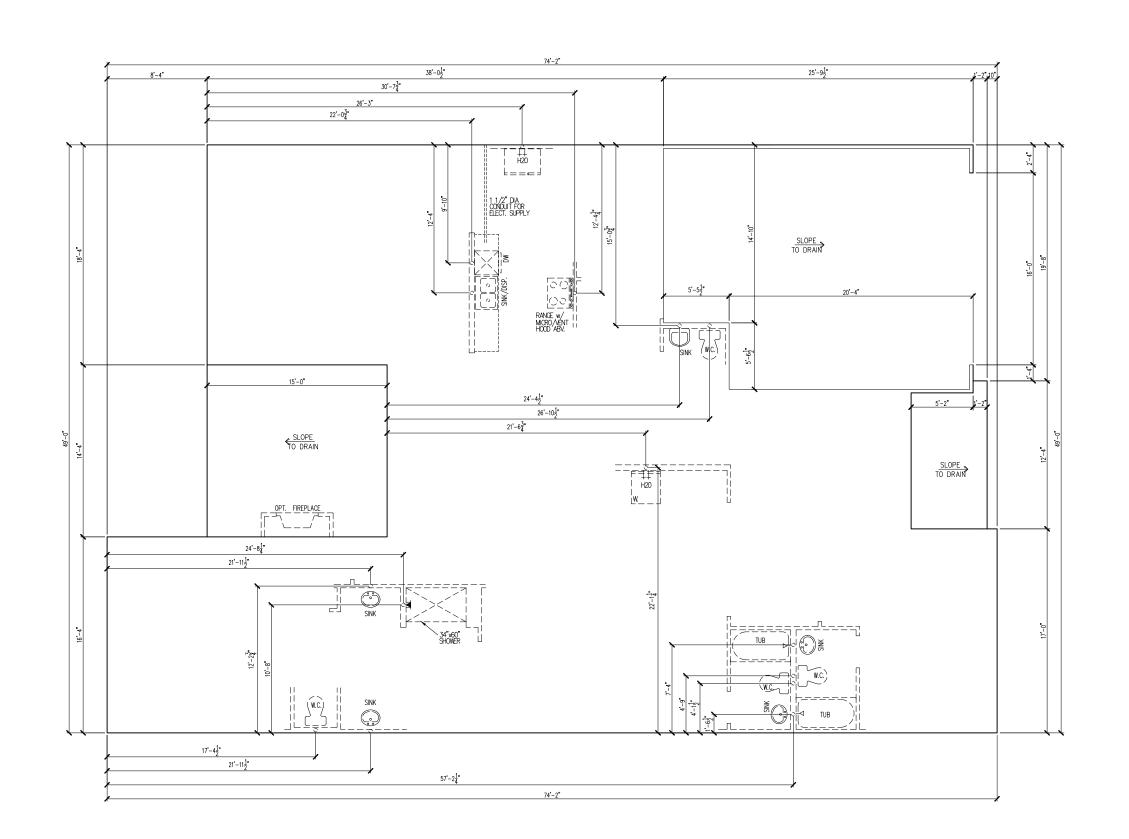

tri pointe HOMES 540 WADE PARK BLYD, SUITE 400, RALEIGH, NG 27607

Business Operations 5440 Wade Park Blvd Suite 400 Raleigh, NC 27607


SUBDIVISION: ALTIS ® SERENITY
ADDRESS: 36 SERENE XING
LOT: 275 BLOCK:

Issue Date: 11-17-24
Drawn By: ACC

5921-09

PLAN NAME:
POPLAR RIDGE

SHEET #: S1.10C

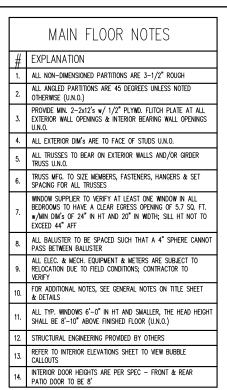

## **Options**

\*Gourmet Kitchen 2

\*Prep Zone ILO Pantry

\*Great Room Fireplace

\*Great Room Tray Ceiling


\*12080 Sliding Glass Door in Dining Room

\*Primary Suite Tray Ceiling

\*Primary Bath 3 (Super Shower)

\*Bath 3 Shower ILO Tub

\*Outdoor Fireplace

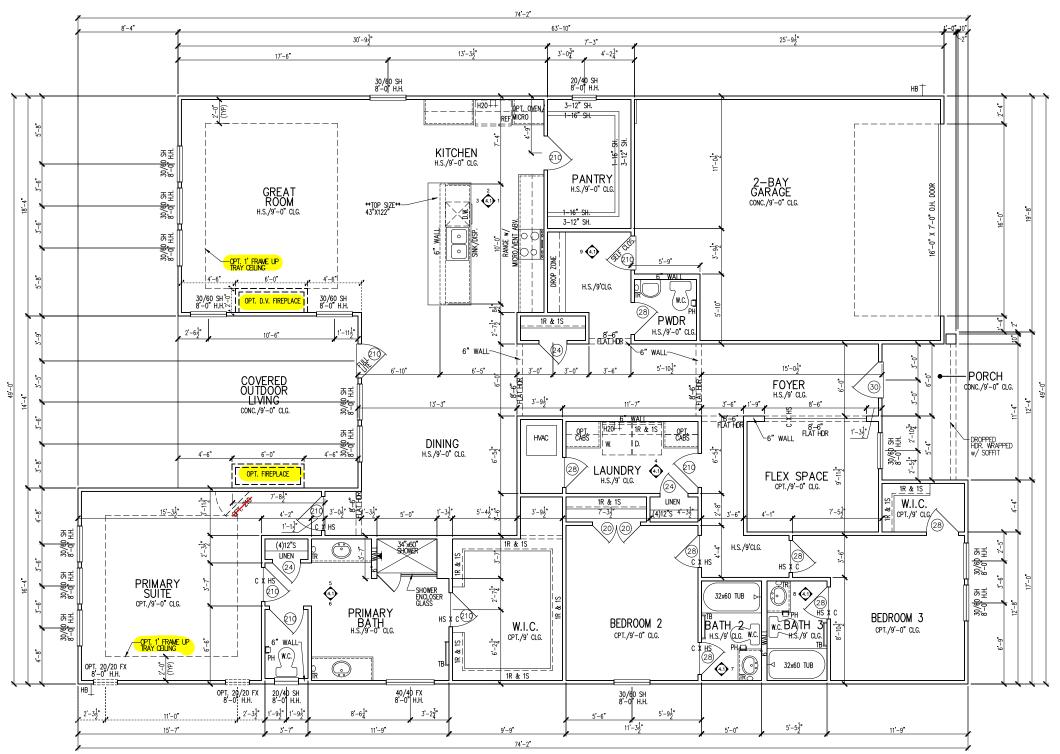

tri pointe.

HOMES

HOMES

Business Operations 5440 Wade Park Blvd Suite 400 Raleigh, NC 27607

1st FLOOR PLAN

ON: ALTIS @ SERENITY

36 SERENE XING

BLOCK:


SUBDIVISION:
ADDRESS: 30
LOT: 275 BI

Issue Date: 11-17-24
Drawn By: ACC

5921-09

POPLAR RIDGE

A1.10

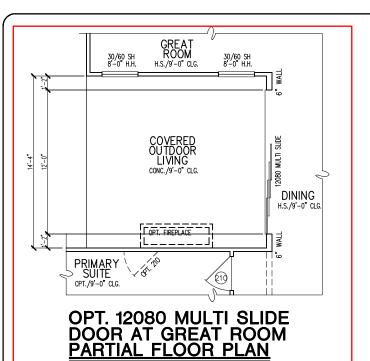

MAIN FLOOR NOTES

ALL NON-DIMENSIONED PARTITIONS ARE 3-1/2" ROUGH

ALL EXTERIOR DIM'S ARE TO FACE OF STUDS U.N.O.

ALL ANGLED PARTITIONS ARE 45 DEGREES UNLESS NOTED

PROVIDE MIN. 2-2x12's w/ 1/2" PLYWD. FLITCH PLATE AT ALL EXTERIOR WALL OPENINGS & INTERIOR BEARING WALL OPENINGS

TRUSS MFG. TO SIZE MEMBERS, FASTENERS, HANGERS & SET SPACING FOR ALL TRUSSES WINDOW SUPPLIER TO VERIFY AT LEAST ONE WINDOW IN ALL BEDROOMS TO HAVE A CLEAR ECRESS OPENING OF 5.7 SQ. FT. w/MIN DIM's OF  $24^{\circ}$  in HT and  $20^{\circ}$  in width; sill HT not to

ALL BALUSTER TO BE SPACED SUCH THAT A 4" SPHERE CANNO PASS BETWEEN BALUSTER

ALL ELEC. & MECH. EQUIPMENT & METERS ARE SUBJECT TO RELOCATION DUE TO FIELD CONDITIONS; CONTRACTOR TO

FOR ADDITIONAL NOTES, SEE GENERAL NOTES ON TITLE SHEET & DETAILS ALL TYP. WINDOWS 6'-0" IN HT AND SMALLER, THE HEAD HEIGH

SHALL BE 8'-10" ABOVE FINISHED FLOOR (U.N.O.)

INTERIOR DOOR HEIGHTS ARE PER SPEC - FRONT & REAR

STRUCTURAL ENGINEERING PROVIDED BY OTHERS REFER TO INTERIOR ELEVATIONS SHEET TO VIEW BUBBLE CALLOUTS


# EXPLANATION


OTHERWISE (U.N.O.)

TRUSS U.N.O.


VFRIFY

PATIO DOOR TO BE 8'

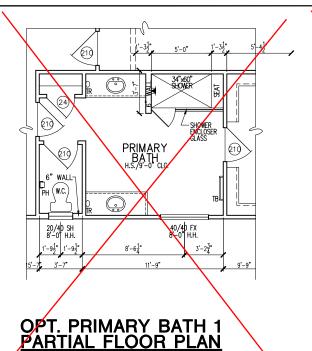

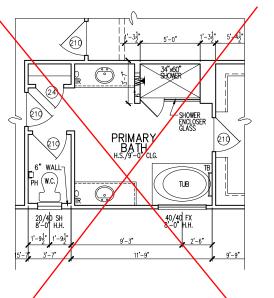



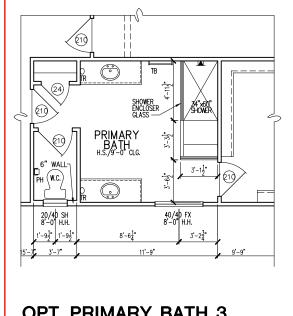



Business Operations 5440 Wade Park Blvd Suite 400 Raleigh, NC 27607

ALTIS @ SERENITY SERENE XING OPTIONS PLAN

36 SUBDIVISION: ADDRESS: LOT: 275


FLOOR


Issue Date: 11-17-24 ACC


5921-09

POPLAR RIDGE

01.A10

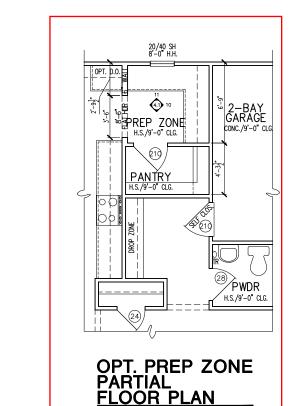


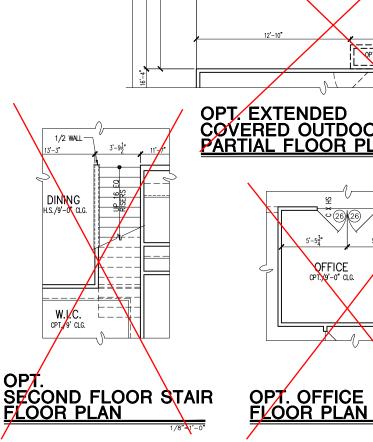


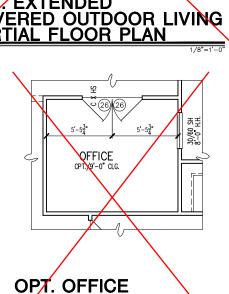




OPT. SHOWER ILO TUB PARTIAL FLOOR PLAN

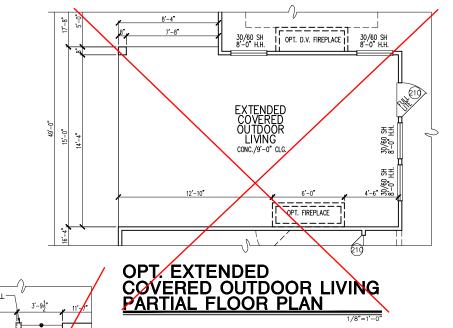


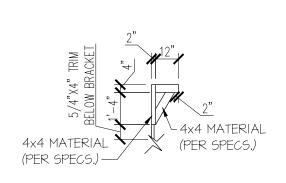


# BRACKET DETAIL

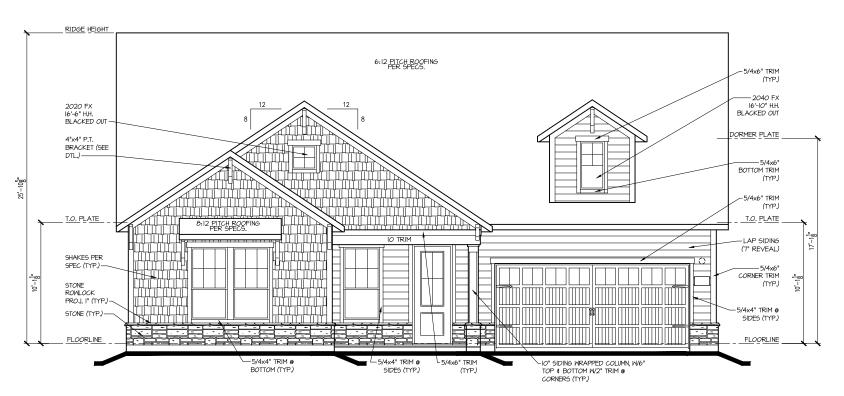

# FRONT ELEV. "C"

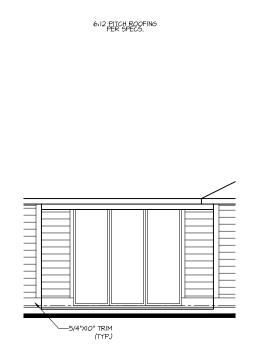

OPT. 9'x8' SLIDING GLASS DOOR @ GREAT ROOM PARTIAL REAR ELEVATION

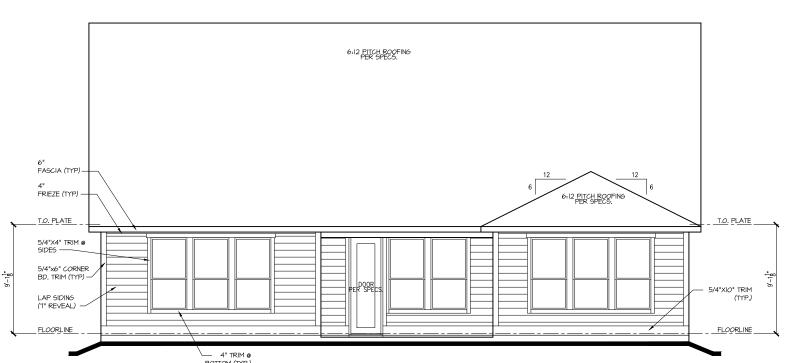

# TRIM @ BOTTOM (TYP)

REAR ELEV. "C"

1/8"=1'-

tri pointe H O M E S 5440 WADE PARK BLVD. SUITE 400, RALEIGH, NC 27807

Business Operations 5440 Wade Park Blvd Suite 400 Raleigh, NC 27607


SUBDIVISION: ALTIS © SERENITY
ADDRESS: 36 SERENE XING
LOT: 275 BLOCK:

Issue Date: 11-17-24
Drawn By: ACC


5921-09

POPLAR RIDGE

A2.01C

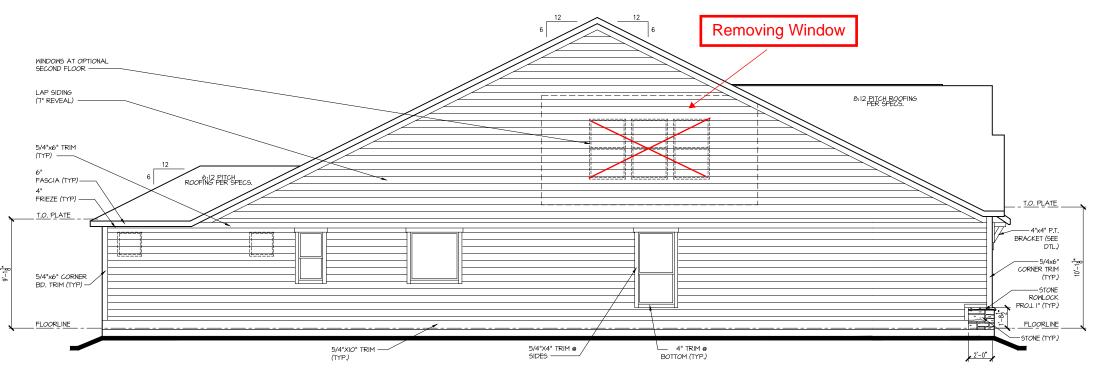

# **LEFT ELEV. "C"**1/8"=1'-0"

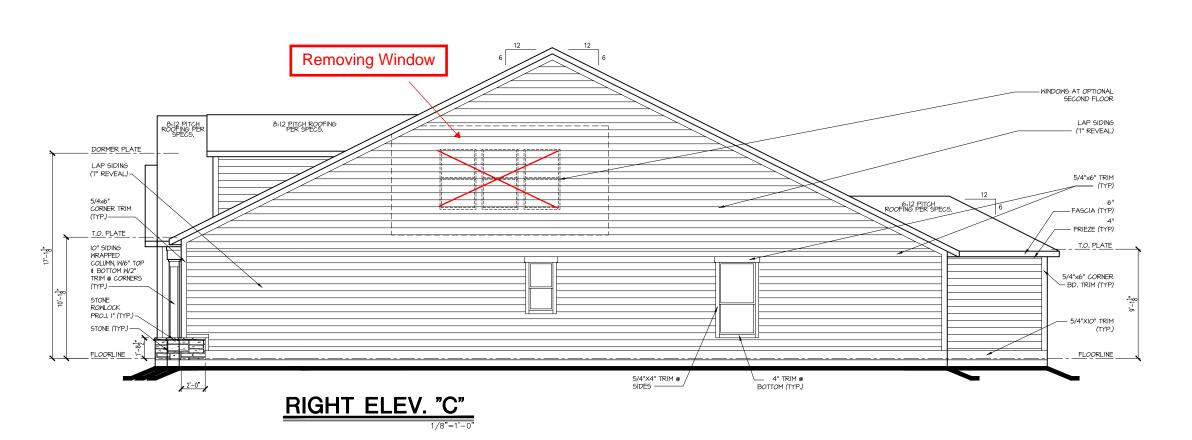

tripointe.

HOMES

HOMES

S440 WADE PARK BLVD, SUITE 400, RALEIGH, NC 27607

Business Operations 5440 Wade Park Blvd Suite 400 Raleigh, NC 27607


EXTERIOR ELEVATIONS
SUBDIVISION: ALTIS ® SERENITY
ADDRESS: 36 SERENE XING
LOT: 275 BLOCK:

Issue Date: 11-17-24
Drawn By: ACC

5921-09

POPLAR RIDGE

( A2.02C

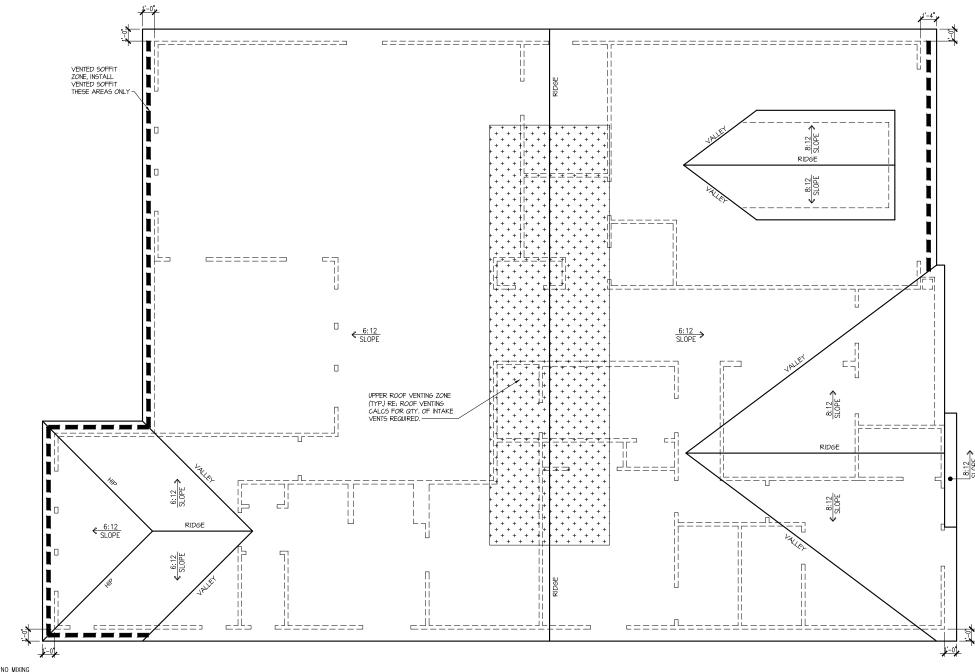

VENT TYPES

ROOF INFORMATION

TOTAL SF ROOF AREA

AVAILABLE L.F. ROOF SOFFIT

AVAILABLE L.F. ROOF RIDGE

VENT TYPES
LOWER VENTS
CONTINUOUS SOFFIT VENTING
@ 5 SILF
UPPER VENTS
SLANT 150 VENTS @ 150
SIVENT
UPPER VENTS
RIDGE VENTS @ 72 SI/VENT

NOTE: QTY OF UPPER VENTS SHOWN COVERS 100% OF UPPER VENTING. NO MIXING OF VENT TYPES FOR UPPER VENTING IS FIGURED FOR IN THIS TABLE.

BASE

3567

85

QTY VENTS

171 LF

6

Attic Venting Calculations Elev. "C"

ROOF PLAN 'C'

Dointe HOMES ARR BLVD, SUITE 400, RALEIGH, NG 27607

Business Operations 5440 Wade Park Blvd Suite 400 Raleigh, NC 27607

ALTIS @ SERENITY SERENE XING ROOF PLAN 36 SEF BLOCK:


SUBDIVISION:
ADDRESS: 36
LOT: 275 BL

Issue Date: 11-17-24 Drawn By: ACC

5921-09

POPLAR RIDGE

A3.01C

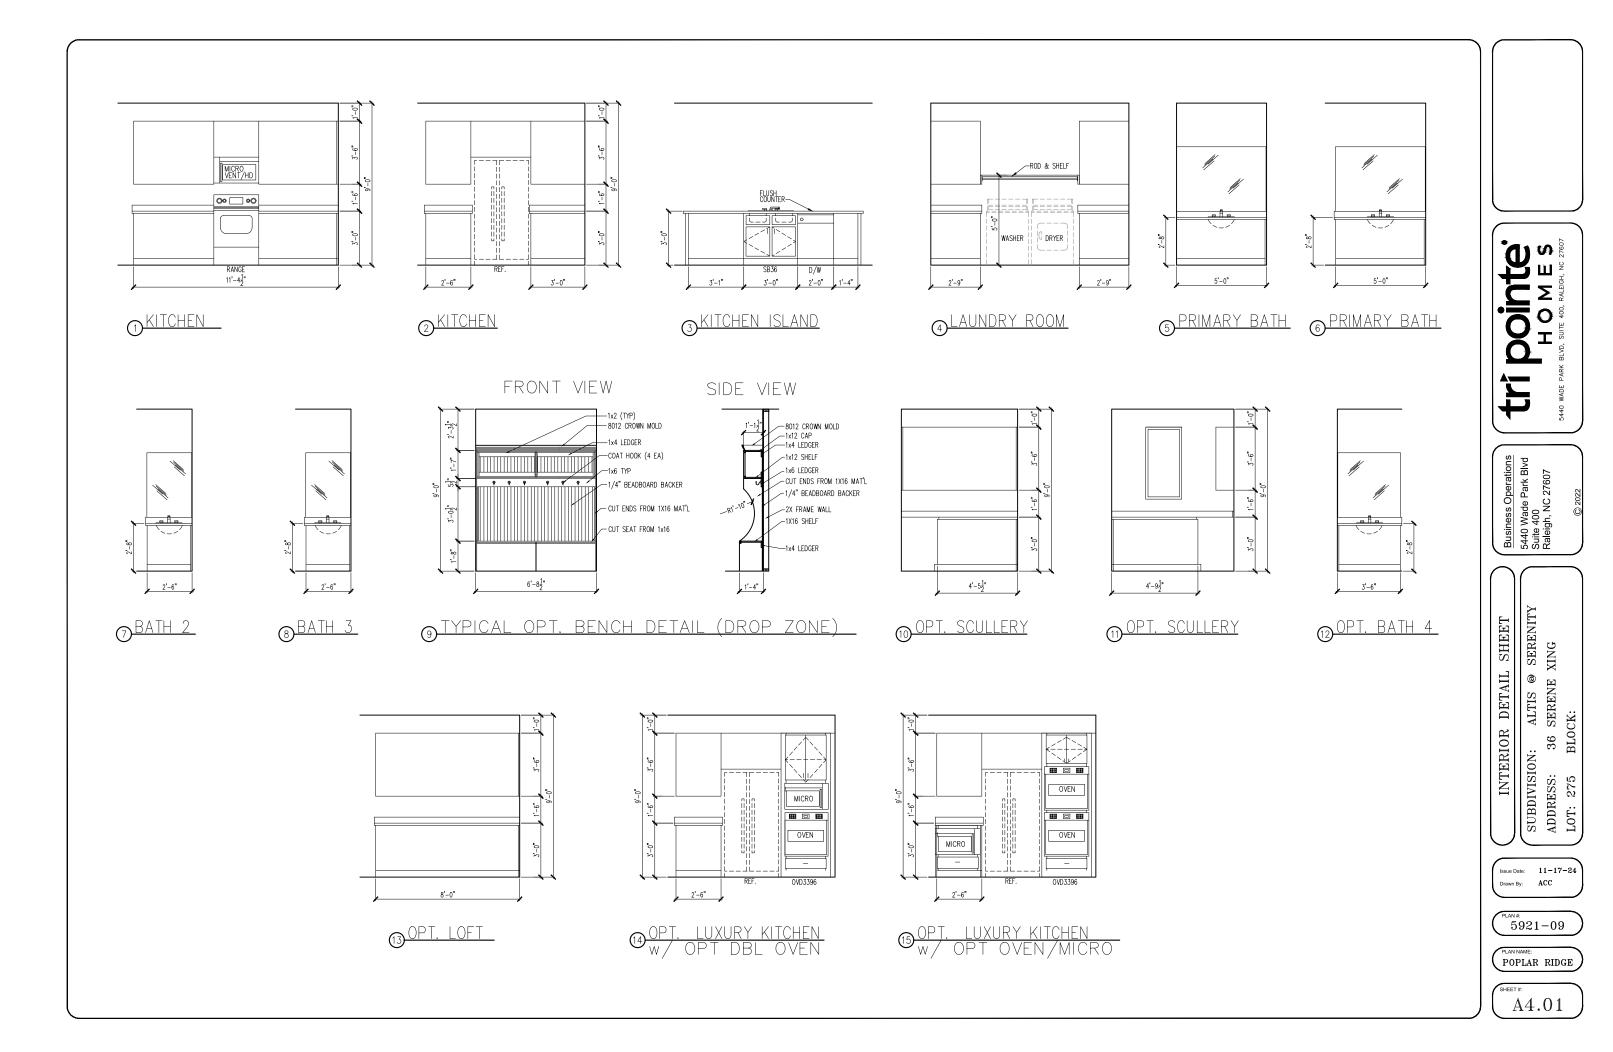

ELECTRICAL I SCHEDU	FIXTURE LE
DESCRIPTION	SYMBOL
110V OUTLET	ф
220V OUTLET	<b>\$</b> 220
1/2 HOT OUTLET	•
GFI OUTLET	<b>∜</b> GFI
WP GFI OUTLET	₩P/GFI
GARAGE DOOR OPENER OUTLET	Ø GDO
SECURITY SYSTEM	♦ SEC SYS
DISHWASHER	<b>⊕</b> DW
JUNCTION BOX	①
CEILING MOUNTED LIGHT	<del></del>
CEILING FAN w/ LIGHT KIT	BRAZING
RECESSED CEILING LIGHT	Ø
RECESSED WATER PROOF LIGHT	<b>⊠</b> WP
WALL MOUNTED LIGHT	9
WALL MOUNTED PUSH BUTTON	<b>₫</b> PB
TWO WAY SWITCH	\$
THREE WAY SWITCH	<b>"</b> \$
FOUR WAY SWITCH	\$
DIMMER SWITCH	\$ <sup>D</sup>
EXHAUST VENTS	<b>O</b> VENT TO EXT
LOW VOLTAGE PANEL	
PHONE OUTLET	<b>●</b> PH
TV OUTLET	<b>⊕</b> TV
DATA & RG6 COMBO BOX	
SMOKE DETECTOR	Ŝ
CARBON MONOXIDE SMOKE DETECTOR COMBO	⊚ CM/SD
DOOR CHIMES	CHIMES
ELECTRICAL PANEL	EP.
SURFACE MOUNT LED	•
EXTERIOR WALL MOUNT UPLIGHT	88
SOFFIT MOUNT FLOOD LIGHT	44
UNDER COUNTER LIGHTING	-cc- UCL
SMURF TUBE	

## **ELECTRICAL NOTES:**

- PROVIDE AND INSTALL LOCALLY CERTIFIED

  PROVIDE AND INSTALL LOCALLY CERTIFIED

  SMOKE AND CARBON MONOXIDE DETECTORS

  REQUIRED BY NATIONAL FIRE PROTECTION

  ASSOCIATION (NFPA) AND MEETING THE

  REQUIREMENTS OF ALL GOVERNING CODES

  PROVIDE AND INSTALL GROUND FAULT

  IGROUIT-INTERRUPTERS

  (GFI) AS REQUIRED BY

  NATIONAL ELECTRIC CODE (NEC) AND MEETING

  THE REQUIREMENTS OF ALL GOVERNING CODES

  ELECTRICAL CONTRACTOR TO PROVIDE

  REQUIRED DIRECT HOOK—UPS/CUTOFFS.

  HAVAC CONTRACTOR TO VERIFY THERMOSTAT


  LOCATIONS.

  ALL ELECTRICAL AND MECHANICAL EQUIPMENT

  (I.E. FURNACES, A/C UNITS, ELECTRICAL PANELS,
  SANITARY SUMP, PITS, DRAIN TILE SUMP, AND

SANITARY SUMP PITS, DE WATER HEATERS) ARE SI DUE TO FIELD CONDITION	JBJECT TO RELOCATION
	ABOVE FINISHED FLOOR:
SWITCHES OVER COUNTER.	
WALL OUTLETS OVER COUN	TER
+42" TO BOTTOM OF HORIZON	TAL OUTLET(TYP. @ COUNTER)
REMAINING SWITCHES	
BATH VANITY BRACKET OUT (1" ABOVE TOP OF VANITY)	[LET 1,2
WATER SOFTENER AND SUM	IP OUTLETS 48" TO C
EXTERIOR GFI OUTLETS	12." .TO .C
GARAGE GFI (ABOVE GARAG	GE FLOOR) 48" TO C
FRONT DOOR COACH LIGHT.	
GARAGE DOOR COACH LIGH	T, 84" · TO C
(ABOVE GARAGE FLOOR)	84" . I.O C
DOORBELL BUTTON	LEVEL W
KITCHEN HOOD FAN "WHIP"	
KITCHEN WALL HUNG MICRO	WAVE OUTLET 72" TO C
KITCHEN DISHWASHER RECE	PTACLE UNDER SI
KITCHEN RANGE	24".TD.C
KITCHEN REFRIGERATOR	4.8". TO C

CL = CENTER LINE 1 = FIELD VERIFY 2 = MASTER BATH STANDARD 30" HIGH VANITY TO BE RAISED 4"

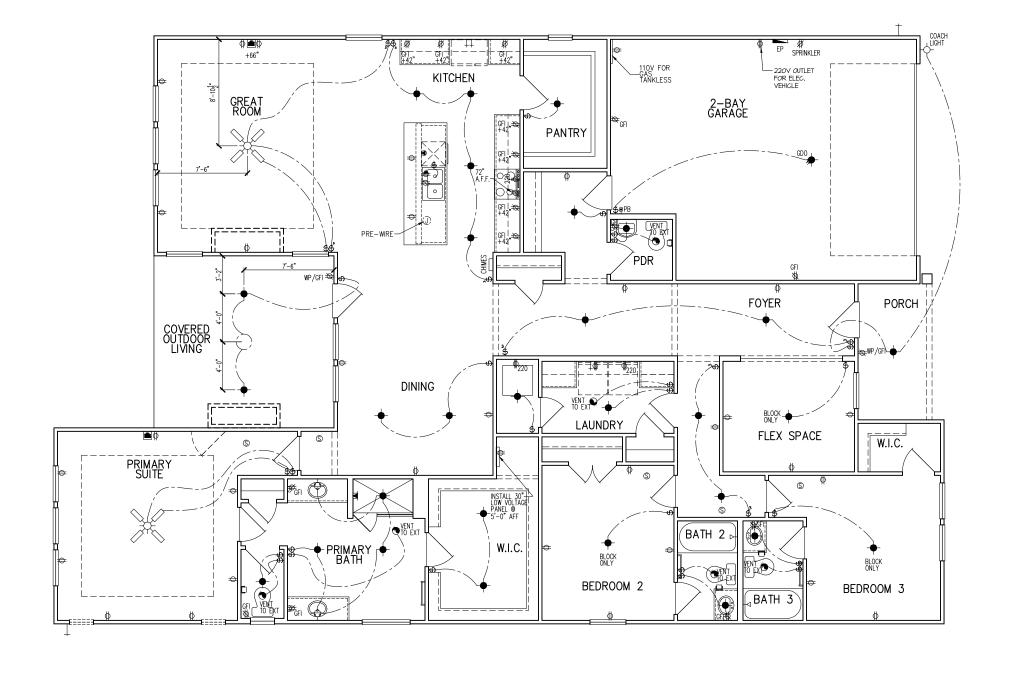

Dointe HOMES RR BLD. SUITE 400, FALEIGH, NG 27607

Business Operations 5440 Wade Park Blvd Suite 400 Raleigh, NC 27607

ELECTRICAL PLAN

ALTIS @ SERENITY SERENE XING 1st FLOOR 36 SUBDIVISION:
ADDRESS: 36
LOT: 275 BL

Issue Date: 11-17-24 Drawn By: ACC

5921-09

POPLAR RIDGE

E1.10C

ELECTRICAL FIXTURE SCHEDULE		
DESCRIPTION	SYMBOL	
110V OUTLET	ф	
220V OUTLET	Ф 220	
1/2 HOT OUTLET		
GFI OUTLET	₩ GFI	
WP GFI OUTLET	₩P/GFI	
GARAGE DOOR OPENER OUTLET	Ø GDO	
SECURITY SYSTEM	∯SEC SYS	
DISHWASHER	●DW	
JUNCTION BOX	Ũ	
CEILING MOUNTED LIGHT	$\phi$	
CEILING FAN w/ LIGHT KIT	BROVIDE	
RECESSED CEILING LIGHT	R	
RECESSED WATER PROOF LIGHT	∭ WP	
WALL MOUNTED LIGHT	9	
WALL MOUNTED PUSH BUTTON	<b>b</b> PB	
TWO WAY SWITCH	\$	
THREE WAY SWITCH	<b>*</b> \$	
FOUR WAY SWITCH	<del>\$</del>	
DIMMER SWITCH	\$ <sup>DIM</sup>	
EXHAUST VENTS	<b>S</b> VENT TO EXT	
LOW VOLTAGE PANEL	∳	
PHONE OUTLET	<b>●</b> PH	
TV OUTLET	<b>▲</b> TV	
DATA & RG6 COMBO BOX		
SMOKE DETECTOR	Ŝ	
CARBON MONOXIDE SMOKE DETECTOR COMBO	⊚ CM/SD	
DOOR CHIMES	CHIMES	
ELECTRICAL PANEL	EP EP	
SURFACE MOUNT LED	•	
EXTERIOR WALL MOUNT UPLIGHT	8	
SOFFIT MOUNT FLOOD LIGHT	442	
UNDER COUNTER LIGHTING	esse-UCL	
SMURF TUBE		

## **ELECTRICAL NOTES:**

- 1. PROVIDE AND INSTALL LOCALLY CERTIFIED SMOKE AND CARBON MONOXIDE DETECTORS AS REQUIRED BY NATIONAL FIRE PROTECTION ASSOCIATION (NPA) AND MEETING THE REQUIREMENTS OF ALL GOVERNING CODES PROVIDE AND INSTALL GROUND FAULT CIRCUIT—INTERRUPTERS (GF) AS REQUIRED BY NATIONAL ELECTRIC CODE (NEC) AND MEETING THE REQUIREMENTS OF ALL GOVERNING CODES.


  3. ELECTRICAL CONTRACTOR TO PROVIDE REQUIRED DIRECT HOOK—UPS/CUTOFFS.

  4. HVAC CONTRACTOR TO VERIFY THERMOSTAT LOCATIONS.

  5. ALL ELECTRICAL AND MECHANICAL EQUIPMENT (LE. FURNACES, A/C UNITS, ELECTRICAL PANELS, SANITARY SUMP PITS, DRAIN TILE SUMP, AND WATER HEATERS) ARE SUBJECT TO RELOCATION DUE TO FIELD CONDITIONS.

DUE TO FIELD CONDITIONS.	
ELECTRICAL DEVICES:	ABOVE FINISHED FLOOR:
SWITCHES OVER COUNTER	
WALL OUTLETS OVER COUNTER	
+42" TO BOTTOM OF HORIZONTAL	. OUTLET(TYP. @ COUNTER)
REMAINING SWITCHES	
WALL OUTLETS	
BATH VANITY BRACKET OUTLE (1" ABOVE TOP OF VANITY)	т
WATER SOFTENER AND SUMP	OUTLETS 48" TO CL
EXTERIOR GFI OUTLETS	
GARAGE GFI (ABOVE GARAGE	
FRONT DOOR COACH LIGHT	
GARAGE DOOR COACH LIGHT, (ABOVE GARAGE FLOOR)	84".TO CL
THERMOSTAT	
DOORBELL CHIMES	
DOORBELL BUTTON	LEVEL W/
KITCHEN HOOD FAN "WHIP"	
KITCHEN WALL HUNG MICROWA	
KITCHEN DISHWASHER RECEPT.	
KITCHEN RANGE	
KITCHEN REFRIGERATOR	
WASHER/DRYER OUTLET	
CL - CENTED LINE	

CL = CENTER LINE 1 = FIELD VERIFY 2 = MASTER BATH STANDARD 30" HIGH VANITY TO BE RAISED 4"

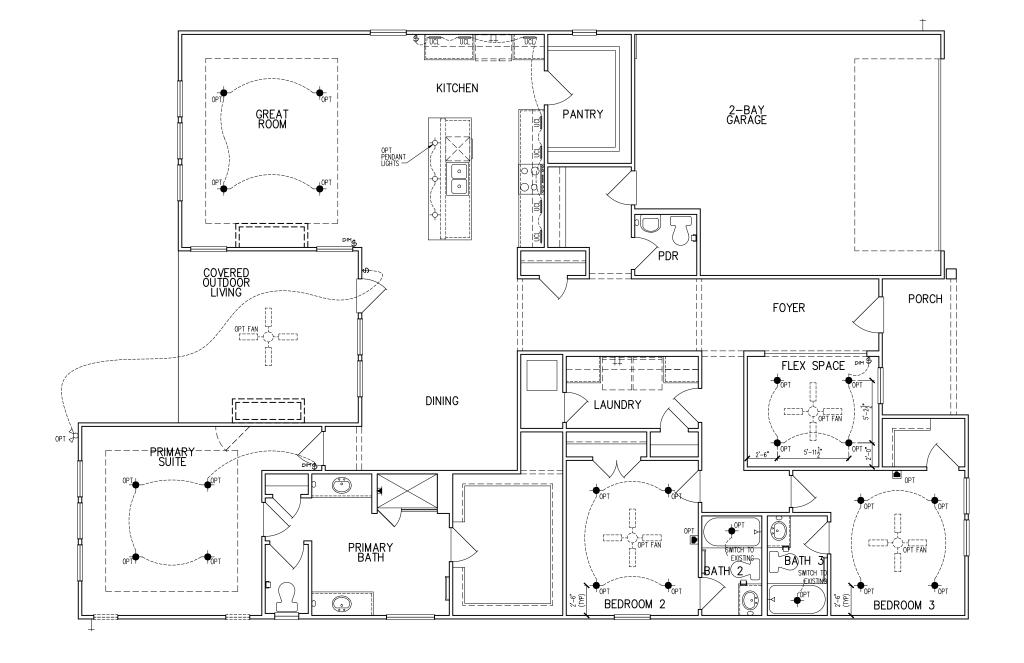

Dointe HOMES RR BLVD, SUITE 400, RALEIGH, NG 27607

Business Operations 5440 Wade Park Blvd Suite 400 Raleigh, NC 27607


- OPITONS ALTIS @ SERENITY SERENE XING 1st FLOOR ELEC. PLAN : 36 SUBDIVISION:
ADDRESS: 36
LOT: 275 BL


Issue Date: 11-17-24 Drawn By: ACC


5921-09

POPLAR RIDGE


E1.11C

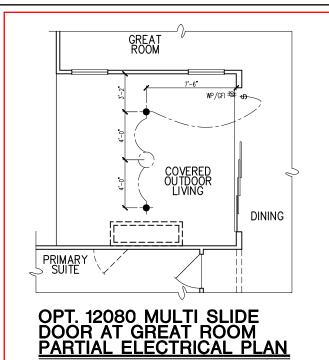

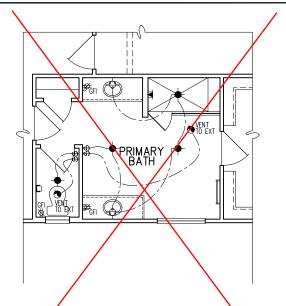

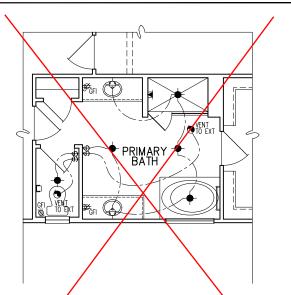

OPT. PRIMARY BATH 2
PARTIAL ELECTRICAL PLAN

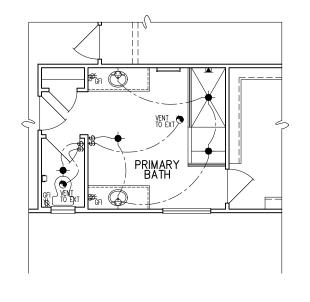

OPT. PRIMARY BATH 3
PARTIAL ELECTRICAL PLAN

OPT. PRIMARY BATH 1
PARTIAL ELECTRICAL PLAN



OPT. SHOWER
BATH 4 - PARTIAL
ELECTRICAL PLAN

# OPT. EXTENDED COVERED OUTDOOR LIVING PARTIAL ELECTRICAL PLAN

OPT. OFFICE ELECTRICAL PLAN


OPT. SHOWER ILO TUB PARTIAL ELECTRICAL PLAN

SCHEDU	LE	
DESCRIPTION	SYMBOL	
110V OUTLET	ф	
220V OUTLET	<b>Ф</b> 220	1
1/2 HOT OUTLET	♦	1
GFI OUTLET	<b>V</b> \$ GFI	<b>ELECTRICAL NOTES:</b>
WP GFI OUTLET	WP/GFI	
GARAGE DOOR OPENER OUTLET	Ø GDO	PROVIDE AND INSTALL LOCALLY CERTIFIED     SMOKE AND CARBON MONOXIDE DETECTION     REQUIRED BY NATIONAL FIRE PROTECTION
SECURITY SYSTEM	∯ SEC SYS	ASSOCIATION (NFPA) AND MEETING THE
DISHWASHER	<b>⊕</b> DW	REQUIREMENTS OF ALL GOVERNING CODES 2. PROVIDE AND INSTALL GROUND FAULT
JUNCTION BOX	0	CIRCUIT—INTERRUPTERS (GFI) AS REQUIRED BY NATIONAL ELECTRIC CODE (NEC) AND MEETING
CEILING MOUNTED LIGHT	- <b></b>	NATIONAL ELECTRIC CODE (NEC) AND MEETING THE REQUIREMENTS OF ALL GOVERNING CODES.
CEILING FAN W/ LIGHT KIT	ERRXINE	ELECTRICAL CONTRACTOR TO PROVIDE     REQUIRED DIRECT HOOK—UPS/CUTOFFS.     HVAC CONTRACTOR TO VERIFY THERMOSTAT     LOCATIONS.
RECESSED CEILING LIGHT	Ø	<ol> <li>ALL ELECTRICAL AND MECHANICAL EQUIPMENT (I.E. FURNACES, A/C UNITS, ELECTRICAL PANELS,</li> </ol>
RECESSED WATER PROOF LIGHT	∭EWP	SANITARY SUMP PITS, DRAIN TILE SUMP, AND WATER HEATERS) ARE SUBJECT TO RELOCATION
WALL MOUNTED LIGHT	Ŷ	DUE TO FIELD CONDITIONS.
WALL MOUNTED PUSH BUTTON	á PB	ELECTRICAL DEVICES: ABOVE FINISHED FLOOR: SWITCHES OVER COUNTER 48". TO CL
TWO WAY SWITCH	\$	WALL OUTLETS OVER COUNTER
THREE WAY SWITCH	3\$	+42 TO BOTTOM OF HORIZONTAL OUTLET(TYP. © COUNTER)
FOUR WAY SWITCH	*\$	REMAINING SWITCHES. 48".TD.CL. WALL OUTLETS. 12". TO CL.
DIMMER SWITCH	\$P™	BATH VANITY BRACKET OUTLET
EXHAUST VENTS	NENT TO EXT	(1" ABOVE TOP OF VANITY)  WATER SOFTENER AND SUMP OUTLETS 48" TO CL
LOW VOLTAGE PANEL	_ \psi =	EXTERIOR GFI OUTLETS
PHONE OUTLET	<b>⊕</b> PH	GARAGE GFI (ABOVE GARAGE FLOOR) 48 TO CL
TV OUTLET	⊕TV	FRONT DOOR COACH LIGHT
DATA & RG6 COMBO BOX	₹	GARAGE DOOR COACH LIGHT, (ABOVE GARAGE FLOOR)
SMOKE DETECTOR	S	THERMOSTAT
CARBON MONOXIDE SMOKE DETECTOR COMBO	⊚ CM/SD	DOORBELL BUTTON
DOOR CHIMES	CHIMES	KITCHEN HOOD FAN "WHIP"
ELECTRICAL PANEL	EP EP	KITCHEN WALL HUNG MICROWAVE OUTLET 72" TO CL KITCHEN DISHWASHER RECEPTACLE JUNDER SIN
SURFACE MOUNT LED	•	KITCHEN RANGE
EXTERIOR WALL MOUNT UPLIGHT	<u> </u>	KITCHEN REFRIGERATOR
COSSIT MOUNT STORE MOUT	A A	monery prince of the first section 100 for the


---- UCL


CL = CENTER LINE 1 = FIELD VERIFY 2 = MASTER BATH STANDARD 30" HIGH VANITY TO BE RAISED 4"

ELECTRICAL FIXTURE

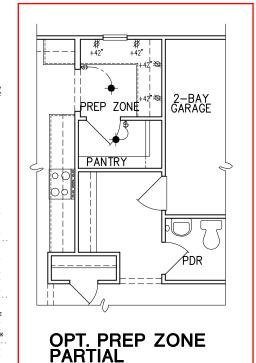

**ELECTRICAL PLAN** 

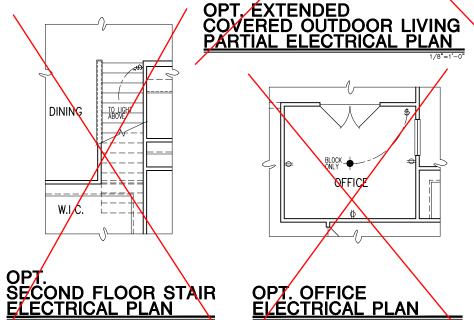

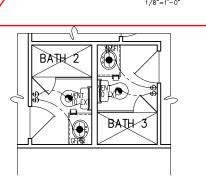

5921-09 POPLAR RIDGE

01.E10

Dointe S HOMES HOW, SUITE 400, RALEIGH, NC 27607

ヸ

Business Operations 5440 Wade Park Blvd Suite 400 Raleigh, NC 27607

ALTIS @ SERENITY SERENE XING

36

ADDRESS: LOT: 275

SUBDIVISION:


Issue Date: 11-17-24

ACC

OPTIONS

PLAN

ELEC.

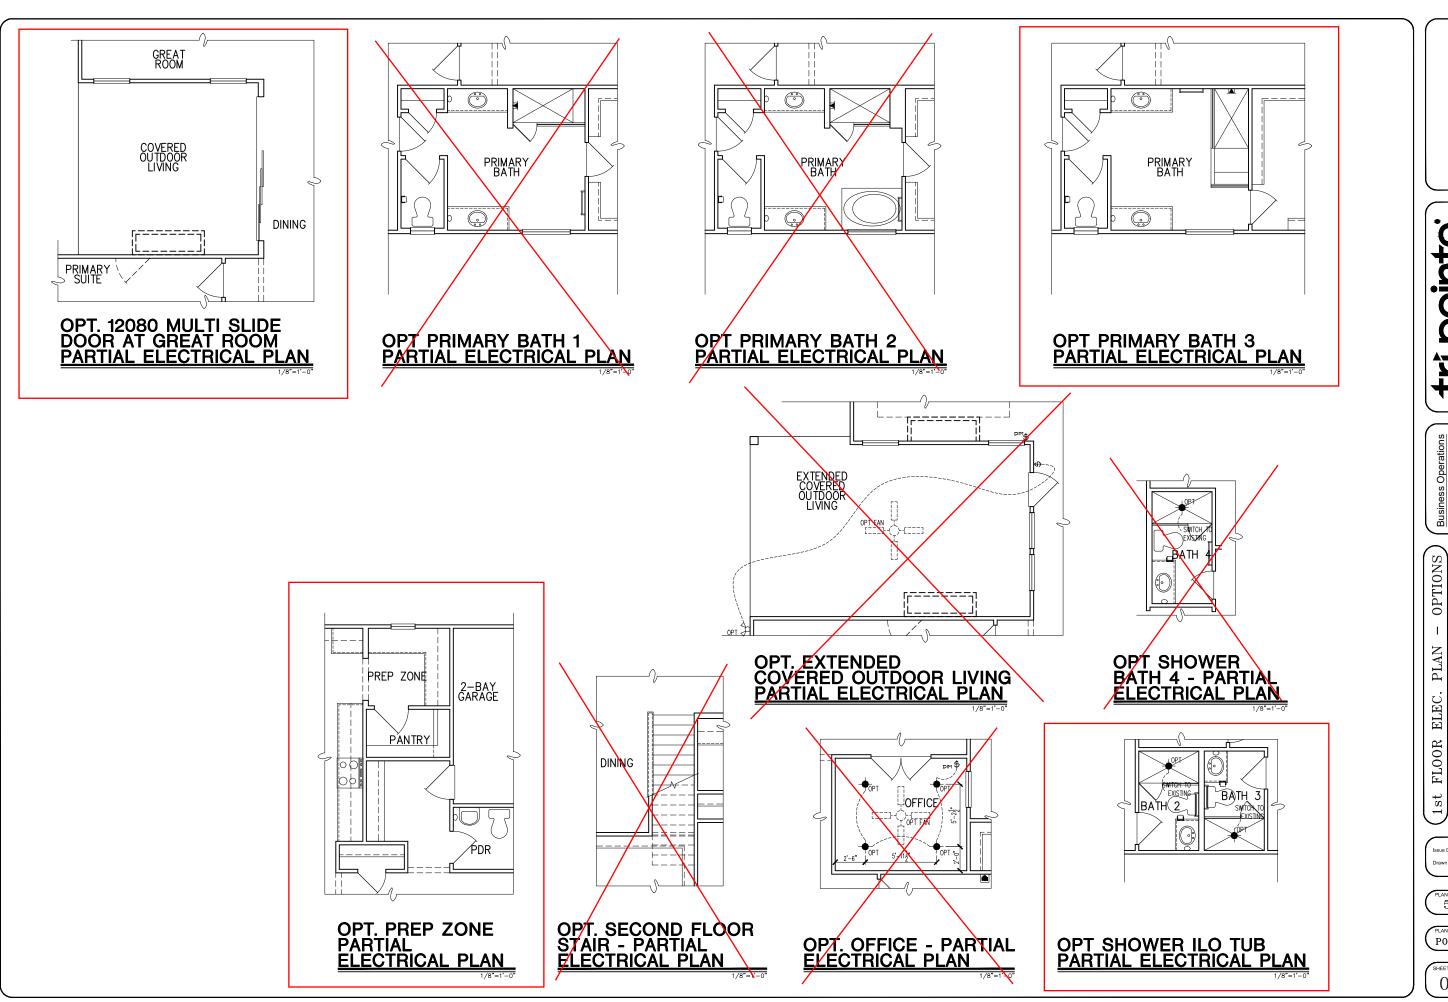

tri pointe HOMES 5440 WAE PARK BLVD, SUITE 400, RALEGH, NG 27607

Business Operations 5440 Wade Park Blvd Suite 400 Raleigh, NC 27607

SERENITY
Suite 400
Suite 400
ING
Raleigh,

TSION: ALTIS @ SERENITY
SS: 36 SERENE XING

SUBDIVISION:
ADDRESS: 36
LOT: 275 BLo

Issue Date: 11-17-24
Drawn By: ACC

5921-09

POPLAR RIDGE

01.E11

#### GENERAL STRUCTURAL NOTES

#### FLOOR FRAMING

- L- IOISTS/TRUSSES SHALL BE DESIGNED BY MANUE TO MEET OR EXCEED L/480 LIVE LOAD DEFLECTION CRITERIA. (EXCLUDES STONE/MARBLE OR WET BED CONSTRUCTED FLOORS - CONTACT M&K FOR EXCLUDED FLOOR DESIGNS)
- PER THE GUIDELINES OF THE TILE COUNCIL OF NORTH AMERICA (TCNA HANDBOOK), IT SHALL BE THE FLOOR FINISH INSTALLER'S RESPONSIBILITY TO VERIEY THAT THE FINISHES TO BE INSTALLED MATCH THE DESIGN CRITERIA NOTED ABOVE (UNDER "DESIGN
- FLOOR SYSTEMS & SHEATHING HAVE BEEN DESIGNED TO SUPPORT ADDITIONAL DEAD LOAD FROM CERAMIC TILE (EXCLUDING MARBLE OR STONE). HOWEVER, IT SHALL BE THE FLOOR FINISH INSTALLER'S RESPONSIBILITY TO PROVIDE PROPER UNDERLAYMENT, UNCOUPLING MEMBRANE AND MORTAR/GROUT PER THE ASSEMBLY DESIGNATIONS IN THE TONA HANDBOOK (TILE COUNCIL OF NORTH AMERICA).
- AT I-JOIST FLOORS, PROVIDE I 1/8" MIN. OSB RIM BOARD.
- METAL HANGERS SHALL BE SPECIFIED BY MANUFACTURER, U.N.O.
- I-JOIST/TRUSS SHOP DWGS. SHALL BE SUBMITTED TO ARCH. & ENG. FOR REVIEW AND APPROVAL PRIOR TO FABRICATION OR DELIVERY
- FLOOR SHEATHING SHALL BE 23/32" A.P.A. RATED 'STURD-I-FLOOR' 24" O.C. EXPOSURE I (OR APPROVED EQUAL) WITH TONGUE AND GROOVE EDGES. FASTEN TO FRAMING MEMBERS W GLUE AND
- 2 ½" x 0.131" NAILS @ 6"o.c. @ PANEL EDGES € @ 12"o.c. FIELD.
- 2 3 × 0.120 NAILS 4 O.C. PANEL EDGES € 8 O.C. FIELD.
- 2 3 × 0.113" NAILS @ 3" O.C. @ PANEL EDGES \$ @ 6" O.C. IN FIELD

#### ROOF FRAMING

- ROOF SHEATHING SHALL BE 1/16" A.P.A. RATED SHEATHING 24/16 EXPOSURE I (OR APPROVED EQUAL). FASTEN TO FRAMING MEMBERS
- W/ 2 1 × 0.131" NAILS @ 6"O.C. @ PANEL EDGES \$ @ 12" O.C. FIELD.
- · w/ 2 🖁 × 0.120" NAILS 👁 4"o.c. 👁 PANEL EDGES 🕏 🕫 8" O.C. FIELD. - w/ 2 🖁 × 0.113" NAILS @ 3"o.c. @ PANEL EDGES \$ @ 6" O.C. FIELD.
- WITHIN 48" OF ALL ROOF EDGES RIDGES & HIPS FASTEN ROOF SHEATHING FIELDS PER EDGE NAILING SPEC.
- FASTEN FACH ROOF TRUSS TO TOP PLATE W/ SIMPSON H25T CLIP (OR APPROVED EQUAL) • ALL BEARING POINTS. PROVIDE (2) H2.51 CLIPS AT 2-PLY GIRDER TRUSSES, (3) H2.5T CLIPS AT 3-PLY GIRDER TRUSSES & ROOF BEAMS - AT ALL BEARING POINTS.
- METAL HANGERS SHALL BE SPECIFIED BY THE MANUFACTURER, U.N.O. ROOF TRUSS SHOP DWGS SHALL BE SUBMITTED TO ARCH & ENG.
- FOR REVIEW AND APPROVAL PRIOR TO FABRICATION OR DELIVERY ERECT AND INSTALL ROOF TRUSSES PER WTCA & TPI'S BCSI I
- "GUIDE TO GOOD PRACTICE FOR HANDLING, INSTALLING & BRACING OF METAL PLATE CONNECTED WOOD TRUSSES." SUPPORT SHORT SPAN ROOF TRUSSES w/2x4 LEDGER FASTENED TO
- FRAMING w/(2) 3" x 0.120" NAILS @ 16" O.C. (UP TO 7' SPAN).

#### CONNECTION SPECIFICATIONS (TYP. U.N.O.)

DESCRIPTION OF BLDG, ELEMENT	3"x0.131" NAIL5	3"x0.120" NAILS
JOIST TO SOLE PLATE	(3) TOENAILS	(3) TOENAILS*
SOLE PL. TO JOIST/RIM OR BLK'G	NAILS @ 4" o.c.	NAILS @ 4" o.c.
STUD TO PLATE	(4) TOENAILS/ (3)END NAILS	(4) TOENAILS/ (4)END NAILS*
RIM TO TOP PLATE	TOENAILS @ 6" o.c.	TOENAILS @ 4" o.c.*
BLK'G. BTWN. JOISTS TO TOP PL.	(3) TOENAILS EA. END	(3) TOENAILS EA. END*
DOUBLE STUD	NAILS @ 16" O.C.	NAILS @ 16" o.c.
DOUBLE TOP PLATE	NAILS @ 12" o.c.	NAILS @ 8" o.c.
DOUBLE TOP PLATE LAP SPLICE	(I2) NAILS IN LAPPED AREA (24" MIN.)	(15) NAILS IN LAPPED AREA (24" MIN.)
TOP PLATE LAP @ CORNERS & INTERSECTING WALLS	(3) NAILS	(3) NAILS
RAFTER/TRUSS TO TOP PLATE	(4) TOENAILS +	(4) TOENAILS +
	(I) SIMPSON H2.5T	(I) SIMPSON H2.5T
GAB. END TRUSS TO DBL. TOP PL.	TOENAILS @ 8" o.c.	TOENAILS Ø 6" o.c.
R.T. w/ HEEL HT. 9 1/4" TO 12"	2xIO BLK EVERY 3RD BAY FASTENED TO DBL. TOP PLATE W/ TOENAILS @ 6" O.C.	2xIO BLK EVERY 3RD BAY FASTENED TO DBL. TOP PLATE W/ TOENAILS @ 4" O.C.
R.T. w/ HEEL HT. 12" TO 16"	2xI2 BLK EVERY 3RD BAY FASTENED TO DBL. TOP PLATE W/ TOENAILS @ 6" O.C.	2xI2 BLK EVERY 3RD BAY FASTENED TO DBL. TOP PLATE w/ TOENAILS @ 4" O.C.
R.T. w/ HEEL HT. UP TO 24"	LAP WALL SHTG. W/ DBL. TOP PL. \$ INSTALL ON TRUSS VERT FASTEN W/ NAILS @ 6" O.C.	LAP WALL SHTG. W/ DBL. TOP PL. \$ INSTALL ON TRUSS VERT FASTEN W/ NAILS @ 6" O.C.*
R.T. w/ HEEL HT. 24" TO 48"  LAP WALL SHTG. w/ DBL. TOP PL.  INSTALL ON TRUSS VERT FASTEN w/ NAILS @ 6" O.C. PROVIDE 2x BLK @ EA. BAY AT TOP OF HEEL		LAP WALL SHTG, W DBL. TOP PL. \$ INSTALL ON TRUSS VERT FASTEN W NAILS @ 6" O.C. PROVIDE 2x BLK @ EA. BAY AT TOP OF HEEL!
WALL TO FOUNDATION	WALL SHTG. LAP W/ SILL PL. \$ FASTENED PER SHEAR WALL FASTENING SPEC.	
* 2½"x0.113 IS AN ACCEPTABLE AL	TERNATIVE TO A 3"x0.120", SAME SP	'ACING OR NUMBER OF NAILS.

#### GENERAL STRUCTURAL NOTES

#### DESIGN LOADING

- DESIGN IS BASED ON 2018 NORTH CAROLINA STATE BUILDING CODE: RESIDENTIAL CODE.
- WOOD FRAME ENGINEERING IS BASED ON NDS, "NATIONAL DESIGN SPECIFICATION FOR WOOD CONSTRUCTION" - LATEST EDITION
- DESIGN LOADS ROOF

SNOW = 15 PSF (12 PSF GROUND SNOW, TRUSSES) LIVE = 20 PSF (REDUCIBLE BASED ON ROOF PITCH) DEAD = 7 PSE TG. TO PSE BG. LOAD DURATION FACTOR = 1.25

LIVE = 40 PSE (30 PSE @ SLEEPING AREAS)

DEAD = 10 PSF (I-JOISTS), 15 PSF (FLOOR TRUSSES) ADD'L IO PSE @ CERAMIC TILE IN KITCHEN. SUNROOMS, BATHS, FOYER, LAUND, & MUDRY

2,000 PSF ASSUMED ALLOWABLE BEARING PRESSURE (TO BE VERIFIED BY BUILDER)

115 MPH, EXPOSURE B

#### GENERAL FRAMING

- ALL TYP. NAIL FASTENER REQUIREMENTS ARE NOTED IN STANDARD CONNECTIONS TABLE (IRC TABLE R602.3(I)) OR ON PLANS. ALL NAILS SPECIFIED ARE MIN DIAMETER AND LENGTH REQUIRED FOR CONNECTION. ALL HANGER NAILS SHALL BE INSTALLED PER MANUFACTURER'S REQUIREMENTS FOR MAX CHARTED CAPACITY NOTE: HANGERS USE COMMON NAIL DIAMETERS NOT TYPICAL FRAMING GUN NAILS.
- EXT. & INT. BEARING WALLS SHALL BE 2x4 OR 2x6 (AS SHOWN ON PLANS) @ 16" O.C. SPF/SP #2 GRADE LUMBER, OR BETTER, U.N.O.. . WALLS OVER 12' TALL SHALL BE PER PLAN.
- ALL INTERIOR BEARING WALLS ARE ASSUMED TO BE SHEATHED W/ GYP WALL BOARD (ONE SIDE MIN.) OR PROVIDE MID HT. BLOCKING.
- ALL HEADERS, BEAMS & OTHER STRUCTURAL MEMBERS SHALL BE SPRUCE-PINE-FIR #2 (SPE) OR SOUTHERN PINE #2 (SP) LUMBER OR BETTER. SUPPORT ALL HEADERS/ BEAMS W/ (1)2x JACK STUD \$ (1)2x KING STUD MINIMUM
- THE NUMBER OF STUDS SPECIFIED AT A SUPPORT INDICATES THE NUMBER OF JACK STUDS REQUIRED, U.N.O.,
- ALL NON-BEARING INTERIOR STUD WALLS SHALL BE CONSTRUCTED WITH 2x 'STUD' GRADE MEMBERS SPACED € 24" O.C. (MAX., U.N.O.)

  ◆ HEADERS IN NON-LOAD BEARING WALLS SHALL BE: (1)2x4/6 FLAT @ OPENINGS UP TO 4', (2)2x4/6 FLAT UP TO 8'.
- ALL FRAMING LUMBER SHALL BE DRIED TO 15% MC (KD-15)
- ENGINEERED LUMBER BEAMS TO MEET OR EXCEED THE FOLLOWING: • 'LVL' - Fb=2600 psi; Fv=285 psi; E=2.0x10^6 psi
- ENGINEERED LUMBER POSTS TO MEET OR EXCEED THE FOLLOWING 'LVL' - Fb=2400 psi; FcII=2500 psi; E=I.8xI0^6 psi
- FOR 2 \$ 3 PLY BEAMS OF EQUAL 134" MAX, WIDTH, FASTEN PLIES TOGETHER WITH 3 ROWS OF 3"X0.120" NAILS @ 8" O/C OR 2 ROWS K"x3K" SIMPSON SDS SCREWS (OR 3K" TRUSSI OK SCREWS) @ 16" GREATER APPLY EASTENING AT BOTH FACES FOR 3-PLY CONDITION. LOCATE TOP & BOTTOM NAILS/SCREWS 2" FROM EDGE. SOLID 31/3" OR 51/4" BEAMS ARE ACCEPTABLE, USE 2 ROWS OF NAILS FOR 2x6 \$ 2x8 MEMBERS
- FOR 4 PLY BEAMS OF FOUAL 13/4" MAX, WIDTH, FASTEN PLIES TOGETHER WITH 3 ROWS OF 1/2 x6" SIMPSON SDS SCREWS (OR 6 3/4" TRUSSLOK SCREWS) @ 16" O/C. USE A MINIMUM OF 4 ROWS FOR BEAM DEPTHS OF 14" OR GREATER, APPLY EASTENING AT BOTH FACES (ONE SIDE ONLY FOR TRUSSLOK SCREWS). LOCATE TOP AND BOTTOM SCREWS 2" FROM EDGE, A SOLID 7" BEAM IS ACCEPTABLE
- PROVIDE SOLID BLOCKING IN FLOOR SYSTEM UNDER ALL POSTS CONTINUOUS TO FND./BEARING, BLOCKING TO MATCH POST ABOVE.
- ALL EXTERIOR 4x4 WOOD POSTS SHALL HAVE SIMPSON BCS2-2/4 CAP & ABW44 BASE, U.N.O.
- · CORROSION NOTES
- BUILDER RESPONSIBLE TO DETERMINE CORROSION-RESISTANCE REQUIREMENTS AND COMPATIBILITY OF HARDWARE FASTENERS AND CONNECTORS FOR ENVIRONMENTAL EXPOSURE AND IN CONTACT W/ PRESERVATIVE-TREATED WOOD OF ACTUAL FINAL CONDITIONS AND SOURCED MATERIALS. CONTACT LUMBER \$ HARDWARE SUPPLIERS TO COORD.

#### GENERAL STRUCTURAL NOTES

#### **FOUNDATION**

- DESIGN IS BASED ON 2018 NORTH CAROLINA STATE BUILDING CODE:
- FOOTING DESIGN 2,000 PSF ALLOWABLE SOIL BEARING
- FASTEN 2x4/6 SILL PLATES TO CONC FND WITH A MINIMUM OF 2
- ANCHORS PER PLATE 12" MAX FROM PLATE ENDS UTIL 17ING I/2" DIA. ANCHOR BOLTS 6'-0" O.C,7" MIN. EMBEDMENT
- I/2" DIA. x 6" I ONG SIMPSON TITEN HD @ 6'-0" O.C. • SIMPSON MASA ANCHOR STRAPS @ 6'-0" O.C. (CONCRETE)
- ALL LUMBER EXPOSED TO WEATHER OR IN CONTACT W/ PERIMETER
- FOUNDATION SHALL BE PRESERVATIVE TREATED SOUTHERN PINE #2. BUILDER TO VERIEY CORROSION-RESISTANCE COMPATIBILITY OF HARDWARE & FASTENERS IN CONTACT W/ PRESERVATIVE-TREATED

WOOD, CONTACT LUMBER & HARDWARE SUPPLIERS TO COORD.

- FOOTINGS SHALL BE PLAIN CONCRETE, U.N.O.
- CONCRETE DESIGN BASED ON ACL 318, CONCRETE SHALL ATTAIN THE FOLLOWING MIN. COMPRESSIVE STRENGTHS IN 28 DAYS, U.N.O. f'c = 3,000 psi: ...... FOOTINGS & INTERIOR SLABS ON GRADE 3,500 psi: ...... GARAGE & EXTERIOR SLABS ON GRADE fu = 60.000 psi
- ALL CONCRETE EXPOSED TO THE WEATHER SHALL NOT HAVE LESS THAN 5% OR MORE THAN 7% AIR ENTRAINMENT
- ALL FOOTINGS SHALL BEAR BELOW FROST LINE (TYP.) OR 12" MIN IN REGIONS WHERE CODE FROST DEPTH IS NOT APPLICABLE. CONSULT SOILS REPORT OR BUILDING DEPT. FOR MINIMUM DEPTH BELOW GRADE
- \* FOOTINGS AND SLABS ON GRADE SHALL BEAR ON VIRGIN SOIL OR
- PROVIDE CONTROL JOINTS AT ALL INSIDE CORNERS OF SLAB EDGES, AND OTHER LOCATIONS WHERE SLAB CRACKS ARE LIKELY TO DEVELOP
- JOINTS SHALL BE LOCATED @ 10'-0" O.C. (RECOMMENDED) OR 15'-0" O.C. (MAXIMUM)
- LOINT GRID PATTERN SHALL BE AS CLOSE TO SQUARES AS POSSIBLE (I:I RATIO), WITH A MAXIMUM OF I:1.5 RATIO
- · CONTROL JOINTS SHALL NOT BE INSTALLED IN STRUCTURAL
- DIMENSIONS BY OTHERS, BUILDER TO VERIFY.

#### MEANS & METHODS NOTES

THE STRUCTURE IS DESIGNED TO BE SELF SUPPORTING AND STABLE AFTER THE BUILDING IS FINISHED AND ALL PLAN, DETAIL, AND NOTE SPECIFICATIONS HAVE BEEN COMPLETED. IT IS THE CONTRACTOR'S SOLE RESPONSIBILITY TO DETERMINE THE ERECTION PROCEDURES AND SEQUENCE TO THE SAFETY OF THE BUILDING AND ITS COMPONENTS DURING CONSTRUCTION. THIS INCLUDES BUT IS NOT LIMITED TO, THE ADDITION OF NECESSARY SHORING, SHEETING, TEMPORARY BRACING, GUYS, AND TIE-DOWNS. CONTRACTOR SHALL BE RESPONSIBLE FOR ALL SHORING AND BRACING REQUIRED TO STABILIZE AND PROTECT EXISTING AND ADJACENT STRUCTURES AND SYSTEMS DURING COURSE OF DEMOLITION AND CONSTRUCTION OF THE PROJECT

STRUCTURAL DESIGN AND SPECIFICATIONS ASSUME THAT ALL SUPPORTING AND NON-SUPPORTING ELEMENTS IN CONTACT WITH FLOOR FRAMING ARE LEVEL, INCLUDING, BUT NOT LIMITED TO: FOUNDATIONS. SLABS ON GRADE, BEAMS, WALLS, AND NON-BEARING ELEMENTS. IT IS THE CONTRACTOR'S RESPONSIBILITY TO VERIEY LEVELNESS AND MAKE ADJUSTMENTS AS NECESSARY, INCLUDING CONSIDERATION OF THOSE AREAS THAT MAY BE WITHIN CONTRACTUAL, INDUSTRY OR WARRANTY TOLERANCES

#### VENEER LINTEL SCHEDULE

SPAN (MAX)	HEIGHT OF VENEER ABOVE LINTEL	STEEL ANGLE SIZE
3'-0"	20 FT. MAX	L3"x3"x¼"
	3 FT. MAX	L3"x3"x¼"
6'-0"	I2 FT. MAX	L4"x3"x¼"
	20 FT. MAX	L5"x3½"x¾"
8'-0"	3 FT. MAX	L4"x4"x¼" *
8-0	I2 FT. MAX	L5"x3½"x¾"
	I6 FT. MAX	L6 <b>'</b> x∄⁄2"x¾6"
9'-6"	I2 FT. MAX	L6"x3½"x%6"
16'-0"	2 FT. MAX	L7"x4"x½" **
	2 ET MAY	1 (41), (41), (7) ##

- IL LINTELS

  \$40LL SIPPORT 2 %\* 3 ½" YINDEER W 40 POF MAXIMIM MEIGHT.

  169 SHALL HAVE 4" MN. BEARING

  169 SHALL HAVE 9" MN. BEARING

  169 SHALL HAVE 9" MN. BEARING

  169 SHALL BAT SET PASTINED PACK TO HEADER IN WALL 4049" oz. w/ ½" DIA. x 3 ½"

  LONG LAG 50/ENPG IN 2" LONG YERTICALLY \$LOTTED HALES.

  MAX. YEBER IN APPLIES TO ANY FORTION OF PROKO CAPE THE OPENING.

  ALL INITES 99 SHALL BE LONG LEG YERTICAL.

  MAY BEC OF IN THE PIELD TO BE 3½" MIDE OVER THE BEARING LISGITH ONLY. THIS

  SET STRUCTUREN ANY FOR SOME THE EXTIRGAT TOE OF THE HORIZONTAL LEG

  MAY BEC OF IN THE PIELD TO BE 3½" MIDE OVER THE BEARING LISGITH ONLY. THIS

  SET STRUCTUREN ANY FOR SOME THE ANY ELGONOMY ONLY THE PIELD THE
- FOR QUEEN VENEER USE L4X3%". 'FOR 3%" VENEER ONLY, SEE PLAN FOR VENEER SUPPORT IF VENEER < 3½" THICK

#### ADDITIONAL NOTES FOR TRUSS & I-JOIST MANUFACTURER

ROOF TRUSS, FLOOR TRUSS AND ENGINEERED JOISTS SHALL BE DESIGNED TO MEET THE DEFLECTION CRITERIA BELOW, UNLESS NOTED OTHERWISE ON PLAN, MULHERN & KULP CANNOT BE HELD RESPONSIBLE FOR ANY STRUCTURAL ISSUES RELATED TO ANY BUILDING COMPONENT IF COMPONENT SHOP DRAWINGS ARE NOT SUBMITTED TO M&K FOR REVIEW PRIOR TO FABRICATION, DELIVERY, OR INSTALLATION.

TRUSSES/LIGISTS SHALL BE DESIGNED SO THAT DIFFERENTIAL DEFLECTION BETWEEN ADJACENT PARALLEL TRUSSES/JOISTS OR GIRDER TRUSSES/FLUS BEAMS DO NOT EXCEED THE FOLLOWING: A ROOF TRUSSES.

I/4" DEAD LOAD

B. FLOOR TRUSSES, ATTIC TRUSSES, \$ 1-JOISTS: I/8" DEAD LOAD

ABSOLUTE DEAD LOAD DEFECTION OF FLOOR TRUSSES/ATTIC TRUSSES WHEN ADJACENT TO FLOOR FRAMING BY OTHERS SHALL BE LIMITED TO 3/16". (NO DIFFERENTIAL DEFLECTION

#### FLOOR JOIST NOTES

- ALL FLOOR JOISTS SHALL BE THE DEPTI SPECIFIED ON PLAN - FLOOR JOISTS SERIES & SPACING IS PER THE FLOOR JOIST MANUF.
  - SPACING SHALL NOT EXCEED 19.2" O.C. (MAX.) @ LOCATION OF TILE: SPACING SHALL NOT
  - EXCEED 16" O.C. (MAX.)

#### LATERAL/WALL BRACING & WALL SHEATHING SPECIFICATIONS

THIS MODEL HAS BEEN DESIGNED TO RESIST LATERAL FORCES RESULTING FROM:

## MPH WIND IN 2018 NCSBC:RC

(115 MPH WIND SPEED IN ASCE 7-10 WIND MAP, PER IRC R301,2,1,1) EXP. B, RISK CAT. 2 & SEISMIC CAT. A/B.

THE DESIGN WAS COMPLETED PER 2015 IBC (SECTION 1609) & ASCE 7-10. AS PERMITTED BY R301.1.3 OF THE 2018 NCSBC:RC. ACCORDINGLY THIS MODEL, AS DOCUMENTED AND DETAILED HEREWITHIN, IS ADEQUATE TO RESIST THE CODE REQUIRED LATERAL FORCES.

DESIGN WIND UPLIET LOADS HAVE BEEN CALCULATED UTILIZING ASCE 7-10 (ACCEPTED ENGINEERING PRACTICE) AS ALLOWED PER 2018 NCSBC:RC SECTION R802.II.I.I. THIS MODEL HAS BEEN DETAILED WHERE REQUIRED & ENGINEERED TO RESIST THE WIND UPLIFT LOAD PATH PER SECTIONS R602.3.5¢ R802.II.

#### EXT. WALL SHEATHING SPECIFICATION

- 7/16" OSB OR 15/32" PLYWOOD: FASTEN SHEATHING W/ 2 ₹ "x0.113 NAILS @ 6" O.C. AT EDGES & @ 12" O.C. IN THE PANEL FIELD. (TYP, U.N.O.) ALL SHEATHING PANELS SHALL BE ORIENTED
- VERTICALLY (LONG DIRECTION PARALLEL TO STUDS) AND INSTALLED FULL HEIGHT OF SHEAR WALL - OR 2x HORIZONTAL BLOCKING SHALL BE PROVIDED TO SUPPORT ALL UNSUPPORTED PANEL EDGES & EDGE
- ALL EXT. WALLS SHALL BE CONTINUOUSLY SHEATHED AND ARE CONSIDERED SHEAR WALLS.
- ALT. STAPLE CONNECTION SPEC: 1 3/4" 16 GA STAPLES (1/6" CROWN) @ 3" O.C. AT EDGES \$ @ 6" O.C IN FIELD.


#### 3" O.C. EDGE NAILING

AT DESIGNATED AREAS - FASTEN PANEL EDGES OF WOOD STRUCTURAL WALL SHEATHING TO FRAMING W 2 g × 0.113" NAILS @ 3" O.C. AND 12" O.C. IN THE PANEL FIELD NO STAPLE ALTERNATIVE AVAILABLE AT THIS SPEC. ALL SHEATHING PANELS SHALL BE ORIENTED VERTICALLY (LONG DIRECTION PARALLEL TO STUD) AND INSTALLED FULL HEIGHT OF SHEAR WALL - OR - 2x HORIZONTAL BLOCKING SHALL BE PROVIDED TO SUPPORT UNSUPPORTED PANEL EDGES AND 3" O.C. EDGE FASTENING.

#### TYP. UNIT SEPARATION WALL SHEATHING SPECIFICATION

1/2" OR 5/8" GYPSUM WALL BOARD: FASTEN GWB SHEATHING TO FRAMING W/ 1 3"X0.086" COOLER NAILS OR I &" DRYWALL SCREWS @ 7" O.C. PANEL EDGES & PANEL FIELD (INCLUDING T&B PLATES

- SEE CONNECTION SPECIFICATIONS CHART FOR STANDARD SHEAR TRANSFER DETAILING, IF ADDITIONAL CAPACITY IS REQUIRED BY DESIGN. T WILL BE SPECIFICALLY NOTED ON PLAN.
- DESIGN ASSUMES 16" O.C MAX. STUD SPACING, U.N.O.
- ALL STRUCTURAL PANELS ARE TO BE DIRECTLY APPLIED TO STUD FRAMING.
- PRE-MANUFACTURED PANELIZED WALLS: FASTEN TOGETHER END STUDS OF WALL PANELS SHEATHED W/ OSB OR PLYWOOD W/ 3" x 0.120" NAILS @ 4" O.C. (THRU ONE SIDE ONLY)

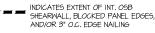

NDICATES HOLDOWN

MULHERN+KULP
RESIDENTIAL STRUCTURAL ENGINEERINS



lulhern+Kulp project number

243-2403

SMŁ KM ssue date: 08-16-2024

REVISIONS:

initial: 11/08/2024 SMM DATED MODEL NAME, OPT, EXT, COVID, PORCH


S NOTE MOD

SERENITY MASTER SET RALEIGH, NC 60 5921

GENERAL

**S0.0** 

## Reference S1.1 For Elevation C Details

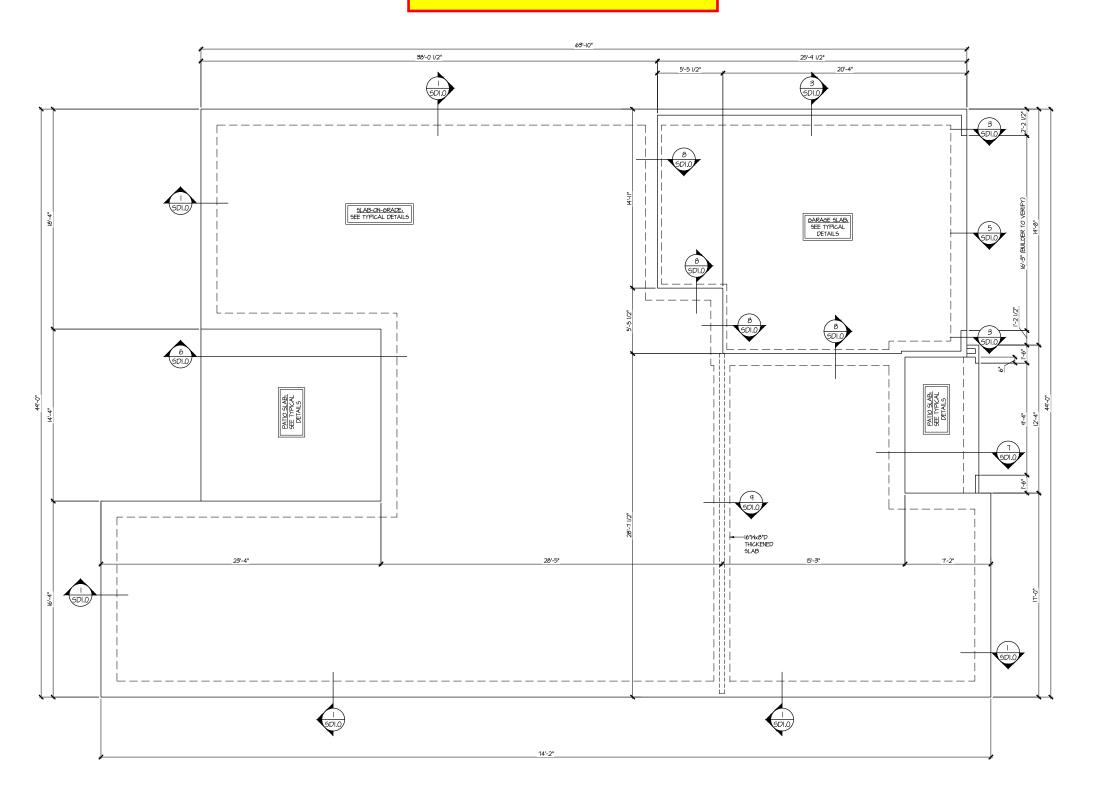

SLAB FOUNDATION PLAN ELEV. A SCALE: 1/4"=1'-0" (22x24 SHEET) 1/8"=1'-0" (IIxIT SHEET)

MULHERN+KULP
RESIDENTIAL STRUCTURAL ENGINEERING
3665 Braickide Parkway, Sala 256 - Apharata, GA 36622
p.776-777-6074 - multimakepiscom
NC Licence # C-36.25



Mulhern+Kulp project number:

243-24035

SMK ΚMV issue date: 08-16-2024

REVISIONS:

date: initial:
II/08/2024 SMM
UPDATED MODEL NAME, OPT. EXT. COVID. PORCH

tri pointe

- INTERIOR BEARING WALL
- ==== BEARING WALL ABOVE (B.W.A.)
- BEAM / HEADER
- INDICATES EXTENT OF INT.

  OSB SHEARWALL AND/OR
  3" O.C. EDGE NAILING
- EXTENT OF VALLEY TRUSS OVERFRAMING

   24" O.C. (MAX.)
- EXTENT OF FLOOR SYSTEM TO BE DESIGNED FOR TILE
- NDICATES HOLDOWN
- JL METAL HANGER
- \* INDICATES POST ABOVE. PROVIDE SOLID BLOCKING UNDER POST OR JAMB ABOVE.


REFER TO SO.O FOR TYPICAL STRUCTURAL NOTES # SCHEDULES


LEGEND

FOUNDATION PLAN

5921-09 MODEL SERENITY MASTER SET RALEIGH, NC

**S1.0** 

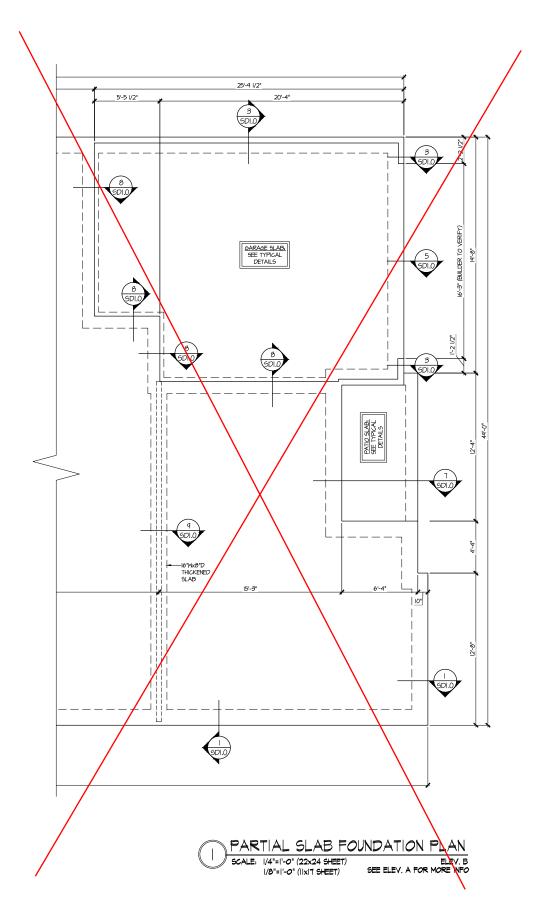

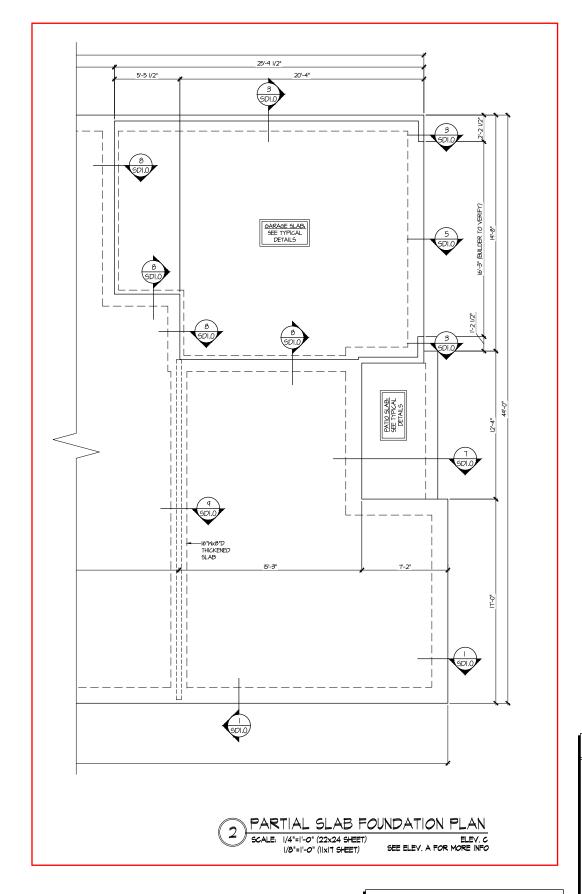

REFER TO SO.O FOR TYPICAL STRUCTURAL NOTES & SCHEDULES

MULHERN+KULP

BESIDENTIAL STRUCTURAL ENSINEERING
3865 Braisled Parkway, Sala 256 - Aphrenia, SA 2862

p.776-777-9074 - multiperiodicom

N. Licence # C-2825



Mulhern+Kulp project number:

243-24035

SMK KΜ\ issue date: 08-16-2024

REVISIONS:

date: initial:
II/08/2024 SMM
UPDATED MODEL NAME, OPT. EXT. COVID. PORCH

tri pointe

## LEGEND

- INTERIOR BEARING WALL
- □===□ BEARING WALL ABOVE (B.W.A.)
- BEAM / HEADER
- INDICATES EXTENT OF INT.


  OSB SHEARWALL AND/OR
  3" O.C. EDGE NAILING
- EXTENT OF VALLEY TRUSS OVERFRAMING

  24" O.C. (MAX.)
- EXTENT OF FLOOR SYSTEM TO BE DESIGNED FOR TILE
- NDICATES HOLDOWN
- JL METAL HANGER
- \* INDICATES POST ABOVE. PROVIDE SOLID BLOCKING UNDER POST OR JAMB ABOVE.

FOUNDATION PLAN

5921-09 MODEI SERENITY MASTER SET RALEIGH, NC

## Reference S2.1 For Elevation C Details

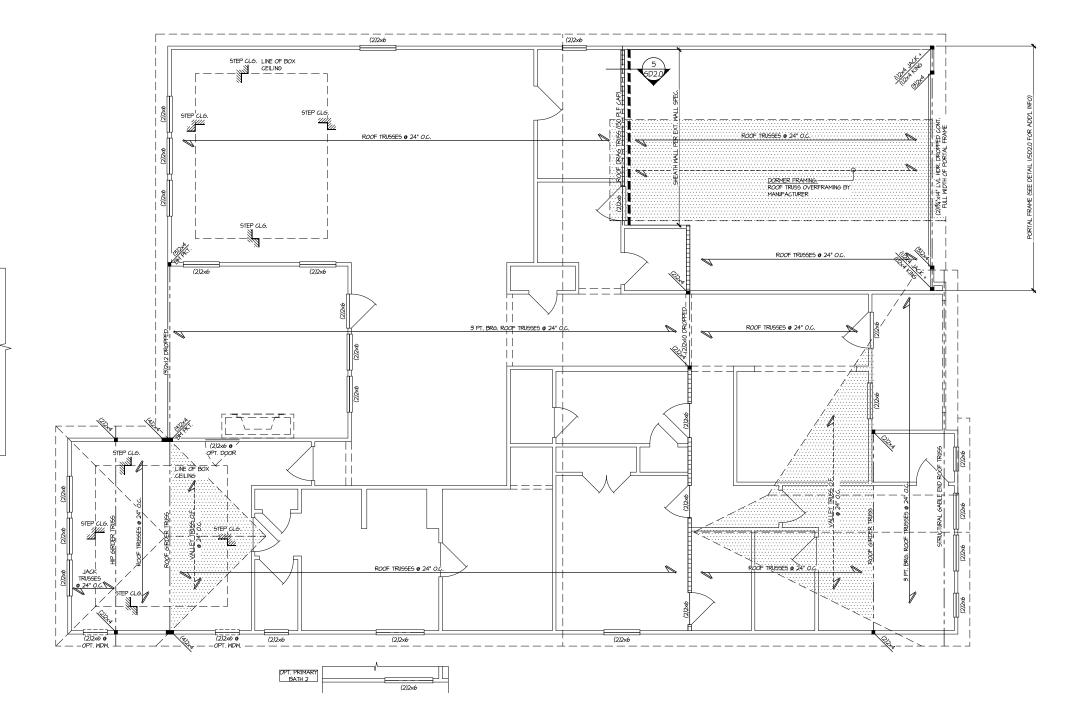

REMOVE— (I)2x4 TOP 2: PLATE TO SE FIT HDR. SEAL DE 75.22

© copyright, MQUENN's NUP
Structural Engineering, Inc.

MULHERN + KULP

RESIDENTIAL STRUCTURAL ENGINEERING

3665 Brankskip Parkway, Sala 256 - Aphwella, SA 3602

9.70-777-6074 - mulbenkulpsom

NC. Licence # C-39.25

**y** 

Mulhern+Kulp project number:

243-24035

project mgr: SMK drawn by: KMV issue date: 08-16-2024

REVISIONS:

date: initial:
II/08/2024 SMM
UPDATED MODEL NAME, OPT, EXT, COVID, PORCH

tri pointe

THIS LEVEL HAS BEEN DESIGNED FOR 9'-1" PLATE HEIGHT

#### LEGEND

- INTERIOR BEARING WALL
- □===□ BEARING WALL ABOVE (B.W.A.)
- BEAM / HEADER
- INDICATES EXTENT OF INT.

  OSB SHEARWALL AND/OR
  3" O.C. EDGE NAILING
- EXTENT OF VALLEY TRUSS OVERFRAMING
  221 0C. (MAX.)
- EXTENT OF FLOOR SYSTEM TO BE DESIGNED FOR TILE
- ► INDICATES HOLDOWN
- JL METAL HANGE
- | INDICATES POST ABOVE. PROVIDE SOLID BLOCKING UNDER POST OR JAMB ABOVE.

REFER TO SO.O FOR
TYPICAL STRUCTURAL NOTES

\$ SCHEDULES

ROOF FRAMING PLAN 5921-09 MODEL

SERENITY
MASTER SET
RALEIGH, NC


S2.0


ROOF FRAMING PLAN

SCALE: 1/4"=1'-0" (22x24 SHEET)

1/8"=1'-0" (1|x|7 SHEET)

ELEV. A

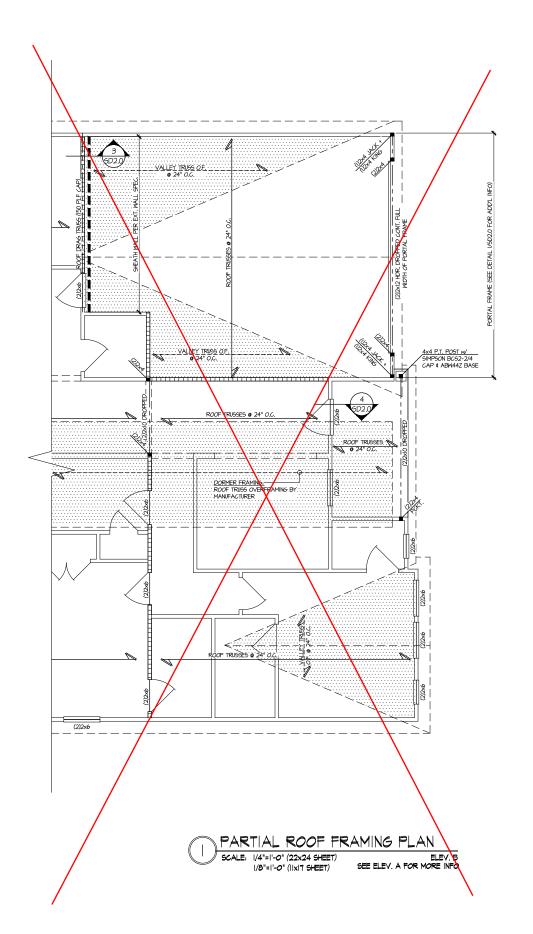

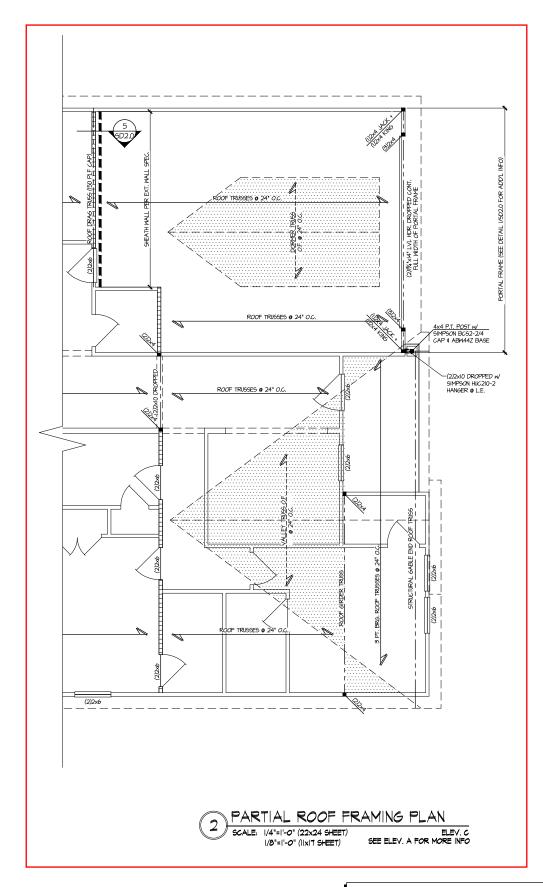

THIS LEVEL HAS BEEN DESIGNED FOR 9'-I" PLATE HEIGHT

REFER TO SO.O FOR TYPICAL STRUCTURAL NOTES # SCHEDULES

MULHERN+KULP

BESIDENTIAL STRUCTURAL ENSINEERING
3865 Braiside Parkway, Sala 256 - Aphrenia, SA 2862

p.776-777-9074 - multiperiodescen

N. Licence # C-2825

Mulhern+Kulp project number:

243-24035

SMK KΜ\ issue date: 08-16-2024

REVISIONS:

II/08/2024 SMM UPDATED MODEL NAME, OPT. EXT. COVID. PORCH

tri pointe

ROOF FRAMING PLAN

## LEGEND

- INTERIOR BEARING WALL
- □===□ BEARING WALL ABOVE (B.W.A.)
- BEAM / HEADER
- INDICATES EXTENT OF INT.


  OSB SHEARWALL AND/OR
  3" O.C. EDGE NAILING
- EXTENT OF VALLEY TRUSS OVERFRAMING

  2 24" O.C. (MAX.)
- EXTENT OF FLOOR SYSTEM TO BE DESIGNED FOR TILE
- INDICATES HOLDOWN

- | INDICATES POST ABOVE. PROVIDE SOLID BLOCKING UNDER POST OR JAMB ABOVE.

5921-09 MODEI SERENITY MASTER SET RALEIGH, NC

**S2.1** 

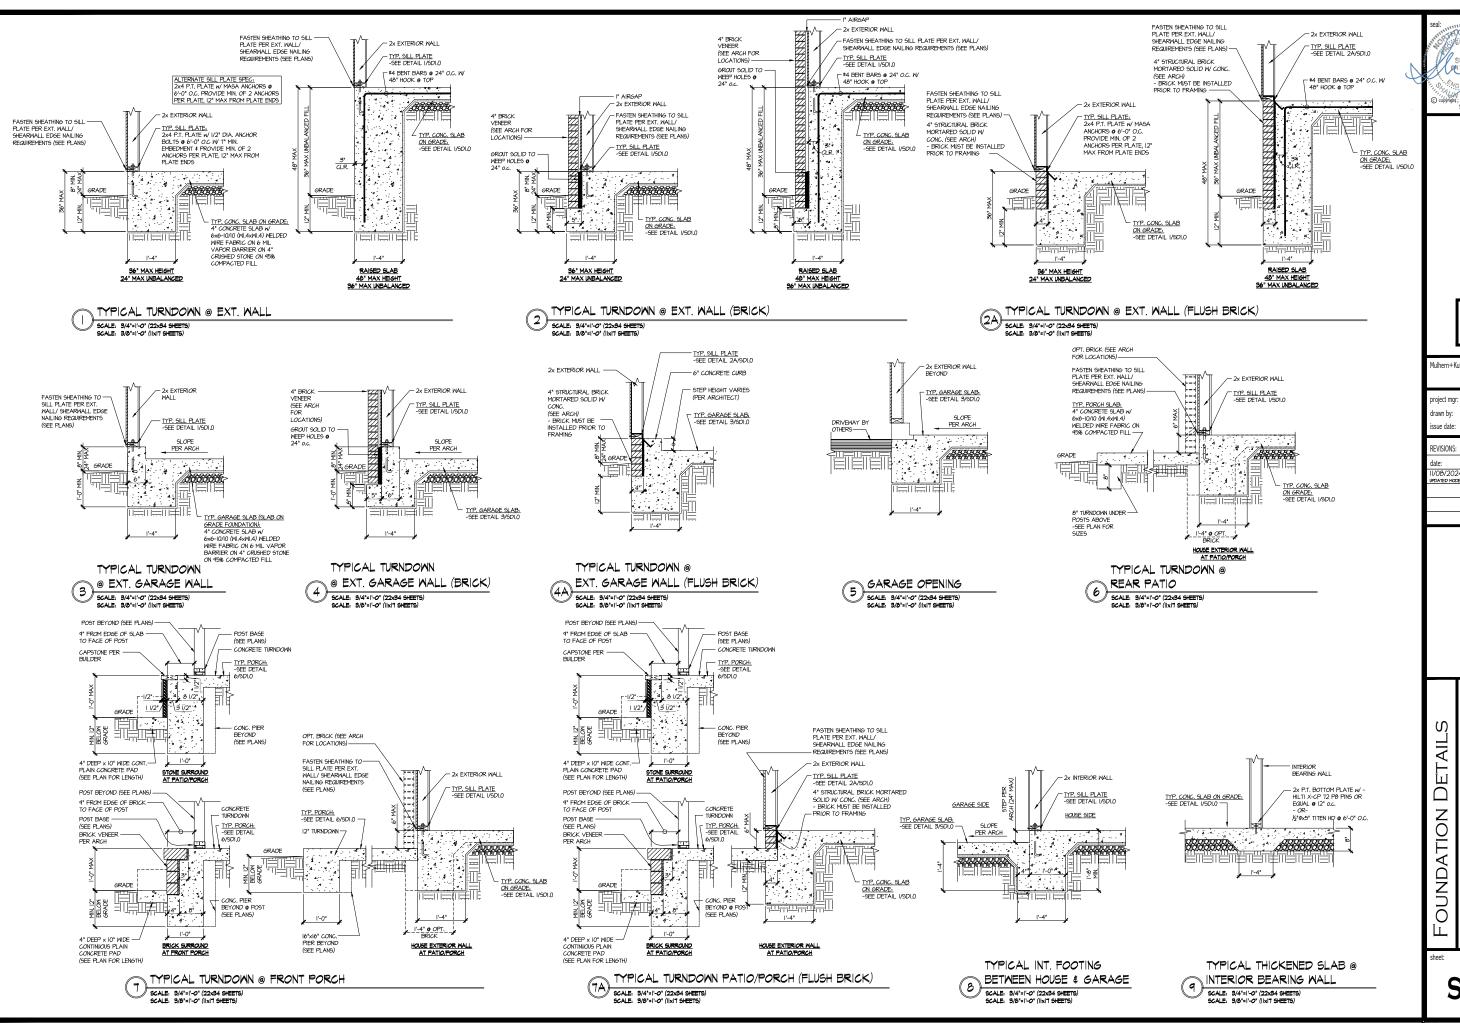

MULHERN+KULP
RESIDENTIAL STRUCTURAL ENGINEERING

Mulhern+Kulp project number 243-2403

SMK ΚM issue date: 08-16-2024


initial: II/08/2024 SMM UPDATED MODEL NAME, OPT. EXT. COVID. PORCH


pointe.

60 5921-


MASTER SET RALEIGH, NC SERENITY

**SD1.0** 

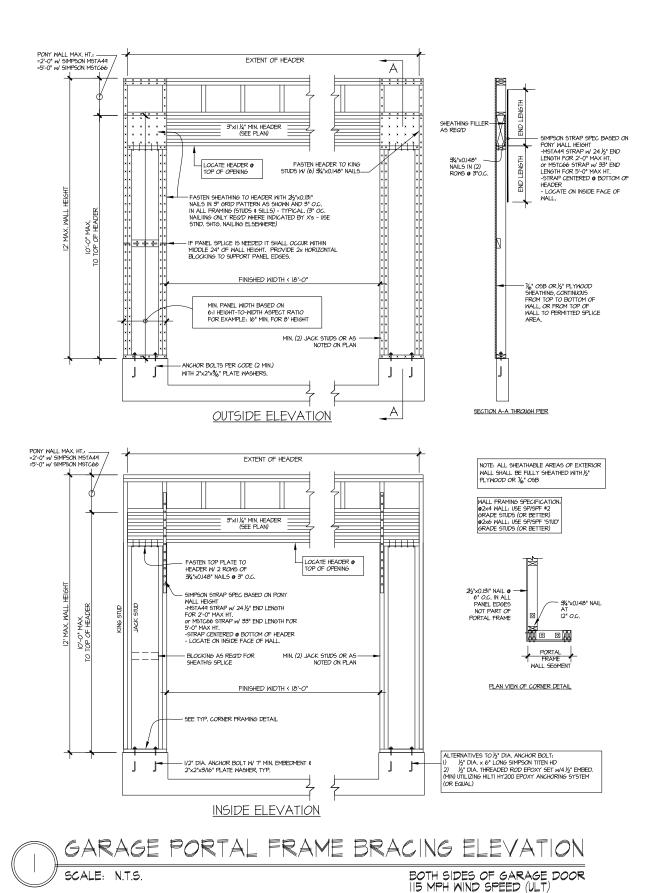


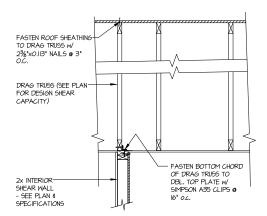


## INTERIOR DRAG TRUSS DETAIL

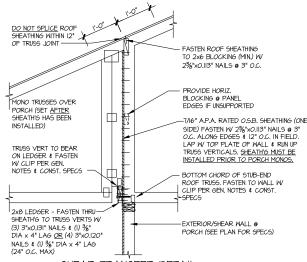


## SHEAR TRANSFER DETAIL @ BREAK IN TRUSSES OVER SHEAR WALL

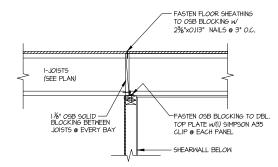

SHEAR TRANSFER DETAIL @ INTERIOR SHEARWALL BELOW

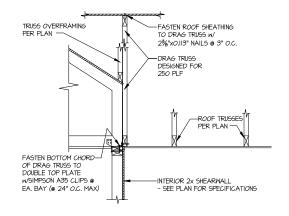

## SHEAR TRANSFER DETAIL AT INTERIOR SHEARWALL BELOW

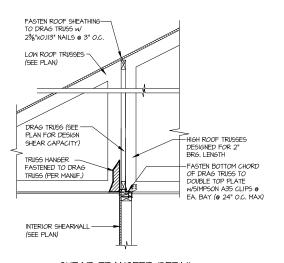

SHEAR TRANSFER DETAIL

AT INTERIOR SHEARWALL BELOW

SCALE. 3/4"=1"-0"



MULHERN+KULP
RESIDENTIAL STRUCTURAL ENGINEERING 3000 Breakside Parkway, Suite 256 • Al p 778-777-8674 • mulhemkulp.com NC License # C-3025

Mulhern+Kulp project number 243-2403

SMK frawn by: KΜ\ issue date: 08-16-2024

REVISIONS:


initial: II/08/2024 SMM UPDATED MODEL NAME, OPT. EXT. COVD. PORCH


pointe HOMES

Ŋ DETAIL MODE FRAMING

SERENITY MASTER SET RALEIGH, NC 5921-09

**SD2.0** 

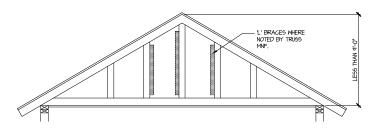

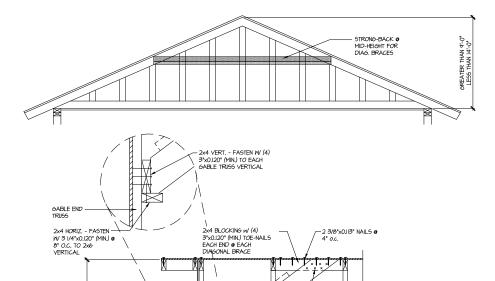


(4) 3"x0.120" (MIN.) TOENAIL5

2x6 DIAG. BRACE (w/ 2x4
T-BRACE IF LENGTH EXCEEDS 6'),
SPACED • 4'-0' O.C. MAX. FASTEN
2x4 TO 2x6 w/ 3'×0.020" (MIX.)
NAILS • 8' O.C.

ESTRONG-BACK @ MID-HEIGHT (MIN, 4'-6")

GABLE END TRUSS SHEATHED WITH OSB.

FASTEN BOTTOM CHORD OF — GABLE END TRUSS TO DBL. TOP PLATE w/ 3"X0.120" (MIN.) TOE-NAILS @ 8" O.C.

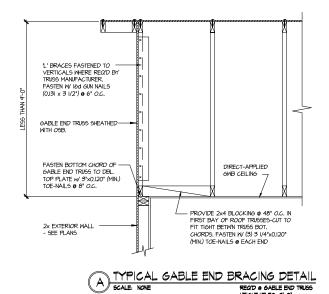

BRACE GABLE END TRUSSES PER ABOVE DETAIL WHEN GABLE HEIGHT IS LESS THAN 9-0". "L" BRACES REQUIRED WHERE NOTED BY TRUSS MANUFACTURER.

REQ'D & GABLE END TRUSS HEIGHT UP TO 9'-0"



- PROVIDE 2x4 BLOCKING @ 48" O.C. IN FIRST BAY OF ROOF TRUSSES-CUT TO FIT TICHIT DETINN TRUSS BOT. CHORDS, FASTEN W (4) 3"x0,120" (MIN.) TOE-NAILS @ EACH END

- (8) 3'x0,120" (MIN.) NAILS

BRACE GABLE END TRUGGES PER ABOVE DETAIL WHEN GABLE HEIGHT EXCEEDS 9'-0'. "L' BRACES NOT REQUIRED.

MULHERN+KULP
RESIDENTIAL STRUCTURAL ENGINEERING
3665 Braickide Parkway, Sala 256 - Apharata, GA 36622
p.776-777-6074 - multimakepiscom
NC Licence # C-36.25



Mulhern+Kulp project number:

243-24035

SMK KΜ\ drawn by: issue date: 08-16-2024

REVISIONS:

initial: II/08/2024 SMM UPDATED MODEL NAME, OPT. EXT. COVID. PORCH

tri pointe

FRAMING DETAILS

5921-09 MODEL

**SD2.1** 

SERENITY MASTER SET RALEIGH, NC