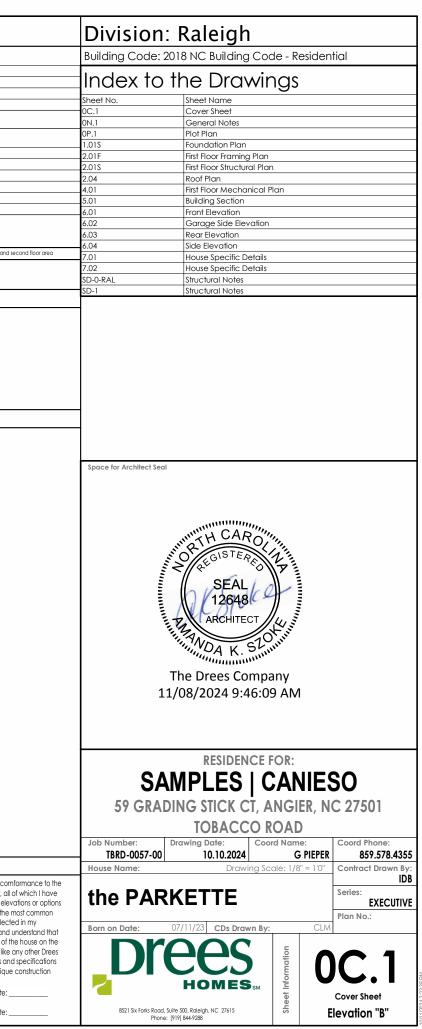
				Square Footage         Living Areas         1st Floor       2351 SF         2nd Floor       724 SF         3076 SF         Unfinished Areas         2nd Floor Storage       76 SF         Covered Entry       142 SF         Garage       843 SF         Rear Covered Porch       165 SF         1226 SF       1226 SF         Square Footage total may vary by +1 SF due to automated rounding of first and st         Redraws         Plan Review: XX/XX/XX         Xoox         Plan Review: XX/XX/XX         Xoox       Xoox
Architecture Plan Review: X No Com	ments	traven on any drawings and not written in the contract selctions <u>WILL NOT</u> be included in the	he site specific drawings.	Customer Plan Review Sianature
Architecture Plan Review: No Com Customer Request:	ments See Comments Items of Design Solution:		he site specific drawings.	Customer Plan Review Signature I understand that my new Drees home will be built in general com
Customer Request:	Design Solution:	travm on any drawings and not written in the contract selctions <u>WILL NOT</u> be included in the Reason For Modification:	Comments:	I understand that my new Drees home will be built in general com
		trawn on any drawings and not written in the contract selctions <u>WILL NOT</u> be included in th		I understand that my new Drees home will be built in general com plans, specifications, selections and the Purchase Agreement, all reviewed and approved. This set of plans may not reflect the elev for my house. Drees drows the standard plans compolete with the
Customer Request:	Design Solution:	trawn on any drawings and not written in the contract selctions <u>WILL NOT</u> be included in the Reason For Modification:	Comments: 1. XXX	I understand that my new Drees home will be built in general com plans, specifications, selections and the Purchase Agreement, all reviewed and approved. This set of plans may not reflect the elev for my house. Drees draws the standard plans complete with the r options. The subcontractor's sets will show only the options I select
Customer Request:	Design Solution:	travm on any drawings and not written in the contract selctions <u>WILL NOT</u> be included in the Reason For Modification:	Comments:	I understand that my new Drees home will be built in general com plans, specifications, selections and the Purchase Agreement, all reviewed and approved. This set of plans may not reflect the elev for my house. Drees draws the standard plans complete with the r options. The subcontractor's sets will show only the options I select selection sheets. I have reviewed the plot plan for my house and there may be some field adjustments as to the exact location of th
2. XXX	Design Solution: 1. XXX 2. XXX	trawn on any drawings and not written in the contract selctions <u>WILL NOT</u> be included in the Reason For Modification:	Comments: 1. XXX 2. XXX	I understand that my new Drees home will be built in general com plans, specifications, selections and the Purchase Agreement, all reviewed and approved. This set of plans may not reflect the elev for my house. Drees drows the standard plans complete with the r options. The subcontractor's sets will show only the options I select selection sheets. I have reviewed the plot plan for my house and there may be some field adjustments as to the exact location of th lot. I further understand that my home will not be built exactly like v
Customer Request:	Design Solution:	trawn on any drawings and not written in the contract selctions <u>WILL NOT</u> be included in the Reason For Modification:	Comments: 1. XXX	I understand that my new Drees home will be built in general com plans, specifications, selections and the Purchase Agreement, all reviewed and approved. This set of plans may not reflect the elev for my house. Drees draws the standard plans complete with the r options. The subcontractor's sets will show only the options I select selection sheets. I have reviewed the plot plan for my house and u there may be some field adjustments as to the exact location of th lot. I further understand that my home will not be built exactly like thome or Model and that some minor variations from my plans area
Customer Request: 1. XXX 2. XXX	Design Solution: 1. XXX 2. XXX	trawn on any drawings and not written in the contract selctions <u>WILL NOT</u> be included in the Reason For Modification:	Comments: 1. XXX 2. XXX	I understand that my new Drees home will be built in general com plans, specifications, selections and the Purchase Agreement, all reviewed and approved. This set of plans may not reflect the elev for my house. Drees draws the standard plans complete with the r options. The subcontractor's sets will show only the options I select selection sheets. I have reviewed the plot plan for my house and there may be some field adjustments as to the exact location of th lot. I further understand that my home will not be built exactly like home or Model and that some minor variations from my plans and may occur since every home that is built has it's own set of unique problems that must be dealt with as the home is being built.
Customer Request: 1. XXX 2. XXX 3. XXX	Design Solution: 1. XXX 2. XXX 3. XXX	trown on any drawings and not written in the contract selctions <u>WILL NOT</u> be included in the Reason For Modification:	Comments: 1. XXX 2. XXX 3. XXX	I understand that my new Drees home will be built in general com plans, specifications, selections and the Purchase Agreement, all reviewed and approved. This set of plans may not reflect the elev for my house. Drees draws the standard plans complete with the r options. The subcontractor's sets will show only the options I select selection sheets. I have reviewed the plot plan for my house and there may be some field adjustments as to the exact location of th lot. I further understand that my home will not be built exactly like home or Model and that some minor variations from my plans and may occur since every home that is built has it's own set of unique problems that must be dealt with as the home is being built.
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### **GENERAL NOTES - RALEIGH**

### FOUNDATION NOTES

#### CRAWL SPACES:

- SLOPE CONCRETE SLAB 4" MINIMUM TOWARDS GARAGE DOOR
- EXTERIOR FLATWORK/GARAGES SHALL HAVE A MINIMUM CONCRETE SRENGTH OF 4,500 PSI
- FOOTINGS TO A MINIMUM CONCRETE STRENGTH OF 2500 PSI, UNLESS OTHERWISE NOTED
- ASSUMED ALLOWABLE SOIL BEARING PRESSURE: 2,000 p.s.f.
- WATERPROOF FOUNDATION WITH BITUMINOUS SPRAY.
- WALL TIES EMBEDDED IN THE HORIZONTAL MORTAR JOINT SHALL BE 16" ON CENTER. TIES IN ALTERNATE COURSES SHALL
- BE STAGGERED. THE MAXIMUM VERTICAL DISTANCE BETWEEN TIES SHALL NOT EXCEED 16" AND THE MAXIMUM
- HORIZONTAL DISTANCE SHALL NOT EXCEED 16" ADDITIONAL TIES SHALL BE PROVIDED AT ALL OPENINGS, AND WITHIN 12"
- OF THE OPENING.
- CORE FILL ENTIRE BLOCK WALL WHEN THE WALL IS 4'-0" TALL OR HIGHER. INSTALL #4 REBAR IN EACH HOLLOW AREA OF EACH BLOCK FROM FOOTING TO TOP OF WALL, ON THE ENTIRE WALL PRIOR TO CORE FILLING IT.
- TOP COURSE OF BLOCK ON ALL WALLS WILL BE FILLED SOLID WITH MORTAR PLACING THE FOUNDATION STRAPS OR
- BOLTS IN THE MORTAR 6'-0" ON CENTER, AND 12" FROM EACH CORNER.
- 12"x16" PIERS: HOLLOW MASONRY UP TO 48" HIGH, SOLID MASONRY UP TO 9'0" HIGH
- 16"x16" PIERS: HOLLOW MASONRY UP TO 64" HIGH, SOLID MASONRY UP TO 12'0" HIGH
- BLOCK PIERS SHOULD BE PLACED DIRECTLY ON CONCRETE FOOTINGS PER PLAN. THEY SHOULD BE PLUMBED AND SQUARE WITHIN 1/4"
- SILL PLATES TO BE A MINIMUM OF 2x4 NOMINAL LUMBER.

#### FRAMING NOTES

					_
DESIGN LOADS: FLOORS: 40 psf LIVE LOAD + 10 psf DEAD LO/	ND = 50  pcf		OOR: 50 psf LIVE LOAD	SEISMIC: "A" & "B"	
ROOF: 18 psf LIVE LOAD + 10 psi DEAD LOA		WIND SPEED:		JEIJ/MIC. A & B	
DESIGN DEFLECTION LIMITS (BASED ON LIVE LOAD, EXC			120 MITT		
RAFTERS GREATER THAN 3:12	L/180	CEILINGS	L/240		
MASONRY VENEER	L/600	OLILIIVOO	L/ 2 10		
NOMINAL LUMBER FLOORS:	L/360				
MANUFACTURED WOOD FLOORS:	1	MINIMUM PRO RA	ATING OF 35 (OR EQUIVAL	ENT).	
			RENCE BETWEEN ADJACEN		
			AND NO GREATER TH		
	L/600 FOR SPA	ANS OVER 16'-0" II	SIMPLE SPAN AND	NO GREATER THAN 1/2" DEFLECTION	
	L/840 FOR SPA	NS OVER 16'-0" I	CONTINUOUS SPAN. A	ND NO GREATER THAN 1/2" DEFLECTION	N
-JOIST SPACING: 19.2" o.c. MAXIMUM SPACING					-
DOUBLE EVERY OTHER FLOOR JO					
INSTALL UNCOUPLING MEMBRA					_
GLUE AND MECHANICALLY FAS					- /
- MANUFACTURED WOOD PRODUCTS (INCLUDING, BUT				Shall be fabricated,	- H
HANDLED, AND INSTALLED IN ACCORDANCE WITH TH					- /
-JOISTS ARE NOT TO BE PLACED DIRECTLY OVER INTERIO					- (
- ALL WOOD BEAMS/HEADERS: 2x6's TO BE SPF STUD GR					SE
- ALL HEADERS SHALL BE SUPPORTED BY (1) 2x JACK STU					- (
NUMBER OF JACKS REQUIRED, U.N.O. AT FLUSH OR DRC	DPPED BEAMS, II	HE NUMBER OF 31	UDS SPECIFIED INDICATES	THE TOTAL NUMBER OF STUDS REQUIRED	- ( - F
TO SUPPORT THE BEAM. - EXTERIOR WALLS TO BE 2x4 SPF STUD GRADE AT 16" 0.0					
- ALL INTERIOR BEARING WALLS AND WALLS AT BASEME					PL   - /
ALL OTHER NON-BEARING INTERIOR WALLS TO BE 2x4				O DE 224 311 310D ORADE @ 10 0.C.,	- /
- ALL WALLS TO BE 3 1/2" UNLESS OTHERWISE NOTED.	511 510D OKADI	1 6 24 0.0. 0.0.	•.		IN
- PROVIDE SOLID BEARING TO FOUNDATION OR BEAM I	BELOW FOR ALL	BEAMS, HEADERS	& GIRDER TRUSSES, PROV	IDE BLOCKING BETWEEN JOISTS	EX
AS REQUIRED.					12
- SEE SELECTION SHEET FOR SIZE AND STYLE OF FIREPLAC	CE. SEE FIREPLAC	CE ELEVATION DE	TAIL FOR ADDITIONAL FRA	MING REQUIREMENTS, IF ANY.	FL
- CHECK SELECTION SHEETS FOR FLOOR COVERING AT	top and botto	M OF STAIR RISER	S AND ADJUST RISERS AS F	REQ'D.	FL
- PROVIDE BLOCKING AT ALL HANDRAIL TERMINATION		dcations.			0
- 20-MINUTE FIRE RATED DOOR BETWEEN GARAGE AND					(S
- EXTERIOR WALL TO BE 2x4 SPF STUD G AT 16" o.c. UNLE					(*
- ALL EXTERIOR WALLS AND INTERIOR BEARING WALLS,					E
FULL HEIGHT STUDS TO THE HIGHEST CEILING (I.E. NO I		., .			
- IN THE GARAGE, PROVIDE 1/2" GYP. BOARD AT ALL W					- 1
FLOOR/CEILING ASSEMBLY. GARAGE CEILING TO BE		ani GYP. Board	WHEN THERE ARE NO HAD	STABLE SPACES ABOVE, OR 5/8"	- l
TYPE X GYP. BOARD WHEN HABITABLE SPACES ARE A - ALL EMERGENCY ESCAPE & RESCUE OPENINGS TO BE					- (
OF 24" IN HEIGHT, 20" IN WIDTH, & HAVE A MINIMUM (			HED FLOOR AND HAVE MI	NIMUM OF EINING DIMENSIONS	- F
ALL DOORS TO BE 6'-8" TALL UNLESS OTHERWISE NOTED.	JI LINING AKLA	01 5.7 5.1.			- F
- ALL GLASS IN INTERIOR AND EXTERIOR DOORS TO BE T					- F
- ALL LUMBER CONTACTING CONCRETE TO BE PRESSUR					- E   H/
- ALL FASTENERS, HANGERS, AND OTHER CONNECTORS		H PRESSURE TREA	TED WOOD ARE TO HAVE	7MAX COATING (OR	
EQUIVALENT) HOT-DIPPED GALVANIZED OR STAINLESS					
- AT STAIR HANDRAIL, ON ONE SIDE ONLY, SHALL BE CON		E ENTIRE LENGTH	OF THE STAIRWAY, AND END	DS SHALL BE RETURNED TO A WALL	R
OR POST. THE HANDRAIL MAY BE INTERRUPTED AT A NEW					
- ALL HANDRAIL GRIP PORTIONS SHALL NOT EXCEED 2-1/-					- /
- HANDRAILS SHALL BE INSTALLED ON ALL STAIRS WITH 4 C				34" AND A MAXIMUM OF 38".	- F
- ALL STAIRS TO BE CONSTRUCTED SO AS NOT TO ALLOW					- F
- GUARDRAILS MUST BE A MINIMUM OF 36" HIGH. GUARE				34" HIGH MEASURED VERTICALLY	
FROM THE NOSING AT THE TREADS. THE HORIZONTAL SPA		RIICAL BALUSTERS	SHALL BE 4" O.C.		
- GUARDRAIL DESIGN TO RESIST A MINIMUM OF 200 LBS L	AIERAL FORCE				

#### BASEMENTS:

- SLOPE CONCRETE SLAB 4" MINIMUM TOWARDS GARAGE DOOR - EXTERIOR FLATWORK/GARAGES SHALL HAVE A MINIMUM CONCRETE SRENGTH OF 4 500 PSI

- FOOTINGS TO A MINIMUM CONCRETE STRENGTH OF 2500 PSI, UNLESS OTHERWISE NOTED- ALL FOUNDATION WALLS TO BE CAST IN PLACE CONCRETE 3000 PSI MIN. UNLESS OTHERWISE NOTED.

- BASEMENT WINDOW LOCATIONS MAY VARY FROM DRAWING DUE TO LOT CONDITIONS.

- BACKFILL ADJACENT TO FOUNDATION WALLS SHALL NOT BE PLACED UNTIL THE WALL HAS SUFFICIENT STRENGTH AND HAS BEEN ANCHORED TO THE FLOOR OR HAS BEEN SUFFICIENTLY BRACED TO PREVENT DAMAGE BY THE BACKFILL.

- ASSUMED ALLOWABLE SOIL BEARING PRESSURE: 2,000 p.s.f.
- WATERPROOF FOUNDATION WITH BITUMINOUS SPRAY.
- VERTICAL CONTROL JOINTS IN BASEMENT FOUNDATION WALLS STANDARD LOCATION GUIDELINES:
- 1) PLACE A CONTROL JOINT IN ALL UNBRACED WALLS OVER 30' IN LENGTH. (NOTE: "T" WALLS AND CORNERS COUNT AS A BRACE)
- 2) WINDOWS THAT ARE LARGER THAN THE STANDARD BASEMENT WINDOW REQUIRE A CONTROL JOINT.

3) CONTROL JOINTS ARE NOT REQUIRED AT EVERY WINDOW THAT IS STANDARD SIZE.

4) IF THERE IS A STANDARD WINDOW LOCATED IN A WALL SEGMENT THAT REQUIRES A CONTROL JOINT, THEN THE CONTROL JOINT SHOULD BE PLACED ON THE SIDE OF THE WINDOW THAT IS ADJACENT TO THE LONG SIDE OF THE WALL. IF THERE IS MORE THAN ONE WINDOW IN A WALL THEN ONLY ONE WINDOW SHOULD HAVE A CONTROL JOINT.

5) DOORS DO NOT GET CONTROL JOINTS.

- 6) CONTROL JOINTS SHOULD NOT BE LOCATED WITHIN 3' OF A BEAM POCKET.
- 7) CONTROL JOINTS ARE REQUIRED AT THE FIRST AND LAST STEP DOWN AT STEPPED BASEMENT FOUNDATION WALLS.

- INTERIOR FLATWORK SHALL HAVE A MINIMUM CONCRETE STRENGTH OF 3,000

PSI. - ALL VERTICAL STEEL AND ALL STEEL IN STRUCTURAL SLABS TO BE GRADE 60. ALL HORIZONTAL STEEL IN FOUNDATION WALLS AND FOOTERS TO BE GRADE 40 STEEL.

### ECHANICAL/ELECTRICAL NOTES

NY GAS APPLIANCES MUST BE INSTALLED PER MANUFACTURER'S SPECIFICATIONS. OLD THE CENTERLINE OF ALL EXTERIOR LIGHT FIXTURES AT 5'-8" OFF BOTTOM OF DOOR OPENING. LL KITCHEN CABINET DIMENSIONS ARE CABINET TO CABINET. ABINET STYLES MAY VARY FROM INTERIOR ELEVATIONS DEPENDING ON STYLE, MANUFACTURER, ETC, FOR CABINET DETAILS

SHOP DRAWINGS. ABINET SIZES MAY VARY WITH FULL-OVERLAY CABINETS.

ROUND FAULT INTERRUPTER (GFCI) OUTLETS TO BE INSTALLED PER NEC 2017, SECT. 210.8

ROVIDE HOSE BIBS PER DIVISION SPEC. SHEET. EXACT LOCATION TO BE FIELD DETERMINED UNLESS OTHERWISE NOTED ON THE

IN. 50 C.F.M. FOR ALL EXHAUST FANS IN BATHROOMS

EXTERIOR STUD WALL CAVITY:	(2x4)	R-15
(2x6) R-19		
FLOOR JOIST CAVITY AT STANDARD PERI	METER: R-19	
FLOOR JOIST CAVITY AT CANTILEVER:		R-19
OVER GARAGE: (OVER HORIZONT	al space)	R-38 BLOWN
(SLOPED AND VERTICAL SPACE) R-	38 BATT	

#### EVATION NOTES

INDOW STYLE AND MULLIONS MAY VARY FROM ELEVATION DEPENDING UPON MANUFACTURER, STYLE, PATTERN, TYPE, ETC. E SECONDARY HEAT BARRIER ON ALL DIRECT VENT FIREPLACES 7' OR LESS ABOVE A WALKWAY. RADE AWAY FROM FOUNDATION WALLS SHALL FALL A MINIMUM OF 6" WITHIN THE FIRST 10'. ROVIDE TYVEK OR EQUIVALENT HOUSE WRAP BEHIND BRICK AND STONE VENEER OVER WOOD SHEATHING. OVIDE BRICK WEEP HOLES AT 24" O.C. WITH BRICK VENEER AND MORTER NET BEHIND AND THROUGH WEEP HOLES. OVIDE FLASHING AND WEEP HOLES ABOVE ALL BRICK ANGLE IRONS, BELOW ALL BRICK SILLS AND ABOVE SILL PLATE SEALERS. (TERIOR STEPS TO HAVE A MAXIMUM 8" RISER. WHEN VERTICAL RISE EXCEEDS 30" OR FOUR OR MORE CONTINUOUS RISERS, A NDRAIL IS REQUIRED

#### DOF PLAN NOTES


LL OVERHANGS TO HAVE (2) SOFFIT VENTS PER EACH 8' SOFFIT SECTION. ROVIDE BAFFLES AT EXTERIOR TRUSS BEARING FOR VENTILATION. OVIDE 15# FELT PAPER UNDER SHINGLES.


#### SLAB ON GRADE:

- ALL CONCRETE SLABS ON GRADE SHALL BE THE THICKNESS AS INDICATED ON THE DETAILS OVER MINIMUM 6 MIL. POLYETHYLENE (VISQUEEN) VAPOR BARRIER. SLABS SHALL BE REINFORCED WITH 6x6 W1 4 WWE LAPPED 8" AT EDGES AND ENDS IN CONFORMANCE WITH ASTM-A 185. OR FIBERMESS REINFORCEMENT SHALL BE USED WITH A MINIMUM FIBER LENGTH OF 1 TO 2 1 COMPLYING WITH ASTM C 1116. THE DOSAGE AMOUNT SHALL BE 0.75 TO 3.0 POUNDS PER CUBIC YARD IN ACCORDANCE WITH MANUFA TURER'S RECOMMENDATIONS.

- SLABS ON GRADE SHALL BEAR ON STRUCTURAL FILL WHICH SHALL BE CLEAN SAND FREE OF DEBRIS AND OTHER DELETERIOUS MATERIAL. STRUCTURAL FILL SHALL BE COMPACTED TO A DENSITY OF AT LEAST 95% OF THE MODIFIED PROCTOR MAXIMUMN DRY DENSITY (ASTM D1557). TERMITE PROTECTION SHALL BE PROVIDED IN ACCORDANCE WITH APPLICABLE CODE REQUIREMENTS. IF SOIL TREATMENT IS USED. THE TREATMENT SHALL BE DONE AFTER ALL EXCAVATION, BACKFILLING, AND COMPACTION IS COMPLETED. - FOOTINGS MAY BEAR UPON UNDISTURBED SOIL OR UPON STRUCTURAL FILL. STRUCTURAL FILL SHALL BE COMPACTED TO A DENSITY OF AT LEAST 95% OF THE MODIFIED PROCTOR MAXIMUMN DRY DENSITY (ASTM D1557) FOR A DEPTH OF AT LEAST TWO FEET (2'-0") BELOW THE BOTTOM OF THE FOOTING.

- THE FOLLOWING MINIMUM CONCRETE COVER SHALL BE PROVIDED FOR REINFORCEMENT: 3" CONCRETE CAST AGAINST AND PERMANENTLY EXPOSED TO EARTH
- 2" CONCRETE EXPOSED TO EARTH AND WEATHER
- 1 <sup>1</sup>/<sub>a</sub> CONCRETE NOT EXPOSED TO EARTH OR WEATHER
- SLOPÉ CONCRETE SLAB 4" MINIMUM TOWARDS GARAGE DOOR
- EXTERIOR FLATWORK/GARAGES SHALL HAVE A MINIMUM CONCRETE SRENGTH OF 4,500 PSI - ASSUMED ALLOWABLE SOIL BEARING PRESSURE: 2,000 p.s.f.
- INTERIOR FLATWORK SHALL HAVE A MINIMUM CONCRETE STRENGTH OF 3,000 PSI. - ALL STEEL IN STRUCTURAL SLABS TO BE GRADE 60. ALL HORIZONTAL STEEL IN FOUNDATION WALLS AND FOOTERS TO BE GRADE 40 STEEL

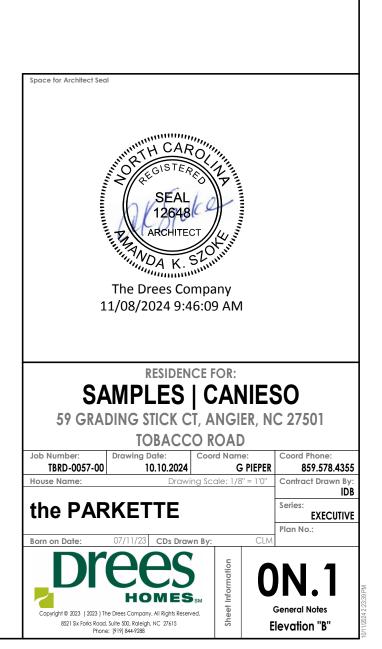

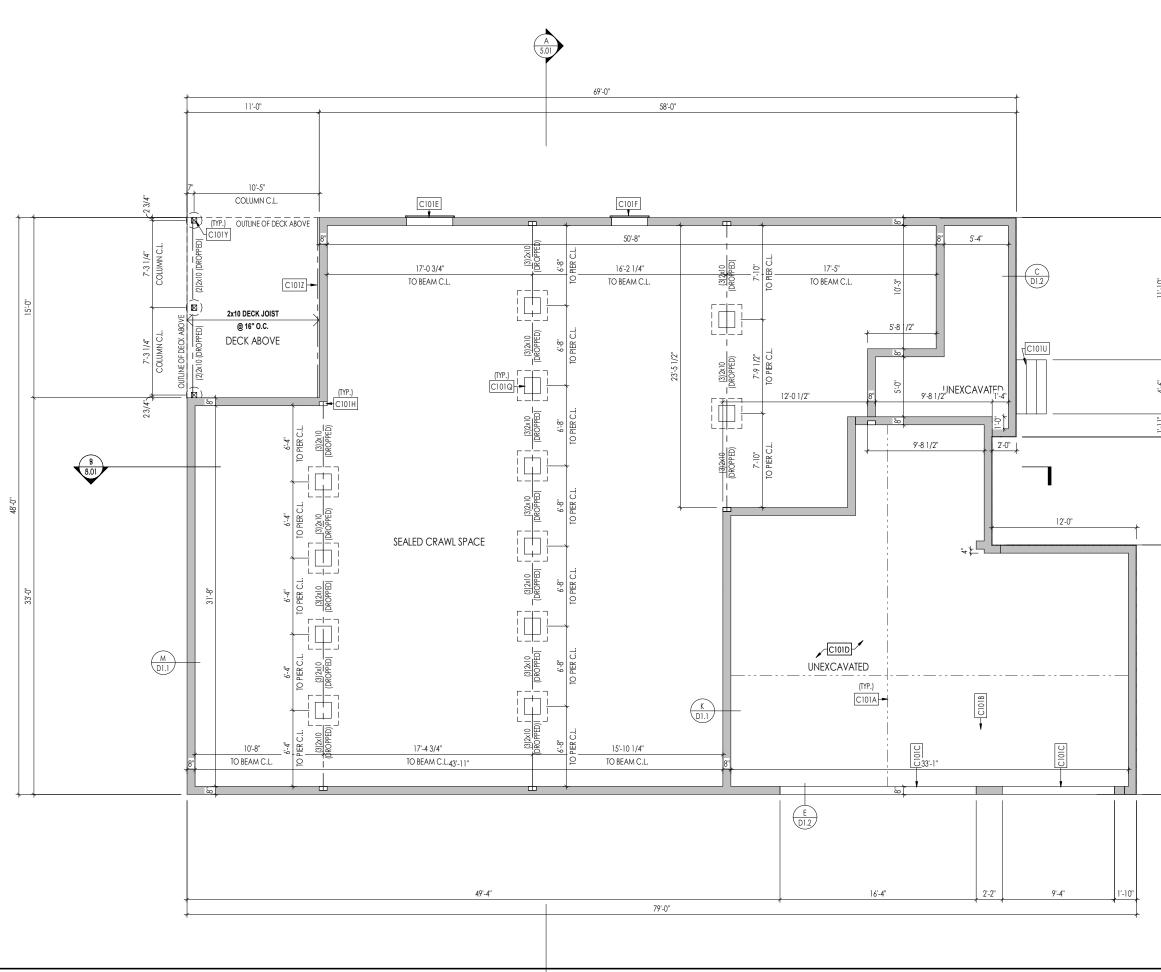



1. REFER TO SHEET 0N.1 FOR GENERAL NOTES. 2. ALL FOUNDATION WALLS TO BE 8" THICK UNLESS OTHERWISE NOTED.

### Key Notes:

1.0,	
C101A	SLAB CONTROL JOINT
C101B	GARAGE SLAB TO BE HELD A MINIMUM OF 4" BELOW TOP OF FOUNDATION AND IS TO SLOPE 1/4" PER FOOT TOWARDS GARAGE DOOR
C101C	CONTINUOUS FOOTING AND FOUNDATION; DROP TO BE FIELD DETERMINED
C101D	4" CONCRETE SLAB (3000 PSI) OVER 4" CRUSHED STONE, OVER COMPACTED OR UNDISTURBED EARTH.
C101E	46"W x 26"H HVAC ACCESS PANEL WITH DOUBLE BANDBOARD - BUILDER TO FIELD VERIFY LOCATION PER GRADE
C101F	36"W x 30"H CRAWL SPACE ACCESS PANEL WITH DOUBLE BANDBOARD - BUILDER TO FIELD VERIFY LOCATION PER GRADE
C101H	8"W x 8"H x 4"D BEAM POCKET
C101Q	16"x16" CMU PIER W/ 30"x30"x12" PLAIN CONC. FOOTING
C101U	PORCH STEPS - RISE AND RUN TO BE FIELD DETERMINED
C101Y	6x6 P.T. POST W/ SIMPSON BCS2-3/6 CAP & ABW66Z BASE ON 16" DIA. SONOTUBE FOOTING TO FROST
C101Z	2x10 P.T. LEDGER FASTENED TO RIM w/ (3)1/4"x3-1/2" LONG SIMPSON SDS SCREWS @ 16" O.C.

Space for Architect Seal



The Drees Company 11/08/2024 9:46:09 AM

### RESIDENCE FOR: SAMPLES | CANIESO 59 GRADING STICK CT, ANGIER, NC 27501

TOBACCO ROAD Coord Name Job Number: Drawina Date: Coord Phone: TBRD-0057-00 10.10.2024 859.578.4355 **G PIEPER** House Name: Drawing Scale: 1/8" = 1'0" Contract Drawn By IDB the **PARKETTE** Series: EXECUTIVE Plan No.: Born on Date: CDs Drawn Bv


Foundation Plan

Elevation "B"

HOMES


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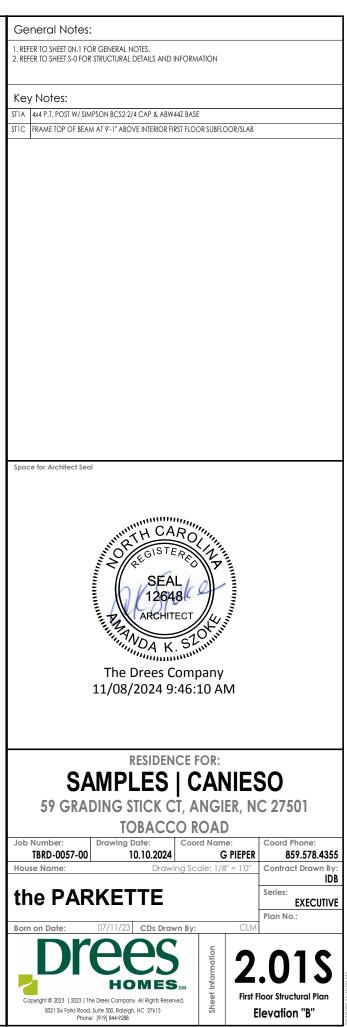
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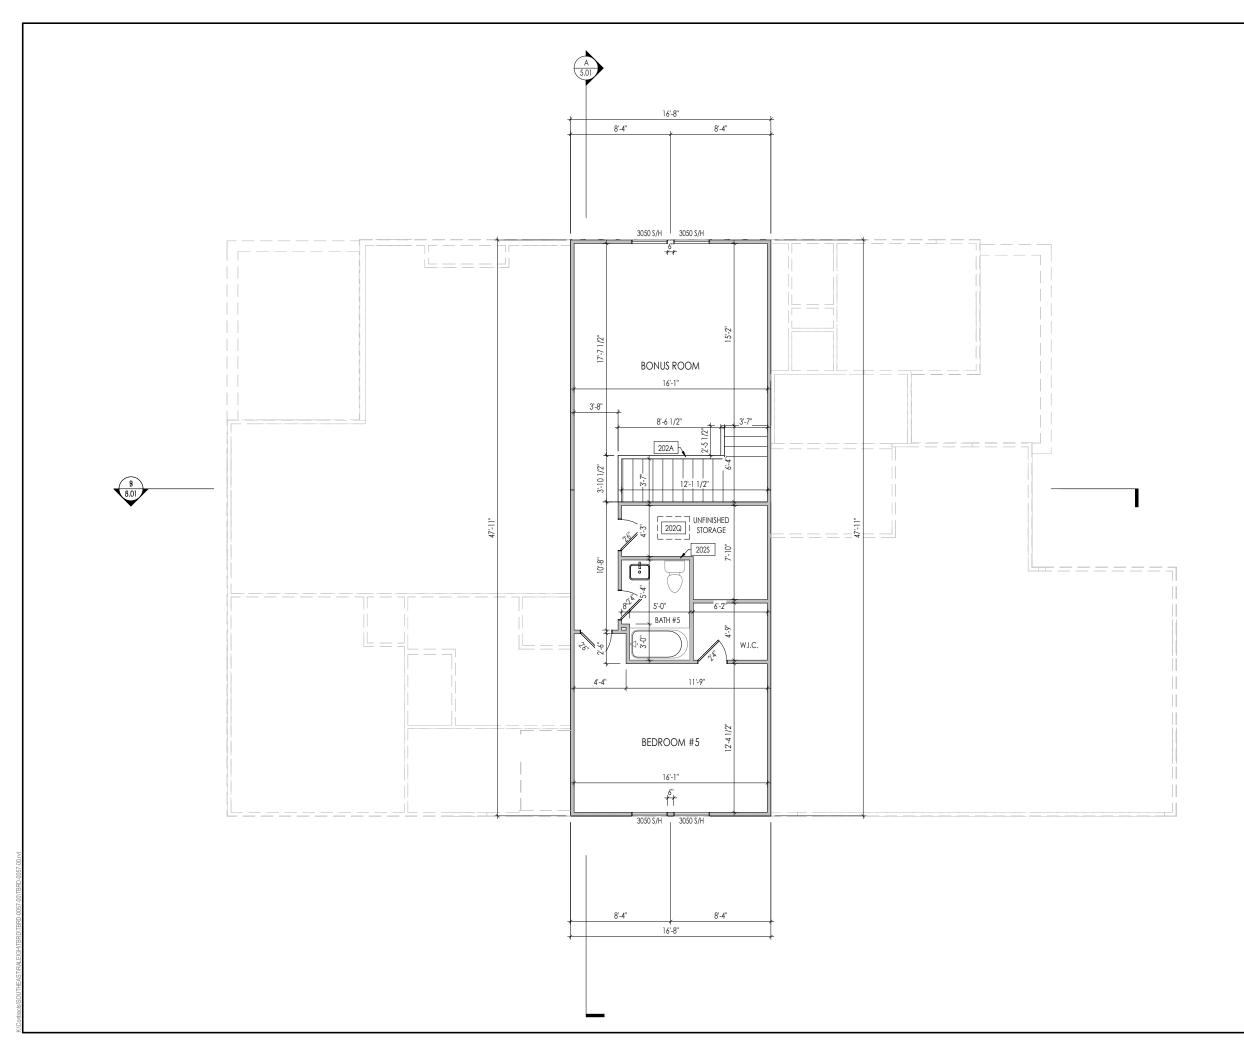



		1
		General Notes:
DRS LOO	R,	<ol> <li>REFER TO SHEET ON.1 FOR GENERAL NOTES.</li> <li>ALL FIRST FLOOR CEILINGS TO BE 10'-1" ABOVE SUBFLOOR UNLESS OTHERWISE NOTED.</li> <li>FRAME TOP OF ALL WINDOWS AT 1'-10" BELOW TOP OF PLATE UNLESS OTHERWISE NOTED.</li> <li>ALL DROPPED, INTERIOR HEADERS (FALSE AND BEARING) ARE DROPPED 1'-3" FROM CEILING.</li> <li>REFER TO SELECTION SHEETS FOR FLOORING MATERIAL PRIOR TO CONSTRUCTING STAIRS TO DETERMINE RISER HEIGHTS.</li> <li>REFER TO SHEET 2.01S FOR STRUCTURAL INFORMATION.</li> <li>REFER TO SHEET 3-0 FOR STRUCTURAL DETAILS AND INFORMATION</li> </ol>
		Key Notes:
		2018 FRAME GARAGE WALL FULL HEIGHT STUDS AT 11'-5 1/4" WITH 2x4 STUDS AT 16" O.C. FROM TOP OF FOUNDATION WALL; IF ELECTRICAL PANEL LOCATED IN GARAGE, PAD OUT WALL FOR ELECTRICAL PANEL 201E SLOPE WALL EVEN WITH TOP OF STAR STRINGER, RAILING ABOVE
		201F SEE DETAIL C/7.02 FOR STAIR FRAMING DETAILS
		201G APPROX. LOCATION OF 36" HIGH WALL UNDER STAIRS (FIELD VERIFY)
1	1	201J FRAME TOP OF OPENING AT HEIGHT SPECIFIED IN GENERAL NOTES ON THIS SHEET 201K 50° HIGH WALL
		201L FRAME TOP OF OPENING AT REFRIGERATOR AT 6'-1 1/2" A.F.F.
		201M BALLOON FRAME WALL TO UNDERSIDE OF SCISSOR TRUSS
		201N PRE-FABRICATED FIREPLACE INSERT
		201P CARPENTER TO DROP ELECTRICAL WIRE THROUGH PORCH CEILING FOR LIGHTS
		201Q 10"x10" BOX COLUMN - SEE DETAIL A/7.01 201S COLUMN - SEE DETAIL B/7.01
2		2013 PROVIDE BLOCKING FOR SHOWER DOOR/ENCLOSURE
		201Y PROVIDE 4-1/2" SHOWER CURB
		2017 22-1/2" x 32" ATTIC ACCESS
10'-4"	F	
20:8"		The Drees Company 11/08/2024 9:46:09 AM
	*	RESIDENCE FOR: SAMPLES   CANIESO 59 GRADING STICK CT, ANGIER, NC 27501 TOBACCO ROAD
		Job Number:         Drawing Date:         Coord Name:         Coord Phone:           TBRD-0057-00         10.10.2024         G PIEPER         859.578.4355           House Name:         Drawing Scale: 1/8" = 1'0"         Contract Drawn By:
		the PARKETTE
		Born on Date: 07/11/23 CDs Drawn By: CLM

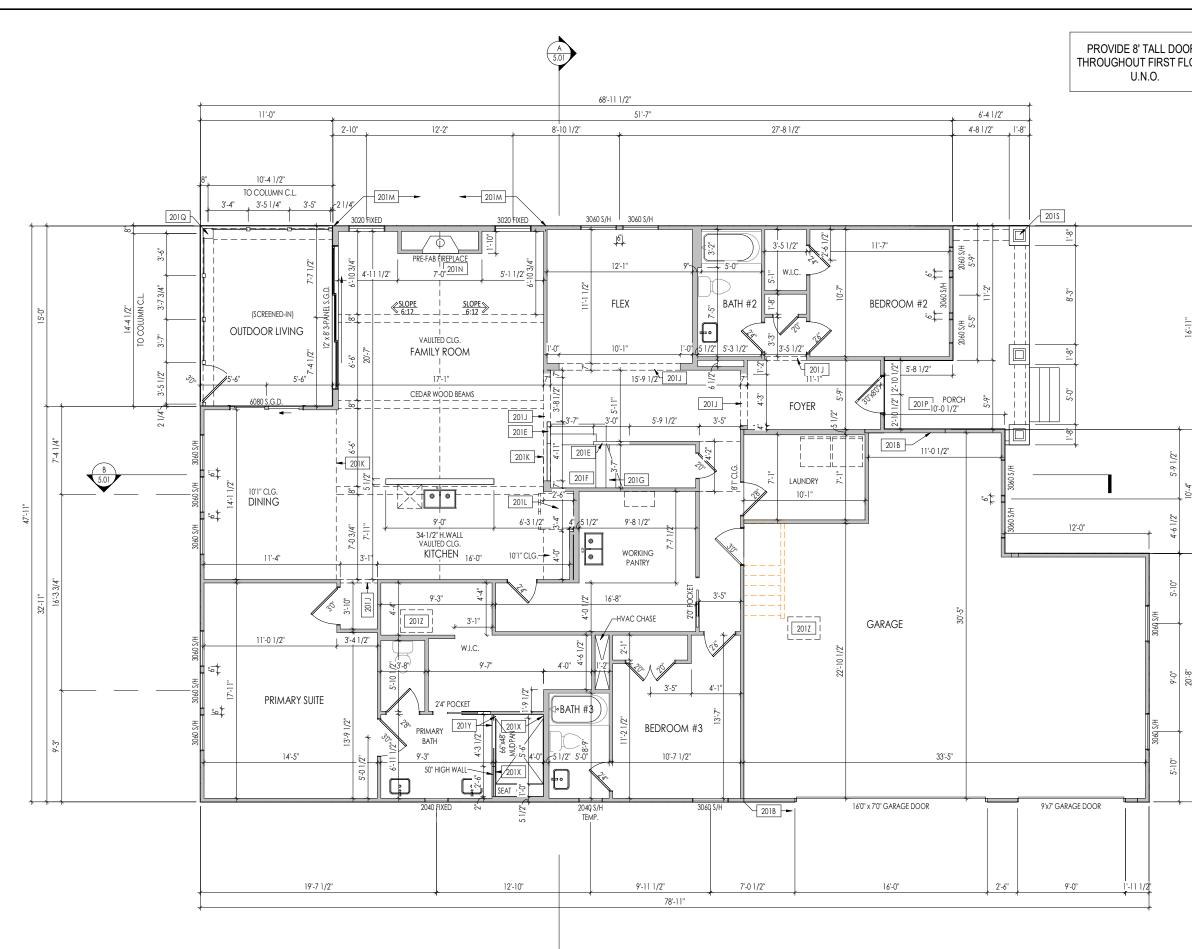
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1. REFER TO SHEET 0N.1 FOR GENERAL NOTES. 2. REFER TO SHEET S-0 FOR STRUCTURAL DETAILS AND INFORMATION

Key Notes:

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# The Drees Company 11/08/2024 9:46:10 AM
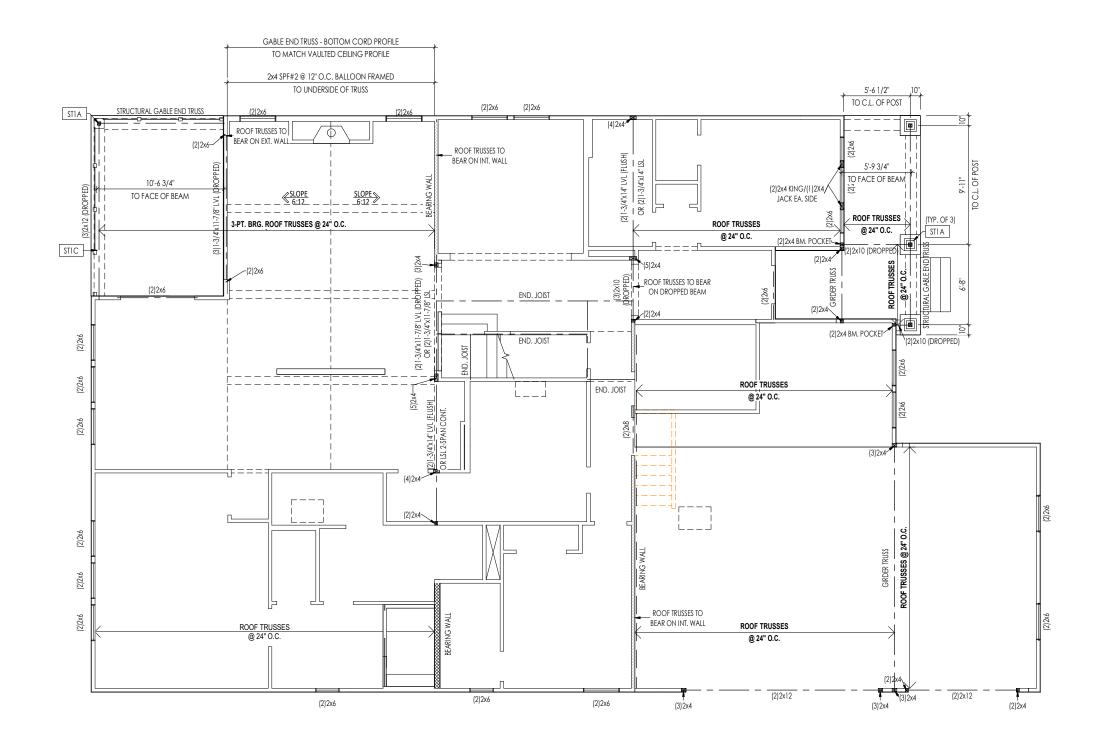
### RESIDENCE FOR: SAMPLES | CANIESO 59 GRADING STICK CT, ANGIER, NC 27501

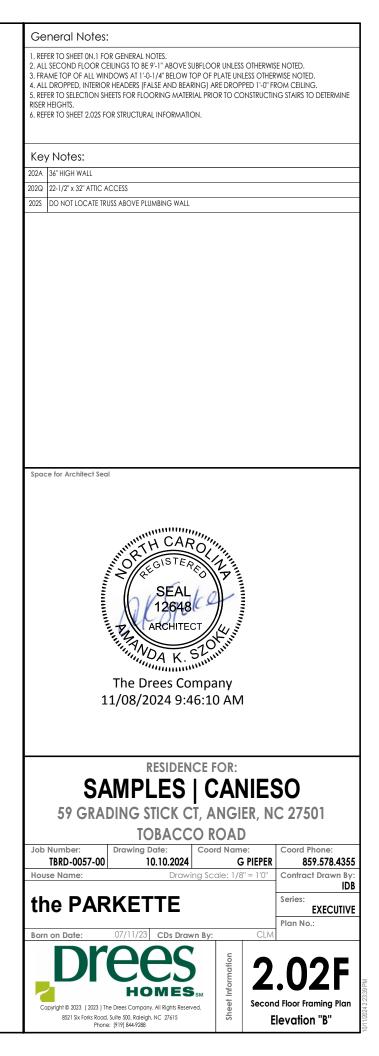
TOBACCO ROAD Job Number: Drawing Date: Coord Name: Coord Phone: TBRD-0057-00 10.10.2024 859.578.4355 G PIEPER House Name: Drawing Scale: 1/8" = 1'0" Contract Drawn By: IDB the **PARKETTE** Series: EXECUTIVE Plan No.: Born on Date: 07/11/23 CDs Drawn By: CLN HOMES
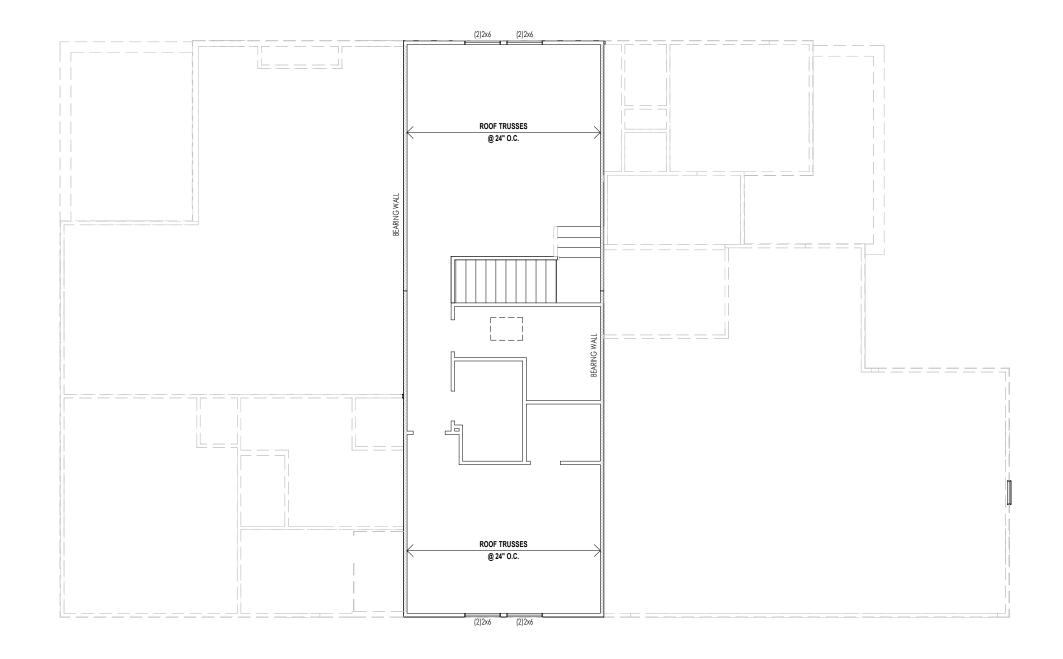
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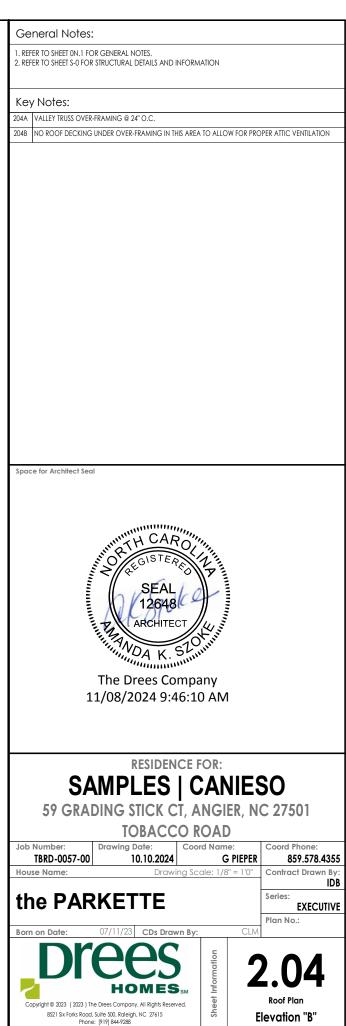
Copyright © 2023 (2023) The Drees Company. All Rights Reserved. 8521 Six Forks Road, Suite 500, Raleigh, NC 27615 Phone: [919] 844-9288 Second Floor Structural Plan

Elevation "B"


	HEEL	CUT STAN	DARDS
		OVER	HANG
		1'-0"	2'-0"
	4:12	3-3/4"	7-3/4"
	5:12	4-3/4"	9-3/4"
	6:12	5-3/4"	11-3/4"
GH	7:12	6-3/4"	13-3/4"
: PITCH	8:12	7-3/4"	N/A
ROOF	9:12	8-3/4"	N/A
Ŕ	10:12	9-3/4"	N/A
	12:12	11-3/4"	N/A
	14:12	13-3/4"	N/A

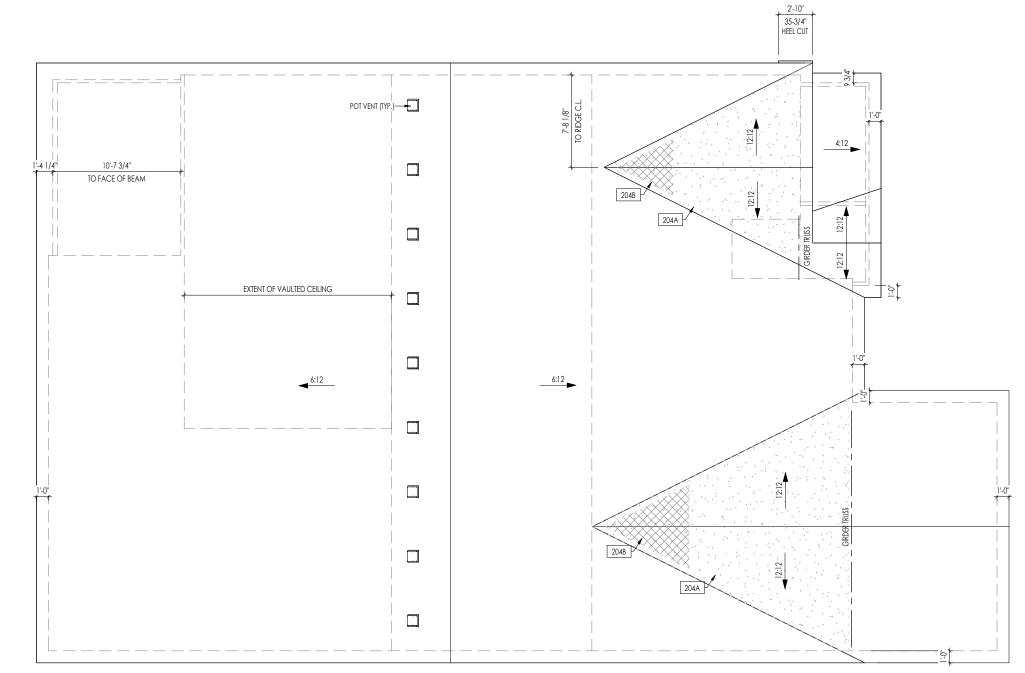



ROOF VENTILATION	
CITY/SERIES:	RALEIGH
	MAIN HOUSE
TOTAL ATTIC AREA:	3,740
REQUIRED NET FREE VENTILATION (ATTIC AREA/300):	12.47
ACTUAL NET FREE VENTILATION (UPPER + LOWER):	13.28
DOWNSPOUT CALCULATION	
	MAIN HOUSE
TOTAL DRAINABLE ROOF AREA:	4862
MINIMUM # OF DOWNSPOUTS:	9




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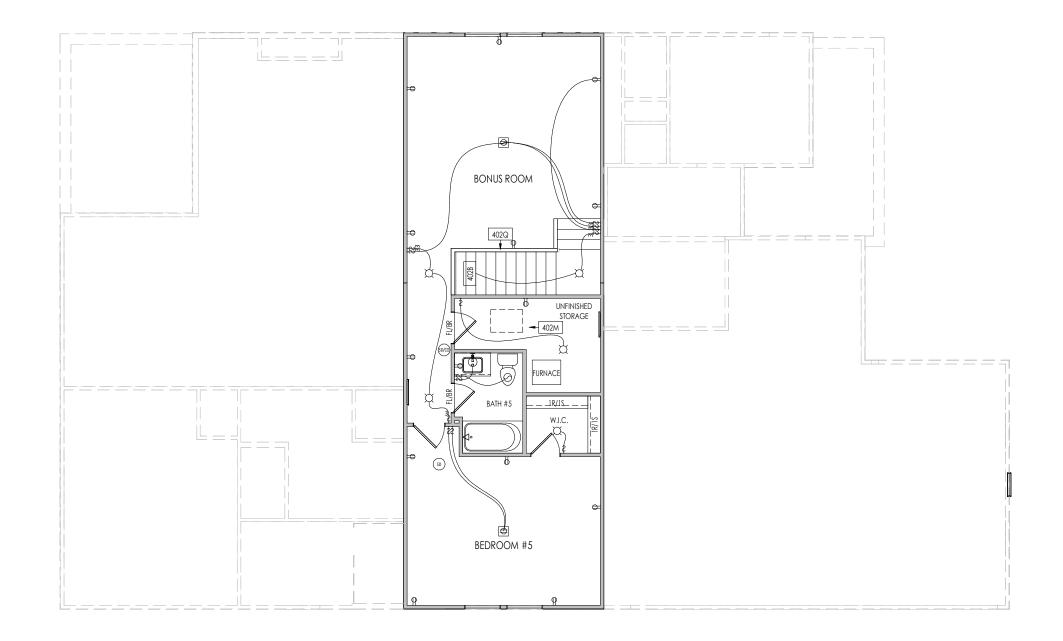


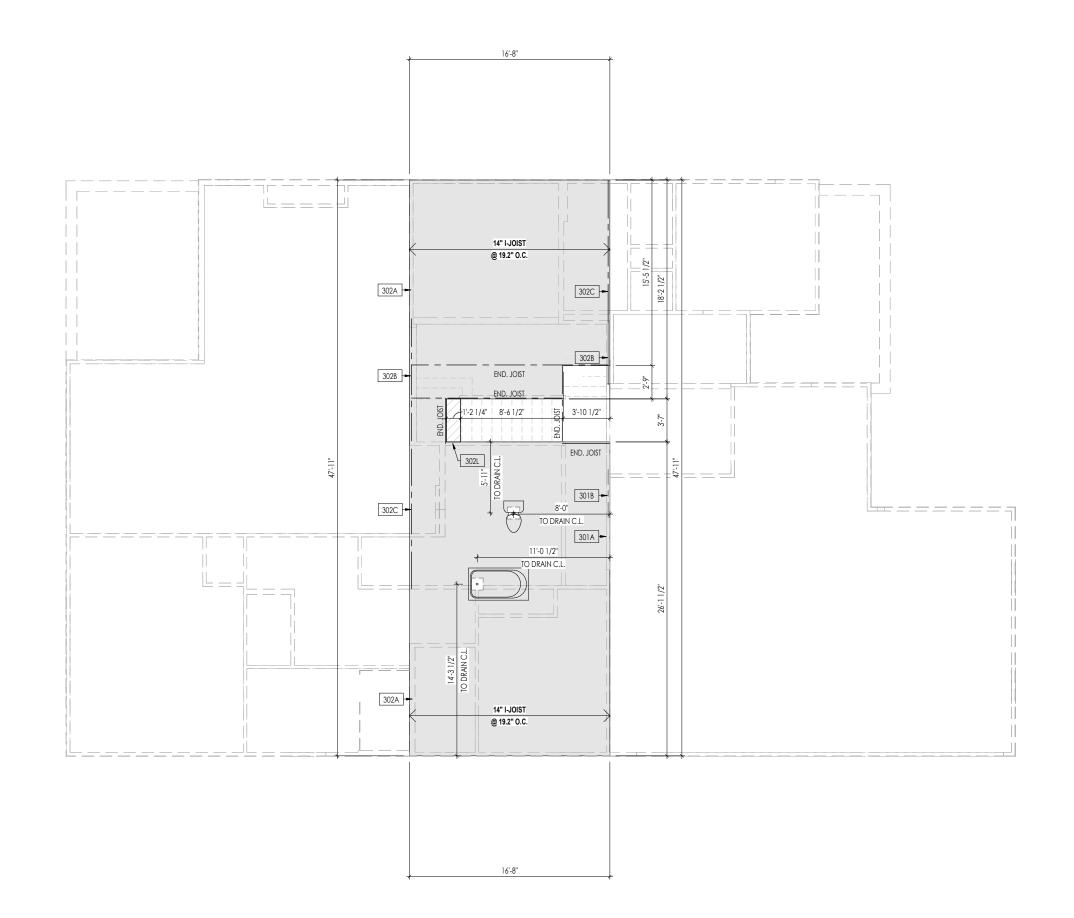

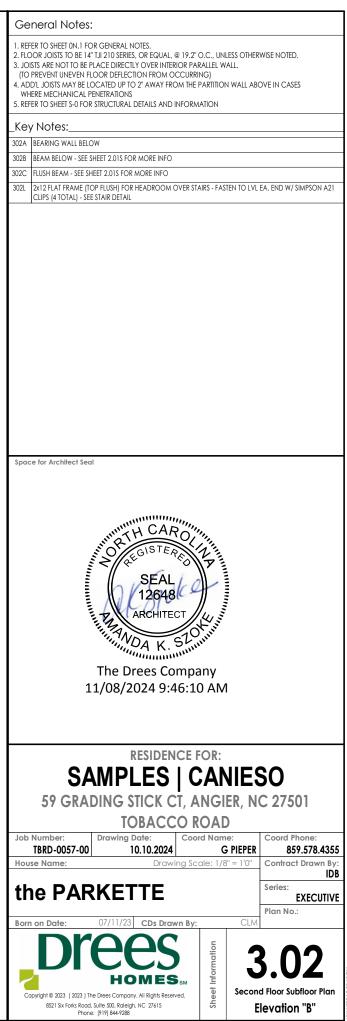


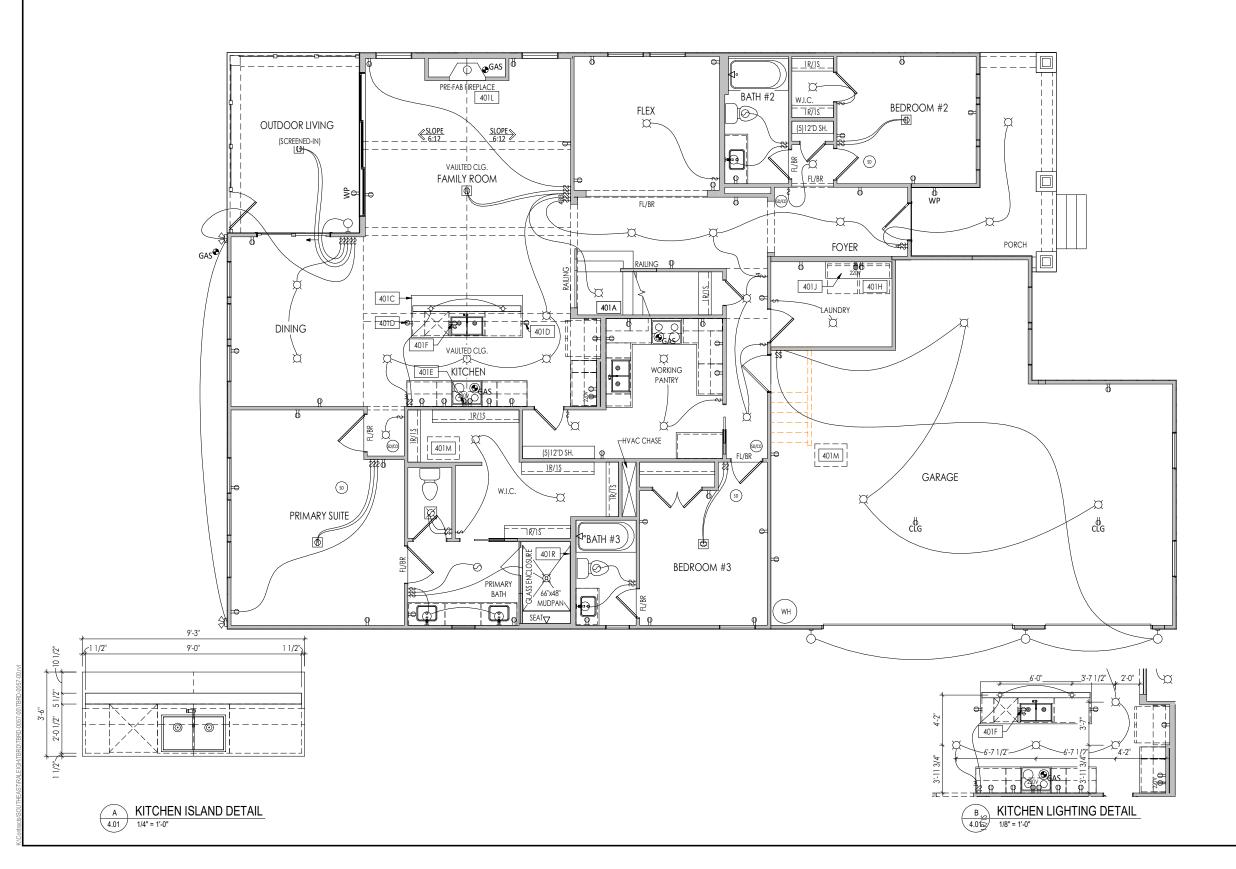


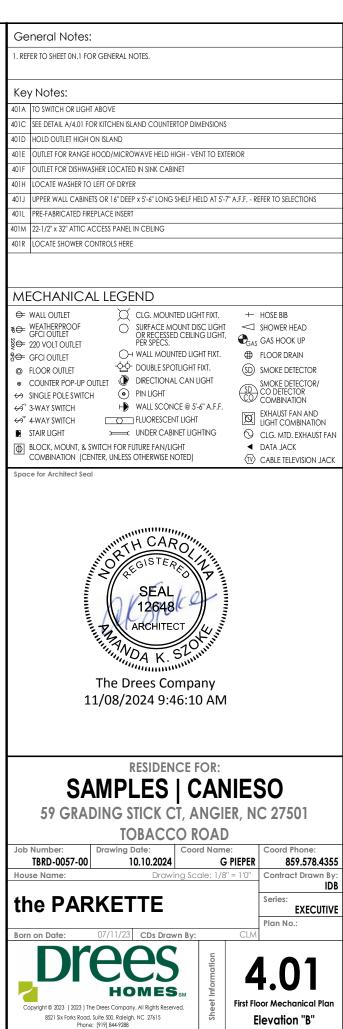
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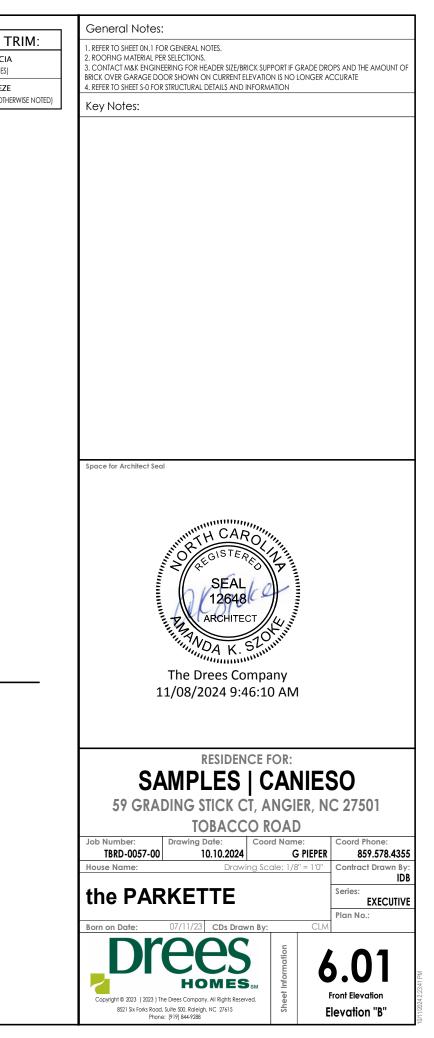


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General Notes:	
1. REFER TO SHEET 0N.1 FOR GENERAL NOTES.	
2. REFER TO SHEET S-0 FOR STRUCTURAL DETAILS AND INFORM	MATION
Koy Notor	
Key Notes:	
Space for Architect Seal	
SEAL	1111
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12648 C	2
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The Drees Comp 11/08/2024 9:46:1 RESIDENCE	any 0 AM FOR:
The Drees Comp 11/08/2024 9:46:1 RESIDENCE SAMPLES   C	any 0 AM FOR: CANIESO
The Drees Comp 11/08/2024 9:46:1 RESIDENCE SAMPLES   C 59 GRADING STICK CT, A	any 0 AM FOR: CANIESO ANGIER, NC 27501
The Drees Comp 11/08/2024 9:46:1 RESIDENCE SAMPLES   C 59 GRADING STICK CT, A TOBACCO F	any 0 AM FOR: CANIESO ANGIER, NC 27501 ROAD
The Drees Comp 11/08/2024 9:46:1 RESIDENCE SAMPLES   C 59 GRADING STICK CT, A TOBACCO F	any 0 AM FOR: CANIESO ANGIER, NC 27501
The Drees Comp 11/08/2024 9:46:1 RESIDENCE SAMPLES ( C 59 GRADING STICK CT, A TOBACCO F Job Number: TBRD-0057-00 Drawing Date: Coor 10.10.2024	Any 0 AM FOR: CANIESO ANGIER, NC 27501 Coord Phone: <u>6 PIEPER</u> <u>859.578.4355</u> cole: 1/8" = 1'0" Contract Drawn By:
The Drees Comp 11/08/2024 9:46:1 RESIDENCE SAMPLES ( C 59 GRADING STICK CT, A TOBACCO F Job Number: TBRD-0057-00 Drawing Date: 10.10.2024 House Name: Drawing Sc	any 0 AM FOR: CANIESO ANGIER, NC 27501 ROAD ord Name: G PIEPER Coord Phone: 859.578.4355
The Drees Comp 11/08/2024 9:46:1 RESIDENCE SAMPLES ( C 59 GRADING STICK CT, A TOBACCO F Job Number: TBRD-0057-00 Drawing Date: 10.10.2024	any 0 AM FOR: CANIESO ANGIER, NC 27501 ROAD ord Name: G PIEPER 859.578.4355 cole: 1/8" = 1'0" Contract Drawn By: IDB Series: EXECUTIVE
The Drees Comp 11/08/2024 9:46:1 RESIDENCE SAMPLES ( C 59 GRADING STICK CT, A TOBACCO F Job Number: TBRD-0057-00 Drawing Date: 10.10.2024 House Name: Drawing Sc	any 0 AM FOR: CANIESO ANGIER, NC 27501 ROAD ord Name: G PIEPER 859.578.4355 cole: 1/8" = 1'0" Contract Drawn By: IDB Series: EXECUTIVE Plan No.:
The Drees Comp 11/08/2024 9:46:1 RESIDENCE SAMPLES   C 59 GRADING STICK CT, A TOBACCO F Job Number: TBRD-0057-00 Drawing Date: TBRD-0057-00 Drawing Sc The PARKETTE	Any 0 AM FOR: CANIESO ANGIER, NC 27501 Coord Phone: G PIEPER 859.578.4355 cale: 1/8" = 1'0" Contract Drawn By: IDB Series: EXECUTIVE Plan No.:
The Drees Comp 11/08/2024 9:46:1 RESIDENCE SAMPLES   C 59 GRADING STICK CT, A TOBACCO F Job Number: TBRD-0057-00 Drawing Date: TBRD-0057-00 Drawing Sc The PARKETTE	Any 0 AM FOR: CANIESO ANGIER, NC 27501 Coord Phone: G PIEPER 859.578.4355 cale: 1/8" = 1'0" Contract Drawn By: IDB Series: EXECUTIVE Plan No.:
The Drees Comp 11/08/2024 9:46:1 RESIDENCE SAMPLES   C 59 GRADING STICK CT, A TOBACCO F Job Number: Drawing Date: Coc 10.10.2024 House Name: Drawing Sc the PARKETTE Born on Date: 07/11/23 CDs Drawn By DTOCOS	Any 0 AM FOR: CANIESO ANGIER, NC 27501 Coord Phone: G PIEPER 859.578.4355 cale: 1/8" = 1'0" Contract Drawn By: IDB Series: EXECUTIVE Plan No.:
The Drees Comp 11/08/2024 9:46:1 RESIDENCE SAMPLES   C 59 GRADING STICK CT, A TOBACCO F Job Number: TBRD-0057-00 Drawing Date: TBRD-0057-00 Drawing Date: TBRD-0057-00 Drawing Sc the PARKETTE	any 0 AM FOR: CANIESO ANGIER, NC 27501 Coord Phone: <u>6 PIEPER</u> <u>859.578.4355</u> cole: 1/8" = 1'0" Contract Drawn By: <u>IDB</u> Series: <u>EXECUTIVE</u> Plan No.: <u>5</u>


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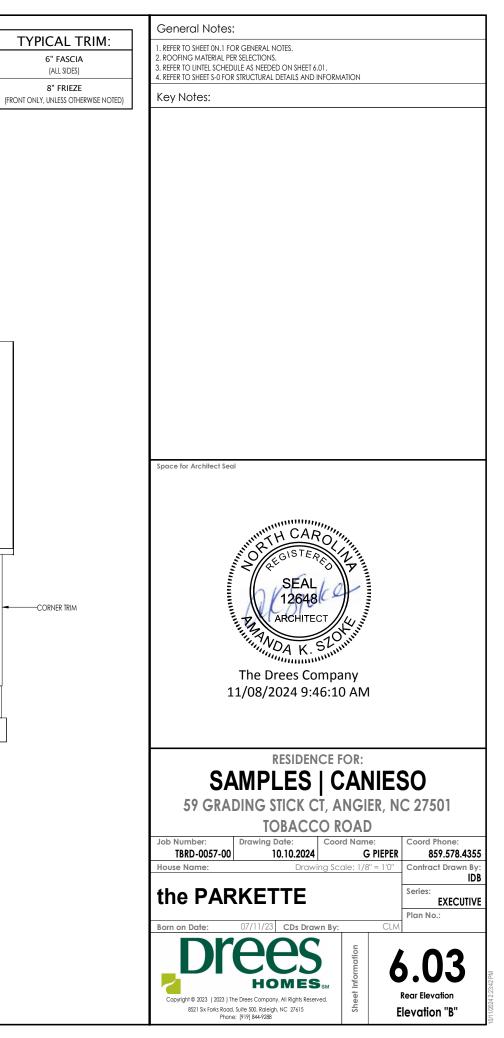
### ELEVATION B

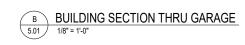

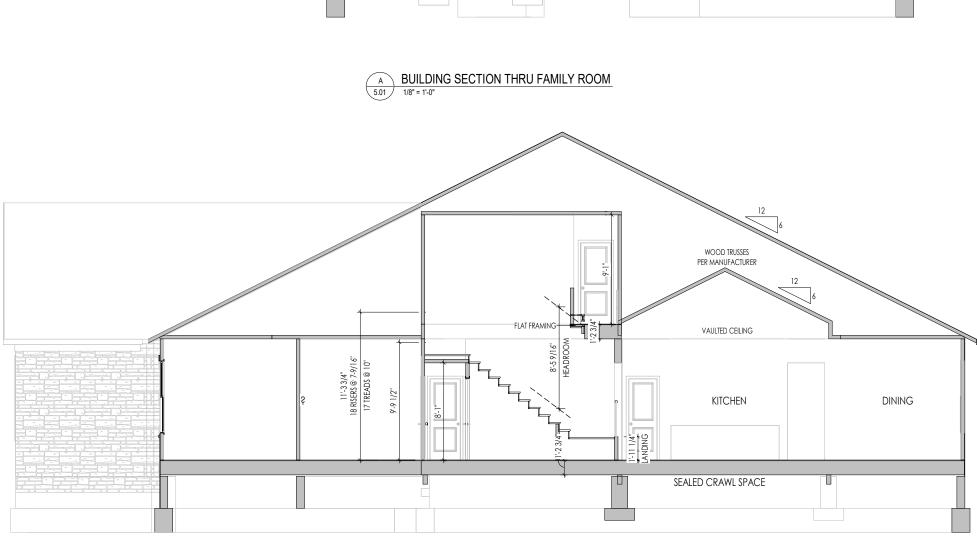


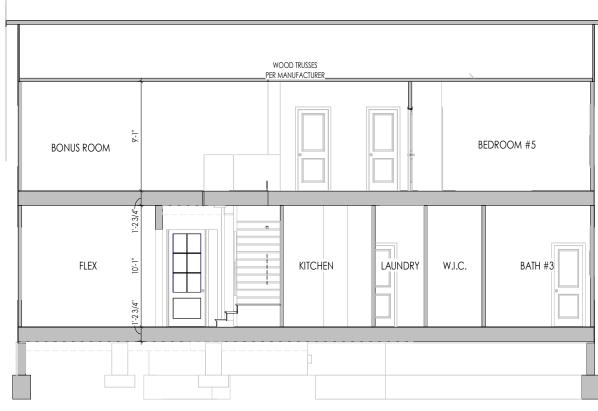





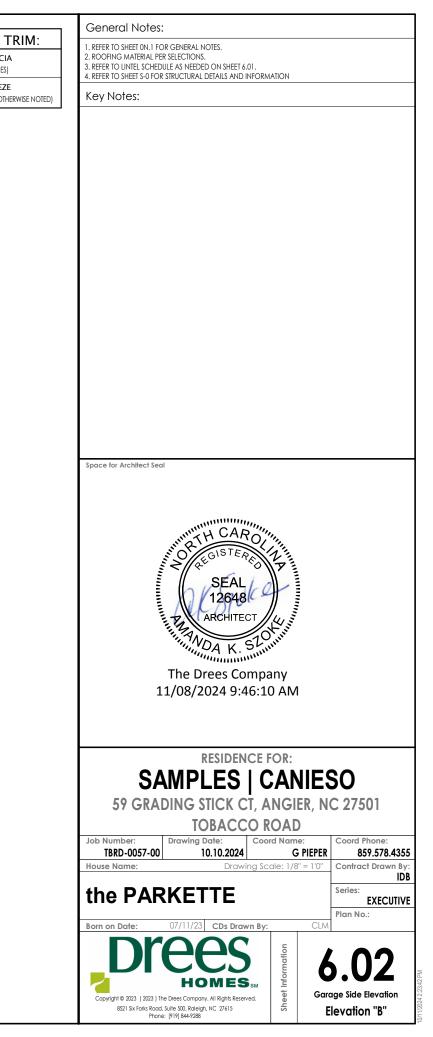





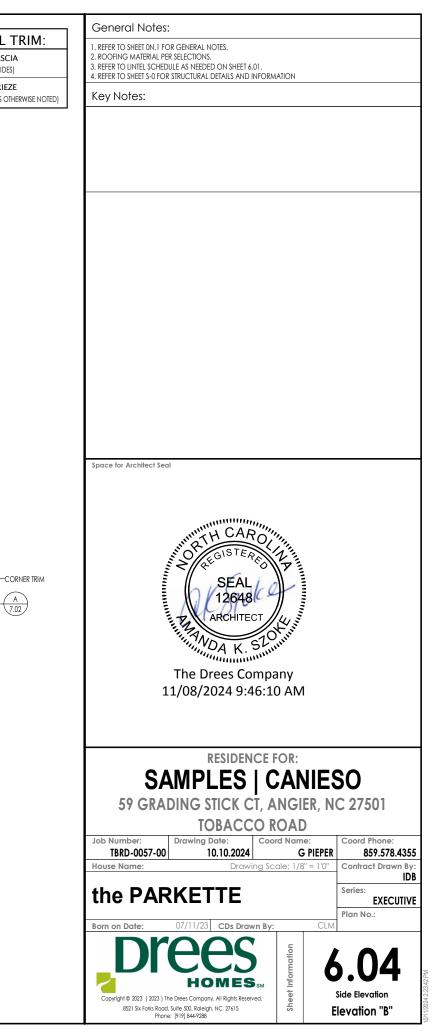

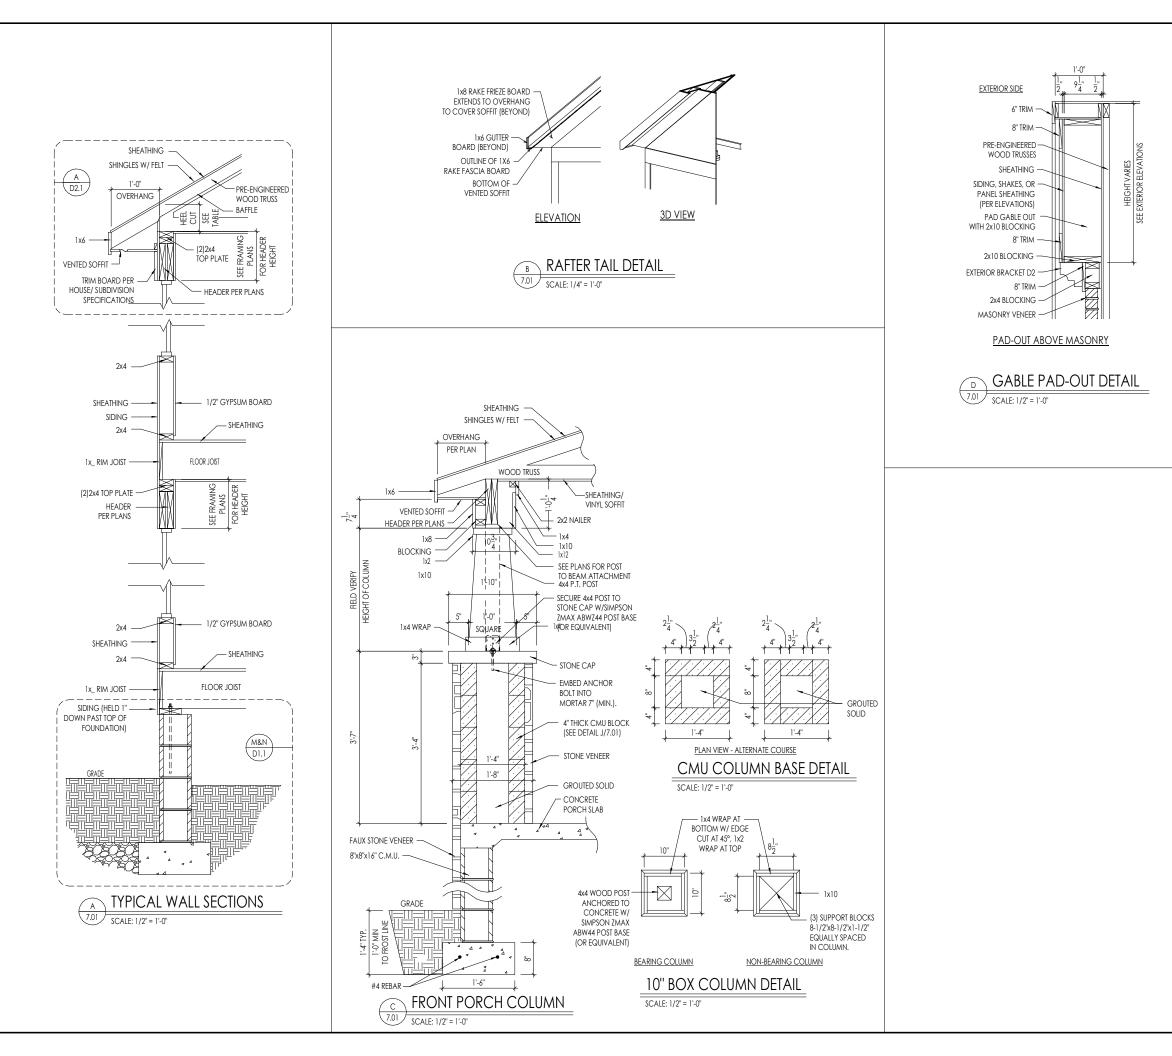


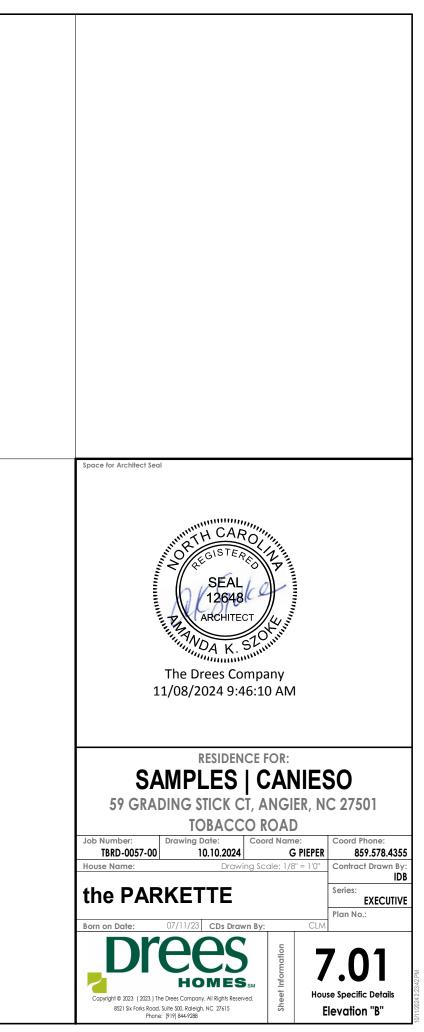

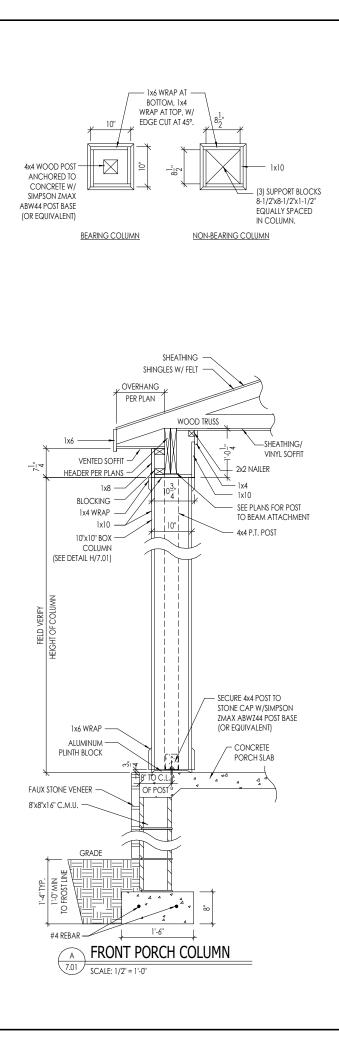


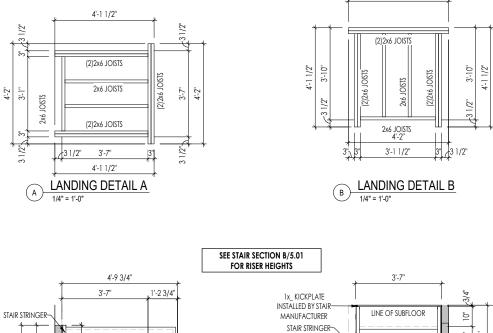

4'-2"

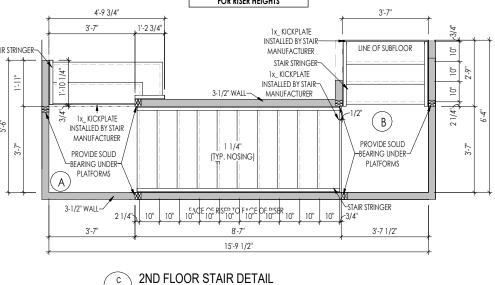



c 2ND FL 7.02 1/4" = 1'-0"

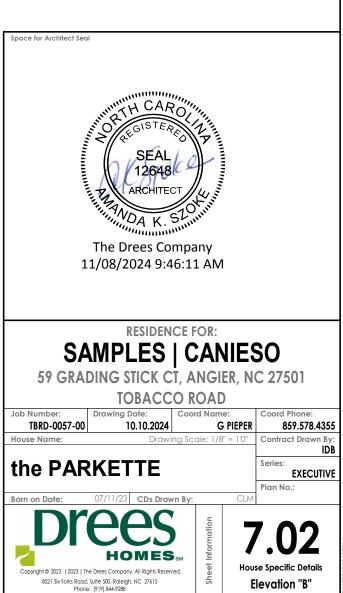



CONNECTION SPECIFICATIO	ONS (TYP. U.N.O.)	VENEER LINTEL SCHEDULE	GENERAL STRUCTURAL NOTES	LATERAL/WALL BRACING & WALL	GENERAL STRUCTURAL NOTES
Note: 10d Nail = 3" × 0.131	31" gun nail	SPAN HEIGHT OF VENEER STEEL ANGLE SIZE (MAX) ABOVE LINTEL STEEL ANGLE SIZE 3'-0' 20 FT. MAX L4'x3'x4'	FOUNDATION		FLOOR FRAMING
NOTE: IOD NAIL = 3" x 0.31           JOIST TO SOLE PLATE         (3)IOD TO           SOLE PLATE         (3)IOD TO           STID TO SOLE PLATE         (3)IOD TO           STID TO SOLE PLATE         (3)IOD TO           TOP OR SOLE PLATE         (3)IOD TO           BLKG. BTAN. JOISTS TO TOP PL.         (3)IOD TO           RAFTER/RUSS TO TOP PLATE         (3)IOD TO           RAFTER/RUSS TO TOP PLATE         (3)IOD TO           R.T. N/ HEEL HT. 12" TO 12"         2xIO BLK           R.T. N/ HEEL HT. 12" TO 16"         2xI2 BLK           R.T. N/ HEEL HT. 12" TO 16"         2xI2 BLK           R.T. N/ HEEL HT. 12" TO 16"         2xI2 BLK           R.T. N/ HEEL HT. 12" TO 16"         2xI2 BLK           R.T. N/ HEEL HT. 12" TO 16"         2xI2 BLK           R.T. N/ HEEL HT. 12" TO 48"         LAP WAL           R.T. N/ HEEL HT. 24" TO 48"         LAP WAL           R.T. N/ HEEL HT. 24" TO 48"         LAP WAL           R.T. N/ HEEL HT. 24" TO 48"         LAP WAL           R.T. N/ HEEL HT. 24" TO 48"         LAP WAL           R.T. N/ HEEL HT. 24" TO 48"         LAP WAL           R.T. N/ HEEL HT. 24" TO 48"         LAP WAL           R.T. N/ HEEL HT. 24" TO 48"         LAP WAL           R.T. N/ HEEL HT. 24" TO 48"	All GUN NAIL OENAILS S $\bullet$ 6 ° 0.C. OENAILS S $\bullet$ 6 ° 0.C. OENAILS AILS OENAILS OENAILS OENAILS SON H25A NAILS $\bullet$ 6 ° 0.C. EVERY 3RD BAY ED TO DEL. TOP PLATE TOP NAILS $\bullet$ 6 ° 0.C. K EVERY 3RD BAY ED TO DEL. TOP PLATE TOP NAILS $\bullet$ 6 ° 0.C. LL SHTG. N/ DEL. TOP PL. LL ON TR/S6 VERT LW dd NAILS $\bullet$ 6 ° 0.C. LL SHTG. N/ DEL. TOP PL. LL ON TR/S6 VERT LW dd NAILS $\bullet$ 6 ° 0.C. LL SHTG. N/ DEL. TOP PL. LL ON TR/S6 VERT LW dd NAILS $\bullet$ 6 ° 0.C. S $\bullet$ 24 ° 0.C. S $\bullet$ 25 ° 24 ° 0.C. S $\bullet$ 26 ° 0.C. S $\bullet$ 27 ° 0.C. S $\bullet$ 27 ° 0.C. S $\bullet$ 27 ° 0.C. S $\bullet$ 20 °	SPAN HEIGHT OF VENEER STEEL ANGLE SIZE		LATERAL/WALL BRACING & WALL SHEATHING SPECIFICATIONS THIS MODEL HAS BEEN DESIGNED TO RESIST LATERAL FORCES RESULTING FROM: IO MPH WIND SPEED IN ASCE 7-10 WIND MAP, PER IRC R3012.1.1) EXP. B & SEISMIC CAT. A/B. EXT. WALL SHEATHING SPECIFICATION • 7/16" OSB OR I5/32" PLYWOOD: FASTEN SHEATHING Y & WAILS NAILS • 6" OC. AT EDGES & 0 12" OC. IN THE PAREL FIELD. (TYP, UNO) • ALL SHEATHING PARELS SHALL BE ORIENTED VERTICALLY (LONG DIRECTION PARALLEL TO STUDS) AND INSTALLED FULL HEIGHT OF SHEAR WALL - OR - 22: HORIZONTAL BLOCKING SHALL BE PROVIDED TO SUPPORT ALL WEUPPORTED PAREL ELDGES & EDGE FASTENING. • ALL EXT. WALLS SHALL BE CONTINUOUSLY SHEATHED AND ARE CONSIDERED SHEAR WALLS. • ALT. STAPLE CONNECTION SPEC: 1 %" 16 GA STAPLES (%" CRONN • 3" OC. AT EDGES & • 6" OC IN FIELD. <u>3" O.C. EDGE NAILING</u> • AT DESIGNATED AREAS - FASTEN PAREL EDGES OF WOOD STRUCTURAL WALL SHEATHING TO FRAMING W 2 §" X OLIS' NAILS • 3" OC. AND 12" OC. IN THE PAREL FIELD NO STAPLE ALTERNATIVE AVAILABLE AT THIS SPEC, ALL SHEATHING FOR FRAMING W 2 §" X OLIS' NAILS • 3" OC. AND 12" OC. IN THE PAREL FIELD NO STAPLE ALTERNATIVE AVAILABLE AT THIS SPEC, ALL SHEATHING PARELS SHALL BE ORIENTED VERTICALLY (LONG PARALLE) DE ORIENTED VERTICALLY (LONG PARALLE) DE ORIENTED VERTICALLY (LONG PARALLE) DE NOOD STRUCTURAL WALL SHEATHING TO FRAMING W 2 §" X OLIS' NAILS • 3" OC. AND 12" OC. IN THE PAREL FIELD NO STAPLE ALTERNATIVE AVAILABLE AT THIS SPEC, ALL SHEATHING PARELS SHALL BE ORIENTED VERTICALLY (LONG PARALLE) DE ORIENTED VERTICALLY (LONG DIRE CTION PARALLE) DE ORIENTED VERTICALLY (LONG DIRE CTION PARALLE) DE ROVIDED TO STUDPART MEMPRORTED PARALLE DEGES AND 3" OC. EDGE FASTENING. • DESIGN ASSIMES 16" OC MAX. STUD SPACING, UNO. • ALL STRUCTURAL PARELS ARE TO DE DIRECTLY APPLIED TO STUD FRAMING. • PRESIDENCES ARE TO DE DIRECTLY APPLIED	
4" CONC. SLAB W/ 6x6 MIL VAPOR BARRIER O FILL ON 95% COMPACT HOLD-DOWN SC	on 4" min. Granular Ted Fill/Virgin Soil	ROOF TRUES, FLOOR TRUES AND ENGINEERED JOISTS SHALL BE DESIGNED TO MEET THE DEFLECTION CRITERIA BELON (NULESS NOTED OTHERNISE ON PLAN, MULEREN & KULP CANNOT BE HELD RESPONSIBLE FOR ANY STRUCTURAL ISSUES RELATED TO ANY BUILDING COMPONENT IF COMPONENT SHOP DRAWINGS ARE NOT SUBMITTED TO MIK FOR REVIEW PRICH TO FABRICATION.	GRADE. • FOOTINES AND SLADE ON GRADE SHALL BEAR ON VIRGIN SOIL OR 45% COMPACTED FILL. • FROVIDE CONTROL JOINTS AT ALL INSIDE CORNERS OF SLAB EDGES, AND OTHER LOCATIONS WHERE SLAB CRACKS ARE LIKELY TO DEVELOP. • JOINTS SHALL BE LOCATED • 10'-0" O.C. (RECOMMENDED) OR	INDICATES EXTENT OF INT. OSB SHEARWALL, BLOCKED PANEL EDGES, AND/OR 3" O.C. EDGE NAILING INDICATES HOLDOWN	
SYMBOL SPECIFIC,	CATION	DELIVERY, OR INSTALLATION. TRUSSES/JOISTS SHALL BE DESIGNED SO THAT DIFFERENTIAL DEFLECTION BETWEEN ADJACENT PARALLEL TRUSSES/JOISTS OR GIRDER TRUSSES/FLUSH	15'-0" O.C. (MAXIMM) JOINT GRID PATTERN SHALL BE AS CLOSE TO SQUARES AS POSSIBLE (1:1 RATIO), WITH A MAXIMUM OF 1:15 RATIO CONTROL JOINTS SHALL NOT BE INSTALLED IN STRUCTURAL	INDICATES POST ABOVE (P.A.) PROVIDE SOLID BLOCKING UNDER POST OR JAMB ABOVE.	
<ul> <li>→ HD-1 SIMPSON HTT4 HOLD-1</li> <li>→ HD-2 SIMPSON HDV4-SDS2.5</li> </ul>		BEAMS DO NOT EXCEED THE FOLLOWING: A. ROOF TRUSSES: 1/4" DEAD LOAD	SLAB5 • TYPICAL REINFORCEMENT DETAILS: PROVIDE 3" MIN. CLEAR COMPRESSION FOR A STATE ADDITION OF A STATE OF	MIK 5110 5891. 2016	
HD-3 SIMPSON HDU5-SD52.5	5 HOLD-DOWN *	B. FLOOR TRUSSES, ATTIC TRUSSES, & I-JOISTS: 1/8° DEAD LOAD	COVER WHERE CAST AGAINST EARTH, I 1/2" MIN. CLEAR COVER AGAINST FORMS. LAP ALL REBAR 48 BAR DIAMETERS MIN. (24" FOR #4 BARS) & BEND BARS AND LAP AT CORNERS. PROVIDE 6"		
HD-4 SIMPSON STHDIARJ HO	HOLD-DOWN	ABSOLUTE DEAD LOAD DEFECTION OF FLOOR TRUSSES/ATTIC TRUSSES WHEN ADJACENT TO FLOOR FRAMING BY OTHERS SHALL BE LIMITED TO 3/16", (NOT	HOOK INTO SUPPORTING FOOTINGS WHEN FOOTINGS INTERSECT.		
HD-5 SIMPSON CSI6 STRAP	P TIE (14" END LENGTH)	DIFFERENTIAL DEFLECTION	• DIMENSIONS BY OTHERS, BUILDER TO VERIFY.		
	NTC40 STRAP TIE N FLOOR SYSTEM U.N.O.)				
	NTC66 STRAP TIE N FLOOR SYSTEM U.N.O.)				
ALTERNATIVE TO 55TB24 ANCHOR UTILIZE SIMPSON "SET" EPOXY DIA. THREADED ROD INTO CONCR PROVIDE 12" MIN. EMERDMENT, INT REMEDINE 11" MIN. EMERDMENT, INT	SYSTEM TO FASTEN 🗞" RETE FOUNDATION.				


INSTALL PER MANUF. RECOMMENDATIONS. DO NOT LOCATE ANCHORS WITHIN 1 3/4" OF EDGE OF FOUNDATION.

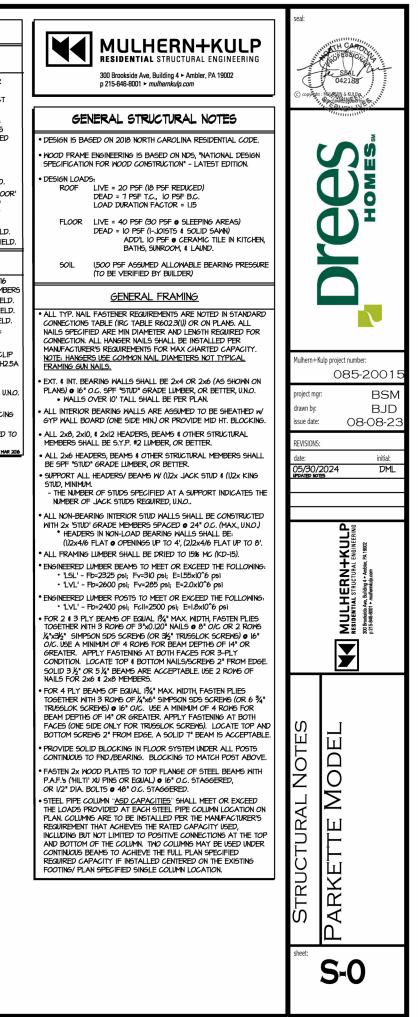


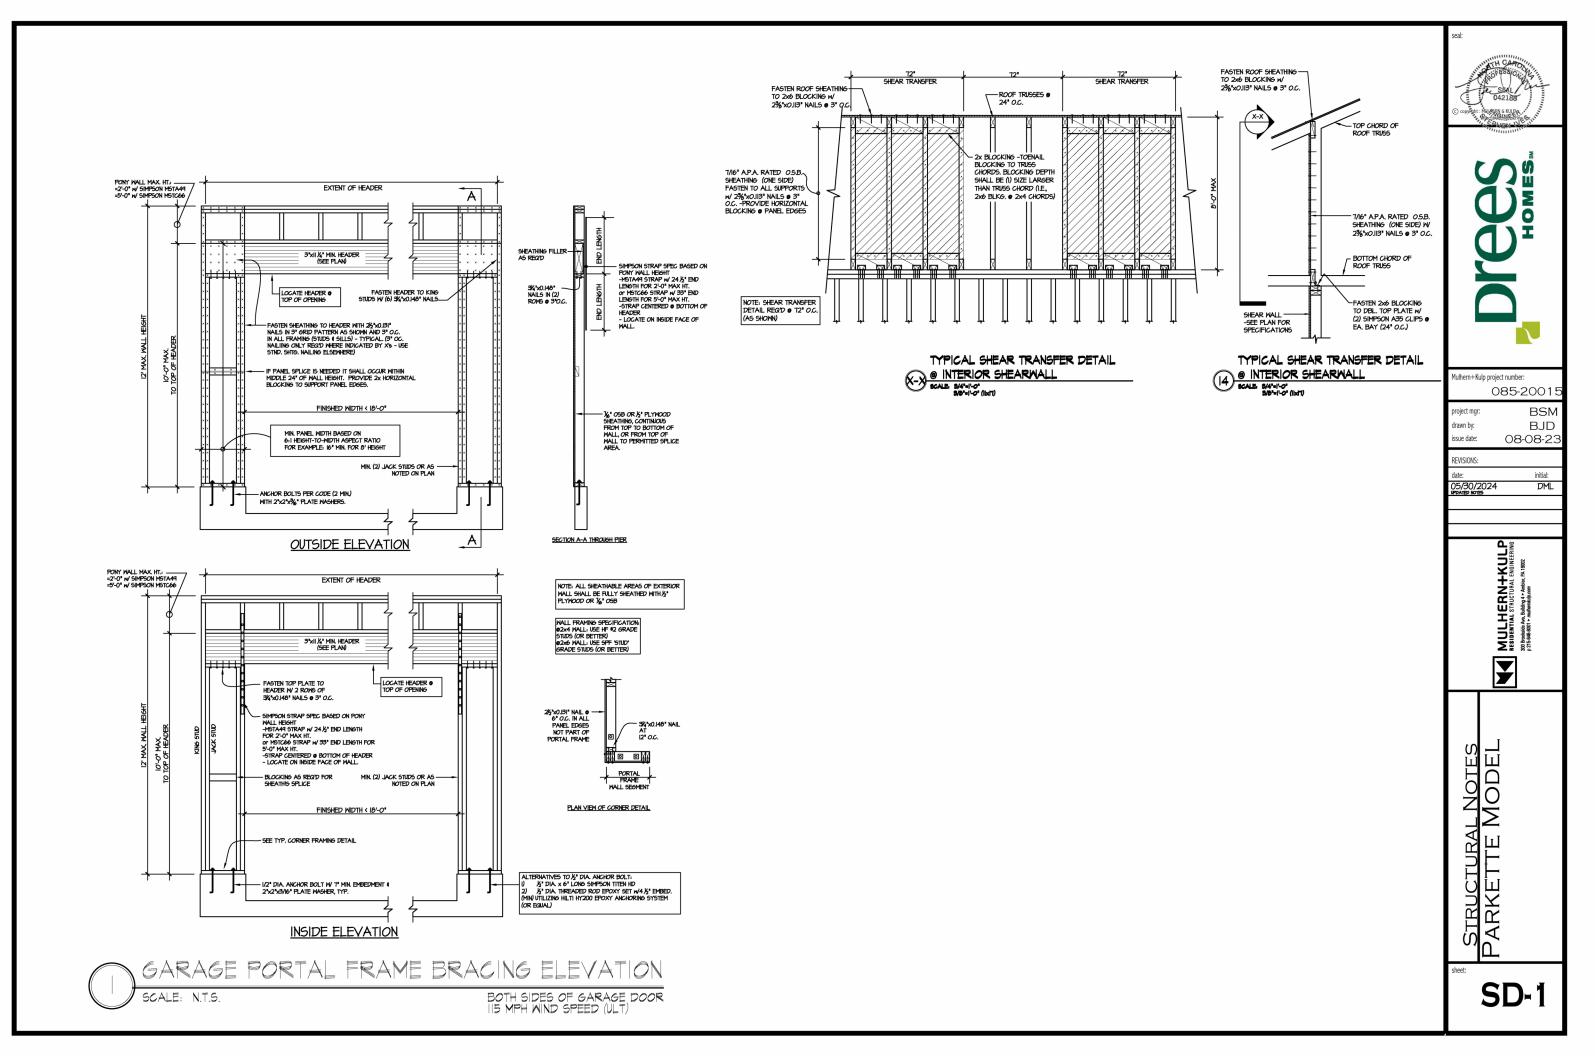

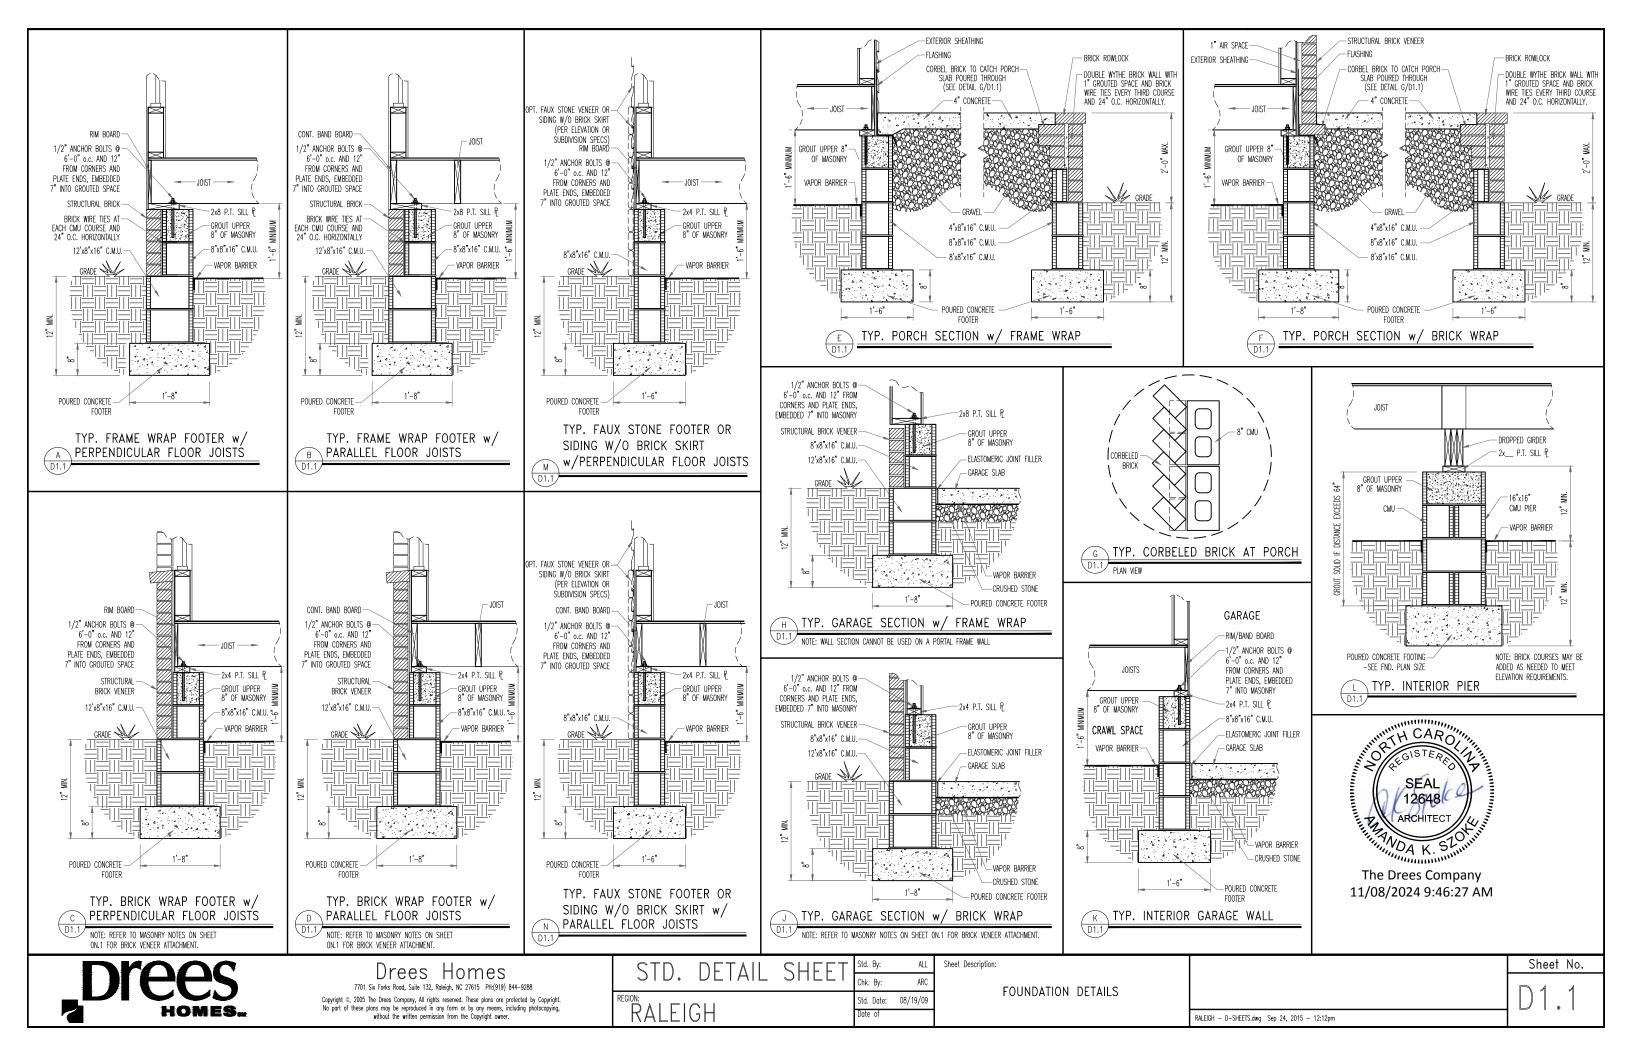


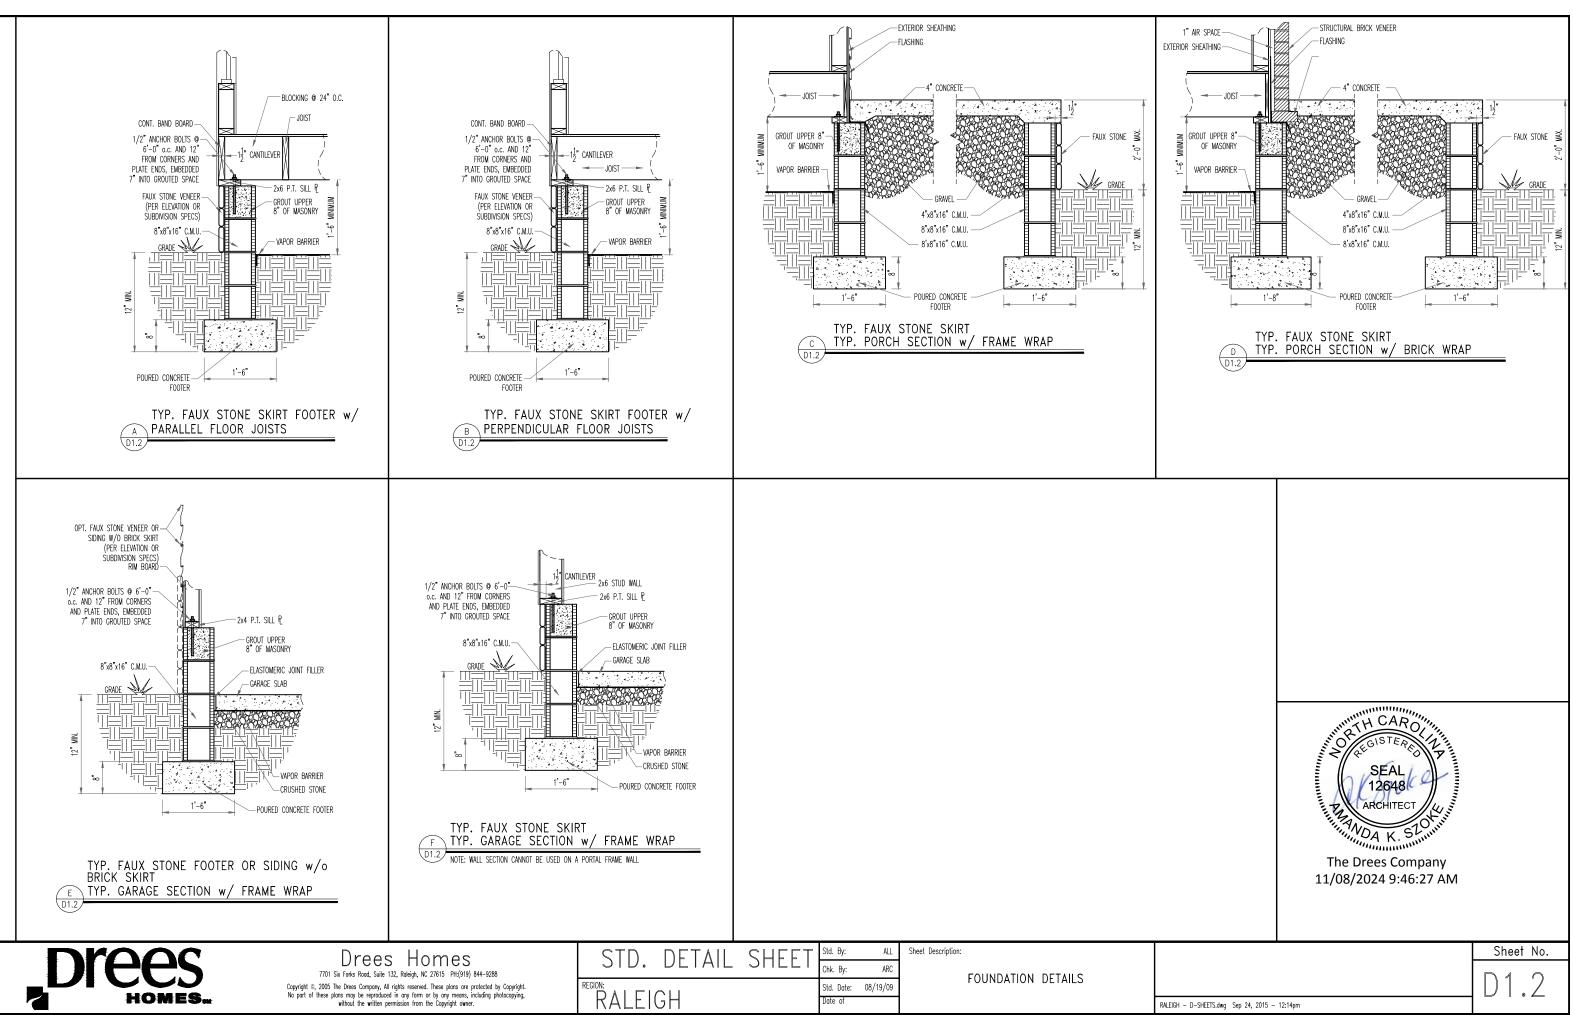


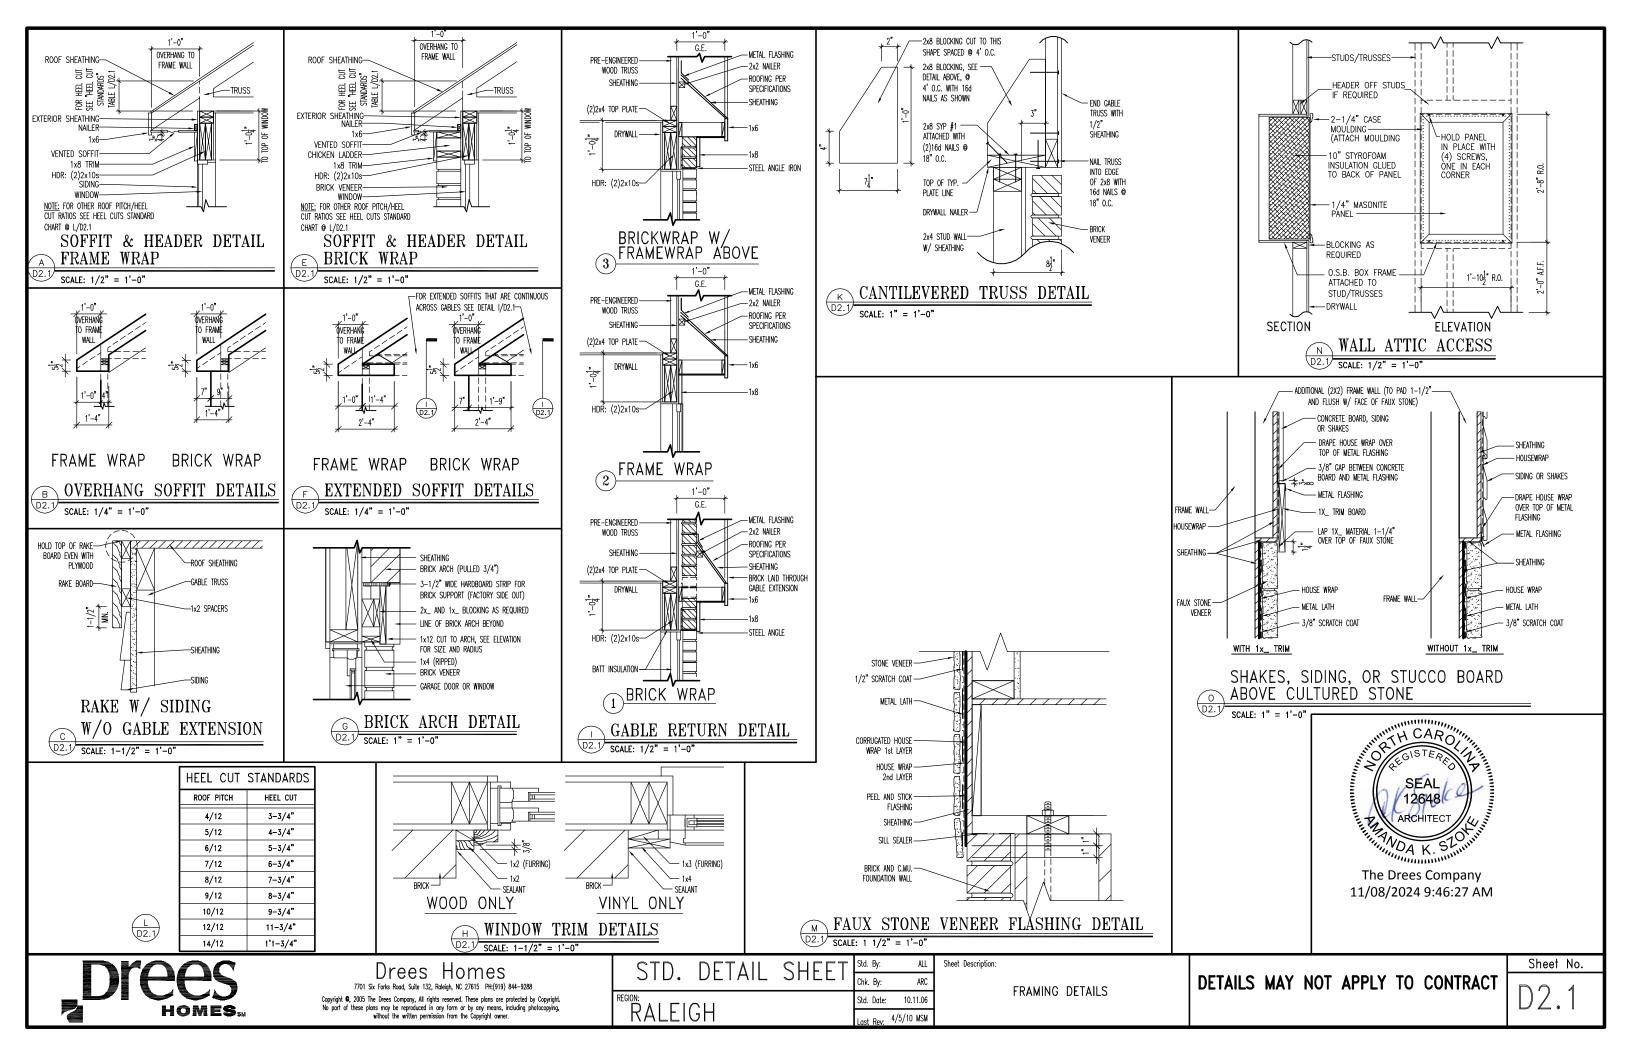

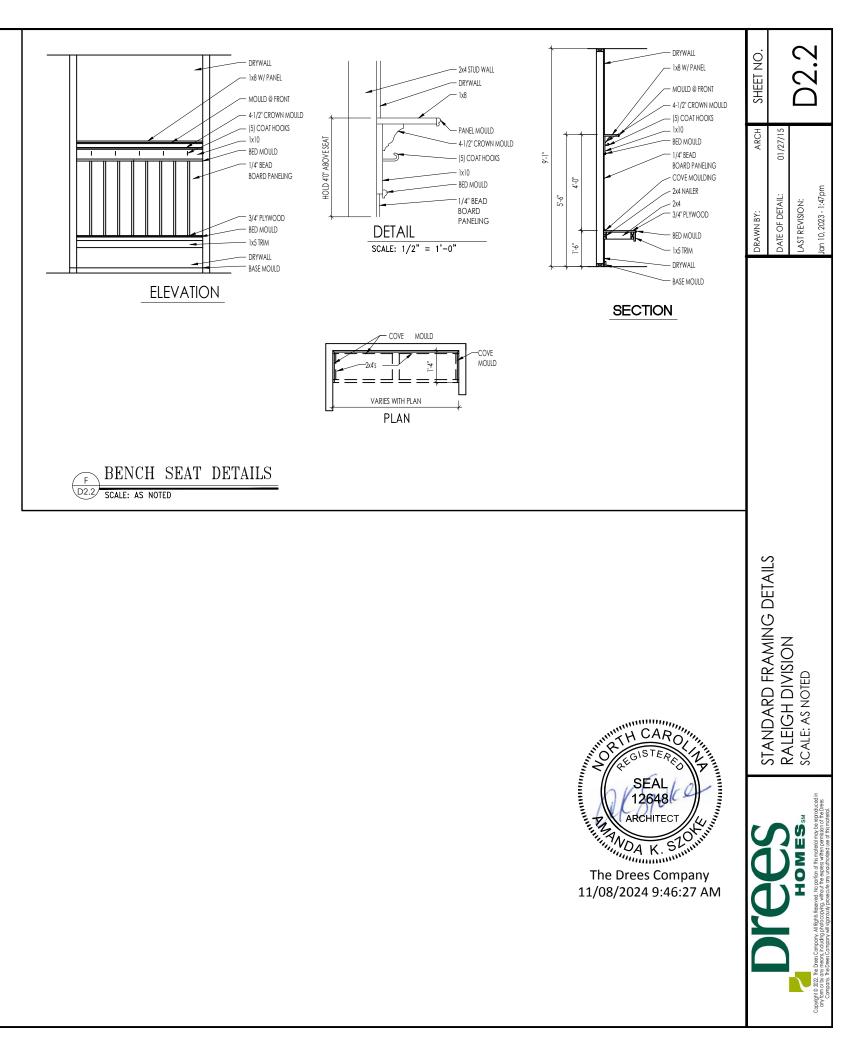




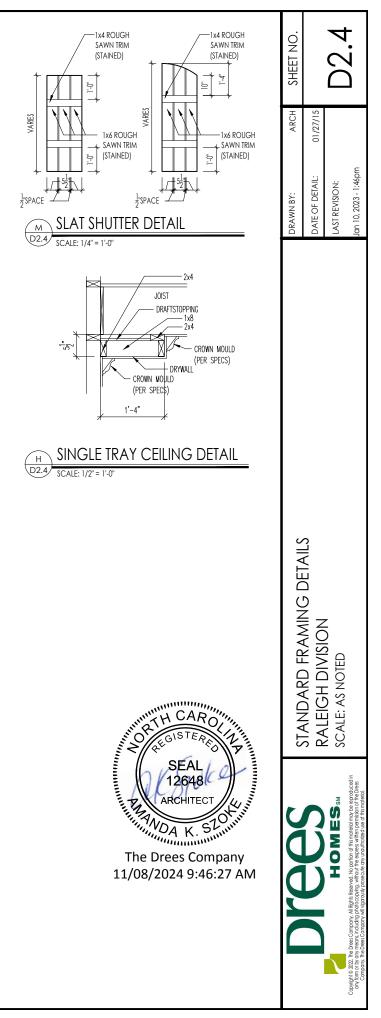


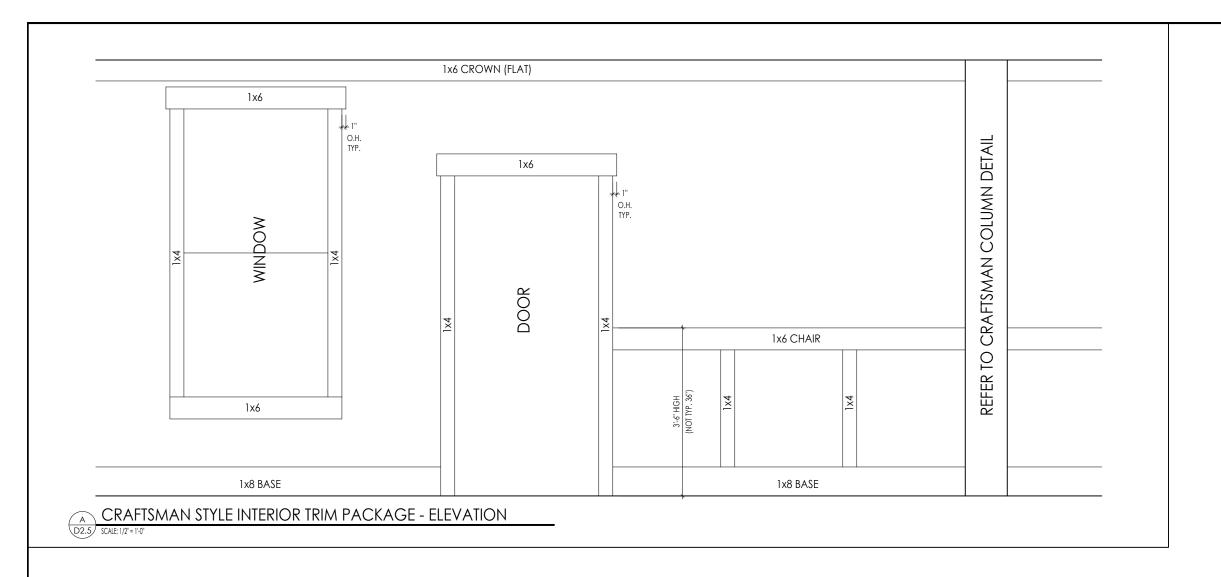

	DRAWN BY:	ARCH	SHEET NO.
のししう	DATE OF DETAIL:	01/27/15	
HOMES	LAST REVISION:		С О О
Copright 6 202, the Deer Company, All Right Reened. No portion of this inclusion may be produced in any port of the Deers. Include profocopy, which the sense with preamption PhoDeer Company. The Deers Company with groups are not any variable and and the markets.	Jan 10, 2023 - 8:34am		C + . C



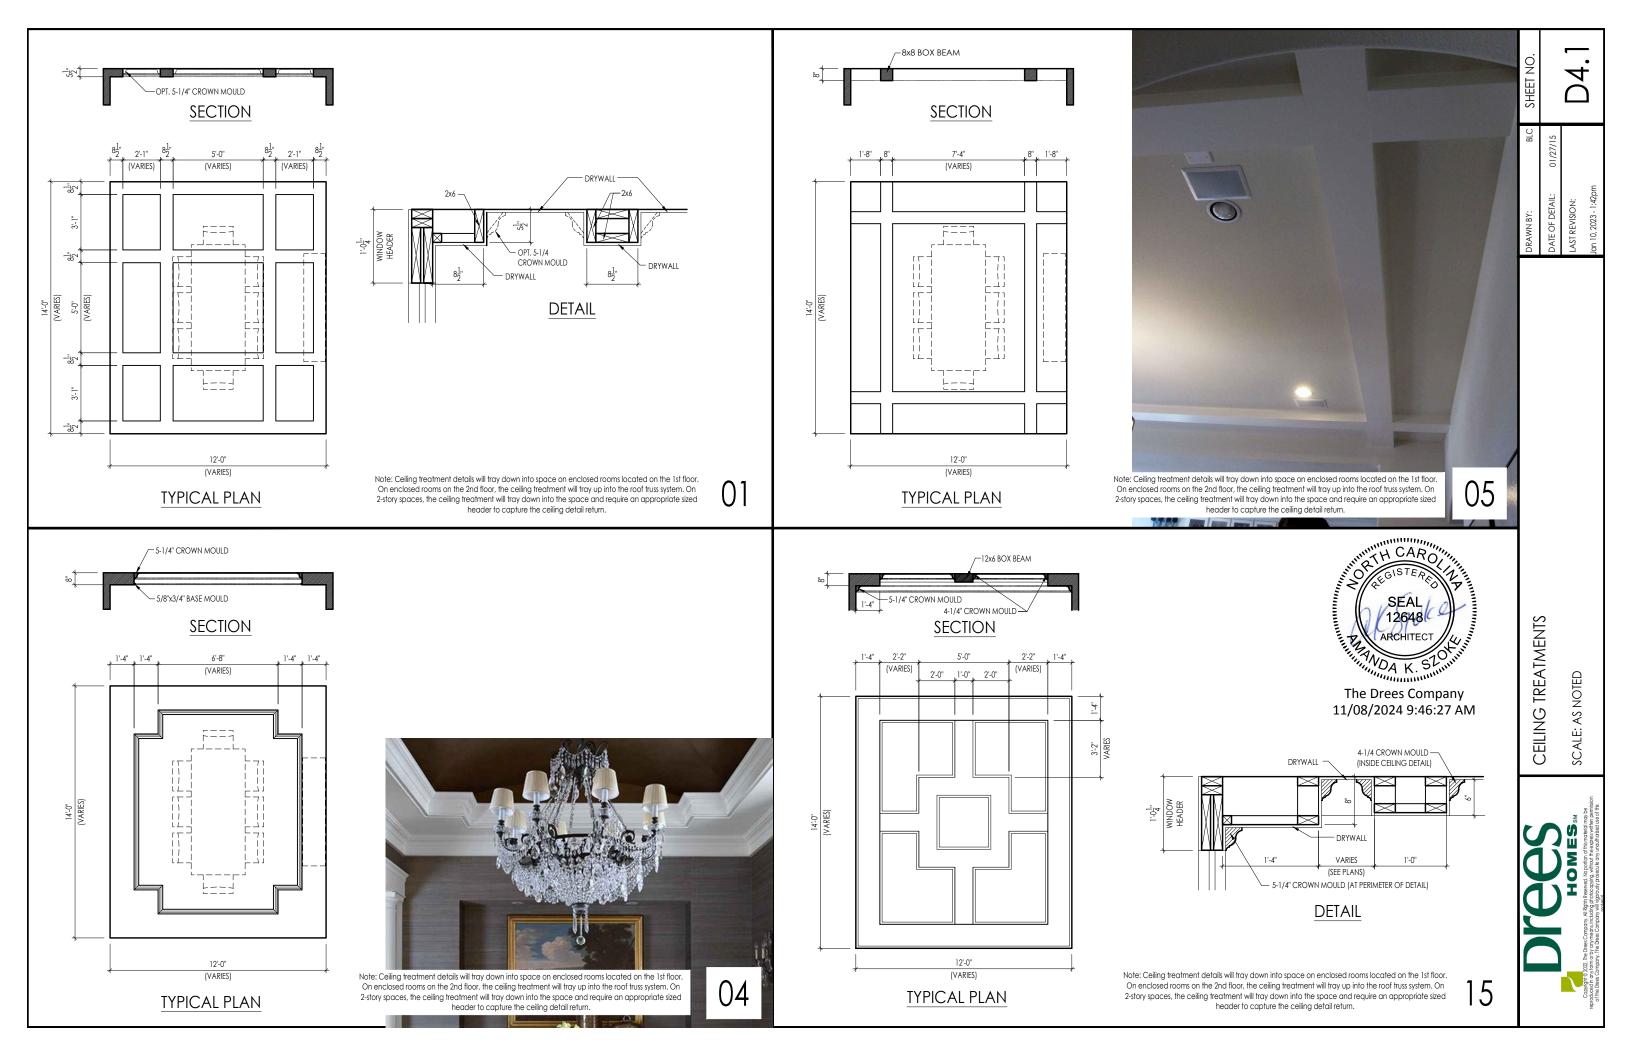

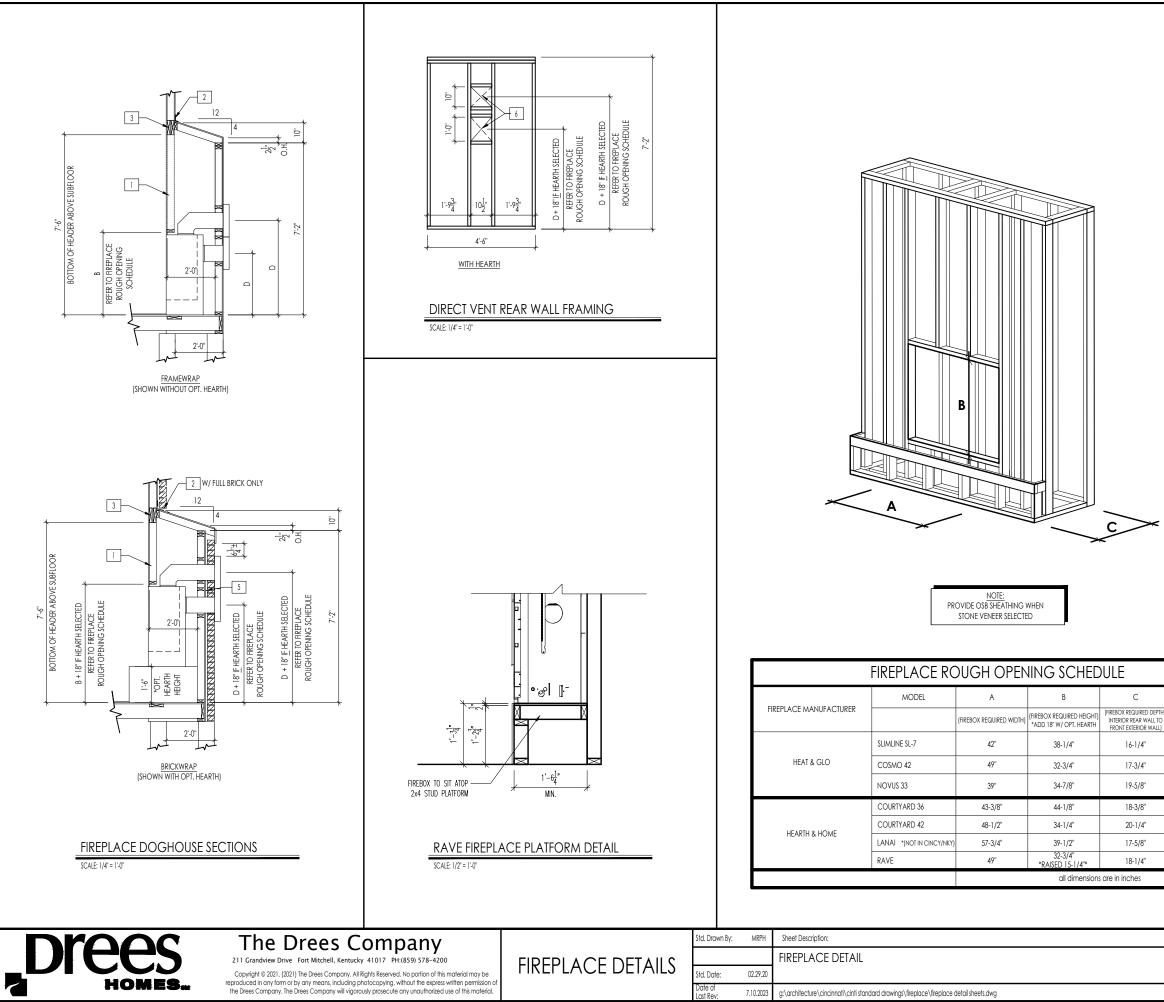

	General Notes	
	<ol> <li>REFER TO SHEET 0N.1 FOR GENERAL NOTES.</li> <li>VERIFY FIREPLACE MODEL AND HEARTH SELECTION WITH CL</li> </ol>	STOMER'S SELECTIONS.
	Key Notes	
	7 J FUTURE FRAMING FOR F.P. OPENING AFTER INSULATION HA	S REEN INSTALLED IN EXT. WALLS
	2 FLASHING	
	3 HEADER PER PLAN	
	4	
	5 1" AIRSPACE	
	6 BOX OUT FOR FLUE (REFER TO SELECTIONS FOR FIREPLACE	AND OPENING HEIGHT)
D		
1- (VENT CENTERLINE HEIGHT)	WITH CARO	
*ADD 18" W/ OPT. HEARTH	SEAL ARCHITECT	
TOP 40" SIDE 26-7/8"		
TOP ONLY 47-1/16"	6 SEAL	
TOP 40"	14048r	
SIDE 23-1/2" SEE MANUFACTURER'S SPECS	ARCHITECT	
SEE MANUFACTURER'S SPECS	THE WOAK SZUMM	
SEE MANUFACTURER'S SPECS		
TOP ONLY 46-1/2"	The Drees Company	
IVI VINLI 40-1/2	11/08/2024 9:46:27 AM	
SCALE: VARIES		Sheet No.
		F-1

## RALEIGH WINDOW SCHEDULE

Drees General	Window Type	MI Window: Capitol				Drees General				
Callout	window rype	Call No.	Rough Opening	Call No.	Rough Opening	Callout	Call No.	Rough Opening	Call No.	Rough Openin
1660	SINGLE/DOUBLE HUNG SINGLE/DOUBLE HUNG	CW3500 1/8 x 6/0 CW3500 1/8 x 7/0 CW3500 1/8 x 6/0	20" x 60-1/4"							
1670 1860	SINGLE/DOUBLE HUNG	CW3500 1/8 x 7/0	20" x 60-1/4"							
2030	SINGLE/DOUBLE HUNG	CW3500 2/0 x 3/0	24" x 36"							
2040 2050	SINGLE/DOUBLE HUNG SINGLE/DOUBLE HUNG	CW3500 2/0 x 4/0 CW3500 2/0 x 5/0	24" x 48" 24" x 60-1/4"		<u>├</u> ────┤					
2060	SINGLE/DOUBLE HUNG	CW3500 2/0 x 6/0	24" x 72"							
2070 2430	SINGLE/DOUBLE HUNG SINGLE/DOUBLE HUNG	CW3500 2/0 x 7/0 CW3500 2/4 x 3/0	24" x 84"							
2430	SINGLE/DOUBLE HUNG	CW3500 2/4 x 3/0 CW3500 2/4 x 4/0	28" x 48"							
2450	SINGLE/DOUBLE HUNG SINGLE/DOUBLE HUNG	CW3500 2/4 x 5/0	28" x 60-1/4"							
2460 2830	SINGLE/DOUBLE HUNG SINGLE/DOUBLE HUNG	CW3500 2/4 x 6/0 CW3500 2/8 x 3/0	28" x 72" 32" x 36"							
2840	SINGLE/DOUBLE HUNG	CW3500 2/8 x 4/0	32" x 48"							
2850	SINGLE/DOUBLE HUNG	CW3500 2/8 x 5/0	32" x 60-1/4"							
2860 3030	SINGLE/DOUBLE HUNG SINGLE/DOUBLE HUNG	CW3500 2/8 x 6/0 CW3500 3/0 x 3/0	32 x 72							
3040	SINGLE/DOUBLE HUNG	CW3500 3/0 x 4/0	36-1/4" x 48"							
3050 3060	SINGLE/DOUBLE HUNG SINGLE/DOUBLE HUNG	CW3500 3/0 x 5/0 CW3500 3/0 x 6/0	<u>36-1/4" x 60-1/4"</u>		-					
3070	SINGLE/DOUBLE HUNG	CW3500 3/0 x 7/0	36-1/4" x 84"							
3470	SINGLE/DOUBLE HUNG	CW3500 3/4 x 7/0	40" x 84"							
050 FIXED 640 FIXED		910T 5/0 x 1/0 910T 4/0 x 1/8	59-5/8" x 11-1/2" 47-1/4" x 19-1/2"		┼───┤┠					-
2020 FIXED		CW3500 2/0 x 2/0	47-1/4" x 19-1/2" 24" x 24" (0 24" x 36"							
2030 FIXED 2040 FIXED		CW3500SL 2/0 x 3, CW3500SL 2/0 x 4,	<u>/0 24" x 36"</u>							
2040 FIXED		CW3500SL 2/0 x 4,	/0 24" x 60-1/4"		<u> </u>					
2816 FIXED		910TSL 2/6 x 1/8	29-1/4" x 19-1/2"							
2860 FIXED 3016 FIXED		CW3500 3/0 x 6/0 910TSL 3/0 x 1/8	36" x 72" 35-1/4" x 19-1/2"							
020 FIXED		910TSL 3/0 x 2/0	35-1/4" x 23-1/2"							
030 FIXED		CW3500P 3/0 x 3/0	) 36-1/4" x 36"							
3040 FIXED 3050 FIXED		CW3500P 3/0 x 4/0 CW3500P 3/0 x 5/0	) 36-1/4 x 48 ) 36-1/4" x 60-1/4"							
3060 FIXED		CW3500P 3/0 x 6/0	) 36-1/4" x 72"							
3070 FIXED 4010 FIXED		CW3500P 3/0 x 7/0 910T 4/0 x 1/0	) 36-1/4" x 84" 47-1/4" x 11-1/2"							
4020 FIXED		910T 4/0 x 2/0	47-1/4" x 23-1/2" 48" x 36"							
4030 FIXED		CW3500P 4/0 x 3/0	) 48" x 36"							
4040 FIXED 4044 FIXED		CW3500P 4/0 x 4/0 CW3500P 4/0 x 4/4	1 48 x 48							
4050 FIXED		CW3500P 4/0 x 5/0	) 48" x 60-1/4"							
4060 FIXED 4070 FIXED		CW3500P 4/0 x 6/0 CW3500P 4/0 x 7/0	) 48" x 72" ) 48" x 84"							
5030 FIXED		CW3500P 5/0 x 3/0	) 60" x 36"							
5040 FIXED		CW3500P 5/0 x 4/0	) 60" x 48"							
5060 FIXED 5070 FIXED		CW3500P 5/0 x 6/0 CW3500P 5/0 x 7/0	) 60" x 84"							
6020 FIXED		910T 6/0 x 2/0	71-5/8" x 23-1/2" 72" x 60-1/4"							
6050 FIXED 6060 FIXED		CW3500P 6/0 x 5/0 CW3500P 6/0 x 6/0	) 72" x 60-1/4"							
3'-0" HALF ROUNE	)	CW3500 3/0 HC	36-1/4"							
1'-0" HALF ROUNE	<u> </u>	CW3500 3/0 HC	48"							
5'-0" HALF ROUNE 2020 OCTAGON	<i>,</i>	CW3500 3/0 HC CW3500 2/0 OCT	60" 24"		<u>                                     </u>					
2'-4" QUARTER RC		CW3500 2/4 QC	28"							
5'-0" QUARTER RC	)UND	CW3500 3/0 QC	36-1/4"							
					┼────┤┃					
RKA	<u>^^</u>	Drees Ho	mes	Sheet Description:						Sheet N
Dre		7701 Six Forks Road, Suite 132, Raleigh, NC 2	7615 PH:(919) 844-9288	WINDOW SO	CHEDULE					
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2_2	OMES <sub>SM</sub> of the Drees Co	mpany. The Drees Company will vigorously pro-	ecute any unauthorized use of this ma	erial.						

### \* MEETS EMERGENCY ESCAPE & RESCUE OPENING REQUIREMENTS

# MOULDED MILLWORK SCHEDULE

ARCHED HEADER D1KHARCHED HEADER D2HARCHED HEADER D2KHARCHED HEADER D3AARCHED HEADER D3AARCHED HEADER D3KNARCHED HEADER D4KAARCHED HEADER D4KAARCHED HEADER D5AARCHED HEADER D5AARCHED HEADER D6AARCHED HEADER D6AARCHED HEADER D6KAARCHED HEADER D7KHARCHED HEADER D8AARCHED BEADER D8AARCHED HEADER D8ACROSSHEAD A1HCROSSHEAD B1HCROSSHEAD B2HCROSSHEAD B2HCROSSHEAD C2HCROSSHEAD C2HCROSSHEAD C2HCROSSHEAD Z-E3-HDRZCROSSHEAD Z-E3-HDRHWINDOW HEADER B1HWINDOW HEADER C1KH <t< th=""><th>BxxEFR BxxEFR BxxEFTR BxxEFTR BxxEFTR BxxEFTR BxxEFTR BxxEFTR BxxEFR R10xx R10xx R10xx R10xxCC R10xxCC 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BxxEFR BxxEFTR BxxEFTR BxxEFTR BxxEFTR BxxEFTR BxxEFTR BxxEFR R10xx R10xx R10xx R10xxCC R10xxCC 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CROSSHEAD C2HCROSSHEAD C2KHCROSSHEAD Z-E1-HDRZCROSSHEAD Z-E2-HDRZCROSSHEAD Z-E3-HDRZCROSSHEAD Z-E3-ARCHHDRZCROSSHEAD Z-E3-CLHDRZCROSSHEAD Z-E5-HDRZWINDOW HEADER A1HWINDOW HEADER A1HWINDOW HEADER B1HWINDOW HEADER B1HWINDOW HEADER B1HWINDOW HEADER C1HWINDOW HEADER C1HWINDOW HEADER C2HWINDOW HEADER C2HWINDOW HEADER C2HWINDOW HEADER C3HWINDOW HEADER C3H	18xxBT-PA 18xxBTK-PA E1-HDR E2-HDR E3-HDR E3-ARCHHDR E3-CLHDR E5-HDR 6xx 6xxK 6xxK 9xx-2 9xx-2K 9xxBT	LDCHxxX18 LDCHxxX18K Z-E1-HDR Z-E2-HDR Z-E3-HDR Z-E3-ARCHHDR Z-E3-CLHDR Z-E5-HDR WCHxxX6 WCHxxX6K WCHxxX6K WCHxxX9N WCHxxX9N
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CROSSHEAD Z-E1-HDRZ-CROSSHEAD Z-E2-HDRZ-CROSSHEAD Z-E3-HDRZ-CROSSHEAD Z-E3-ARCHHDRZ-CROSSHEAD Z-E3-CLHDRZ-CROSSHEAD Z-E5-HDRZ-CROSSHEAD Z-E5-HDRZ-WINDOW HEADER A1HWINDOW HEADER A1HWINDOW HEADER B1HWINDOW HEADER B1HWINDOW HEADER B1HWINDOW HEADER B1HWINDOW HEADER C1HWINDOW HEADER C1HWINDOW HEADER C2HWINDOW HEADER C2HWINDOW HEADER C3HWINDOW HEADER C3H	E1-HDR E2-HDR E3-HDR E3-ARCHHDR E3-CLHDR E5-HDR 6xx 6xx 6xx 6xx 9xx-2 9xx-2 9xx-2K 9xxBT	Z-E1-HDR Z-E2-HDR Z-E3-HDR Z-E3-ARCHHDR Z-E3-CLHDR Z-E5-HDR WCHxXX6 WCHxXX6K WCHxXX6K WCHxXX9N WCHxXX9N
CROSSHEAD Z-E2-HDRZ-CROSSHEAD Z-E3-HDRZ-CROSSHEAD Z-E3-ARCHHDRZ-CROSSHEAD Z-E3-CLHDRZ-CROSSHEAD Z-E5-HDRZ-WINDOW HEADER A1HWINDOW HEADER A1KHWINDOW HEADER B1HWINDOW HEADER B1HWINDOW HEADER B2HWINDOW HEADER B2KHWINDOW HEADER C1HWINDOW HEADER C1HWINDOW HEADER C2HWINDOW HEADER C2HWINDOW HEADER C3HWINDOW HEADER C3H	E2-HDR E3-HDR E3-ARCHHDR E3-CLHDR E5-HDR 6xx 6xx 6xx 6xx 9xx-2 9xx-2 9xx-2K 9xxBT	Z-E2-HDR Z-E3-HDR Z-E3-ARCHHDR Z-E3-CLHDR Z-E5-HDR WCHxXX6 WCHxXX6K WCHxXX6K WCHxXX9N WCHxXX9N
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WINDOW HEADER A1KHWINDOW HEADER B1HWINDOW HEADER B1KHWINDOW HEADER B2HWINDOW HEADER B2KHWINDOW HEADER C1HWINDOW HEADER C1KHWINDOW HEADER C2HWINDOW HEADER C2KHWINDOW HEADER C3HWINDOW HEADER C3KH	6xxK 9xx-2 9xx-2K 9xxBT	WCHxxX6K WCHxxX9N WCHxxX9NK
WINDOW HEADER B1HWINDOW HEADER B1KHWINDOW HEADER B2HWINDOW HEADER B2KHWINDOW HEADER C1HWINDOW HEADER C1KHWINDOW HEADER C2HWINDOW HEADER C2KHWINDOW HEADER C3HWINDOW HEADER C3KH	9xx-2 9xx-2К 9xxBT	WCHxxX9N WCHxxX9NK
WINDOW HEADER B2HWINDOW HEADER B2KHWINDOW HEADER C1HWINDOW HEADER C1KHWINDOW HEADER C2HWINDOW HEADER C2KHWINDOW HEADER C3HWINDOW HEADER C3KH	9xxBT	
WINDOW HEADER B2K       H         WINDOW HEADER C1       H         WINDOW HEADER C1K       H         WINDOW HEADER C2       H         WINDOW HEADER C2       H         WINDOW HEADER C2K       H         WINDOW HEADER C3       H         WINDOW HEADER C3K       H		WCHYYX10NBT
WINDOW HEADER C1 H WINDOW HEADER C1K H WINDOW HEADER C2 H WINDOW HEADER C2K H WINDOW HEADER C3 H WINDOW HEADER C3K H	9xxBTK	W CHANNION DI
WINDOW HEADER C1K H WINDOW HEADER C2 H WINDOW HEADER C2K H WINDOW HEADER C3 H WINDOW HEADER C3K H		WCHxxX10NBTK
WINDOW HEADER C2 H WINDOW HEADER C2K H WINDOW HEADER C3 H WINDOW HEADER C3K H	9xx	CCAxxX10
WINDOW HEADER C2K H WINDOW HEADER C3 H WINDOW HEADER C3K H	9xxK	CCAxxX10K
WINDOW HEADER C3 H WINDOW HEADER C3K H	9xxT	WCHxxX9T
WINDOW HEADER C3K H	9xxTK	WCHxxX9TK
	12xxBT 12xxBTK	WCHxxX10BT WCHxxX10BTK
	14xxBT	WCHXXX10BIK WCHXXX14BT
	7xxF-4	N/A
	7xxF-4K	N/A
	9xxK-1	N/A
	W1	Z-W1
	W3	Z-W3
WINDOW HEADER Z-W3K Z-	W3K	Z-W3K
WINDOW HEADER Z-W3D Z-	W3D	Z-W3D
	W4	Z-W4
WINDOW HEADER Z-W4K Z-	W4K	Z-W4K

	PILASTERS			
Drees General Callout	Nuwood		Fypon	Drees Gene
FLUTED PILASTER A1	PL7xxF	PIL7Xxx		BAND MOULD [
FLUTED PILASTER B1	PL9xxF	PIL9Xxx		BAND MOULD
FLUTED PILASTER C1	PL11xxFM	PIL11Xxx		BARGE MOULD
PANEL PILASTER A2	PL7xxP	PIL7XxxDP		CASE MOULD D
PANEL PILASTER B2	PL9xxP	PIL9XxxDP		CASE MOULD D
PANEL PILASTER C2	PL11xxPM	PIL11XxxDP		CROWN MOUL
PILASTER D1	M311-9	PIL10XxxA		DENTIL MOULD
PILASTER D2	M323-9	N/A		DENTIL MOULD
PILASTER Z-E1-PIL	Z-E1-PIL	Z-E1-PIL		HALF ROUND M
PILASTER Z-E2-PIL	Z-E2-PIL	Z-E2-PIL		PANEL MOULD
PILASTER Z-E3-PIL	Z-E3-PIL	Z-E3-PIL		
PILASTER Z-PIL-EXT	Z-PIL-EXT	Z-PIL-EXT		
PLAIN PILASTER A3	PL7xxS	PIL7XxxP		
PLAIN PILASTER B3	PL9xxS	PIL9XxxP		
PLAIN PILASTER C3	PL11xxS	PIL11XxxP		Drees Gene
PLINTH D1	PF10		END OF PILASTER	BROW COMBO
PLINTH D2	P14.5	N/A		PEAK PEDIMENT
	LOUVERS			PEAK PEDIMENT
	LOOVERS			PEAKED COMB
Drago Constal Callout	bluu vo o ol	Evinon		RAMS HEAD PE
Drees General Callout	Nuwood	Fypon	Mid-America	ROUND PEDIME
CATHEDRAL LOUVER D1	CLV1224	CLV12X24		SUNRISE COMB
CATHEDRAL LOUVER D1T	CLV1224TRIM4	CLV12X24X4F		VICTORIAN PED
CATHEDRAL LOUVER D2	CLV1432	CLV14X32		
CATHEDRAL LOUVER D2T	CLV1432TRIM4	CLV14X32X4F	00 44 1422	
CATHEDRAL LOUVER D21	CLV14321KI/04 CLV2232	CLV22X32	<u> </u>	
CATHEDRAL LOUVER D3T	CLV2232TRIM4	CLV22X32X4F		Drees Gene
HALF CIRCLE LOUVER D1	HRLV32	HRLV32X16		
HALF CIRCLE LOUVER D1T	HRLV32TRIM4	HRLV32X4F		HALF CIRCLE SU
HALF CIRCLE LOUVER D2	HRLV36	HRLV36X18		PALLADIAN WIN
HALF CIRCLE LOUVER D2T	HRLV36TRIM4	HRLV36X4F	00 43 2234	PALLADIAN WIN
OCTAGONAL LOUVER D1	OLV24	OLV24		PALLADIAN WIN
OCTAGONAL LOUVER D12	OLV24TRIM4	OLV24X4F		
OVAL LOUVER D1	OLV2537	OLV37X25		PALLADIAN WIN
OVAL LOUVER DIT	OLV2537TRIM4	OLV37X25X4F		
	LV1224V	LV12X24		
RECTANGUAR LOUVER D1			00 45 1218	PEAKED CAP HE
RECTANGUAR LOUVER D1T	LV1224VTRIM4	LV12X24-4F	00 45 1218	PLAIN SEGMEN
RECTANGUAR LOUVER D2	LV1636V	LV16X36		SEGMENT SUNB
RECTANGUAR LOUVER D2T	LV1636VTRIM4	LV16X36-4F		
RECTANGUAR LOUVER D3	LV2436V	LV24X36		
RECTANGUAR LOUVER D3T	LV2436VTRIM4	LV24X36-4F		
RECTANGUAR LOUVER D4	LV2424V	LV24X24		
RECTANGUAR LOUVER D4T	LV2424VTRIM4	LV24X24-4F		Drees Gene
ROUND LOUVER D1	RLV18	RLV18		GABLE D1
ROUND LOUVER DIT	RLV18TRIM4	RLV18X4F	<u>+</u>	KEYSTONE D1
ROUND LOUVER D2	RLV22	RLV22		KEYSTONE D2
				WREATH D1
ROUND LOUVER D2T	RLV22TRIM4	RLV22X4F		WREATH DI
TRIANGULAR LOUVER D1		TRLVxxX36	00 47 0x0x	
	BRACKETS			
				1
Droop Conoral Callout	Numerad		Fypon	
Drees General Callout	Nuwood			1
EXTERIOR BRACKET D1	BR437	N/A		
EXTERIOR BRACKET D2	DB102	DTLB6X4X6		
EXTERIOR BRACKET D3	BR304 (7" WIDE)	BKT24X24X7	,	
EXTERIOR BRACKET D3	BR455	N/A		1
	BR300-1	BKT12X12X6		1
EXTERIOR BRACKET D5			)	1
EXTERIOR BRACKET D6	BR300	BKT12X12		
EXTERIOR BRACKET D7	BR409	BKT16X18X3	5	
EXTERIOR BRACKET D8	BR413	DTLB5X5X3		
EXTERIOR BRACKET D9	TBD	BKT11X20		
EXTERIOR BRACKET D10	TBD	BKT12X24X3	3	
EXTERIOR BRACKET D11	BR435	BKT25X27		
EXTERIOR BRACKET D12	BR404	BKT16X30X4	<u> </u>	
EXTERIOR BRACKET D13	BR23.13x10.13x5.5	N/A		
GABLE BRACKET D1	TBD			
				1
GABLE BRACKET D2	BR423-x:12	BKT5X20		1
GABLE BRACKET D3	BR424-x:12	BK15X20 (C	UT 2" PROJECTION)	



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Sheet Description:

MOULDED MILLWORK SCHEDULE

LAST REVISED 11/22/17

### MOULDINGS

Drees General Callout	Nuwood	Fypon
BAND MOULD D1	M210-16	MLD612-12
BAND MOULD D2	M301-16	MLD220-16
BARGE MOULD D1	WM210	WM210
CASE MOULD D1	M320-16	MLD226-16
CASE MOULD D2	N/A	MLD244-12
CROWN MOULD D1	M404-16	MLD572-16
DENTIL MOULD D1	M105-16	MLD310-16
DENTIL MOULD D2	M108-8	MLD353-8
HALF ROUND MOULD D1	N/A	MLD605-12
PANEL MOULD D1	M310-8 OR 16	MLD612-12

### PEDIMENTS / COMBO HEADERS

Drees General Callout	Nuwood	Fypon
BROW COMBO D1	BCxx	CSAPxx
PEAK PEDIMENT D1	Pxx-4 (6:12)	PCPxx
PEAK PEDIMENT Z-E1-PED	Z-E1-PED	Z-E1-PED
PEAKED COMBO D1	PCxx-4	СРСРхх
RAMS HEAD PEDIMENT D1	Rxx	RHPxx00
ROUND PEDIMENT D1	Bxx-4	PSPxx
SUNRISE COMBO D1	SCxx-4	CSPxx
VICTORIAN PEDIMENT D1	VPxx	DVPxx w/ SWDHxxXxx

WINDOW DECORATION				
Drees General Callout	Nuwood	Fypon		
HALF CIRCLE SUNBURST D1	SPxxxx	SWDHxxXxx		
PALLADIAN WINDOW D1	H9AR10-xx xx' FL/FR	ARxxX10MFLxxx		
PALLADIAN WINDOW D1K	H9AR10-xxK xx'' FL/FR	ARxxX10MFLxxx with K10TM		
PALLADIAN WINDOW D2	H9AR10SPxxxx	ARxxX10MFLxxx with		
		SWDHxxXxx		
PALLADIAN WINDOW D2K	H9AR10SPxxxxK	ARxxX10MFLxxx with		
		SWDHxxXxx and K10TM		
PEAKED CAP HEADER D1	N/A	CHPCxxX15		
Plain Segment D1	SPxxxxP	PSPxx		
SEGMENT SUNBURST D1	SPxxxx	SWDHxxXxx		

	ACCESSORIES	
Drees General Callout	Nuwood	Fypon
GABLE D1	PGDx12	GPA (width X height)
(EYSTONE D1	KY14F-3	KY14
CEYSTONE D2	КҮНМ9F	K9M
WREATH D1	N/A	WAB34

Sheet No.

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