THIS PLAN HAS BEEN DRAWN TO CONFORM TO THE 2018 NORTH CAROLINA RESIDENTIAL CODE

CONTRACTOR SHALL VERIFY ALL DIMENSIONS AND CONDITIONS PRIOR TO BEGGINING WORK. CONTRACTOR IS RESPONSIBLE FOR COMPLIANCE WITH ALL STATE AND LOCAL BUILDING CODES AND ORDINANCES. KADS CUSTOM HOME DESIGNS ASSUMES NO LIABILITY FOR SITE CONDITIONS, CONSTRUCTION METHODS


NO LIABILITY FOR SITE CONDITIONS, COOR ANY DEVIATION OF THESE PLANS.

NOTE


ALL WINDOWS TO BE INSTALLED MUST MEET
A MAXIMUM OF .32 U VALUE OR BETTER, UNLESS
ENERGY CALCULATIONS ARE SUBMITTED WITH PLANS
PROVIDED BY BUILDER AT TIME OF PLAN REVIEW.




FRONT ELEVATION SCALE: 1/4"=1'-0"

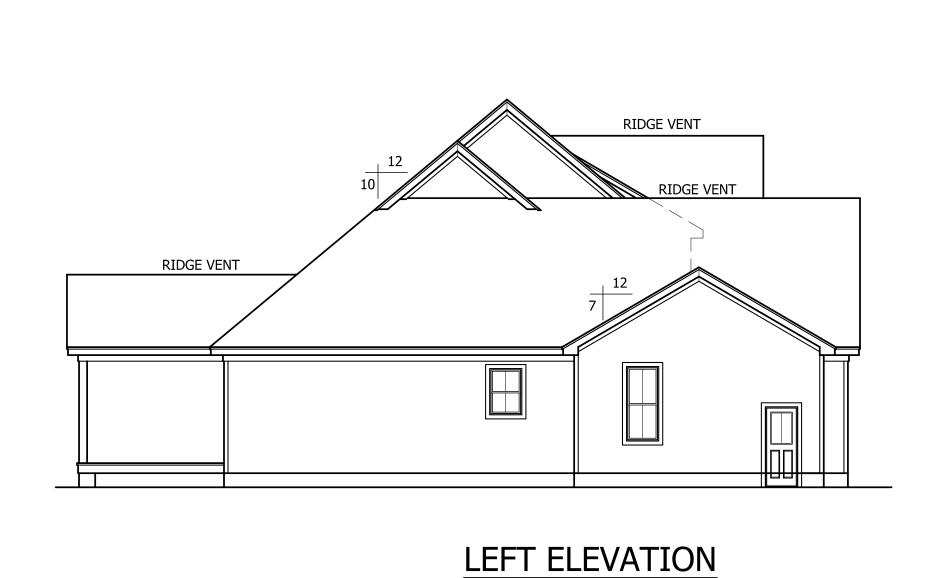

SCALE: 1/8"=1'-0"

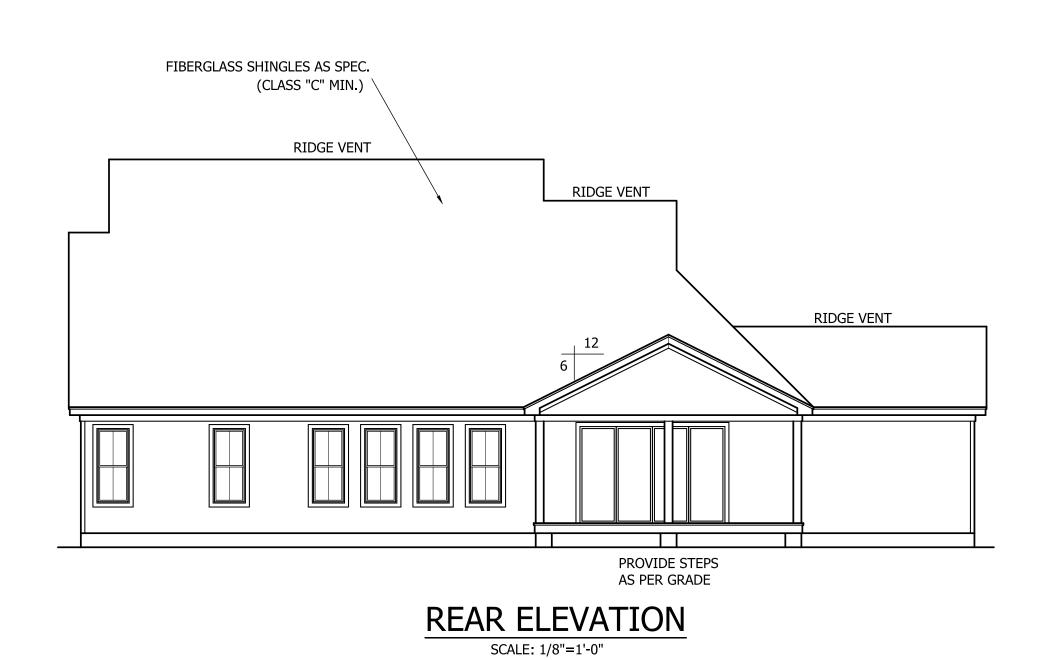


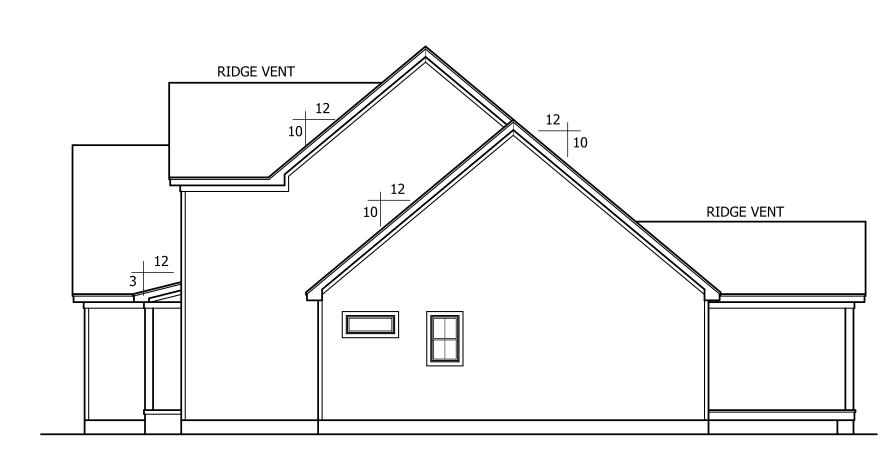

RIGHT ELEVATION

SCALE: 1/8"=1'-0"

STEPHENSON BUILDERS, LOT 14 LANE FARMS

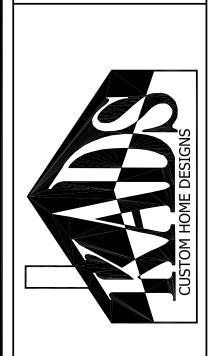

ANGIER, NC 919-369-7181

> DRAWN BY: D.W.O.

DATE: 11/27/24

PAGE NO

1OF

4

PLAN NO. DK3199

ARMS STEPHENS



ANGIER, NC 919-369-7181

DRAWN BY: D.W.O.

DATE: 11/27/24


PAGE NO

OF

PLAN NO. DK3199

= 844

GARAGE SQ. FT.

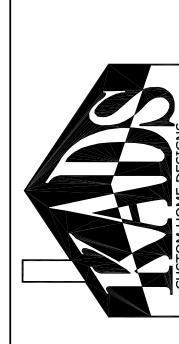

ANGIER, NC 919-369-7181

DRAWN BY:

DATE: 11/27/24

PAGE NO

3

4


OF

SECOND FLOOR PLAN

SCALE: 1/4"=1'-0"
9'-0" CLG. HGT.

PLAN NO.
DK3199



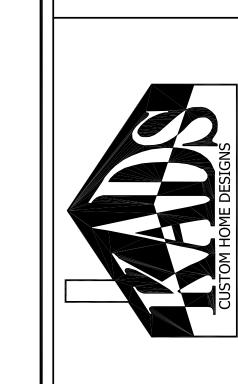

FIRESTOPPING:

handrail height and below the required headroom height.

on either side of the stairway and the minimum clear width

of the stairway at and below the handrail height, including

treads and landings, shall not be less than 31-1/2 inches where

Stairways shall not be less than 36 inches

in clear width at all points above the permitted

Handrails shall not project more than 4.5 inches

a handrail is installed on one side and 27 inches

where handrails are provided on both sides

STAIR DETAIL

ANGIER, NC 919-369-7181


DRAWN BY: D.W.O.


DATE: 11/27/24

PAGE NO

OF

PLAN NO. DK3199

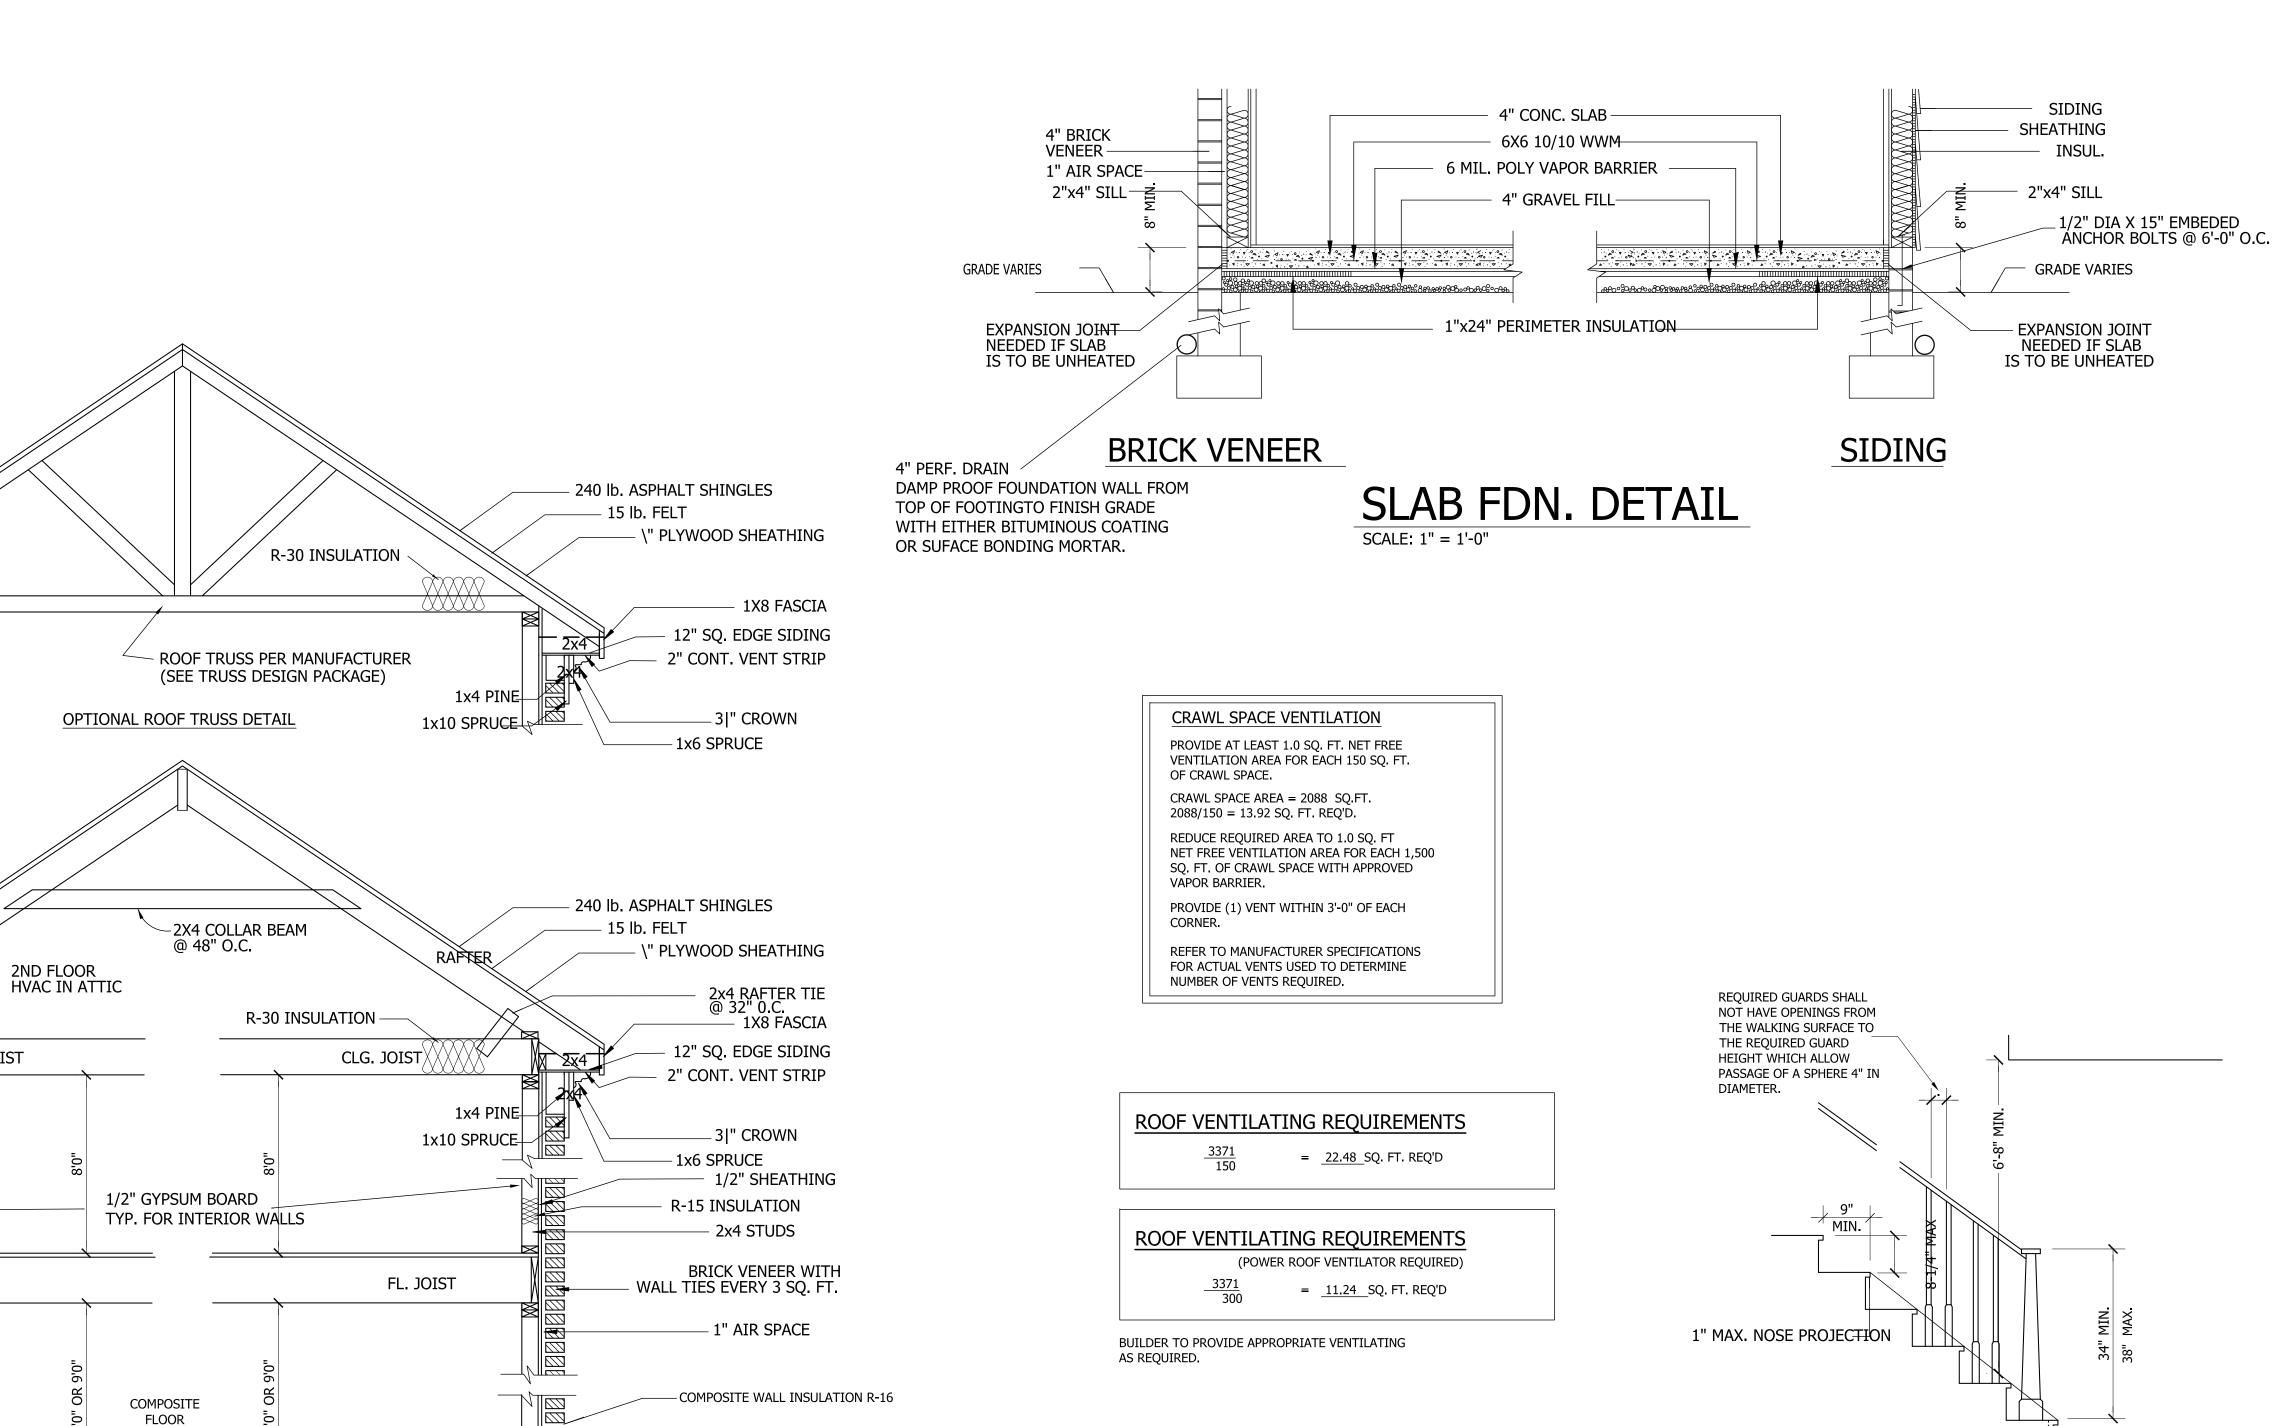

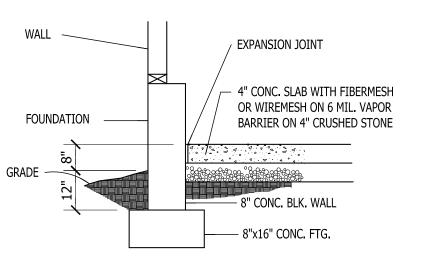

GARAGE SLAB

WALL SECTION SCALE: \" = 1'-0"

INSULATION R-20 —

R-19 INSULATIQN

- GIRDER

FL. JOIST

1ST FLOOR HVAC IN CRAWL SPACE

(MIN. 22" CLEARANCE)

BRICK SECTION

TREATED SILL

CORBEL BRICK

8" SOLID CAP

- CONC. BLOCK

AS SHOWN BELOW

- SUBFLOOR

- FINISH FLOOR

- 2 X BAND

WEEP HOLES 48" O.C.

— 30# FELT OR FLASHING UP 6" BEHIND SHEATHING

1/2" DIA X 15" EMBEDED ANCHOR BOLTS @ 6'-0" O.C.

4" PERF. DRAIN

DAMP PROOF FOUNDATION WALL FROM

TOP OF FOOTINGTO FINISH GRADE

OR SUFACE BONDING MORTAR.

WITH EITHER BITUMINOUS COATING

240 lb. ASPHALT SHINGLES

240 lb. ASPHALT SHINGLES

\" PLYWOOD SHEATHING_

15 lb. FELT

\" PLYWOOD SHEATHING_

1x8 FASCIA

3|" CROWN

2x4 RAFTER TIE @ 32" O.C.

12" SQ. EDGE SIDING -

2" CONT. VENT STRIP

1x8 FASCIA

3|" CROWN

SIDING-

1/2" SHEATHING-

2x4 STUDS -

SUBFLOOR -

2 X BAND

FINISH FLOOR

FINISH GRADE -

1/2" DIA X 15" EMBEDED ANCHOR BOLTS @ 6'-0" O.C.

12" SQ. EDGE SIDING

2" CONT. VENT STRIP

15 lb. FELT

-1x10 SPRUCE

CLG. JOIST

-1x10 SPRUCE

FL. JOIST

FL. JOIST

3" MIN. PROJECTION MAX. - THICKNESS OF


FOOTING

SIDING SECTION

TREATED SILL

- 8" SOLID CAP FOR 2 STORY

4" SOLID CAP FOR 1 STORY

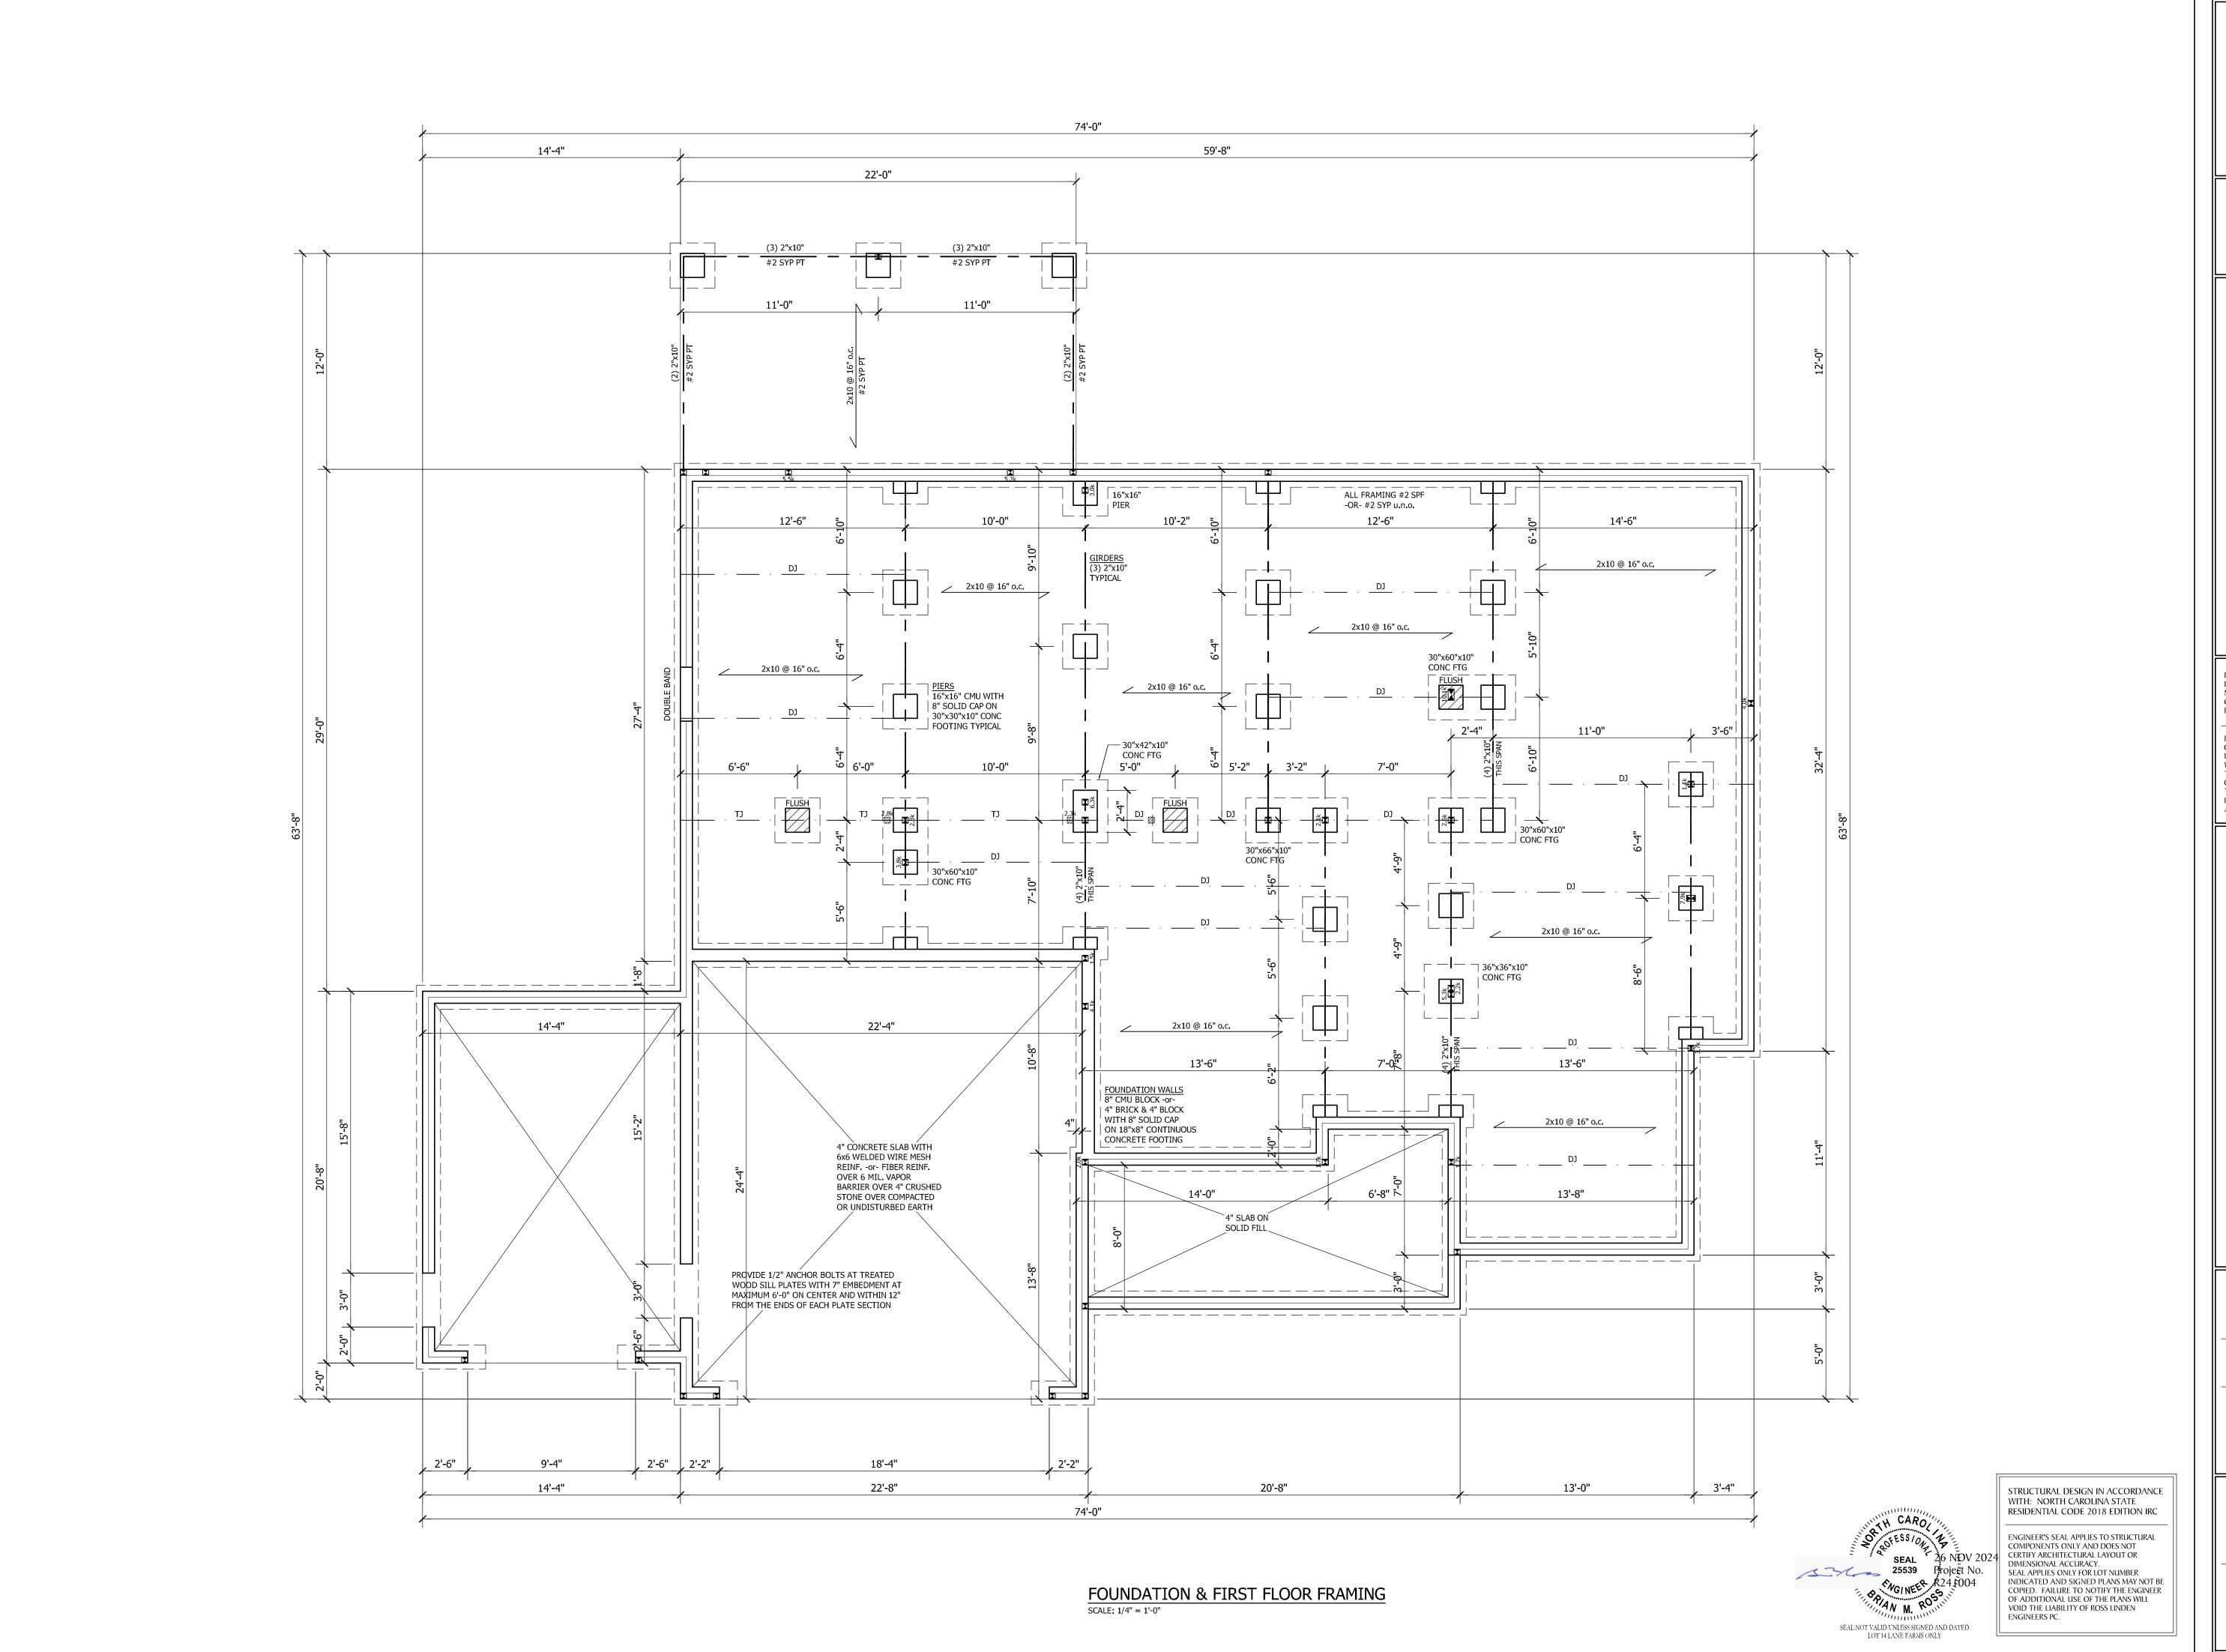



709 W. JONES STREET RALEIGH, NC 27603 TEL 919.832.5680 FAX 919.832.5675 WWW.ROSSLINDEN.COM

> SS LINDEN INEERSPC

ROSS LINDEN ENGINEERS PC ASSUMES NO LIABILITY FOR CHANGES OR MODIFICATIONS MADE TO THESE PLANS BY OTHERS, OR FOR CONSTRUCTION METHODS, OR FOR ANY DEVIATION FROM THESE PLANS.

PLAN ENGINEERING REMAINS THE PROPERTY OF ROSS LINDEN ENGINEERS PC AND ANY UNAUTHORIZED USE OR DUPLICATION IN WHOLE OR PART IS STRICTLY PROHIBITED. THESE DRAWINGS ARE OFFERED TO THE CLIENT FOR A CONDITIONAL ONE TIME USE. THE CONDITIONAL USE IS LIMITED TO THE LOT OR PROPERTY AS SPECIFIED HEREIN, AND ONLY FOR THE SAID LOCATION.

STEPHENSON BUILDERS LOT 14 LANE FARMS

PROJECT NO. R241004

DESIGN BY LLR
27 NOV 2024

DATE

REVISION
-

FOUNDATION & FIRST FLOOR

SHEET NO.

OF S5

WALL BRACING NOTES:

WALL BRACING SHALL BE IN ACCORDANCE WITH SECTION R602.10.3
CONTINUOUS SHEATHING. BRACING METHOD CS-WSP SHALL BE USED IN
ACCORDANCE WITH TABLE R602.10.1.

THE REQUIRED LENGTH OF BRACING FOR EACH SIDE OF A RECTANGLE CIRCUMSCRIBED AROUND THE PLAN OR A PORTION OF THE PLAN AT EACH STORY LEVEL SHALL BE IN ACCORDANCE WITH TABLE R602,10.3 AND FIGURE R60.10.3(1). UNLESS NOTED OTHERWISE, THE ENTIRE STRUCTURE IS ASSUMED TO CIRCUMSCRIBED WITHIN A SINGLE

MINIMUM PANEL WIDTH IS 24". SEE SECTION R602.10.3 FOR ADDITIONAL INFORMATION. CONNECTION CRITERIA SHALL BE IN ACCORDANCE WITH TABLE R602.10.1. PORTAL FRAME CONSTRUCTION SHALL BE IN ACCORDANCE WITH FIGURE R602.10.1

HOLD DOWN DEVICE SHALL BE AS FOLLOWS: SIMPSON LSTA24 STRAP (OR EQUIVALENT) BETWEEN FLOORS EXTENDING FROM BOTTOM OF FLOOR BAND UP STUDS WHERE SHOWN. SIMPSON HD3B HOLDOWN (OR EQUIVALENT) WHERE REQUIRED TO CONNECT DIRECTLY TO FOUNDATION.

WIND SPEED: 115 mph

EAVE TO RIDGE HEIGHT: 10.83 ft

FIRST FLOOR:

SHORT SIDE LENGTH OF CIRCUMSCRIBED RECTANGLE: 51.67 ft REQUIRED LENGTH OF BRACING = 13.1 ftPROVIDED LENGTH OF BRACING = $\frac{25.33 \text{ ft}}{}$

LONG SIDE LENGTH OF CIRCUMSCRIBED RECTANGLE: 74.0 ft REQUIRED LENGTH OF BRACING = 18.2 ftPROVIDED LENGTH OF BRACING = $\overline{37.33}$ ft

(2) 2"x10" CONTINUOUS 2x6 @ 16" o.c. 2x6 @ 16" o.c. (2) 1 3/4" x 16" LVL SET FLUSH w/ JOIST 11'-6" 11'-0" 20'-4" 14'-6" 2x10 @ 16" o.c. - JOISTS CANTILEVER OVER LOAD BEARING WALL - DO NOT ATTACH TO BEAM (2) 9 1/4" LVL (2) <u>1 3/4" x 9 1/4" LVL</u> / 2x10 @ 16" 16" LPI 42Plus @ 16" o.c. 2x10 @ 16" o.c. 2x8 @ 16" o.c. 2x10 @ 16" o.c. 16" LPI 42Plus @ 16" o.c. (2) 1 3/4" x 11 7/8" LVL (2) 1 3/4" x 14" LVL — EXTEND HEADER AND PROVIDE CS-PF PORTAL FRAME BOTH

FRAMING NOTES

1. STRUCTURAL NOTES SHEET S5.

2. FRAMING SHALL BE #2 SPF OR #2 SYP OR BETTER WITH A MINIMUM Fb = 800 psi

3. EXTERIOR AND BEARING HEADERS (2) 2"x10" u.n.o.

4. ■ DENOTES POINT LOAD. SEE CONSTRUCTION NOTE #4 ON S5.

FRAMING SYSTEM
JOIST LAYOUT AND PLACEMENT BY MANUFACTURER TO COINCIDE WITH THE SUPPORT LOCATIONS SHOWN. JOISTS SHALL BE DESIGNED FOR MAXIMUM L/480 LIVE LOAD DEFLECTION, JOIST LAYOUT SHALL BE PROVIDED FOR REVIEW AND COORDINATED WITH THE ENGINEER OF RECORD. INSTALLATION SHALL BE IN ACCORDANCE WITH THE MANUFACTURER'S INSTRUCTIONS.

EXTEND HEADER AND PROVIDE CS-PF PORTAL FRAME PANEL PER FIG. R602.10.1. PROVIDE LSTA24 STRAP (OR EQUIVALENT) EACH SIDE AS SHOWN. FASTEN SHEATHING TO HEADER AND WALL FRAMING (EACH STUD) WITH 8d NAILS AT 3" o.c. AS SHOWN, SEE FIG. R602.10.1 FOR ADDITIONAL REQUIREMENTS. SEE SHEET S5



STRUCTURAL DESIGN IN ACCORDANCE WITH: NORTH CAROLINA STATE RESIDENTIAL CODE 2018 EDITION IRC

ENGINEER'S SEAL APPLIES TO STRUCTURAL COMPONENTS ONLY AND DOES NOT CERTIFY ARCHITECTURAL LAYOUT OR DIMENSIONAL ACCURACY. SEAL APPLIES ONLY FOR LOT NUMBER INDICATED AND SIGNED PLANS MAY NOT BE COPIED. FAILURE TO NOTIFY THE ENGINEER OF ADDITIONAL USE OF THE PLANS WILL VOID THE LIABILITY OF ROSS LINDEN

709 W. JONES STREET RALEIGH, NC 27603 TEL 919.832.5680 FAX 919.832.5675 WWW.ROSSLINDEN.COM

ROSS LINDEN ENGINEERS PC ASSUMES NO LIABILITY FOR CHANGES OR MODIFICATIONS MADE TO THESE PLANS BY OTHERS, OR FOR CONSTRUCTION METHODS, OR FOR ANY DEVIATION FROM THESE PLANS.

PLAN ENGINEERING REMAINS THE PROPERTY OF ROSS LINDEN ENGINEERS PC AND ANY UNAUTHORIZED USE OR DUPLICATION IN WHOLE OR PART IS STRICTLY PROHIBITED. THESE DRAWINGS ARE OFFERED TO THE CLIENT FOR A CONDITIONAL ONE TIME USE. THE CONDITIONAL USE IS LIMITED TO THE LOT OR PROPERTY AS SPECIFIED HEREIN, AND ONLY FOR THE SAID LOCATION.

STEPHENSON BUILDERS LOT 14 LANE FARMS

PROJECT NO.

R241004

DESIGN BY LLR 27 NOV 2024

DATE REVISION

> FIRST CEILING FRAMING

SHEET NO.

OF S5

FIRST CEILING FRAMING SCALE: 1/4" = 1'-0"

ENDS. SEE NOTE ABOVE.


PER SECTION R602.10.3.2, THE AMOUNT OF BRACING PROVIDED ON THE SECOND STORY EQUALS OR EXCEEDS THE AMOUNT OF BRACING FOR THE FIRST STORY BELOW, THEREFORE A SEPARATE ANALYSIS OF SECOND STORY BRACING IS NOT REQUIRED.


FRAMING NOTES

1. STRUCTURAL NOTES SHEET S5.

2. FRAMING SHALL BE #2 SPF OR #2 SYP OR BETTER WITH A MINIMUM Fb = 800 psi

3. EXTERIOR AND BEARING HEADERS (2) 2"x10" u.n.o. 4. ■ DENOTES POINT LOAD. SEE CONSTRUCTION NOTE #4 ON S5.

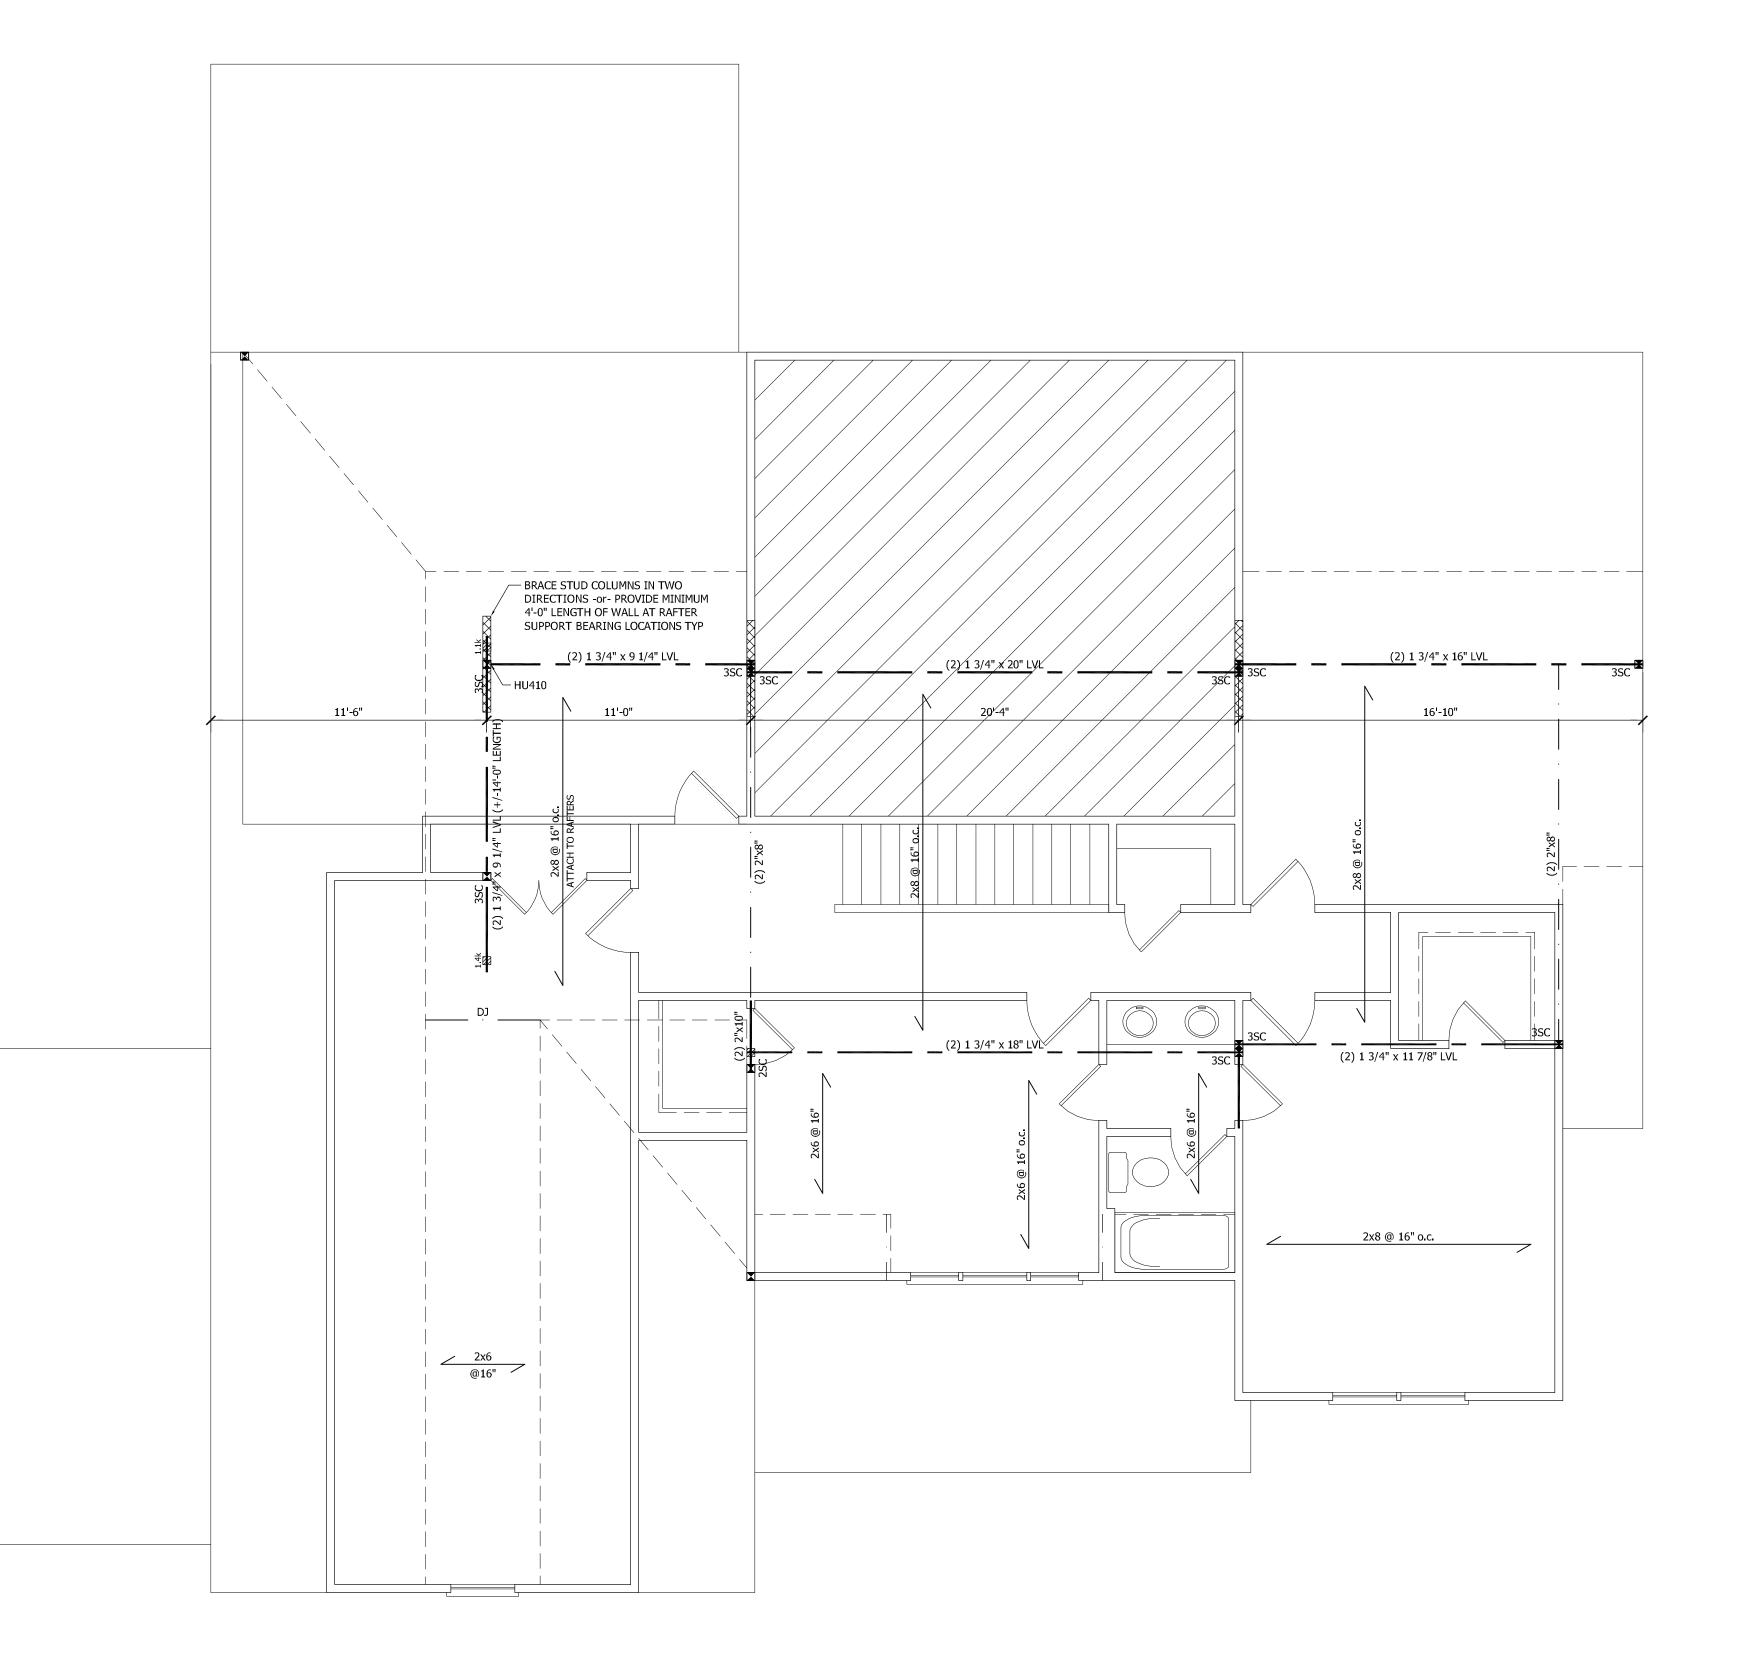

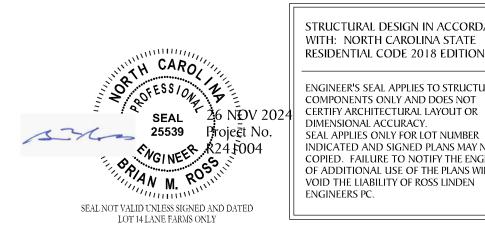

STRUCTURAL DESIGN IN ACCORDANCE WITH: NORTH CAROLINA STATE RESIDENTIAL CODE 2018 EDITION IRC ENGINEER'S SEAL APPLIES TO STRUCTURAL COMPONENTS ONLY AND DOES NOT CERTIFY ARCHITECTURAL LAYOUT OR DIMENSIONAL ACCURACY.
SEAL APPLIES ONLY FOR LOT NUMBER
INDICATED AND SIGNED PLANS MAY NOT BE COPIED. FAILURE TO NOTIFY THE ENGINEER
OF ADDITIONAL USE OF THE PLANS WILL

709 W. JONES STREET RALEIGH, NC 27603 TEL 919.832.5680 FAX 919.832.5675 WWW.ROSSLINDEN.COM

ROSS LINDEN ENGINEERS PC ASSUMES NO LIABILITY FOR CHANGES OR MODIFICATIONS MADE TO THESE PLANS BY OTHERS, OR FOR CONSTRUCTION METHODS, OR FOR ANY DEVIATION FROM THESE PLANS.

PLAN ENGINEERING REMAINS THE PROPERTY OF ROSS LINDEN ENGINEERS PC AND ANY UNAUTHORIZED USE OR DUPLICATION IN WHOLE OR PART IS STRICTLY PROHIBITED. THESE DRAWINGS ARE OFFERED TO THE
CLIENT FOR A CONDITIONAL ONE TIME USE.
THE CONDITIONAL USE IS LIMITED TO THE
LOT OR PROPERTY AS SPECIFIED HEREIN, AND ONLY FOR THE SAID LOCATION.

STEPHENSON BUILDERS LOT 14 LANE FARMS

PROJECT NO. R241004

DESIGN BY LLR 27 NOV 2024

DATE REVISION

SECOND CEILING FRAMING

OF S5

SHEET NO.

ROOF FRAMING NOTES

1. STRUCTURAL NOTES SHEET S5.

2. FRAMING SHALL BE #2 SPF OR #2 SYP OR BETTER WITH A

MINIMUM Fb = 800 psi

3. PROVIDE 2x4 COLLAR TIES AT 48" o.c. AT UPPER THIRD OF

RAFTERS u.n.o. ON PLAN.

4. FUR RIDGES FOR FULL RAFTER CONTACT

5. ■ DENOTES POINT LOAD. SEE CONSTRUCTION NOTE #4 ON S5.

6. DENOTES OVERFRAMED AREA

SEAL 26 NOV 2024
25539 Project No.

NON MR.

SEAL NOT VALID UNLESS SIGNED AND DATED
LOT 14 LANE FARMS ONLY

STRUCTURAL I WITH: NORTH RESIDENTIAL COMPONENTS COMPONENT

STRUCTURAL DESIGN IN ACCORDANCE
WITH: NORTH CAROLINA STATE
RESIDENTIAL CODE 2018 EDITION IRC

ENGINEER'S SEAL APPLIES TO STRUCTURAL
COMPONENTS ONLY AND DOES NOT
CERTIFY ARCHITECTURAL LAYOUT OR
DIMENSIONAL ACCURACY.
SEAL APPLIES ONLY FOR LOT NUMBER
INDICATED AND SIGNED PLANS MAY NOT BE
COPIED. FAILURE TO NOTIFY THE ENGINEER
OF ADDITIONAL USE OF THE PLANS WILL
VOID THE LIABILITY OF ROSS LINDEN



709 W. JONES STREET RALEIGH, NC 27603 TEL 919.832.5680 FAX 919.832.5675 WWW.ROSSLINDEN.COM

> ROSS LINDEN ENGINEERSPC

ROSS LINDEN ENGINEERS PC ASSUMES NO LIABILITY FOR CHANGES OR MODIFICATIONS MADE TO THESE PLANS BY OTHERS, OR FOR CONSTRUCTION METHODS, OR FOR ANY DEVIATION FROM THESE PLANS.

PLAN ENGINEERING REMAINS THE PROPERTY OF ROSS LINDEN ENGINEERS PC AND ANY UNAUTHORIZED USE OR DUPLICATION IN WHOLE OR PART IS STRICTLY PROHIBITED. THESE DRAWINGS ARE OFFERED TO THE CLIENT FOR A CONDITIONAL ONE TIME USE. THE CONDITIONAL USE IS LIMITED TO THE LOT OR PROPERTY AS SPECIFIED HEREIN, AND ONLY FOR THE SAID LOCATION.

STEPHENSON BUILDERS LOT 14 LANE FARMS

PROJECT NO. R241004

DESIGN BY LLR

27 NOV 2024


REVISION DATE


DOOE DI A

ROOF PLAN FRAMING

SHEET NO.

1 OF S5

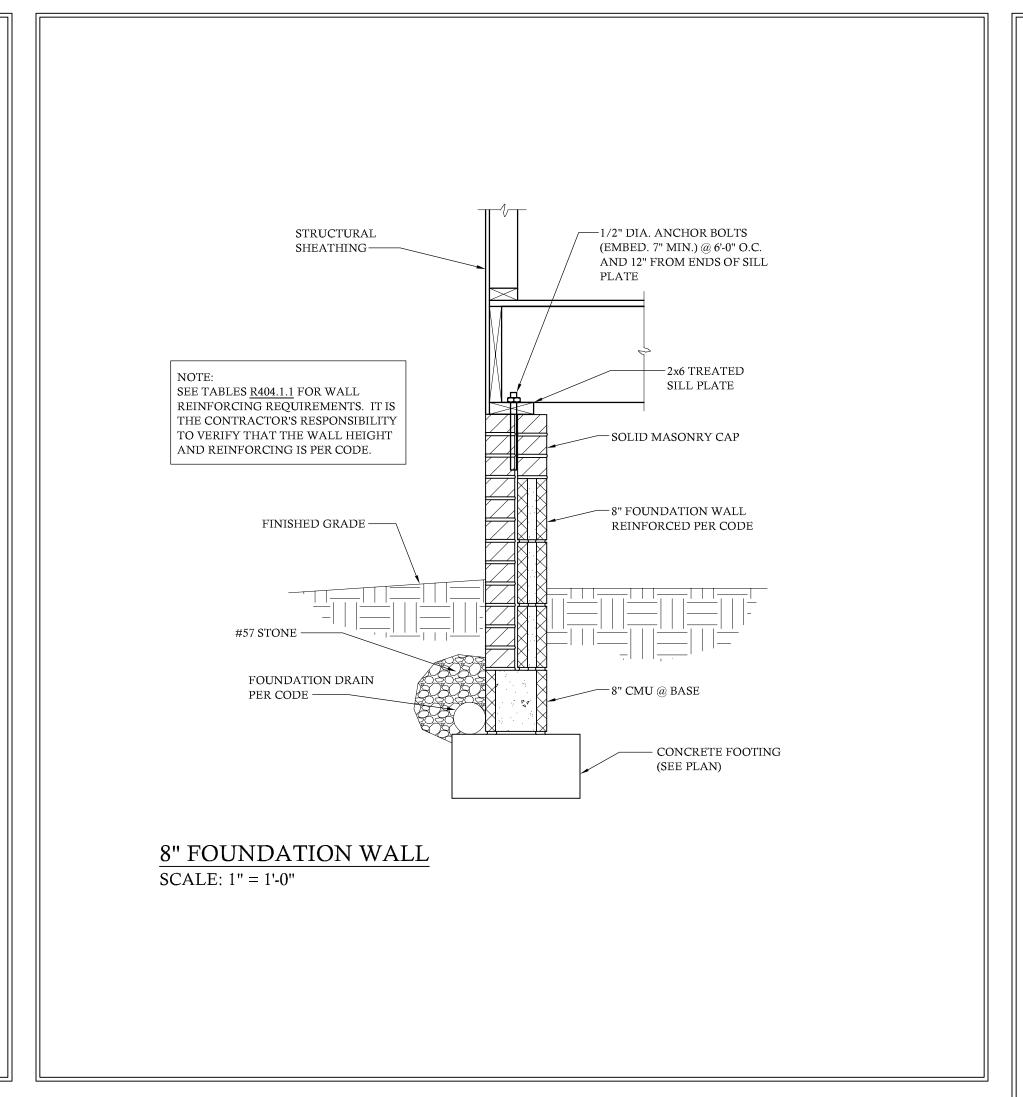

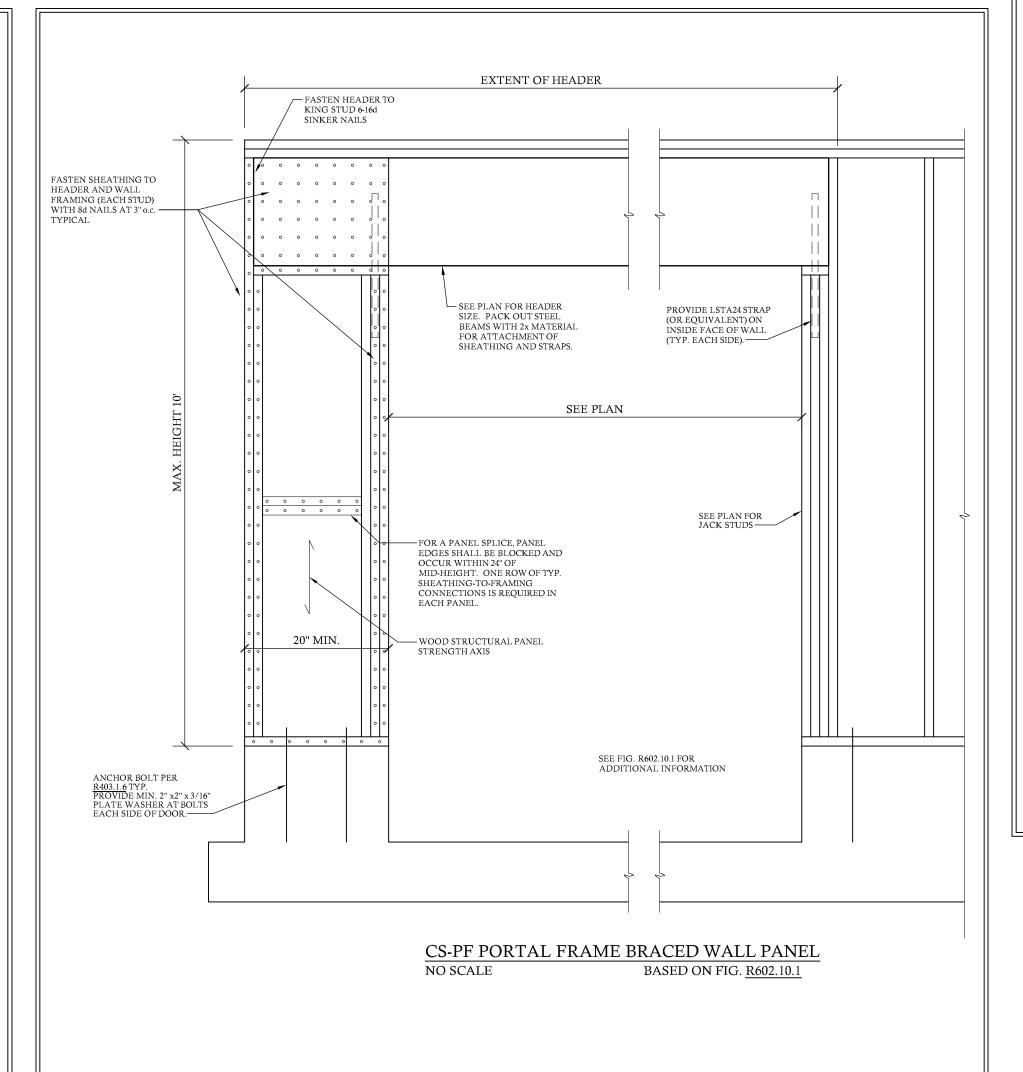

STRUCTURAL NOTES

1. ENGINEER'S SEAL APPLIES TO STRUCTURAL COMPONENTS ONLY AND DOES NOT CERTIFY ARCHITECTURAL LAYOUT OR DIMENSIONAL ACCURACY. ROSS LINDEN ENGINEERS PC ASSUMES NO LIABILITY FOR CHANGES OR MODIFICATIONS MADE TO THESE PLANS BY OTHERS, OR FOR CONSTRUCTION METHODS, OR FOR ANY DEVIATION FROM THE PLANS.

2. ALL CONSTRUCTION, WORKMANSHIP, MATERIAL QUALITY AND SELECTION SHALL BE IN ACCORDANCE WITH THE NORTH CAROLINA STATE BUILDING CODE - RESIDENTIAL CODE 2018 EDITION FROM THE INTERNATIONAL RESIDENTIAL CODE 2015 (IRC), AND LOCAL CODES AND REGULATIONS. DIMENSIONS SHALL GOVERN OVER SCALE AND CODE SHALL GOVERN OVER DIMENSIONS

3. CONTACT THE ENGINEER PRIOR TO CONSTRUCTION IF ANY DISCREPANCIES ARE NOTED ON THE PLANS.

4. ONLY CURRENT SEALED DRAWINGS ARE TO BE USED FOR CONSTRUCTION.

	LIVE LOAD	DEAD LOAD
TABLE R301.4	(PSF)	(PSF)
DWELLING UNITS	40	10
SLEEPING ROOMS	30	10
ATTICS WITH STORAGE	20	10
ATTICS WITHOUT STORAGE	10	10
ROOF SNOW	20	10
STAIRS	40	10
DECKS	40	10
EXTERIOR BALCONIES	60	10
PASSENGER VEHICLE GARAGES	50	
FIRE ESCAPES	40	10
GUARDRAILS AND HANDRAILS	200	

ADDITIONAL LOADS

AS FOLLOWS:

AND NEGATIVE PRESSURE

TABLE R301.2(4) - BASIC DESIGN WIND SPEED 115 MPH TABLE R301.2(7) - SEISMIC DESIGN CATEGORY B

 $\frac{\text{TABLE R301.2(6)}}{\text{DOORS AND WINDOW FOR A MEAN ROOF HEIGHT OF 35 FEET OR}}$ LESS SHALL BE 25 PSF

TABLE R301.2(2) - COMPONENT AND CLADDING LOADS FOR A BUILDING LOCATED IN EXPOSURE B

ROOF VALUES BOTH POSITIVE AND NEGATIVE SHALL BE DESIGNED BASED ON ROOF PITCHES AND MEAN ROOF HEIGHT

2.25:12 TO 7:12 34.8 PSF 36.5 PSF 37.9 PSF 21.0 PSF 22.1 PSF 22.9 PSF 7:12 TO 12:12

WALL CLADDING SHALL BE DESIGNED FOR A 24.1 PSF POSITIVE

MATERIALS

1. FRAMING LUMBER SHALL BE #2 SPRUCE PINE FIR (SPF) WITH THE FOLLOWING DESIGN PROPERTIES: Fb = 875 PSI Fv = 70 PSI E = 1.4E6 PSI

2. FRAMING LUMBER EXPOSED TO WEATHER OR IN CONTACT WITH THE GROUND, CONCRETE OR MASONRY SHALL BE #2 SOUTHERN YELLOW PINE (SYP) TREATED IN ACCORDANCE WITH AWPA C22 WITH THE FOLLOWING DESIGN PROPERTIES: Fb = 1050 PSI Fv = 95 PSI E = 1.6E6 PSI

3. ENGINEERED WOOD BEAMS SHALL BE LAMINATED VENEER LUMBER (LVL) OR PARALLEL STRAND LUMBER (PSL) WITH THE FOLLOWING MINIMUM DESIGN PROPERTIES: Fb = 2600 PSI Fv = 285 PSI E = 1.9E6 PSITHE FOLLOWING PRODUCTS MEET OR EXCEED THE ABOVE

SPECIFICATIONS AND MAY BE USED AT THE LOCATION INDICATED ON THE PLANS: BROADSPAN 1.9E-2750Fb LVL BY GEORGIA PACIFIC iLEVEL TRUS JOIST 1.9E MICROLLAM LVL BY WEYERHAUSER

4. STRUCTURAL STEEL WIDE FLANGE BEAMS SHALL CONFORM TO ASTM A992 OR A572, GRADE 50. ALL OTHER STRUCTURAL STEEL SHALL CONFORM TO ASTM A36.

5. BOLTS SHALL CONFORM TO A325 MINIMUM GRADE.

6. REBAR SHALL BE DEFORMED STEEL CONFORMING TO ASTM A615 GRADE 60.

7. SEE <u>TABLE R602.3(1)</u> FOR STRUCTURAL MEMBER FASTENING

REQUIREMENTS. 8. POURED CONCRETE SHALL HAVE A MINIMUM SPECIFIED COMPRESSIVE STRENGTH OF 3000 PSI AT 28 DAYS. MATERIALS

USED TO PRODUCE CONCRETE SHALL COMPLY WITH THE

APPLICABLE STANDARDS LISTED IN ACI 318 OR ASTM C 1157. 9. CONCRETE LOCATED PER <u>TABLE R402.2</u> SHALL BE AIR ENTRAINED WITH THE TOTAL AIR CONTENT NOT LESS THAN 5 PERCENT OR MORE THAN 7 PERCENT.

10. MASONRY UNITS SHALL CONFORM TO ACI 530/ASCE 5/TMS 402 AND MORTAR SHALL COMPLY WITH ASTM C 270.

CONSTRUCTION

1. STEEL BEAMS SHALL BE SUPPORTED AT EACH END WITH A MINIMUM BEARING LENGTH OF 3 1/2" AND FULL FLANGE WIDTH. BEAMS MUST BE ANCHORED AT EACH END WITH A MINIMUM OF FOUR 16d NAILS OR TWO 1/2" x 4" LAG SCREWS.

2. ENGINEERED WOOD BEAMS SHALL BE INSTALLED WITH ALL CONNECTIONS PER MANUFACTURER'S INSTRUCTIONS.

3. ALL BEAMS SHALL BE CONTINUOUSLY SUPPORTED LATERALLY AND SHALL BEAR FULL WIDTH ON THE SUPPORTING WALLS OR COLUMNS INDICATED WITH A MINIMUM OF THREE STUDS.

4. SOLID BLOCKING SHALL BE PROVIDED AT ALL POINT LOADS TO TRANSFER LOADS THROUGH FLOOR LEVELS. COLUMNS SHALL BE CONTINUOUS TO THE FOUNDATION OR TO OTHER STRUCTURAL ELEMENTS.

5. ENGINEERED WOOD FLOOR SYSTEMS AND ROOF TRUSS SYSTEMS SHALL BE PROVIDED FOR REVIEW AND COORDINATED WITH THE ENGINEER OF RECORD. INSTALLATION SHALL BE IN ACCORDANCE WITH THE MANUFACTURER'S INSTRUCTIONS. ROOF TRUSS DRAWINGS SHALL BE SIGNED AND SEALED BY THE MANUFACTURER AND REVIEWED BY THE ENGINEER OF RECORD PRIOR TO CONSTRUCTION.

6. WALL BRACING REQUIREMENTS SHALL BE IN ACCORDANCE WITH SECTION R602.10 OF THE NORTH CAROLINA RESIDENTIAL

CODE. A. EXTERIOR WALLS ARE ASSUMED TO BE BRACED WALL LINES. ADDITIONAL INTERIOR WALLS MAY ALSO BE USED AS BRACED WALL LINES WHERE APPLICABLE. SEE PLAN FOR LOCATIONS.

B. THE EXTERIOR OF THE STRUCTURE SHALL BE CONTINUOUSLY SHEATHED WITH 1/2" WOOD STRUCTURAL SHEATHING (PLYWOOD OR OSB) PER CODE SECTION <u>R602.10.3</u>. EXTERIOR BRACED WALL LINES ARE ASSUMED TO BE BRACED WITH CS-WSP (WOOD STRUCTURAL PANEL) BRACED WALL PANELS. ALTERNATE BRACING METHODS, IF USED, MUST BE INSTALLED IN ACCORDANCE WITH THE APPLICABLE SECTIONS OF THE CODE AND MUST BE REVIEWED BY THE ENGINEER PRIOR TO CONSTRUCTION. C. INTERIOR BRACED WALL LINES ARE CONSIDERED TO BE BRACED WITH 1/2" GB (GYPSUM BOARD) BRACED WALL

PANELS. SEE TABLE R602.10.2 FOR CONNECTION CRITERIA. D. SEE PLANS FOR SPECIAL WALL BRACING REQUIREMENTS FOR GARAGE WALLS AND OTHER WALLS WITH MULTIPLE OR LARGE OPENINGS.

7. STEEL FLITCH BEAMS SHALL BE FASTENED TOGETHER WITH 1/2" DIAMETER BOLTS WITH WASHERS PLACED UNDER THE THREADED END OF THE BOLT. BOLTS SHALL BE SPACED AT MAXIMUM 24" o.c. STAGGERED TOP AND BOTTOM OF BEAM WITH A MINIMUM 2" EDGE DISTANCE. TWO BOLTS SHALL BE LOCATED AT 6" FROM EACH END OF FLITCH BEAM.

8. BRICK LINTELS SHALL BE 3 1/2 x 3 1/2 x 1/4 STEEL ANGLE FOR UP TO 6'-0" MAXIMUM SPAN AND 6 x 4 x 5/16 FOR SPANS GREATER THAN 6'-0".

9. BRICK LINTELS AT SLOPED AREAS SHALL BE 4 x 3 1/2 x 1/4 STEEL ANGLE WITH 16d NAILS IN 3/16" HOLES IN 4" ANGLE LEG AT 12" o.c. TO TRIPLE RAFTER. WHEN THE SLOPE EXCEEDS 4:12 A MINIMUM OF 3 x 3 x 1/4 PLATES SHALL BE WELDED AT 24" o.c. ALONG THE STEEL ANGLE.

FOUNDATION

1. MINIMUM ALLOWABLE SOIL BEARING CAPACITY IS ASSUMED TO BE 2000 PSF. IT IS THE CONTRACTOR'S RESPONSIBILITY TO VERIFY SOIL BEARING CAPACITY.

2. CONCRETE AND MASONRY FOUNDATION WALLS SHALL BE SELECTED AND CONSTRUCTED IN ACCORDANCE WITH THE PROVISIONS OF SECTION R404 OR IN ACCORDANCE WITH ACI 318, NCMA TR68-A, OR ACI 530/ASCE 5/TMS 402.

3. MASONRY AND POURED CONCRETE WALL REINFORCEMENT SHALL BE IN ACCORDANCE WITH TABLES R404.1.1 (1 THROUGH 4) OF THE NORTH CAROLINA RESIDENTIAL CODE.

A. PER R404.1.3, TABLES ASSUME THAT WALLS HAVE PERMANENT LATERAL SUPPORT AT THE TOP AND BOTTOM. B. WALL REINFORCING SHALL BE PLACED ACCORDING TO FOOTNOTE (c) OF THE TABLES (REINFORCING IS NOT

CENTERED IN WALL). C. FOUNDATION DRAINS ARE ASSUMED AT ALL WALLS PER


4. WOOD SILL PLATES SHALL BE ANCHORED TO THE FOUNDATION WITH 1/2" ANCHOR BOLTS WITH MINIMUM 7" EMBEDMENT SPACED A MAXIMUM OF 6'-0" o.c. AND WITHIN 12" FROM THE ENDS OF EACH PLATE SECTION.


5. THE UNSUPPORTED HEIGHT OF SOLID MASONRY PIERS SHALL NOT EXCEED TEN TIMES THEIR LEAST DIMENSION. UNFILLED HOLLOW PIERS MAY BE USED IF THE UNSUPPORTED HEIGHT IS NOT MORE THAN FOUR TIMES THEIR LEAST DIMENSION.

6. CENTERS OF PIERS SHALL BEAR IN THE MIDDLE THIRD OF THE FOOTINGS, AND GIRDERS SHALL CENTER IN THE MIDDLE THIRD OF THE PIERS.

7. ALL FOOTINGS SHALL HAVE MINIMUM 2" PROJECTION ON EACH SIDE OF FOUNDATION WALLS.

ABBREVIATIONS	
CONC	CONCRETE
CONT	CONTINUOUS
DBL	DOUBLE
DJ	DOUBLE JOIST
DSP	DOUBLE STUD POCKET
EA	EACH
FL PT	FLAT PLATE
FTG	FOOTING
HGR	HANGER
LVL	LAMINATED VENEER LUMBER
NTS	NOT TO SCALE
OC	ON CENTER
PT	PRESSURE TREATED
RS	RAFTER SUPPORT
SC	STUD COLUMN
SP	STUD POCKET
TJ	TRIPLE JOIST
TYP	TYPICAL
UNO	UNLESS NOTED OTHERWISE
XJ	EXTRA JOIST

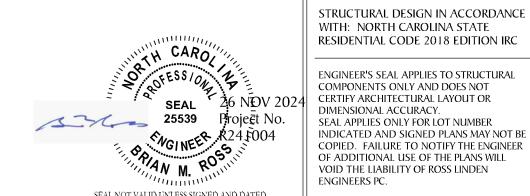

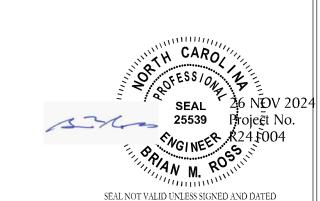



709 W. JONES STREET RALEIGH, NC 27603 TEL 919.832.5680 FAX 919.832.5675 WWW.ROSSLINDEN.COM

ROSS LINDEN ENGINEERS PC ASSUMES NO LIABILITY FOR CHANGES OR MODIFICATIONS MADE TO THESE PLANS BY OTHERS, OR FOR CONSTRUCTION METHODS, OR FOR ANY DEVIATION FROM THESE PLANS

PLAN ENGINEERING REMAINS THE PROPERTY OF ROSS LINDEN ENGINEERS PC AND ANY UNAUTHORIZED USE OR DUPLICATION IN WHOLE OR PART IS STRICTLY PROHIBITED THESE DRAWINGS ARE OFFERED TO THE CLIENT FOR A CONDITIONAL ONE TIME USE THE CONDITIONAL USE IS LIMITED TO THE LOT OR PROPERTY AS SPECIFIED HEREIN, AND ONLY FOR THE SAID LOCATION.

> Ш ON BUILDE FARMS EN PHI 14 **4** –

PROJECT NO. R241004

DESIGN BY LLR

27 NOV 2024 DATE REVISION

STRUCTURAL NOTES & DETAILS

SHEET NO.

OF S5