

GENERAL NOTES - RALEIGH

FOUNDATION NOTES

CRAWL SPACES:

- SLOPE CONCRETE SLAB 4" MINIMUM TOWARDS GARAGE DOOR
- EXTERIOR FLATWORK/GARAGES SHALL HAVE A MINIMUM CONCRETE SRENGTH OF 4.500 PSI
- FOOTINGS TO A MINIMUM CONCRETE STRENGTH OF 2500 PSI, UNLESS OTHERWISE NOTED
- ASSUMED ALLOWABLE SOIL BEARING PRESSURE: 2,000 p.s.f.
- WATERPROOF FOUNDATION WITH BITUMINOUS SPRAY.
- WALL TIES EMBEDDED IN THE HORIZONTAL MORTAR JOINT SHALL BE 16" ON CENTER, TIES IN ALTERNATE COURSES SHALL
- BE STAGGERED. THE MAXIMUM VERTICAL DISTANCE BETWEEN TIES SHALL NOT EXCEED 16" AND THE MAXIMUM
- HORIZONTAL DISTANCE SHALL NOT EXCEED 16" ADDITIONAL TIES SHALL BE PROVIDED AT ALL OPENINGS, AND WITHIN 12"
- CORE FILL ENTIRE BLOCK WALL WHEN THE WALL IS 4'-0" TALL OR HIGHER, INSTALL #4 REBAR IN EACH HOLLOW AREA OF EACH BLOCK FROM FOOTING TO TOP OF WALL, ON THE ENTIRE WALL PRIOR TO CORE FILLING IT.
- TOP COURSE OF BLOCK ON ALL WALLS WILL BE FILLED SOLID WITH MORTAR PLACING THE FOUNDATION STRAPS OR BOLTS IN THE MORTAR 6'-0" ON CENTER, AND 12" FROM EACH CORNER.
- 12"x16" PIERS: HOLLOW MASONRY UP TO 48" HIGH, SOLID MASONRY UP TO 9'0" HIGH
- 16"x16" PIERS: HOLLOW MASONRY UP TO 64" HIGH, SOLID MASONRY UP TO 12'0" HIGH
- BLOCK PIERS SHOULD BE PLACED DIRECTLY ON CONCRETE FOOTINGS PER PLAN. THEY SHOULD BE PLUMBED AND SQUARE WITHIN 1/4".
- SILL PLATES TO BE A MINIMUM OF 2x4 NOMINAL LUMBER.

FRAMING NOTES

DESIGN LOADS:

FLOORS:

40 psf LIVE LOAD + 10 psf DEAD LOAD = 50 psf 18 psf LIVE LOAD + 17psf DEAD LOAD = 35 psf ROOF:

DESIGN DEFLECTION LIMITS (BASED ON LIVE LOAD, EXCEPT MASONRY): RAFTERS GREATER THAN 3:12 L/180 **CEILINGS**

MASONRY VENEER L/600 NOMINAL LUMBER FLOORS: L/360

19.2" o.c. MAXIMUM SPACING

MANUFACTURED WOOD FLOORS: DESIGNED TO MINIMUM PRO RATING OF 35 (OR EQUIVALENT).

NO MORE THAN 8 POINT DIFFERENCE BETWEEN ADJACENT SPANS.

L/480 FOR SPANS UP TO 16'-0" AND NO GREATER THAN 1/2" DEFLECTION L/600 FOR SPANS OVER 16'-0" IF SIMPLE SPAN AND NO GREATER THAN 1/2" DEFLECTION

GARAGE FLOOR: 50 psf LIVE LOAD

L/240

WIND SPEED: 120 MPH

L/840 FOR SPANS OVER 16'-0" IF CONTINUOUS SPAN. AND NO GREATER THAN 1/2" DEFLECTION

SFISMIC: "A" & "B"

-JOIST SPACING:

DOUBLE EVERY OTHER FLOOR JOIST UNDER KITCHEN ISLANDS

INSTALL UNCOUPLING MEMBRANE IN TILE FLOOR AREAS IF 19.2" O.C. FLOOR JOIST SPACING

GLUE AND MECHANICALLY FASTEN [SCREWS] WOOD FLOOR IF 19.2" o.c. FLOOR JOIST SPACING

MANUFACTURED WOOD PRODUCTS (INCLUDING, BUT NOT LIMITED TO, STRUCTURAL WOOD BEAMS AND I-JOISTS) SHALL BE FABRICATED. HANDLED, AND INSTALLED IN ACCORDANCE WITH THE MANUFACTURER'S INSTRUCTIONS.

-JOISTS ARE NOT TO BE PLACED DIRECTLY OVER INTERIOR PARALLEL WALLS. (TO PREVENT UNEVEN FLOOR DEFLECTION FROM OCCURRING)

- ALL WOOD BEAMS/HEADERS: 2x6's TO BE SPF STUD GRADE OR BETTER/ 2x8 OR LARGER TO BE SYP #2 | PER NDS 2012 | OR BETTER, U.O.N. - ALL HEADERS SHALL BE SUPPORTED BY (1) 2x JACK STUD AND (1) 2x KING STUD MINIMUM. THE NUMBER OF STUDS SPECIFIED AT A SUPPORT INDICATES THE
- NUMBER OF JACKS REQUIRED, U.N.O. AT FLUSH OR DROPPED BEAMS, THE NUMBER OF STUDS SPECIFIED INDICATES THE TOTAL NUMBER OF STUDS REQUIRED TO SUPPORT THE BEAM
- EXTERIOR WALLS TO BE 2x4 SPF STUD GRADE AT 16" O.C. UNLESS OTHERWISE NOTED (10'4-1/2" MAXIMUM WALL HEIGHT
- ALL INTERIOR BEARING WALLS AND WALLS AT BASEMENT & FIRST FLOOR STAIRWELLS, KITCHEN, BATH, & GARAGE TO BE 2x4 SPF STUD GRADE @ 16" o.c.; ALL OTHER NON-BEARING INTERIOR WALLS TO BE 2x4 SPF STUD GRADE @ 24" o.c. U.O.N.
- ALL WALLS TO BE 3 1/2" UNLESS OTHERWISE NOTED.
- PROVIDE SOLID BEARING TO FOUNDATION OR BEAM BELOW FOR ALL BEAMS, HEADERS & GIRDER TRUSSES. PROVIDE BLOCKING BETWEEN JOISTS AS REQUIRED
- See Selection Sheet for Size and Style of Fireplace. See fireplace elevation detail for additional framing requirements, if any.
- CHECK SELECTION SHEETS FOR FLOOR COVERING AT TOP AND BOTTOM OF STAIR RISERS AND ADJUST RISERS AS REQ'D.
- PROVIDE BLOCKING AT ALL HANDRAIL TERMINATION AND BRACKET LOCATIONS.
- 20-MINUTE FIRE RATED DOOR BETWEEN GARAGE AND LIVING AREA.
- EXTERIOR WALL TO BE 2x4 SPF STUD G AT 16" o.c., UNLESS OTHERWISE NOTED (10'-0" MAXIMUM UNBRACED WALL HEIGHT).
- ALL EXTERIOR WALLS AND INTERIOR BEARING WALLS, FRAMED HIGHER THAN THE STANDARD PLATE HEIGHT. SHALL BE FRAMED WITH CONTINUOUS FULL HEIGHT STUDS TO THE HIGHEST CEILING (I.E. NO INTERMEDIATE BREAKS) TO PREVENT LATERAL HINGE CONDITIONS.
- In the garage, provide 1/2" gyp. board at all walls common to living space and all structural members supporting FLOOR/CEILING ASSEMBLY. GARAGE CEILING TO BE 1/2" SAG RESISTANT GYP. BOARD WHEN THERE ARE NO HABITABLE SPACES ABOVE, OR 5/8" TYPE X GYP. BOARD WHEN HABITABLE SPACES ARE ABOVE.
- ALL EMERGENCY ESCAPE & RESCUE OPENINGS TO BE A MAXIMUM OF 44" OFF OF FINISHED FLOOR AND HAVE MINIMUM OPENING DIMENSIONS OF 24" IN HEIGHT, 20" IN WIDTH, & HAVE A MINIMUM OPENING AREA OF 5.7 S.F.
- ALL DOORS TO BE 6'-8" TALL UNLESS OTHERWISE NOTED.
- ALL GLASS IN INTERIOR AND EXTERIOR DOORS TO BE TEMPERED (INCLUDING SIDELITES AND TRANSOMS)
- ALL LUMBER CONTACTING CONCRETE TO BE PRESSURE TREATED
- ALL FASTENERS, HANGERS, AND OTHER CONNECTORS TO BE USED WITH PRESSURE TREATED WOOD ARE TO HAVE ZMAX COATING (OR EQUIVALENT) HOT-DIPPED GALVANIZED OR STAINLESS STEEL.
- AT STAIR HANDRAIL, ON ONE SIDE ONLY, SHALL BE CONTINUOUS FOR THE ENTIRE LENGTH OF THE STAIRWAY, AND ENDS SHALL BE RETURNED TO A WALL OR POST. THE HANDRAIL MAY BE INTERRUPTED AT A NEWEL POST AT A TURN.
- ALL HANDRAIL GRIP PORTIONS SHALL NOT EXCEED 2-1/4" IN CROSS SECTIONAL DIMENSION.
- HANDRAILS SHALL BE INSTALLED ON ALL STAIRS WITH 2 OR MORE RISERS, HANDRAIL HEIGHTS SHALL BE A MINIMUM OF 34" AND A MAXIMUM OF 38".
- ALL STAIRS TO BE CONSTRUCTED SO AS NOT TO ALLOW A 4" SPHERE TO PASS THROUGH THE RISER.
- GUARDRAILS MUST BE A MINIMUM OF 36" HIGH. GUARDRAILS AT THE OPEN SIDES OF STAIRS MUST BE A MINIMUM OF 34" HIGH MEASURED VERTICALLY
- FROM THE NOSING AT THE TREADS. THE HORIZONTAL SPACING OF THE VERTICAL BALUSTERS SHALL BE 4" O.C.
- GUARDRAIL DESIGN TO RESIST A MINIMUM OF 200 LBS LATERAL FORCE

BASEMENTS:

- SLOPE CONCRETE SLAB 4" MINIMUM TOWARDS GARAGE DOOR
- EXTERIOR FLATWORK/GARAGES SHALL HAVE A MINIMUM CONCRETE SRENGTH OF 4 500 PSI
- FOOTINGS TO A MINIMUM CONCRETE STRENGTH OF 2500 PSI, UNLESS OTHERWISE NOTED- ALL FOUNDATION WALLS TO BE CAST IN PLACE CONCRETE 3000 PSI MIN. UNLESS OTHERWISE NOTED.
- BASEMENT WINDOW LOCATIONS MAY VARY FROM DRAWING DUE TO LOT CONDITIONS
- BACKFILL ADJACENT TO FOUNDATION WALLS SHALL NOT BE PLACED UNTIL THE WALL HAS SUFFICIENT STRENGTH AND HAS BEEN ANCHORED TO THE FLOOR OR HAS BEEN SUFFICIENTLY BRACED TO PREVENT DAMAGE BY THE BACKFILL.
- ASSUMED ALLOWABLE SOIL BEARING PRESSURE: 2,000 p.s.f
- WATERPROOF FOUNDATION WITH BITUMINOUS SPRAY.
- VERTICAL CONTROL JOINTS IN BASEMENT FOUNDATION WALLS STANDARD LOCATION GUIDELINES:
- 1) PLACE A CONTROL JOINT IN ALL UNBRACED WALLS OVER 30' IN LENGTH. (NOTE: "T" WALLS AND CORNERS COUNT AS A BRACE).
- 2) WINDOWS THAT ARE LARGER THAN THE STANDARD BASEMENT WINDOW REQUIRE A CONTROL JOINT.
- 3) CONTROL JOINTS ARE NOT REQUIRED AT EVERY WINDOW THAT IS STANDARD
- 4) IF THERE IS A STANDARD WINDOW LOCATED IN A WALL SEGMENT THAT REQUIRES A CONTROL JOINT, THEN THE CONTROL JOINT SHOULD BE PLACED ON THE SIDE OF THE WINDOW THAT IS ADJACENT TO THE LONG SIDE OF THE WALL. IF THERE IS MORE THAN ONE WINDOW IN A WALL THEN ONLY ONE WINDOW SHOULD HAVE A CONTROL IOINT
- 5) DOORS DO NOT GET CONTROL JOINTS.
- 6) CONTROL JOINTS SHOULD NOT BE LOCATED WITHIN 3' OF A BEAM POCKET.
- 7) CONTROL JOINTS ARE REQUIRED AT THE FIRST AND LAST STEP DOWN AT STEPPED BASEMENT FOUNDATION WALLS.
- INTERIOR FLATWORK SHALL HAVE A MINIMUM CONCRETE STRENGTH OF 3.000
- ALL VERTICAL STEEL AND ALL STEEL IN STRUCTURAL SLABS TO BE GRADE 60. ALL HORIZONTAL STEEL IN FOUNDATION WALLS AND FOOTERS TO BE GRADE 40 STEEL

SLAB ON GRADE:

- ALL CONCRETE SLABS ON GRADE SHALL BE THE THICKNESS AS INDICATED ON THE DETAILS OVER MINIMUM 6 MIL. POLYETHYLENE (VISQUEEN) VAPOR BARRIER. SLABS SHALL BE REINFORCED WITH 6x6 W1 4 WWE LAPPED 8" AT EDGES AND ENDS IN
- CONFORMANCE WITH ASTM-A 185, OR FIBERMESS REINFORCEMENT SHALL BE USED WITH A MINIMUM FIBER LENGTH OF $\frac{1}{2}$ TO 2 $\frac{1}{4}$ COMPLYING WITH ASTM C 1116. THE DOSAGE AMOUNT SHALL BE 0.75 TO 3.0 POUNDS PER CUBIC YARD IN ACCORDANCE WITH MANUFA TURER'S RECOMMENDATIONS.
- SLABS ON GRADE SHALL BEAR ON STRUCTURAL FILL WHICH SHALL BE CLEAN SAND FREE OF DEBRIS AND OTHER DELETERIOUS MATERIAL. STRUCTURAL FILL SHALL BE COMPACTED TO A DENSITY OF AT LEAST 95% OF THE MODIFIED PROCTOR MAXIMUMN DRY DENSITY (ASTM D1557), TERMITE PROTECTION SHALL BE PROVIDED IN ACCORDANCE WITH APPLICABLE CODE REQUIREMENTS. IE SOIL TREATMENT IS LISED. THE TREATMENT SHALL BE DONE AFTER ALL EXCAVATION, BACKFILLING, AND COMPACTION IS COMPLETED.
- FOOTINGS MAY BEAR UPON UNDISTURBED SOIL OR UPON STRUCTURAL FILL, STRUCTURAL FILL SHALL BE COMPACTED TO A DENSITY OF AT LEAST 95% OF THE MODIFIED PROCTOR MAXIMUMN DRY DENSITY (ASTM D1557) FOR A DEPTH OF AT LEAST TWO FEET (2'-0") BELOW THE BOTTOM OF THE FOOTING.
- THE FOLLOWING MINIMUM CONCRETE COVER SHALL BE PROVIDED FOR REINFORCEMENT: 3" CONCRETE CAST AGAINST AND PERMANENTLY EXPOSED TO EARTH
- 2" CONCRETE EXPOSED TO EARTH AND WEATHER
- 1 ½" CONCRETE NOT EXPOSED TO EARTH OR WEATHER
- SLOPÉ CONCRETE SLAB 4" MINIMUM TOWARDS GARAGE DOOR
- EXTERIOR FLATWORK/GARAGES SHALL HAVE A MINIMUM CONCRETE SRENGTH OF 4,500 PSI
- ASSUMED ALLOWABLE SOIL BEARING PRESSURE: 2,000 p.s.f.
- INTERIOR FLATWORK SHALL HAVE A MINIMUM CONCRETE STRENGTH OF 3,000 PSI.
- ALL STEEL IN STRUCTURAL SLABS TO BE GRADE 60. ALL HORIZONTAL STEEL IN FOUNDATION WALLS AND FOOTERS TO BE GRADE 40 STEEL.

MECHANICAL/ELECTRICAL NOTES

- ANY GAS APPLIANCES MUST BE INSTALLED PER MANUFACTURER'S SPECIFICATIONS.
- HOLD THE CENTERLINE OF ALL EXTERIOR LIGHT FIXTURES AT 5'-8" OFF BOTTOM OF DOOR OPENING.
- ALL KITCHEN CABINET DIMENSIONS ARE CABINET TO CABINET.
- CABINET STYLES MAY VARY FROM INTERIOR ELEVATIONS DEPENDING ON STYLE, MANUFACTURER, ETC. FOR CABINET DETAILS SEE SHOP DRAWINGS.
- CABINET SIZES MAY VARY WITH FULL-OVERLAY CABINETS.
- GROUND FAULT INTERRUPTER (GFCI) OUTLETS TO BE INSTALLED PER NEC 2017, SECT. 210.8
- PROVIDE HOSE BIBS PER DIVISION SPEC. SHEET. EXACT LOCATION TO BE FIELD DETERMINED UNLESS OTHERWISE NOTED ON THE PLANS.
- MIN. 50 C.F.M. FOR ALL EXHAUST FANS IN BATHROOMS

INSULATION DETAILS

EXTERIOR STUD WALL CAVITY: (2x4) R-19

R-19

FLOOR JOIST CAVITY AT STANDARD PERIMETER: FLOOR JOIST CAVITY AT CANTILEVER: (OVER HORIZONTAL SPACE)

R-19 R-38 BLOWN

R-15

ELEVATION NOTES

(SLOPED AND VERTICAL SPACE)

- WINDOW STYLE AND MULLIONS MAY VARY FROM ELEVATION DEPENDING UPON MANUFACTURER, STYLE, PATTERN, TYPE, ETC.
- USE SECONDARY HEAT BARRIER ON ALL DIRECT VENT FIREPLACES 7' OR LESS ABOVE A WALKWAY.
- GRADE AWAY FROM FOUNDATION WALLS SHALL FALL A MINIMUM OF 6" WITHIN THE FIRST 10'.

R-38 BATT

- PROVIDE TYVEK OR EQUIVALENT HOUSE WRAP BEHIND BRICK AND STONE VENEER OVER WOOD SHEATHING. PROVIDE BRICK WEEP HOLES AT 24" O.C. WITH BRICK VENEER AND MORTER NET BEHIND AND THROUGH WEEP HOLES.
- PROVIDE FLASHING AND WEEP HOLES ABOVE ALL BRICK ANGLE IRONS, BELOW ALL BRICK SILLS AND ABOVE SILL PLATE SEALERS. EXTERIOR STEPS TO HAVE A MAXIMUM 8" RISER. WHEN VERTICAL RISE EXCEEDS 30" OR FOUR OR MORE CONTINUOUS RISERS. A
- HANDRAIL IS REQUIRED

ROOF PLAN NOTES

- ALL OVERHANGS TO HAVE (2) SOFFIT VENTS PER EACH 8' SOFFIT SECTION.
- PROVIDE BAFFLES AT EXTERIOR TRUSS BEARING FOR VENTILATION.
- PROVIDE 15# FELT PAPER UNDER SHINGLES.

Space for Architect Seal



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RESIDENCE FOR:

RICHARD ATTANASIO

15 SONGBIRD COVE

SERENITY Drawina Date Coord Name

STY5-0363-00 10/14/2024 Drawina Scale: 1/8" = 1'0"

Job Number

Born on Date:

the AURORA II

CDs Drawn By

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GREG P.

WAR

Elevation "C"

Series:

Plan No.:


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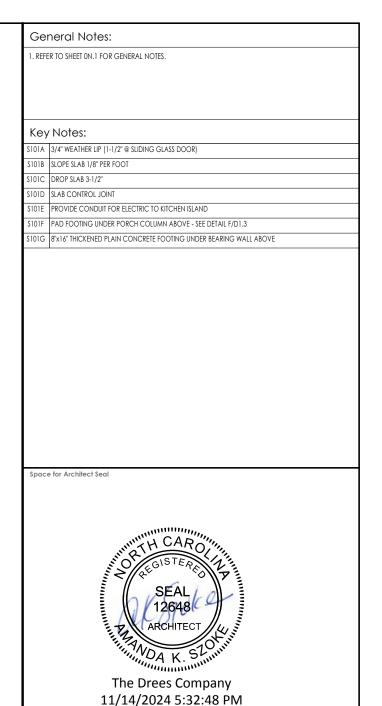
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RESIDENCE FOR:

RICHARD ATTANASIO

15 SONGBIRD COVE

SERENITY

the AURORA II

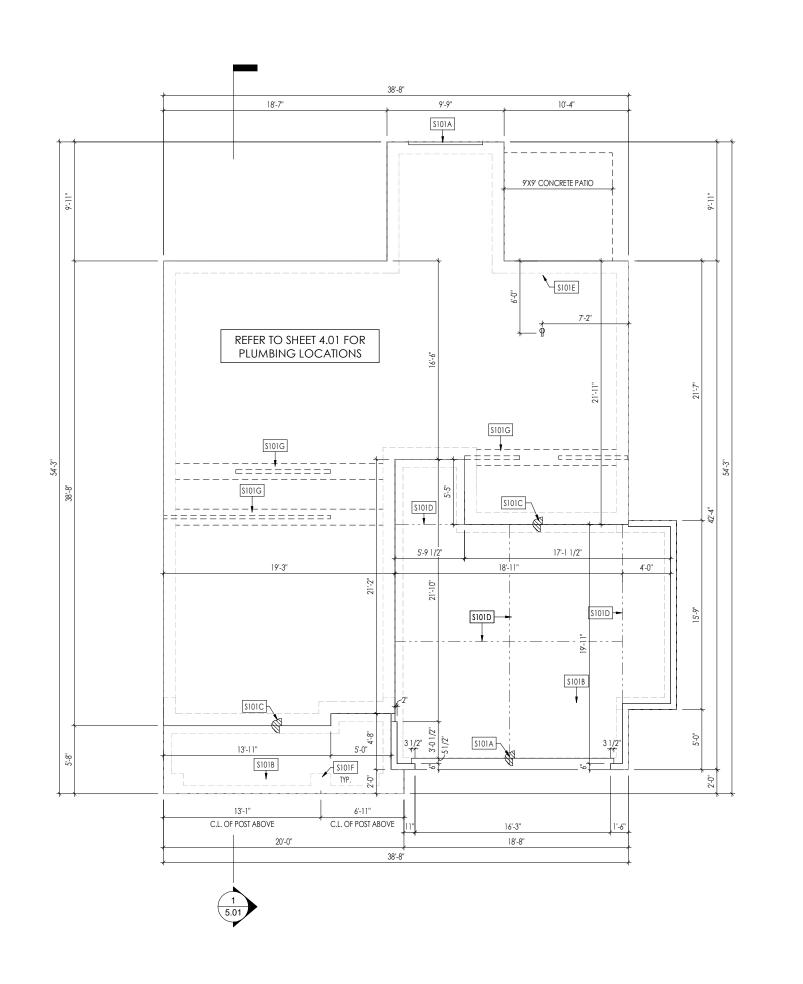02/2021 **CDs Drawn By:** WAB




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Foundation Plan (Sla



General Notes:

- . REFER TO SHEET ON.1 FOR GENERAL NOTES.
- 1. ALTER 10.3 THELT WINT FOR SELECTAL NOTES. 2. ALL FIRST FLOOR CEILINGS TO BE 9-1" ABOVE SUBFLOOR UNLESS OTHERWISE NOTED. 3. FRAME TOP OF ALL WINDOWS AT 1'0-1/4" BELOW TOP OF PLATE UNLESS OTHERWISE NOTED.
- 4. ALL DROPPED, INTERIOR HEADERS (FALSE AND BEARING) ARE DROPPED 1'-0" FROM CEILING.
- 5. REFER TO SELECTION SHEETS FOR FLOORING MATERIAL PRIOR TO CONSTRUCTING STAIRS TO DETERMINE RISER HEIGHTS.

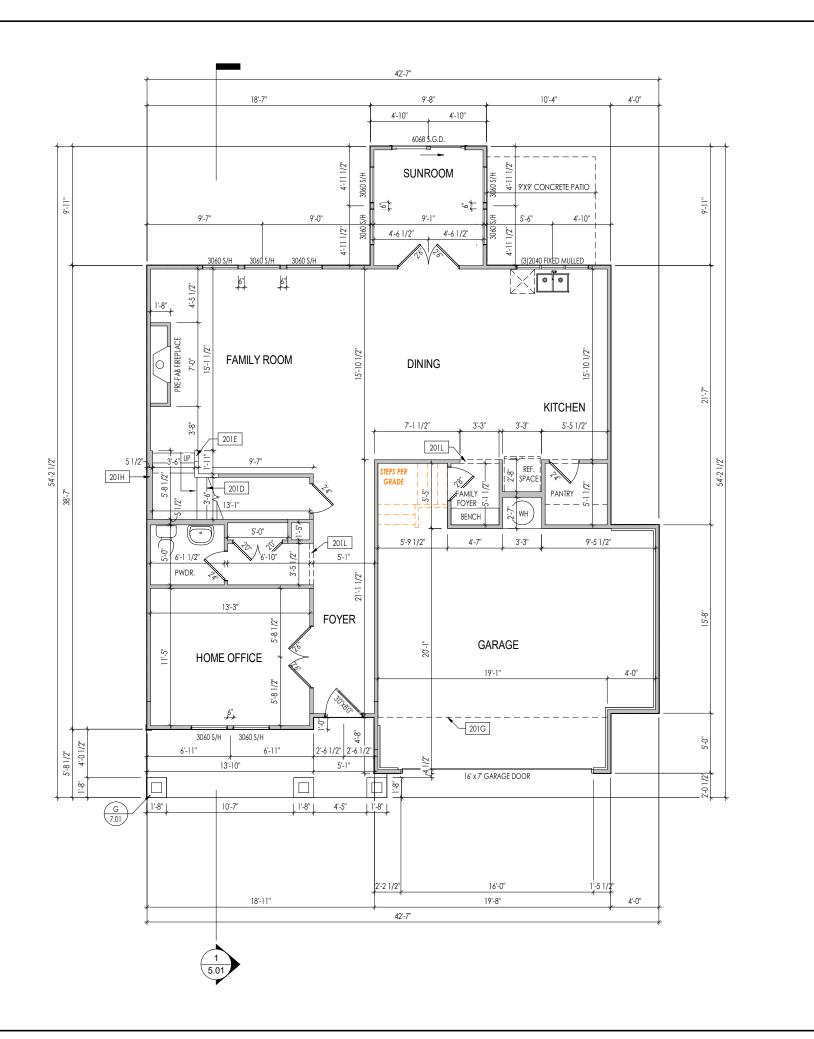 6. REFER TO SHEET 2.01S FOR STRUCTURAL INFORMATION.

Key Notes:

- 201D SEE DETAIL A/7.02 FOR STAIR FRAMING DETAILS
- 201E 36" HIGH WALL SLOPED WITH STAIR STRINGER
- 201G OUTLINE OF SECOND FLOOR ABOVE
- 201H 2x6 BALLOON FRAMED WALL SEE SHEET 2.02S FOR MORE INFO
- 201L FRAME TOP OF OPENING AT 8'-1" A.F.F.

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RESIDENCE FOR:

RICHARD ATTANASIO

15 SONGBIRD COVE

SERENITY

Job Number: 10/14/2024 COORD_PHONE STY5-0363-00 GREG P. Drawing Scale: 1/8" = 1'0"

the AURORA II

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Elevation "C"

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LATERAL/WALL BRACING & WALL SHEATHING SPECIFICATIONS

THIS MODEL HAS BEEN DESIGNED TO RESIST LATERAL FORCES RESULTING FROM:

120 MPH WIND IN 2018 NCSBC MAP

(120 MPH WIND SPEED IN ASCE 7-10 WIND MAP, PER IRC R301.2.1.1) EXP. B & SEISMIC CAT. A/B.

EXT. WALL SHEATHING SPECIFICATION

- 7/16" OSB OR 15/32" PLYWOOD: FASTEN SHEATHING w/ 2-3/8"x 0.113 NAILS @ 6" O.C. AT EDGES & @ 12" O.C. IN THE PANEL FIELD. (TYP,
- ALL SHEATHING PANELS SHALL BE ORIENTED AND INSTALLED FULL HEIGHT OF SHEAR WALL OR 2x HORIZONTAL BLOCKING SHALL BE PROVIDED TO SUPPORT ALL UNSUPPORTED PANEL EDGES & EDGE FASTENING.
- ALL EXT. WALLS SHALL BE CONTINUOUSLY SHEATHED AND ARE CONSIDERED SHEAR WALLS.
- ALT. STAPLE CONNECTION SPEC: 1 3/4" 16 GA STAPLES ($\frac{1}{16}$ " CROWN) @ 3" O.C. AT EDGES & @ 6" O.C IN FIELD.

3" O.C. EDGE NAILING

AT DESIGNATED AREAS - FASTEN PANEL EDGES OF WOOD STRUCTURAL WALL SHEATHING TO FRAMING W/ 2-3/8"x 0.113 NAILS @ 3" O.C. NO STAPLE ALTERNATIVE AVAILABLE AT THIS SPEC . ALL SHEATHING PANELS SHALL BE ORIENTED AND INSTALLED FULL HEIGHT OF SHEAR WALL OR 2x HORIZONTAL BLOCKING SHALL BE PROVIDED TO SUPPORT UNSUPPORTED PANEL EDGES AND 3" O.C. EDGE FASTENING.

- SEE CONNECTION SPECIFICATIONS CHART FOR STANDARD SHEAR TRANSFER DETAILING, IF ADDITIONAL CAPACITY IS REQUIRED BY DESIGN, IT WILL BE SPECIFICALLY NOTED ON PLAN.
- DESIGN ASSUMES 16" O.C MAX. STUD SPACING, U.N.O. · ALL STRUCTURAL PANELS ARE TO BE DIRECTLY APPLIED TO STUD FRAMING.
- PRE-MANUFACTURED PANELIZED WALLS:
 FASTEN TOGETHER END STUDS OF WALL PANELS SHEATHED w/ OSB OR PLYWOOD w/ 10d NAILS @ 4" O.C. (THRU ONE SIDE ONLY)

INDICATES EXTENT OF INT. OSB SHEARWALL, AND/OR 3" O.C. EDGE NAILING



★ INDICATES POST ABOVE (P.A.) PROVIDE SOLID BLOCKING UNDER POST OR JAMB ABOVE.

(2)2x4 (2)2x4 (2)2x4 (2)2x4 BM. POCKFT (2)2x4 BM. POCKET (2)2x4 KING/(1)2X4 (1)1-3/4"x14" LVL FLUSH BEARING WALL [1]1-3/4"x14" LVL FLUSH BEARING WALL (1)1-3/4"x14" LVL FLUSH BEARING WALL BEARING WALL BEARING WALL BEARING WALL 1)1-3/4"x14" LVL FLUSH (2)2x8 DROPPED (1)1-3/4"x14" LVL FLUSH ST1B -(2)2x8 (2)1-3/4"x20" LVL FLUSH BOTTOM STIB 1)2X4 JACK (2)2x12 DROPPED (1)2x4 KING & CONTINUOUS FULL WIDTH OF PORTAL FRAME (1)2X4 JACK (2)2x4 STIA (TYP.) PORTAL FRAME - SEE DETAIL 1/7.03

General Notes:

. REFER TO SHEET ON.1 FOR GENERAL NOTES.

Key Notes:

STIA 4x4 P.T. WOOD POST WITH SIMPSON ABW44Z POST BASE AND SIMPSON BCS2-2/4 CAP

STIB PROVIDE 1-3/4"x14"x12" LONG LVL SCAB FOR ADD'L BEARING AT POST ON BOTH SIDES OF BEAM, FASTEN SCAB TO BEAM w/ (4)ROWS OF (5)0.131"x3-1/2" LONG NAILS.

CONNECTION SPECIFICATIONS (TYP. U.N.O.)

NOTE: 10d NAIL = 3" x 0.131" GUN NAIL				
JOIST TO SOLE PLATE	(3)10d TOENAILS			
SOLE PLATE TO JOIST/BLK'G.	10d NAILS @ 6" o.c.			
STUD TO SOLE PLATE	(3) 10d TOENAILS			
TOP OR SOLE PLATE TO STUD	(3)10d NAILS			
RIM TO TOP PLATE	10d TOENAILS @ 6" o.c.			
BLK'G. BTWN. JOISTS TO TOP PL.	(3)10d TOENAILS			
RAFTER/TRUSS TO TOP PLATE	(3)10d TOENAILS + (1) SIMPSON H2.5A			
GAB. END TRUSS TO DBL. TOP PL.	10d TOENAILS @ 8" o.c.			
R.T. w/ HEEL HT. 9 1/4" TO 12"	2x10 BLK EVERY 3RD BAY FASTENED TO DBL. TOP PLATE w/ 10d TOENAILS @ 6" O.C.			
R.T. w/ HEEL HT. 12" TO 16"	2x12 BLK EVERY 3RD BAY FASTENED TO DBL. TOP PLATE w/ 10d TOENAILS @ 6" O.C.			
R.T. w/ HEEL HT. UP TO 24"	LAP WALL SHTG. w/ DBL. TOP PL. & INSTALL ON TRUSS VERT FASTEN w/ 8d NAILS @ 6" O.C.			
R.T. w/ HEEL HT. 24" TO 48"	LAP WALL SHTG. w/ DBL. TOP PL. & INSTALL ON TRUSS VERT FASTEN w/ 8d NAILS @ 6" O.C. PROVIDE 2x BLK @ EA. BAY AT TOP OF HEEL			
DOUBLE STUD	10d NAILS @ 24" o.c.			
DOUBLE TOP PLATE	10d NAILS @ 24" o.c.			
DOUBLE TOP PLATE LAP SPLICE	(10)10d NAILS IN LAPPED AREA			
TOP PLATE LAP @ CORNERS & INTERSECTING WALLS	(2)10d NAILS			
WALL TO FOUNDATION	WALL SHTG. LAP w/ SILL PL. & FASTENED PER SHEAR WALL FASTENING SPEC.			

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RESIDENCE FOR:

RICHARD ATTANASIO

15 SONGBIRD COVE


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Job Number: Drawina Date: 10/14/2024 COORD PHONE STY5-0363-00 GREG P. Drawing Scale: 1/8" = 1'0"

the AURORA II

CLASSIC Plan No.:

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 3. FRAME TOP OF ALL WINDOWS AT 1"0-1/4" BELOW TOP OF PLATE UNLESS OTHERWISE NOTED.
- 4. ALL DROPPED, INTERIOR HEADERS (FALSE AND BEARING) ARE DROPPED 1'-0" FROM CEILING.
- 5. REFER TO SELECTION SHEETS FOR FLOORING MATERIAL PRIOR TO CONSTRUCTING STAIRS TO DETERMINE
- RISER HEIGHTS. 6. REFER TO SHEET 2.02S FOR STRUCTURAL INFORMATION.

Key Notes:

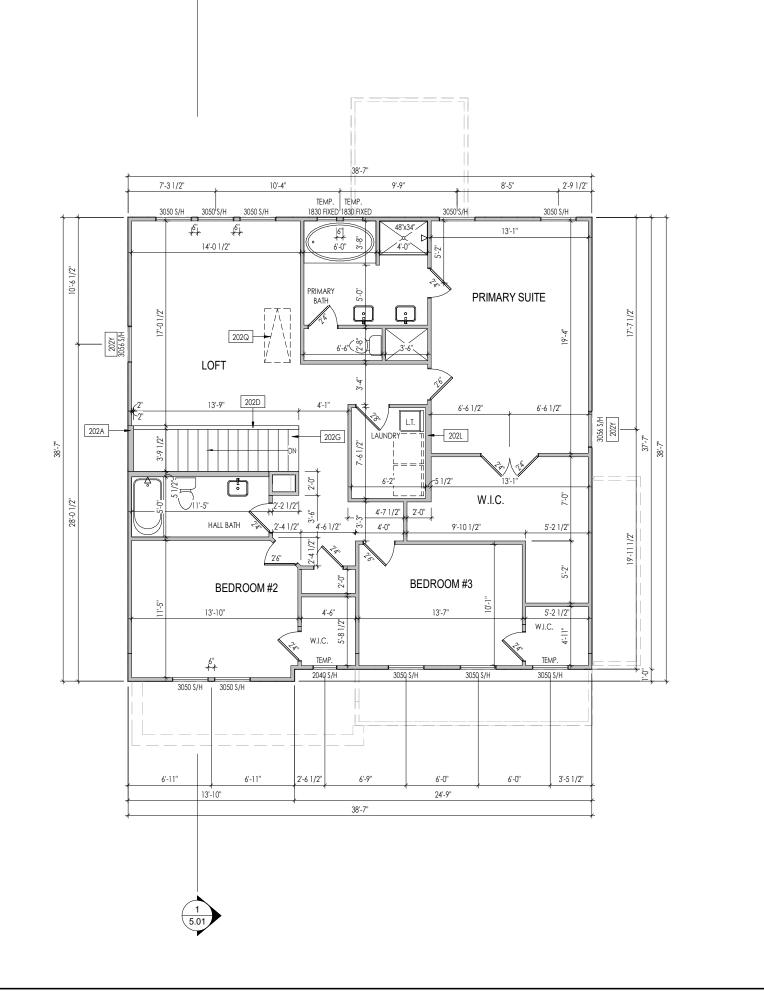202A 2x6 BALLOON FRAMED WALL - SEE SHEET 2.02S FOR MORE INFO

202D 36" HIGH WALL

202G SEE DETAIL B/7.02 FOR THIRD FLOOR STAIR DETAIL

202L DO NOT LOCATE TRUSS ABOVE PLUMBING WALL

202Q PULL DOWN ATTIC ACCESS STAIRS (25-1/2" x 54") WITH LIGHT AND OUTLET

202Y FRAME TOP OF WINDOWS AT 0'6-1/2" BELOW TOP OF PLATE

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RESIDENCE FOR:

RICHARD ATTANASIO

15 SONGBIRD COVE

SERENITY

Job Number: STY5-0363-00 Drawing Date: Coord Name: Coord Phone: COORD_PHONE

House Name: Drawing Scale: 1/8" = 1'0" Contract Drawn But

the AURORA II

CLASSIC Plan No.:

07/02/2021 CD- Pressure Res. WAR



Second Floor Framing
Elevation "C"

LATERAL/WALL BRACING & WALL SHEATHING SPECIFICATIONS

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120 MPH WIND IN 2018 NCSBC MAP

(120 MPH WIND SPEED IN ASCE 7-10 WIND MAP, PER IRC R301.2.1.1) EXP. B & SEISMIC CAT. A/B.

EXT. WALL SHEATHING SPECIFICATION

- 7/16" OSB OR 15/32" PLYWOOD: FASTEN SHEATHING W/ 2-3/8"x 0.113 NAILS @ 6" O.C. AT EDGES & @ 12" O.C. IN THE PANEL FIELD. (TYP,
- ALL SHEATHING PANELS SHALL BE ORIENTED AND INSTALLED FULL HEIGHT OF SHEAR WALL OR 2x HORIZONTAL BLOCKING SHALL BE PROVIDED TO SUPPORT ALL UNSUPPORTED PANEL EDGES & EDGE FASTENING.
- ALL EXT. WALLS SHALL BE CONTINUOUSLY SHEATHED AND ARE CONSIDERED SHEAR WALLS.
- ALT. STAPLE CONNECTION SPEC: 1 3/4" 16 GA STAPLES ($\frac{1}{16}$ " CROWN) @ 3" O.C. AT EDGES & @ 6" O.C IN FIELD.

3" O.C. EDGE NAILING


• AT DESIGNATED AREAS - FASTEN PANEL EDGES OF WOOD STRUCTURAL WALL SHEATHING TO FRAMING W/ 2-3/8"x 0.113 NAILS @ 3" O.C. NO STAPLE ALTERNATIVE AVAILABLE AT THIS SPEC . ALL SHEATHING PANELS SHALL BE ORIENTED AND INSTALLED FULL HEIGHT OF SHEAR WALL OR 2x HORIZONTAL BLOCKING SHALL BE PROVIDED TO SUPPORT UNSUPPORTED PANEL EDGES AND 3" O.C. EDGE FASTENING.

- SEE CONNECTION SPECIFICATIONS CHART FOR STANDARD SHEAR TRANSFER DETAILING, IF ADDITIONAL CAPACITY IS REQUIRED BY DESIGN, IT WILL BE SPECIFICALLY NOTED ON PLAN.
- DESIGN ASSUMES 16" O.C MAX. STUD SPACING, U.N.O. · ALL STRUCTURAL PANELS ARE TO BE DIRECTLY APPLIED TO STUD FRAMING.
- PRE-MANUFACTURED PANELIZED WALLS:
 FASTEN TOGETHER END STUDS OF WALL PANELS
 SHEATHED W/ OSB OR PLYWOOD W/ 10d NAILS @ 4" O.C. (THRU ONE SIDE ONLY)

INDICATES EXTENT OF INT. OSB SHEARWALL, AND/OR 3" O.C. EDGE NAILING



★ INDICATES POST ABOVE (P.A.) PROVIDE SOLID BLOCKING UNDER POST OR JAMB

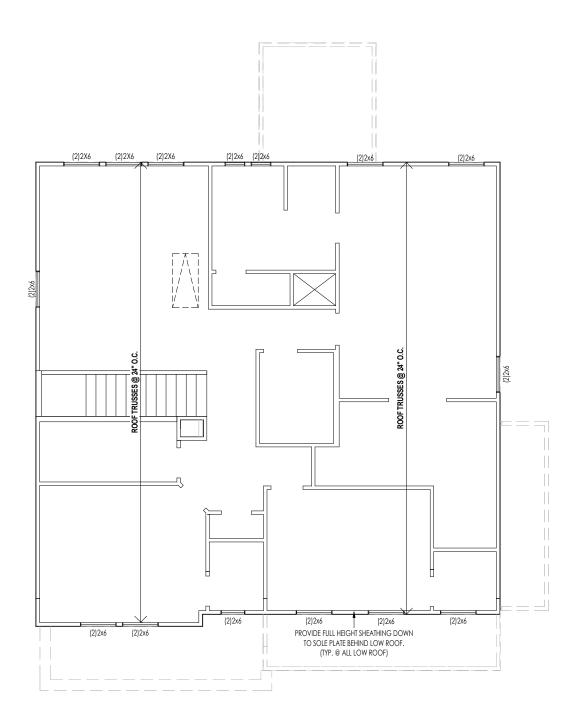

Key Notes:	
,	
CONNECTION SPE	ECIFICATIONS (TYP. U.N.O.)
	E: 10d NAIL = 3" x 0.131" GUN NAIL
JOIST TO SOLE PLATE	(3)10d TOENAILS
SOLE PLATE TO JOIST/BLK'G.	10d NAILS @ 6" o.c.
STUD TO SOLE PLATE	(3)10d TOENAILS
TOP OR SOLE PLATE TO STUD	(3)10d NAILS
RIM TO TOP PLATE	10d TOENAILS @ 6" o.c.
BLK'G. BTWN. JOISTS TO TOP PL.	(3)10d TOENAILS
RAFTER/TRUSS TO TOP PLATE	(3)10d TOENAILS + (1) SIMPSON H2.5A
GAB. END TRUSS TO DBL. TOP PL.	10d TOENAILS @ 8" o.c.
R.T. w/ HEEL HT. 9 1/4" TO 12"	2x10 BLK EVERY 3RD BAY FASTENED TO DBL. TOP PLATE w/ 10d TOENAILS @ 6" O.C.
R.T. w/ HEEL HT. 12" TO 16"	2x12 BLK EVERY 3RD BAY FASTENED TO DBL. TOP PLATE w/ 10d TOENAILS @ 6" O.C.
R.T. w/ HEEL HT. UP TO 24"	LAP WALL SHTG. w/ DBL. TOP PL. & INSTALL ON TRUSS VERT FASTEN w/ 8d NAILS @ 6" O.C.
R.T. w/ HEEL HT. 24" TO 48"	LAP WALL SHTG. w/ DBL. TOP PL. & INSTALL ON TRUSS VERT FASTEN w/ 8d NAILS @ 6" O.C. PROVIDE 2x BLK @ EA. BAY AT TOP OF HEEL
DOUBLE STUD	10d NAILS @ 24" o.c.
DOUBLE TOP PLATE	10d NAILS @ 24" o.c.
DOUBLE TOP PLATE LAP SPLICE	(10)10d NAILS IN LAPPED AREA
TOP PLATE LAP @ CORNERS & INTERSECTING WALLS	(2)10d NAILS
WALL TO FOUNDATION	WALL SHTG. LAP w/ SILL PL. & FASTENED PER SHEAR WALL FASTENING SPEC.
Space for Architect Seal	
·	
	TH CAROLLING

General Notes:



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RESIDENCE FOR:

RICHARD ATTANASIO

15 SONGBIRD COVE

SERENITY


Job Number: Drawing Date: STY5-0363-00 10/14/2024 GREG P. COORD_PHONE Drawing Scale: 1/8" = 1'0" Contract Drawn By

the AURORA II

CLASSIC Plan No.:

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ROOF VENTILATION		
CITY/SERIES:	RALEIGH	
	MAIN HOUSE	REAR
TOTAL ATTIC AREA:	1,622	132
REQUIRED NET FREE VENTILATION (ATTIC AREA/300):	5.41	0.44
ACTUAL NET FREE VENTILATION (UPPER + LOWER):	5.51	1.32
DOWNSPOUT CALCULATION		
	MAIN HOUSE	REAR
TOTAL DRAINABLE ROOF AREA:	2108.6	171.6
MINIMUM # OF DOWNSPOUTS:	4	1

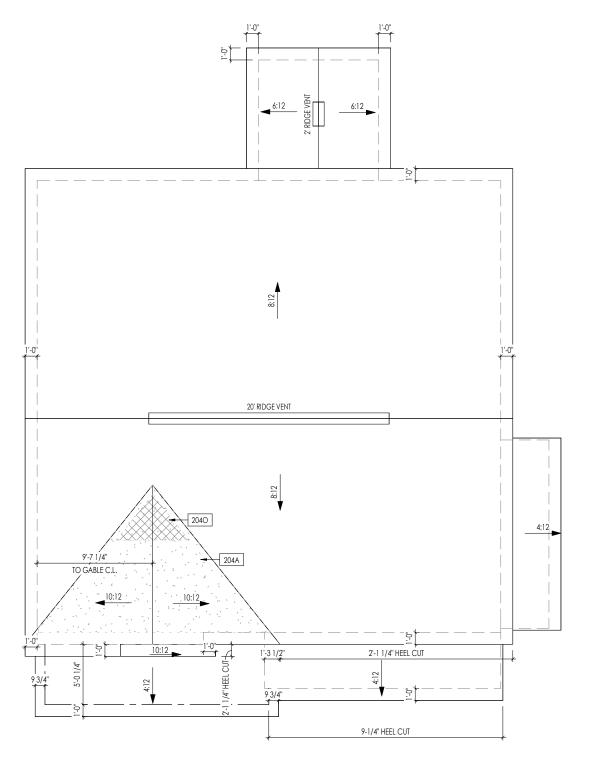

	HEEL CUT STANDARDS					
		OVERH	HANG			
		1'-0"	2'-0"			
	4:12	3-3/4"	7-3/4"			
	5:12	4-3/4"	9-3/4"			
	6:12	5-3/4"	11-3/4"			
등	7:12	6-3/4"	13-3/4"			
ROOF PIT	8:12	7-3/4"	N/A			
8	9:12	8-3/4"	N/A			
2	10:12	9-3/4"	N/A			
	12:12	11-3/4"	N/A			
	14:12	13-3/4"	N/A			

	Ge	neral Notes:				
	1. REF	1. REFER TO SHEET 0N.1 FOR GENERAL NOTES.				
	Ke	y Notes:				
	204A	VALLEY TRUSS OVER FRAMING @ 24" O.C.				
	2040	XXX				

CONNECTION SPE	CIFICATIONS (TYP. U.N.O.)
NOTE	: 10d NAIL = 3" x 0.131" GUN NAIL
JOIST TO SOLE PLATE	(3)10d TOENAILS
SOLE PLATE TO JOIST/BLK'G.	10d NAILS @ 6" o.c.
STUD TO SOLE PLATE	(3) 10d TOENAILS
TOP OR SOLE PLATE TO STUD	(3) 10d NAILS
RIM TO TOP PLATE	10d TOENAILS @ 6" o.c.
BLK'G. BTWN. JOISTS TO TOP PL.	(3)10d TOENAILS
RAFTER/TRUSS TO TOP PLATE	(3)10d TOENAILS + (1) SIMPSON H2.5A
GAB. END TRUSS TO DBL. TOP PL.	10d TOENAILS @ 8" o.c.
R.T. w/ HEEL HT. 9 1/4" TO 12"	2x10 BLK EVERY 3RD BAY FASTENED TO DBL. TOP PLATE W/ 10d TOENAILS @ 6" O.C.
R.T. w/ HEEL HT. 12" TO 16"	2x12 BLK EVERY 3RD BAY FASTENED TO DBL. TOP PLATE W/ 10d TOENAILS @ 6" O.C.
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R.T. w/ HEEL HT. 24" TO 48"	LAP WALL SHTG, W/ DBL. TOP PL. & INSTALL ON TRUSS VERT FASTEN W/ 8d NAILS @ 6" O.C. PROVIDE 2x BLK @ EA. BAY AT TOP OF HEEL
DOUBLE STUD	10d NAILS @ 24" o.c.
DOUBLE TOP PLATE	10d NAILS @ 24" o.c.
DOUBLE TOP PLATE LAP SPLICE	(10)10d NAILS IN LAPPED AREA
TOP PLATE LAP @ CORNERS & INTERSECTING WALLS	(2)10d NAILS
WALL TO FOUNDATION	WALL SHTG. LAP W/ SILL PL. & FASTENED PER SHEAR WALL FASTENING SPEC.

Space for Architect Seal



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RESIDENCE FOR:

RICHARD ATTANASIO

15 SONGBIRD COVE

SERENITY


Job Number: STY5-0363-00 10/14/2024 GREG P. COORD_PHONE

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General Notes:

- . REFER TO SHEET ON.1 FOR GENERAL NOTES.
- 2. FLOOR JOISTS TO BE 14" I-JOISTS (TJI 210 EQUIVALENT) @ 19.2"o.c., UNLESS OTHERWISE NOTED.
- S. JOISTS ARE NOT TO BE PLACE DIRECTLY OVER INTERIOR PARALLEL WALL.
- (TO PREVENT UNEVEN HOOR DEFLECTION FROM OCCURRING)
 4. ADD'L JOISTS MAY BE LOCATED UP TO 2" AWAY FROM THE PARTITION WALL ABOVE IN CASES WHERE MECHANICAL PENETRATIONS

Key Notes:

302A BEARING WALL BELOW

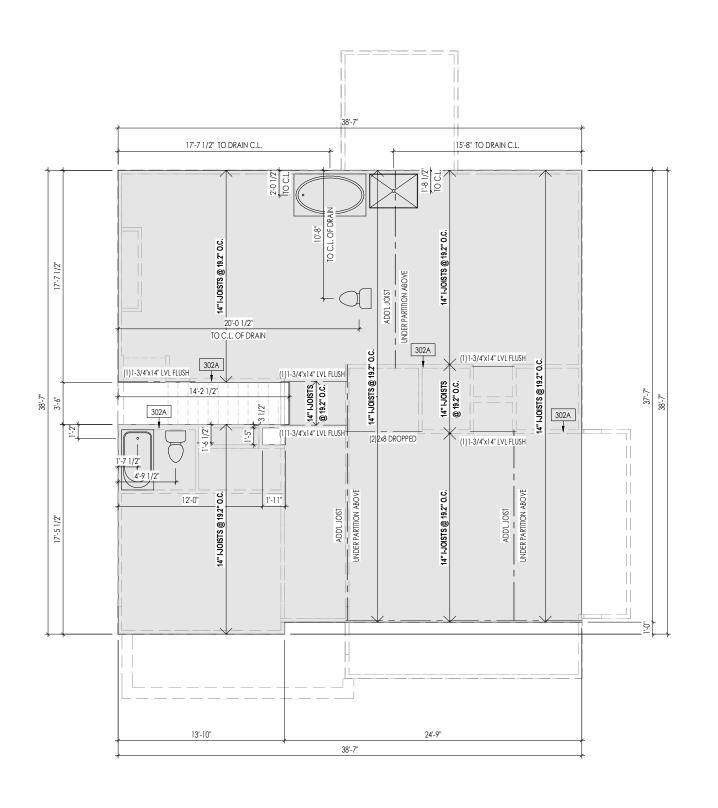Space for Architect Seal



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RESIDENCE FOR:

RICHARD ATTANASIO

15 SONGBIRD COVE

SERENITY

Job Number: STY5-0363-00 10/14/2024 GREG P. COORD_PHONE Drawing Scale: 1/8" = 1'0"


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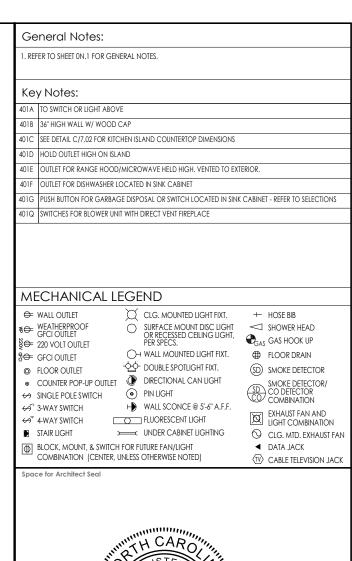
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CLASSIC

Plan No.:

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RESIDENCE FOR:

RICHARD ATTANASIO

15 SONGBIRD COVE

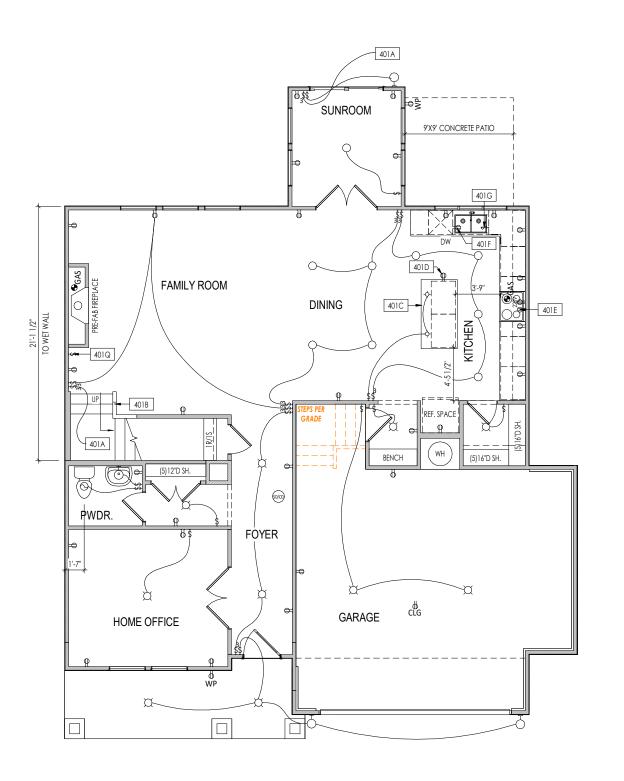SERENITY

Job Number: Drawing Date: 10/14/2024 GREG P. COORD_PHONE STY5-0363-00 Drawing Scale: 1/8" = 1'0"


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RESIDENCE FOR:

RICHARD ATTANASIO

15 SONGBIRD COVE

SERENITY

Job Number:	Drawing Date:	Coord Name:	Coord Phone:
STY5-0363-00	10/14/2024	GREG P.	COORD_PHON
House Name:	Drawi	ng Scale: 1/8" = 1'0"	Contract Drawn B
			EV
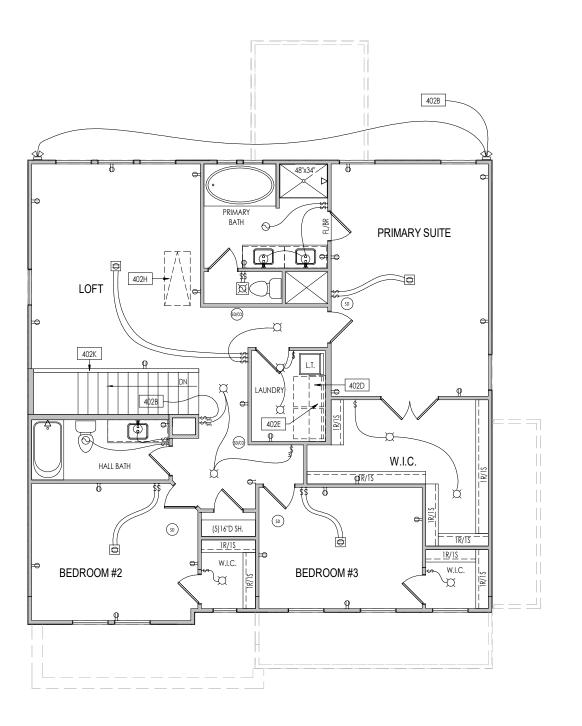
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2/2021 CDs Drawn By:

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WAB


4.02

Plan No.:

Second Floor Mechanical Pla

Elevation "C"


CLASSIC

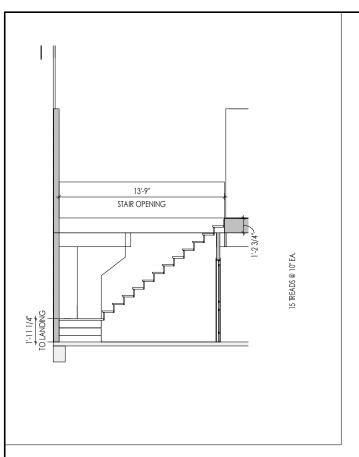

Section Thru Stairs
5.01 1/8" = 1'-0"



5.01 - Building Section 1 5.01 - Bu 5.01 1/8" = 1'-0"

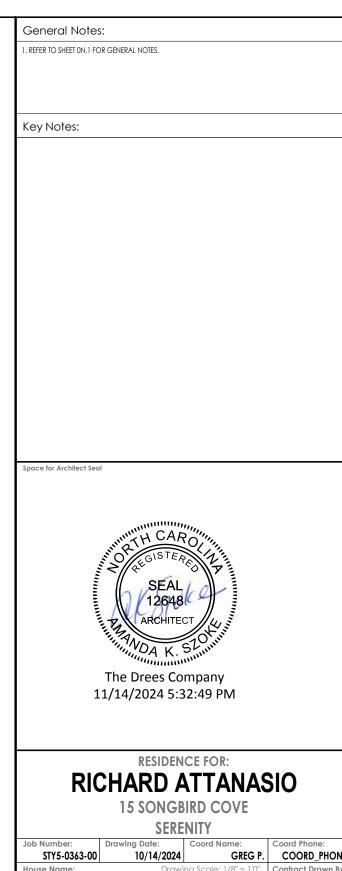

COORD_PHONE Drawing Scale: 1/8" = 1'0"

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ELEVATION 'C'

TOP OF FDN

TYPICAL TRIM:

6" FASCIA (ALL SIDES)

8" FRIEZE (FRONT ONLY, UNLESS OTHERWISE NOTED)

General Notes:

- . REFER TO SHEET ON.1 FOR GENERAL NOTES.
- 2. ROOFING MATERIAL PER SELECTIONS.
 3. CONTACT M&K ENGINEERING FOR HEADER SIZE/BRICK SUPPORT IF GRADE DROPS AND THE AMOUNT OF BRICK OVER GARAGE DOOR SHOWN ON CURRENT ELEVATION IS NO LONGER ACCURATE

Key Notes:

BRICK VENEER LINTEL SCHEDULE

SPAN	STEEL ANGLE SIZE	HEIGHT OF VENEER ABOVE LINTEL
Up to 3'-6"	L3-1/2 x3-1/2 x1/4	20 FT. MAX
Up to 6'-0"	L5x 3-1/2x 5/16 (LLV)	20 FT. MAX
Up to 8'-0"	L6x 3-1/2x 3/8 (LLV)	20 FT. MAX
9'-0"	L7x 4x 3/8 (LLV)	12 FT. MAX
*16'-0"	L7x 4x 3/8 (LLV)	3 FT. MAX
*16'-0"	L8x 4x 1/2 (LLV)	4-1/2 FT. MAX

ALL LINTELS <=6' SHALL HAVE 4" MINIMUM BEARING AT EACH END.

ALL LINTELS >=6' SHALL HAVE 8" MINIMUM BEARING AT EACH END.

* FASTENED TO HDR @ 1/3 SPAN POINTS THRU 1-1/2 "LONG VERTICALLY SLOTTED HOLES IN LINTEL W/ 1/2" DIA. x 3-1/2 " LONG LAG SCREWS. LOCATE LAG SCREWS @ MIDDLE OF SLOTTED HOLE & TIGHTEN SCREWS ENOUGH TO ALLOW MOVEMENT OF LINTEL.

**ANY LINTEL CONDITION NOT SPECIFIED ABOVE SHALL BE DESIGNED

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RESIDENCE FOR:

RICHARD ATTANASIO

15 SONGBIRD COVE

SERENITY


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TYPICAL TRIM:

6" FASCIA (ALL SIDES)

8" FRIEZE (FRONT ONLY, UNLESS OTHERWISE NOTED)

General Notes:

- 1. REFER TO SHEET ON.1 FOR GENERAL NOTES. 2. ROOFING MATERIAL PER SELECTIONS. 3. REFER TO LINTEL SCHEDULE AS NEEDED ON SHEET 6.01.

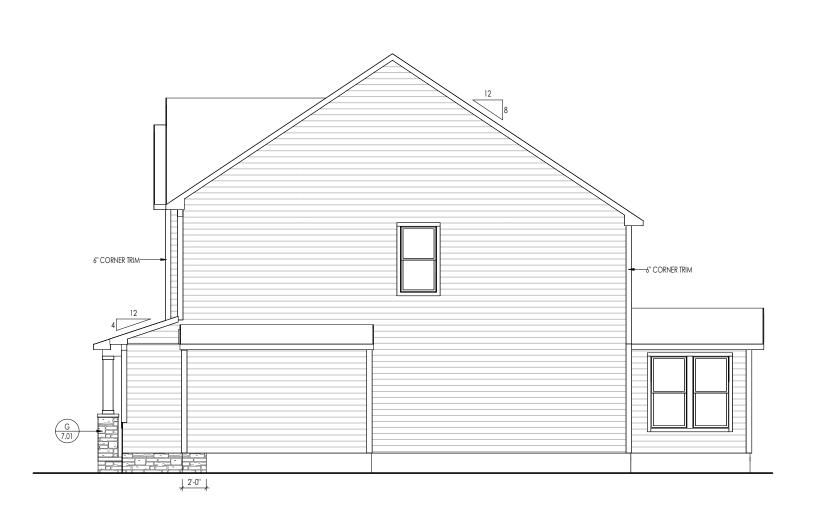Key Notes:

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RESIDENCE FOR:

RICHARD ATTANASIO

15 SONGBIRD COVE

SERENITY


Job Number: Drawing Date: STY5-0363-00 10/14/2024 GREG P. COORD_PHONE Drawing Scale: 1/8" = 1'0"

the AURORA II

CLASSIC Plan No.:



		-
		General Notes:
	TYPICAL TRIM:	1. REFER TO SHEET ON.1 FOR GENERAL NOTES.
	6" FASCIA (ALL SIDES)	ROOFING MATERIAL PER SELECTIONS. REFER TO LINTEL SCHEDULE AS NEEDED ON SHEET 6.01.
	8" FRIEZE	Key Notes:
	(FRONT ONLY, UNLESS OTHERWISE NOTED)	
		Space for Architect Seal
6" CORNER TRIM————————————————————————————————————		space to Architectural
6		annunnan,
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		O GEGISTERE THE
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		RESIDENCE FOR:
		RICHARD ATTANASIO
		15 SONGBIRD COVE
		SERENITY
		Job Number: Drawing Date: Coord Name: Coord Phone: STY5-0363-00 10/14/2024 GREG P. COORD_PHONE
		House Name: Drawing Scale: 1/8" = 1'0" Contract Drawn By: EWT
		the ALIDODA II Series:
		the AURORA II Series: CLASSIC Plan No.:
		Born on Date: 07/02/2021 CDs Drawn By: WAB
		DICCS 6.03
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TYPICAL TRIM:

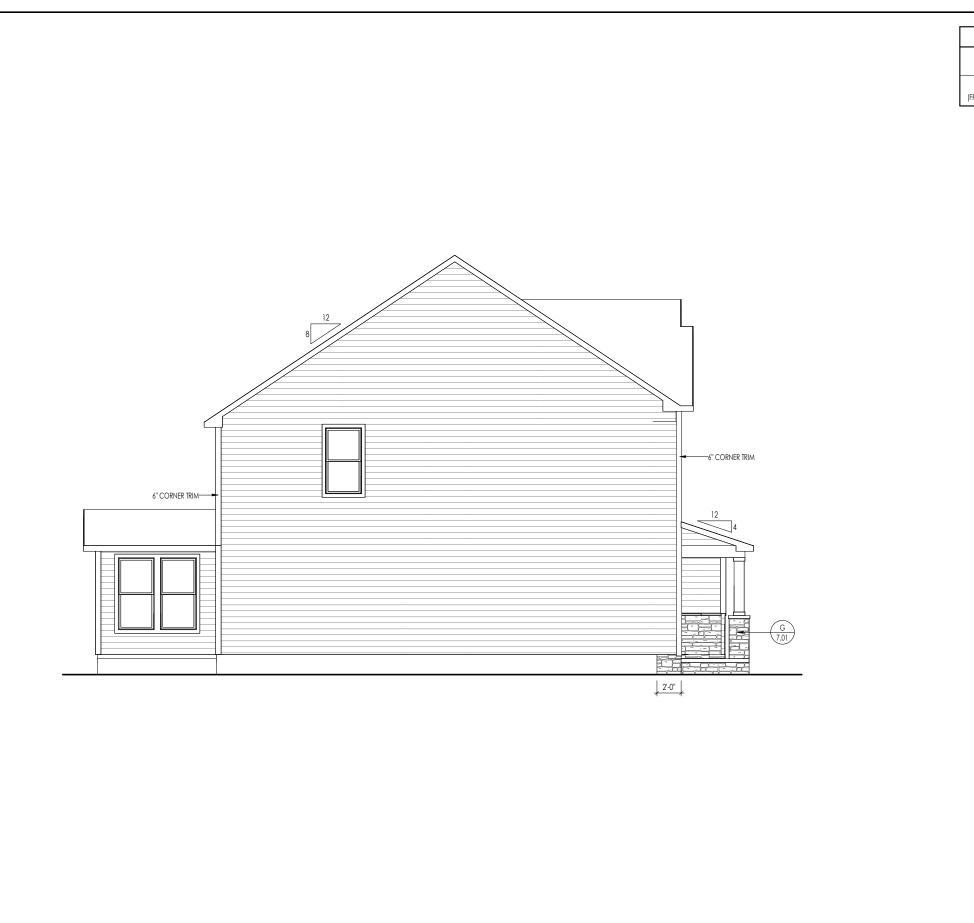6" FASCIA (ALL SIDES)

8" FRIEZE (FRONT ONLY, UNLESS OTHERWISE NOTED)

General Notes:

- 1. REFER TO SHEET ON.1 FOR GENERAL NOTES. 2. ROOFING MATERIAL PER SELECTIONS. 3. REFER TO LINTEL SCHEDULE AS NEEDED ON SHEET 6.01.

Key Notes:

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RESIDENCE FOR:

RICHARD ATTANASIO

15 SONGBIRD COVE

SERENITY

Job Number: STY5-0363-00 10/14/2024 GREG P. COORD_PHONE Drawing Scale: 1/8" = 1'0"

the AURORA II


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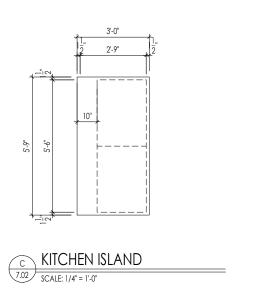
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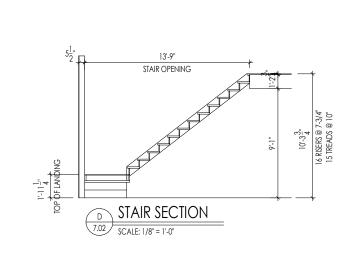
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15 SONGBIRD COVE

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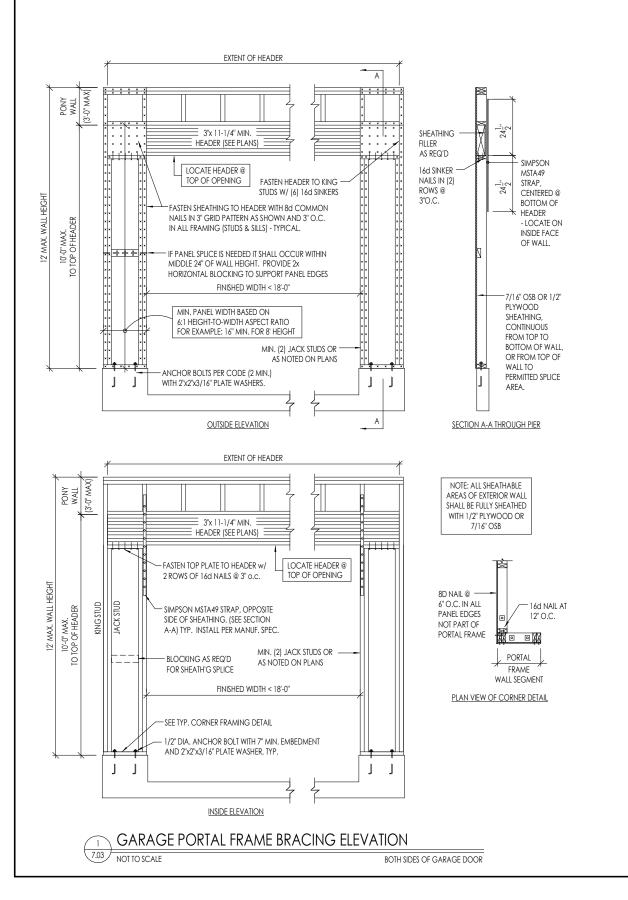
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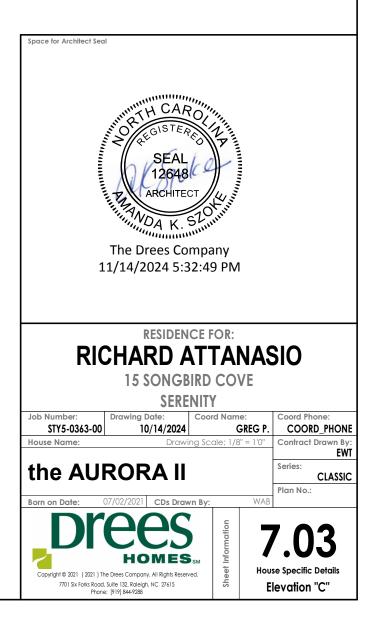
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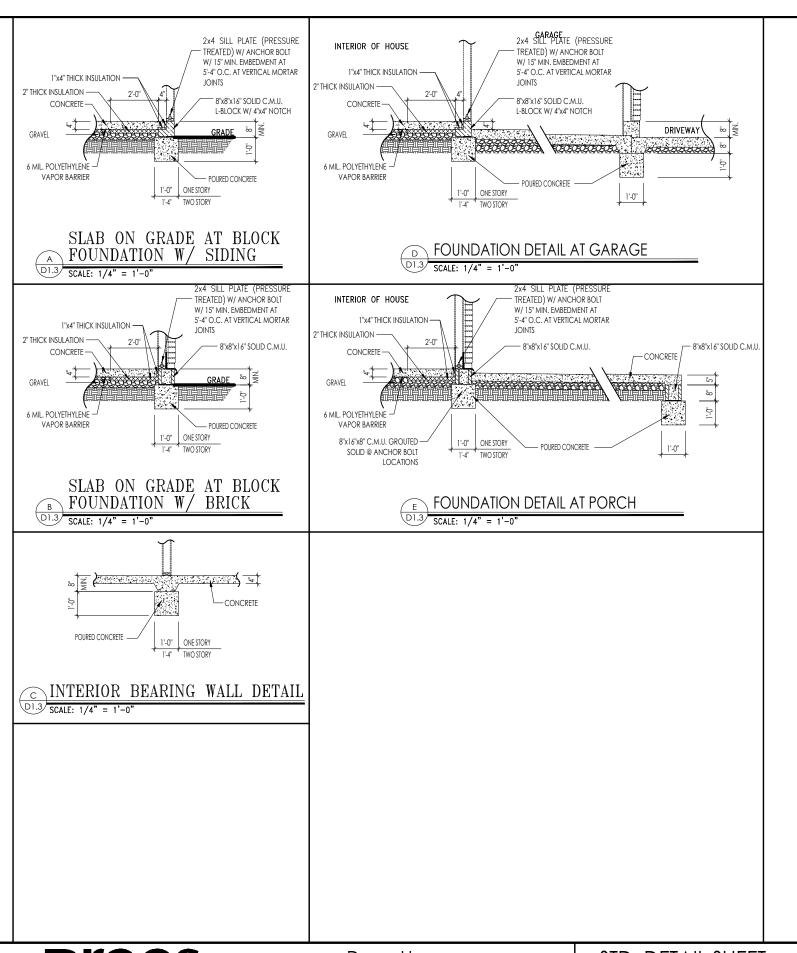


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STD. DETAIL SHEET	Std. By:	ALL
SID. DEIAIL SITELI	Chk. By:	ARC
REGION:	Std. Date:	08/19/09
RALEIGH	Date of	


Sheet Description:

CONC. BLOCK SLAB ON GRADE DETAILS

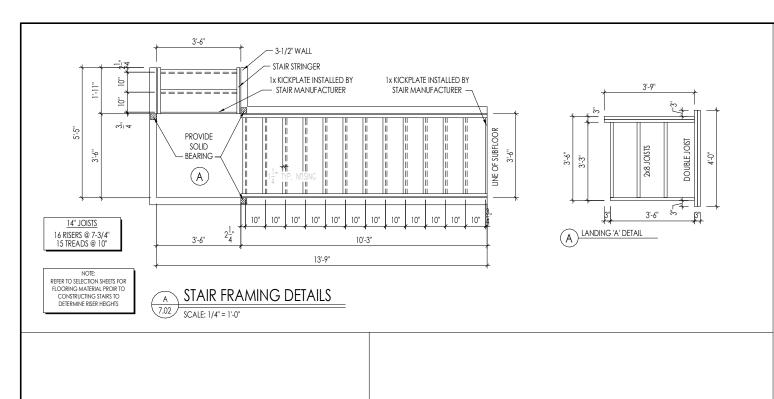RALEIGH - D-SHEETS.dwg Jul 31, 2023 - 4:07pm

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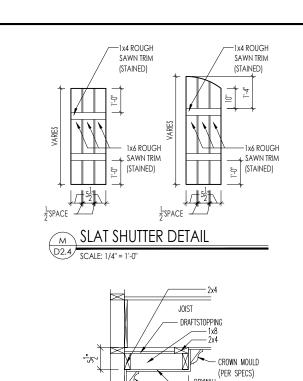
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D2.2

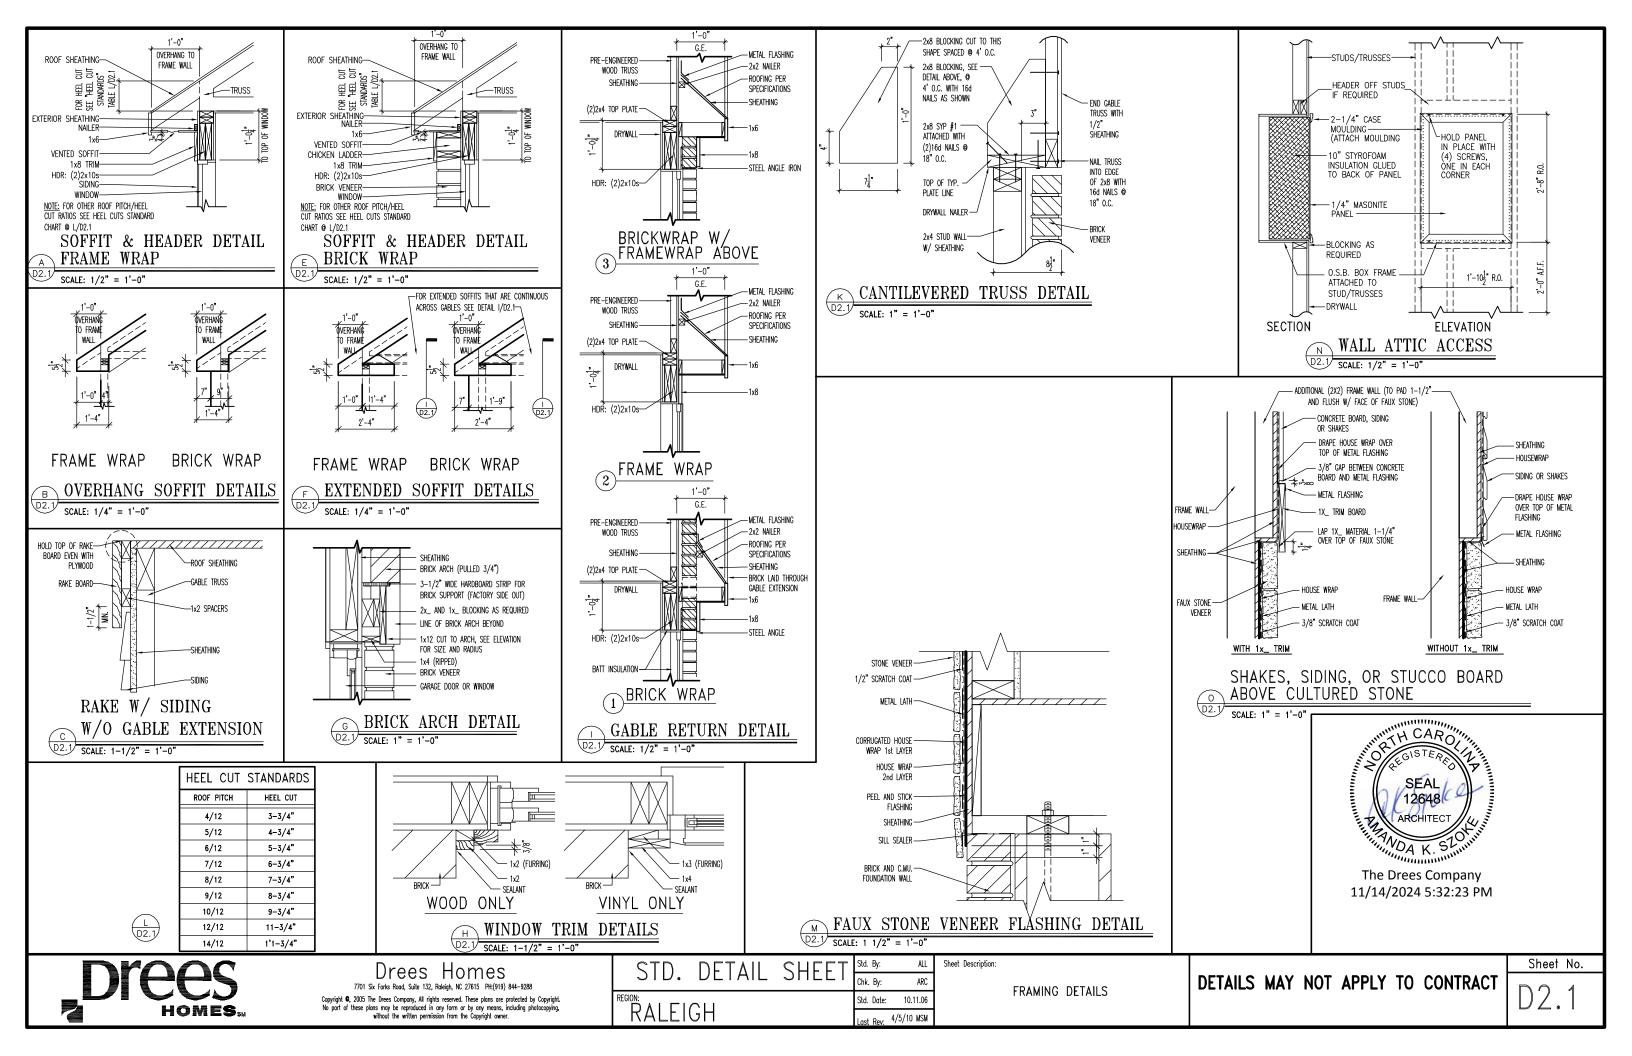


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— CROWN MOULD (PER SPECS)









The Drees Company 11/14/2024 5:32:24 PM

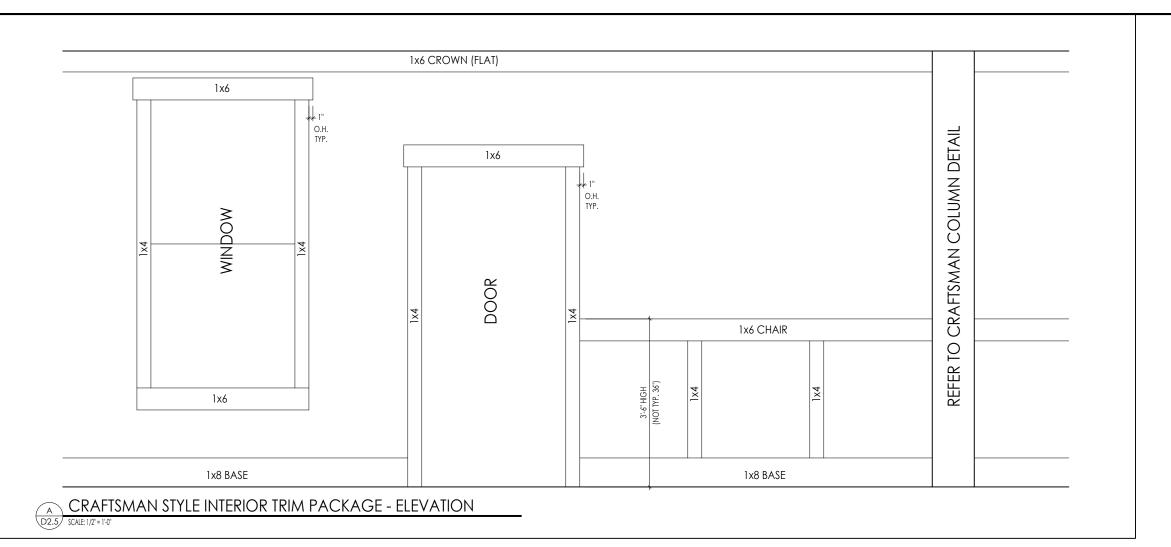

D2.5

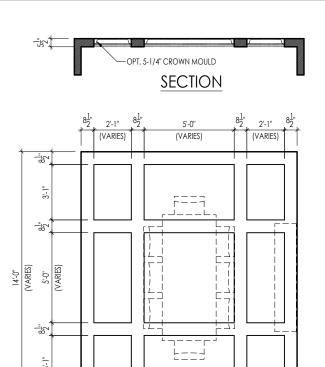

¹2¹1

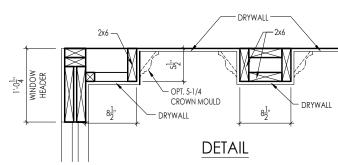

Note: Ceiling treatment details will tray down into space on enclosed rooms located on the 1st floor. On enclosed rooms on the 2nd floor, the ceiling treatment will tray up into the roof truss system. On 2-story spaces, the ceiling treatment will tray down into the space and require an appropriate sized header to capture the ceiling detail return.

SECTION TYPICAL PLAN

-8x8 BOX BEAM


On enclosed rooms on the 2nd floor, the ceiling treatment will tray up into the roof truss system. On 2-story spaces, the ceiling treatment will tray down into the space and require an appropriate sized header to capture the ceiling detail return.

Note: Ceiling treatment details will tray down into space on enclosed rooms located on the 1st floor.



12'-0" (VARIES)

TYPICAL PLAN

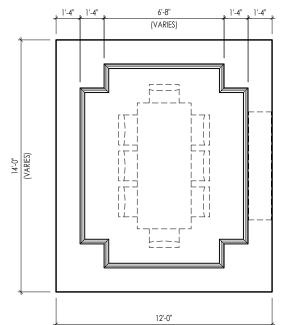


TYPICAL PLAN

header to capture the ceiling detail return.



Note: Ceiling treatment details will tray down into space on enclosed rooms located on the 1st floor. On enclosed rooms on the 2nd floor, the ceiling treatment will tray up into the roof truss system. On 2-story spaces, the ceiling treatment will tray down into the space and require an appropriate sized

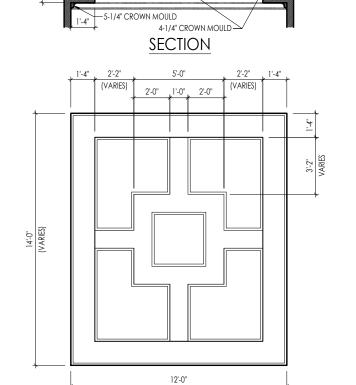


12x6 BOX BEAM

TYPICAL PLAN



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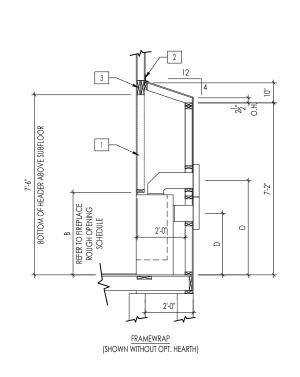


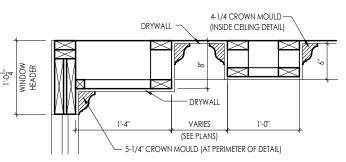
DETAIL

Note: Ceiling treatment details will tray down into space on enclosed rooms located on the 1st floor. On enclosed rooms on the 2nd floor, the ceiling treatment will tray up into the roof truss system. On 2-story spaces, the ceiling treatment will tray down into the space and require an appropriate sized header to capture the ceiling detail return.

CEILING TREATMENTS


SCALE: AS NOTED



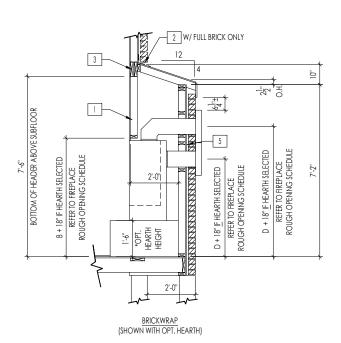


FIREPLACE DOGHOUSE SECTIONS

SCALE: 1/4" = 1'-0"

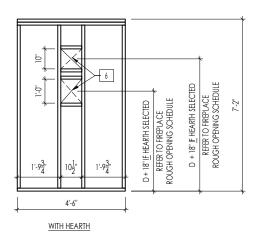


DIRECT VENT REAR WALL FRAMING

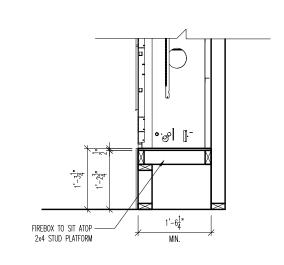

RAVE FIREPLACE PLATFORM DETAIL

SCALE: 1/2" = 1'-0"

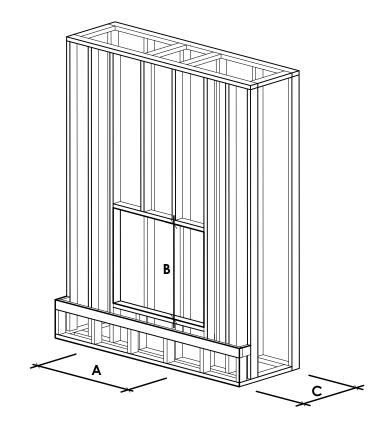

NOTE: PROVIDE OSB SHEATHING WHEN STONE VENEER SELECTED


FIREPLACE ROUGH OPENING SCHEDULE					
	MODEL	А	В	С	D
FIREPLACE MANUFACTURER		(FIREBOX REQUIRED WIDTH)	(FIREBOX REQUIRED HEIGHT) *ADD 18" W/ OPT. HEARTH	(FIREBOX REQUIRED DEPTH - INTERIOR REAR WALL TO FRONT EXTERIOR WALL)	(VENT CENTERLINE HEIGHT *ADD 18" W/ OPT. HEARTH
	SLIMLINE SL-7	42"	38-1/4"	16-1/4"	TOP 40" SIDE 26-7/8"
HEAT & GLO	COSMO 42	49"	32-3/4"	17-3/4"	TOP ONLY 47-1/16"
	NOVUS 33	39"	34-7/8"	19-5/8"	TOP 40" SIDE 23-1/2"
	COURTYARD 36	43-3/8"	44-1/8"	18-3/8"	SEE MANUFACTURER'S SPEC
HEARTH & HOME	COURTYARD 42	48-1/2"	34-1/4"	20-1/4"	SEE MANUFACTURER'S SPEC
REAKIR & ROME	LANAI *(NOT IN CINCY/NKY)	57-3/4"	39-1/2"	17-5/8"	SEE MANUFACTURER'S SPEC
	RAVE	49"	32-3/4" *RAISED 15-1/4"*	18-1/4"	TOP ONLY 46-1/2"
		all dimensions are in inches			

General Notes

REFER TO SHEET ON.1 FOR GENERAL NOTES. 2. VERIFY FIREPLACE MODEL AND HEARTH SELECTION WITH CUSTOMER'S SELECTIONS.

Key Notes

- 1 FUTURE FRAMING FOR F.P. OPENING AFTER INSULATION HAS BEEN INSTALLED IN EXT. WALLS
- 2 FLASHING
- 3 HEADER PER PLAN
- 4
- 5 1" AIRSPACE
- 6 BOX OUT FOR FLUE (REFER TO SELECTIONS FOR FIREPLACE AND OPENING HEIGHT)

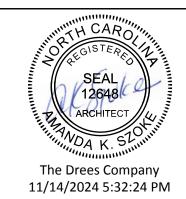



The Drees Company 211 Grandview Drive Fort Mitchell, Kentucky 41017 PH:(859) 578-4200

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Std. Drawn By:	MRPH	Sheef Description: SC	CALE: VARIES
		FIREPLACE DETAIL	
Std. Date:	02.29.20		
Date of Last Rev:	7.10.2023	g:\architecture\cincinnati\cinti standard drawings\fireplace\fireplace detail sheets.dwg	

Sheet No.

F-1

RALEIGH WINDOW SCHEDULE

* MEETS EMERGENCY ESCAPE & RESCUE OPENING REQUIREMENTS

		MI Windows	and Doors			T				OPENING REQUIREMENTS
Drees General Callout	Window Type	Capitol Call No.	Series Rough Opening	Call No.	Rough Opening	Drees General Callout	Call No.	Rough Opening	Call No.	Rough Opening
1660	SINGLE/DOUBLE HUNG	CW3500 1/8 x 6/0		Call No.	Rough Opening		Call No.	Kough Opening	Call No.	Kough Opening
1670	SINGLE/DOUBLE HUNG	CW3500 1/8 x 7/0	20" x 84"							
1860	SINGLE/DOUBLE HUNG	CW3500 1/8 x 6/0	20" x 60-1/4"							
2030 2040	SINGLE/DOUBLE HUNG SINGLE/DOUBLE HUNG	CW3500 2/0 x 3/0 CW3500 2/0 x 4/0	24 X 36 24" x 48"							
2050	SINGLE/DOUBLE HUNG	CW3500 2/0 x 5/0	24" x 60-1/4"							
2060	SINGLE/DOUBLE HUNG	CW3500 2/0 x 6/0	24" x 72"							
2070 2430	SINGLE/DOUBLE HUNG SINGLE/DOUBLE HUNG	CW3500 2/0 x 7/0 CW3500 2/4 x 3/0	24" X 84" 28" x 36"							
2440	SINGLE/DOUBLE HUNG	CW3500 2/4 x 4/0	28" x 48"							
2450	SINGLE/DOUBLE HUNG	CW3500 2/4 x 5/0	28" x 60-1/4"							
2460 2830	SINGLE/DOUBLE HUNG SINGLE/DOUBLE HUNG	CW3500 2/4 x 6/0 CW3500 2/8 x 3/0	28 X /2 32" x 36"							
2840	SINGLE/DOUBLE HUNG	CW3500 2/8 x 4/0	32" x 48"							
2850	SINGLE/DOUBLE HUNG	CW3500 2/8 x 5/0	32" x 60-1/4"							
* 2860 3030	SINGLE/DOUBLE HUNG SINGLE/DOUBLE HUNG	CW3500 2/8 x 6/0	32" X /2" 36-1/4" v 36"							
3040	SINGLE/DOUBLE HUNG	CW3500 3/0 x 3/0 CW3500 3/0 x 4/0	36-1/4" x 48"							
* 3050	SINGLE/DOUBLE HUNG	I CW3500 3/0 x 5/0	I 36-1/4" x 60-1/4"I							
* 3060 * 3070	SINGLE/DOUBLE HUNG SINGLE/DOUBLE HUNG	CW3500 3/0 x 6/0 CW3500 3/0 x 7/0								
* 3470	SINGLE/DOUBLE HUNG	CW3500 3/0 x 7/0	40" x 84"							
1050 FIXED		910T 5/0 x 1/0	59-5/8" x 11-1/2"							
1640 FIXED 2020 FIXED		910T 4/0 x 1/8 CW3500 2/0 x 2/0	47-1/4" x 19-1/2"							
2030 FIXED		CW35002/0 x 2/0 CW3500SL 2/0 x 3/	0 24" x 36"							
2040 FIXED		CW3500SL 2/0 x 4/	0 24" x 48"							
2050 FIXED		CW3500SL 2/0 x 5/								
2816 FIXED 2860 FIXED		910TSL 2/6 x 1/8 CW3500 3/0 x 6/0	29-1/4" x 19-1/2" 36" x 72"							
3016 FIXED		910TSL 3/0 x 1/8	35-1/4" x 19-1/2"							
3020 FIXED		910TSL 3/0 x 2/0	35-1/4" x 23-1/2"							
3030 FIXED 3040 FIXED		CW3500P 3/0 x 3/0 CW3500P 3/0 x 4/0	36-1/4 X 36 36-1/4" x 48"							
3050 FIXED		CW3500P 3/0 x 5/0	36-1/4" x 60-1/4"							
3060 FIXED		CW3500P 3/0 x 6/0	36-1/4" x 72"							
3070 FIXED 4010 FIXED		CW3500P 3/0 x 7/0 910T 4/0 x 1/0	36-1/4 X 84 47-1/4" x 11-1/2"							
4020 FIXED		910T 4/0 x 2/0	47-1/4" x 23-1/2"							
4030 FIXED		CW3500P 4/0 x 3/0	48" x 36"							
4040 FIXED 4044 FIXED		CW3500P 4/0 x 4/0 CW3500P 4/0 x 4/4	48 X 48 48" x 52"							
4050 FIXED		CW3500P 4/0 x 5/0	48" x 60-1/4"							
4060 FIXED		CW3500P 4/0 x 6/0	48" x 72"							
4070 FIXED 5030 FIXED		CW3500P 4/0 x 7/0 CW3500P 5/0 x 3/0								
5040 FIXED		CW3500P 5/0 x 4/0	60" x 48"							
5060 FIXED		CW3500P 5/0 x 6/0	60" x 72"							
5070 FIXED 6020 FIXED		CW3500P 5/0 x 7/0 910T 6/0 x 2/0	60" x 84" 71-5/8" x 23-1/2"							
6050 FIXED		CW3500P 6/0 x 5/0	72" x 60-1/4"							
6060 FIXED		CW3500P 6/0 x 6/0	72" x 72"							
3'-0" HALF ROUNI 4'-0" HALF ROUNI		CW3500 3/0 HC CW3500 3/0 HC	36-1/4" 48"							
5'-0" HALF ROUNI)	CW3500 3/0 HC	60"							
2020 OCTAGON		CW3500 2/0 OCT	60"							
2'-4" QUARTER RO 3'-0" QUARTER RO		CW3500 2/4 QC CW3500 3/0 QC	28" 36-1/4"							
J-0 QUARTER RO	סאטע	CW3300 3/0 QC	J 20-1/7							



Drees Homes

7701 Six Forks Road, Suite 132, Raleigh, NC 27615 PH:(919) 844-9288

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Sheet Description:

WINDOW SCHEDULE

Sheet No.

MOULDED MILLWORK SCHEDULE

LAST REVISED 11/22/11

	HEADERS		
Drees General Callout	Nuwood	Fypon	
ARCHED HEADER D1	H8xxEFR	N/A	
ARCHED HEADER D1K	H8xxEFKR	N/A	
ARCHED HEADER D2	H8xxEFTR	N/A	
ARCHED HEADER D2K	H8xxEFTKR	N/A	
ARCHED HEADER D3	AH10xx	WCHSEGxxX10	
ARCHED HEADER D3K	N/A	WCHSEGxxX10K	
ARCHED HEADER D4	AR5xx	ARxxX6M	
ARCHED HEADER D4K	AR5xxK	ARxxX6MK	
ARCHED HEADER D5	AR10xxEC	ARxxX6METAR6C	
ARCHED HEADER D5K	AR10xxECK	ARXXX6METAR6CK	
ARCHED HEADER D6	AR10xxC	ARxxX10MC	
ARCHED HEADER D6K	AR10xxCK	ARXXX10MCK	
ARCHED HEADER D7K	H7xxEF-4K	N/A	
ARCHED HEADER D8	AR14xxC	ARXXX14MC	
ARCHED HEADER D8K	AR14xxCK	ARXXX14MCK	
ARCHED HEADER DOR	H9xxE	WCHARSxx13	
CROSSHEAD A1	H9xx	WCHXXX9N	
CROSSHEAD ATK	H9xxK	WCHXXX9N WCHXXX9NK	
CROSSHEAD BT		WCHXXX9NK WCHXXX14BT	
	H14xxBT H14xxBTK		
CROSSHEAD B1K		WCHxxX14BTK WCHxxX12	
CROSSHEAD B2	H12xx		
CROSSHEAD B2K	H12xxK	WCHxxX12K	
CROSSHEAD C1	H18xxBT	WCHxxX14BT	
CROSSHEAD C1K	H18xxBTK	WCHxxX14BTK	
CROSSHEAD C2	H18xxBT-PA	LDCHxxX18	
CROSSHEAD C2K	H18xxBTK-PA	LDCHxxX18K	
CROSSHEAD Z-E1-HDR	Z-E1-HDR	Z-E1-HDR	
Crosshead z-e2-hdr	Z-E2-HDR	Z-E2-HDR	
Crosshead z-e3-hdr	Z-E3-HDR	Z-E3-HDR	
CROSSHEAD Z-E3-ARCHHDR	Z-E3-ARCHHDR	Z-E3-ARCHHDR	
CROSSHEAD Z-E3-CLHDR	Z-E3-CLHDR	Z-E3-CLHDR	
CROSSHEAD Z-E5-HDR	Z-E5-HDR	Z-E5-HDR	
WINDOW HEADER A1	H6xx	WCHxxX6	
WINDOW HEADER A1K	H6xxK	WCHxxX6K	
WINDOW HEADER B1	H9xx-2	WCHxxX9N	
WINDOW HEADER B1K	H9xx-2K	WCHxxX9NK	
WINDOW HEADER B2	H9xxBT	WCHXXX10NBT	
WINDOW HEADER B2K	H9xxBTK	WCHXXX10NBTK	
WINDOW HEADER C1	H9xx	CCAXXX10	
WINDOW HEADER C1K	H9xxK	CCAXXX10K	
WINDOW HEADER C1K	H9xxT	WCHxxX9T	
WINDOW HEADER C2K	H9xxTK	WCHXXX9TK	
WINDOW HEADER C2N	H12xxBT	WCHXXX91K WCHXXX10BT	
WINDOW HEADER C3 WINDOW HEADER C3K	H12xxBTK	WCHXXX10B1 WCHXXX10BTK	
WINDOW HEADER C4	H14xxBT	WCHxxX14BT	
WINDOW HEADER D1	H7xxF-4	N/A	
WINDOW HEADER D1K	H7xxF-4K	N/A	
WINDOW HEADER D2K	H9xxK-1	N/A	
WINDOW HEADER Z-W1	Z-W1	Z-W1	
window header z-w3	Z-W3	Z-W3	
window header z-w3K	Z-W3K	Z-W3K	
window header z-w3d	Z-W3D	Z-W3D	
WINDOW HEADER Z-W4	Z-W4	Z-W4	
WINDOW HEADER Z-W4K	Z-W4K	Z-W4K	
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PILASTERS					
Drees General Callout	Nuwood	Fypon			
FLUTED PILASTER A1	PL7xxF	PIL7Xxx			
FLUTED PILASTER B1	PL9xxF	PIL9Xxx			
FLUTED PILASTER C1	PL11xxFM	PIL11Xxx			
Panel Pilaster A2	PL7xxP	PIL7XxxDP			
PANEL PILASTER B2	PL9xxP	PIL9XxxDP			
Panel Pilaster C2	PL11xxPM	PIL11XxxDP			
PILASTER D1	M311-9	PIL10XxxA			
PILASTER D2	M323-9	N/A			
PILASTER Z-E1-PIL	Z-E1-PIL	Z-E1-PlL			
PILASTER Z-E2-PIL	Z-E2-PIL	Z-E2-PIL			
PILASTER Z-E3-PIL	Z-E3-PIL	Z-E3-PIL			
PILASTER Z-PIL-EXT	Z-PIL-EXT	Z-PIL-EXT			
PLAIN PILASTER A3	PL7xxS	PIL7XxxP			
PLAIN PILASTER B3	PL9xxS	PIL9XxxP			
PLAIN PILASTER C3	PL11xxS	PIL11XxxP			
PLINTH D1	PF10	ADD "P" TO END OF PILASTER			
PLINTH D2	P14.5	N/A			
LOUVERS					

Drees General Callout	Nuwood	Fypon	Mid-America
CATHEDRAL LOUVER D1	CLV1224	CLV12X24	
CATHEDRAL LOUVER D1T	CLV1224TRIM4	CLV12X24X4F	
CATHEDRAL LOUVER D2	CLV1432	CLV14X32	
CATHEDRAL LOUVER D2T	CLV1432TRIM4	CLV14X32X4F	00 44 1422
CATHEDRAL LOUVER D3	CLV2232	CLV22X32	
CATHEDRAL LOUVER D3T	CLV2232TRIM4	CLV22X32X4F	
HALF CIRCLE LOUVER D1	HRLV32	HRLV32X16	
HALF CIRCLE LOUVER D1T	HRLV32TRIM4	HRLV32X4F	
HALF CIRCLE LOUVER D2	HRLV36	HRLV36X18	
HALF CIRCLE LOUVER D2T	HRLV36TRIM4	HRLV36X4F	00 43 2234
OCTAGONAL LOUVER D1	OLV24	OLV24	
OCTAGONAL LOUVER D12	OLV24TRIM4	OLV24X4F	
OVAL LOUVER D1	OLV2537	OLV37X25	
OVAL LOUVER DIT	OLV2537TRIM4	OLV37X25X4F	
RECTANGUAR LOUVER D1	LV1224V	LV12X24	00 45 1218
RECTANGUAR LOUVER D1T	LV1224VTRIM4	LV12X24-4F	00 45 1218
RECTANGUAR LOUVER D2	LV1636V	LV16X36	
RECTANGUAR LOUVER D2T	LV1636VTRIM4	LV16X36-4F	
RECTANGUAR LOUVER D3	LV2436V	LV24X36	
RECTANGUAR LOUVER D3T	LV2436VTRIM4	LV24X36-4F	
RECTANGUAR LOUVER D4	LV2424V	LV24X24	
RECTANGUAR LOUVER D4T	LV2424VTRIM4	LV24X24-4F	
ROUND LOUVER D1	RLV18	RLV18	
ROUND LOUVER D1T	RLV18TRIM4	RLV18X4F	
ROUND LOUVER D2	RLV22	RLV22	
ROUND LOUVER D2T	RLV22TRIM4	RLV22X4F	
TRIANGULAR LOUVER D1		TRLVxxX36	00 47 0x0x
<u> </u>		1	

BRACKETS

Drees General Callout	Nuwood	Fypon
EXTERIOR BRACKET D1	BR437	N/A
EXTERIOR BRACKET D2	DB102	DTLB6X4X6
EXTERIOR BRACKET D3	BR304 (7" WIDE)	BKT24X24X7
EXTERIOR BRACKET D4	BR455	N/A
EXTERIOR BRACKET D5	BR300-1	BKT12X12X6
EXTERIOR BRACKET D6	BR300	BKT12X12
EXTERIOR BRACKET D7	BR409	BKT16X18X3
EXTERIOR BRACKET D8	BR413	DTLB5X5X3
EXTERIOR BRACKET D9	TBD	BKT11X20
EXTERIOR BRACKET D10	TBD	BKT12X24X3
EXTERIOR BRACKET D11	BR435	BKT25X27
EXTERIOR BRACKET D12	BR404	BKT16X30X4
EXTERIOR BRACKET D13	BR23.13x10.13x5.5	N/A
GABLE BRACKET D1	TBD	DTLB6X4X6R(OR L)PITCH
GABLE BRACKET D2	BR423-x:12	BKT5X20
GABLE BRACKET D3	BR424-x:12	BKT5X20 (CUT 2" PROJECTION)
		•

MOULDINGS					
Drees General Callout	Nuwood	Fypon			
BAND MOULD D1	M210-16	MLD612-12			
BAND MOULD D2	M301-16	MLD220-16			
BARGE MOULD D1	WM210	WM210			
CASE MOULD D1	M320-16	MLD226-16			
CASE MOULD D2	N/A	MLD244-12			
CROWN MOULD D1	M404-16	MLD572-16			
DENTIL MOULD D1	M105-16	MLD310-16			
DENTIL MOULD D2	M108-8	MLD353-8			
HALF ROUND MOULD D1	N/A	MLD605-12			
PANEL MOULD D1	M310-8 OR 16	MLD612-12			

PEDIMENTS / COMBO HEADERS

Drees General Callout	Nuwood	Fypon
BROW COMBO D1	BCxx	CSAPxx
PEAK PEDIMENT D1	Pxx-4 (6:12)	PCPxx
PEAK PEDIMENT Z-E1-PED	Z-E1-PED	Z-E1-PED
PEAKED COMBO D1	PCxx-4	CPCPxx
RAMS HEAD PEDIMENT D1	Rxx	RHPxx00
ROUND PEDIMENT D1	Bxx-4	PSPxx
SUNRISE COMBO D1	SCxx-4	CSPxx
VICTORIAN PEDIMENT D1	VPxx	DVPxx w/ SWDHxxXxx
	· · · · · · · · · · · · · · · · · · ·	

WINDOW DECORATION

Drees General Callout	Nuwood	Fypon
HALF CIRCLE SUNBURST D1	SPxxxx	SWDHxxXxx
PALLADIAN WINDOW D1	H9AR10-xx xx" FL/FR	ARxxX10MFLxxx
PALLADIAN WINDOW D1K	H9AR10-xxK xx" FL/FR	ARxxX10MFLxxx with K10TM
PALLADIAN WINDOW D2	H9AR10SPxxxx	ARxxX10MFLxxx with
		SWDHxxXxx
PALLADIAN WINDOW D2K	H9AR10SPxxxxK	ARxxX10MFLxxx with
		SWDHxxXxx and K10TM
PEAKED CAP HEADER D1	N/A	CHPCxxX15
PLAIN SEGMENT D1	SPxxxxP	PSPxx
SEGMENT SUNBURST D1	SPxxxx	SWDHxxXxx

ACCESSORIES

Drees General Callout	Nuwood	Fypon
GABLE D1	PGDx12	GPA (width X height)
KEYSTONE D1	KY14F-3	KY14
KEYSTONE D2	KYHM9F	К9М
WREATH D1	N/A	WAB34



MOULDED MILLWORK SCHEDULE

Sheet No.