#### **REVISION LOG**

REVISION:001

ADJUST OPTION SQUARE FOOTAGES TO ACCURATELY SHOW THE DIFFERENCES FROM THE BASE PLAN SQUARE FOOTAGE TOTALS.

REVISION:002

RELOCATE FRONT DOOR TO ALIGN W/ GARAGE WALL. ADJUST FOUNDATION AND OPTIONS

accordingly.

2. Add wall & door at foyer for optional smart door delivery center.

3. Note door into main house w/ optional smart door delivery center to be 3068 3/4

CHANGE DOOR WIDTH FROM 2/6 TO 2/4 @ BATH #3, BED #3 CLOSET, BATH #2, BED #2

CLOSET AND OPT. BED #5.

6. FUP PANTRY SHELVES, DELETE DOOR ACCESSED FROM DROP ZONE & ADD 2/4 DOOR

ACCESSED FROM MESSY KITCHEN.
DIMENSION TO CENTER OF TRIPLE WINDOWS ONLY.

MAKE ALL STUD POCKETS 4 1/2".

ADD NOTE AT FIREPLACE FOR A "42"X39" R.O." FOR FIREBOX

9. AUD NOTE AT PREPARE FOR A 42 AS9 K.U. FOR TREBUS.
10. RELOCATE WALL UNDER STAR & NOTE @ 95" WALL HT (VLF.).
11. ADD GOURMET KITCHEN, ALTERNATE KITCHEN AND ALTERNATE GOURMET KITCHEN OPTIONS.
12. DELETE 2ND WINDOW NEAREST TO CORNER @ POCKET OFFICE OPTION.
13. DELETE OPTIONAL PAINTY DOOR LOCATION.
14. CHANGE SIDELOAD GARAGE FRONT WINDOWS FROM 5/0 HT TO 6/0 HT.

15. ADD 8" DEEP CHASE BEHIND 2ND FL LINEN CLOSET @ HALL.

16. RELOCATE WATER HEATER AT SIDELOAD GARAGE UNDER NEW LINEN CLOSET CHASE.

17. DECREASE DEPTH OF CHASE BEHIND OWNERS BATH WATER CLOSET TO 10" TO INCREASE WATER CLOSET DEPTH TO 6"-1".

18. MOVE OWNERS VANITY WALL UP TO ALLOW ROOM IN LAUNDRY FOR CHASE @ LINEN, OPT 30"
CAB W/ OPT L.T. AND WASHER/DRYER.

19. ADD PULL DOWN STAIR IN LAUNDRY. NOTE "25 1/2" X 54 1/2" R.O."

20. ADD 18"X24" CHASE IN OWNERS WIC CLOSET @ SHOWER WALL.

21. MAKE BATH/2 VANITY 60".

22. MAKE MC © BED/2 5"-4" DEEP, ADDING 3" TO BATH #2.

33. MOVE BATH/2 TOLET, TUB AND WINDOW 3" TOWARD FRONT OF HOUSE.

24. MAKE WINDOW IN BED #2 CLOSET TEMPERED.

DATF: 2/4/2022

REVISION:003

DIMENSION TRIPLE STUD POCKETS
RELOCATE ISLAND PER REDLINES.
REMOVE WINDON IN MESSY KITCHEN
FULL HEIGHT WALL AT END OF CABINETS ON GARAGE ADJACENT WALL.
REMOVE UNDER-COLUNIER SIDE WALLS IN ISLAND.
SHOW AND CALL OUT DROP ZONE BENCH AS 18" DEEP.

VERIFY CASE OF PRINGS ARE 3/0X6/8 ON 1ST FLOOR.
ELIMINATE ALT KITCHEN
MATCH BASE PLAN LOCATION FOR WATER HEATER IN SIDE LOAD GARAGE.

3/4 LITE ENTRY DOOR.

10. Syf die Lynn book.

11. Create Sower Option with 18" seat.

12. Resize Standard Shower to 60x36. Extend full height wall at Standard Shower.

13. Add 2x6 wall just inside exterior wall for opt. Super Shower w/ opt. 2nd floor.

13. AUU ZAG WALL JUST INSUE EXTENDIN MALL FOR OPT. SUPEN STUMEN MY OPT. ZMD FLOUR.

14. ALL LIBEN CALLED OUT AS (4) SHELVES.

15. POCKET DOORS CHANGE TO STANDARD 2/4 IN OWNER'S WC TO LAUNDRY.

16. EXTEND REAR PORCH 6" SO BEAM BEARS ON CAFE WALL.

17. CHANGE COLUMNS TIO 6X6 P.T. WITH IX WRAP FOR TRADITIONAL ELEVATION.

18. CHANGE REAR PORCH COLUMNS TIO 6X6 P.T. POST, NO WRAP.

19. CHANGE ENTRY DOOR TO 3/4 LITE

20. EXTEND PORCH SLAB 4" AT FRONT AND EXTEND AROUND CORNER 20" TO SUPPORT STONE VENEER.

21. REMOVED HALF WALLS AT KITCHEN ISLAND AND UPDATED PER CABINET PROVIDER
22. CHANGED THE BASE OWNER'S BATH WINDOW TO 4010
24. CHANGED THE OWNER'S BATH OPTION SHOWER W/18" SEAT WINDOW TO 4010

24. CHANGED THE OWNER'S BATH OPTION SUPER SHOWER MINDOWS TO (2)3010
25. CHANGED THE OPTION 2ND FLOOR OWNER'S BATH WINDOW TO 4010
26. CHANGED THE OPTION 2ND FLOOR OWNER'S BATH OPTION SUPER SHOWER WINDOWS TO (2)3010

20. CHANGED 2ND FLOOR WINDOW OVER PORCH TO BE 2040 ALL ELEVATIONS
28. UPDATED THE WINDOW HEADER AT THE STAIR LANDING TO BE 8'-10" ABOVE LANDING
29. RE-CENTERED GEORGIAN PORCH TO BE CENTERED ON THE WINDOW ABOVE
30. ADDED AN EXTENDED PORCH OPTION TO THE TRADITIONAL ELEVATION ONLY

REVISION:004

CHANGED 2ND FLOOR WINDOW OVER PORCH TO BE 2040 ALL ELEVATIONS UPDATED THE WINDOW HEADER AT THE STAIR LANDING TO BE 8"-10" ABOVE LANDING CHANGED SIZE OF GEORGIAN PORCH TO BE CENTERED ON THE WINDOW ABOVE CHANGED STIZE OF GEORGIAN COLUMNS FROM ROUND TO SQUARE ADDED AN EXTENDED PORCH OPTION TO THE TRADITIONAL ELEVATION ONLY ADDED ELECTRICAL PLAN SHEETS

REVISION:005

ADD "STEM WALL" TO CRAWL ELEVATION TITLES AND ADD NOTE "SEE FOUNDATION

PAGES FOR FOUNDATION TYPE". UPDATE SHEET TITLES

REVISION:007

DATE: 11/28/2023

ADD 6" TO THE SIDE OF THE PATIO/DECK/COVERED PORCH TO THE BEAM FOR THE ROOF OF THE COVERED PORCH HAS A BEARING POINT.

Redlines completed 11-Sep-24 - DP

## Lot 8 - Ballard Road

1817 Ballard Road Fuquay-Varina, NC 27526

# **NC.**



Total Heated: 2710 Total Unheated: 783

# PLAN 4 The Selma RH **'ENGLISH COUNTRY'**

Sheet No.	Sheet Description
0.0	Cover Sheet
1.1	Foundation (Slab)
1.1.1	Foundation Options (Slab)
1.2	Foundation (Crawl)
1.2.1	Foundation Options (Crawl)
1.3	Foundation (Stem Wall Slab)
1.3.1	Foundation Options (Stem Wall Slab)
2.1	First Floor Plan
2.1.1	First Floor Plan Options
2.2	Second Floor Plan
2.2.1	Second Floor Plan Options
2.4	Covered Porch Plans & Elevations (Slab)
2.4.1	Covered Porch Plans & Elevations (Crawl/Stem Wall)
2.5	Side Load Garage Elevations (Slab)
2.5.1	Side Load Garage Elevations (Crawl/ Stem Wall)
3.1	Front & Rear Elevations (Slab)
3.1.1	Front & Rear Elevations (Crawl/Stem Wall)
3.2	Side Elevations (Slab)
3.2.1	Side Elevations (Crawl/Stem Wall)
3.3	Roof Plan
5.1	First Floor Electrical
5.1.1	First Floor Options Electrical
5.2	Second Floor Electrical
5.2.1	Second Floor Options Electrical

	'ENGLISH COUNTRY' ELEVATION				
	UNHEATED	HEATED			
FIRST FLOOR	0	1194			
SECOND FLOOR	0	1452			
RONT PORCH (CRAWL)	147	0			
FRONT PORCH (SLAB)	158	0			
REAR PATIO/DECK	210	Ü			
2 CAR GARAGE	415	0			
SUBTOTALS	930	2646			
TOTAL UNDER ROOF	35	76			
Ol	ptions				
	UNHEATED S.F.	HEATED S.F.			
OPT. POCKET OFFICE	0	+64			
TIREF LACE BUIVIF OUT	0	134			
COVERED PATIO/DECK	210	0			
Ord Car Carage	. 202	. 40			

## **DESIGN CRITERIA:**

THIS PLAN IS TO BE BUILT IN CONFORMANCE WITH THE 2018 NORTH CAROLINA STATE BUILDING CODE: RESIDENTIAL CODE

DIMENSIONS SHALL GOVERN OVER SCALE, AND CODE SHALL GOVERN OVER DIMENSIONS.

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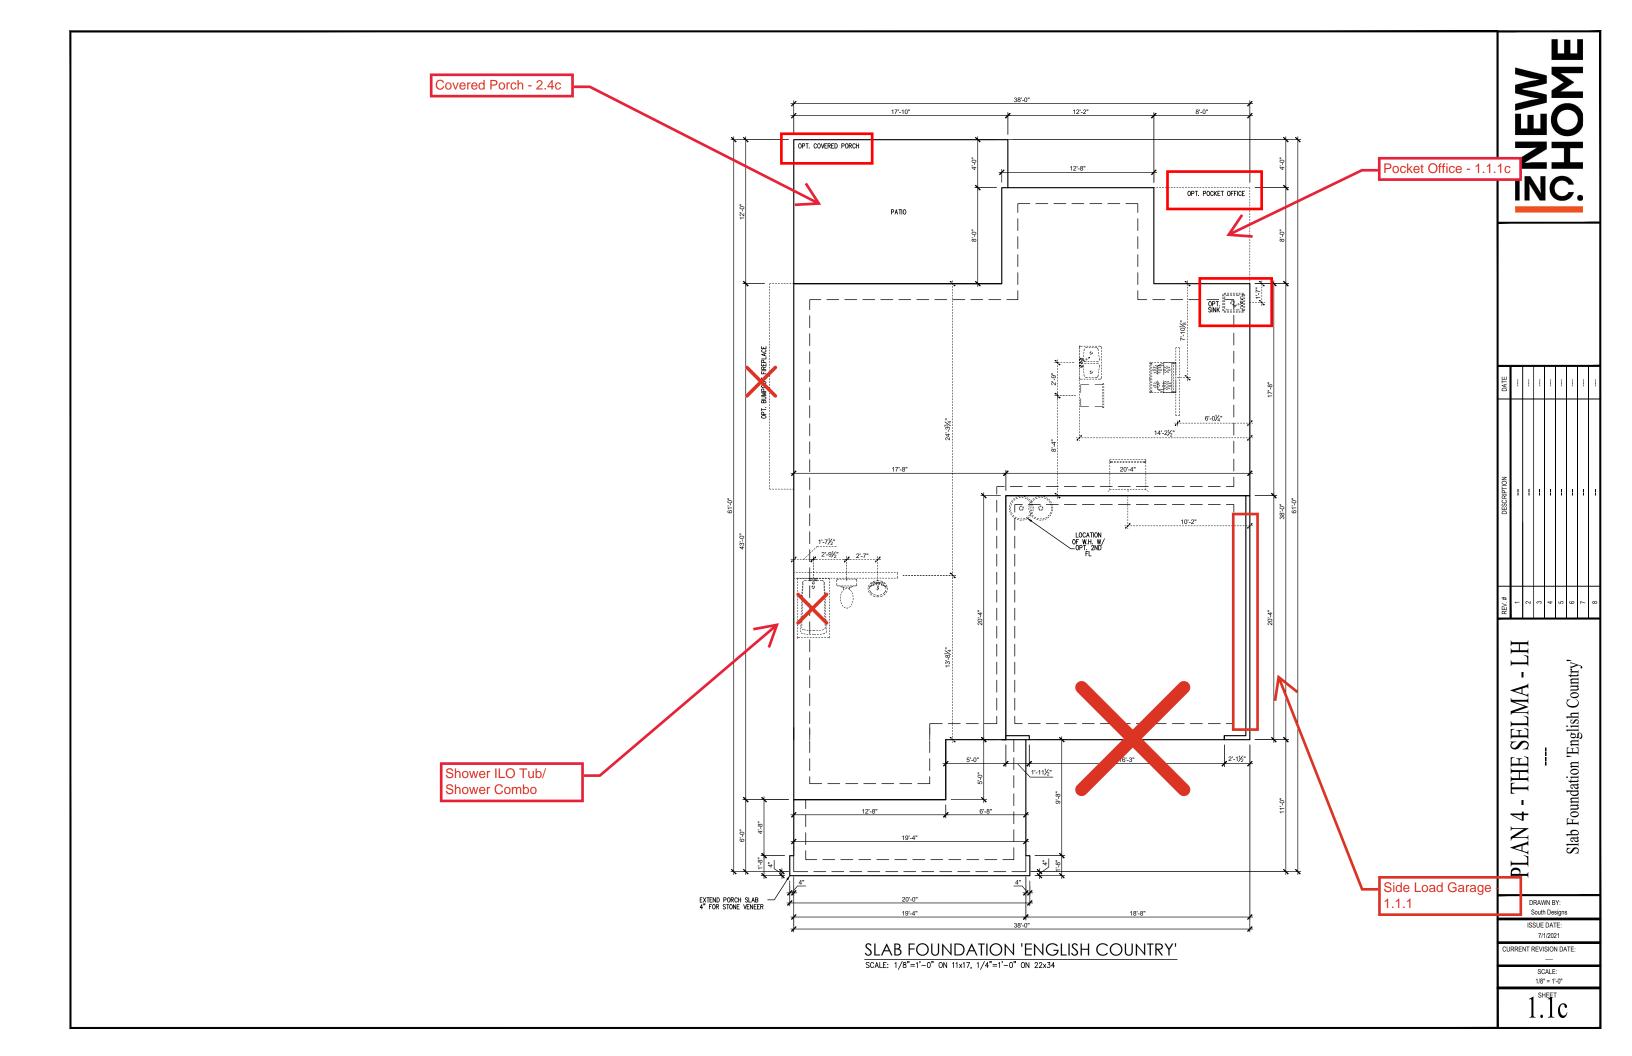
1 Cover Sheet 'English Country' THE SELMA 4


DRAWN BY: South Designs ISSUE DATE: 7/1/2021


**PLAN** 

RRENT REVISION DATE

1/8" = 1'-0"



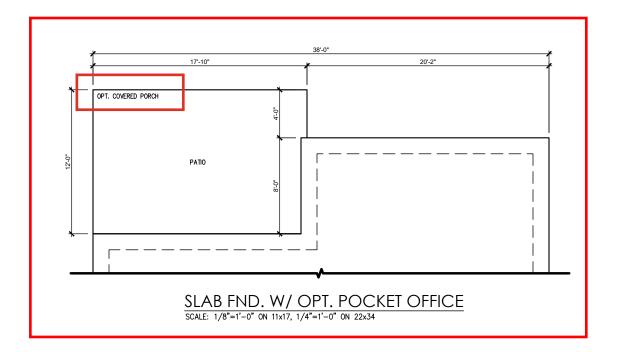

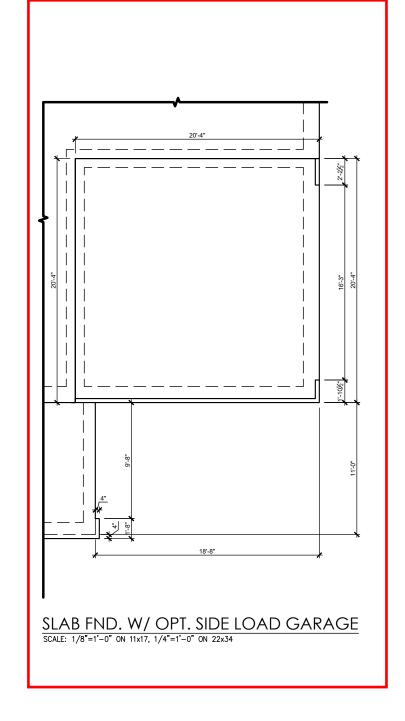

	REV.#	DESCRIPTION	DATE
	1		
THE SELIMIT	2		
	3		
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	9		
Slab Foundation Ontions 'English Country'	2		
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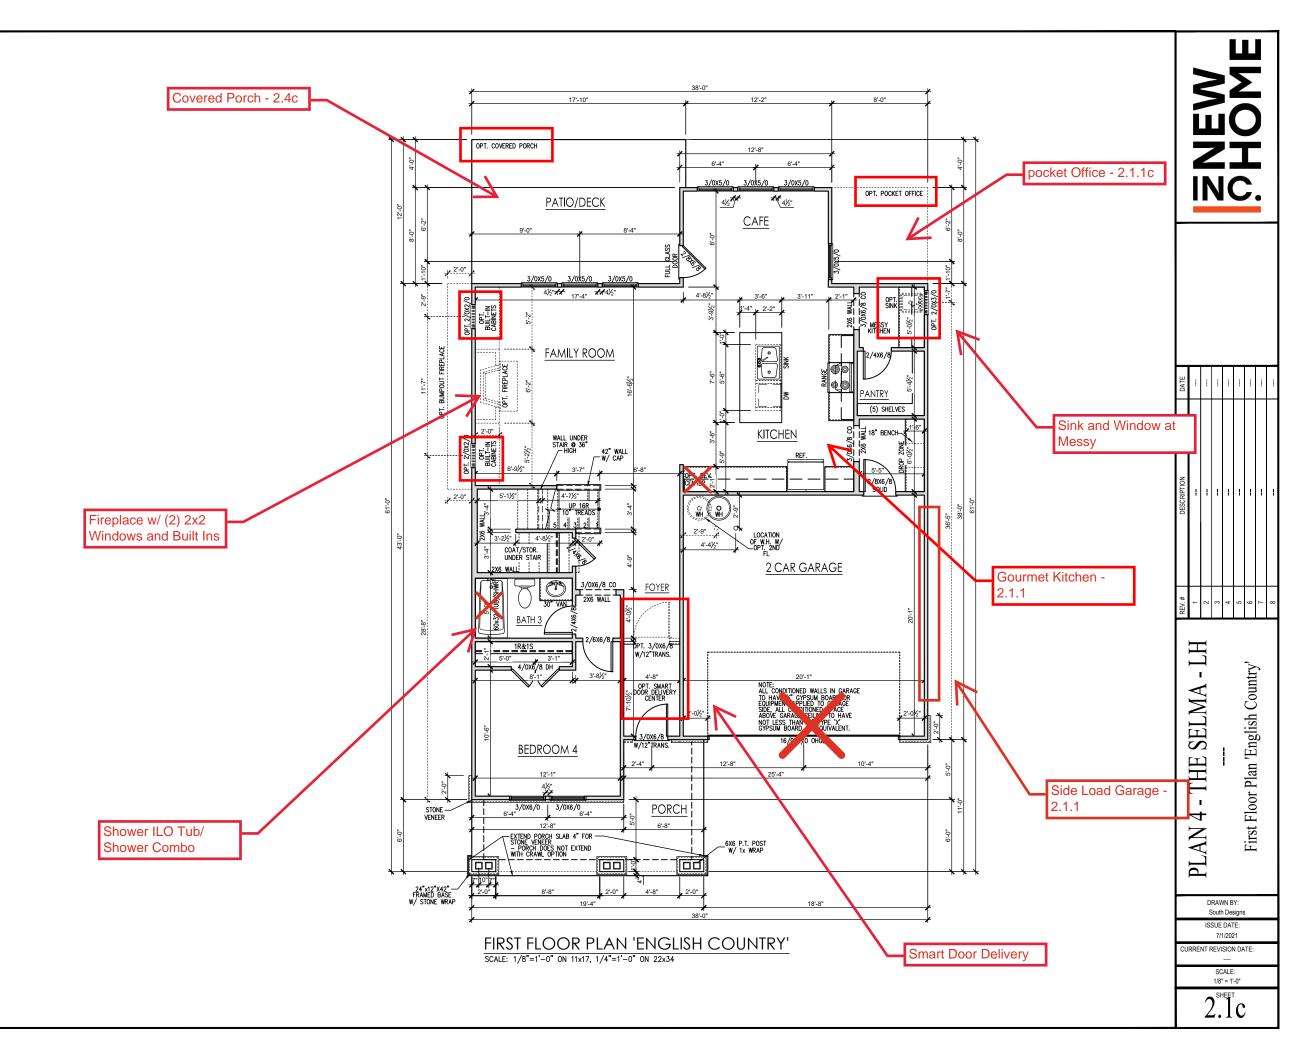
DRAWN BY: South Designs

ISSUE DATE: 7/1/2021

CURRENT REVISION DATE:


General Floor Plan Notes shall apply unless noted otherwise on plan.


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- 10. Handrails and Guards at stairs shall be 34" above the finished surface of the ramp surface of the stair. Handrails at landings and overlooks of multilevel spaces shall be 36" above finished floor. Guards (pickets or balusters) shall be spaced with no more than 4" between guards.
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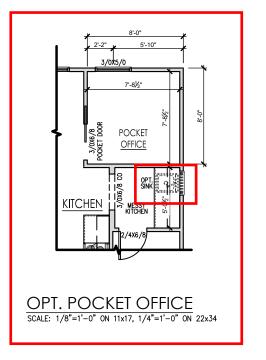



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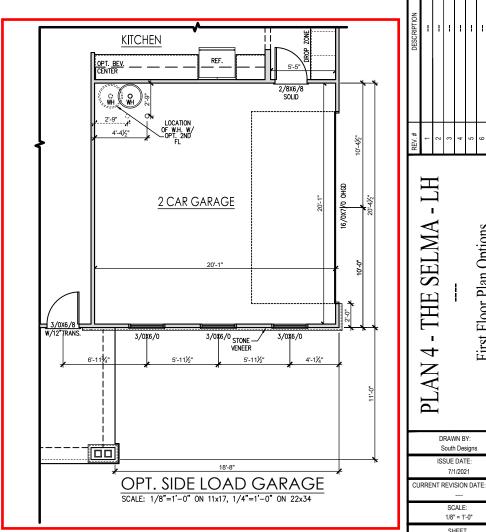
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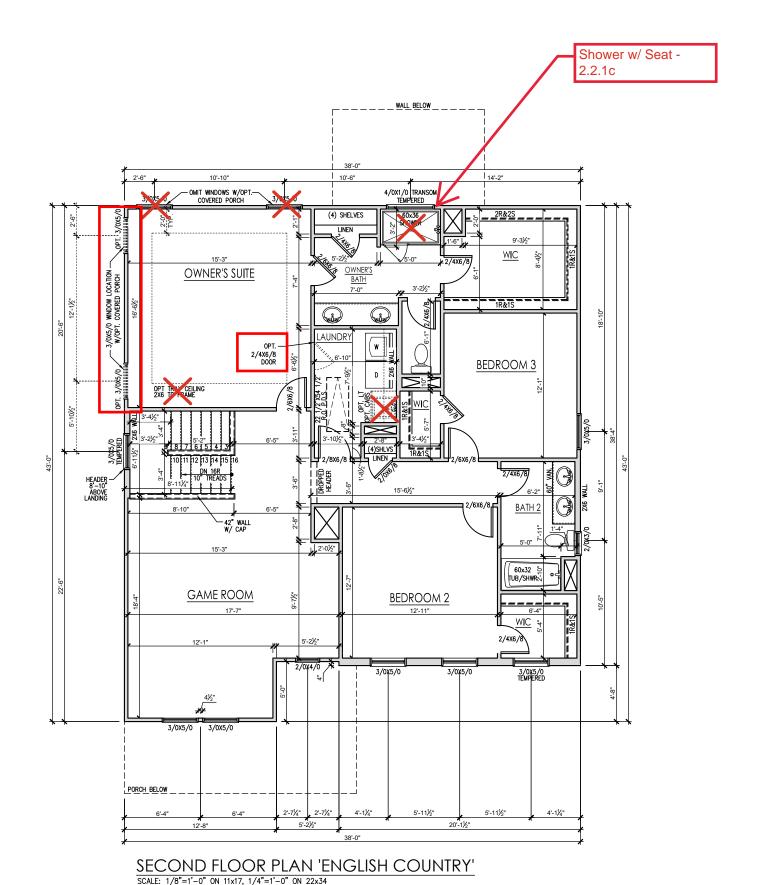




First Floor Plan Options
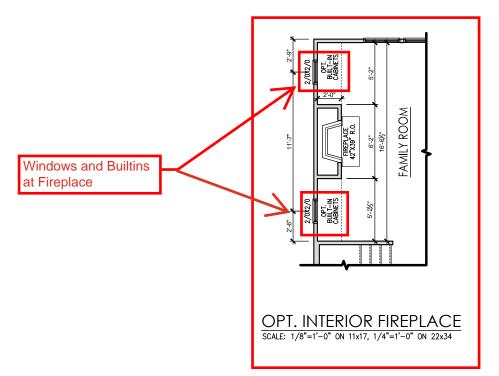
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PLAN 4 - THE SELMA - LH
--Second Floor Plan 'English Country'

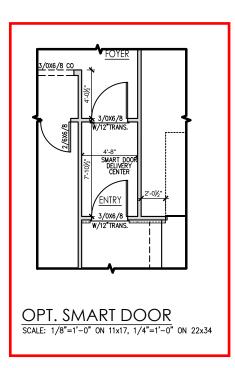
DRAWN BY: South Designs ISSUE DATE: 7/1/2021

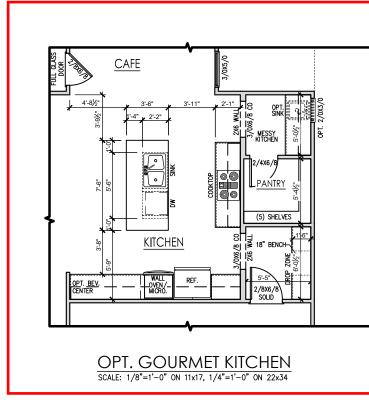JRRENT REVISION DATE:

1/8" = 1'-0"

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PLAN 4 - THE SELMA - I


Second Floor Plan Options

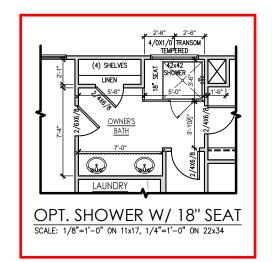DRAWN BY: South Designs ISSUE DATE:

7/1/2021 CURRENT REVISION DATE:

> SCALE: 1/8" = 1'-0"

2.2.1c

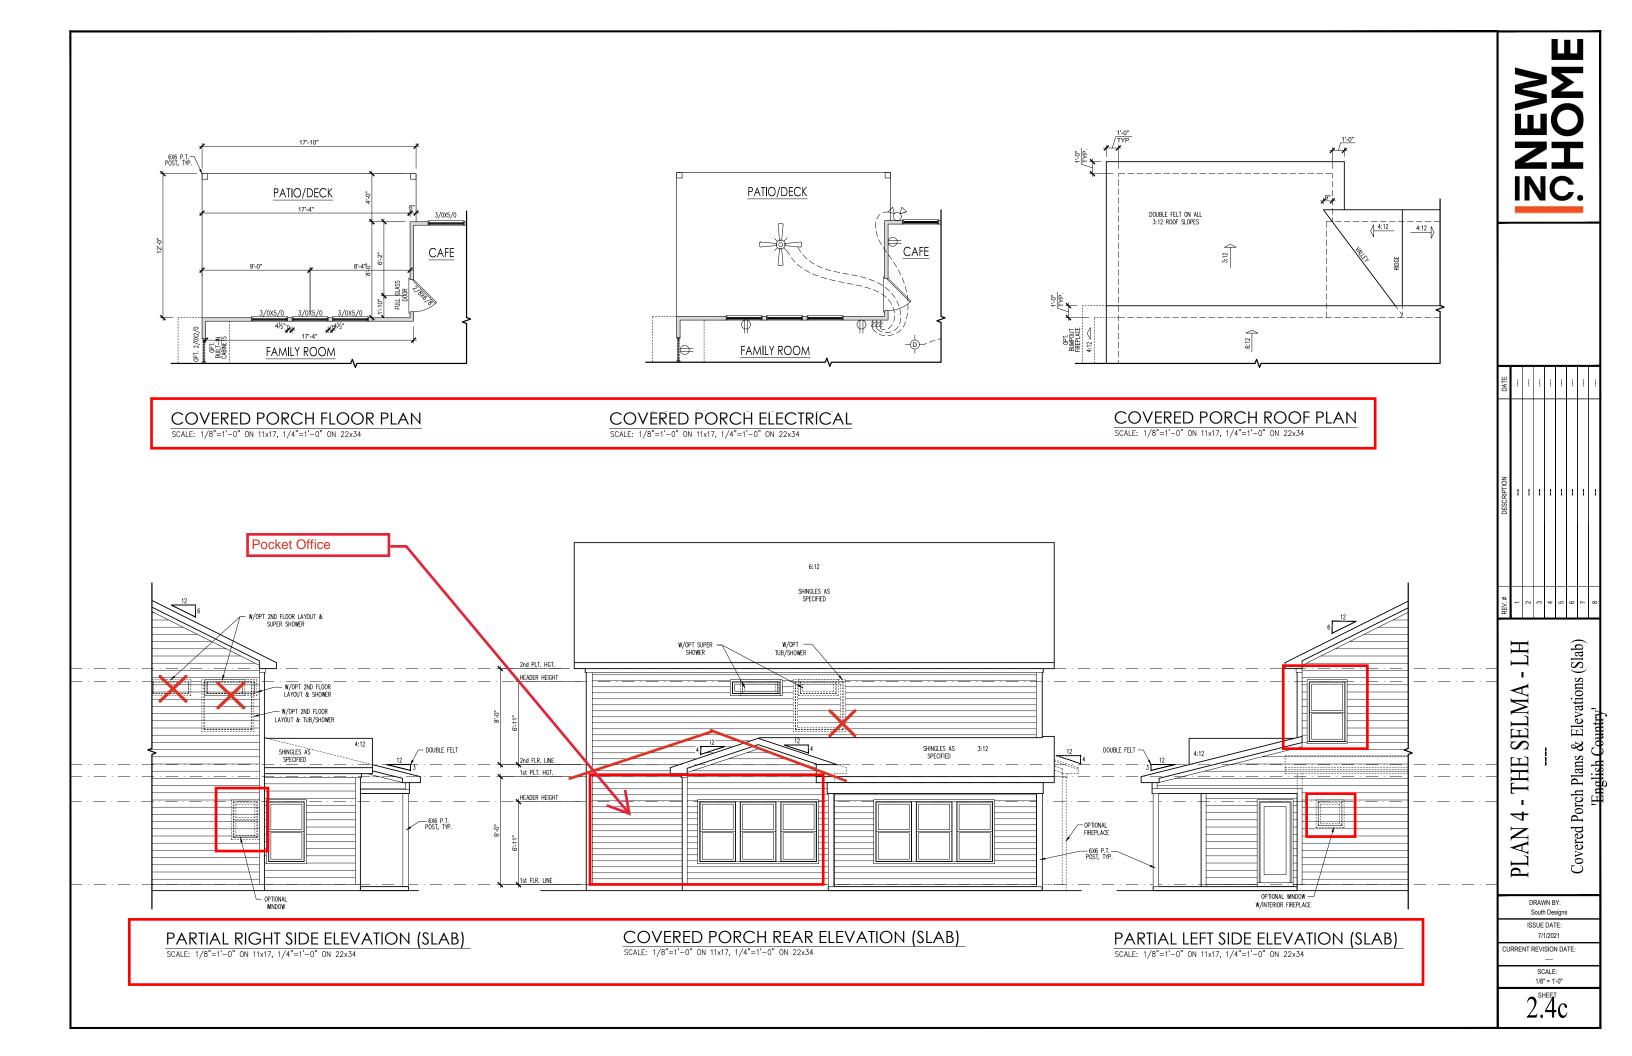

#### **General Elevation Notes**

General Elevation Notes shall apply unless noted otherwise on plan.

- Roof shall be finished with architectural composition shingles with slopes as noted on plan.
- Ridge Vent shall be provided and installed on all ridges greater than 6' in length per manufacturer's specifications.
- 3. Soffit Vent shall be continuous soffit vent
- House Wrap, "tyvek" or approved equal shall be installed over entire exterior wall per manufacturer's specifications and recommendations.
- Flashing shall be provided above all door and window openings, above finish wall material changes and at wall surfaces where lower roof areas abut vertical wall surfaces.
- Porch Railings shall be provided at all porch walking surfaces greater than 30" above adjacent finished grade. It shall be 36" high with guards spaced no more than 4" apart. Consult community specifications for material.
- Finish Wall Material shall be as noted on elevation drawings.
- 8. Brick Veneer, if included on elevation shall be tied to wall surface with galvanized corrugated metal ties at a rate of 24" oc horizontally and 16" oc vertically so that no more than 2.67sf of brick is supported by (1) tie. Space between face of wall and back face of brick shall be limited to a maximum of 1". Flashing shall be provided behind brick above all wall openings and at base of brick wall. Flashing shall be a minimum of 6-mil poly or other corrosion resistant material and shall be installed so that it laps under the house wrap material a minimum of 2".

  Weepholes shall be provided at a rate of 48" oc and shall not be less than 3/16" in diameter and shall be located immediately above flashing.
- Brick Veneer Support Lintels shall be provided if brick veneer is included on elevation. Lintels shall be provided as listed in the following schedule and shall have a minimum bearing length of 6". Masonry Lintels shall be provided so that deflection is limited to L/600.

Masonry Opening Lintel Schedule

Opening Size Angle


 up to 4'-0"
 3-1/2" x 3-1/2" x 5/16"

 4'-1" to 5'-6"
 4" x 3-1/2" x 5/16" LLV

 5'-7" to 6'-6"
 5" x 3-1/2" x 5/16" LLV

 6'-7" to 8"-4"
 6" x 3-1/2" x 5/16" LLV

 8'-5" to 16'-4"
 7" x 4" x 3/8" LLV

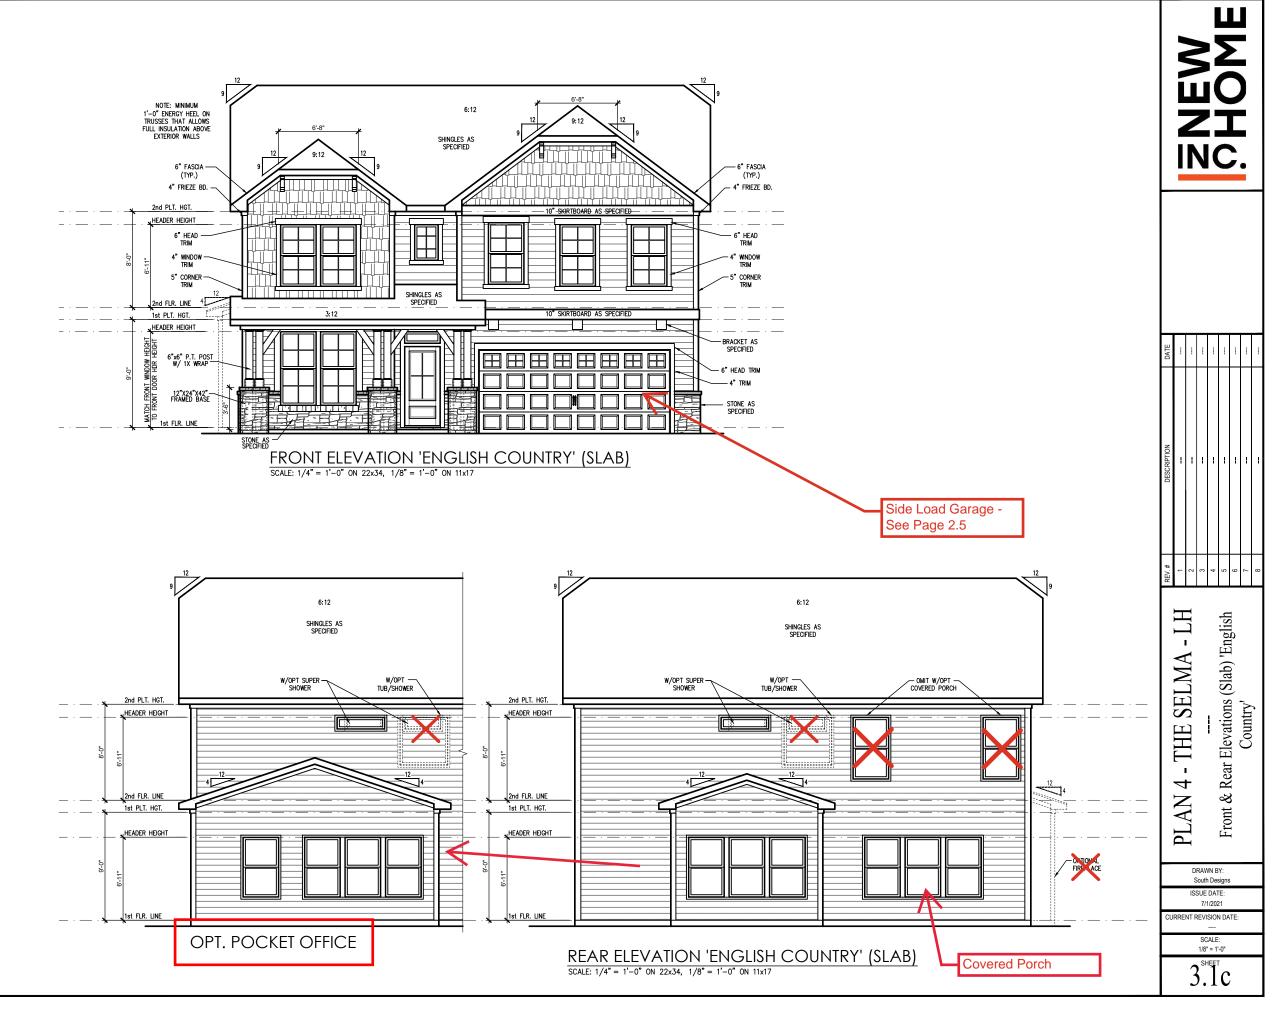

#### **General Elevation Notes**

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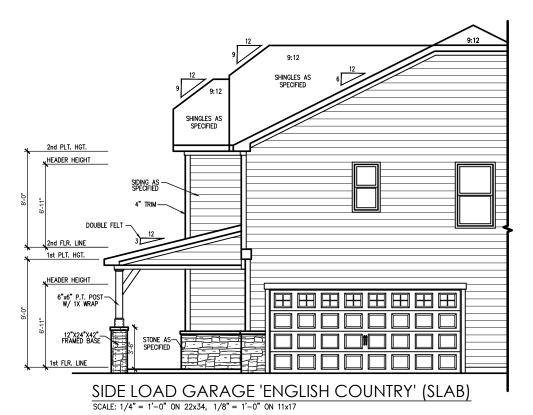
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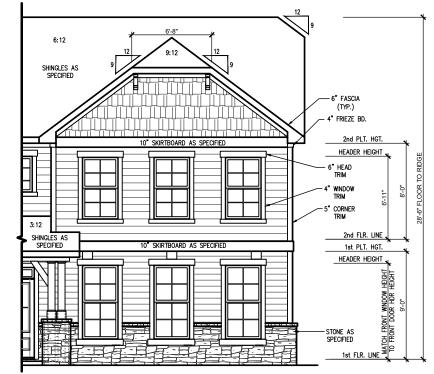
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Masonry Opening Lintel Schedule

Opening Size Angle

up to 4'-0'		3-1/2" x 3-1/2" x 5/16
4'-1" to	5'-6"	4" x 3-1/2" x 5/16" LLV
5'-7" to	6'-6"	5" x 3-1/2" x 5/16" LLV
6'-7" to	8'-4"	6" x 3-1/2" x 5/16" LLV
8'-5" to	16'-4"	7" x 4" x 3/8" LLV





FRONT ELEVATION 'ENGLISH COUNTRY' (SLAB) SCALE: 1/4" = 1'-0" ON 22x34, 1/8" = 1'-0" ON 11x17

Side Load Garage Elevations (Slab) 'English Country' -RH

> DRAWN BY: South Designs

ISSUE DATE: 7/1/2021

SELMA

THE

CURRENT REVISION DATE: 1/8" = 1'-0"

2.5c


#### **General Elevation Notes**


General Elevation Notes shall apply unless noted otherwise on plan.

- Roof shall be finished with architectural composition shingles with slopes as noted on plan.
- Ridge Vent shall be provided and installed on all ridges greater than 6' in length per manufacturer's specifications.
- 3. Soffit Vent shall be continuous soffit vent
- House Wrap, "tyvek" or approved equal shall be installed over entire exterior wall per manufacturer's specifications and recommendations.
- Flashing shall be provided above all door and window openings, above finish wall material changes and at wall surfaces where lower roof areas abut vertical wall surfaces.
- Porch Raillings shall be provided at all porch walking surfaces greater than 30" above adjacent finished grade. It shall be 36" high with guards spaced no more than 4" apart. Consult community specifications for material.
- 7. Finish Wall Material shall be as noted on elevation drawings
- 8. Brick Veneer, if included on elevation shall be tied to wall surface with galvanized corrugated metal ties at a rate of 24" oc horizontally and 16" oc vertically so that no more than 2.67sf of brick is supported by (1) tie. Space between face of wall and back face of brick shall be limited to a maximum of 1". Flashing shall be provided behind brick above all wall openings and at base of brick wall. Flashing shall be a minimum of 6-mil poly or other corrosion resistant material and shall be installed so that it laps under the house wrap material a minimum of 2". Weepholes shall be provided at a rate of 48" oc and shall not be less than 3/16" in diameter and shall be located immediately above flashing.
- Brick Veneer Support Lintels shall be provided if brick veneer is included on elevation. Lintels shall be provided as listed in the following schedule and shall have a minimum bearing length of 6". Masonry Lintels shall be provided so that deflection is limited to 1/600.

#### Masonry Opening Lintel Schedule


Opening S	ize	Angle					
up to 4'-0"		3-1/2" x 3-1/2" x 5/16"					
4'-1" to	5'-6"	4" x 3-1/2" x 5/16" LLV					
5'-7" to	6'-6"	5" x 3-1/2" x 5/16" LLV					
6'-7" to	8'-4"	6" x 3-1/2" x 5/16" LLV					
8'-5" to	16'-4"	7" x 4" x 3/8" LLV					

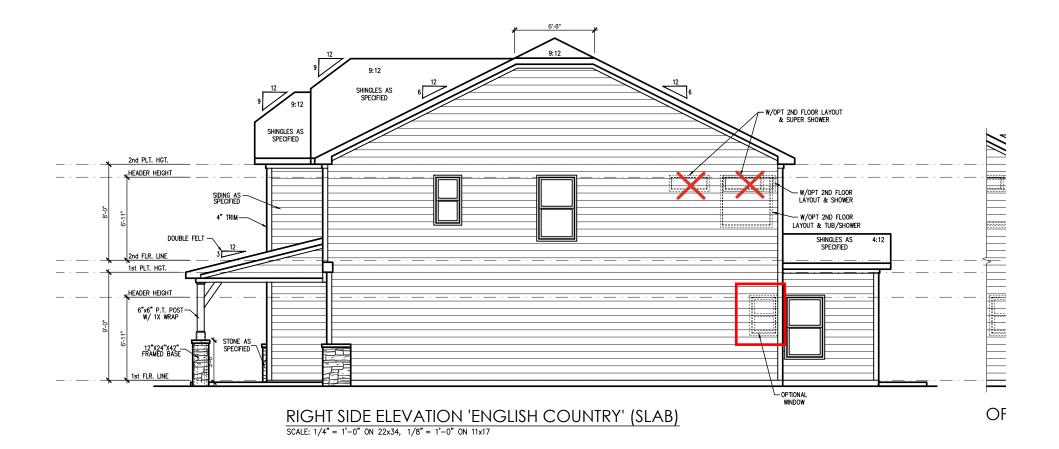

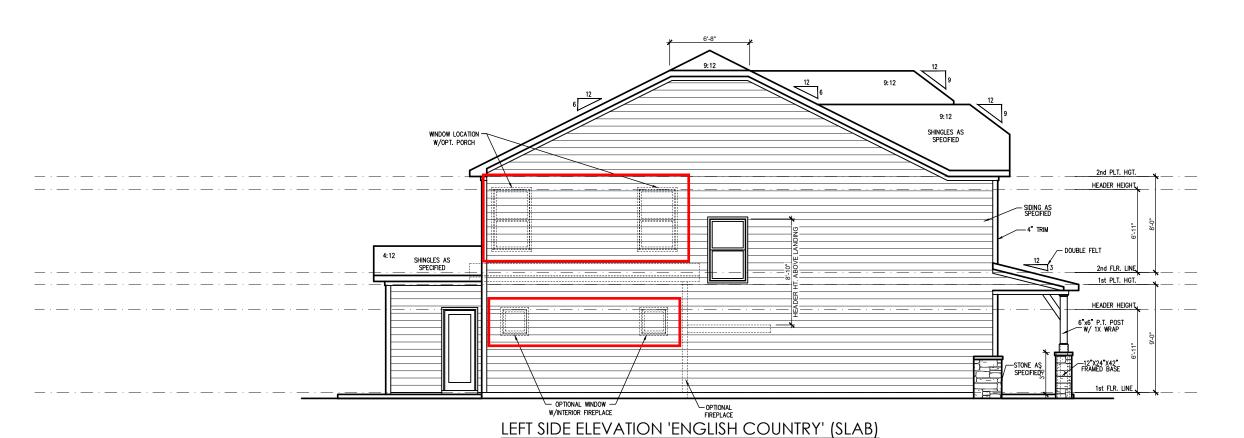

SCALE: 1/4" = 1'-0" ON 22x34, 1/8" = 1'-0" ON 11x17

MUNIC.

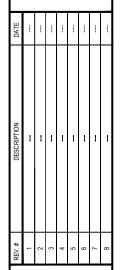


PLAN 4 - THE SELMA - LH
--Side Elevations (Slab) 'English Country'

DRAWN BY: South Designs ISSUE DATE: 7/1/2021

JRRENT REVISION DATE:
---SCALE:
1/8" = 1'-0"

 $3.2^{\text{SHEET}}$ 

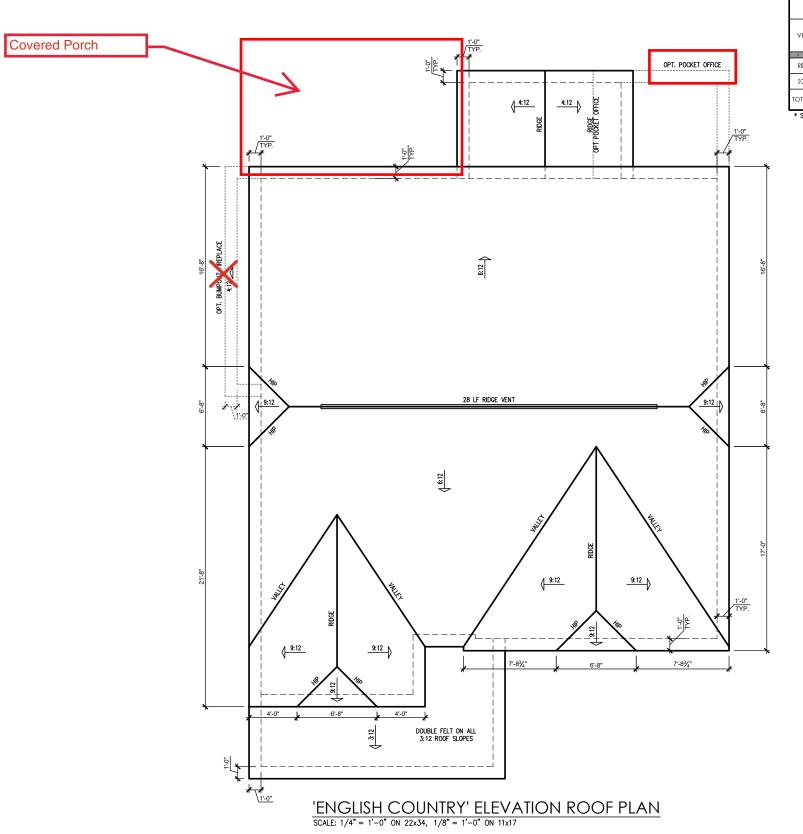

ļ		ATTIC VENT SCHEDULE											
	'ENGLISH COUNTRY' ELEVATION												
	MAIN H	HOUSE		SQ FTG	1514	AT	AT / NEAR RIDGE AT / NEAR EAVE						
	VENT TYPE	SQ. REQU		SQ. FT.	PERCENT OF TOTAL	POT LARGE (SQ. FT. EACH)	POT SMALL (SQ. FT. EACH)	RIDGE VENT (SQ. FT. PER LF)	EAVE VENT (SQ. IN. EACH)	CONT. VENT (SQ. IN. PER LF)			
-	72	RAN		SUPPLIED	SUPPLIED	0.4236	0.2778	0.125	0.1944	0.0625			
,	0												
ļ	RIDGE VENT	2.02	2.52	3.50	48.28	0	0	28.00					
ļ	SOFFIT VENTS	3.03	2.52	3.75	51.72				0	60.00			
	TOTAL (MIN)	5.05	5.05	7.25	100.00	POT VENTS MAY BE REQUIRED IF THERE IS INSUFFICIENT RIDGE AVAILABLE							

\* SCHEDULE HAS BEEN CALCULATED ASSUMING EAVE VENTILATION AT 50-60% OF TOTAL AND RIDGE AT 40-50% OF TOTAL REQUIRED VENTILATION


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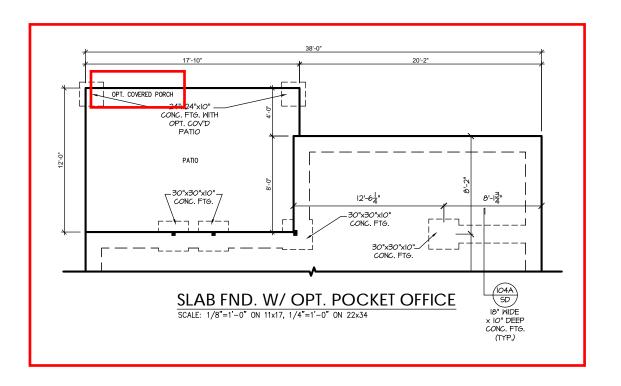
PLAN 4 - THE SELMA - LH Roof Plan 'English Country'

> DRAWN BY: South Designs ISSUE DATE: 7/1/2021


URRENT REVISION DATE: SCALE: 1/8" = 1'-0"

3.3c



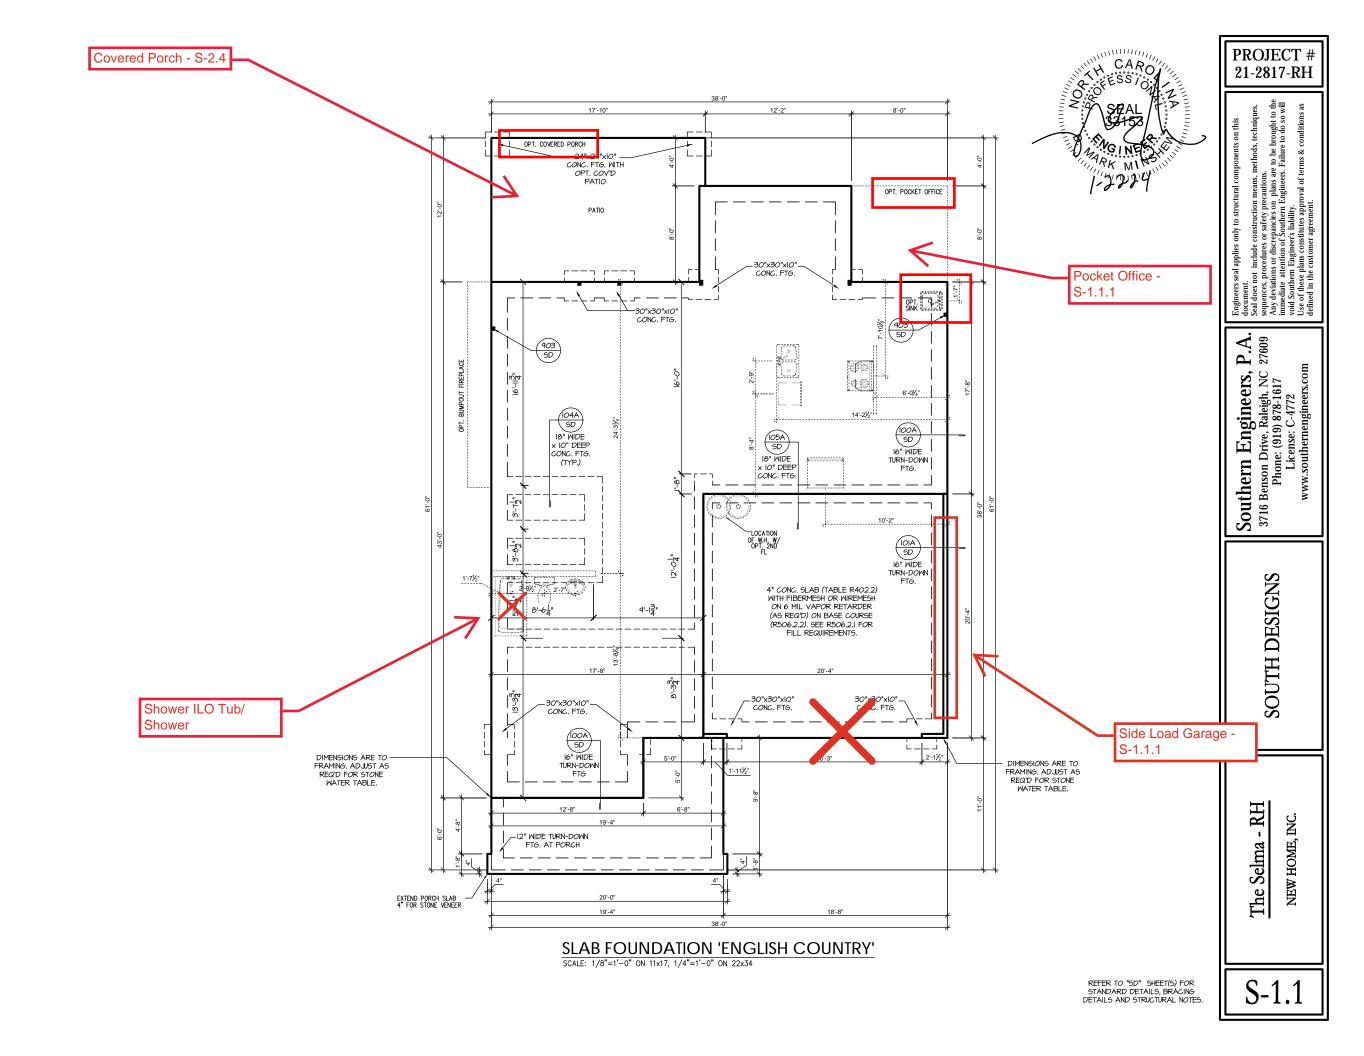



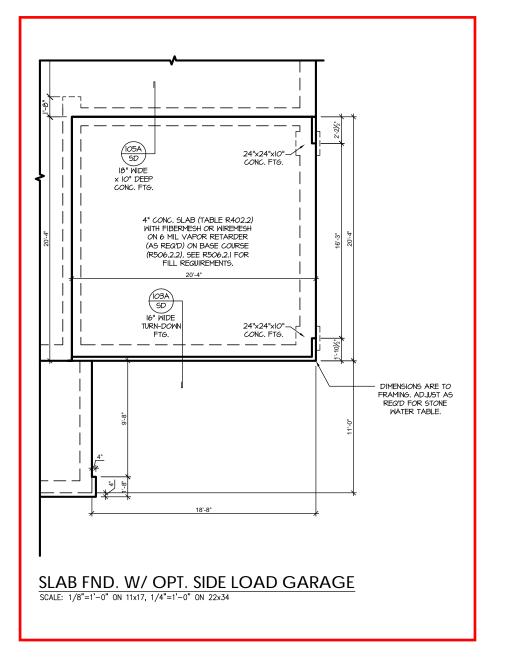

P.A. 27609

PROJECT # 21-2817-RH

Southern Engineers, P. 3716 Benson Drive, Raleigh, NC 276 Phone: (919) 878-1617 License: C-4772 www.southernengineers.com

SOUTH DESIGNS

The Selma - RH NEW HOME, INC.

REFER TO "SD" SHEET(S) FOR STANDARD DETAILS, BRACING DETAILS AND STRUCTURAL NOTES.

#### TRUSS SYSTEM REQUIREMENTS

NC (2018 NCRC): Wind: 115-120 mph

- I. TRUSS SYSTEM LAYOUTS (PLACEMENT PLANS) SHALL BE DESIGNED IN ACCORDANCE WITH SEALED STRUCTURAL PLANS, ANY NEED TO CHANGE TRUSSES SHALL BE COORDINATED WITH SOUTHERN ENGINEERS.
- TRUSS SCHEMATICS (PROFILES) SHALL BE PREPARED
  AND SEALED BY TRUSS MANUFACTURER.
- 3. ALL TRUSSES SHALL BE DESIGNED FOR BEARING ON SPF #2 OR #3 PLATES OR LEDGERS (UNO).
- 4. ALL REQUIRED ANCHORS FOR TRUSSES DUE TO UPLIFT OR BEARING SHALL MEET THE REQUIREMENTS AS SPECIFIED ON THE TRUSS SCHEMATICS.


#### HEADER/BEAM & COLUMN NOTES


- I. ALL EXTERIOR AND LOAD BEARING HEADERS SHALL BE MIN. (2)2x6 (4" WALL) OR (3)2x6 (6" WALL) WITH (I) SUPPORT STUD, UNLESS NOTED OTHERWISE.
- 2. THE NUMBER SHOWN AT BEAM AND HEADER SUPPORTS INDICATES THE NUMBER OF SUPPORT STUDS REQUIRED IN STUD POCKET OR COLUMN. THE NUMBER OF KING STUDS AT EACH END OF HEADERS IN EXTERIOR WALLS SHALL BE ACCORDING TO ITEM "0" IN TABLE R602.3(5) OR AS BELOW PER NCDOI COMMENTARY "KING STUDS AT WALL OPENINGS" REVISED 1-4-2020;
- UP TO 3' SPAN: (I) KING STUD
- OVER 3' UP TO 6' SPAN: (2) KING STUDS
- OVER 6' UP TO 9' SPAN: (3) KING STUDS
- OVER 9' UP TO 12' SPAN: (4) KING STUDS
- OVER 12' UP TO 15' SPAN: (5) KING STUDS


#### FRAMING NOTES


NC (2018 NCRC): Wind: 115-120 mph


- I. BRACING METHOD AND TYPE: CONTINUOUSLY SHEATHED MSP: CS-MSP. NOTE THAT THE MALL BRACING AMOUNT PROVIDED ON THE PLANS (DETAILS AND SPECIFICATIONS) IS GREATER THAN THE AMOUNT OF MALL BRACING REQUIRED BY SECTION R602.10 OF THE CODE. SEE NOTES BELOW FOR DETAILS AND SPECIFICATIONS FOR WALL BRACING AND MALL FRAMING.
- 2. EXTERIOR WALL SHEATHING: WALLS SHALL BE BRACED BY SHEATHING WALLS ON ALL STORIES MITH WOOD STRUCTURAL PANEL SHEATHING (WEP) (EXPOSURE 6: B. 1716\*, EXPOSURE 6: IS/32\*), SHEATHING SHALL BE ATTACHED MITH BO NAILS AT A 6"/12" NAILING PATTERN (6" OC AT PANEL EDGES AND 12" OC AT INTERNEDIATE SUPPORTS), INSTALL BLOCKING AT ALL PANEL EDGES.
- 3. MSP SHEATHING SHALL EXTEND TO THE UPPERMOST DOUBLE BEARING PLATE. BLOCK AT ROOF PER SECTION R602.10.4.5 AND ATTACH BRACED WALLS PER CODE. MSP SHEATHING BETWEEN FLOORS SHALL BE SPLICED ALONG CONTINUOUS BAND OR THE MSP SHEATHING MAY BE SPLICED ACROSS STUDS (CONTINUOUS ACROSS FLOOR SYSTEM) WITH BLOCKING AT PANEL EDGES. (MINIMUM 12\* BEYOND FLOOR BREAK) OR OTHER APPROVED METHOD.
- 4. "HD" = HOLDOWN: HOLD-DOWN DEVICE (NOTED AS "HD" ON PLANS) SHALL BE AN 800 POUND CAPACITY ASSEMBLY AS NOTED ON PLANS, SEE DETAILS FOR HD ASSEMBLY.
- \*\*GROUND/FIRST FLOOR: USE "HD HOLD-DOWN DETAIL" ON SD SHEET (OR EQUIV.)
- \*\*UPPER FLOORS: ATTACH BASE OF KING STUD WITH A SIMPSON CS20 OR CSHP20 STRAP DOWN ACROSS THE BAND AND DOWN TO A STUD BELOW OR HEADER BELOW, EXTEND STRAP T\* MIN ALONG EACH STUD (OR HEADER) AND ATTACH EACH END W (1) 8d NAILS.
- INTERIOR BRACED WALL: (NOTED AS "IBN!" ON PLANS) ATTACH I/2" SYPSUM BOARD (6B) ON EACH SIDE OF WALL WITH A MIN. OF 5d COOLER NAILS OR #6 SCREW6 @ 1" OC. ALONG THE EDGES AND AT INTERMEDIATE SUPPORTS, SEE SECTION R602.10.4.4 OF THE CODE.
- 6. INTERIOR BRACED WALL-WOOD STRUCTURAL PANEL: (NOTED AS "IBN-WSP" ON PLANS), ATTACH ONE SIDE WITH 1/6" MSP SHEATHING WITH 3d NAILS AT A 6"/12" NAILING PATTERN (6" OC AT PANEL EDGES AND 12" OC AT INTERWEDIATE SUPPORTS), INSTALL BLOCKING AT ALL PANEL EDGES, ATTACH 6B OVER MSP AS REQUIRED, ATTACH OPPOSITE SIDE WITH 1/2" 6B WITH A MIN, OF 5d COOLER NAILS OR #6 SCREMS @ 1" OC ALONG THE EDGES AND AT INTERMEDIATE SUPPORTS, SEE SECTION R602,10,4.4 OF THE CODE.

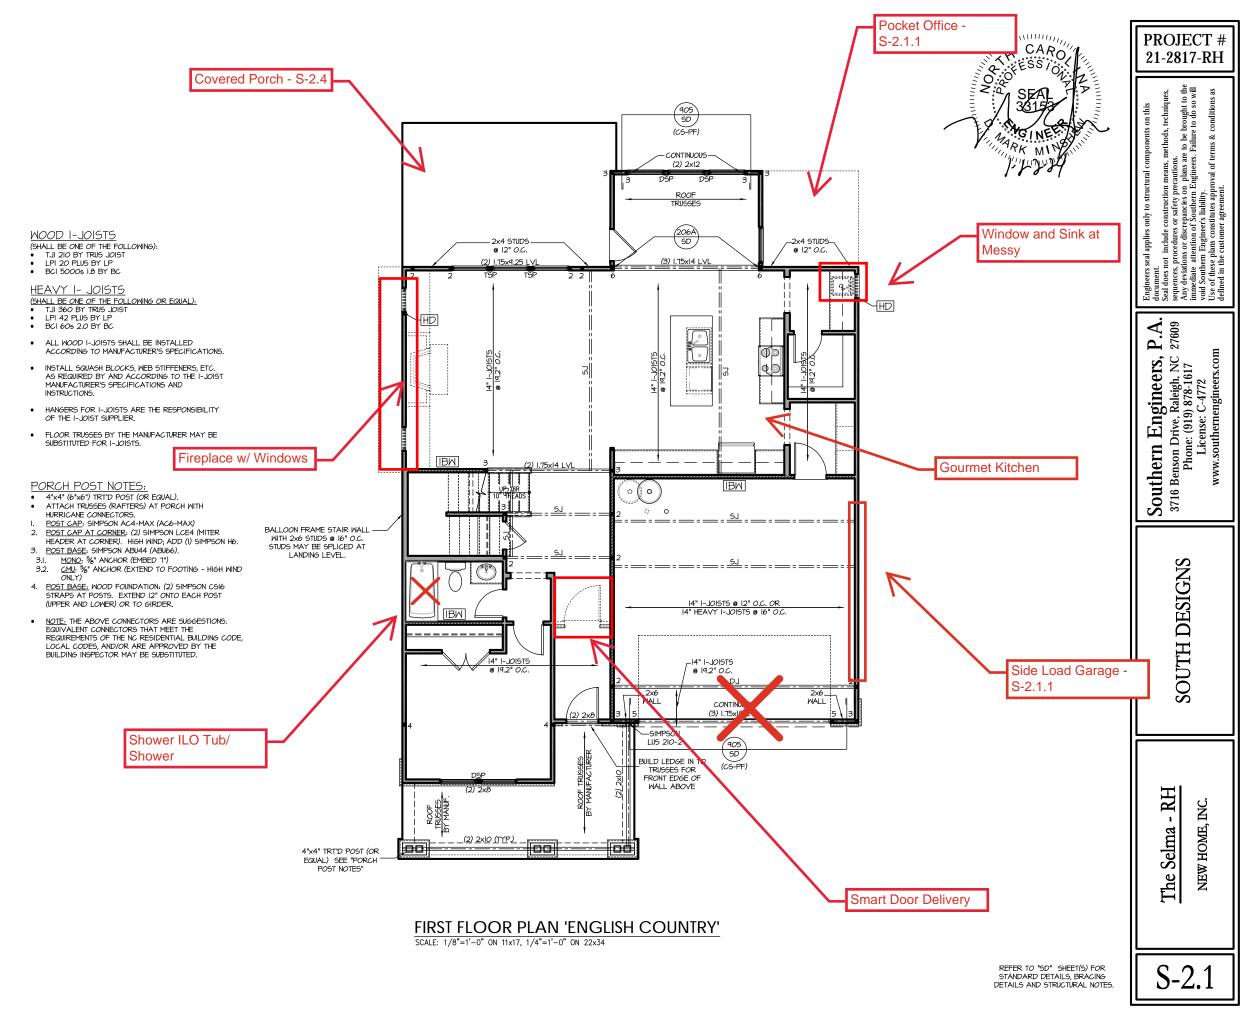

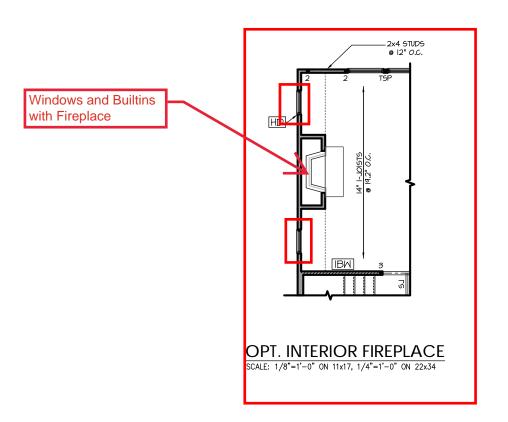

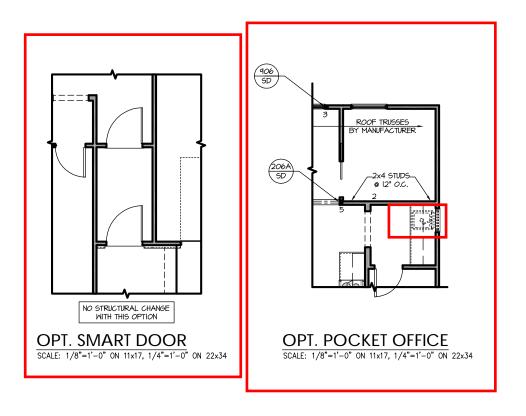

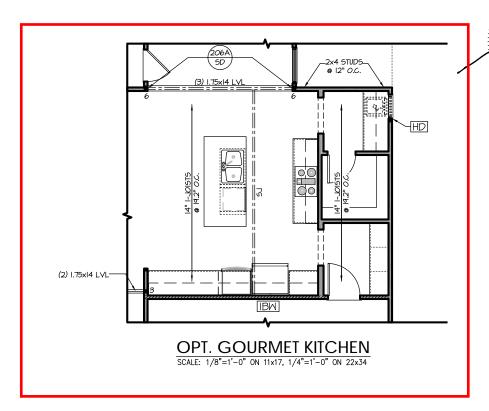

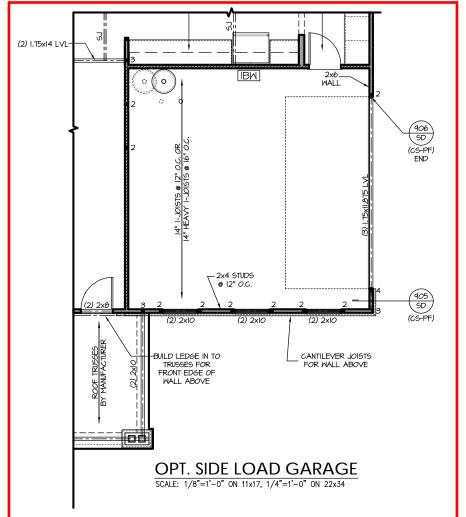

PROJECT # 21-2817-RH

P.A. 27609

Southern Engineers, P. 3716 Benson Drive, Raleigh, NC 276 Phone: (919) 878-1617 License: C-4772 www.southernengineers.com

SOUTH DESIGNS

-RH NEW HOME, INC. The Selma

REFER TO "SD" SHEET(S) FOR STANDARD DETAILS, BRACING DETAILS AND STRUCTURAL NOTES.

#### TRUSS SYSTEM REQUIREMENTS

NC (2018 NCRC): Wind: 115-120 mph

- TRUSS SYSTEM LAYOUTS (PLACEMENT PLANS) SHALL BE DESIGNED IN ACCORDANCE WITH SEALED STRUCTURAL PLANS, ANY NEED TO CHANGE TRUSSES SHALL BE COORDINATED WITH SOUTHERN ENGINEERS.
- TRUSS SCHEMATICS (PROFILES) SHALL BE PREPARED AND SEALED BY TRUSS MANUFACTURER.
- ALL TRUSSES SHALL BE DESIGNED FOR BEARING ON SPF  $\pm$ 2 OR  $\pm$ 3 PLATES OR LEDGERS (UNO).
- ALL REQUIRED ANCHORS FOR TRUSSES DUE TO UPLIFT OR BEARING SHALL MEET THE REQUIREMENTS AS SPECIFIED ON THE TRUSS SCHEMATICS.


#### HEADER/BEAM & COLUMN NOTES

- ALL EXTERIOR AND LOAD BEARING HEADERS SHALL BE MIN. (2)2x6 (4" WALL) OR (3)2x6 (6" WALL) WITH (1) SUPPORT STUD, UNLESS NOTED OTHERWISE.
- THE NUMBER SHOWN AT BEAM AND HEADER SUPPORTS INDICATES THE NUMBER OF SUPPORT STUDS REQUIRED IN STUD POCKET OR COLUMN. THE NUMBER OF KING STUDS AT EACH END OF HEADERS IN EXTERIOR WALLS SHALL BE ACCORDING TO ITEM "d" IN TABLE R602.3(5) OR AS BELOW PER NCDOI COMMENTARY "KING STUDS AT WALL OPENINGS" REVISED 1-9-2020: UP TO 3' SPAN: (I) KING STUD
- OVER 3' UP TO 6' SPAN: (2) KING STUDS OVER 6' UP TO 9' SPAN: (3) KING STUDS
- OVER 9' UP TO 12' SPAN: (4) KING STUDS
- OVER 12' UP TO 15' SPAN: (5) KING STUDS

## FRAMING NOTES

NC (2018 NCRC): Wind: 115-120 mph

- BRACING METHOD AND TYPE: CONTINUOUSLY SHEATHED WSP: CS-WSP. NOTE THAT THE WALL BRACING AMOUNT PROVIDED ON THE PLANS (DETAILS AND SPECIFICATIONS) IS GREATER THAN THE AMOUNT OF WALL BRACING REQUIRED BY SECTION R602.10 OF THE CODE. SEE NOTES BELOW FOR DETAILS AND SPECIFICATIONS FOR WALL BRACING AND WALL FRAMING.
- 2. EXTERIOR WALL SHEATHING: WALLS SHALL BE BRACED BY SHEATHING WALLS ON ALL STORIES WITH WOOD STRUCTURAL PANEL SHEATHING (MSP) (EXPOSURE B: 7/16". EXPOSURE C: 15/32"). SHEATHING SHALL BE ATTACHED WITH 8d NAILS AT A 6"/12" NAILING PATTERN (6" OC AT PANEL EDGES AND 12" OC AT INTERMEDIATE SUPPORTS). INSTALL BLOCKING AT ALL PANEL EDGES.
- WSP SHEATHING SHALL EXTEND TO THE UPPERMOST DOUBLE BEARING PLATE. BLOCK AT ROOF PER SECTION R602.10.4.5 AND ATTACH BRACED WALLS PER CODE. WSP SHEATHING BETWEEN FLOORS SHALL BE SPLICED ALONG CONTINUOUS BAND OR THE WSP SHEATHING MAY BE SPLICED ACROSS STUDS (CONTINUOUS ACROSS FLOOR SYSTEM)
  WITH BLOCKING AT PANEL EDGES. (MINIMUM 12" BEYOND FLOOR BREAK) OR OTHER APPROVED METHOD.
- 4. "HD" = HOLDOWN: HOLD-DOWN DEVICE (NOTED AS "HD" ON PLANS)
  SHALL BE AN 800 POUND CAPACITY ASSEMBLY AS NOTED ON PLANS. SEE DETAILS FOR HD ASSEMBLY
- \*\*GROUND/FIRST FLOOR: USE "HD HOLD-DOWN DETAIL" ON SD SHEET (OR EQUIV.)
- \*\*UPPER FLOORS: ATTACH BASE OF KING STUD WITH A SIMPSON C520 OR CSHP20 STRAP DOWN ACROSS THE BAND AND DOWN TO A STUD BELOW OR HEADER BELOW. EXTEND STRAP 7" MIN ALONG EACH STUD (OR HEADER) AND ATTACH EACH END W (7) 8d NAILS.
- 5. INTERIOR BRACED WALL: (NOTED AS "IBW" ON PLANS) ATTACH I/2" GYPSUM BOARD (GB) ON EACH SIDE OF WALL WITH A MIN. OF 5d COOLER NAILS OR #6 SCREWS @ 7" O.C. ALONG THE EDGES AND AT INTERMEDIATE SUPPORTS. SEE SECTION R602.10.4.4 OF THE CODE.
- 6. INTERIOR BRACED WALL-WOOD STRUCTURAL PANEL: (NOTED AS "IBW-WSP" ON PLANS). ATTACH ONE SIDE WITH 1/6" WSP SHEATHING WITH 8d NAILS AT A 6"/12" NAILING PATTERN (6" OC AT PANEL EDGES AND 12" OC AT INTERMEDIATE SUPPORTS). INSTALL BLOCKING AT ALL PANEL EDGES, ATTACH GB OVER WSP AS REQUIRED, ATTACH OPPOSITE SIDE WITH 1/2" GB WITH A MIN. OF 5d COOLER NAILS OR #6 SCREWS @ 7" OC ALONG THE EDGES AND AT INTERMEDIATE SUPPORTS. SEE SECTION R602.10.4.4 OF THE CODE.

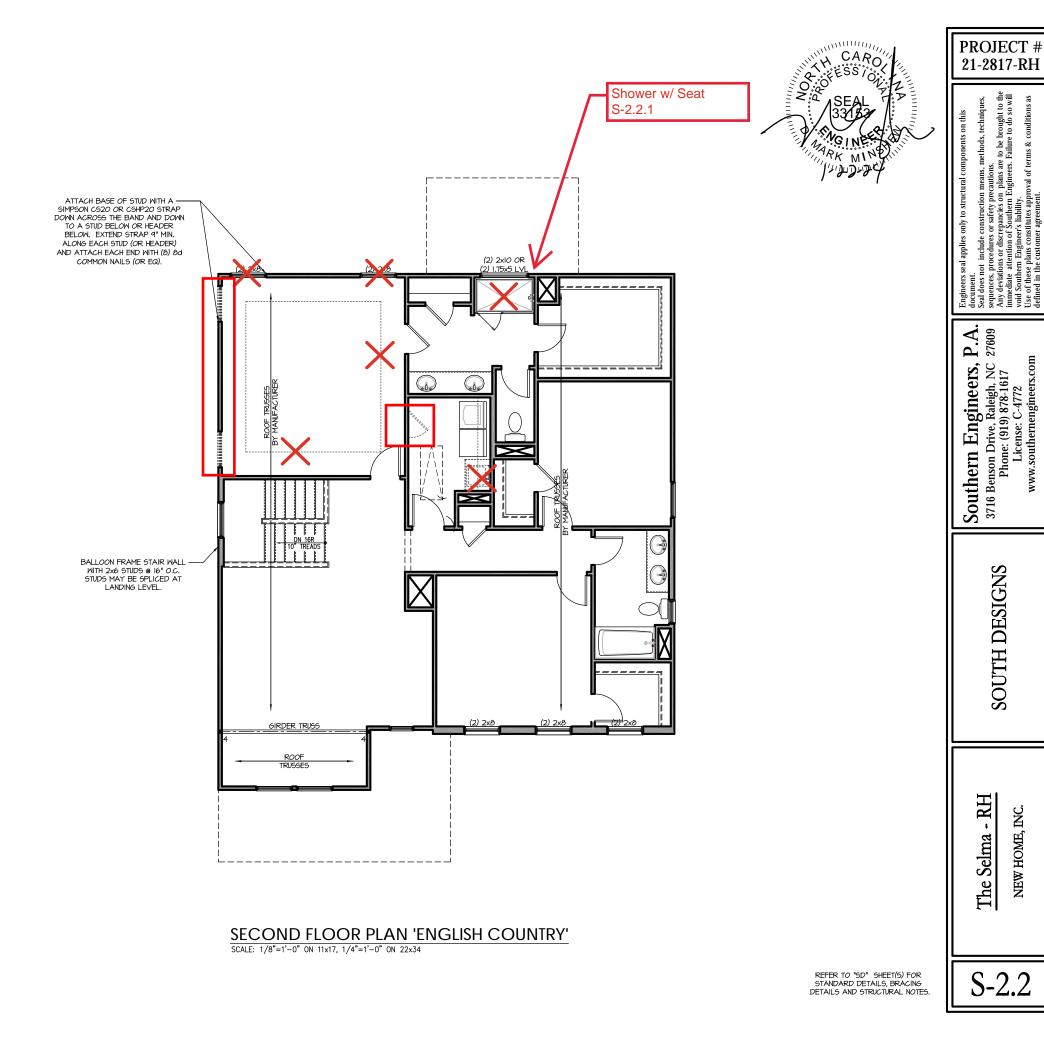



(2) 2xIO OR (2) 1.75x5 LVL OPT. SHOWER W/ 18" SEAT SCALE: 1/8"=1'-0" ON 11x17, 1/4"=1'-0" ON 22x34 Southern Engineers, P.A. 3716 Benson Drive, Raleigh, NC 27609 Phone: (919) 878-1617 License: C-4772 www.southernengineers.com

PROJECT # 21-2817-RH

SOUTH DESIGNS

The Selma - RH NEW HOME, INC.

#### TRUSS SYSTEM REQUIREMENTS NC (2018 NCRC): Wlind: 115-120 mph

- I. TRUSS SYSTEM LAYOUTS (PLACEMENT PLANS) SHALL BE DESIGNED IN ACCORDANCE WITH SEALED STRUCTURAL PLANS, ANY NEED TO CHANGE TRUSSES SHALL BE COORDINATED WITH SOUTHERN ENGINEERS.
- TRUSS SCHEMATICS (PROFILES) SHALL BE PREPARED AND SEALED BY TRUSS MANUFACTURER.
- 3. ALL TRUSSES SHALL BE DESIGNED FOR BEARING ON SPF #2 OR #3 PLATES OR LEDGERS (UNO).
- ALL REQUIRED ANCHORS FOR TRUSSES DUE TO UPLIFT OR BEARING SHALL MEET THE REQUIREMENTS AS SPECIFIED ON THE TRUSS SCHEMATICS.


#### TRUSS SYSTEM REQUIREMENTS NC (2018 NCRC): Wind: 115-120 mph

- I. TRUSS SYSTEM LAYOUTS (PLACEMENT PLANS)
  SHALL BE DESIGNED IN ACCORDANCE WITH SEALED
  STRUCTURAL PLANS, ANY NEED TO CHANGE
  TRUSSES SHALL BE COORDINATED WITH SOUTHERN
  ENGINEERS
- TRUSS SCHEMATICS (PROFILES) SHALL BE
  PREPARED AND SEALED BY TRUSS MANUFACTURER.
- 3. ALL TRUSSES SHALL BE DESIGNED FOR BEARING ON SPF #2 OR #3 PLATES OR LEDGERS (UNO).
- 4. ALL REQUIRED ANCHORS FOR TRUSSES DUE TO UPLIFT OR BEARING SHALL MEET THE REQUIREMENTS AS SPECIFIED ON THE TRUSS SCHEMATICS.

ATTIC VENT SCHEDULE											
'ENGLISH COUNTRY' ELEVATION											
MAIN HOUSE SQ FTG 1514 AT / NEAR RIDGE						AT / NE	AR EAVE				
VENT TYPE	SQ. FT. SQ. FT.			PERCENT OF TOTAL	POT LARGE (SQ. FT. EACH)	POT SMALL (SQ. FT. EACH)	RIDGE VENT (SQ. FT. PER LF)	EAVE VENT (SQ. IN. EACH)	CONT. VENT (SQ. IN. PER LF)		
		RANGE SUPPL		SUPPLIED SUPPLIED		0.2778	0.125	0.1944	0.0625		
RIDGE VENT	2.02	2.52	3.50	48.28	0	0					
SOFFIT VENTS	3.03	2.52	3.75	51.72	0 60.00				60.00		
TOTAL (MIN)	5.05	5.05	7.25	100.00	POT VENTS MAY BE REQUIRED IF THERE IS INSUFFICIENT RIDGE AVAILABLE						

<sup>\*</sup> SCHEDULE HAS BEEN CALCULATED ASSUMING EAVE VENTILATION AT 50-60% OF TOTAL AND RIDGE AT 40-50% OF TOTAL REQUIRED VENTILATION

OPT. POCKET OFFICE

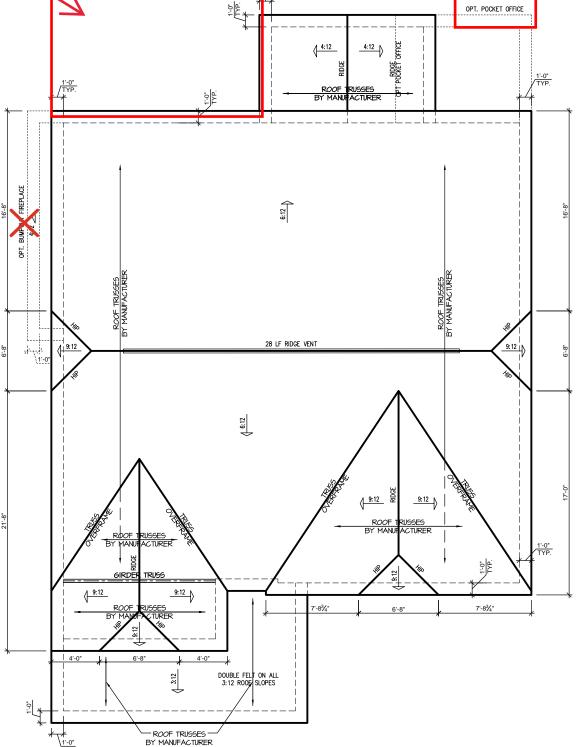

'ENGLISH COUNTRY' ELEVATION ROOF PLAN
SCALE: 1/4" = 1'-0" ON 22x34, 1/8" = 1'-0" ON 11x17

PROJECT # 21-2817-RH

ns. are to be brought to the cars. Failure to do so will frems & conditions as

eers seal applies only to structural components on the nent.

oes not include construction means, methods, techn coes, procedures or safety precautions.

eviations or discrepancies on plans are to be brough dialet attention of Southern Engineers. Failure to do contame. Engineers, Failure to do contame.

Southern Engineers, P.A. 3716 Benson Drive, Raleigh, NC 27609 Phone: (919) 878-1617


SOUTH DESIGNS


The Selma - RH
NEW HOME, INC.

REFER TO "SD" SHEET(S) FOR STANDARD DETAILS, BRACING DETAILS AND STRUCTURAL NOTES.

S-3.1



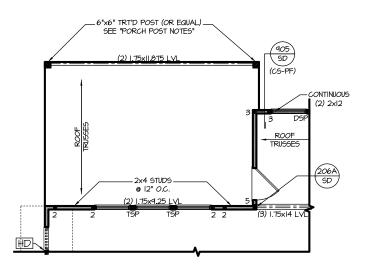

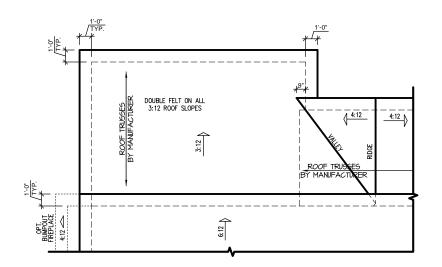

COVERED PORCH FLOOR PLAN
SCALE: 1/8"=1'-0" ON 11x17, 1/4"=1'-0" ON 22x34

COVERED PORCH ROOF PLAN
SCALE: 1/8"=1'-0" ON 11x17, 1/4"=1'-0" ON 22x34

6:12 Pocket Office SHINGLES AS SPECIFIED W/OPT 2ND FLOOR LAYOUT & SUPER SHOWER W/OPT — TUB/SHOWER 2nd PLT. HGT. LENDER HEIGHT -W/OPT 2ND FLOOR LAYOUT & SHOWER \_W/OPT 2ND FLOOR LAYOUT & TUB/SHOWER -DOUBLE FELT SHINGLES AS SPECIFIED DOUBLE FELT-2nd FLR. LINE 1st PLT. HGT. HEADER HEIGHT COVERED PORCH REAR ELEVATION (SLAB) PARTIAL RIGHT SIDE ELEVATION (SLAB) PARTIAL LEFT SIDE ELEVATION (SLAB) SCALE: 1/8"=1'-0" ON 11x17, 1/4"=1'-0" ON 22x34 SCALE: 1/8"=1'-0" ON 11x17, 1/4"=1'-0" ON 22x34 SCALE: 1/8"=1'-0" ON 11x17, 1/4"=1'-0" ON 22x34

> REFER TO "5D" SHEET(S) FOR STANDARD DETAILS, BRACING DETAILS AND STRUCTURAL NOTES.

PROJECT # 21-2817-RH

rate sear appears only to structural components on time.

Int.

So not include construction means, methods, techniques,

res, procedures or safely precautions.


Adiations of discrepancies on plans are to be brought to the
attention of Southern Engineers. Failure to do so will
ate attention of southern Engineers.


Southern Engineers, P.A. 3716 Benson Drive, Raleigh, NC 27609 Phone: (919) 878-1617 License: C-4772 www.southernengineers.com


SOUTH DESIGNS


The Selma - RH
NEW HOME, INC.


S-2.4

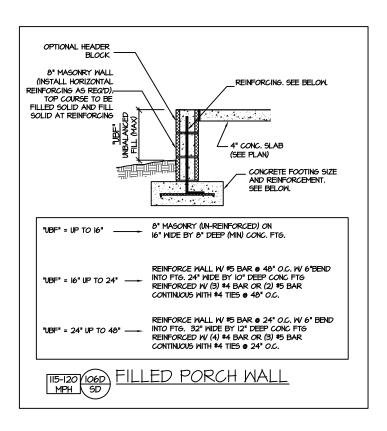

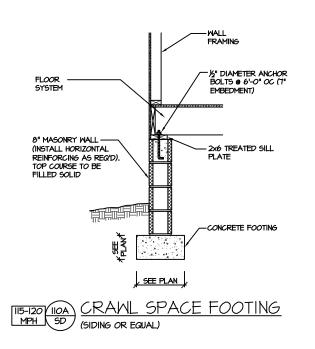


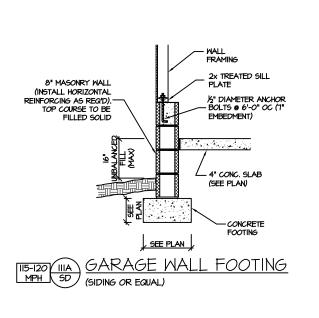

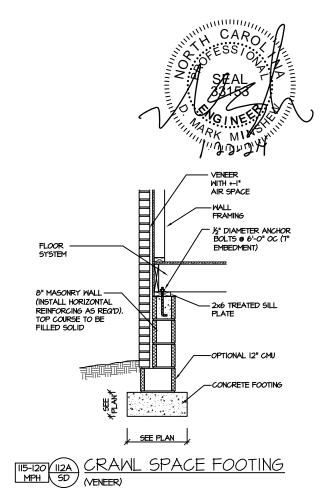

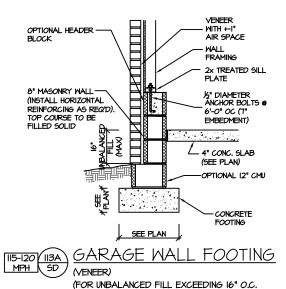


SEE DETAIL "IO6D/SD")

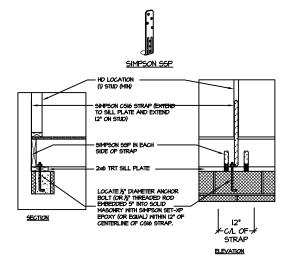

BRACED WALL END CONDITION " HD" HOLD-DOWN DETAIL

NOTE: SIMPSON DTT-IZ IS ACCEPTABLE ALTERNATE NOTE: ALTERNATE HD HOLD-DOWN DEVICES OR SYSTEMS MAY BE USED TO MEET THE CODE REQUIRED 800 LB CAPACITY IN LIEU OF THE ABOVE DETAIL.

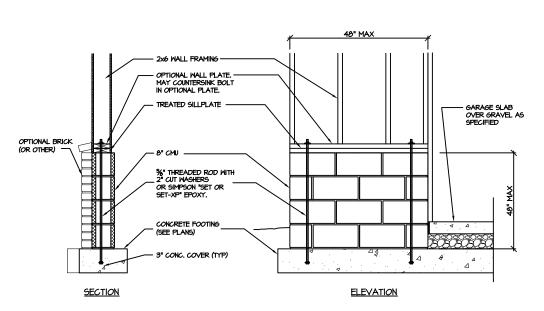

GARAGE 'WING WALL' REINFORCING PER IRC FIGURE R602.IO.4.3

CRAWL SPACE FOUNDATION

PROJECT # 21-2817


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NEW HOME,


SELMA THE 4 PLAN


SD




# MPH SD (SIDING OR FOLK)

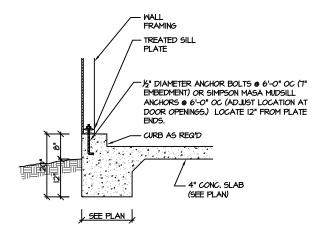

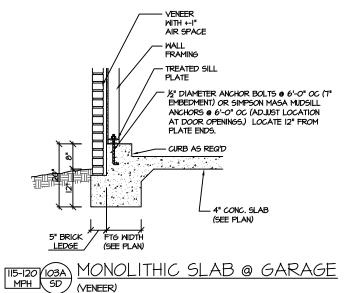

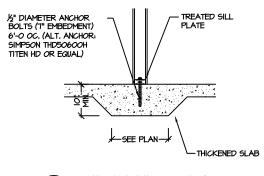




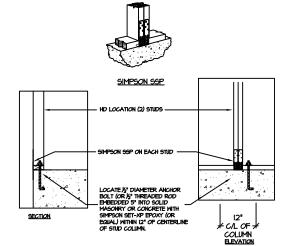


### BRACED WALL END CONDITION "HD" HOLD-DOWN DETAIL

NOTE: SIMPSON DTT-IZ IS ACCEPTABLE ALTERNATE NOTE: ALTERNATE HD HOLD-DOWN DEVICES OR SYSTEMS MAY BE USED TO MEET THE CODE REQUIRED 800 LB CAPACITY IN LIEU OF THE ABOVE DETAIL.

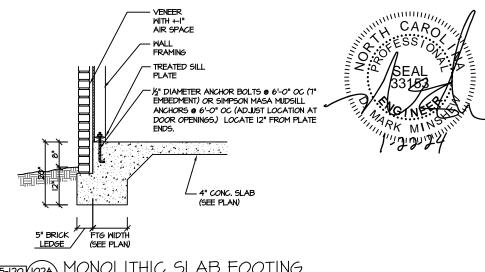

MONOLITHIC SLAB FOOTING (MPH SD) MONOLITHIC SLAB FOOTING

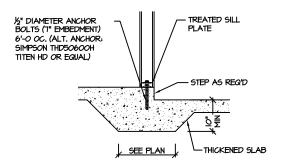

THICKENED SLAB @ GARAGE (INTERIOR GARAGE WALL)

P.A. 27609

PROJECT #

21-2817

Southern Engineers, P 3716 Benson Drive, Raleigh, NC 27 Phone: (919) 878-1617 License: C-4772


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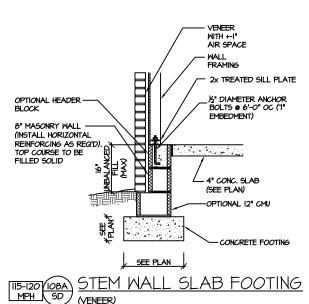
> SELMA THE 4 **PLAN**

SD

SLAB FOUNDATION






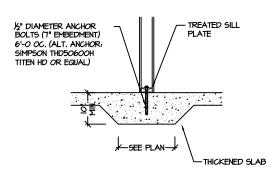


(FOR UNBALANCED FILL EXCEEDING 16" O.C.

(VENEER)


SEE DETAIL "IO6E/SD")

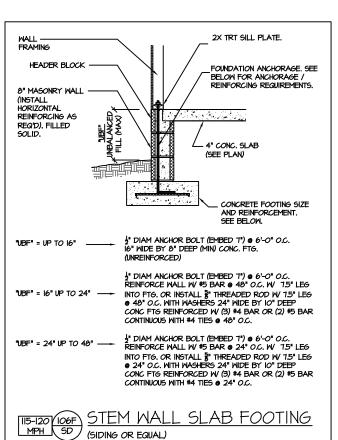


(SIDING OR EQUAL)

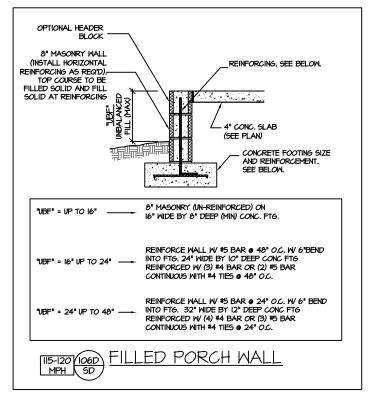




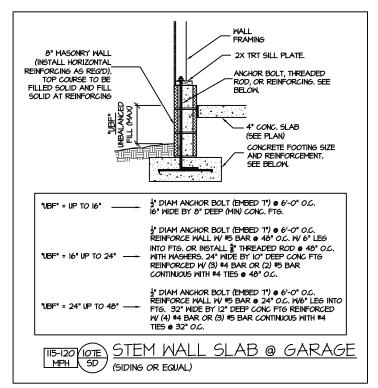

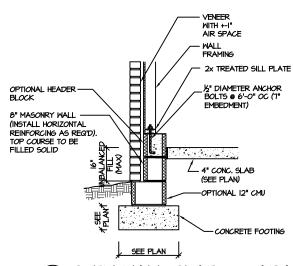


STEM WALL SLAB @ GARAGE 115-120 109A MPH SD (VENEER)

(FOR UNBALANCED FILL EXCEEDING 16" O.C. SEE DETAIL "IO6E/SD")

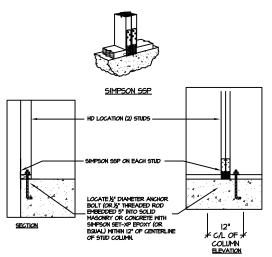

BRACED WALL END CONDITION "HD" HOLD-DOWN DETAIL

NOTE: SIMPSON DTT-IZ IS ACCEPTABLE ALTERNATE NOTE: ALTERNATE HD HOLD-DOWN DEVICES OR SYSTEMS MAY BE USED TO MEET THE CODE REQUIRED 800 LB CAPACITY IN LIEU OF THE ABOVE DETAIL.

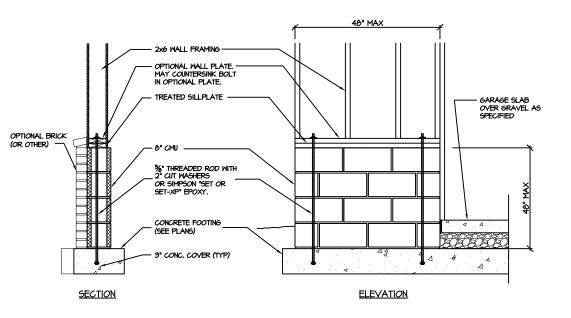

GARAGE 'WING WALL' REINFORCING PER IRC FIGURE R602.IO.4.3

STEMMALL SLAB FOUNDATION


PROJECT # 21-2817


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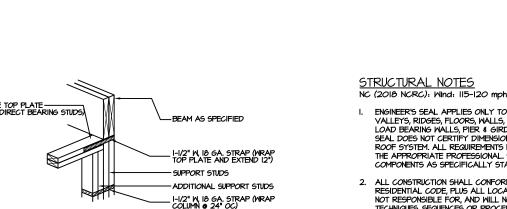
PROJECT #


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CS-PF: END CONDITION DETAIL (FOR USE WITH SINGLE CS-PF CONDITION) DETAIL AND APPLICATION BASED ON NORC FIGURE R602.IO.I - PORTAL FRAME CONSTRUCTION

DOUBLE TOP PLATE (CUT @ DIRECT BEARING STUDS)

NOTE: AT INTERMEDIATE WALL SEGMENTS BETWEEN OPENINGS, THE STRAPS SHALL BE INSTALLED AT THE STUD COLUMN ON EACH END OF

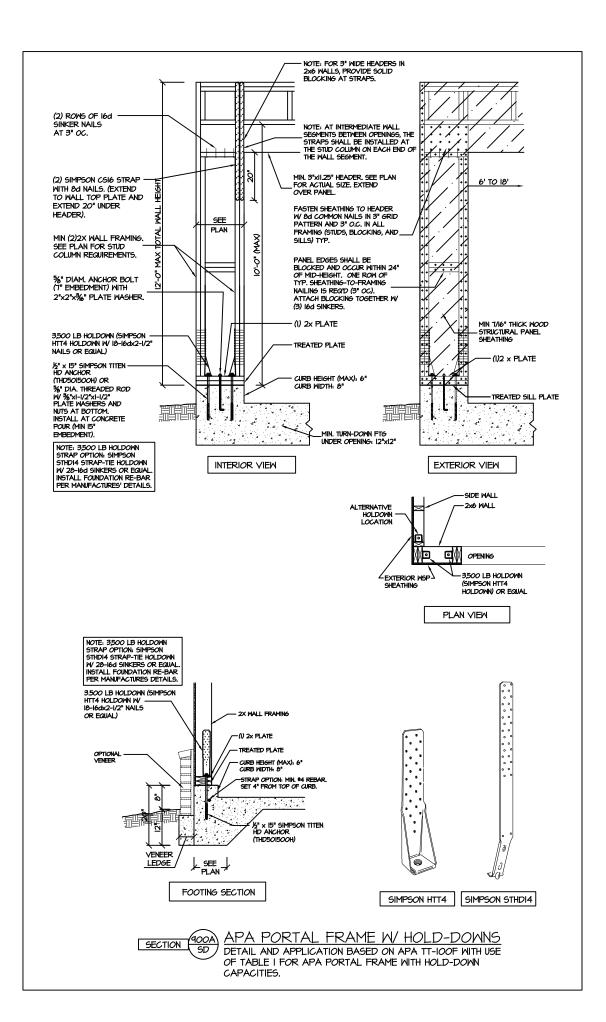MIN. 3"XII.25" HEADER, SEE PLAN FOR ACTUAL SIZE, EXTEND - OVER PANEL.

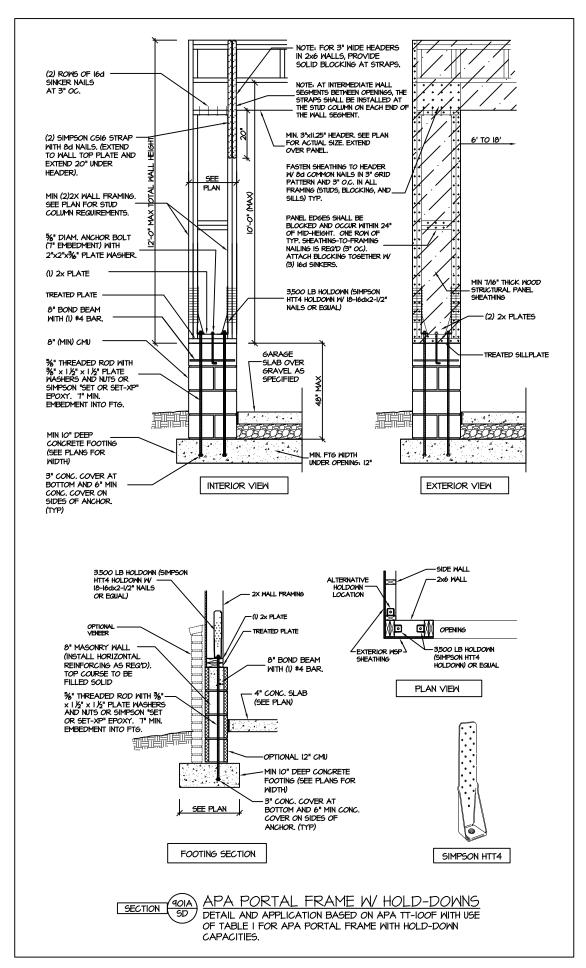FASTEN SHEATHING TO HEADER W 8d COMMON NAILS IN 3" GRID \_ PATTERN AND 3" O.C. IN ALL

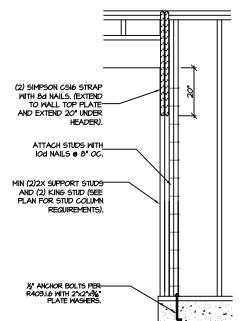FRAMING (STUDS, BLOCKING, AND

PANEL EDGES SHALL BE BLOCKED AND OCCUR WITHIN 24" OF MID-HEIGHT. ONE ROW OF TYP. SHEATHING-TO-FRAMING

ATTACH BLOCKING TOGETHER W

MIN 76" THICK WOOD - STRUCTURAL PANEL SHEATHING

EXTERIOR VIEW

-8d NAILS @ 3" OC TOP AND BOTTOM

-EXTEND SHEATHING TO

SILL PLATE (DO NOT

SPLICE)

MSP OVERLAP OPTION

TREATED SILLPLATE

NAILING IS REQ'D (3" OC).

PLAN

INTERIOR VIEW

FRAMING ANCHOR OPTION

DETAIL AND APPLICATION BASED ON NORC FIGURE

R602.IO.I - PORTAL FRAME CONSTRUCTION

SIMPSON LTP4 FRAMING

CS-PF - OVER WOOD FLOOR

<u>CS-PF: CONTINUOUS PORTAL FRAME CONSTRUCTION</u>

(2) SIMPSON CSIG STRAF WITH 8d NAILS. (EXTEND TO WALL TOP PLATE AND EXTEND 20" UNDER HEADER).

(2) ROWS OF 16d-NAILS @ 3" OC

MIN (2)2X WALL FRAMING

SEE PLAN FOR STUD COLUMN REQUIREMENTS.

TREATED SILLPLATE

**5" ANCHOR BOLTS PER** 


NOTE: FOR CMU APPLICATIONS AT GARAGE DOORS, ANCHOR BOLTS SHALL

BE %" DIAMETER AND SHALL EXTEND TO FOOTING (PER NORG FIGURE

R602.10.4.3 (SEE GARAGE WING WALL

DETAIL ON STRUCTURAL PLANS)

DIRECT BEAM BEARING

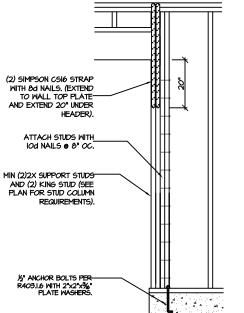

STRUCTURAL NOTES

- ENGINEER'S SEAL APPLIES ONLY TO STRUCTURAL COMPONENTS INCLUDING ROOF RAFTERS, HIPS, VALLEY'S, RIDGES, FLOORS, WALLS, BEAMS AND HEADERS, COLUMNS, CANTILEVERS, OFFSET LOAD BEARING WALLS, PIER ♣ GIRDER SYSTEM, FOOTING, AND PILING SYSTEM. ENGINEER'S SEAL DOES NOT CERTIFY DIMENSIONAL ACCURACY OR ARCHITECTURAL LATOUT INCLUDING ROOF SYSTEM, ALL REQUIREMENTS FOR PROFESSIONAL CERTIFICATION SHALL BE PROVIDED BY THE APPROPRIATE PROFESSIONAL. SOUTHERN ENGINEERS, P.A. CERTIFIES ONLY THE STRUCTURAL COMPONENTS AS SPECIFICALLY STATED.
- ALL CONSTRUCTION SHALL CONFORM TO THE LATEST REQUIREMENTS OF THE 2018 NC RESIDENTIAL CODE, PLUS ALL LOCAL CODES AND REGULATIONS. THE STRUCTURAL ENGINEER IS NOT RESPONSIBLE FOR, AND WILL NOT HAVE CONTROL OF, CONSTRUCTION MEANS, METHODS, TECHNIQUES, SEQUENCES OR PROCEDURES, OR FOR SAFETY PRECAUTIONS AND PROGRAMS IN CONNECTION WITH THE CONSTRUCTION MORK, NOR WILL THE ENGINEER BE RESPONSIBLE FOR THE CONTRACTOR'S FAILURE TO CARRY OUT THE CONSTRUCTION WORK IN ACCORDANCE WITH THE CONTRACT DOCUMENTS. "CONSTRUCTION REVIEW" SERVICES ARE NOT PART OF OUR CONTRACT.
  ALL MEMBERS SHALL BE FRAMED ANCHORED, TIED AND BRACED IN ACCORDANCE WITH GOOD CONSTRUCTION PRACTICE AND THE BUILDING CODE.

- ATTIC WITHOUT PERMANENT STAIR: (20 PSF, I/O PSF, L/360) ATTIC WITHOUT STORAGE: (10 PSF, I/O PSF, L/240)
- STAIRS: (40 PSF, IO PSF, L/360)
- EXTERIOR BALCONIES: (60 PSF, IO PSF, L/360)
- PASSSENGER VEHICLE GARAGES: (50 PSF, IO PSF, L/360) FIRE ESCAPES: (40 PSF, IO PSF, L/360)
- SNOW: (20 PSF)
- 4. WALLS SHALL BE BRACED BY SHEATHING WALLS ON ALL STORIES WITH WOOD STRUCTURAL PANELS. SEE FRAMING NOTES FOR THICKNESS AND NAILING REQUIREMENTS
- LATERAL LOADS.
- 5 INCHES UNLESS NOTED OTHERWISE (UNO). AIR ENTRAINED PER TABLE 402.2. ALL CONCRETE SHALL BE PROPORTIONED, MIXED, HANDLED, SAMPLED, TESTED, AND PLACED IN ACCORDANCE MITH ACI STANDARDS, ALL SAMPLES FOR PUMPING SHALL BE TAKEN FROM THE EXIT END OF THE PUMP. CONTROL JOINTS IN SLABS SHALL BE SPACED ON A GRID OF +30 TIMES THE DEPTH (D). CONTROL JOINTS SHALL BE SANCUT TO A DEPTH OF I/D. (I.E. 4" CONCRETE SLABS SHALL HAVE 以" DEEP CONTROL JOINTS SANCUT IN SLAB ON A +-10'-0" x +-10'-0" GRID).
- ALLOMABLE SOIL BEARING PRESSURE ASSUMED TO BE 2000 PSF. THE CONTRACTOR MUST CONTACT A GEOTECHNICAL ENGINEER AND THE STRUCTURAL ENGINEER IF UNGATISFACTORY SUBSURFACE CONDITIONS ARE ENCOUNTERED. THE SURFACE AREA ADJACENT TO THE FOUNDATION WALL SHALL BE PROVIDED WITH ADEQUATE DRAINAGE, AND SHALL BE GRADED SO AS TO DRAIN SURFACE WATER AWAY FROM FOUNDATION WALLS.
- TREATED LUMBER SHALL BE SYP # 2. PLATE MATERIAL MAY BE SPF # 3 OR SYP #3 (Fc(perp) =
- 9. L.V.L. SHALL BE LAMINATED VENEER LUMBER: Fb=2600 PSI, Fv=285 PSI, E=I.9xi0 PSI. P.S.L. SHALL BE PARALLEL STRAND LUMBER: Fb=2900 PSI, Fv=290 PSI, E=2.0xl0 PSI. L.S.L. SHALL BE LAMINATED STRAND LUMBER: Fb=2250 PSI, Fv=400 PSI, E=1.55xl0 PSI.
- IO. ALL ROOF TRUSS AND I-JOIST LAYOUTS SHALL BE PREPARED IN ACCORDANCE WITH THE SEALED STRUCTURAL DRAWINGS, TRUSSES AND I-JOISTS SHALL BE INSTALLED ACCORDING TO THE MANUFACTURE'S SPECIFICATIONS, ANY CHANGE IN TRUSS OR I-JOIST LAYOUT SHALL BE
- END WITH A MINIMUM BEARING LENGTH OF 3 1/2" INCHES AND FULL FLANGE WIDTH, PROVIDE SOLID BEARING FROM BEAM SUPPORT TO FOUNDATION. BEAMS SHALL BE ATTACHED TO EACH SUPPORT WITH TWO LAG SCREWS (I/2" DIAMETER x 4" LONG). LATERAL SUPPORT IS CONSIDERED ADEQUATE PROVIDING THE JOIST ARE TOE NAILED TO THE SOLE PLATE, AND SOLE PLATE IS NAILED OR BOLTED TO THE BEAM FLANGE @ 48" O.C. ALL STEEL TUBING SHALL BE ASTM A500.
- FOR SPANS OVER 4'-0". SEE ALSO SECTION R703.8.3 LINTELS.

DESIGN LOADS (LISTED AS: LIVE LOAD, DEAD LOAD, DEFLECTION) ROOMS OTHER THAN SLEEPING ROOMS: (40 PSF, IO PSF, L/360)

SLEEPING ROOMS: (30 PSF, IO PSF, L/360)

ATTIC WITH PERMANENT STAIR: (40 PSF, IO PSF, L/360)

- DECKS: (40 PSF, IO PSF, L/360)
- GUARDRAILS AND HANDRAILS: (200 LBS)

- 5. SEE APPENDIX M (DCA6) FOR EXTERIOR DECK REQUIREMENTS INCLUDING ATTACHMENTS FOR
- 6. CONCRETE SHALL HAVE A MINIMUM 28 DAY STRENGTH OF 3000 PSI AND A MAXIMUM SLUMP OF
- 8. ALL FRAMING LUMBER SHALL BE SPF #2 (Fb = 875 PSI) UNLESS NOTED OTHERWISE (UNO). ALL
- INSTALL ALL CONNECTIONS PER MANUFACTURERS INSTRUCTIONS.
- ALL STRUCTURAL STEEL SHALL BE ASTM A-36. STEEL BEAMS SHALL BE SUPPORTED AT EACH
- 12. REBAR SHALL BE DEFORMED STEEL, ASTM615, GRADE 60. LAP ALL REBAR SPLICES 30 BAR
- 13. FLITCH BEAMS SHALL BE BOLTED TOGETHER USING (2) ROWS OF 1/2" DIAMETER BOLTS (ASTM A325) WITH WASHERS PLACED UNDER THE THREADED END OF BOLT. BOLTS SHALL BE SPACED AT 24" O.C. (MAX), AND STAGGERED AT THE TOP AND BOTTOM OF BEAM (2" EDGE DISTANCE), WITH 2 BOLTS LOCATED AT 6" FROM EACH END.
- 14. BRICK LINTELS (WHEN REQUIRED) SHALL BE 3 1/2"x3 1/2"x1/4" STEEL ANGLE FOR UP TO 6'-0" SPAN AND 6"x4"x5/16" STEEL ANGLE WITH 6" LEG VERTICAL FOR SPANS UP TO 9'-0". SEE PLANS

PROJECT # 21-2817

P.A. 27609

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