



Rothbard w/ Porch

Precision Custom Hom Raeford, NC n@PrecisionCustomHom


10/16/24

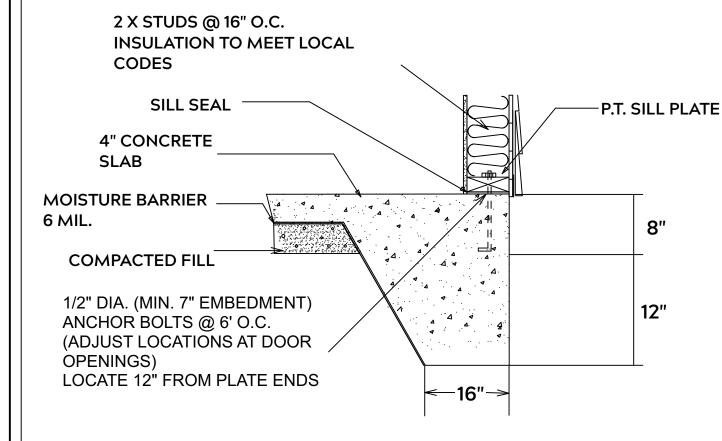

MONOLITHIC SLAB

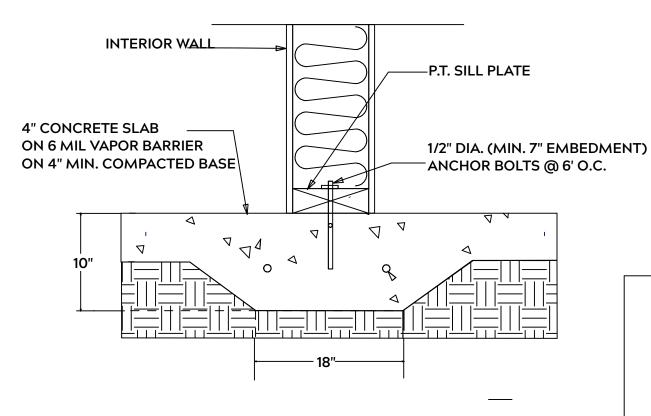

LUG FOOTING

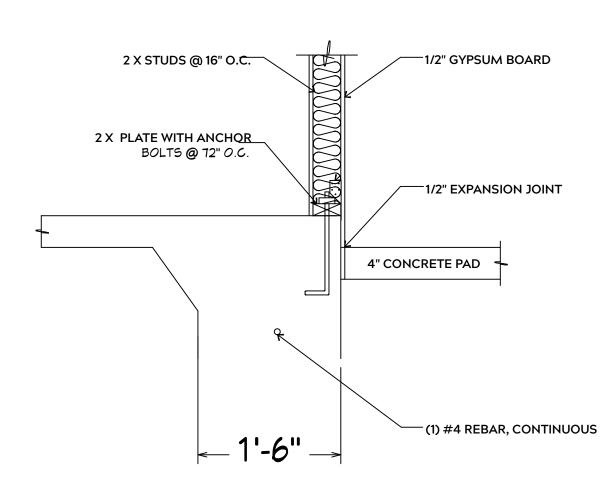

FOUNDATION NOTES:


ALL FOOTINGS SHALL BEAR ON ORIGINAL UNDISTURBED SOIL THE 28 DAY COMPRESSIVE STRENGTH OF ALL **FOOTINGS IS 3000 PSI**

PROVIDE WATER PROOFING AND PERIMTER **DRAINS AS REQUIRED**

FOOTING WIDTHS ARE BASED ON A LOAD **BEARING SOIL CAPACITY OF 2000 PSI**

PROVIDE 6 MIL POLY VAPOR BARRIER TO COVER GROUND IN CRAWL SPACE AND **GROUND UNDER POURED CONCRETE**

ALL ANCHOR BOLTS TO BE 1/2" X 12" LONG. ANCHOR BOLTS SHALL BE SPACED AT A MAXIMUM OF 6' ON CENTER AND NO MORE THEN 1' FROM EACH CORNER

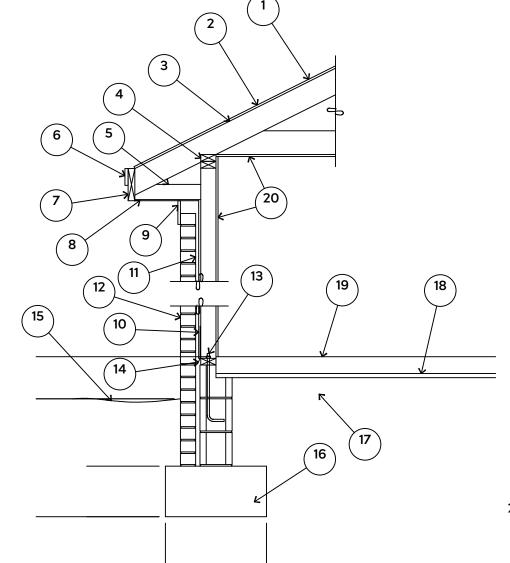

15# FELT UNDERLAYMENT UNDER COMPOSITION SHINGLES.

ROOF DECKING.

3. 2 X RAFTERS / ENGINEERED TRUSSES

DOUBLE TOP PLATE.

5. 2 X 4 RETURN. 6. 3/4" FASCIA OR PVC TRIM COIL

7. 2 X FASCIA

1/4" PLYWOOD OR VINYL SOFFIT 9. 1X FREIZE BOARD (TO BE USED WITH

BRICK VENEERS)

10. INSULATION BOARD OR HOUSE WRAP

11. AIR SPACE.

12 BRICK WITH BRICK TIES PER MANUFACTURER'S SPECIFICATIONS.

13. 1/2" X 12" ANCHOR BOLTS, 6'-0" O.C., 12" FROM CORNERS.

4. FLASHING WITH WEEP HOLES @ 48" O.C.

15. FINISHED GRADE.

16. FOOTING


17. COMPACTED EARTH FILL

18. 6 MIL. VAPOR BARRIER 19. 4" CONCRETE SLAB, 3,000 P.S.I.

WITH 6" X 6" 10 GA. X 10 GA. WELDED WIRE FABRIC.

20. 1/2" GYPSUM BOARD.

EXTERIOR WALL SECTION

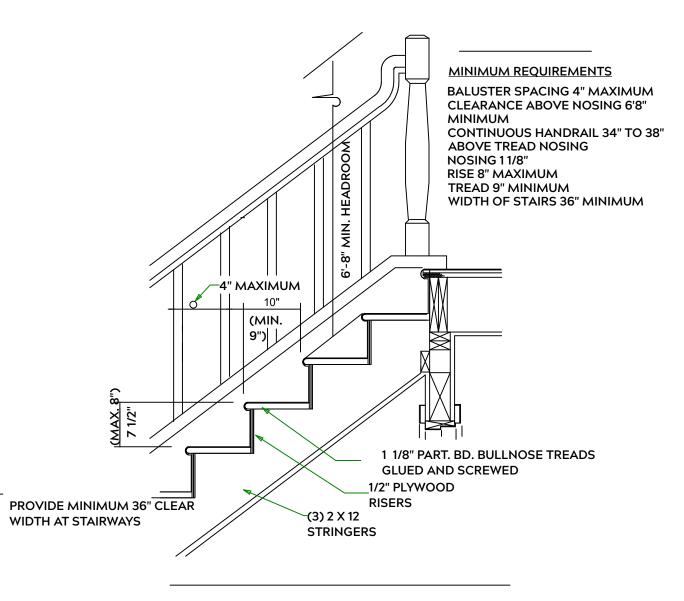

STAIR DETAIL

GENERAL FRAMING NOTES:

ALL LUMBER IN CONTACT WITH CONCRETE OR MASONRY SHALLE BE PRESSURE TREATED

FRAMING LUMBER SHALL BE SYP #2 GRADE AND / OR SPRUCE PINE FIR #1 AND / OR KILN DRIED

WHERE PRE-ENGINEERED JOISTS AND TRUSSES ARE USED, MANUFACTURER SHALL PROVIDE DRAWINGS / SCHEMATICS, WHICH SHALL BEAR OF A N.C. **ENGINEER**

STUDS AND JOISTS SHALL NOT BE CUT TO INSTALL PLUMBING OR WIRING WITHOUT ADDING METAL OR WOOD SIDE PANELS TO STRENGTHEN MEMBER TO ITS ORIGINAL CAPACITY

NAIL MULTIPLE MEMBERS WITH 2 ROWS OF 16d NAILS STAGGERED 32" O.C. AND USE 3 X 16d NAILS 2" IN AT EACH END.

NAIL FLOOR JOISTS TO SILL PLATE WITH WITH 8d TOE NAILS

ALL EXPOSED FRAMING ON PORCHES OR DECKS SHALL BE PRESSURE **TREATED**

PROVIDE WATERPROOFING AND DRAINS AS REQUIRED

ALL FRAMING TO BE 16" O.C. WALL FRAMING DIMENSIONS ARE BASED ON 2X4 OR 2X6 EXTERIOR WALLS AND 2X4 INTERIOR WALLS. DOULBE / TRIPLE JACK STUDS AS NECESSARY UNDER HEADERS AS REQUIRED

LVL'S TO BE SIZED BY OTHERS (TRUSS MANUFACTURER)

INTERIOR WALL @ GARAGE STEP DOWN

PLAN: Rothbard w/ Porch

> SHEETS AIL ET

 $\bar{\Box}$ $\bar{\Box}$

ADDRESS BD Persimmon Tree Magnolias Hills Lot PROJECT ADDF BD Persimmon 7 TBD

Precision Custom Hor Raeford, NC @PrecisionCustomHor

DATE:


10/16/24


SCALE:

1/4" = 1'

SHEET:

A-3

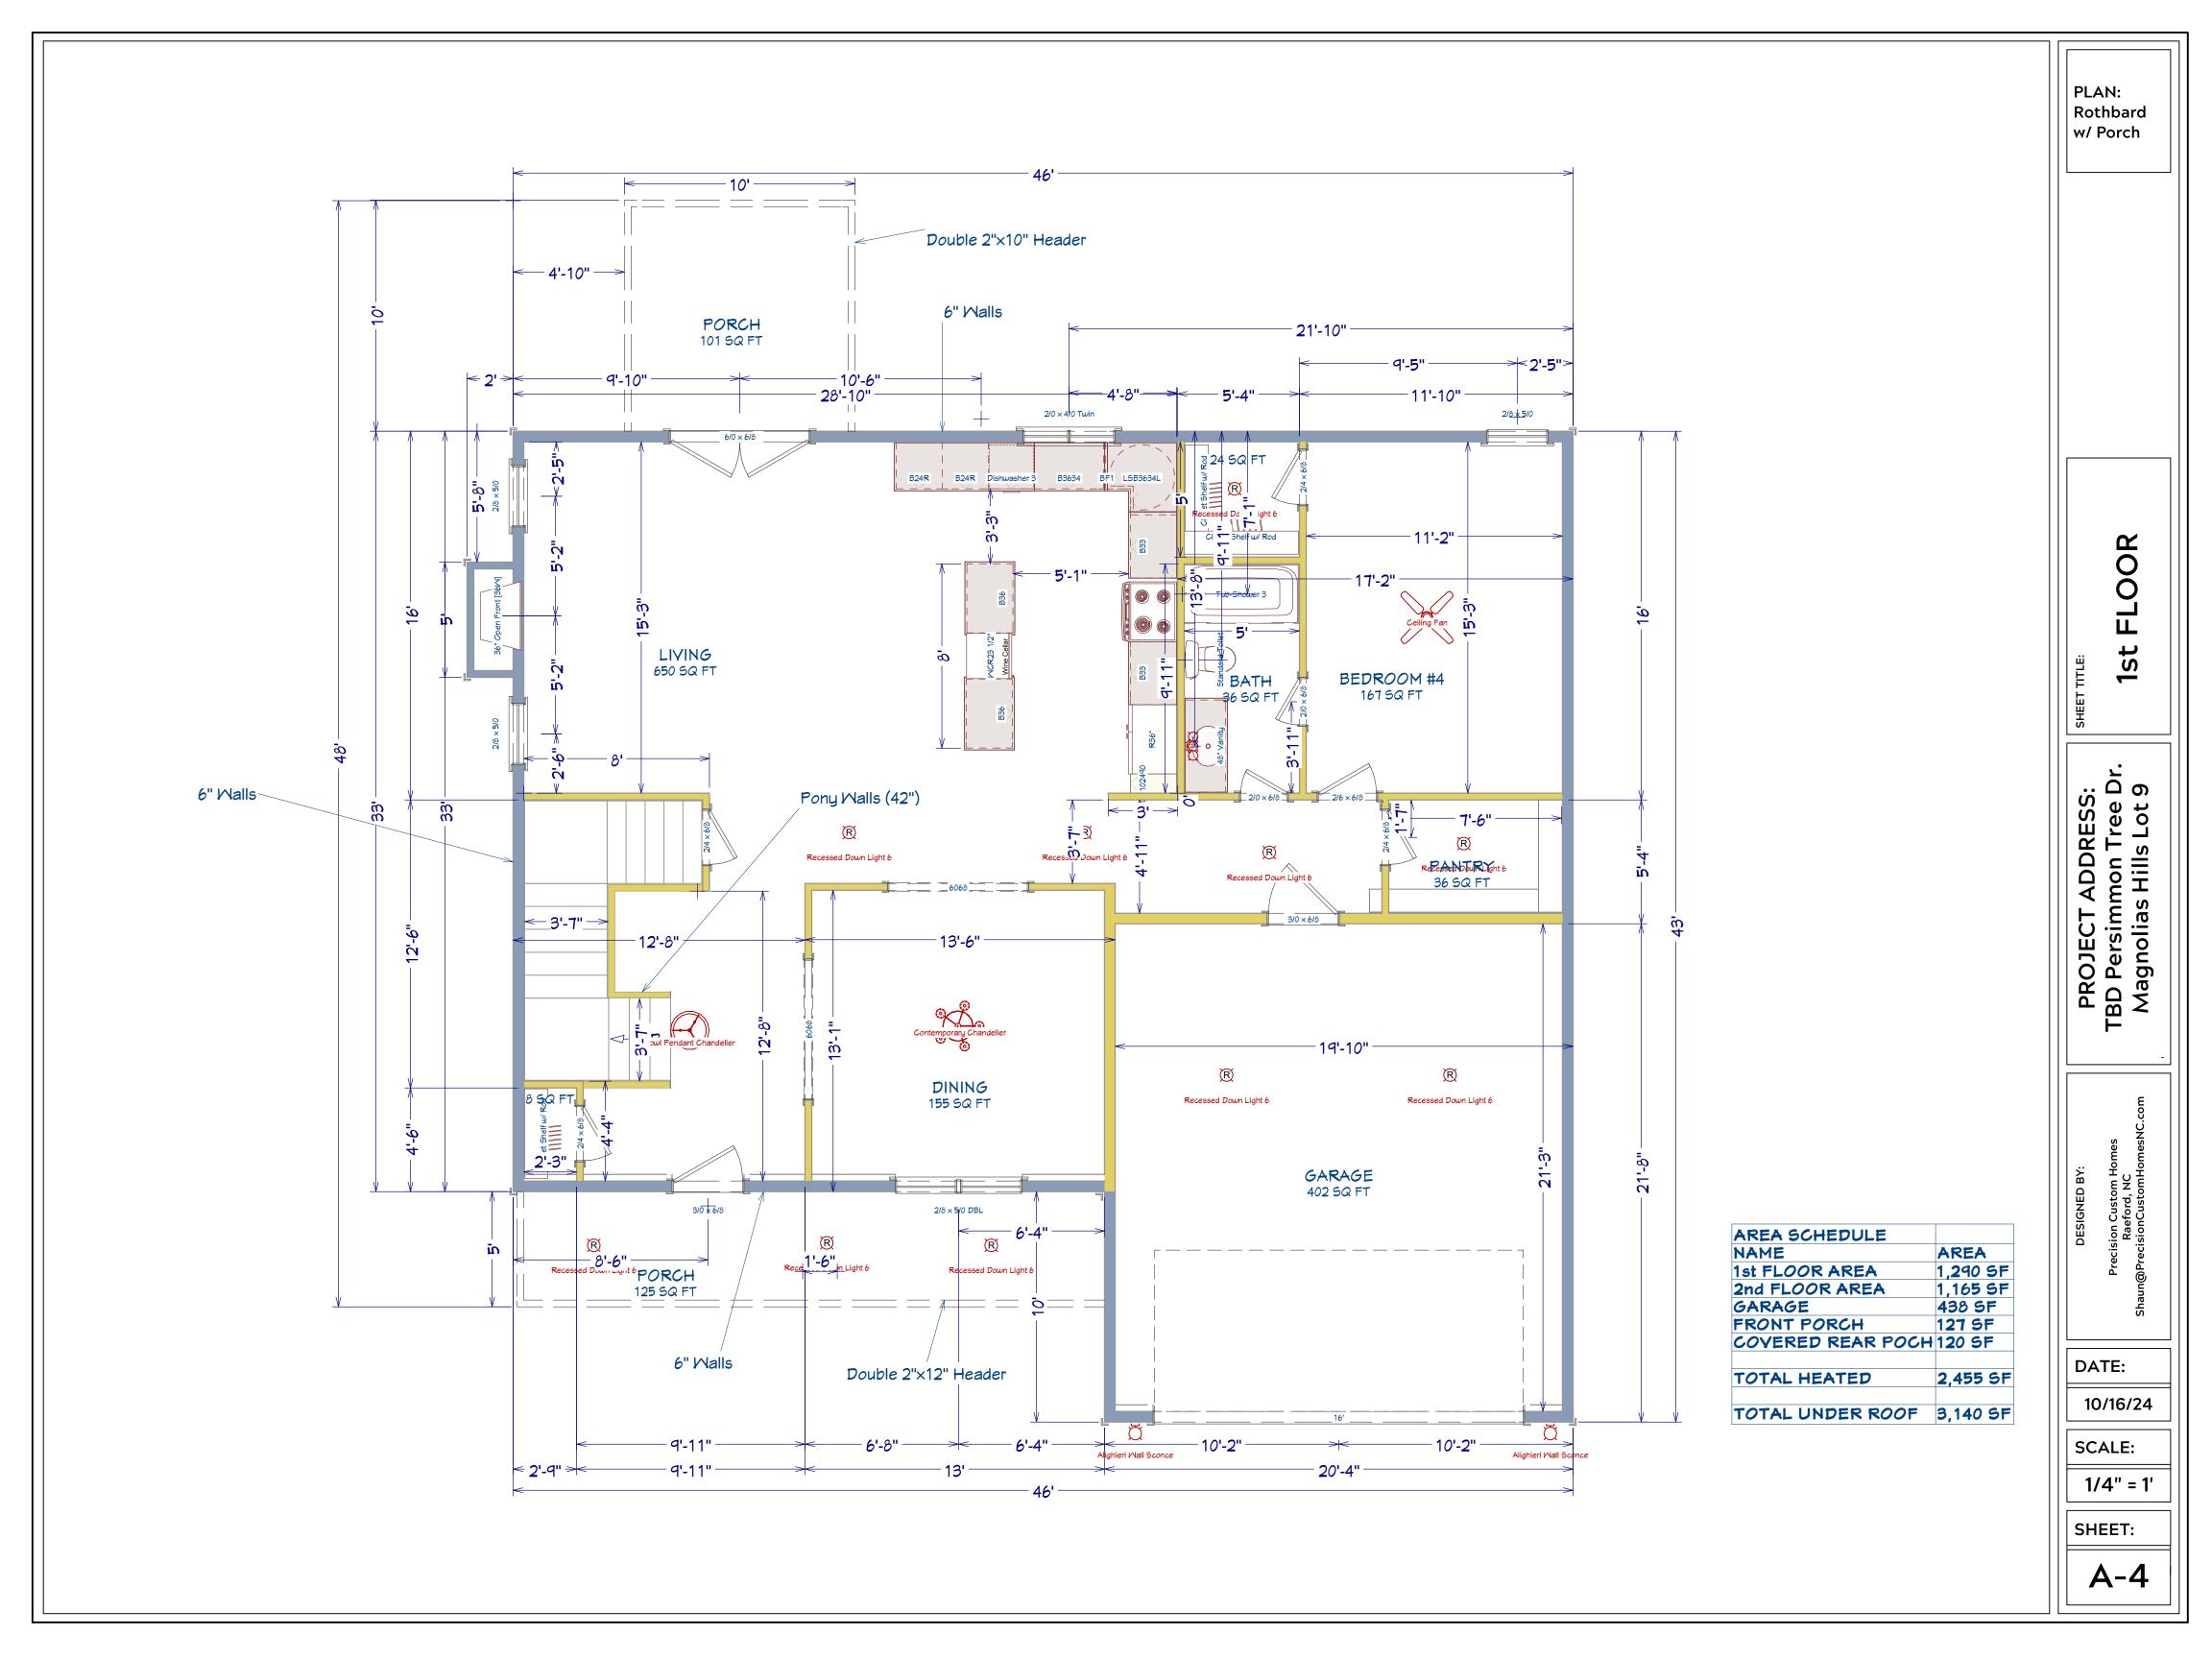

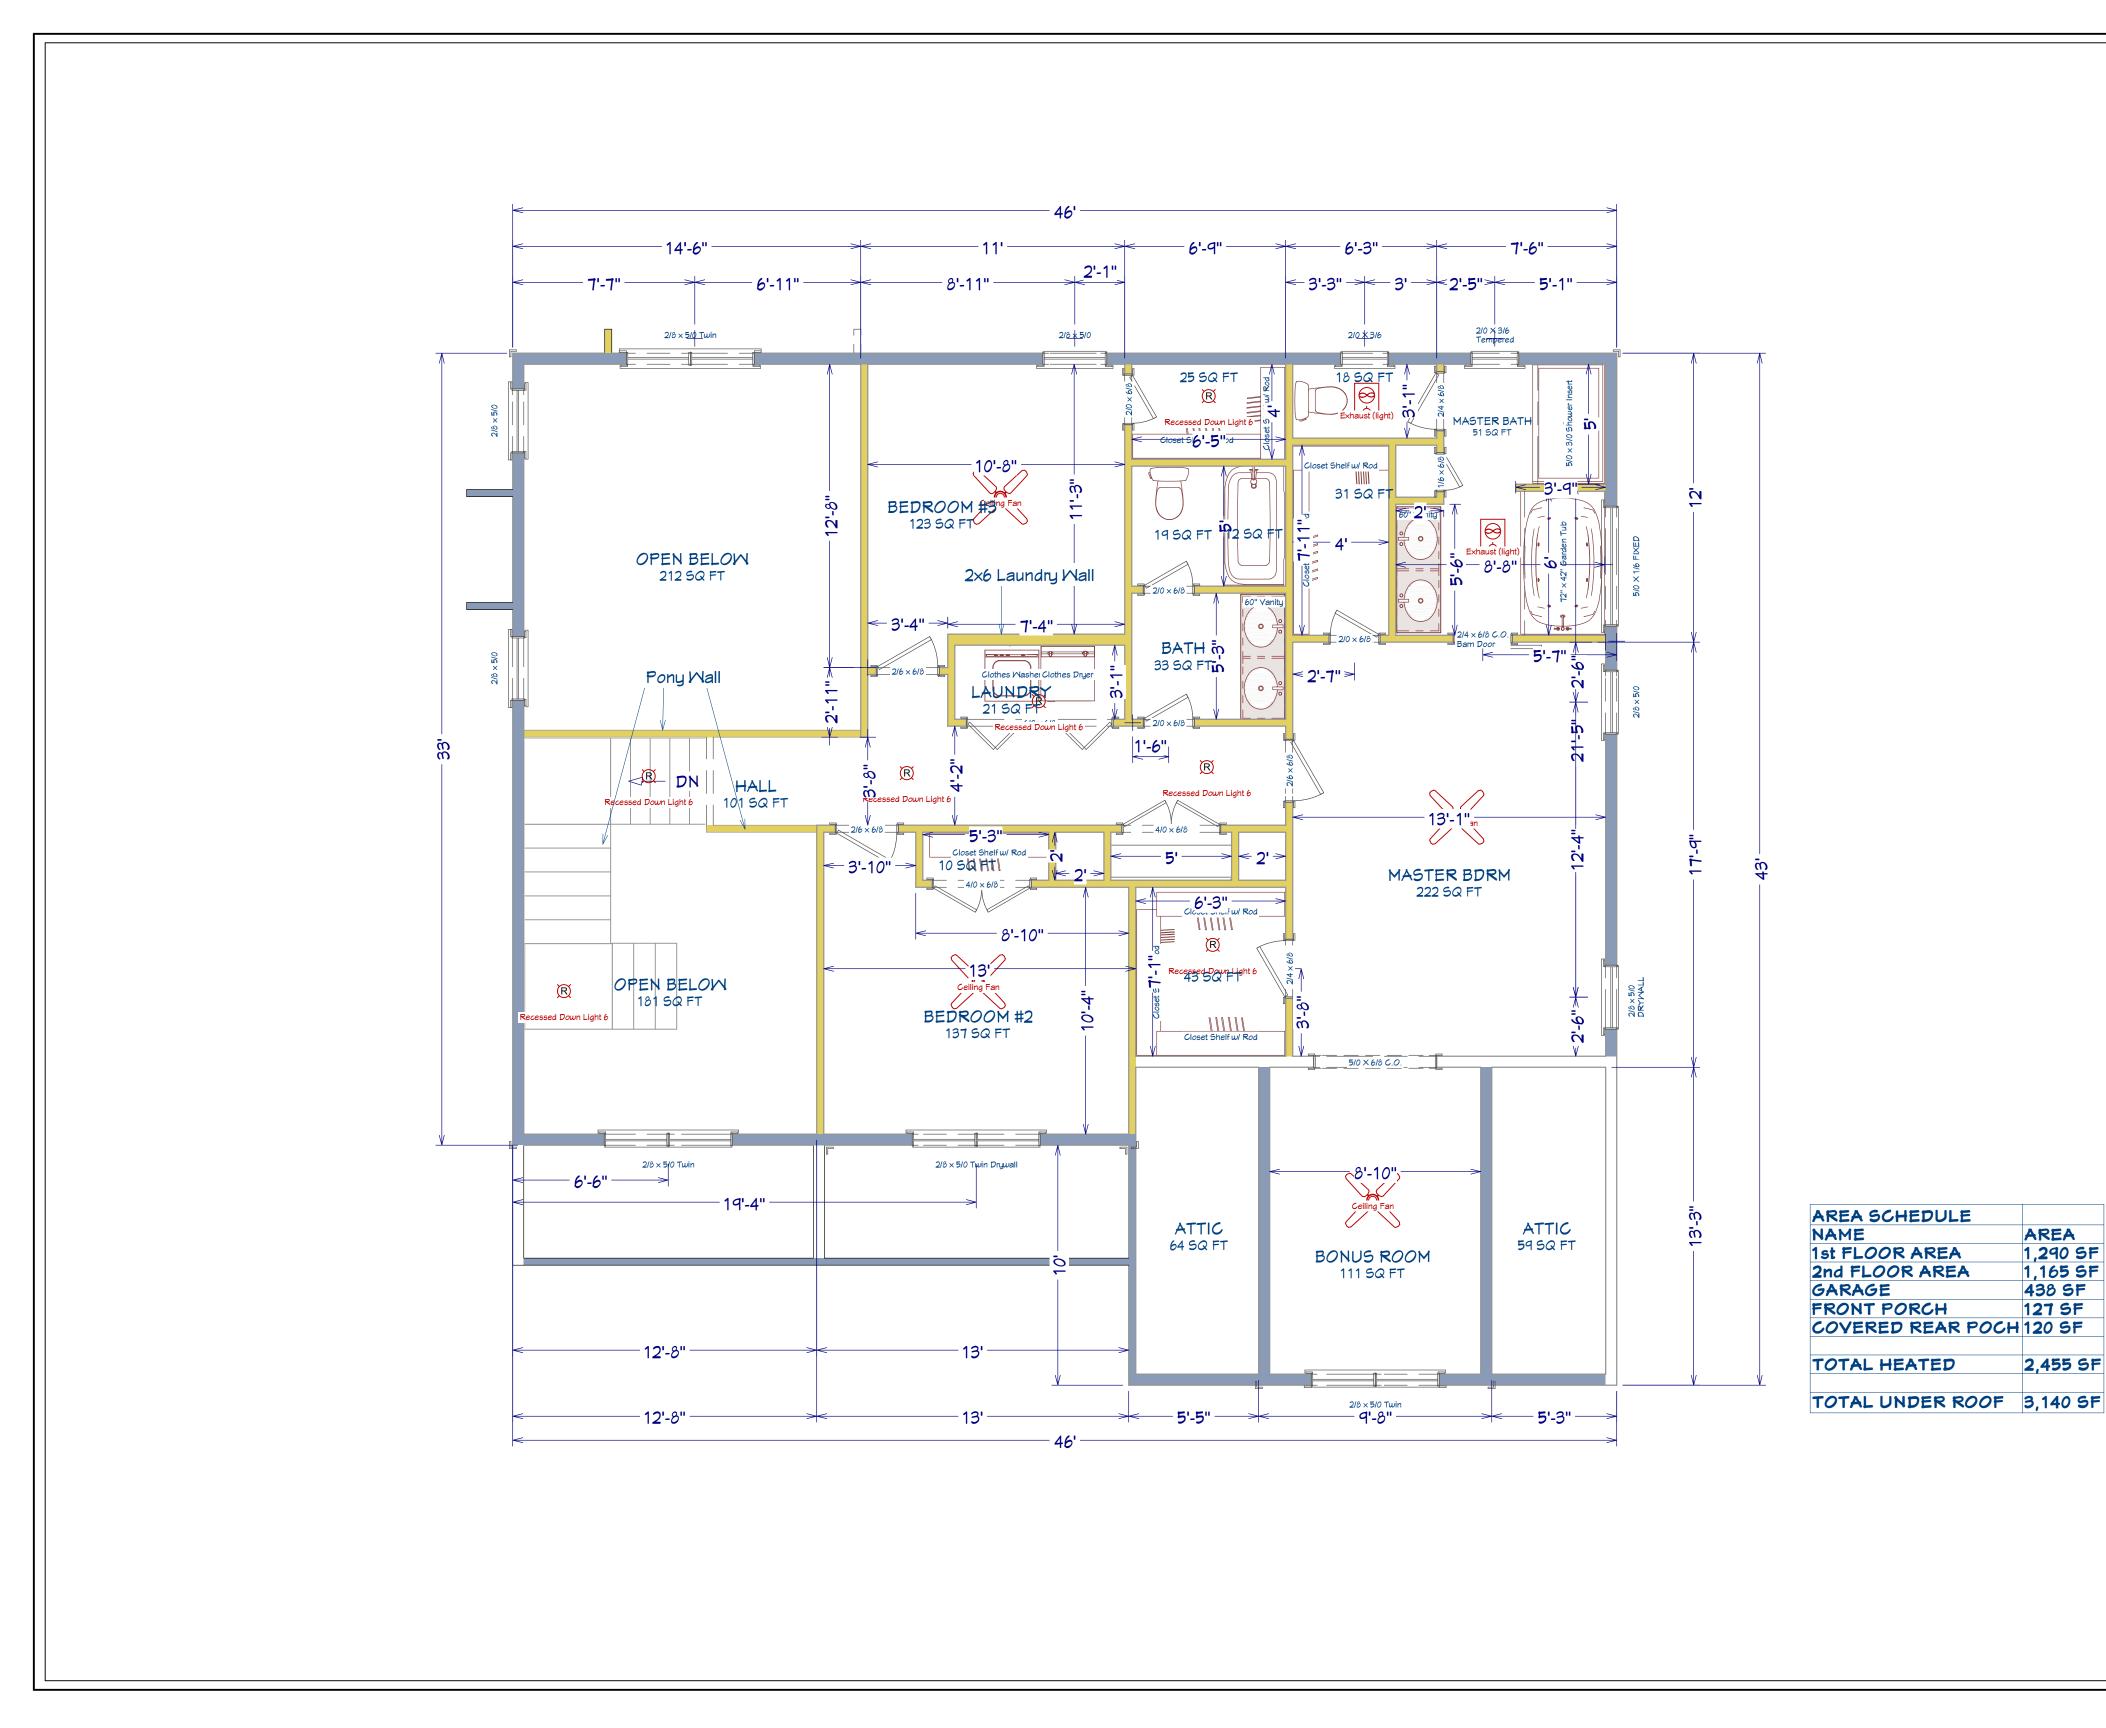

PLAN: Rothbard w/ Porch

2nd FLOOR

PROJECT ADDRESS: TBD Persimmon Tree Dr. Magnolias Hills Lot 9

Precision Custom Hom Raeford, NC n@PrecisionCustomHom DESIGNED BY:

DATE:


10/16/24

SCALE:

SHEET:

1/4" = 1'

A-5

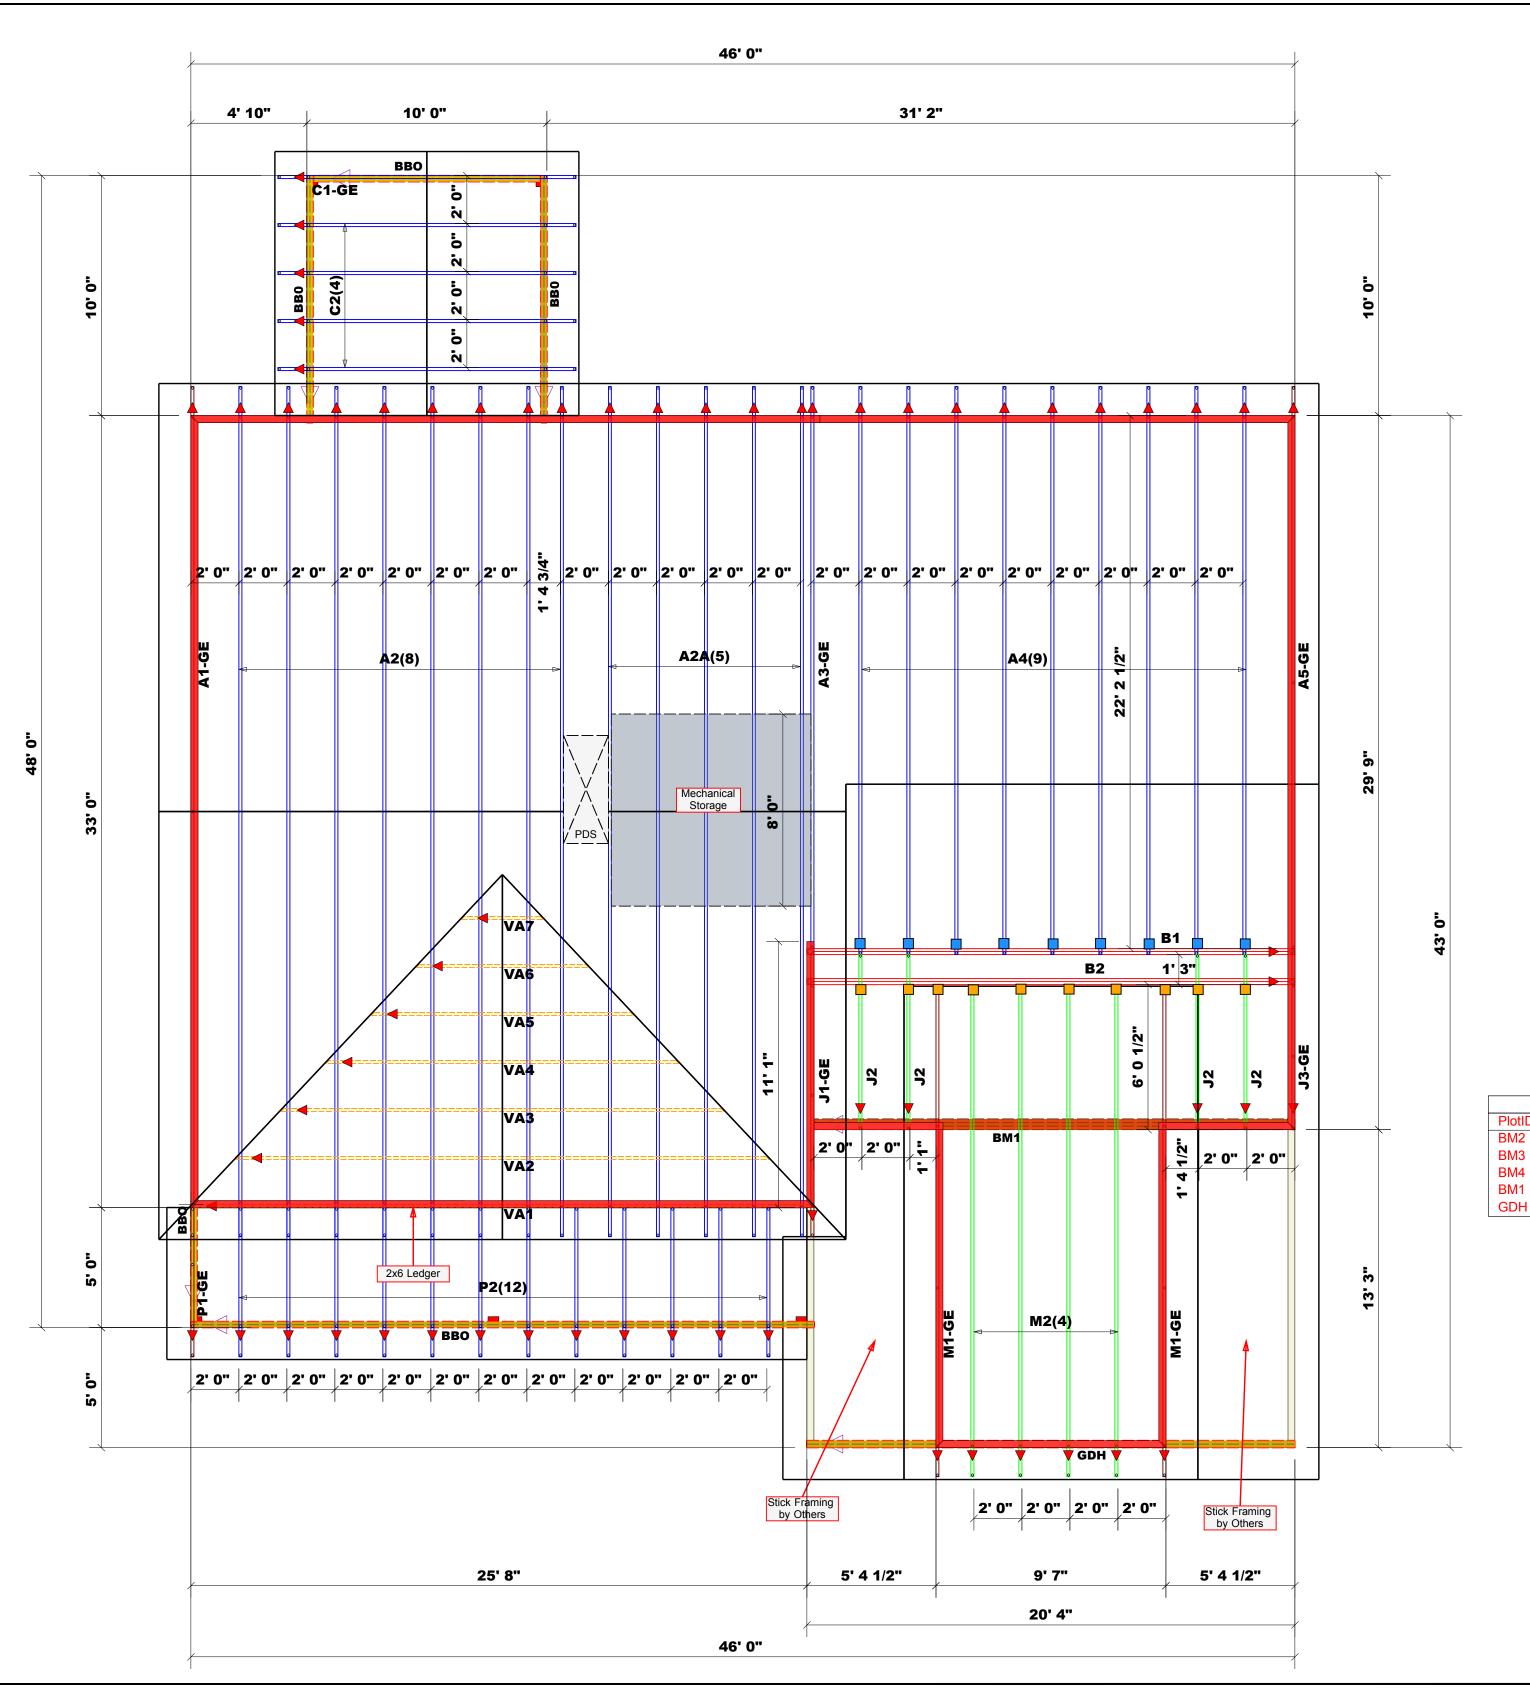



Reilly Road Industrial Park Fayetteville, N.C. 28309 Phone: (910) 864-8787 Fax: (910) 864-4444

Bearing reactions less than or equal to 3000# are deemed to comply with the prescriptive Code requirements. The contractor shall refer to the attached Tables (derived from the prescriptive Code requirements) to determine the minimum foundation size and number of wood studs required to support reactions greater than 3000# but not greater than 15000#. A registered design professional shall be retained to design the support system for any reaction that exceeds those specified in the attached Tables. A registered design professional shall be retained to design the support system for all reactions that exceed 15000#.

Neil Baggett

LOAD CHART FOR JACK STUDS

(BASED ON TABLES R502.5(1) & (b)) NUMBER OF JACK STUDS REQUIRED @ EA END OF HEADER/GIRDER END REACTION
(UP TO)
REQ'D STUDS FOR
(3) PLY HEADER END REACTION
(UP TO)
REQ'D STUDS FOR
(4) PLY HEADER 3400 1 1700 1 2550 1 3400 2 6800 2 5100 2 7650 3 10200 3

13600 4

17000 5

5100 3

13600 8 15300 9

Truss Placement Plan
Scale: 1/4"=1'

Dimension Notes

1. All exterior wall to wall dimensions are to face of stud unless noted otherwise
2. All interior wall dimensions are to face of stud unless noted otherwise
3. All exterior wall to truss dimensions are to face of stud unless noted otherwise

Roof Area = 2630.09 sq.ft.

Ridge Line = 59.33 ft.

Raked OH = 315.12 ft.

Decking = 90 sheets

All Walls Shown Are

Considered Load Bearing

= Indicates Left End of Truss (Reference Engineered Truss Drawing) Do Not Erect Trusses Backwards

Hip Line = 0 ft.

Horiz. OH = 182 ft.

Plumbing Drop Notes Plumbing drop locations shown are NOT exact.
 Contractor to verify ALL plumbing drop locations prior to setting Floor Trusses.
 Adjust spacing as needed not to exceed 24"oc.

	Conne	Nail Info	rmation			
Sym	Product	Manuf	Qty	Supported Member	Header	Truss
	MSH422	USP	9	Varies	10d/3"	10d/3"
	JUS26	USP	10	Varies	10d/3"	10d/3"
	HUS26	USP	9	Varies	16d/3-1/2"	16d/3-1/2"


		Products			
PlotID	Length	Product	Plies	Net Qty	Fab Type
BM2	7' 0"	1-3/4"x 9-1/4" LVL Kerto-S	2	2	FF
BM3	7' 0"	1-3/4"x 9-1/4" LVL Kerto-S	2	2	FF
BM4	6' 0"	1-3/4"x 9-1/4" LVL Kerto-S	2	2	FF
BM1	21' 0"	1-3/4"x 14" LVL Kerto-S	3	3	FF
GDH	21' 0"	1-3/4"x 16" LVL Kerto-S	2	2	FF


Hatch Legend
Mechanical & Light Storage
2nd Floor Walls @ 8' 1 1/2" UNO
Flush Beam
Drop Beam

Precision Custom Homes & Renovations	Lot 9 Magnolia Hills	Rothbard 1.0 w/CP	9/30/2024	N/A	J1024-5360
couNTY	ADDRESS	MODEL	DATE REV . 10/1/2024	DRAWN BY	SALESMAN
Harnett	Lot 9 Magnolia Hills, C	Roof	10/1/2024	DRAWN BY Neil Baggett	SALESMAN Neil Baggett

See individual design sheets for each truss design identified on the placement drawing. The building designer is responsible for temporary and permanent bracing of the roof and floor system and for the overall structure. The design of the truss support structure including headers, beams, walls, and columns is the responsibility of the building designer. For general guidance regarding bracing, consult BCSI-B1 and BCSI-B3 provided with the truss delivery package or online @ shcindustry com

truss delivery package or online @ sbcindustry.com

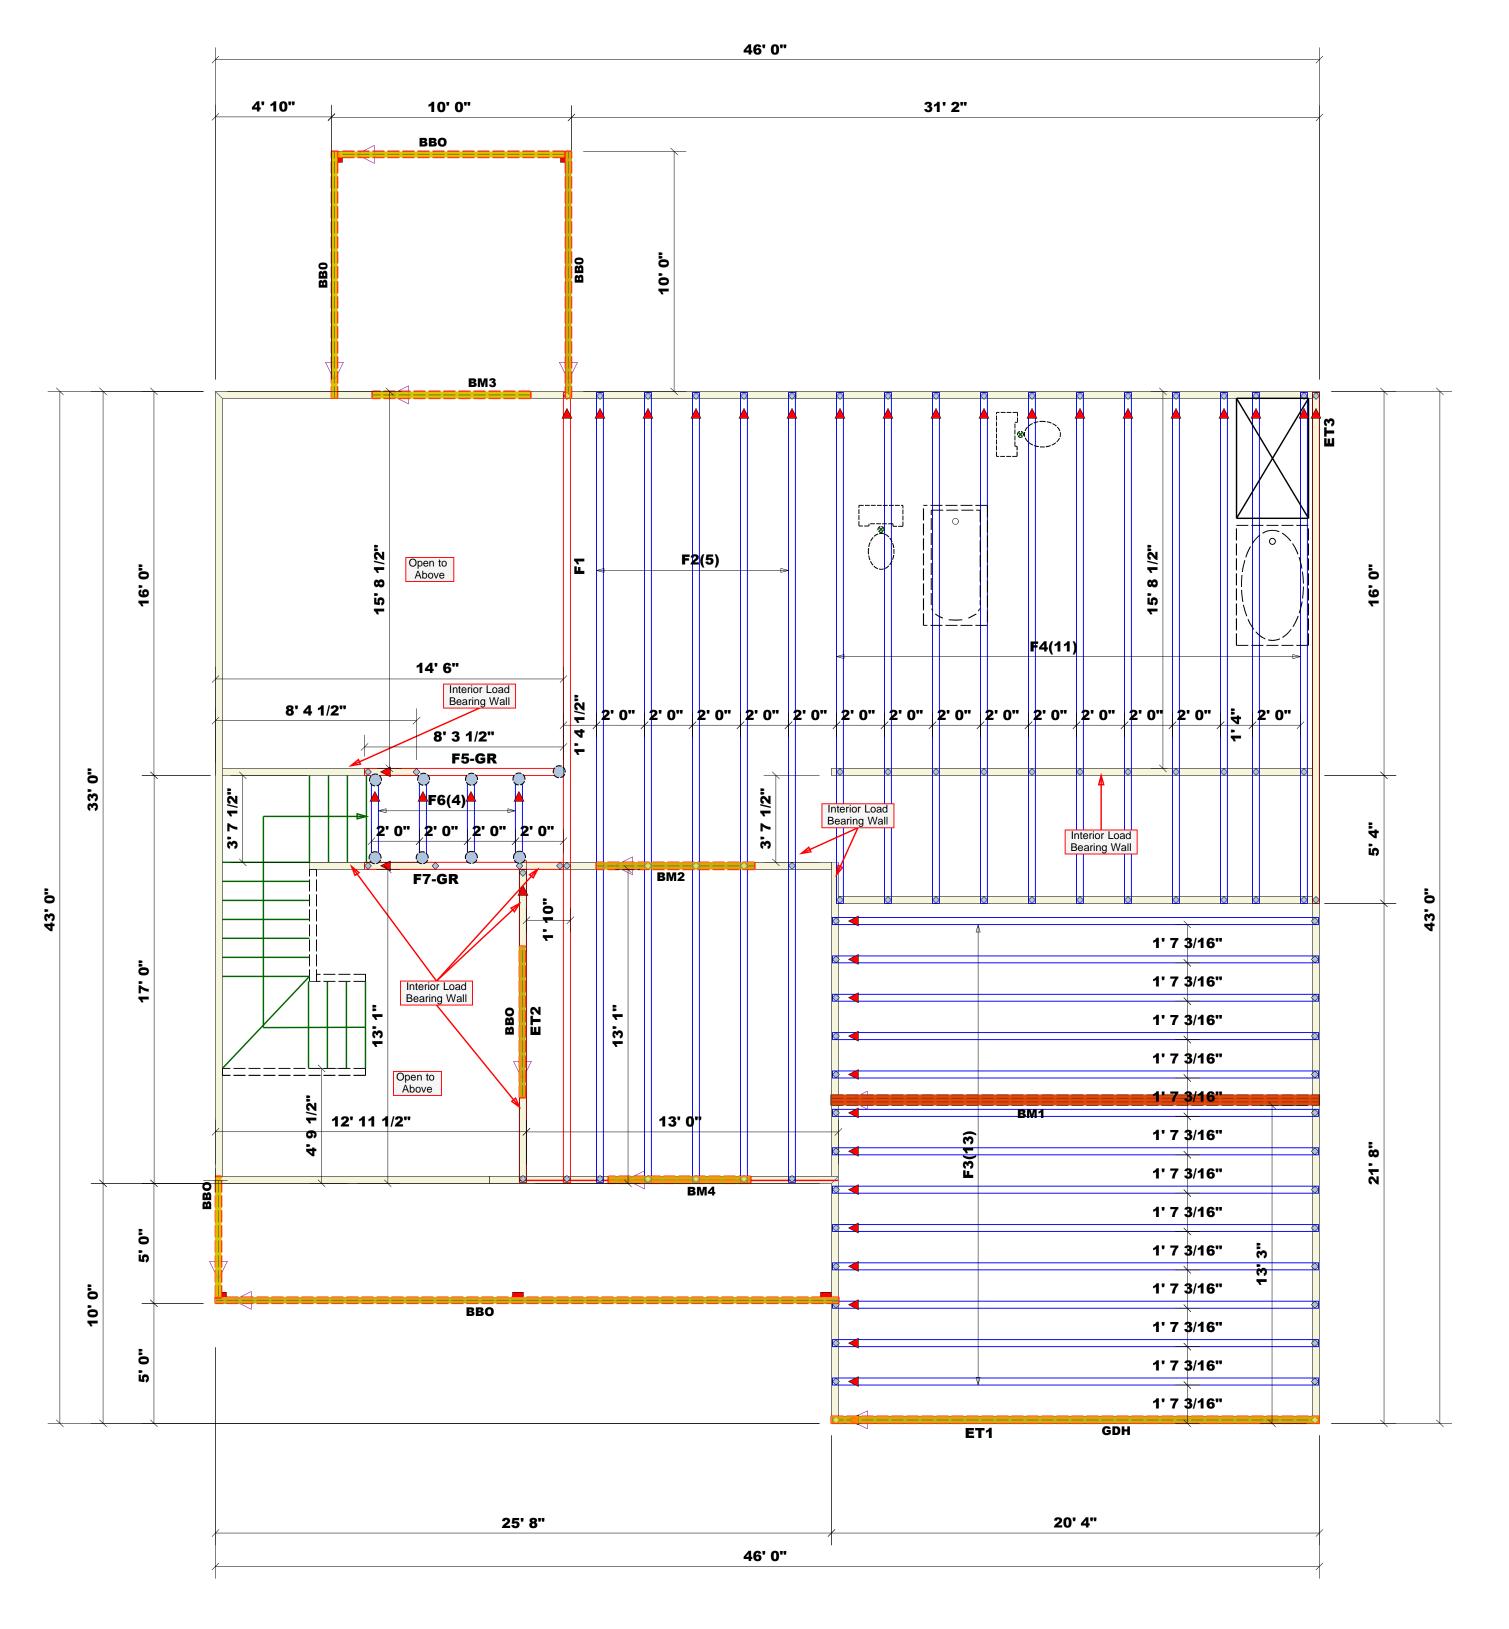

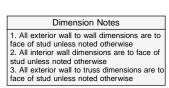

Roof Area = 2630.09 sq.ft.
Ridge Line = 59.33 ft.
Hip Line = 0 ft.
Horiz. OH = 182 ft.
Raked OH = 315.12 ft.
Decking = 90 sheets

All Walls Shown Are Considered Load Bearing

▲ = Indicates Left End of Truss (Reference Engineered Truss Drawing) Do Not Erect Trusses Backwards


Truss Placement Plan
Scale: 1/4"=1'

Plumbing Drop Notes

1. Plumbing drop locations shown are NOT exact.
2. Contractor to verify ALL plumbing drop locations prior to setting Floor Trusses.
3. Adjust spacing as needed not to exceed 24"oc.

	Connector Information					Nail Information		
Sym	Product	Manuf	Qty	Supported Member	Header	Truss		
\bigcirc	MSH422	USP	9	Varies	10d/3"	10d/3"		
	JUS26	USP	10	Varies	10d/3"	10d/3"		
	HUS26	USP	9	Varies	16d/3-1/2"	16d/3-1/2"		

		Products			
PlotID	Length	Product	Plies	Net Qty	Fab Type
BM2	7' 0"	1-3/4"x 9-1/4" LVL Kerto-S	2	2	FF
BM3	7' 0"	1-3/4"x 9-1/4" LVL Kerto-S	2	2	FF
BM4	6' 0"	1-3/4"x 9-1/4" LVL Kerto-S	2	2	FF
BM1	21' 0"	1-3/4"x 14" LVL Kerto-S	3	3	FF
GDH	21' 0"	1-3/4"x 16" LVL Kerto-S	2	2	FF

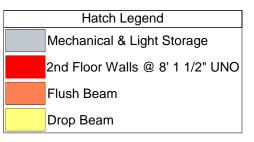

ROOF & FLOOR TRUSSES & BEAMS

Reilly Road Industrial Park Fayetteville, N.C. 28309 Phone: (910) 864-8787 Fax: (910) 864-4444

Bearing reactions less than or equal to 3000# are deemed to comply with the prescriptive Code requirements. The contractor shall refer to the attached Tables (derived from the prescriptive Code requirements) to determine the minimum foundation size and number of wood studs required to support reactions greater than 3000# but not greater than 15000#. A registered design professional shall be retained to design the support system for any reaction that exceeds those specified in the attached Tables. A registered design professional shall be retained to design the support system for all reactions that exceed 15000#.

No:I Da

Neil Baggett

LOAD CHART FOR JACK STUDS

(BASED ON TABLES R502.5(1) & (b))

NUMBER OF JACK STUDS REQUIRED @ EA END OF HEADER/GIRDER

\$ 1 NOO3	Harnett
ADDRESS	Lot 9 Magnolia Hills, Cameron, NC
MODEL	Floor
DATE REV.	10/1/2024
DRAWN BY	DRAWN BY Neil Baggett
SALESMAN	SALESMAN Neil Baggett

BUILDERPrecision Custom Homes & RenovationsJOB NAMELot 9Magnolia HillsPLANRothbard 1.0 w/CPSEAL DATE9/30/2024QUOTE #N/AJOB #J1024-5361

THIS IS A TRUSS PLACEMENT DIAGRAM ONLY.

These trusses are designed as individual building components to be incorporated into the building design at the specification of the building designer. See individual design sheets for each truss design identified on the placement drawing. The building designer is responsible for temporary and permanent bracing of the roof and floor system and for the overall structure. The design of the truss support structure including headers, beams, walls, and columns is the responsibility of the building designer. For general guidance regarding bracing, consult BCSI-B1 and BCSI-B3 provided with the truss delivery package or online @ sbcindustry.com

North Carolina 2018 - R402.1.5 Total UA

Property 168 Edes Ct. Cameron, NC 28326 Model: Rothbard

Community: Liberty Meadows

Template - SMG Precision - Liberty Meadows Lot 20 - CZ 4 slab -Liberty Meadows Lot 20 Organization
Southern Energy Manager

Justin Smith

Builder

SMG Precision Properties



This report is based on a proposed design and does not confirm field enforcement of design elements.

Inspection Status

Results are projected

Building UA

Elements	NC Reference	As Designed
Ceilings	47.3	44.9
Above-Grade Walls	195.7	145.3
Windows, Doors and Skylights	126.2	113.8
Slab Floor:	76.4	99.6
Framed Floors	13.5	14.7
Foundation Walls	0.0	0.0
Rim Joists	8.8	7.1
Overall UA (Design must be equal or lower):	467.9	425.4

Requirements

402.1.5	Total UA alternative compliance passes by 9.1%.	
402.3.2	Average SHGC: 0.28 Max SHGC: 0.30	
R402.4.2.2	Air Leakage Testing	Air sealing is 4.80 ACH at 50 Pa. It must not exceed 5.00 ACH at 50 Pa.
R402.5	Area-weighted average fenestration SHGC	
R402.5	Area-weighted average fenestration U-Factor	
R404.1	Lighting Equipment Efficiency	
Mandatory Checklist	Mandatory code requirements that are not checked by Ekotrope must be met.	
R403.3.1	Duct Insulation	
403.3.3	Duct Testing	

Design exceeds requirements for North Carolina 2018 Prescriptive compliance by 9.1%.

Name:	Justin Smith	Signature:	Justin Smith
Organization:	Southern Energy Management	Digitally signed:	9/2/22 at 12:56 PM

Property 168 Edes Ct. Cameron, NC 28326 Model: Rothbard Community: Liberty Meadows

Template - SMG Precision - Liberty Meadows Lot 20 - CZ 4 slab - ecoSelect Liberty Meadows Lot 20

Organization Southern Energy Manag

Southern Energy Management Justin Smith

Inspection Status

Results are projected

Builder

SMG Precision Properties



General Building Informati	ion
Number Of Bedrooms	4
Number Of Floors	2
Conditioned Floor Area [sq. ft.]	2,455
Has Electric Vehicle Ready Space	No
Unconditioned, attached garage?	Yes
Conditioned Volume [cu. ft.]	25,604
Total Units in Building	1
Residence Type	Single family detached
Number of Floors in Building	-
Floor Number	-
Model	Rothbard
Community	Liberty Meadows
RESNET/IECC 2006 Climate Zone	4A
IECC 2021 Climate Zone	3A

Foundation Wall

None Present

Foundation Wall Library List

None Present

Slab									
	Name	Library Type	Perimeter	Floor Grade	Carpet R	Exposed Masonry Area	Surface Area	Location	Enclosing
	slab	Uninsulated	158	On Grade	1	0	1,290.0 ft²	Exposed Exterior	Conditioned Space

Slab Library List										
Name	Wall Construction Type	Slab Completely Insulated?	Underslab Insulation Width [ft]	Perimeter Insulation Depth [ft]	Perimeter Insulation R Value	Thermal Break	Effective R-value			
Uninsulated	Wood Frame / Other	No	0	0	0	No	0.00			

Property 168 Edes Ct. Cameron, NC 28326 Model: Rothbard Community: Liberty Meadows

Liberty Meadows Lot 20

Community: Liberty Meadows

Template - SMG Precision - Liberty Meadows Lot 20
- CZ 4 slab - ecoSelect

Organization Southern Energy Management Justin Smith

Builder SMG Precision Properties Inspection Status Results are projected



	Framed Floo	r				
	Name	Library Type	Carpet R	Floor Grade	Surface Area	Location
ı						
ı	over garage	R 19, 16"OC G1 Carpet	0	Above Grade	287.0 ft²	Unconditioned, attached garage

Framed Floor Library List			
	Name	Effective R-value	
R 19, 16"OC	G1 Carpet	19.566	

Rim Joist			
Name	Library Type	Surface Area	Location
1st floor ambient	R 19 G1, 16"OC	126.0 ft²	Exposed Exterior
1st floor garage	R 19 G1, 16"OC	32.0 ft²	Unconditioned, attached garage

Rim Joist Library List			
Name	Effective Insulation R-value		
R 19 G1, 16"OC	17.30		

Name	Library Type	Surface Color	Surface Area	Locatio
1st floor ambient	R 19 Adv. Framing G1 16" O.C	Medium	1,135.0 ft²	Exposed Exterio
1st floor garage	R 19 Adv. Framing G1 16" O.C	Medium	287.0 ft²	Unconditioned, attached garage
	-			
2nd floor ambient	R 19 Adv. Framing G1 16" O.C	Medium	1,158.0 ft²	Exposed Exterior
2nd floor attic	R 19 Adv. Framing G1 16" O.C	Medium	322.0 ft²	Atti

Property 168 Edes Ct. Cameron, NC 28326 Model: Rothbard Community: Liberty Meadows

Template - SMG Precision - Liberty Meadows Lot 20 - CZ 4 slab - ecoSelect Liberty Meadows Lot 20

Organization Southern Energy Management Justin Smith

Builder SMG Precision Properties Inspection Status Results are projected



Wall Library List					
Name	Effective R-value				
R 19 Adv. Framing G1 16" O.C	17.492				

Glazing									
Name	Library Type	Wall Assignment	Foundation Wall Assignment	is Operable	Overhang Depth	Overhang Ft To 0 Top	Overhang Ft To Bottom	Orientation	Surface Area
front 2nd unshaded	33/28	2nd floor ambient		Yes	0	0	0	West	81.0 ft²
front shaded	33/28	1st floor ambient		Yes	5	1	6	West	27.0 ft²
left 2nd unshaded	33/28	2nd floor ambient		Yes	0	0	0	North	27.0 ft²
left unshaded	33/28	1st floor ambient		Yes	0	0	0	North	27.0 ft²
rear 2nd unshaded	33/28	2nd floor ambient		Yes	0	0	0	East	54.5 ft²
rear shaded	33/28	1st floor ambient		Yes	10	2	9	East	40.2 ft²
rear unshaded	33/28	1st floor ambient		Yes	0	0	0	East	29.5 ft²
right 2nd unshaded	33/28	2nd floor ambient		Yes	0	0	0	South	34.5 ft²

Glazing Library List			
Name	Shgc	U-factor	
33/28	0.28	0.330	

Skylight		
	None Present	

None Present

Property 168 Edes Ct. Cameron, NC 28326 Model: Rothbard Community: Liberty Meadows

Organization Southern Energy Management Justin Smith

Builder

SMG Precision Properties

Inspection Status Results are projected



Template - SMG Precision - Liberty Meadows Lot 20 - CZ 4 slab - ecoSelect Liberty Meadows Lot 20

Opaque Doo	r							
Name	Library Type	Wall Assignment	Foundation Wall Assignment		Solar Absorptance		Surface Area	Location
front entry	Fiberglass R-5	1st floor ambient		0.9	0.75	Medium	20.0 ft²	Exposed Exterior
garage entry	Fiberglass R-5	1st floor garage		0.9	0.75	Medium	20.0 ft²	Unconditioned, attached garage

Opaque Door Library List Effective U-factor Fiberglass R-5 0.200

Roof Insulation	on					
Name	Library Type	Attic Exterior Area [ft²]	Clay or Concrete Roof Tiles	Surface Color	Surface Area	Location
attic	R 38 Attic BLOWN FG G1 2x10 24"OC NO Padiant Barrier	2,318.19	No	Dark	1,577.0 ft²	Attic

Roof Insulation Library List				
Name	Has Radiant Barrier	Effective R-value		
R 38 Attic BLOWN FG G1 2x10 24"OC NO	No	35.115		

Whole House Inf	iltration	
Infiltration	Measurement Type	Shelter Class
2048 CFM at 50 Pa	Blower-door tested	4

Mechanical Ventilation

None Present

Property 168 Edes Ct. Cameron, NC 28326 Model: Rothbard Community: Liberty Meadows

Template - SMG Precision - Liberty Meadows Lot 20 - CZ 4 slab - ecoSelect Liberty Meadows Lot 20

OrganizationSouthern Energy Management
Justin Smith

Builder





_	iberty ineadows Lot 20					
	Lighting % Interior Fluorescent Lighting	% Interior LED Lighting	% Exterior Fluorescent Lighting	% Exterior LED Lighting	% Garage Fluorescent Lighting	% Garage LED Lighting
	0	90	0	0	0	0
	Onsite Genera		one Present			
	Onsite Genera	ation Library List				
		No	one Present			
	Solar Generat	tion				
		No	one Present			
	Dehumidifier					
		No	one Present			
	Dehumidifier	Library List				
		No	one Present			
	Whole House	Fan				
		No	one Present			

Property 168 Edes Ct. Cameron, NC 28326 Model: Rothbard Community: Liberty Meadows

Template - SMG Precision - Liberty Meadows Lot 20 - CZ 4 slab - ecoSelect Liberty Meadows Lot 20

Organization Southern Energy Management Justin Smith

Builder

SMG Precision Properties



Whole House Fan Library List

None Present

Conditioning	Equipment					
Name	Library Type	Serial Number	Heating Percent Load	Cooling Percent Load	Hot Water Percent Load	
1st floor heat pump	z 24k 14 SEER 8.0hspf		52%	52%	0%	Attic
2nd floor heat pump	z 24k 14 SEER 8.0hspf		48%	48%	0%	Attic
Water Heating	z 50 gal. 0.95 EF Elec		0%	0%	100%	Unconditioned Garage

Inspection Status

Results are projected

Equipment Type: z 24k 14 SEER 8.0hspf			
Equipment Type	Air Source Heat Pump		
Fuel Type	Electric		
Distribution Type	Forced Air		
Motor Type	PSC (Single Speed)		
Heating Efficiency	8 HSPF		
Heating Capacity [kBtu/h]	24		
Backup Fuel Type	Electric		
Switchover Temperature [°F]	0		
Backup Heating Efficiency	1 COP		
Use default Supplemental Heat	Yes		
Cooling Efficiency	14 SEER		
Cooling Capacity [kBtu/h]	24		

Equipment Type: z 24k 14 SEER 8.0hspf			
Equipment Type	Air Source Heat Pump		
Fuel Type	Electric		
Distribution Type	Forced Air		
Motor Type	PSC (Single Speed)		
Heating Efficiency	8 HSPF		
Heating Capacity [kBtu/h]	24		
Backup Fuel Type	Electric		
Switchover Temperature [°F]	0		
Backup Heating Efficiency	1 COP		
Use default Supplemental Heat	Yes		
Cooling Efficiency	14 SEER		
Cooling Capacity [kBtu/h]	24		

Property 168 Edes Ct. Cameron, NC 28326 Model: Rothbard Community: Liberty Meadows

Template - SMG Precision - Liberty Meadows Lot 20 - CZ 4 slab - ecoSelect Liberty Meadows Lot 20

Organization Southern Energy Management

Justin Smith

Builder





Equipment Type: z 50 gal. 0.95 EF Elec			
Equipment Type	Residential Water Heater		
Fuel Type	Electric		
Distribution Type	Hydronic Delivery (Radiant)		
Hot Water Efficiency	0.95 Energy Factor		
Tank Capacity (gal.)	50		
Hot Water Capacity [kBtu/h]	40		
Recovery Efficiency	0.98		

D: (!! (! 0 (
Distribution System	
Distribution Type	Forced Air
Heating Equipment	1st floor heat pump
Cooling Equipment	1st floor heat pump
Sq. Feet Served	1,290
# Return Grilles	2
Supply Duct R Value	8
Return Duct R Value	8
Supply Duct Area [ft²]	348.3
Return Duct Area [ft²]	129
Leakage to Outdoors	51 CFM @ 25Pa (3.95 / 100 ft²)
Total Leakage	51 CFM25
Total Leakage Duct Test Conditions	Post-Construction
Use Default Flow Rate	Yes
Duct 1	
Duct Location	Attic (well vented)
Percent Supply Area	70
Percent Return Area	70
Duct 2	
Duct Location	Conditioned Space
Percent Supply Area	30
Percent Return Area	30
Duct 3	
Duct Location	Conditioned Space
Percent Supply Area	0
Percent Return Area	0
Duct 4	
Duct Location	Conditioned Space
Percent Supply Area	0
Percent Return Area	0
Duct 5	
Duct Location	Conditioned Space
Percent Supply Area	0
Percent Return Area	0
Duct 6	
Duct Location	Conditioned Space
Percent Supply Area	0
Percent Return Area	0
	-

Property 168 Edes Ct. Cameron, NC 28326 Model: Rothbard Community: Liberty Meadows

Template - SMG Precision - Liberty Meadows Lot 20 - CZ 4 slab - ecoSelect Liberty Meadows Lot 20

Organization Southern Energy Management Justin Smith

Builder



21 4 4 T	E 14:
Distribution Type	Forced Air
Heating Equipment	2nd floor heat pump
Cooling Equipment	2nd floor heat pump
Sq. Feet Served	1,165
# Return Grilles	2
Supply Duct R Value	8
Return Duct R Value	8
Supply Duct Area [ft²]	314.55
Return Duct Area [ft²]	116.5
_eakage to Outdoors	46 CFM @ 25Pa (3.95 / 100 ft²)
Total Leakage	46 CFM25
Total Leakage Duct Test Conditions	Post-Construction
Jse Default Flow Rate	Yes
Duct 1	
Duct Location	Attic (well vented)
Percent Supply Area	100
Percent Return Area	100
Duct 2	
Duct Location	Conditioned Space
Percent Supply Area	0
Percent Return Area	0
Duct 3	
Duct Location	Conditioned Space
Percent Supply Area	0
Percent Return Area	0
Duct 4	
Duct Location	Conditioned Space
Percent Supply Area	0
Percent Return Area	0
Duct 5	
Duct Location	Conditioned Space
Percent Supply Area	0
Percent Return Area	0
Duct 6	
Duct Location	Conditioned Space
Percent Supply Area	0
Percent Return Area	0

HVAC Grading	
HVAC Grading Not Conducted	

Ceiling Fan				
Has Ceiling Fan	No			
Cfm Per Watt	100			

Property 168 Edes Ct. Cameron, NC 28326 Model: Rothbard Community: Liberty Meadows

Template - SMG Precision - Liberty Meadows Lot 20 - CZ 4 slab - ecoSelect Liberty Meadows Lot 20

Organization

Southern Energy Management Justin Smith

Inspection Status

Results are projected

Builder



Water Distribution	
Water Fixture Type	Low-flow
Use Default Hot Water Pipe Length	No
Hot Water Pipe Length [ft]	79
At Least R3 Pipe Insulation?	No
Hot Water Recirculation System?	No
Recirculation System Pipe Loop Length [ft]	20
Drain Water Heat Recovery?	No

Clothes Dryer	
Cef	3.01
Fuel Type	Electric
Field Utilization	Timer Controls
Is Outside Conditioned Space	No
Clothes Dryer Available	Yes
Defaults Type	HERS Reference

Clothes Washer	
Label Energy Rating	153 kWh/Year
Annual Gas Cost	\$12.00
Electric Rate	\$0.11/kWh
Gas Rate	\$1.22/Therm
Capacity	3.31
Imef	2.1547
Defaults Type	Custom
Load Type	Front-load
Loads Per Week	6
Is Outside Conditioned Space	No
Clothes Washer Available	Yes

Dishwasher	
Dishwasher Efficiency	270 kWh
Dishwasher Size	Standard
Annual Gas Cost	\$22.23
Electric Rate	\$0.12/kWh
Gas Rate	\$1.09/Therm
Is Outside Conditioned Space	No

Property 168 Edes Ct. Cameron, NC 28326 Model: Rothbard Community: Liberty Meadows

emplate - SMG Precision - Liberty Meadows Lo

Template - SMG Precision - Liberty Meadows Lot 20 - CZ 4 slab - ecoSelect Liberty Meadows Lot 20

Organization

Southern Energy Management Justin Smith

Inspection Status

Results are projected

Builder

SMG Precision Properties



Appliances and Controls	
Thermostat Cooling Setpoint	* * * * 75.0
Thermostat Heating Setpoint	* * * * 70.0
Range/Oven Fuel	Electric
Convection Oven?	No
Induction Range?	No
Range/Oven Outside Conditioned Space?	No
Refrigerator Consumption	538 kWh/Year
Refrigerator Outside Conditioned Space?	No

Notes

Initial Inputs _____JS 09/02/22_____

- -confirm HVAC specs
- -confirm water heater specs
- -confirm ventilation entry
- -modeled to worst case orientation
- -confirm cfl lighting %