


Front Elevation
Scale: 1/4"= 1'0"



Scale: 1/8"= 1'0"

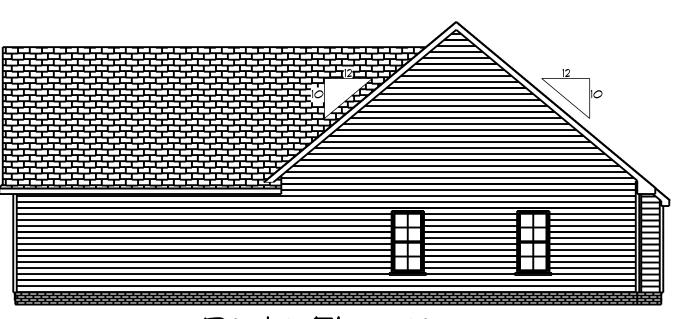













DATE: 10/3/2023 REVISED DRAWING#



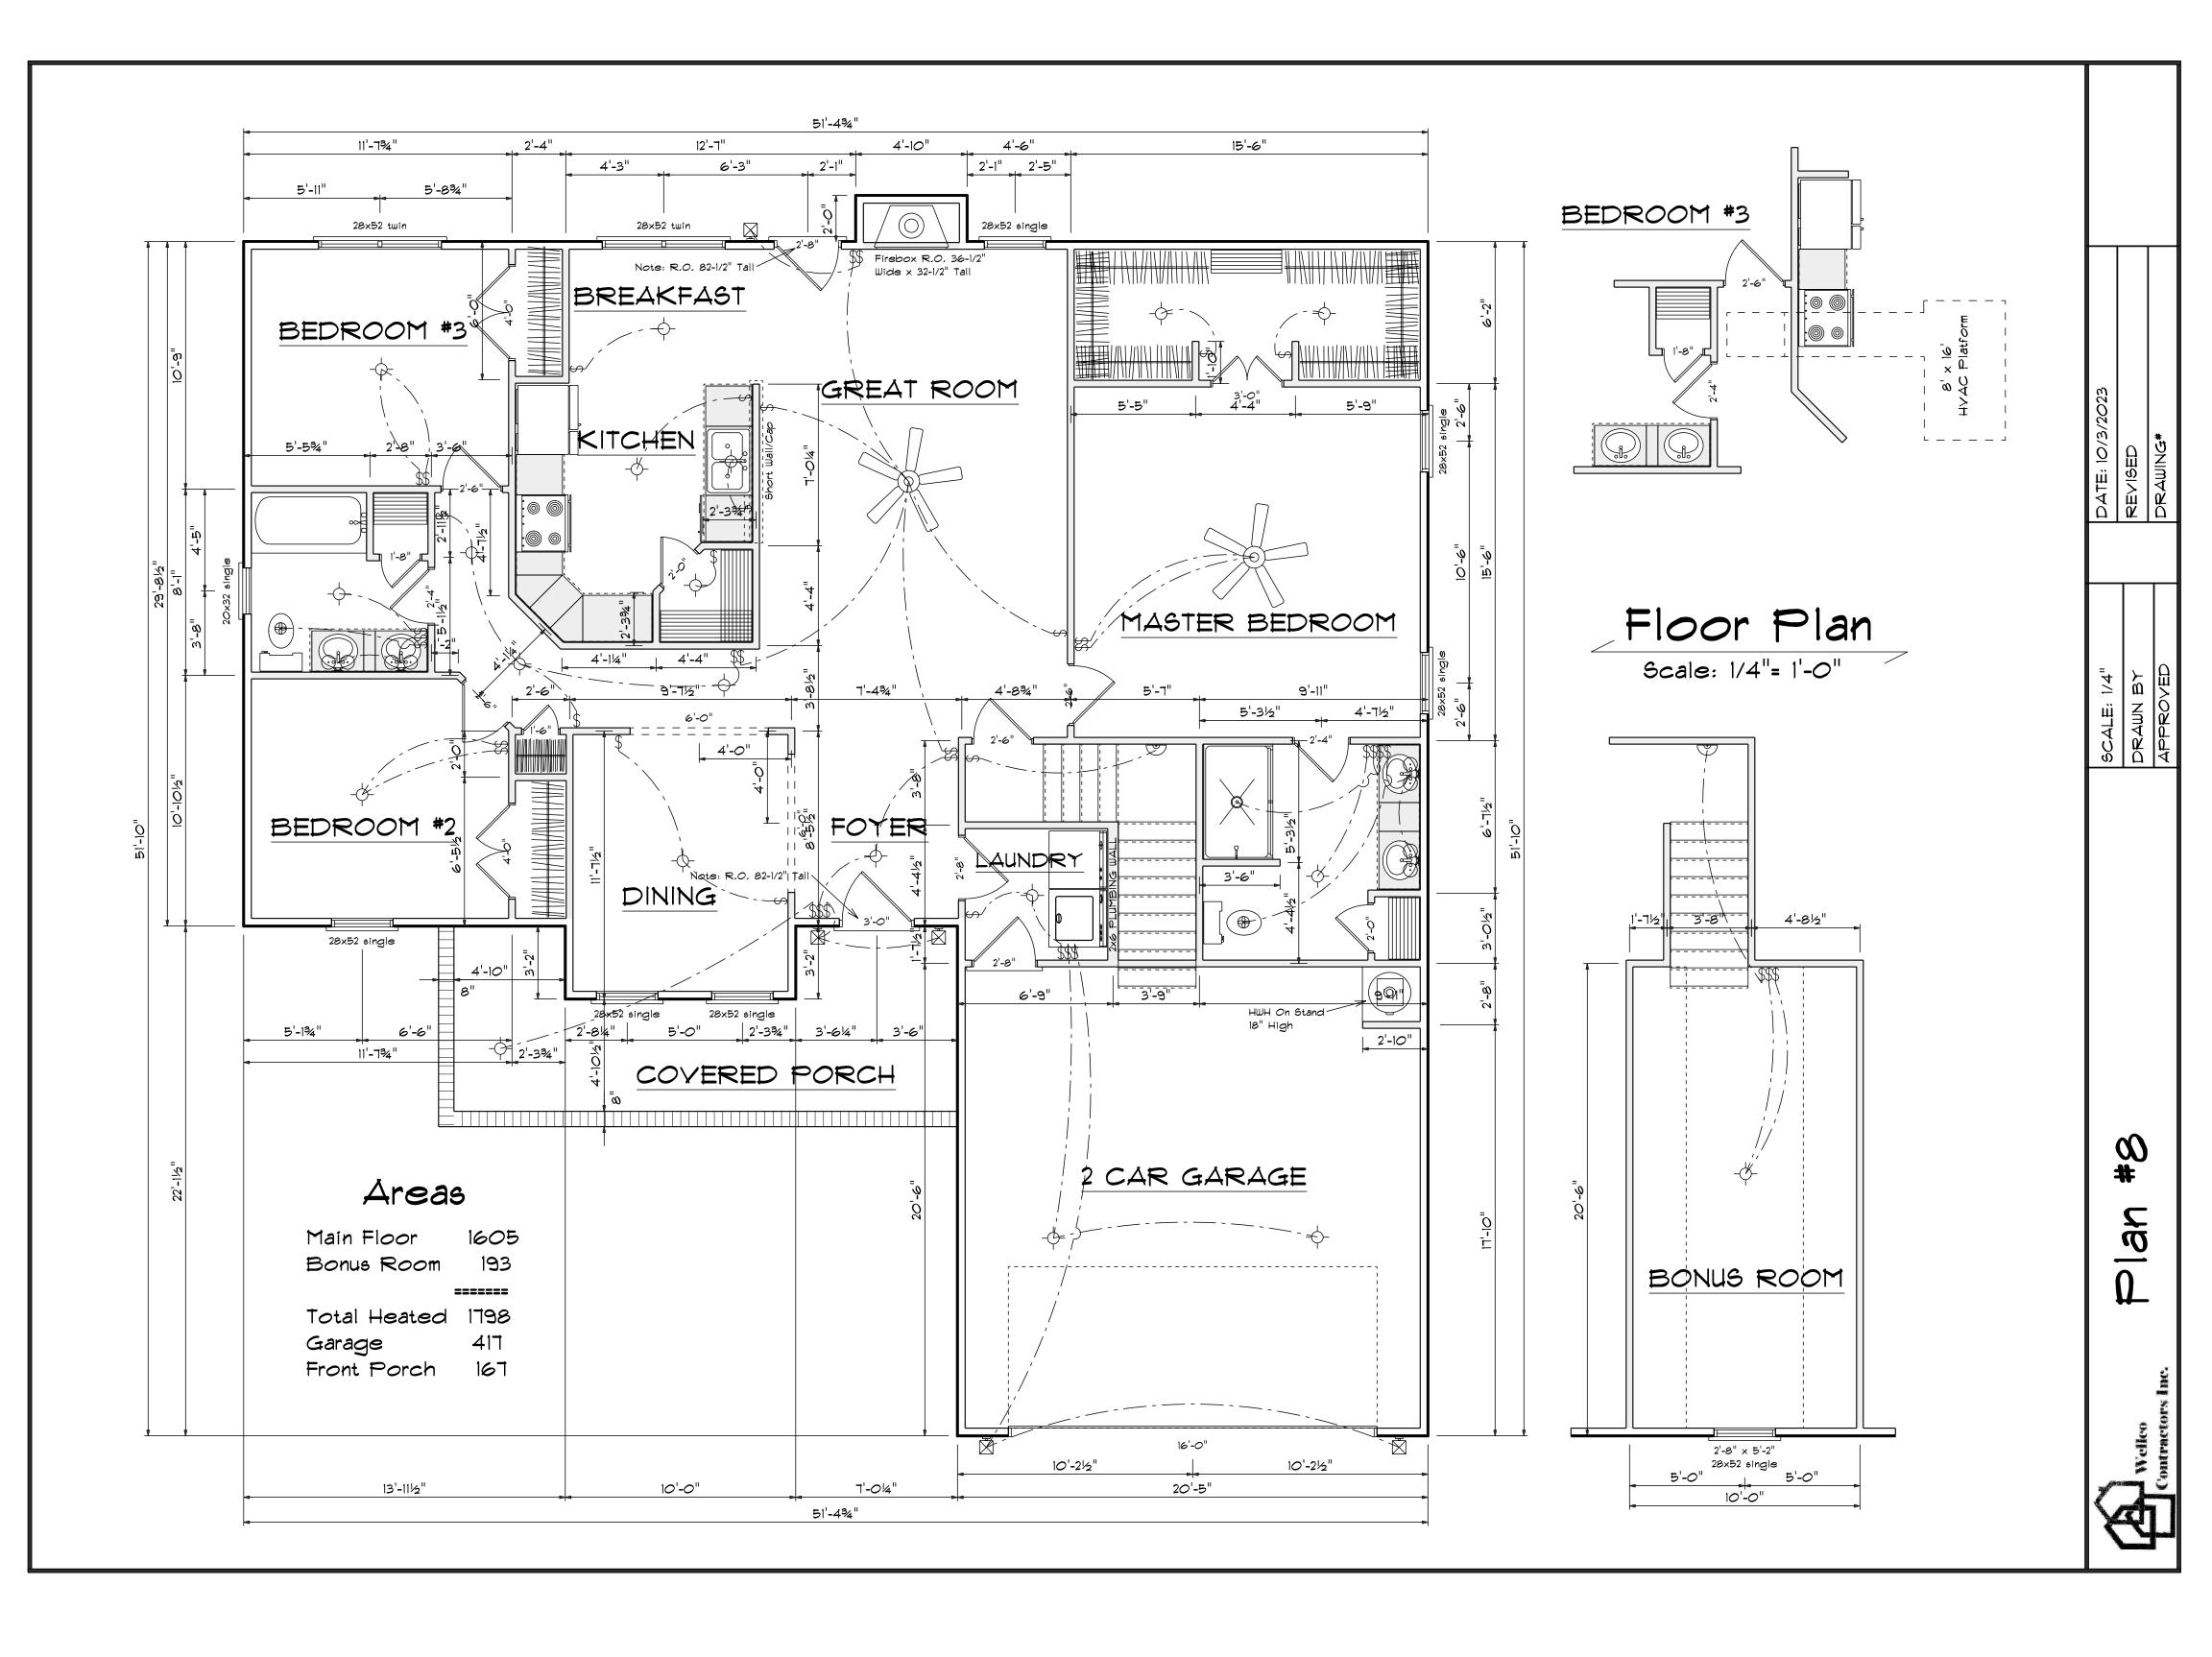

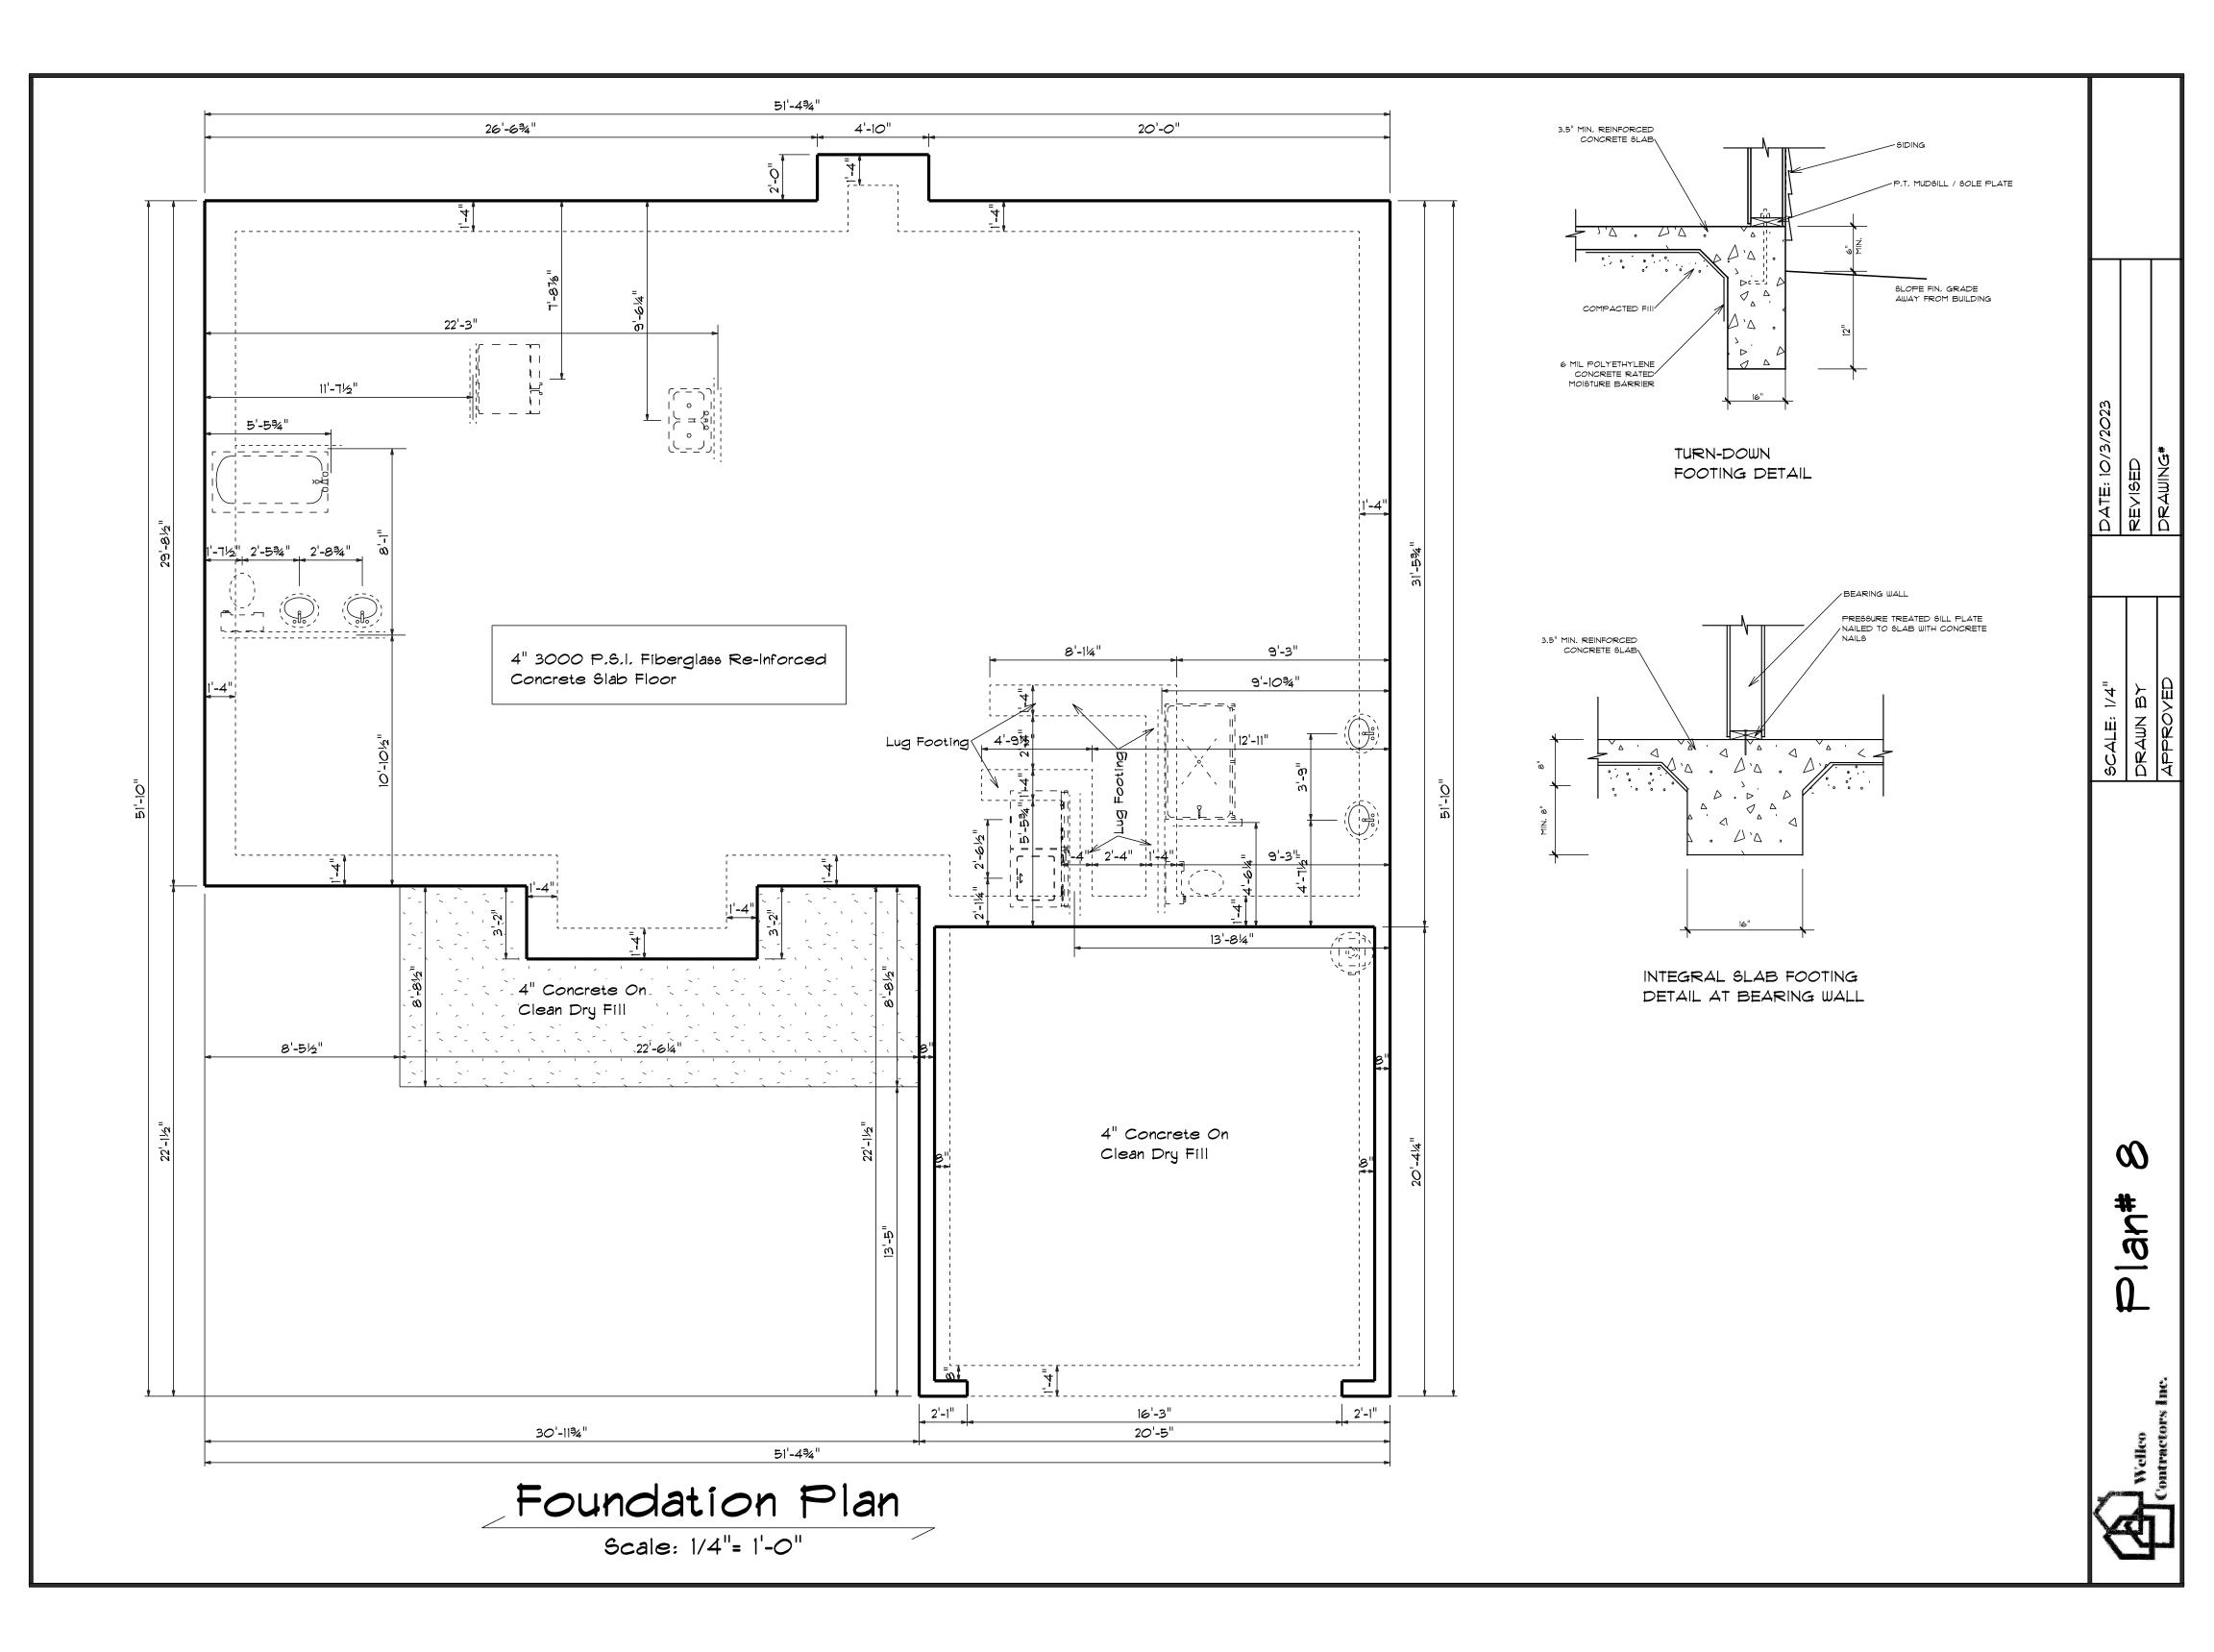

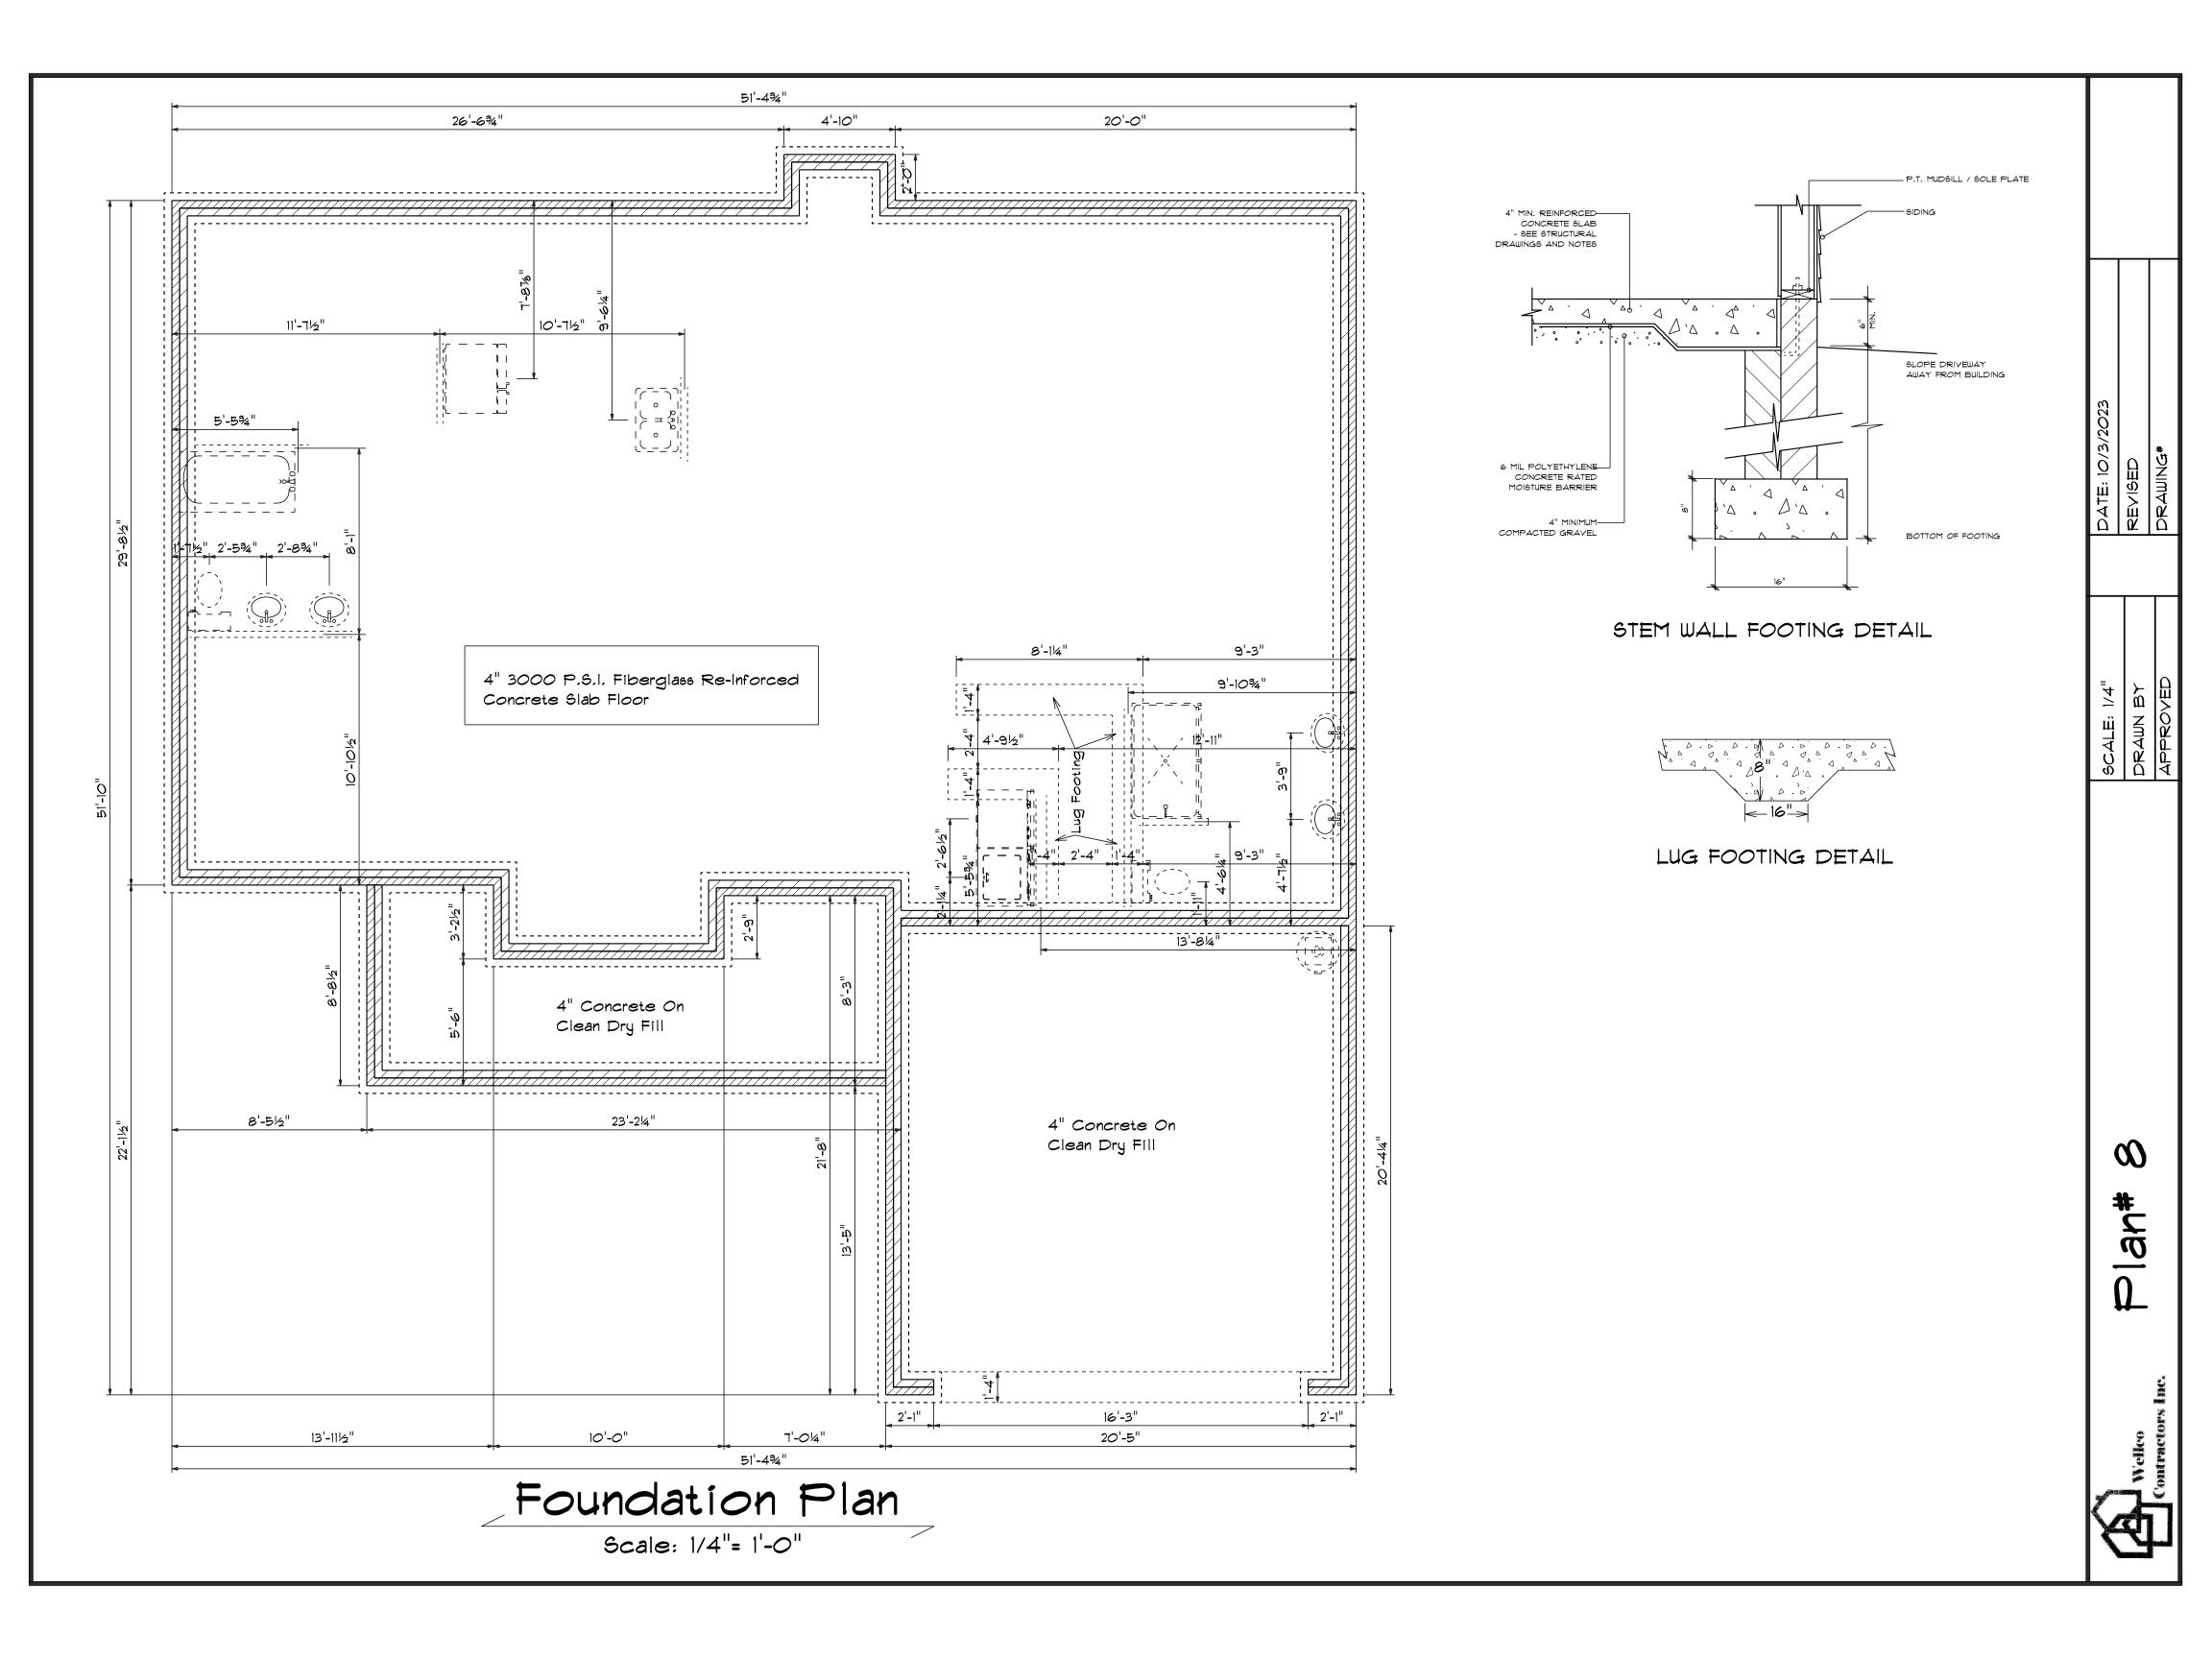

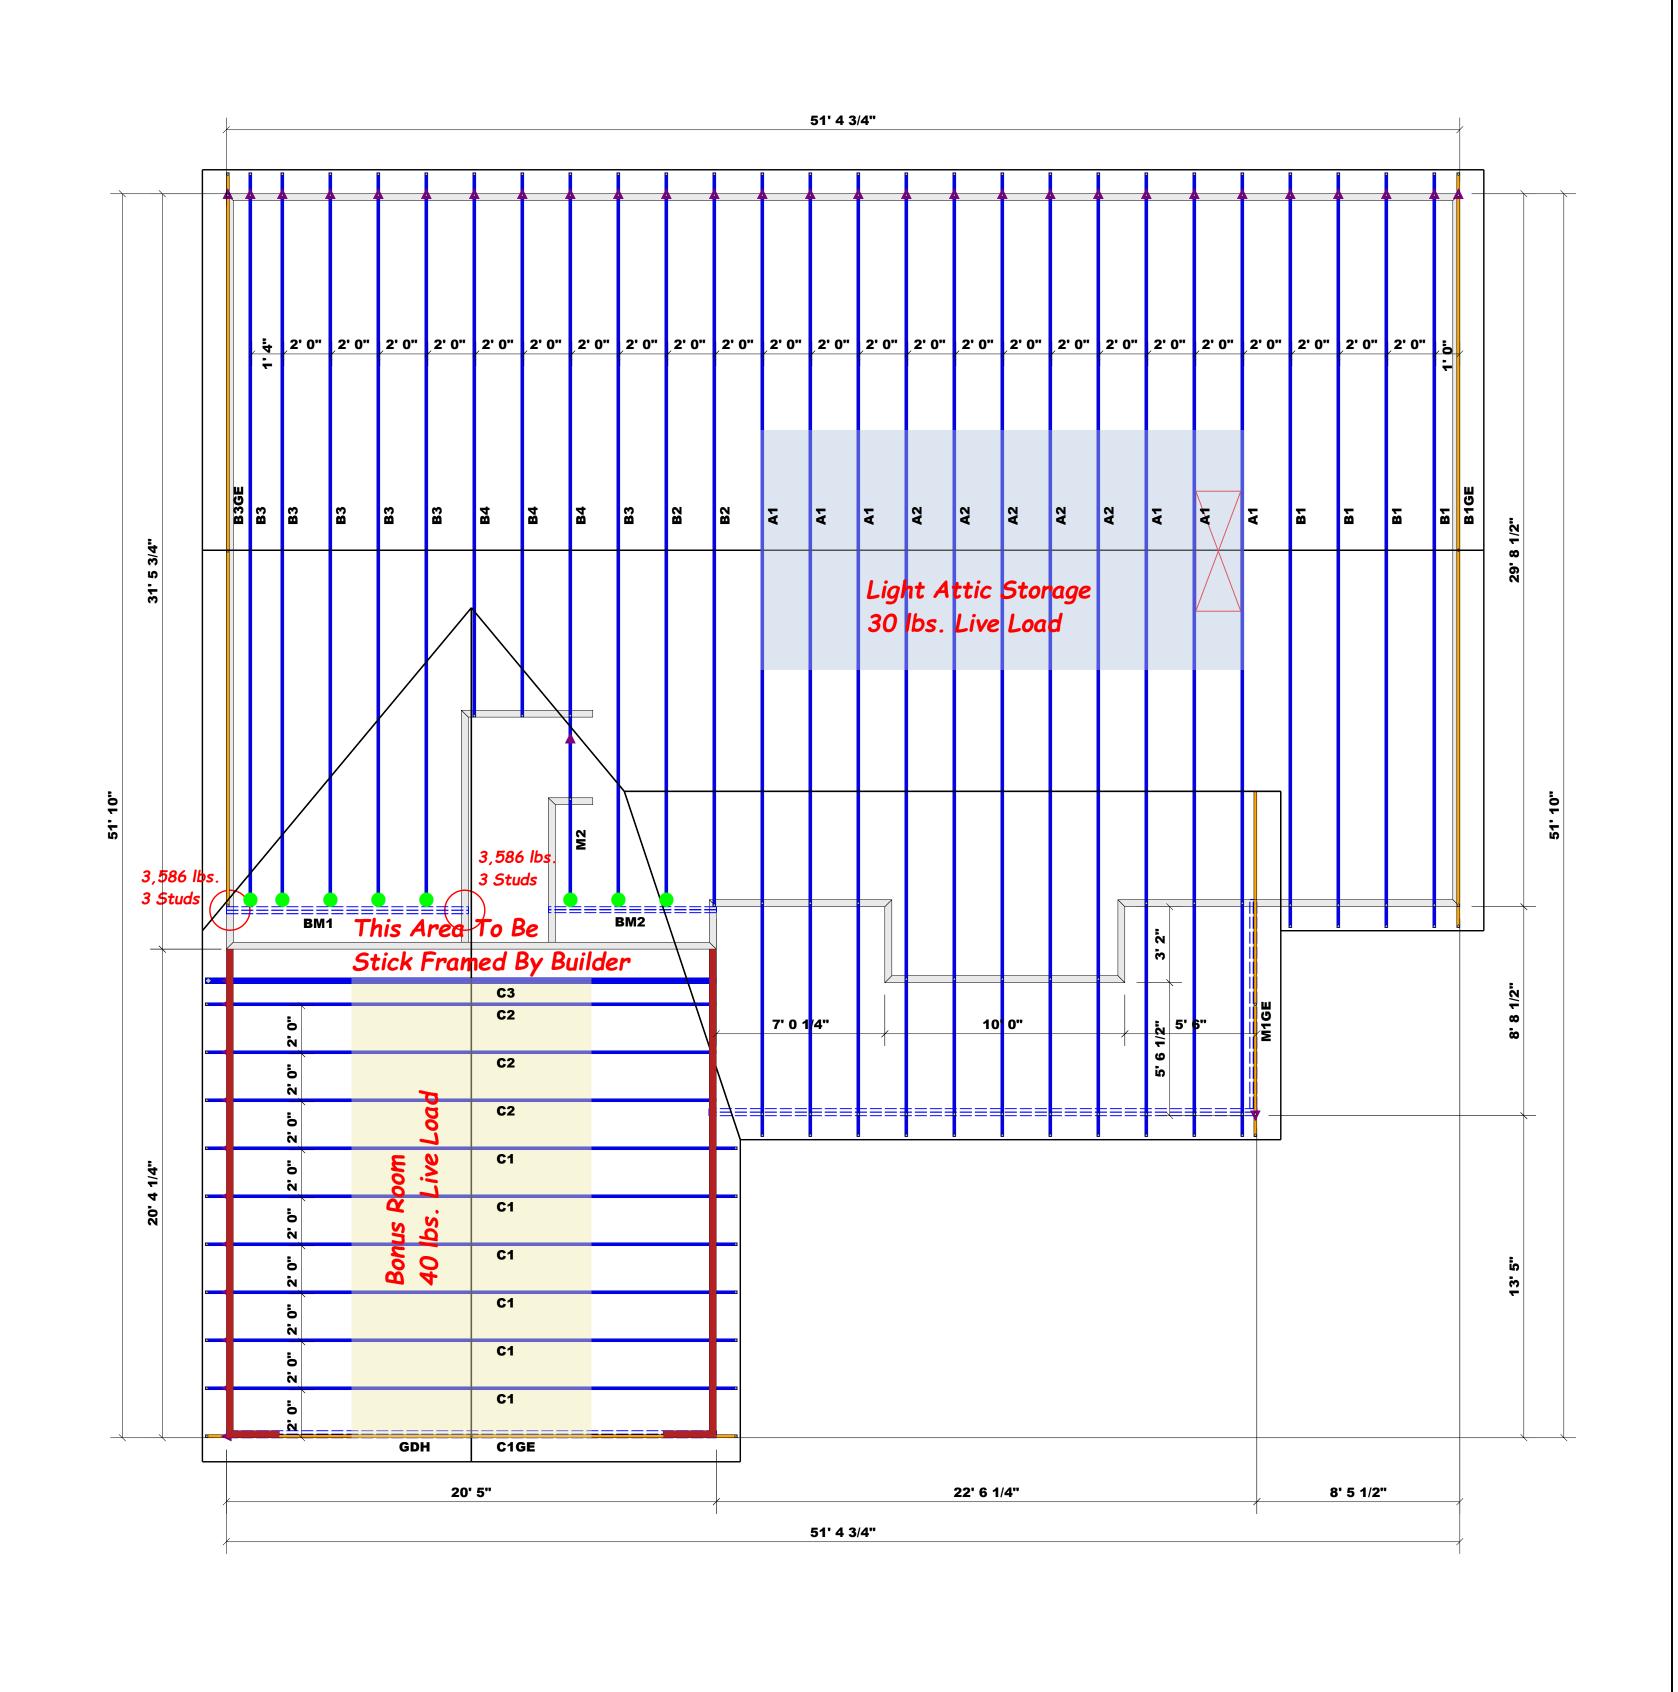

Hatch Legend Garage Walls Dropped 1'

HANGER LEGEND

= USP HUS26 / Single 2x Hanger

= Denotes Left End of Truss (Reference Engineered Truss Drawing)

15300 9

-- Denotes Reaction Greater than 3,000 lbs.

All Truss Reactions are Less than 3,000 lbs. Unless Noted Otherwise.

Truss Placement Plan

Beam Legend					
PlotID	Length	Product	Plies	Net Qty	Fab Type
BM1	11' 0"	1-3/4"x 9-1/4" LVL Kerto-S	2	2	FF
GDH	21' 0"	1-3/4"x 11-7/8" LVL Kerto-S	2	2	FF
BM2	8' 0"	2x10 SP No.2	2	2	FF

Do	Not Erect	rıruss	es Backwards			SCALE: 1/4" = 1'
LOAD CHART FOR JACK STUDS (BASED ON TABLES R502.5(1) & (b)) NUMBER OF JACK STUDS REQUIRED @ EA END OF		BUILDER	Wellco Contractors	CITY / CO.	Spring Lake / Harnett	
	HEADER/GIRDER		JOB NAME	Lot 10 Overhills Creek	ADDRESS	102 Onslow Court
(UP TO) (UP TO) (UP TO) (EQ.) 5 STUDS FOR (C) PLY HEADER (UP TO) (RQ.'D STUDS FOR (3) PLY HEADER	END REACTION (JP TO) REQ'D STUDS FOR (4) PLY HEADER	PLAN	Plan 8	MODEL	Roof	
1700 1 3400 2 5100 3	7650 3	3400 1 6800 2 10200 3	SEAL DATE	Seal Date	DATE REV.	04/16/24
6800 4 8500 5 10200 6		13600 4 17000 5	QUOTE#	Quote #	DRAWN BY	Curtis Quick
11900 7 13600 8 15300 o			JOB#	J0424-2222	SALES REP.	Lenny Norris

THIS IS A TRUSS PLACEMENT DIAGRAM ONLY.


Curtis Quick

Curtis Quick

ROOF & FLOOR TRUSSES & BEAMS

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Reilly Road Industrial Park Fayetteville, N.C. 28309 Phone: (910) 864-8787 Fax: (910) 864-4444

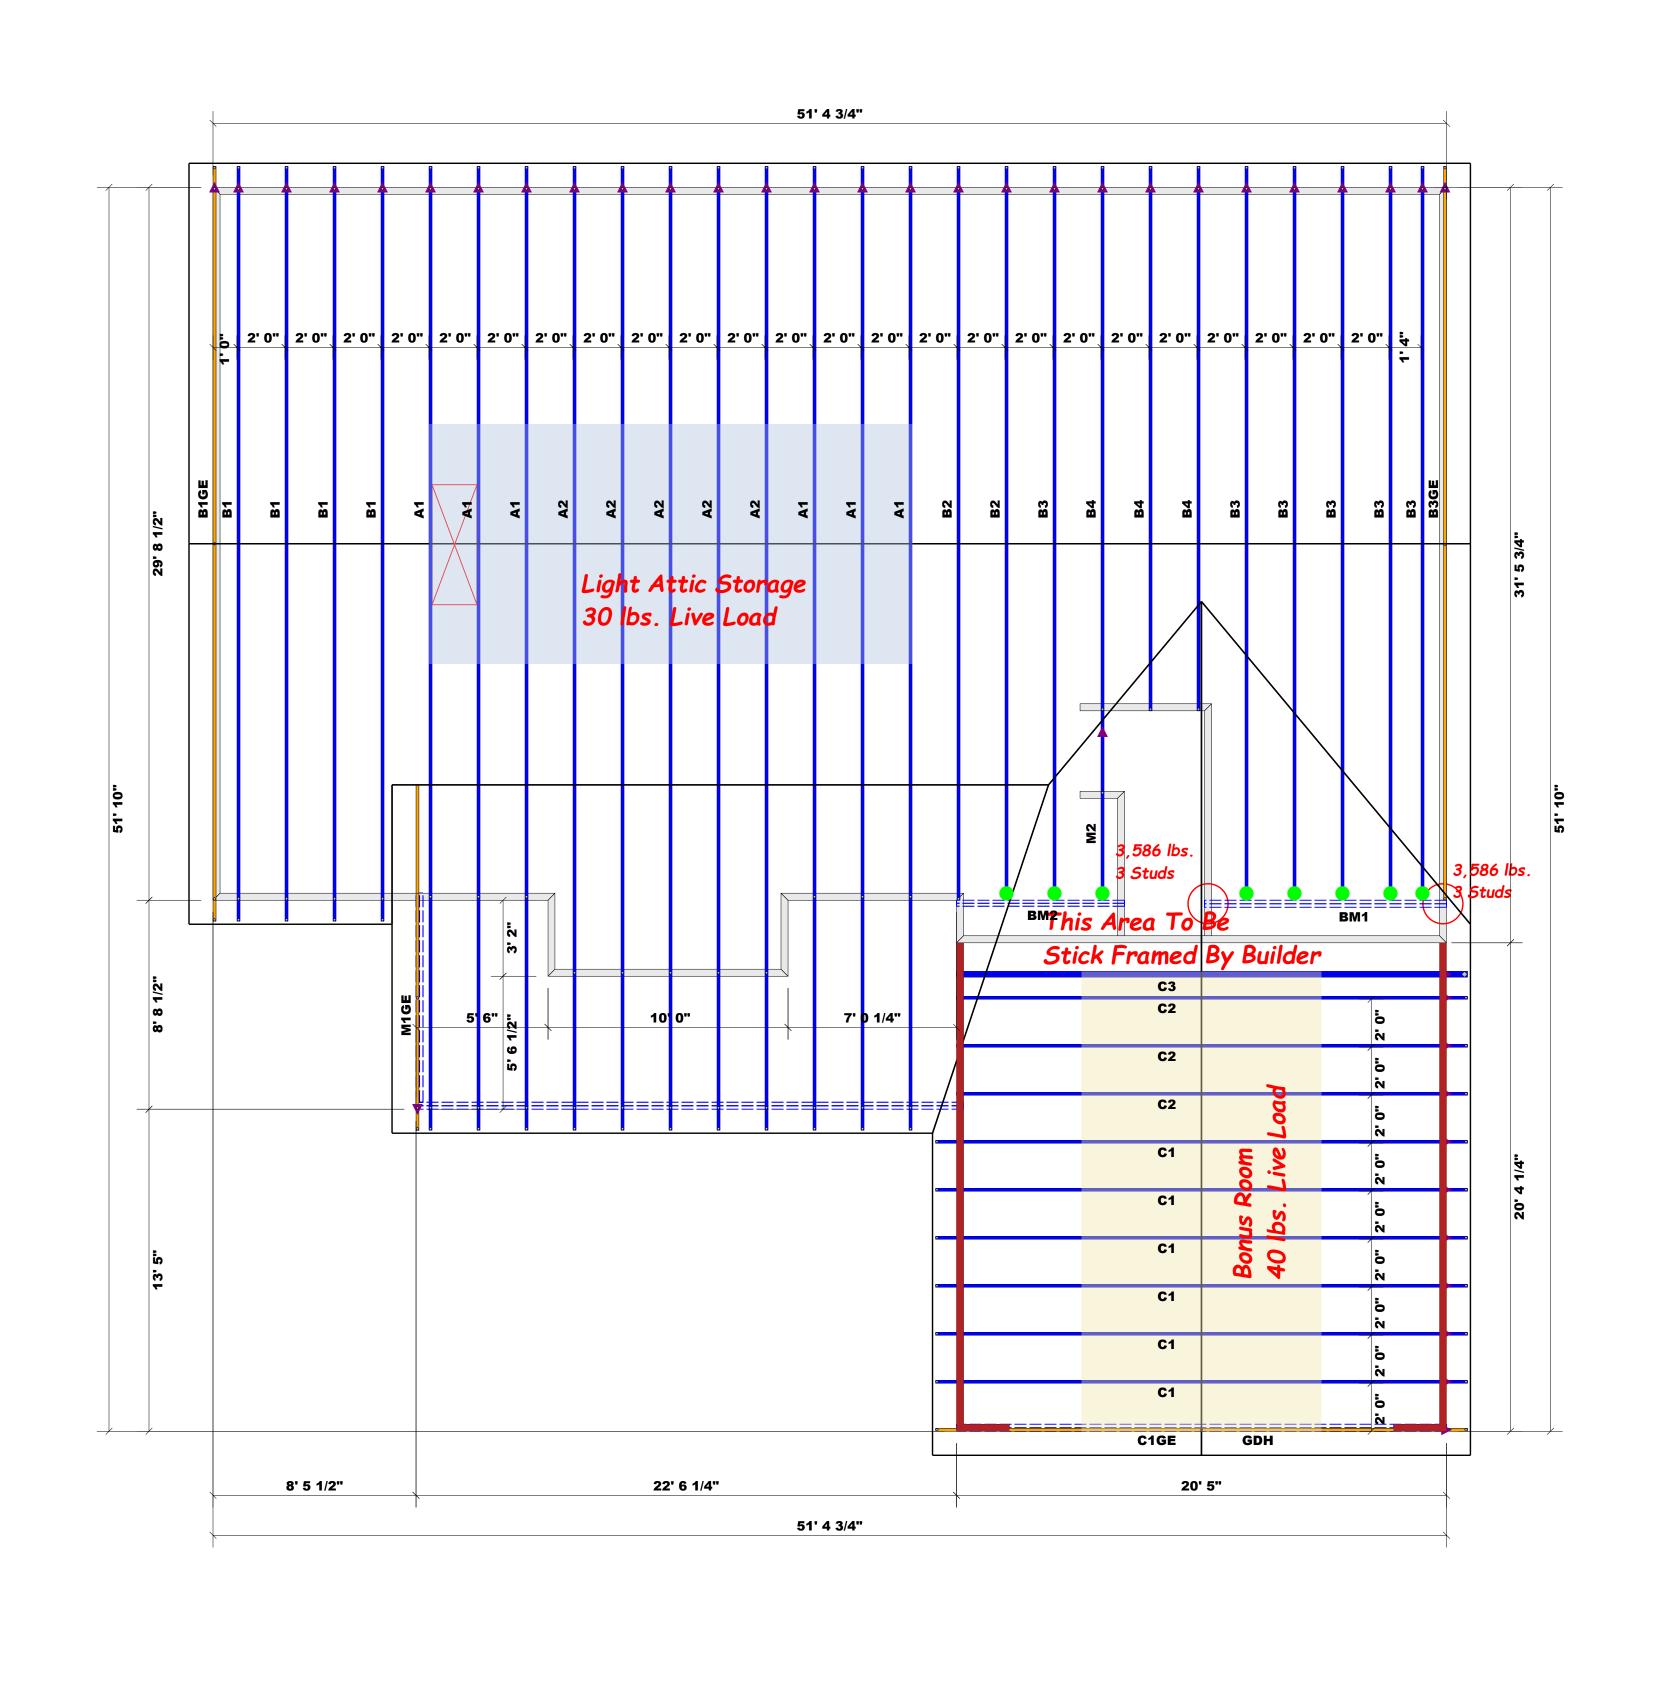

Hatch Legend
Garage Walls Dropped 1'

All Truss Reactions are Less than 3,000 lbs. Unless Noted Otherwise.

HANGER LEGEND

= USP HUS26 / Single 2x Hanger

■ = Denotes Left End of Truss
 (Reference Engineered Truss Drawing)
 Do Not Erect Trusses Backwards

-- Denotes Reaction Greater than 3,000 lbs.

Truss Placement Plan
SCALE: 1/4" - 1'

Beam Legend					
PlotID	Length	Product	Plies	Net Qty	Fab Type
BM1	11' 0"	1-3/4"x 9-1/4" LVL Kerto-S	2	2	FF
GDH	21' 0"	1-3/4"x 11-7/8" LVL Kerto-S	2	2	FF
BM2	8' 0"	2x10 SP No.2	2	2	FF
	BM1 GDH	BM1 11' 0" GDH 21' 0"	PlotID Length Product BM1 11' 0" 1-3/4"x 9-1/4" LVL Kerto-S GDH 21' 0" 1-3/4"x 11-7/8" LVL Kerto-S	PlotID Length Product Plies BM1 11' 0" 1-3/4"x 9-1/4" LVL Kerto-S 2 GDH 21' 0" 1-3/4"x 11-7/8" LVL Kerto-S 2	PlotID Length Product Plies Net Qty BM1 11' 0" 1-3/4"x 9-1/4" LVL Kerto-S 2 2 GDH 21' 0" 1-3/4"x 11-7/8" LVL Kerto-S 2 2

		OOALL. 1/4 = 1		
LOAD CHART FOR JACK STUDS (BASED ON TABLES R502.5(1) & (b)) NUMBER OF JACK STUDS REQUIRED @ EA END OF	BUILDER	Wellco Contractors	CITY / CO.	Spring Lake / Harnett
HEADER/GIRDER	JOB NAME	Lot 10 Overhills Creek	ADDRESS	102 Onslow Court
END (2) (2) (3) (4) (4)	PLAN	Plan 8	MODEL	Roof
1700 1 2550 1 3400 1 3400 2 5100 2 6800 2 5100 3 7650 3 10200 3	SEAL DATE	Seal Date	DATE REV.	04/16/24
6800 4 10200 4 13600 4 8500 5 12750 5 17000 5 10200 6 15300 6	QUOTE#	Quote #	DRAWN BY	Curtis Quick
11900 7 13600 8 15300 9	JOB#	J0424-2222	SALES REP.	Lenny Norris

building design at the specification of the building designer. See individual design lets for each truss design identified on the placement drawing. The building designer esponsible for temporary and permanent bracing of the roof and floor system and for overall structure. The design of the truss support structure including headers, beams, is, and columns is the responsibility of the building designer. For general guidance arding bracing, consult BCSI-B1 and BCSI-B3 provided with the truss delivery package online @ sbcindustry.com

arring reactions less than or equal to 3000# are deemed to comply with the scriptive Code requirements. The contractor shall refer to the attached Tables prived from the prescriptive Code requirements to determine the minimum modation size and number of wood studs required to support reactions greater in 3000# but not greater than 15000#. A registered design professional shall

Curtis Quick

Curtis Quick

THIS IS A TRUSS PLACEMENT DIAGRAM ONLY.

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