


FRONT ELEVATION 7

SCALE: 1/8" = 1'-0"

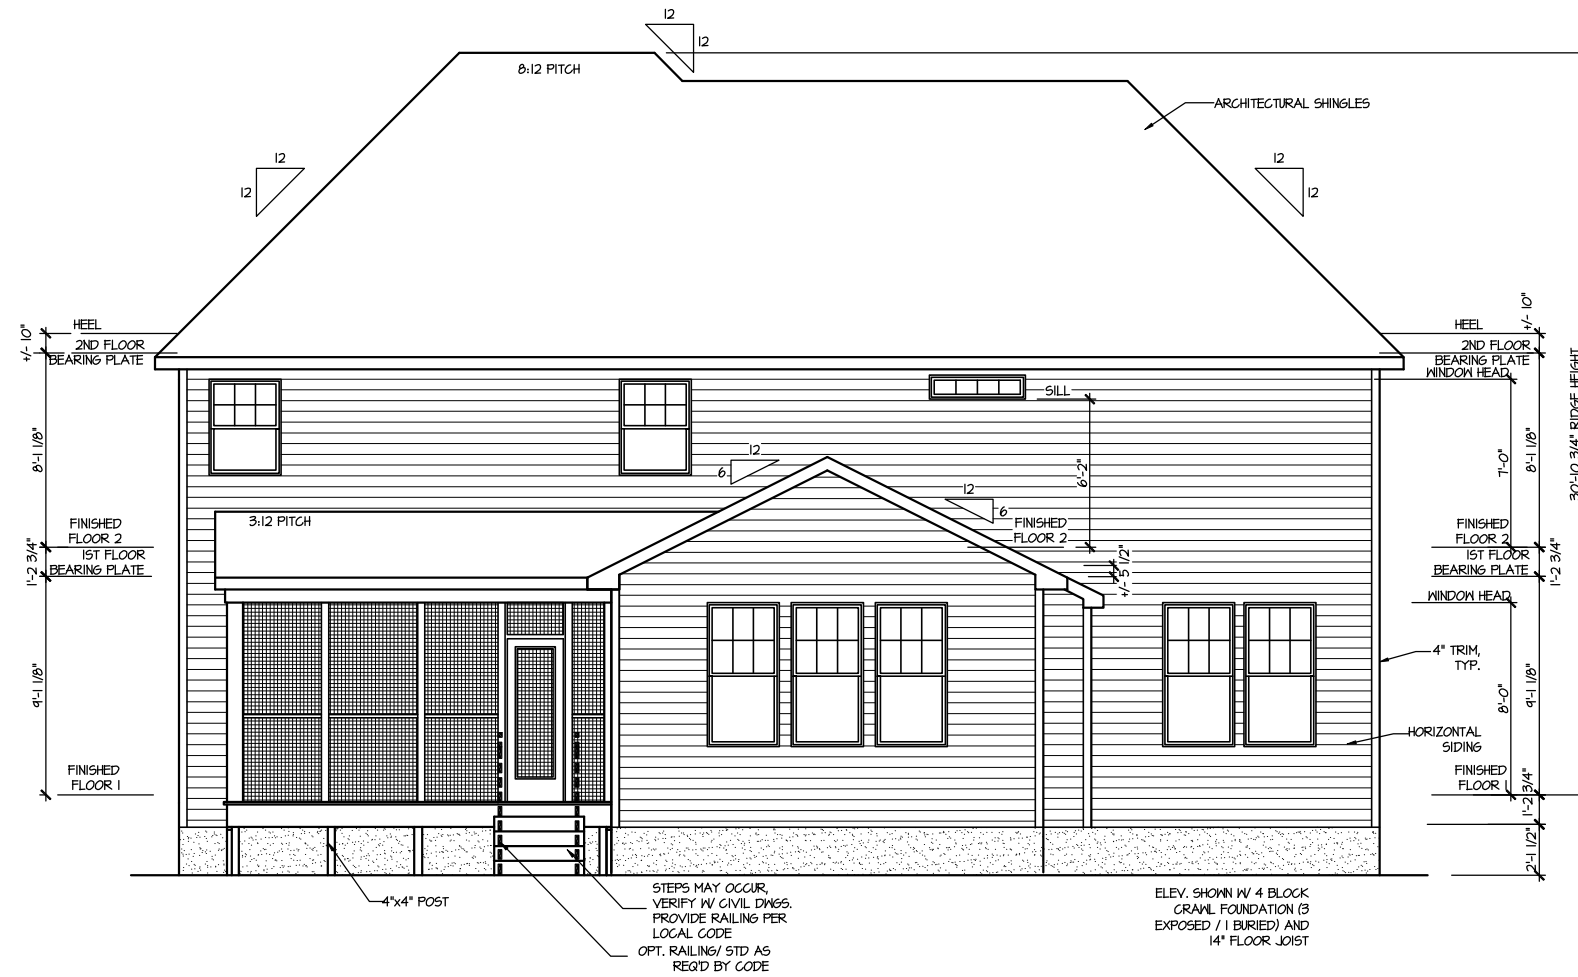

REAR ELEVATION 7

SCALE: 1/8" = 1'-0"

FILE: Lot_00.0036 amendment.dwg DATE: 8/27/2024 12:59 PM

MASTER PLAN INFORMATION


REVISION	DATE	UPDATED DATE
2-RALE	03-20-2024	

DRAWN BY: ITS
 DATE: 08/27/2024
 PLAN NO. 1635




HOUSE NAME: STONEFIELD
 DRAWING TITLE: FRONT & REAR ELEVATIONS

SHEET No. A.1

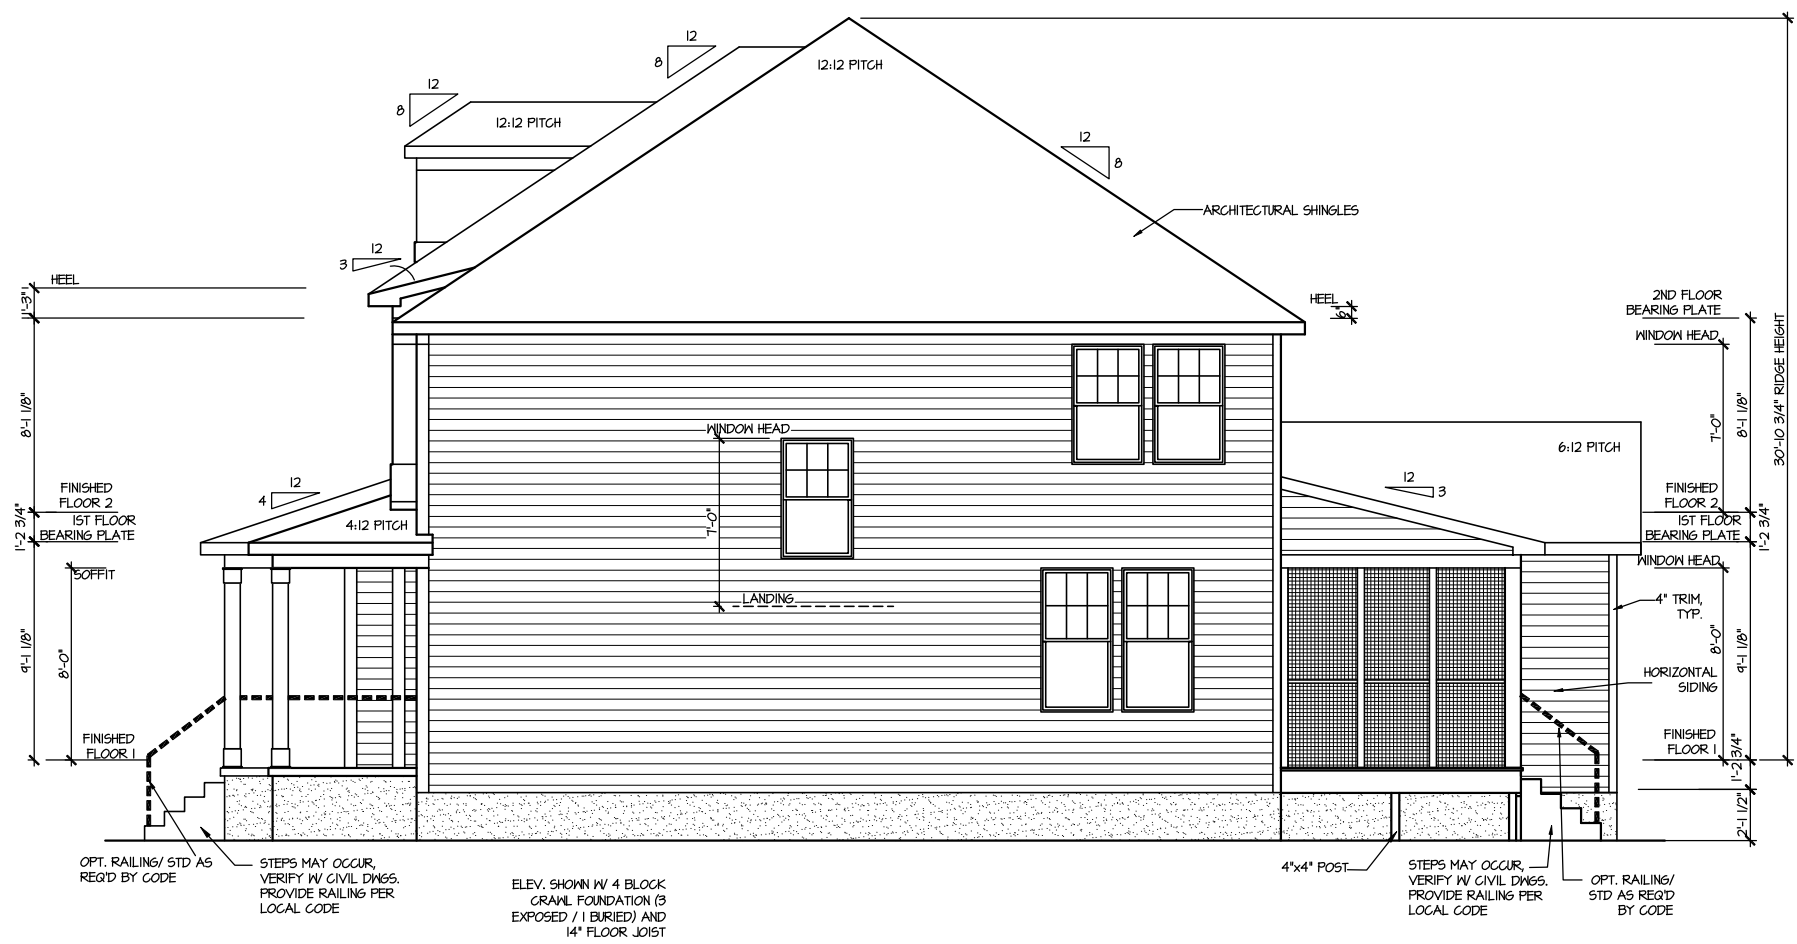

RIGHT ELEVATION 1
SCALE: 1/8" = 1'-0"

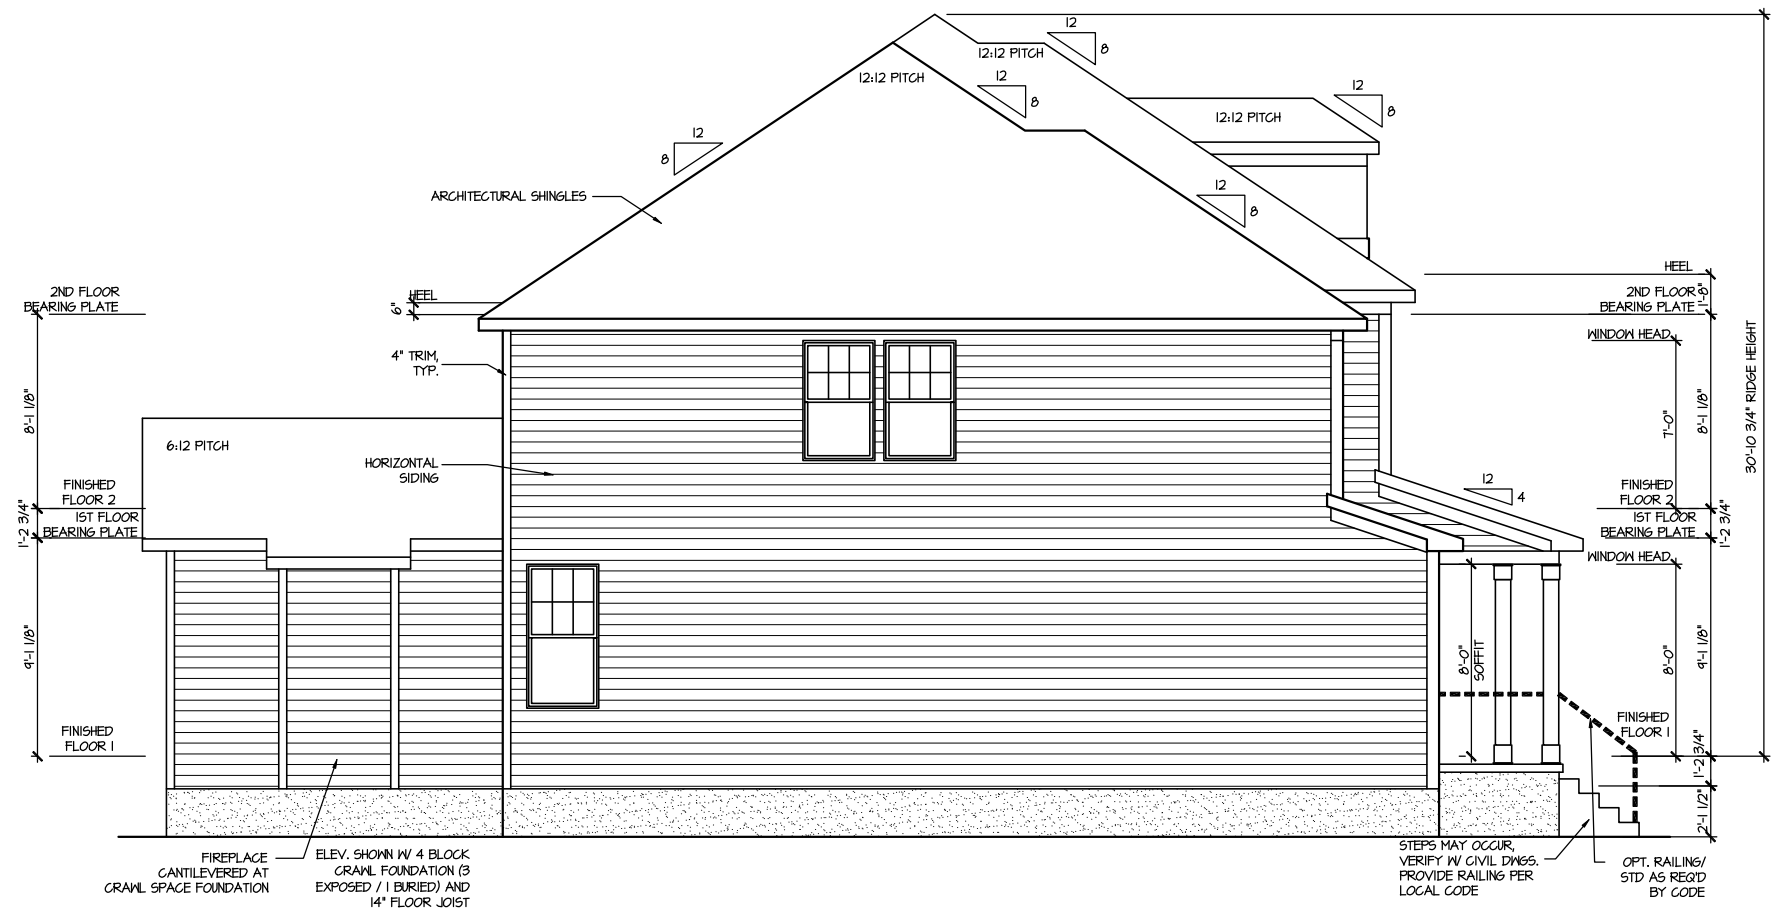

LEFT ELEVATION 1
SCALE: 1/8" = 1'-0"

FILE: Lot_00.0036 amendment.dwg DATE: 8/27/2024 12:59 PM

MASTER PLAN INFORMATION	
DATE	03-20-2024
REVISION	2-RALE
UPDATED DATE	

DRAWN BY: ITS
DATE: 08/27/2024
PLAN NO. 1635



HOUSE NAME: STONEFIELD
DRAWING TITLE: RIGHT & LEFT ELEVATIONS

SHEET No. A1.2

ATTIC VENT CALCULATION FOR PLAN '1'

UPPER ROOF VENTILATION CALCULATIONS:

ROOF AREA 1 = 1791 SQ. FT.
 OVERALL REQUIRED VENTILATION:
 1 TO 150 = 11.94 SQ. FT.
 1 TO 300 = 5.97 SQ. FT.
 50% IN TOP THIRD = 2.98 SQ. FT. (1 TO 300)
 NET FREE AREA OF VENTED SOFFIT = 5.7 SQ. IN / LINEAR FT.
 NET FREE AREA OF RIDGE VENT = 10 SQ. IN / LINEAR FT.

LOWER VENTING (BOTTOM 2/3 RISE)
 82 LINEAR FEET OF SOFFIT X 5.7 SQ. IN = 4674 SQ. FT.
 UPPER VENTING (TOP 1/3 RISE)
 24 LINEAR FEET OF RIDGE X 10 SQ. IN = 240 SQ. FT.
 3 SQ. FT. AT 50%
 (1 TO 300 ALLOWED)

UPPER ROOF VENTILATION CALCULATIONS:

ROOF AREA 3 = 45 SQ. FT.
 OVERALL REQUIRED VENTILATION:
 1 TO 150 = 0.45 SQ. FT.
 1 TO 300 = 0.23 SQ. FT.
 50% IN TOP THIRD = 0.12 SQ. FT. (1 TO 300)
 NET FREE AREA OF VENTED SOFFIT = 5.7 SQ. IN / LINEAR FT.
 NET FREE AREA OF RIDGE VENT = 10 SQ. IN / LINEAR FT.

LOWER VENTING (BOTTOM 2/3 RISE)
 29 LINEAR FEET OF SOFFIT X 5.7 SQ. IN = 1653 SQ. FT.
 UPPER VENTING (TOP 1/3 RISE)
 9 LINEAR FEET OF RIDGE X 10 SQ. IN = 90 SQ. FT.
 1 SQ. FT. AT 50%
 (1 TO 300 ALLOWED)

UPPER ROOF VENTILATION CALCULATIONS:

ROOF AREA 2 = 252 SQ. FT.
 OVERALL REQUIRED VENTILATION:
 1 TO 150 = 1.68 SQ. FT.
 1 TO 300 = 0.84 SQ. FT.
 50% IN TOP THIRD = 0.42 SQ. FT. (1 TO 300)
 NET FREE AREA OF VENTED SOFFIT = 5.7 SQ. IN / LINEAR FT.
 NET FREE AREA OF RIDGE VENT = 10 SQ. IN / LINEAR FT.


LOWER VENTING (BOTTOM 2/3 RISE)
 11 LINEAR FEET OF SOFFIT X 5.7 SQ. IN = 627 SQ. FT.
 UPPER VENTING (TOP 1/3 RISE)
 4 LINEAR FEET OF RIDGE X 10 SQ. IN = 40 SQ. FT.
 0.5 SQ. FT. AT 50%
 (1 TO 300 ALLOWED)

UPPER ROOF VENTILATION CALCULATIONS:

ROOF AREA 4 = 209 SQ. FT.
 OVERALL REQUIRED VENTILATION:
 1 TO 150 = 0.64 SQ. FT.
 1 TO 300 = 0.32 SQ. FT.
 50% IN TOP THIRD = 0.16 SQ. FT. (1 TO 300)
 NET FREE AREA OF VENTED SOFFIT = 5.7 SQ. IN / LINEAR FT.
 NET FREE AREA OF RIDGE VENT = 10 SQ. IN / LINEAR FT.

LOWER VENTING (BOTTOM 2/3 RISE)
 20 LINEAR FEET OF SOFFIT X 5.7 SQ. IN = 1140 SQ. FT.
 UPPER VENTING (TOP 1/3 RISE)
 9 LINEAR FEET OF RIDGE X 10 SQ. IN = 90 SQ. FT.
 1 SQ. FT. AT 50%
 (1 TO 300 ALLOWED)
 TOTAL ROOF VENTILATION: 1.71 SQ. FT. > 0.32 SQ. FT. (R01D)

NOTE: ROOF PLANS SHOWN W/ MIN. REQ'D RIDGE VENT LOCATIONS.
 ACTUAL RIDGE VENT LOCATIONS AND QUANTITY PER BUILDER

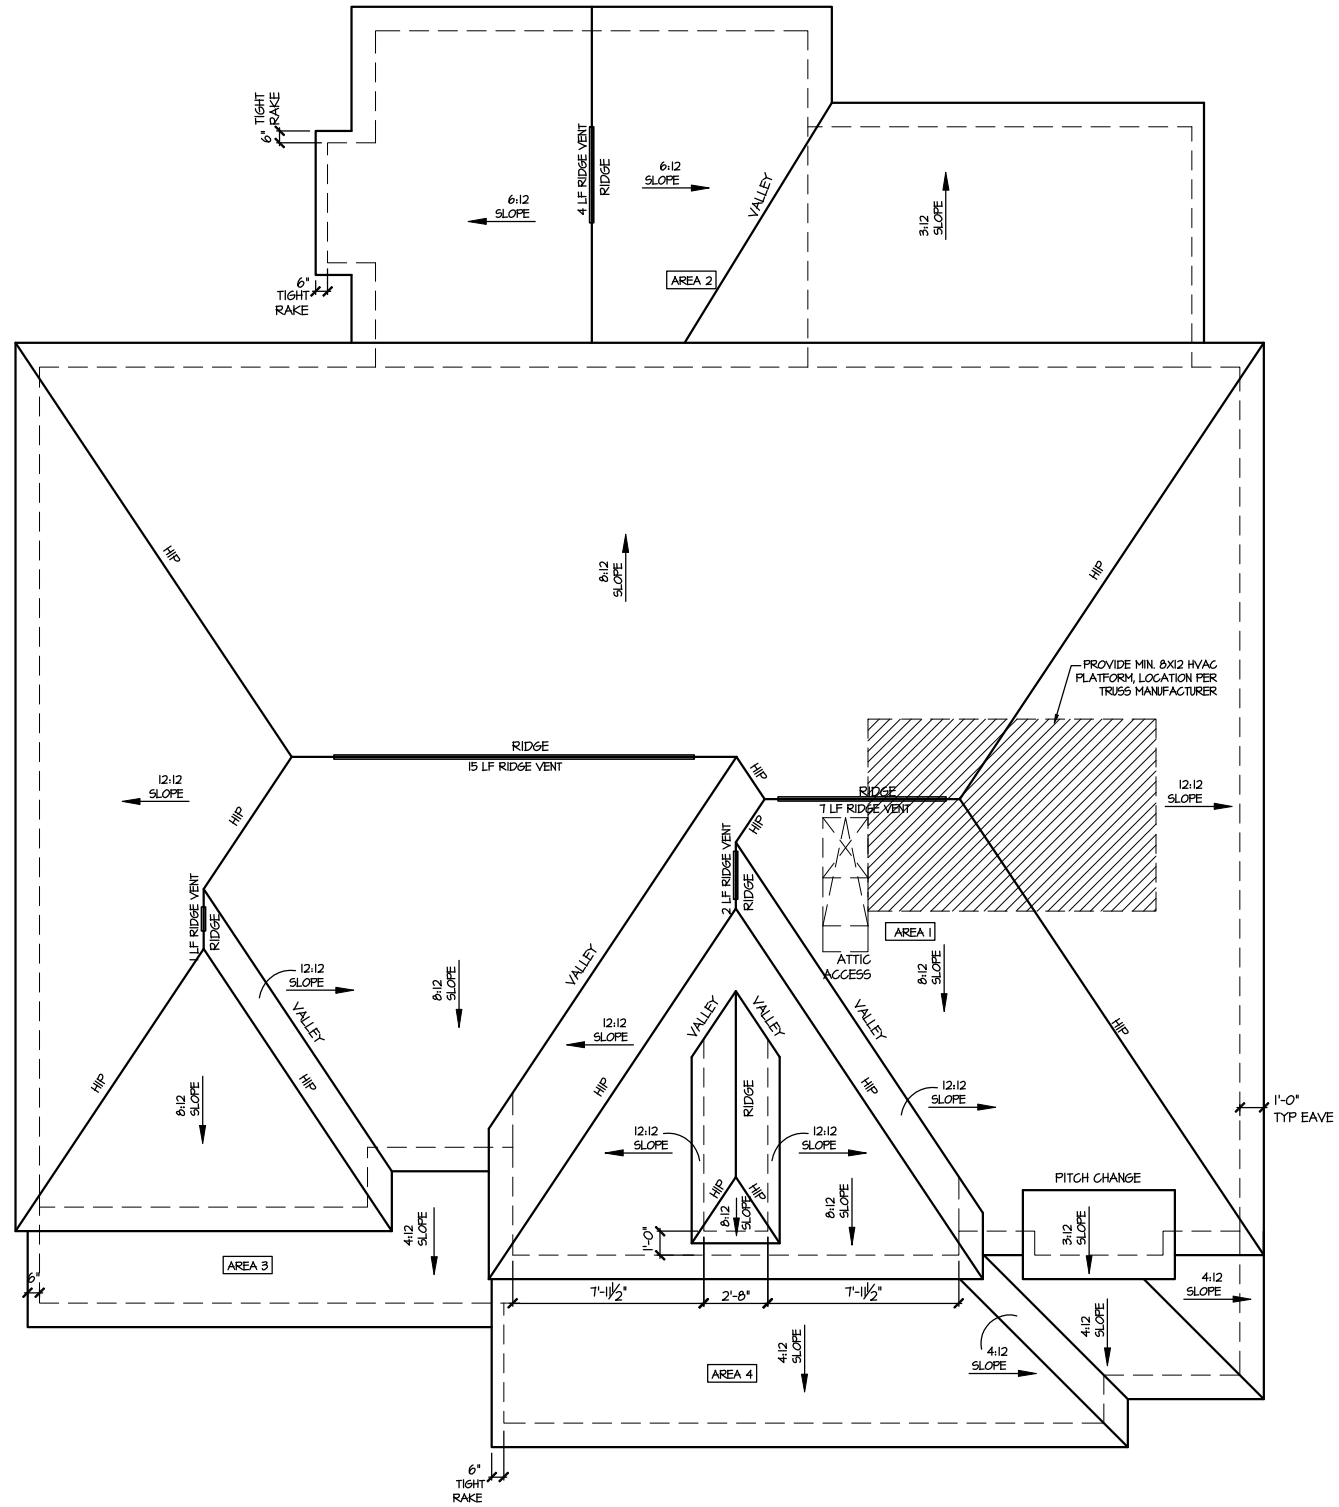

ROOF PLAN ELEV. 7

SCALE: 1/8" = 1'-0"

FILE: Lot_00.0036 amendment.dwg DATE: 8/27/2024 12:59 PM

MASTER PLAN INFORMATION	
REVISION	DATE
2-RALE	03-20-2024
	UPDATED DATE

DRAWN BY:	ITS
DATE:	08/27/2024
PLAN NO.	1635



HOUSE NAME:
STONEFIELD
 DRAWING TITLE
ROOF PLAN


SHEET No.
A.3

CRAWL SPACE VENT CALCULATIONS: ELEV 7
 CRAWL AREA = 1542 SQ. FT.
 OVERALL REQUIRED VENTILATION:
 1 SQ. IN. PER 1 SQ. FT. = 1542 SQ. IN.

 NET FREE AREA OF VENT = 72 SQ. IN. PER VENT
 WITTEN AUTOMATIC VENT OAL-1 OR EQUAL

 VENTING REQUIREMENT:
 1542 SQ. IN. / 72 SQ. IN. = 21.4 VENTS = 22 VENTS

 ONLY VENTS ON THE FRONT ELEVATION ARE SHOWN.
 ALL OTHERS TO BE FIELD LOCATED.
 VENTS SHALL BE INSTALLED PER R322.2.2 - R322.2.2.1

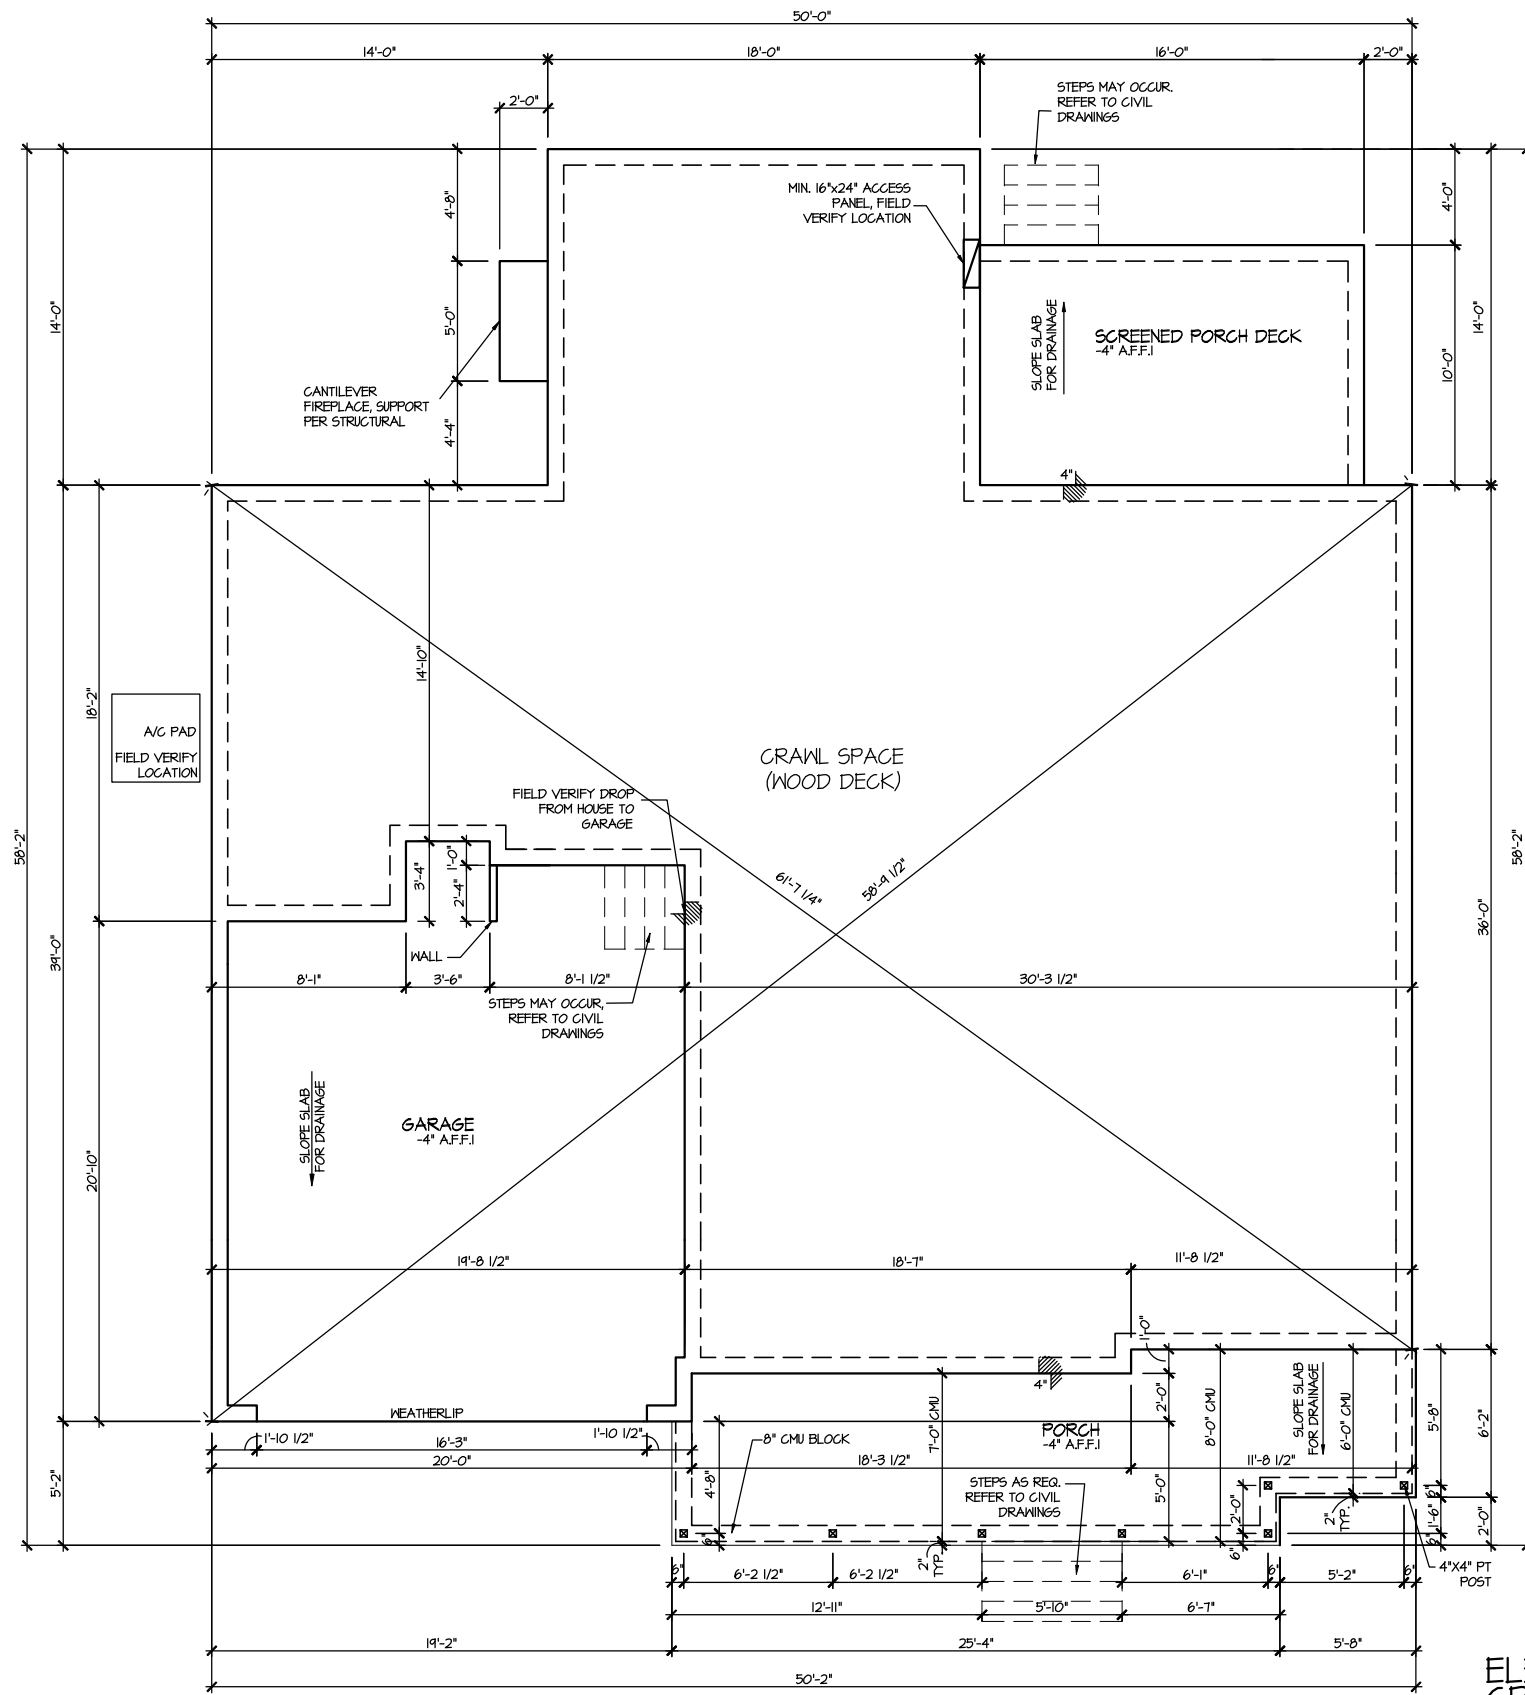

ELEVATION 7
 CRAWL SPACE PLAN
 SCALE: 1/8" = 1'-0"

FILE: Lot_00.0036 amendment.dwg DATE: 8/27/2024 12:59 PM


MASTER PLAN INFORMATION	
REVISION	DATE
2-RALE	03-20-2024
UPDATED DATE	

DRAWN BY: ITS
 DATE: 08/27/2024
 PLAN NO. 1635



HOUSE NAME: STONEFIELD
 DRAWING TITLE: CRAWL SPACE PLAN

SHEET No. A2.1

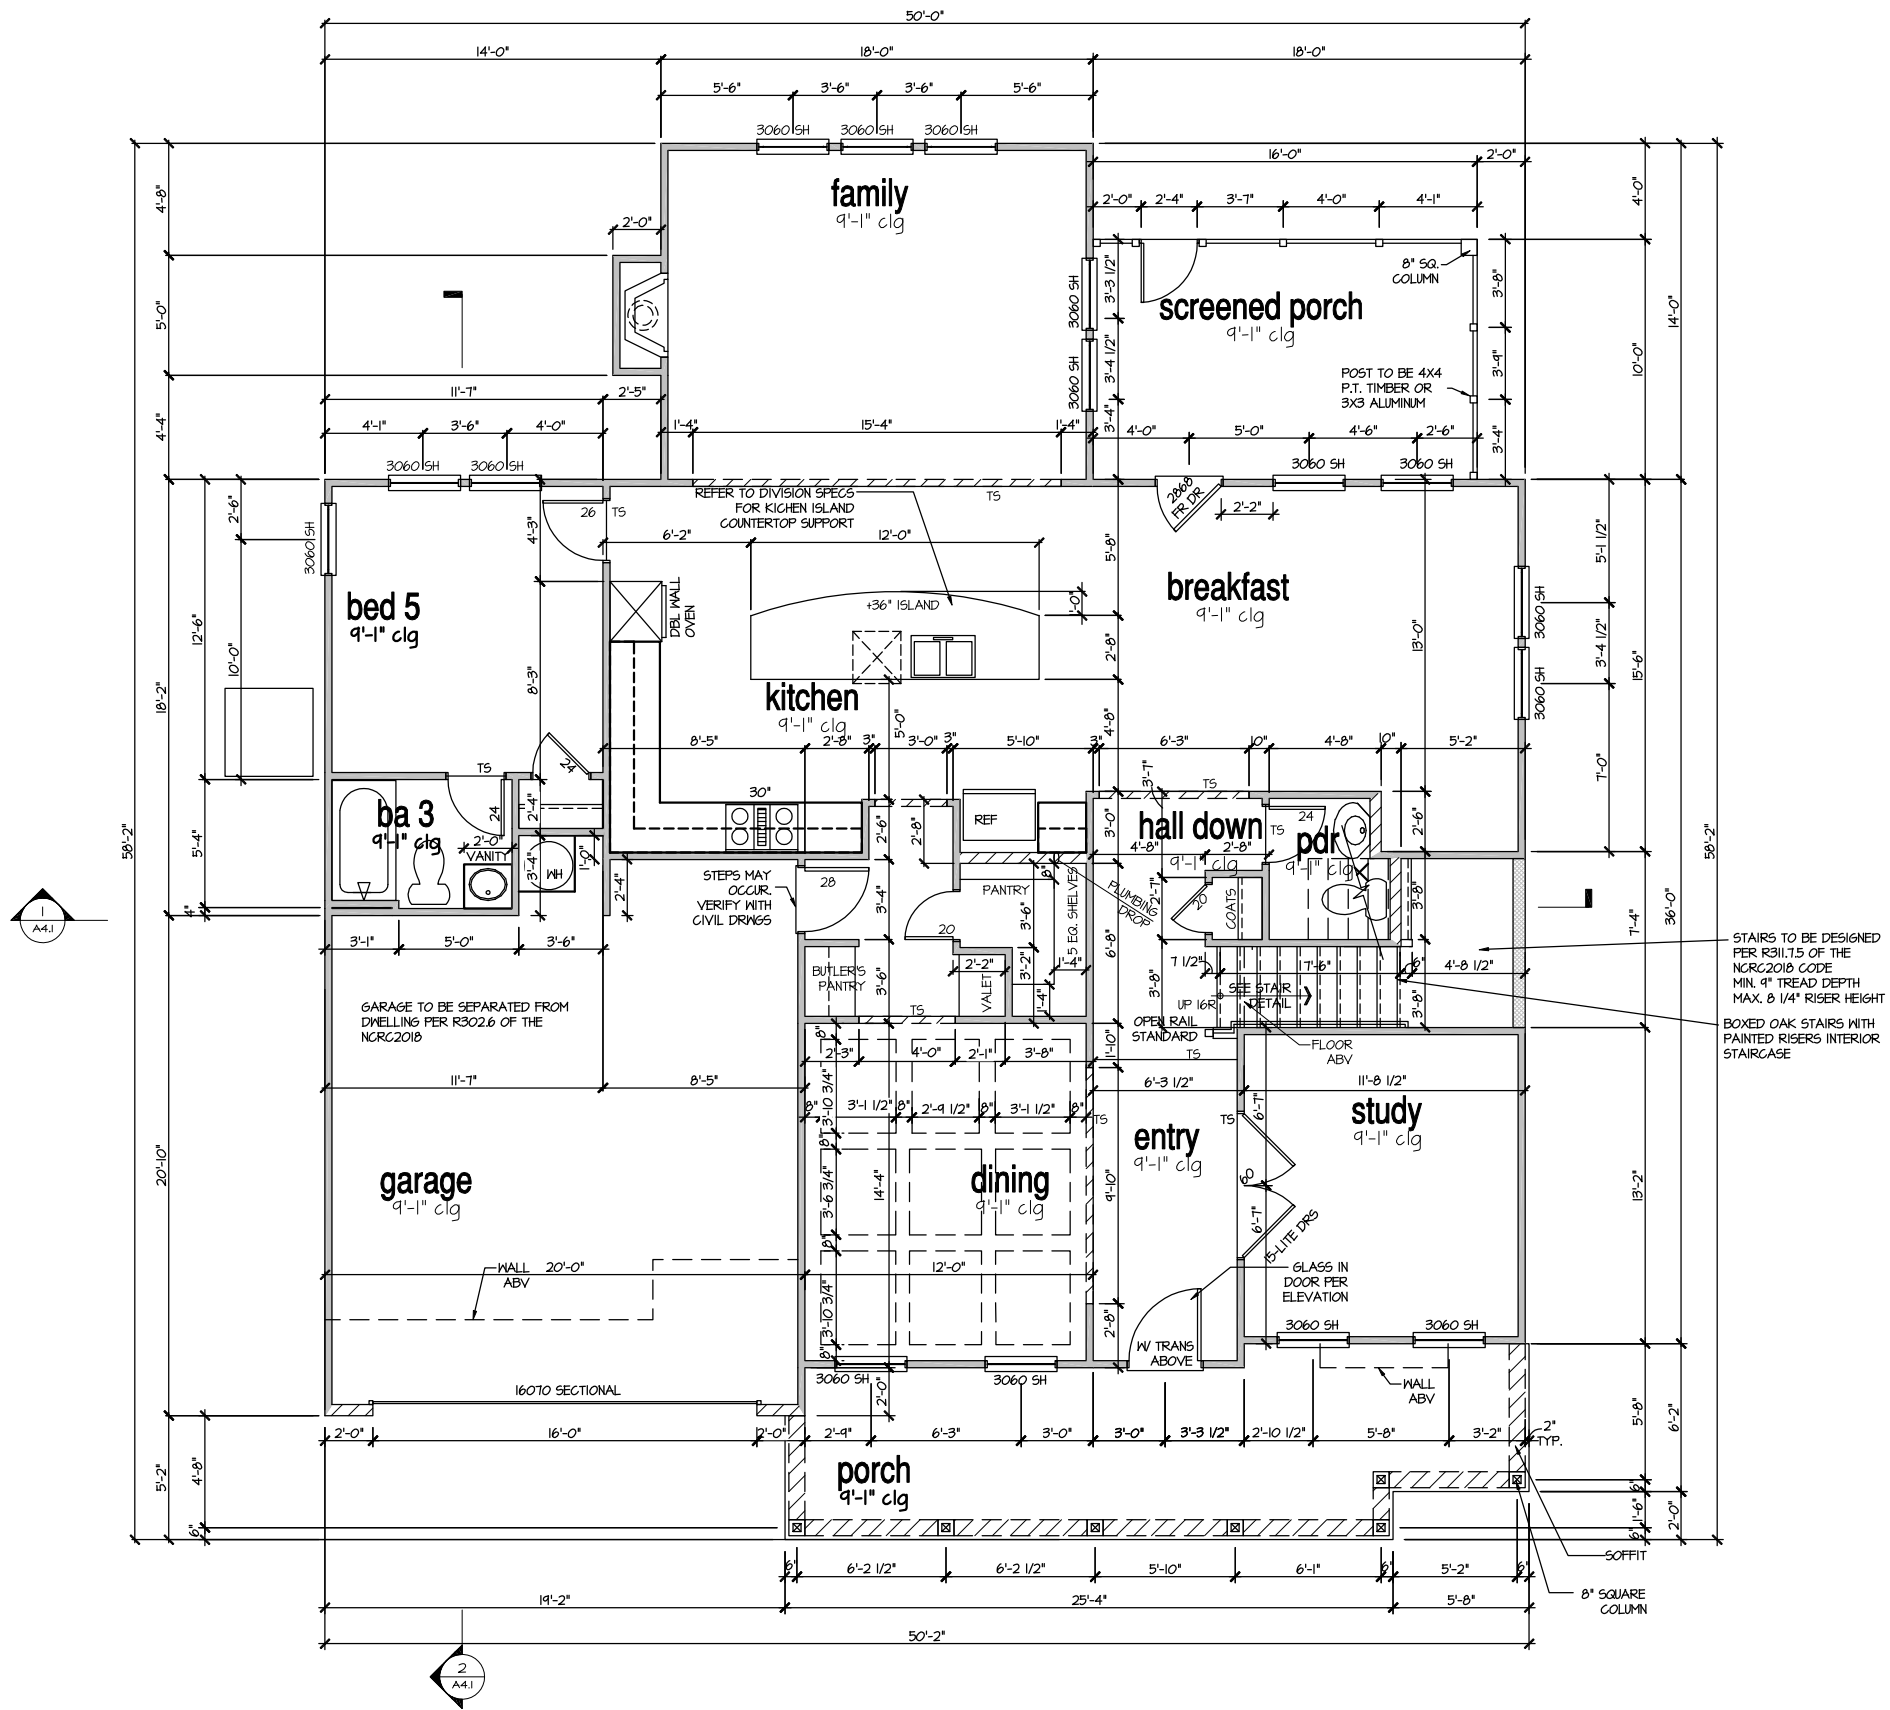


ELEVATION 1
FIRST FLOOR PLAN

SCALE: 1/8" = 1'-0"

MASTER PLAN INFORMATION


REVISION	DATE	UPDATED DATE
2-RALE	03-20-2024	

DRAWN BY:	ITS
DATE:	08/27/2024
PLAN NO.	1635

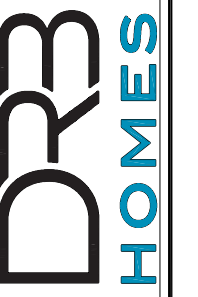

HOUSE NAME:
STONEFIELD
DRAWING TITLE
FIRST FLOOR PLAN

SHEET No.
A3.1

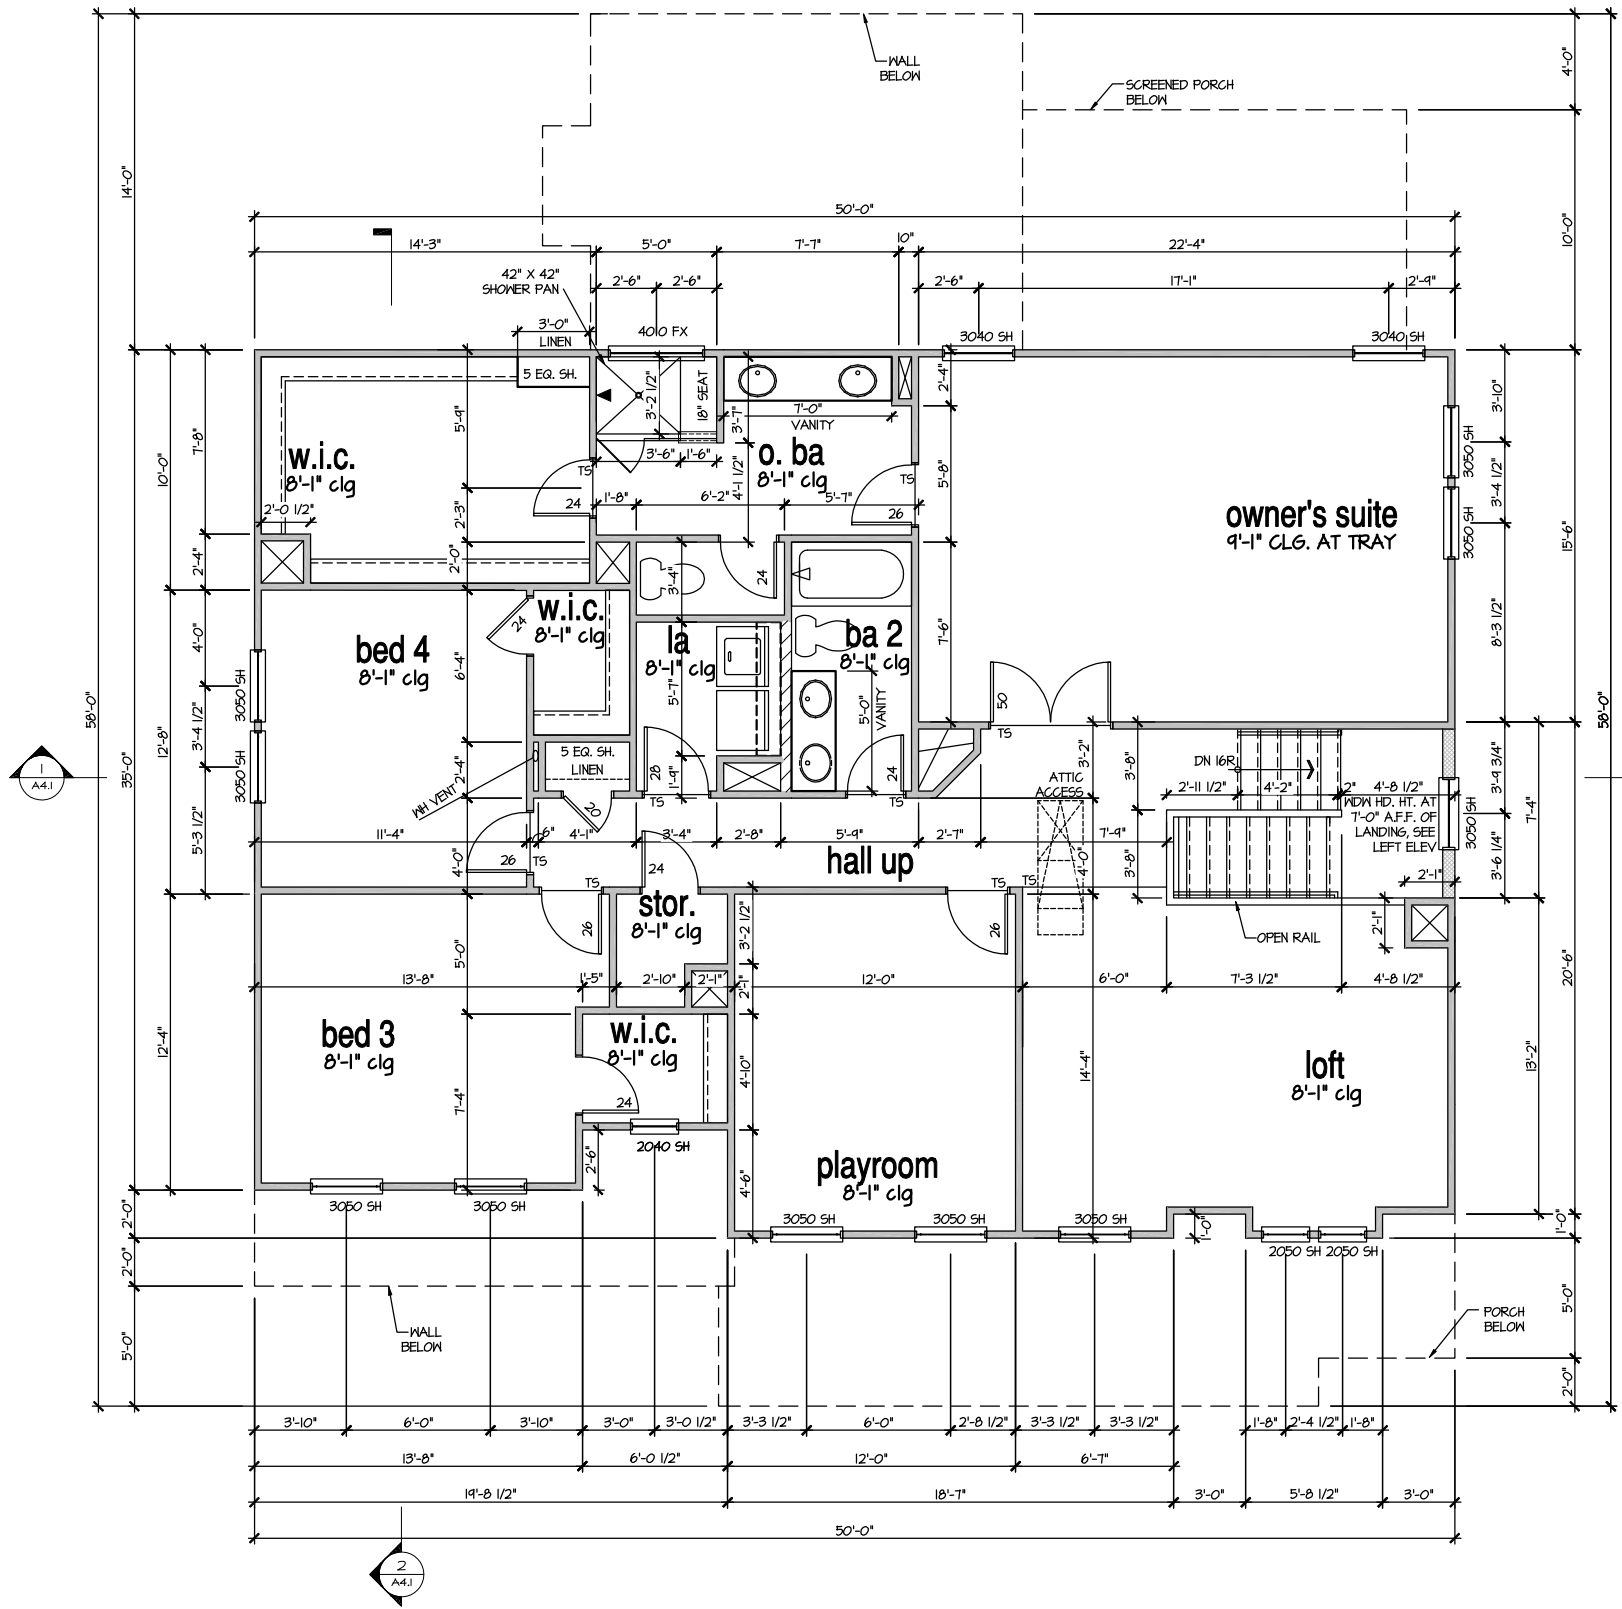

ELEVATION 7
 SECOND FLOOR PLAN
 SCALE: 1/8" = 1'-0"


MASTER PLAN INFORMATION	
REVISION	DATE
2-RALE	03-20-2024
	UPDATED DATE

DRAWN BY:
 ITS
 DATE: 08/27/2024
 PLAN NO.
 1635




HOUSE NAME:
 STONEFIELD
 DRAWING TITLE
 SECOND FLOOR PLAN

SHEET No.
 A3.2

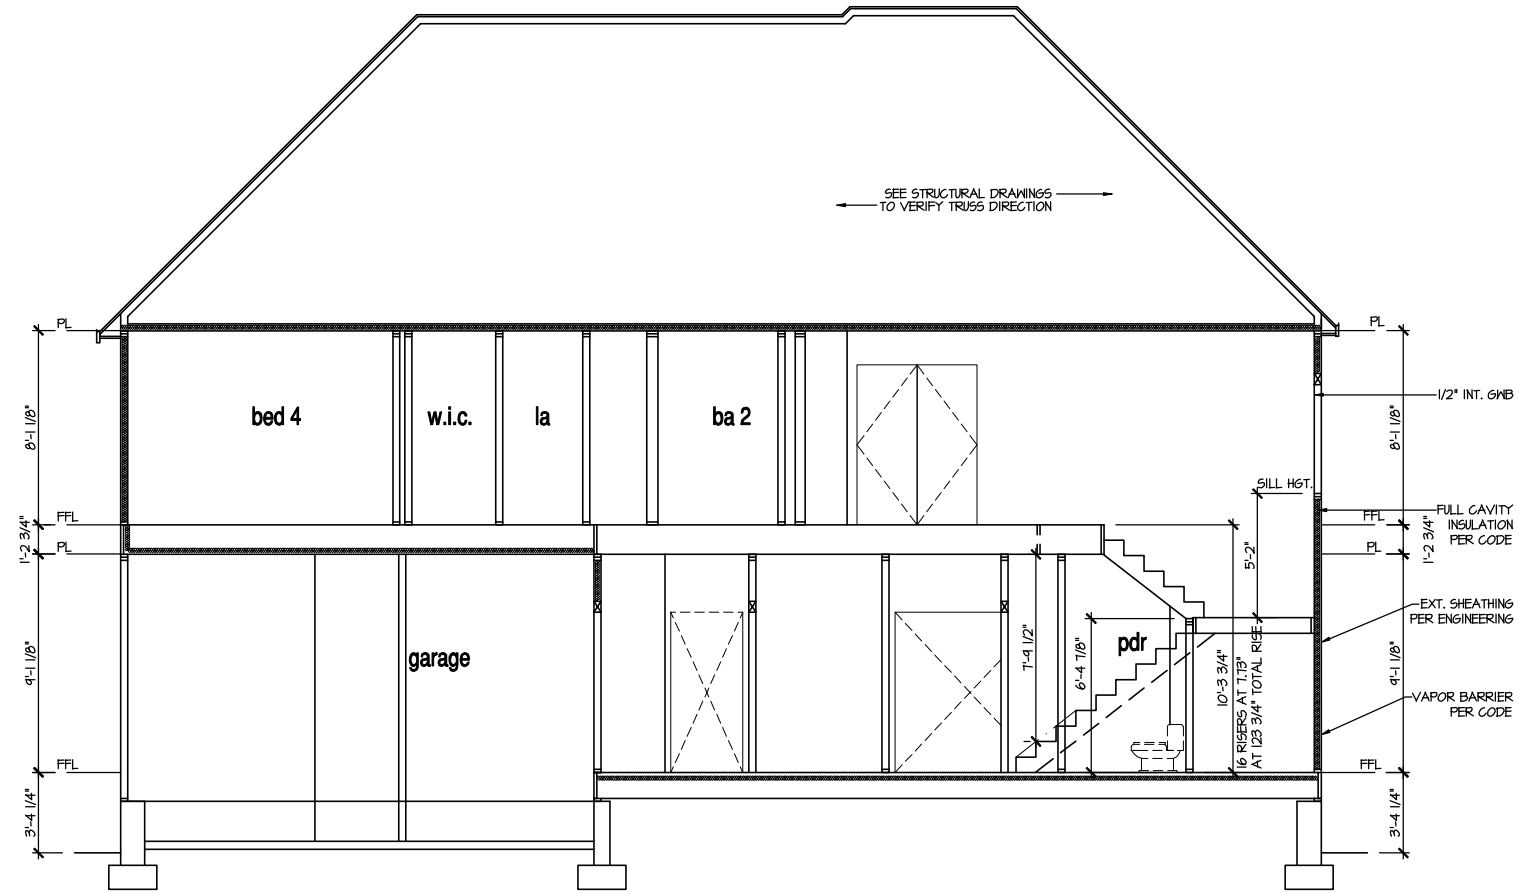

SECTION 1

SCALE: 1/8" = 1'-0"

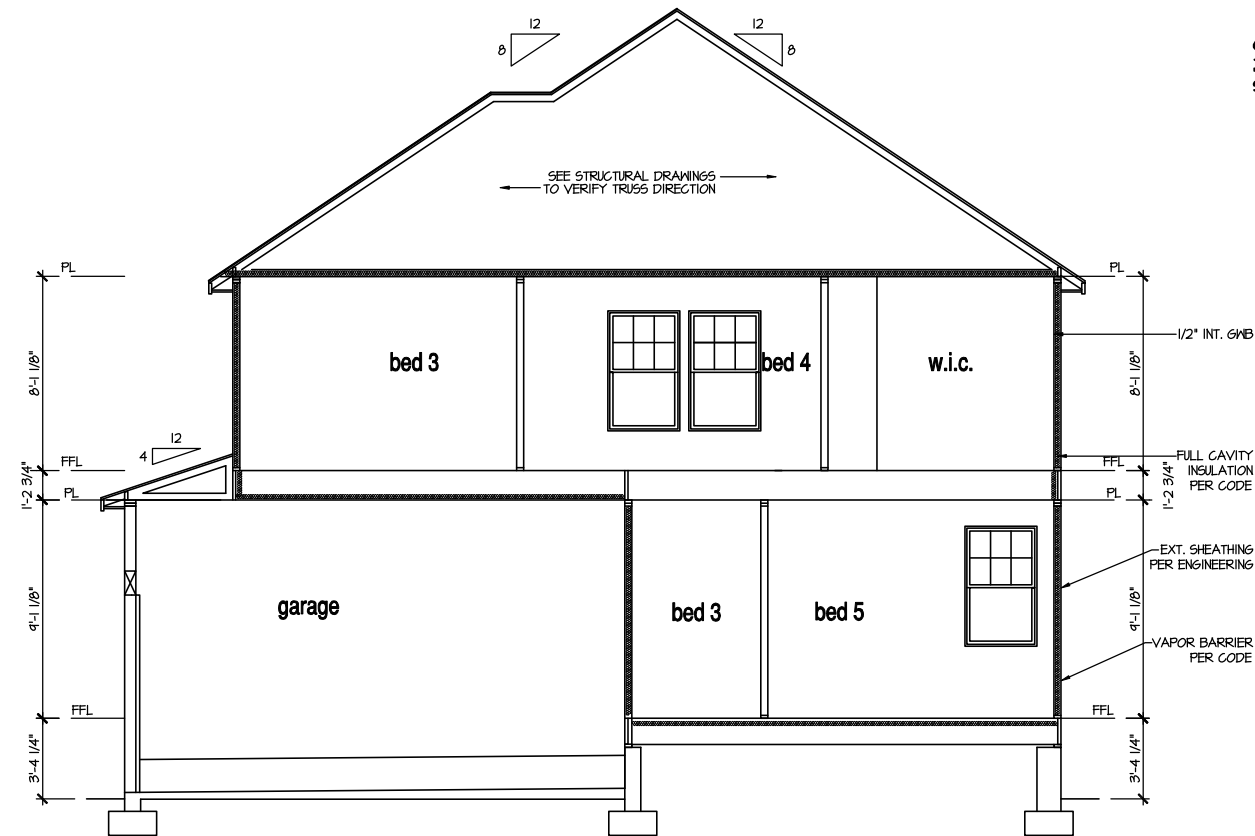

SECTION 2

SCALE: 1/8" = 1'-0"

9'-1" STAIR NOTE:
 (USE 14" TJI WITH 3/4" PLYWOOD SUBFLOOR)
 15 TREADS AT 10" EACH VERIFY
 16 RISERS AT 4'- 1.73" = 123 3/4" TOTAL
 RISE VERIFY

NOTES:


- BUILDING SECTIONS SHOWN HERE DEPICT VOLUMN SPACES WITHIN THE STRUCTURE. REFER TO STRUCTURAL DRAWINGS, TRUSS DRAWINGS, STRUCTURAL DETAILS AND CALCULATIONS BY OTHER FOR ALL STRUCTURAL INFO.
- ROOFING: PITCHED SHINGLE ROOF. REFER TO ROOF PLAN FOR TYPICALS.
- WOOD FLOORS: FLOOR SHEATHING OVER FLOOR JOIST. REFER TO STRUCTURAL AND TRUSS DRAWINGS BY OTHERS.
- INSULATION:
 EXTERIOR WALLS: R-13 BATTIS MINIMUM. VERIFY
 CEILING WITH ATTIC ABOVE: R-30 BATTIS MINIMUM. VERIFY
 FLOOR OVER GARAGE: R-14 BATTIS MINIMUM. VERIFY
 ATTIC KNEEWALL: R-14 BATTIS MINIMUM. VERIFY

PER STATE RESIDENTIAL CODE
 COMPLIANCE METHOD TO BE
 DETERMINED BY BUILDER.

FILE: Lot_00.0036 amendment.dwg DATE: 8/27/2024 12:59 PM

MASTER PLAN INFORMATION	
DATE	03-20-2024
REVISION	2-RALE
UPDATED DATE	


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DATE:	08/27/2024
PLAN NO.	1635

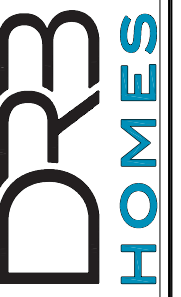


HOUSE NAME:
STONEFIELD
 DRAWING TITLE
BUILDING SECTION

SHEET No.
A4.1


FILE: Lot_00.0036 amendment.dwg DATE: 8/27/2024 12:59 PM

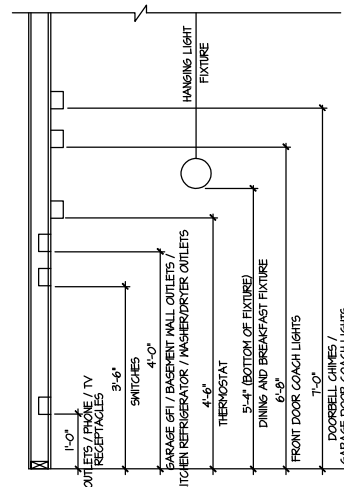

STANDARD ELECTRICAL BOX HEIGHTS

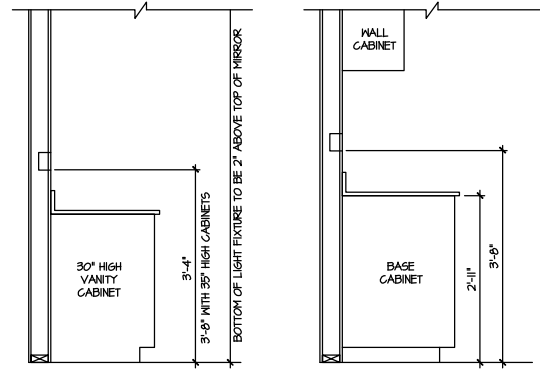

SWITCH AND RECEPTACLE BOXES OVER BATH CABINETS
SWITCH AND RECEPTACLE BOXES OVER KITCHEN CABINETS

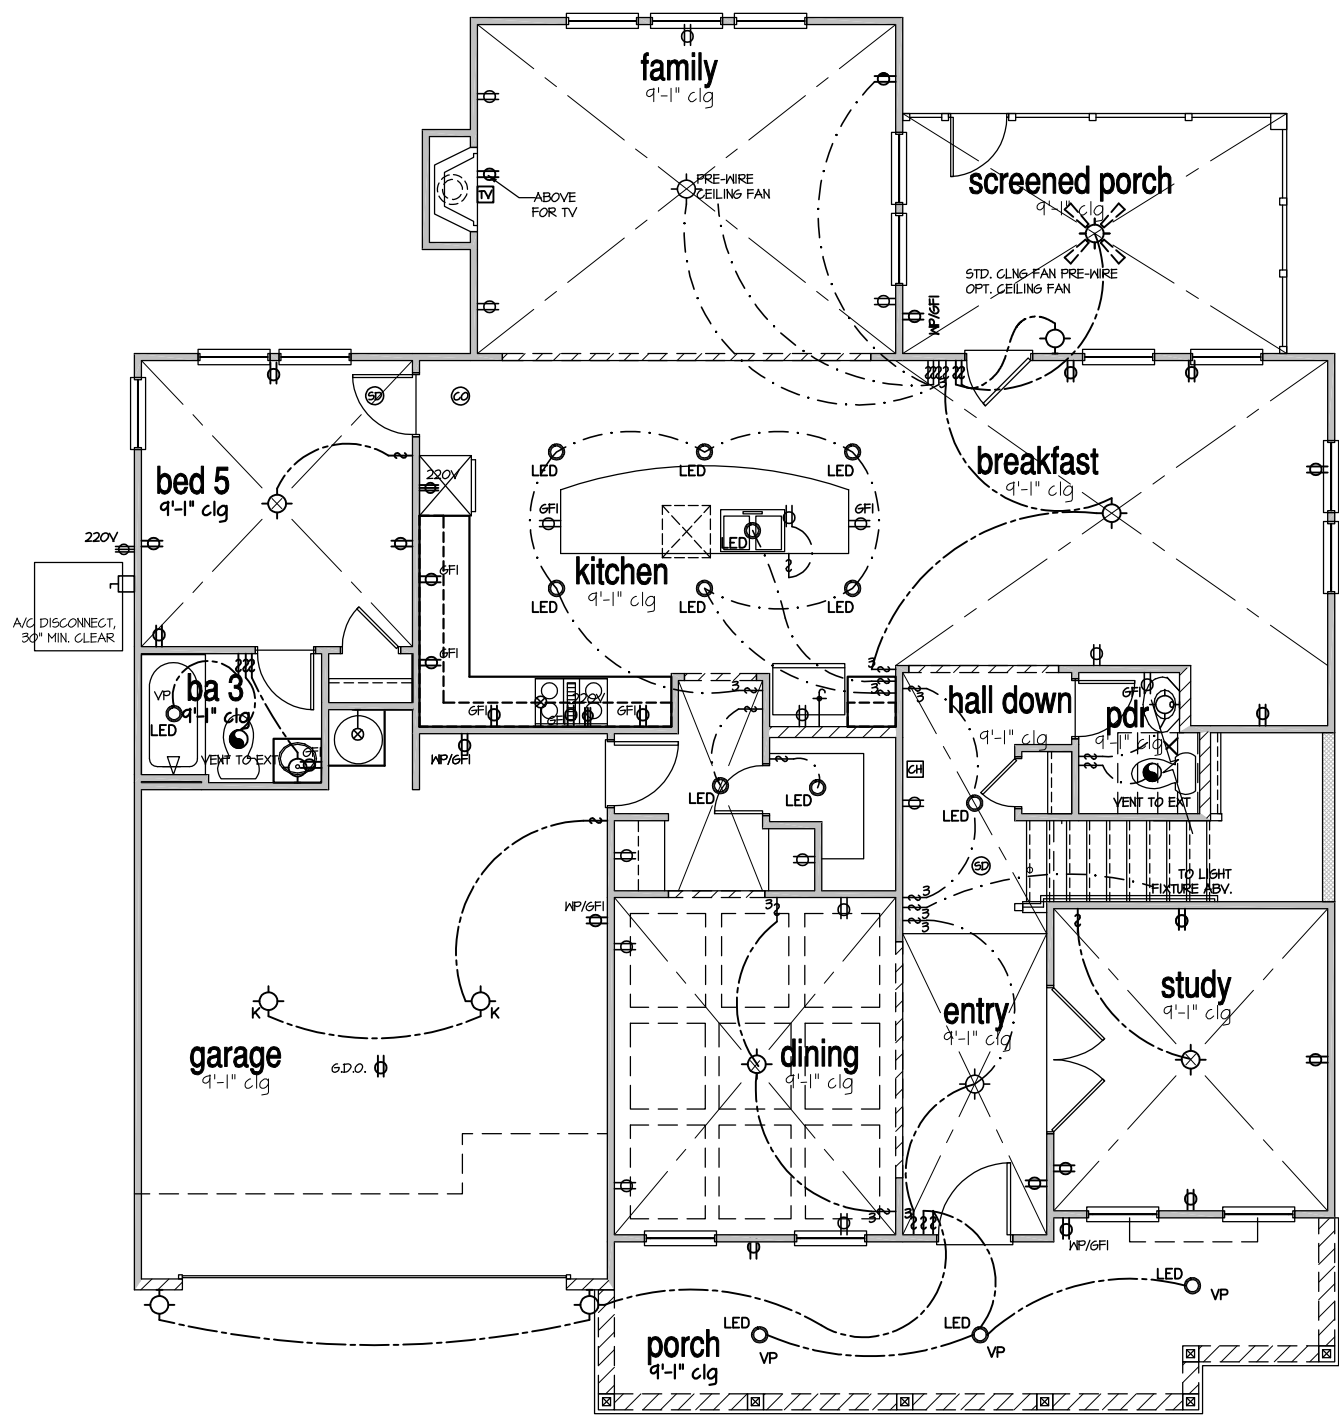

NOTES:

- PROVIDE AND INSTALL LOCALLY CERTIFIED SMOKE DETECTORS AND CO2 DETECTORS AS REQUIRED BY NATIONAL FIRE PROTECTION ASSOCIATION (NFPA) AND MEETING THE REQUIREMENTS OF ALL GOVERNING CODES.
- PROVIDE AND INSTALL GROUND FAULT CIRCUIT-INTERRUPTERS (GFI) AS REQUIRED BY NATIONAL ELECTRICAL CODE (NEC) AND MEETING THE REQUIREMENTS OF ALL GOVERNING CODES.
- ELECTRICAL CONTRACTOR TO PROVIDE REQUIRED DIRECT HOOK-UPS/CUTOFFS.
- HVAC CONTRACTOR TO VERIFY THERMOSTAT LOCATIONS.
- ALL ELECTRICAL AND MECHANICAL EQUIPMENT (FURNACES, A/C UNITS, ELECTRICAL PANELS, SANITARY SUMP PITS, DRAIN TILE SUMP, AND WATER HEATERS) ARE SUBJECT TO RELOCATION DUE TO FIELD CONDITIONS.
- PROVIDE POWER, LIGHT AND SWITCH AS REQUIRED FOR ATTIC FURNACE PER CODE AND MANUFACTURER'S WRITTEN INSTRUCTIONS.
- CLOSET LIGHTS TO BE FLOURESCENT FIXTURES FOR NC & INCANDESCENT CL6. MOUNTED FIXTURES FOR ALL OTHER AREAS.

LEGEND:

⊕	AFCI DUPLEX OUTLET	⊙	CEILING MOUNTED INCANDESCENT LIGHT FIXTURE	⊠	CHIMES	⊗	CEILING FAN (PROVIDE ADEQUATE SUPPORT)
⊕WP/GFI	WEATHERPROOF GFI AFCI DUPLEX OUTLET	⊙K	KEYLESS LIGHT	⊠	PUSHBUTTON SWITCH	⊗	CEILING FAN WITH INCANDESCENT LIGHT FIXTURE (PROVIDE ADEQUATE SUPPORT)
⊕GFI	GROUND-FAULT CIRCUIT-INTERRUPTER AFCI DUPLEX OUTLET	⊙	MALL MOUNTED INCANDESCENT LIGHT FIXTURE	⊠	110V SMOKE DETECTOR W/ BATTERY BACKUP	⊗	CEILING FAN WITH INCANDESCENT LIGHT FIXTURE (PROVIDE ADEQUATE SUPPORT)
⊕	HALF-SWITCHED AFCI DUPLEX OUTLET	⊙	RECESSED LIGHT FIXTURE	⊠	CO2 DETECTOR	⊗	GAS SUPPLY WITH VALVE
⊕220V	220 VOLT AFCI OUTLET	⊙LED	LED SURFACE MOUNTED	⊠	THERMOSTAT	⊗	HOSE BIBB
⊕	REINFORCED JUNCTION BOX	⊙	EXHAUST FAN (VENT TO EXTERIOR)	⊠	TELEPHONE	⊗	1/4" WATER STUB OUT
⊕	WALL SWITCH	⊙	EXHAUST FAN/LIGHT COMBINATION (VENT TO EXTERIOR)	⊠	TELEVISION	⊗	TECH. HUB SYSTEM
⊕3	THREE-WAY SWITCH	⊙	TECH. HUB SYSTEM	⊠	ELECTRIC METER		
⊕4	FOUR-WAY SWITCH			⊠	ELECTRIC PANEL		
⊕	LED STRIP FIXTURE			⊠	DISCONNECT SWITCH		

**ELECTRICAL PLAN
FIRST FLOOR - ELEV. 4**
SCALE: 1/8" = 1'-0"

MASTER PLAN INFORMATION


REVISION	DATE	UPDATED DATE
2-RALE	03-20-2024	

DRAWN BY: ITS
DATE: 08/27/2024
PLAN NO. 1635




HOUSE NAME: STONEFIELD
DRAWING TITLE: FIRST FLOOR ELECTRICAL


SHEET No. 11

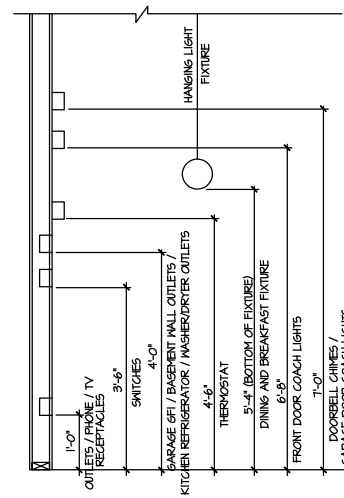

STANDARD ELECTRICAL BOX HEIGHTS

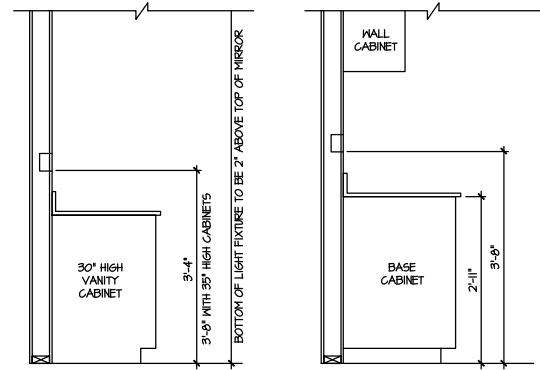

SWITCH AND RECEPTACLE BOXES OVER BATH CABINETS
SWITCH AND RECEPTACLE BOXES OVER KITCHEN CABINETS

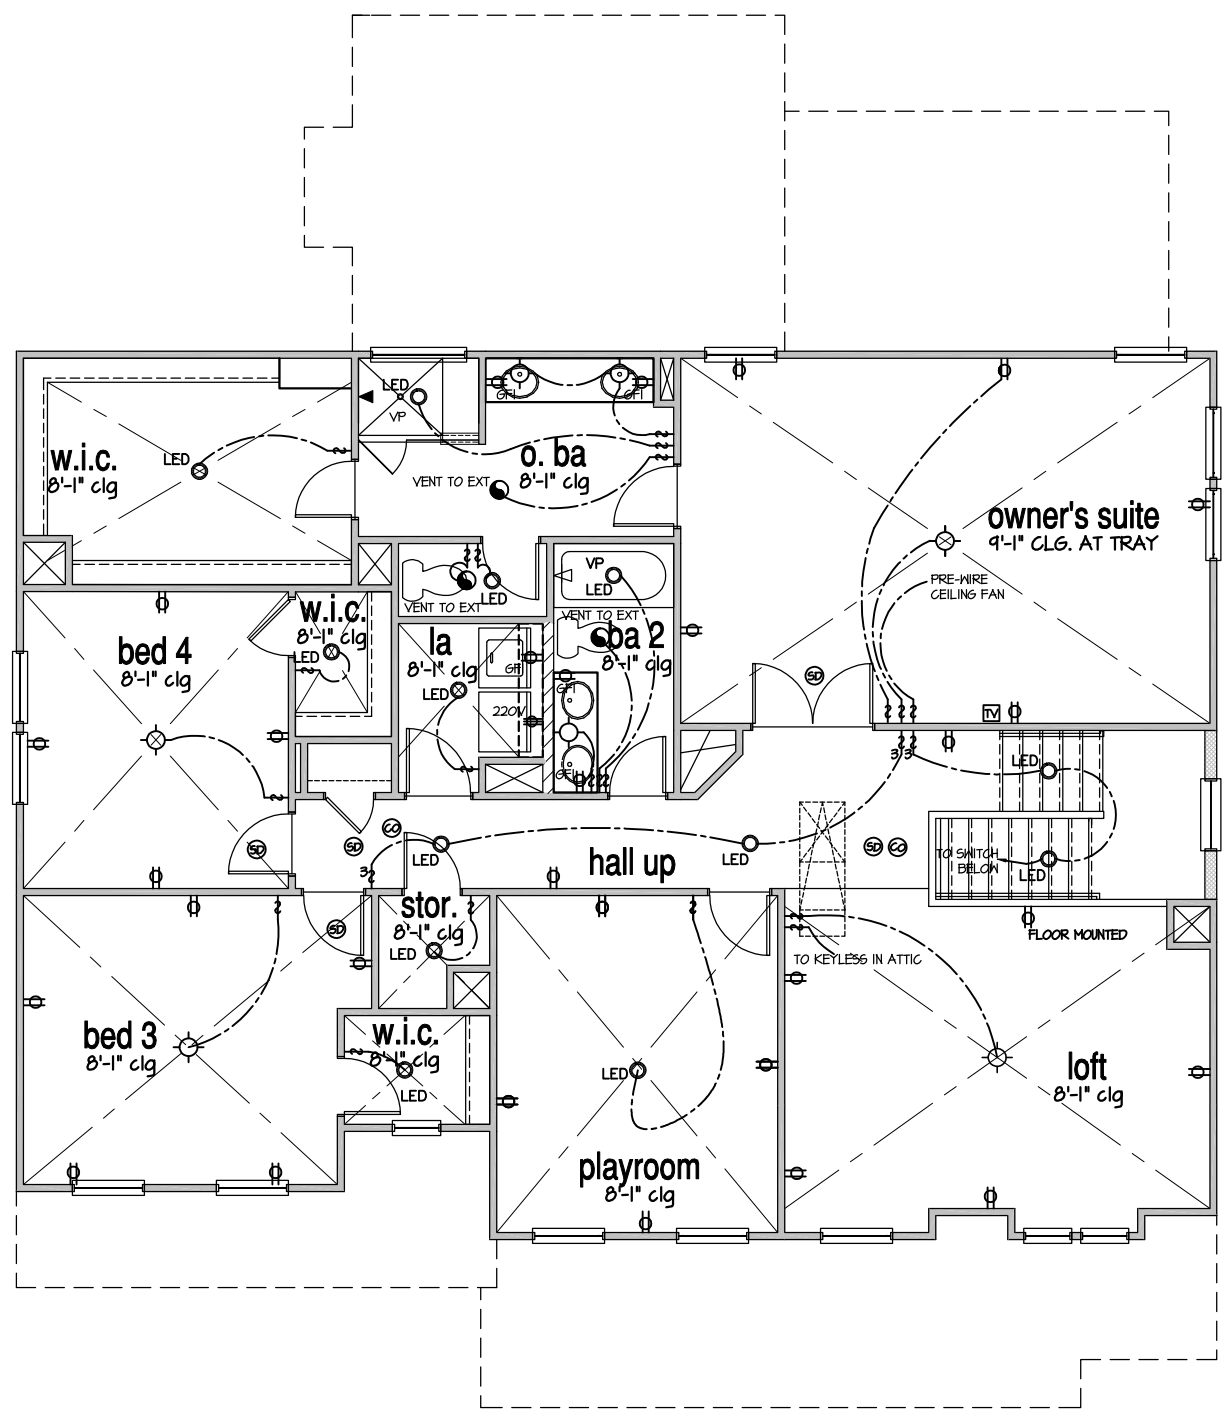

NOTES:

- PROVIDE AND INSTALL LOCALLY CERTIFIED SMOKE DETECTORS AND CO2 DETECTORS AS REQUIRED BY NATIONAL FIRE PROTECTION ASSOCIATION (NFPA) AND MEETING THE REQUIREMENTS OF ALL GOVERNING CODES.
- PROVIDE AND INSTALL GROUND FAULT CIRCUIT-INTERRUPTERS (GFI) AS REQUIRED BY NATIONAL ELECTRICAL CODE (NEC) AND MEETING THE REQUIREMENTS OF ALL GOVERNING CODES.
- ELECTRICAL CONTRACTOR TO PROVIDE REQUIRED DIRECT HOOK-UPS/CUTOFFS.
- HVAC CONTRACTOR TO VERIFY THERMOSTAT LOCATIONS.
- ALL ELECTRICAL AND MECHANICAL EQUIPMENT (FURNACES, A/C UNITS, ELECTRICAL PANELS, SANITARY SUMP PITS, DRAIN TILE SUMP, AND WATER HEATERS) ARE SUBJECT TO RELOCATION DUE TO FIELD CONDITIONS.
- PROVIDE POWER, LIGHT AND SWITCH AS REQUIRED FOR ATTIC FURNACE PER CODE AND MANUFACTURERS WRITTEN INSTRUCTIONS.
- CLOSET LIGHTS TO BE FLOURESCENT FIXTURES FOR NC & INCANDESCENT CLG. MOUNTED FIXTURES FOR ALL OTHER AREAS.

LEGEND:	
⊕	AFGI DUPLEX OUTLET
⊕/HP/HP1	WEATHERPROOF GFI AFGI DUPLEX OUTLET
⊕/GFI	GROUND-FAULT CIRCUIT-INTERRUPTER AFGI DUPLEX OUTLET
⊕	HALF-SWITCHED AFGI DUPLEX OUTLET
⊕/220V	220 VOLT AFGI OUTLET
⊕	REINFORCED JUNCTION BOX
⊕	HALL SWITCH
⊕/3	THREE-WAY SWITCH
⊕/4	FOUR-WAY SWITCH
⊕/LED	LED STRIP FIXTURE
⊕	CEILING MOUNTED INCANDESCENT LIGHT FIXTURE
⊕	KEYLESS LIGHT
⊕	HALL MOUNTED INCANDESCENT LIGHT FIXTURE
⊕	RECESSED LIGHT FIXTURE
⊕/LED	LED SURFACE MOUNTED
⊕	EXHAUST FAN (VENT TO EXTERIOR)
⊕	EXHAUST FAN/LIGHT COMBINATION (VENT TO EXTERIOR)
⊕	TECH. HUB SYSTEM
⊕	CHIMES
⊕	PUSHBUTTON SWITCH
⊕	110V SMOKE DETECTOR W/ BATTERY BACKUP
⊕	CO2 DETECTOR
⊕	THERMOSTAT
⊕	TELEPHONE
⊕	TELEVISION
⊕	ELECTRIC METER
⊕	ELECTRIC PANEL
⊕	DISCONNECT SWITCH
⊕	CEILING FAN (PROVIDE ADEQUATE SUPPORT)
⊕	CEILING FAN WITH INCANDESCENT LIGHT FIXTURE (PROVIDE ADEQUATE SUPPORT)
⊕	6AS SUPPLY WITH VALVE
⊕	HOSE BIBB
⊕	1/4" WATER STUB OUT

ELECTRICAL PLAN
SECOND FLOOR - ELEV. 4
SCALE: 1/8" = 1'-0"

FILE: Lot_00.0036 amendment.dwg DATE: 8/27/2024 12:59 PM

MASTER PLAN INFORMATION	
REVISION	DATE
2-RALE	03-20-2024
UPDATED DATE	


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DATE:	08/27/2024
PLAN NO.	1635



HOUSE NAME:
STONEFIELD
DRAWING TITLE
SECOND FLOOR ELECTRICAL


SHEET No.
11.2

ALL DIMENSIONS ARE TO FRAMING

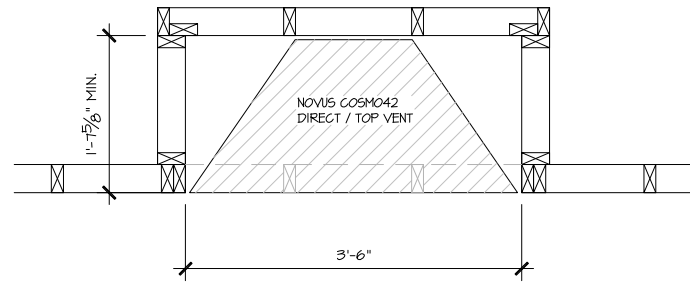


PARTIAL PLAN
NOVUS COSMO42

SCALE: 1/2" = 1'-0"

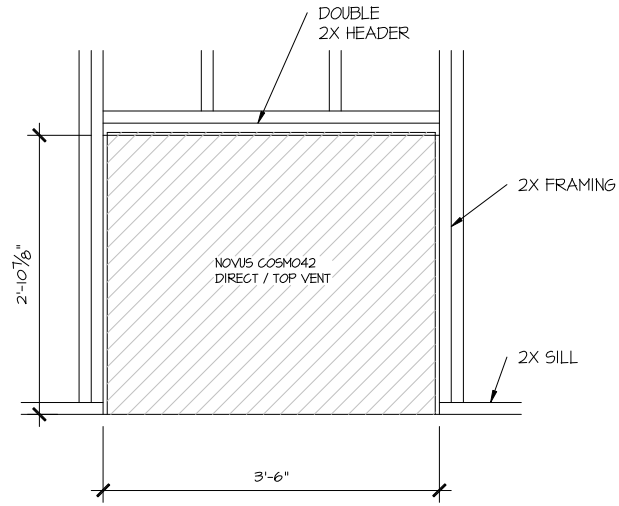


PARTIAL ELEVATION
NOVUS COSMO42

SCALE: 1/2" = 1'-0"

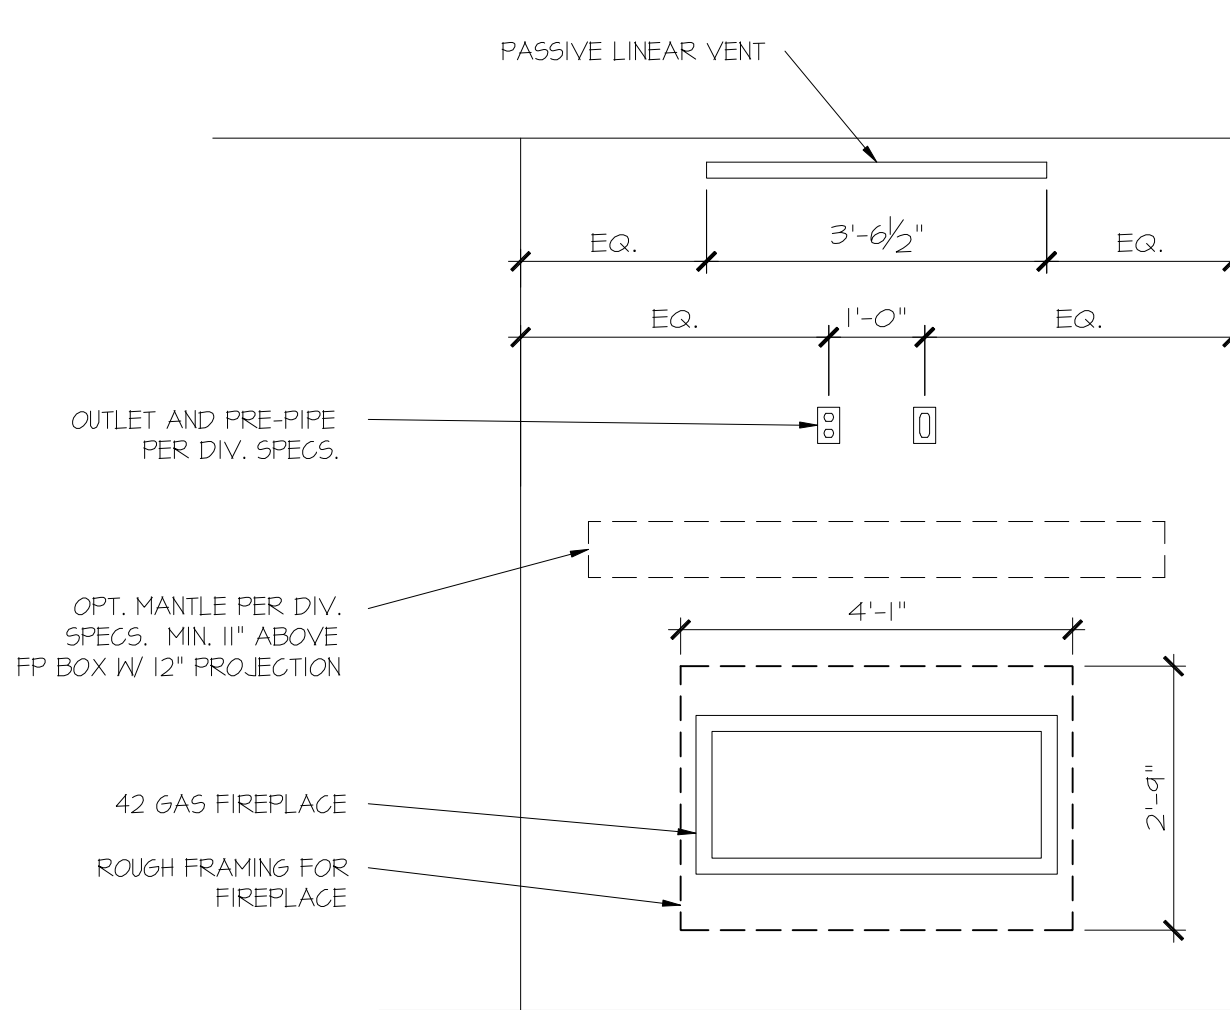

PARTIAL ELEVATION
NOVUS COSMO42

SCALE: 1/2" = 1'-0"

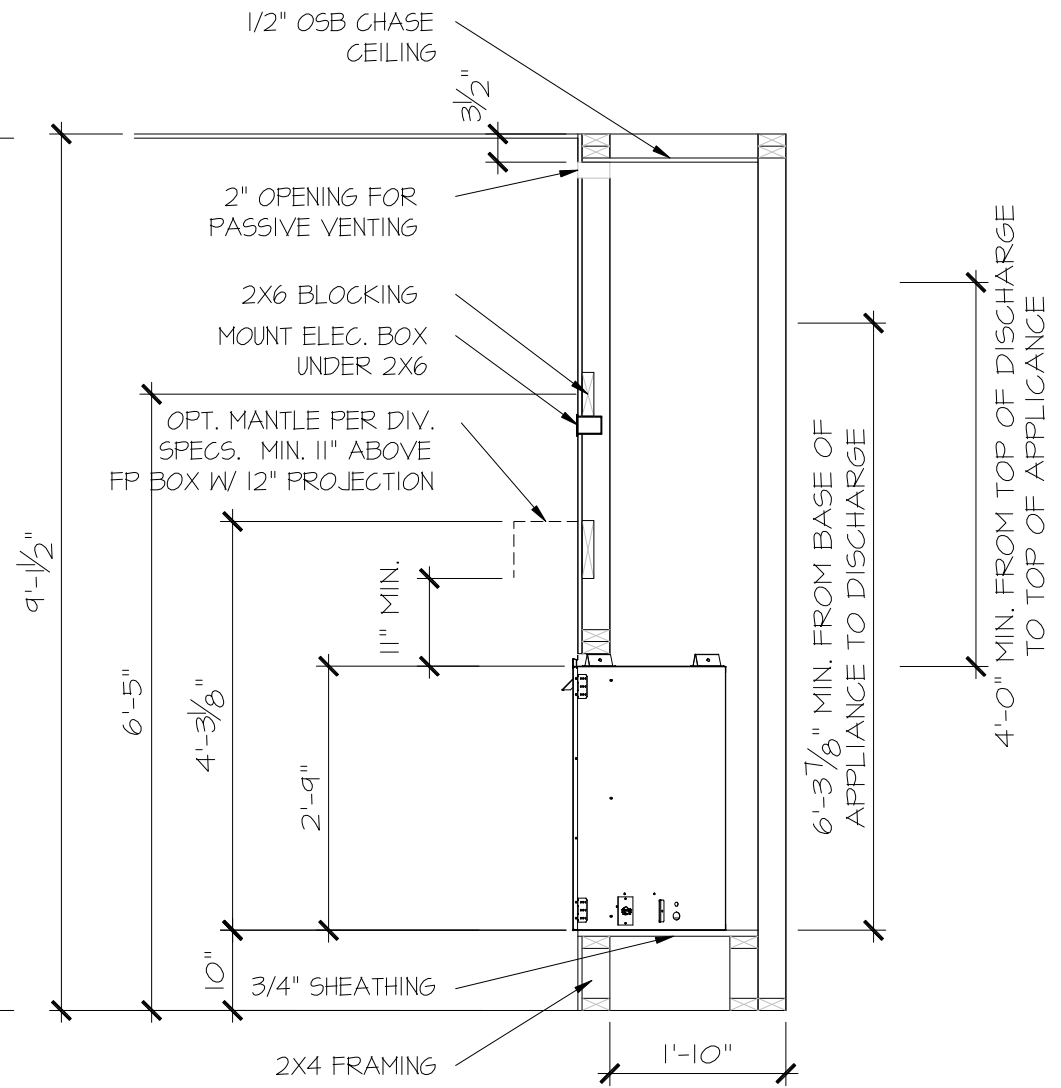

PARTIAL SECTION
NOVUS COSMO42

SCALE: 1/2" = 1'-0"

CONSULTANT LOGO



SEAL

DRAWN BY:
L. BEAVERS
DATE: 11-8-23
PLAN NO. N/A
11 X 17 SCALE
24 X 36 SCALE




HOUSE NAME:
RALE FIREPLACE DETAILS
DRAWING TITLE
RALE FIREPLACE DETAIL
INTERIOR GAS UNITS

SHEET No.
10

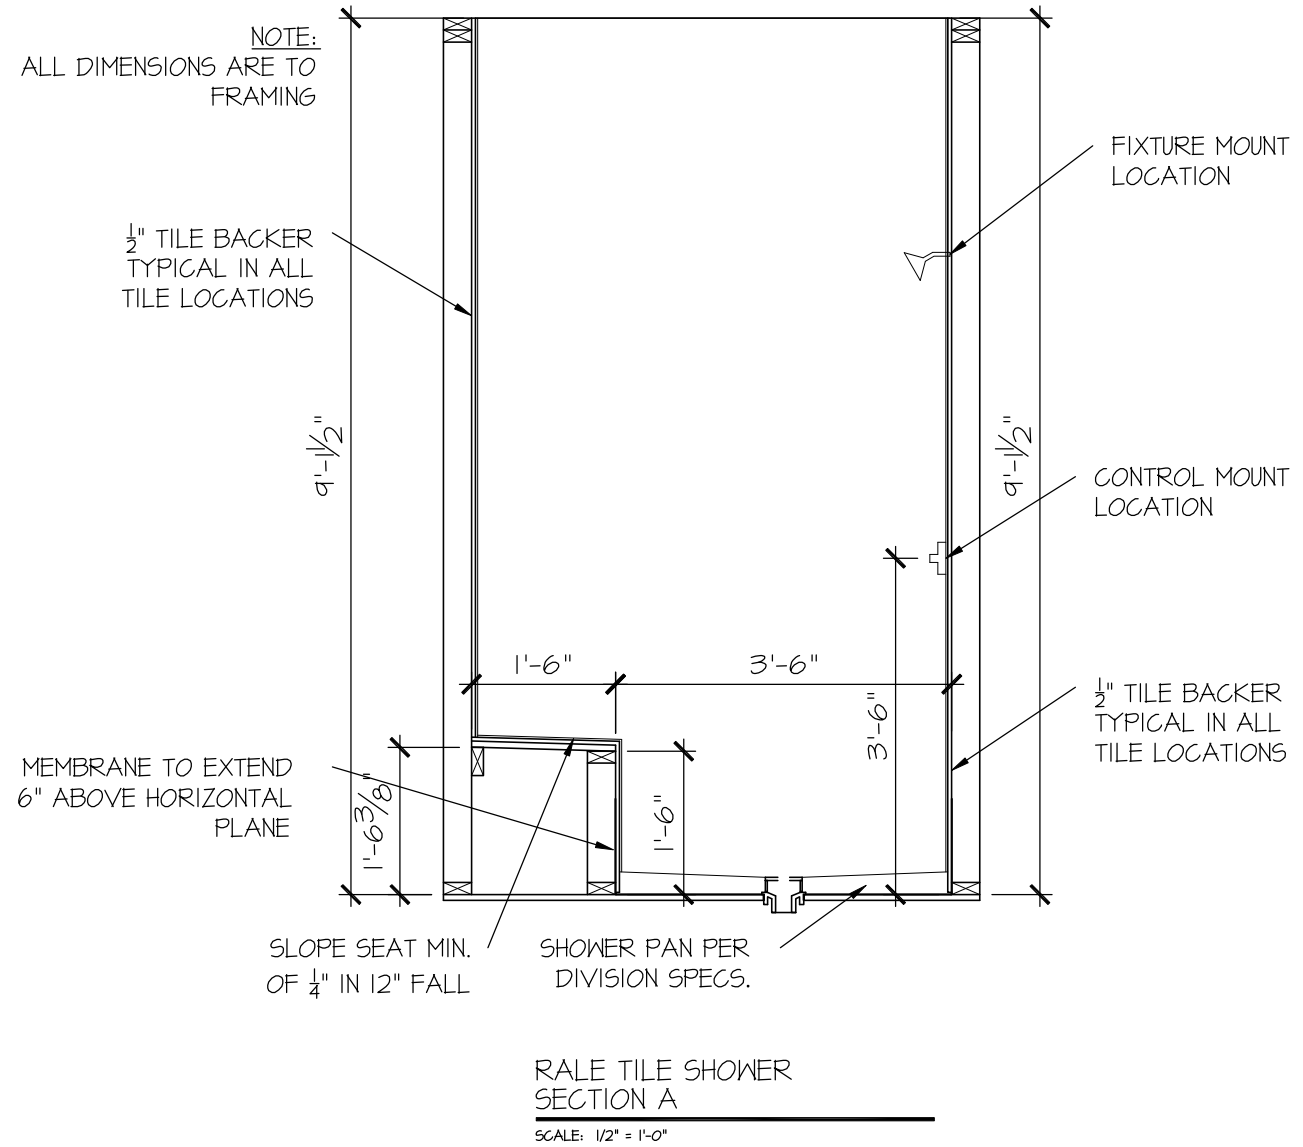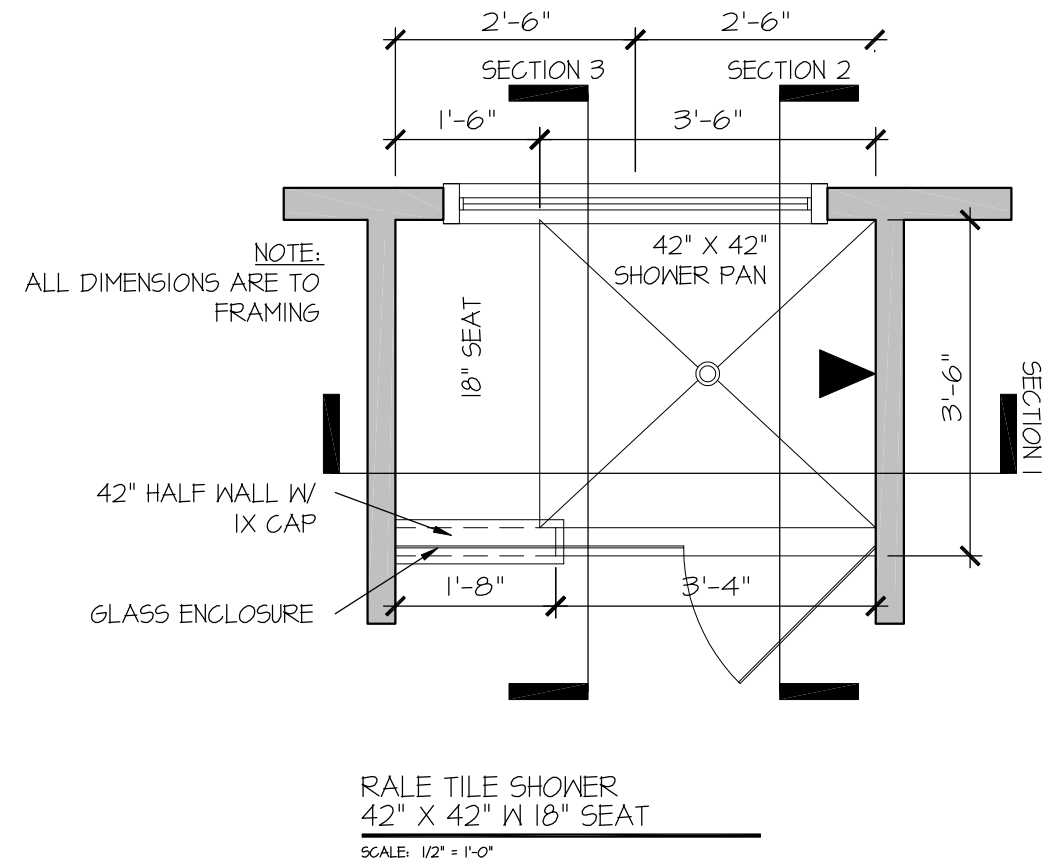


SEAL

DRAWN BY:
L. BEAVERS
DATE: 9/1/22
PLAN NO.
11 X 17 SCALE
24 X 36 SCALE

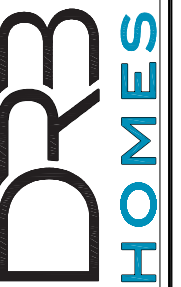


HOUSE NAME:
DRAWING TITLE
RALE TILE SHOWER DETAIL

SHEET No.
01.12

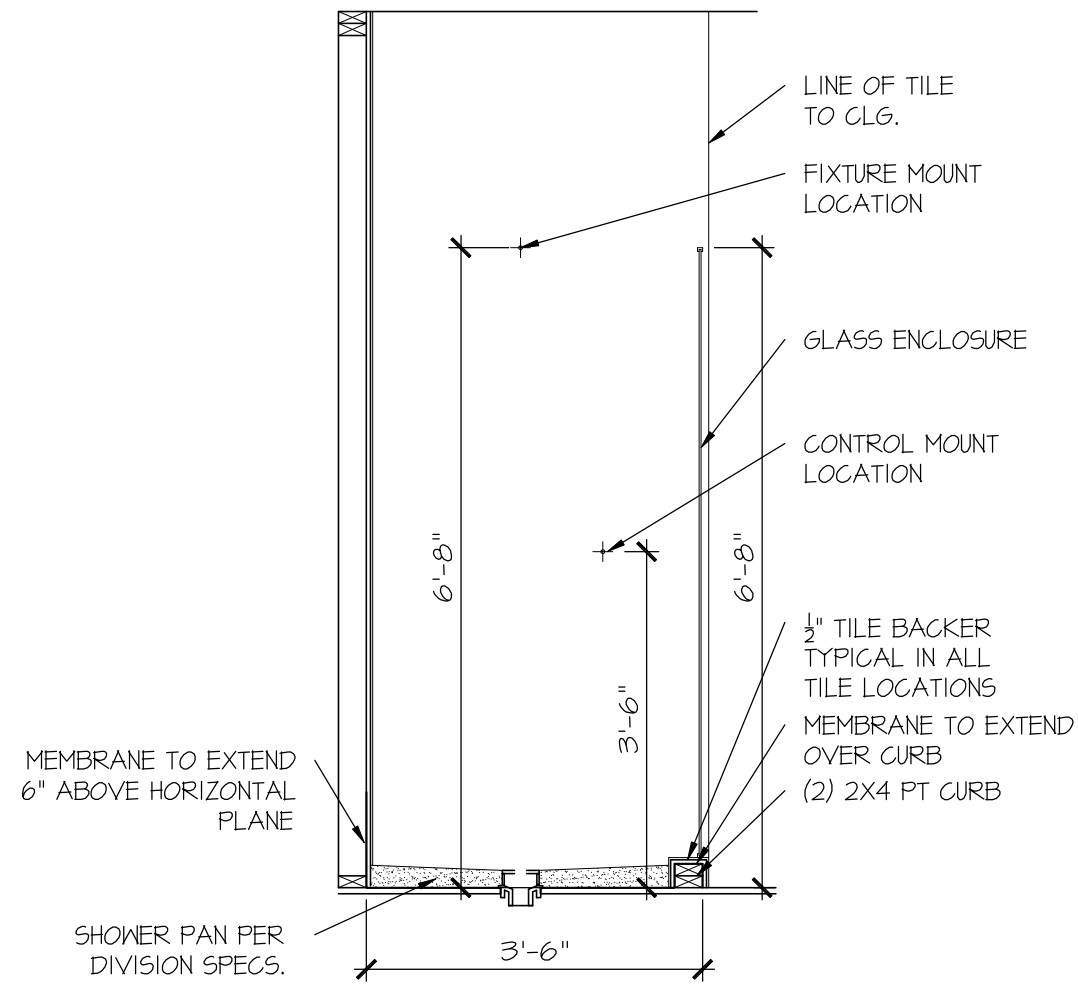


RALE TILE SHOWER SECTION B

SCALE: 1/2" = 1'-0"

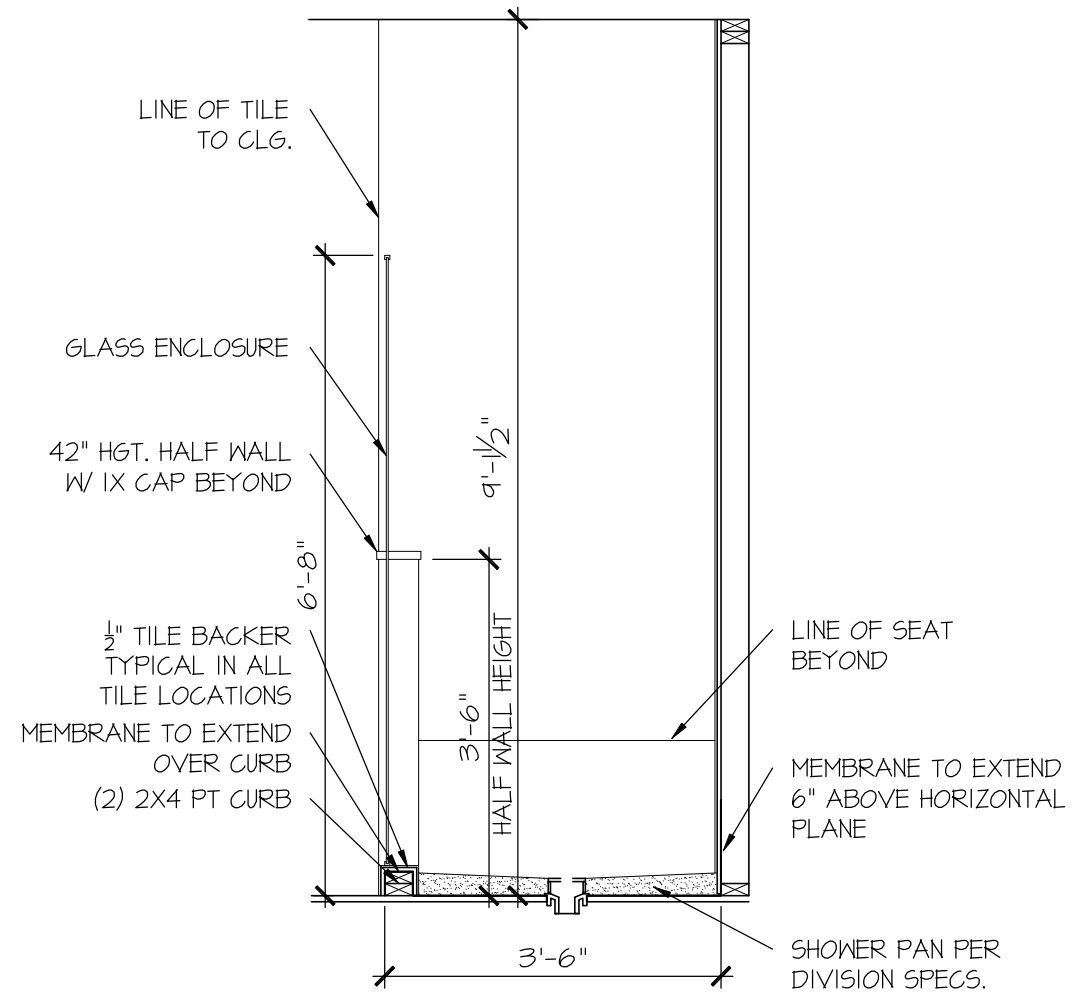

RALE TILE SHOWER SECTION C

SCALE: 1/2" = 1'-0"

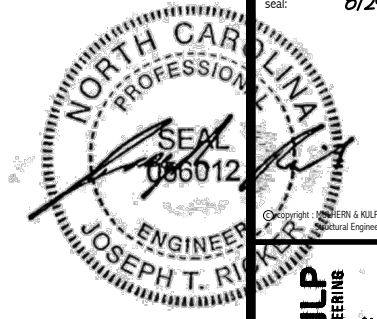

MULHERN+KULP
RESIDENTIAL STRUCTURAL ENGINEERING
3000 Beardslee Ave, Building 4 - Asheville, PA 18002
P 716-896-8881 • mulhern+kulp.com



M&K project number:
126-23047


project mgr: JTR
drawn by: JAD
issue date: 08-29-24

REVISIONS:
date: initial:

DRB
HOMES

FOUNDATION PLANS
HONEYCUTT HILLS
LOT 36 - STONEFIELD 7
RALEIGH, NC

sheet:
S1.0

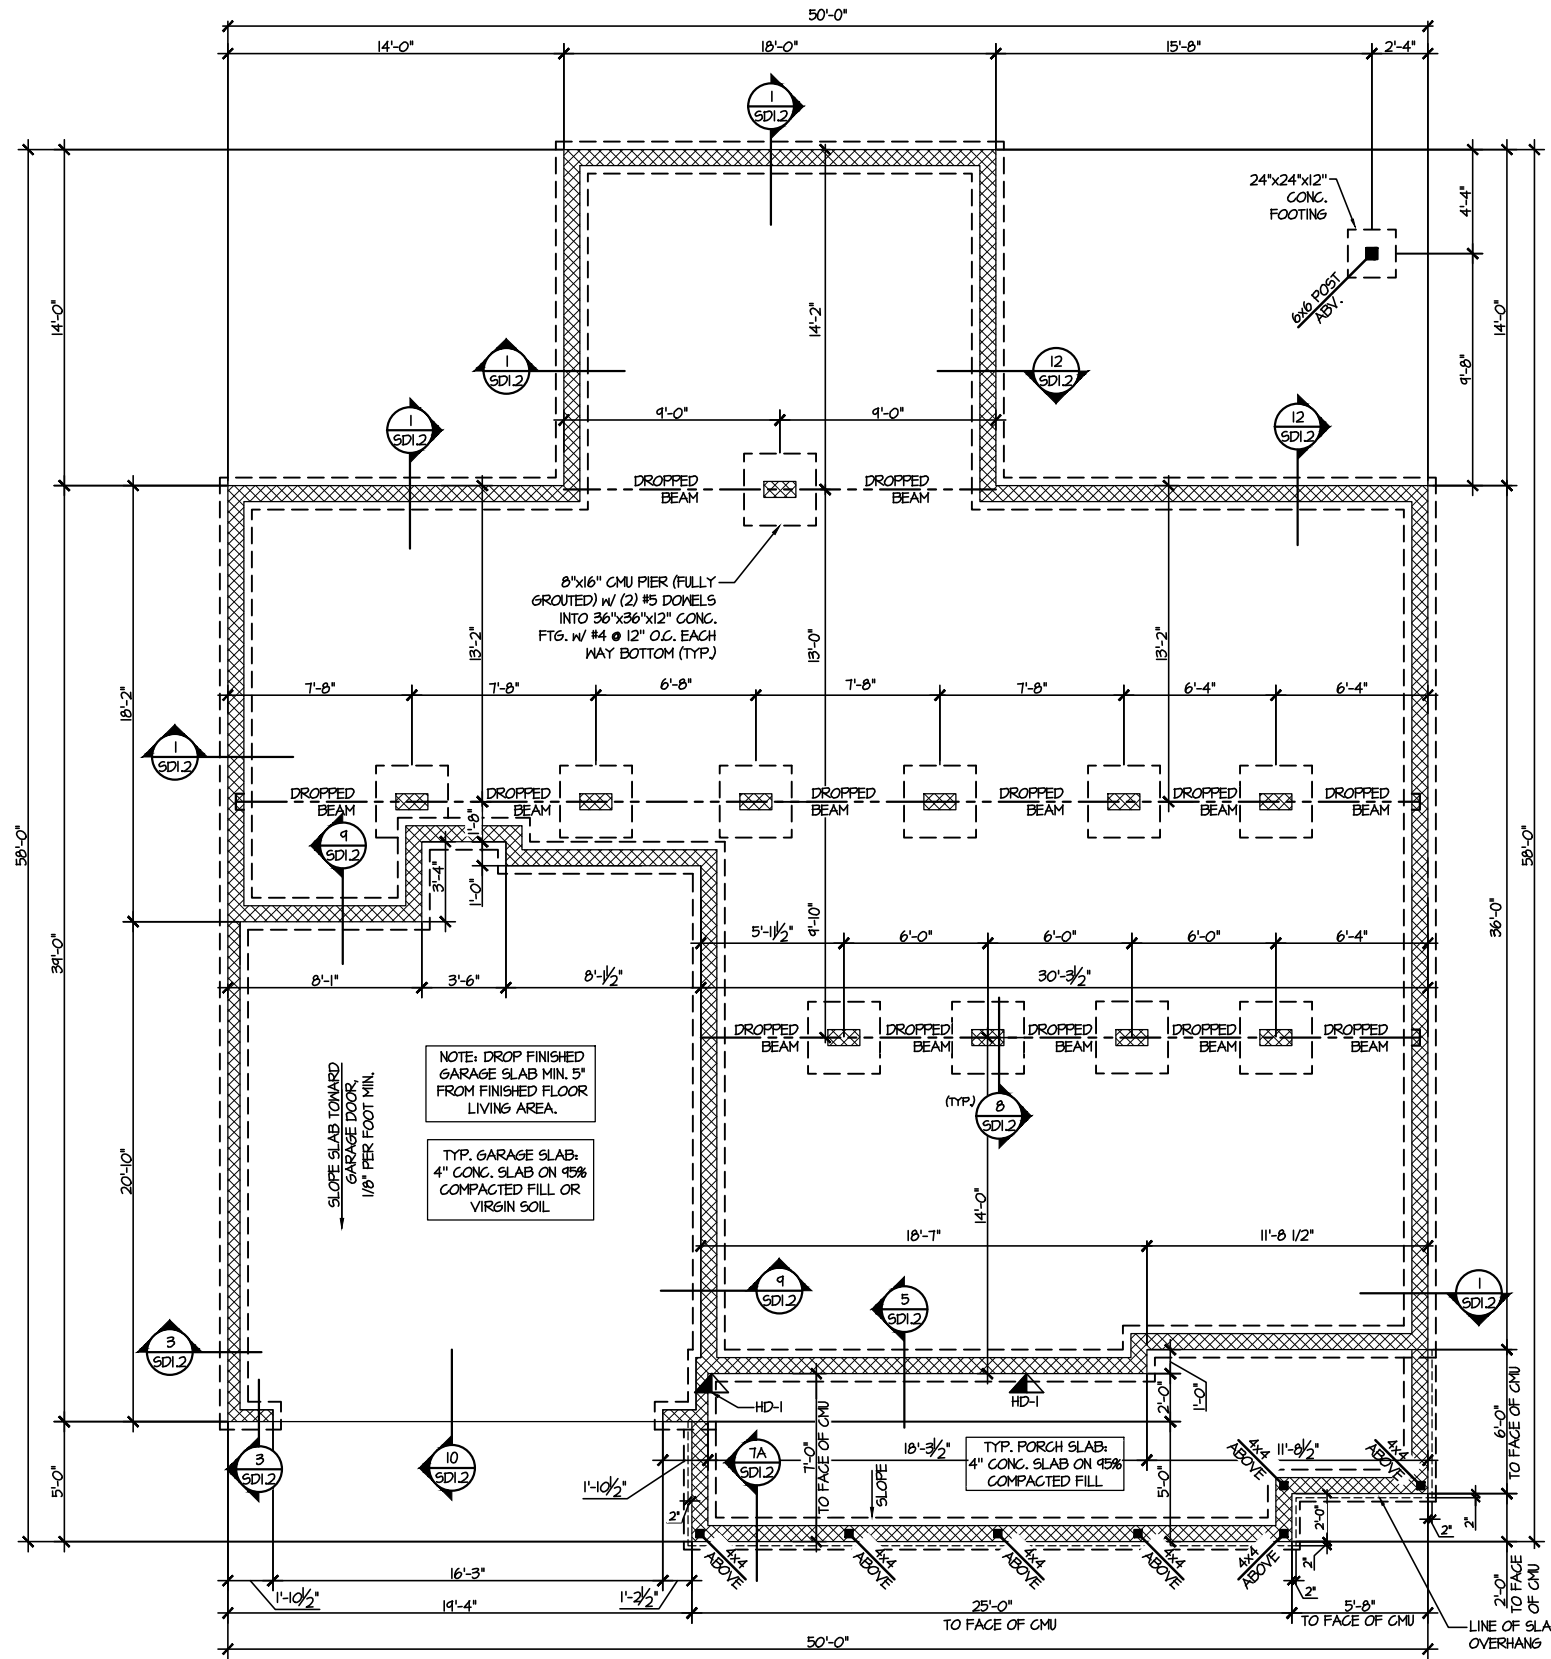


1 CRAWLSPACE FOUNDATION PLAN
SCALE: 1/8"=1'-0"

LEGEND

- [Symbol] INTERIOR BEARING WALL
- [Symbol] BEARING WALL ABOVE
- [Symbol] BEAM / HEADER
- [Symbol] INDICATES SHEAR WALL & EXTENT
- [Symbol] EXTENT OF OVERFRAMING
- JL METAL HANGER
- [Symbol] INDICATES POST ABOVE. PROVIDE SOLID BLOCKING UNDER POST OR JAMB ABOVE.
- [Symbol] INDICATES HOLD-DOWN OR STRAP. REFER TO SCHEDULE.

REFER TO 50.0 FOR
TYPICAL STRUCTURAL NOTES
& SCHEDULES

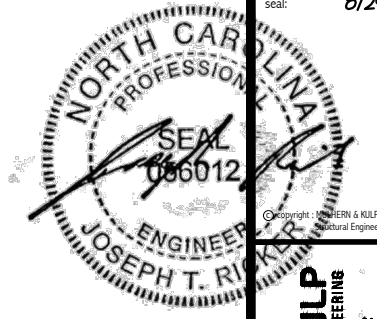

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RESIDENTIAL STRUCTURAL ENGINEERING
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NC LIC. #C-3825



M&K project number:
126-23047


project mgr: JTR
drawn by: JAD
issue date: 08-29-24

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date: initial:

DRB
HOMES

FLOOR FRAMING PLANS
HONEYCUTT HILLS
LOT 36 - STONEFIELD 7
RALEIGH, NC


sheet:
S2.0

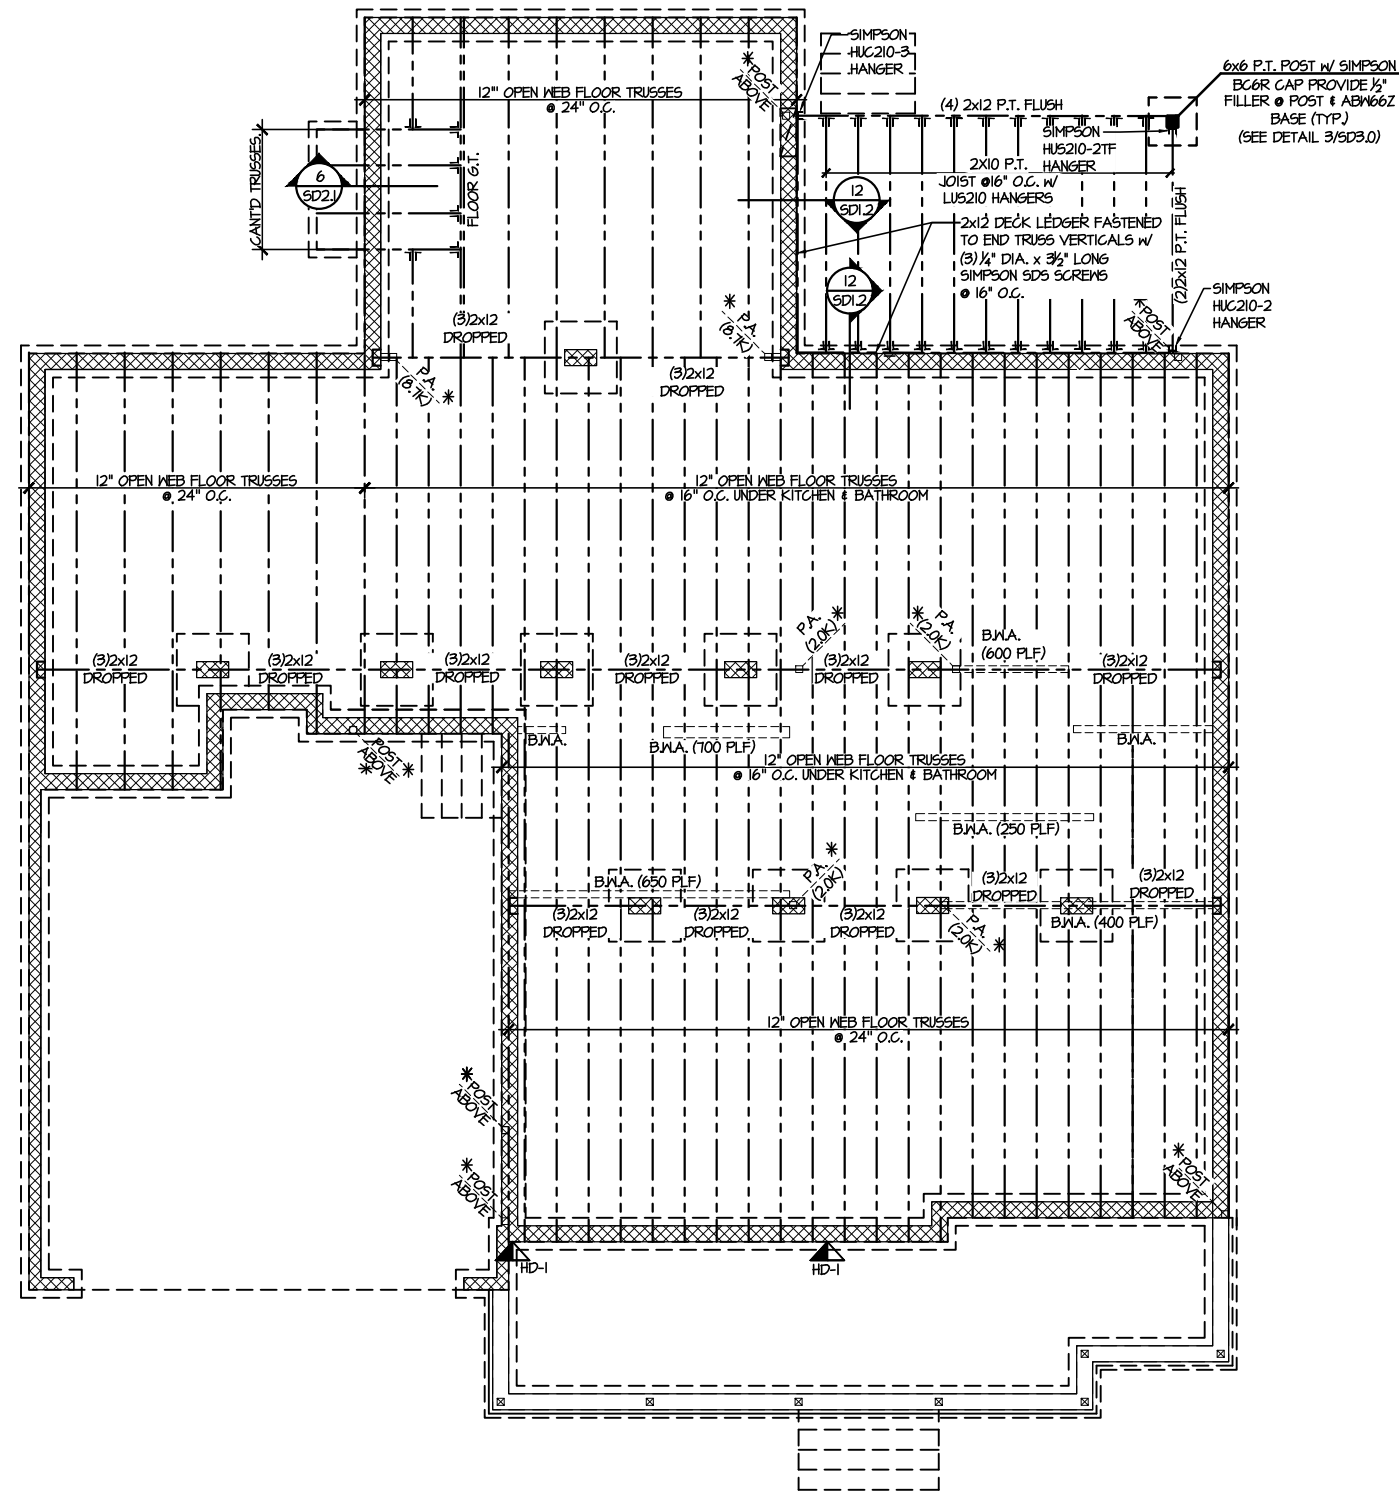

1 1ST FLOOR FRAMING PLAN (CRAWLSPACE)
SCALE: 1/8"=1'-0"

LEGEND	
	INTERIOR BEARING WALL
	BEARING WALL ABOVE
	BEAM / HEADER
	INDICATES SHEAR WALL & EXTENT
	EXTENT OF OVERFRAMING
	JL METAL HANGER
	INDICATES POST ABOVE. PROVIDE SOLID BLOCKING UNDER POST OR JAMB ABOVE.
	INDICATES HOLD-DOWN OR STRAP. REFER TO SCHEDULE.


REFER TO SO.O FOR
TYPICAL STRUCTURAL NOTES
& SCHEDULES

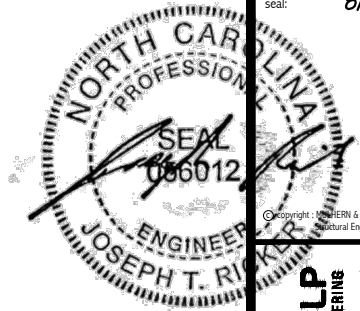

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2ND FLOOR FRAMING PLAN
SCALE: 1/8"=1'-0"

SD2.1 REFERS TO SD2.1A FOR LVL/PSL/LSL BEAMS OR SD2.1B FOR FLITCH BEAMS OR SD2.1C FOR STEEL BEAMS

LEGEND

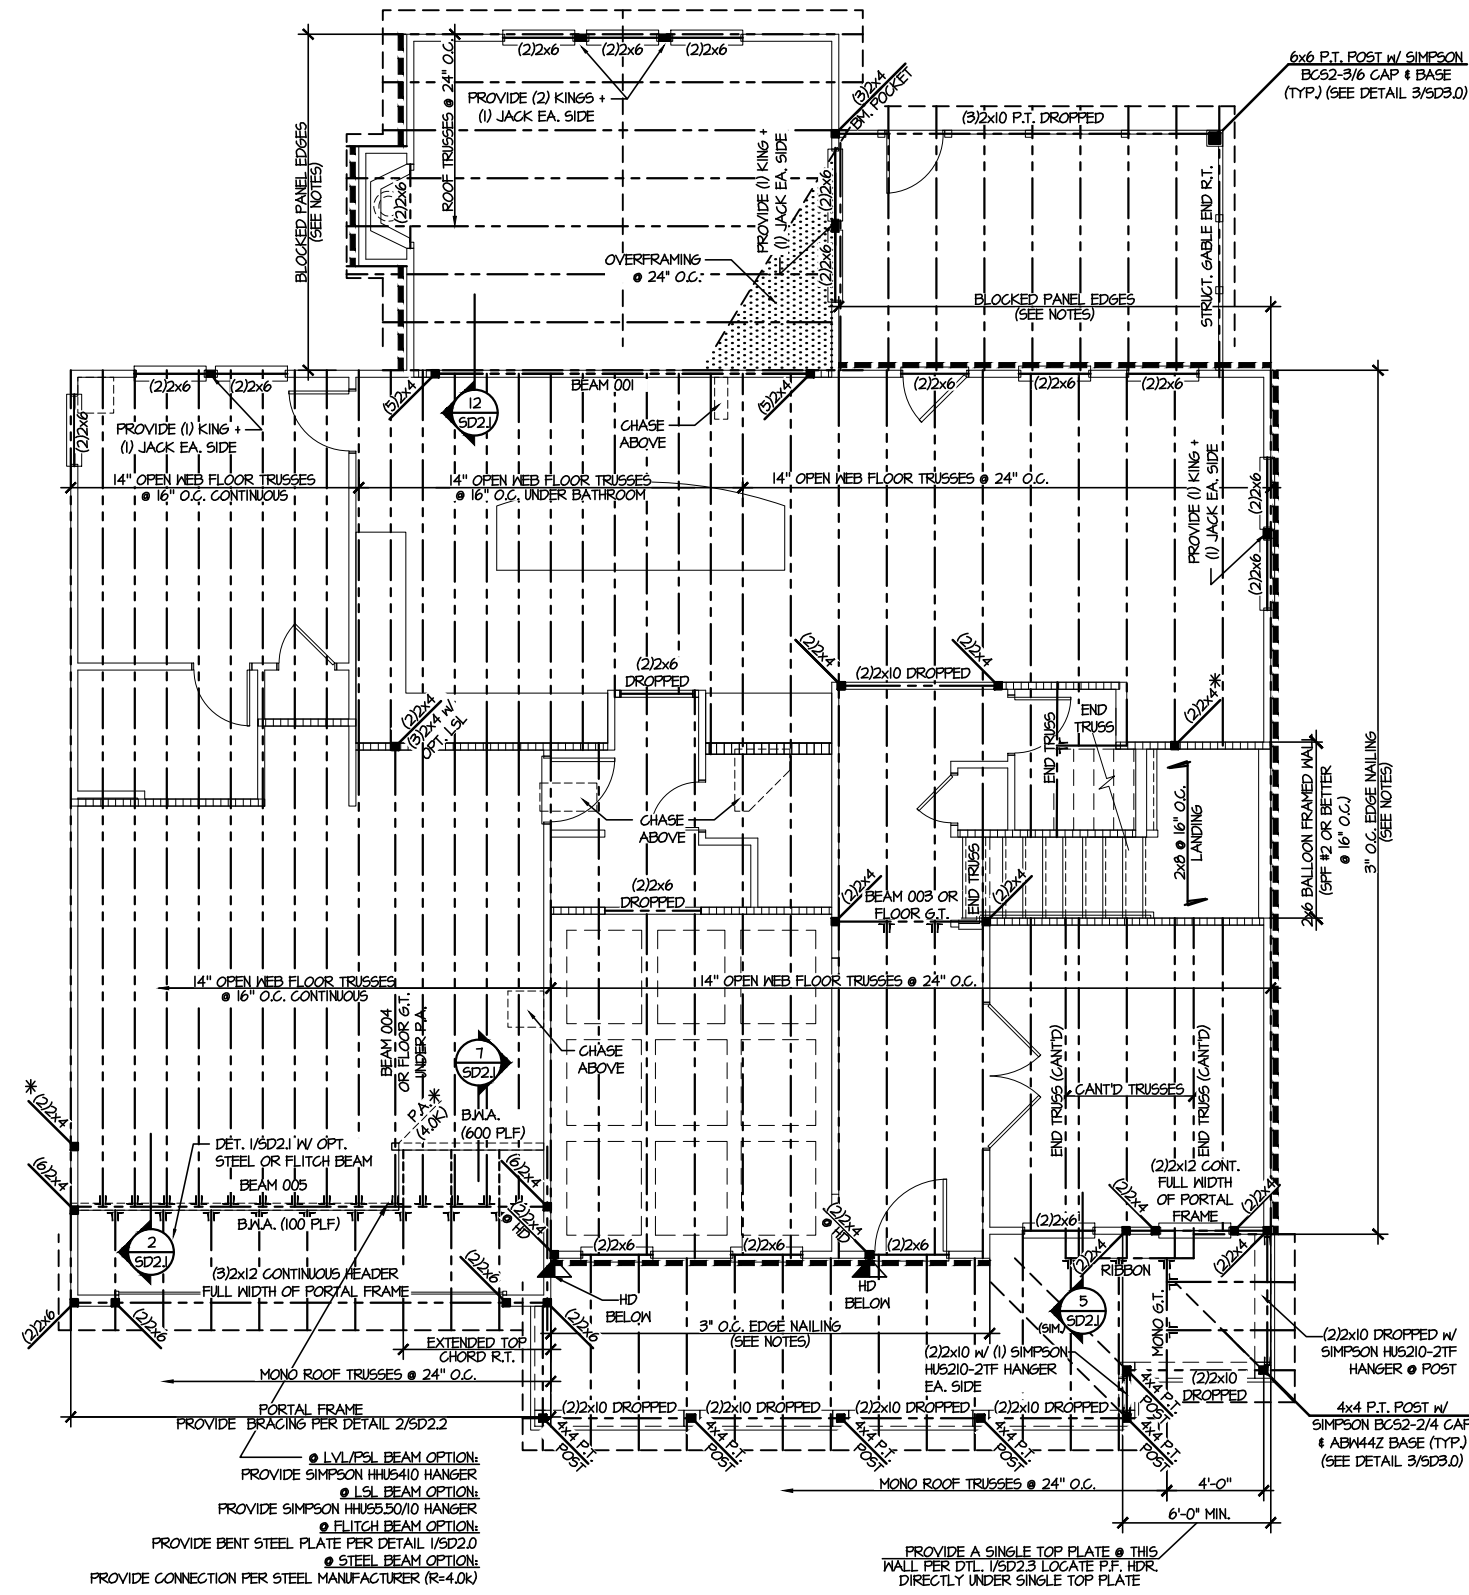- ▬ INTERIOR BEARING WALL
- ▬ BEARING WALL ABOVE
- ▬ BEAM / HEADER
- ▬ INDICATES SHEAR WALL & EXTENT
- ▬ EXTENT OF OVERFRAMING
- JL METAL HANGER
- * INDICATES POST ABOVE. PROVIDE SOLID BLOCKING UNDER POST OR JAMB ABOVE.
- ▴ INDICATES HOLD-DOWN OR STRAP. REFER TO SCHEDULE.

REFER TO 50.0 FOR TYPICAL STRUCTURAL NOTES & SCHEDULES

ENGINEERED BEAM MATERIAL SCHEDULE

BEAM NUMBER	LVL OPTION	PSL OPTION	LSL OPTION	FLITCH OPTION	STEEL OPTION
001	(2)3/4"x16" - D	3/5"x16" - D	N/A	(2)2x12 + (1) 3/8"x1/4" STEEL FLITCH PLATES - D	M12x14 - D
002	(2)3/4"x11 1/2" - D	3/5"x11 1/2" - D	(3)3/4"x11 1/2" - D	(2)2x12 + (1) 1/2"x1/4" STEEL FLITCH PLATES - D	M12x14 - D
003	(2)3/4"x14" - F	3/5"x14" - F	(2)3/4"x14" - F	(2)2x12 + (1) 1/2"x1/4" STEEL FLITCH PLATES - F	M12x14 - F
004	(2)3/4"x14" - F	3/5"x14" - F	(3)3/4"x14" - F	(2)2x12 + (1) 3/8"x1/4" STEEL FLITCH PLATES - F	M12x14 - F
005	(3)3/4"x18" - FT	3/4"x18" - FT	N/A	(3)2x12 + (2) 3/8"x1/4" STEEL FLITCH PLATES - F	M12x26 - F
006	(3)3/4"x18" - FT	3/4"x18" - FT	N/A	(3)2x12 + (2) 3/8"x1/4" STEEL FLITCH PLATES - F	M12x26 - F
007	(2)3/4"x14" - F	3/5"x14" - F	(2)3/4"x14" - F	(2)2x12 + (1) 1/2"x1/4" STEEL FLITCH PLATES - F	M12x14 - F
008	(2)3/4"x14" - F	3/5"x14" - F	(2)3/4"x14" - F	(2)2x12 + (1) 1/2"x1/4" STEEL FLITCH PLATES - F	M12x14 - F
009	(2)3/4"x9 1/2" - D	3/5"x9 1/2" - D	(2)3/4"x9 1/2" - D	(2)2x10 + (1) 1/2"x1/4" STEEL FLITCH PLATES - D	M10x12 - D
010	(2)3/4"x16" - H	3/5"x16" - H	(3)3/4"x16" - H	(3)2x12 + (2) 1/2"x1/4" STEEL FLITCH PLATES - H	N/A
011	(2)3/4"x11 1/2" - D	3/5"x11 1/2" - D	(3)3/4"x11 1/2" - D	(2)2x12 + (1) 1/2"x1/4" STEEL FLITCH PLATES - D	M12x14 - D
012	(3)3/4"x16" - D	3/4"x16" - D	(4)3/4"x16" - D	(3)2x12 + (2) 1/2"x1/4" STEEL FLITCH PLATES - D	M12x19 - D
013	(2)3/4"x11 1/2" - D	3/5"x11 1/2" - D	(3)3/4"x11 1/2" - D	(2)2x12 + (1) 1/2"x1/4" STEEL FLITCH PLATES - D	M12x14 - D
014	(2)3/4"x16" - D	3/5"x16" - D	(3)3/4"x16" - D	(3)2x12 + (2) 3/8"x1/4" STEEL FLITCH PLATES - D	M12x14 - D
015***	(3)3/4"x11 1/2" - D	N/A	(3)3/4"x11 1/2" - D	(3)2x12 + (2) 1/2"x1/4" STEEL FLITCH PLATES - D	M12x14 - D
016	(2)3/4"x11 1/2" - F	3/5"x11 1/2" - F	(3)3/4"x11 1/2" - F	(2)2x12 + (1) 1/2"x1/4" STEEL FLITCH PLATES - F	M12x14 - F

* BEAM NOTATION:
- "F" INDICATES FLUSH BEAM
- "FT" INDICATES FLUSH TOP BEAM
- "FB" INDICATES FLUSH BOTTOM BEAM
- "D" INDICATES DROPPED BEAM
- "H" INDICATES DROPPED OPENING HEADER


• REFER TO DETAIL D/5D2.0 FOR TYPICAL FLITCH BEAM CONNECTIONS
• REFER TO DETAIL E/5D2.0 FOR TYPICAL STEEL BEAM CONNECTIONS
• FOR FLUSH TOP BEAMS PROVIDE 2X STACKED PLATES BENEATH BEAM AS REQ'D. FASTEN PLATES IN SUCCESSION W/ (2) 3"x0.120" NAILS @ 8" O.C.
• FOR FLUSH BOTTOM BEAMS PROVIDE 2X STACKED PLATES ATOP BEAM AS REQ'D. FASTEN PLATES IN SUCCESSION W/ (2) 3"x0.120" NAILS @ 8" O.C.

*** - SEE PLAN FOR EXTENT OF 3-PLY BEAM

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FLOOR FRAMING PLANS
HONEYCUTT HILLS
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Sheet:
S3.0



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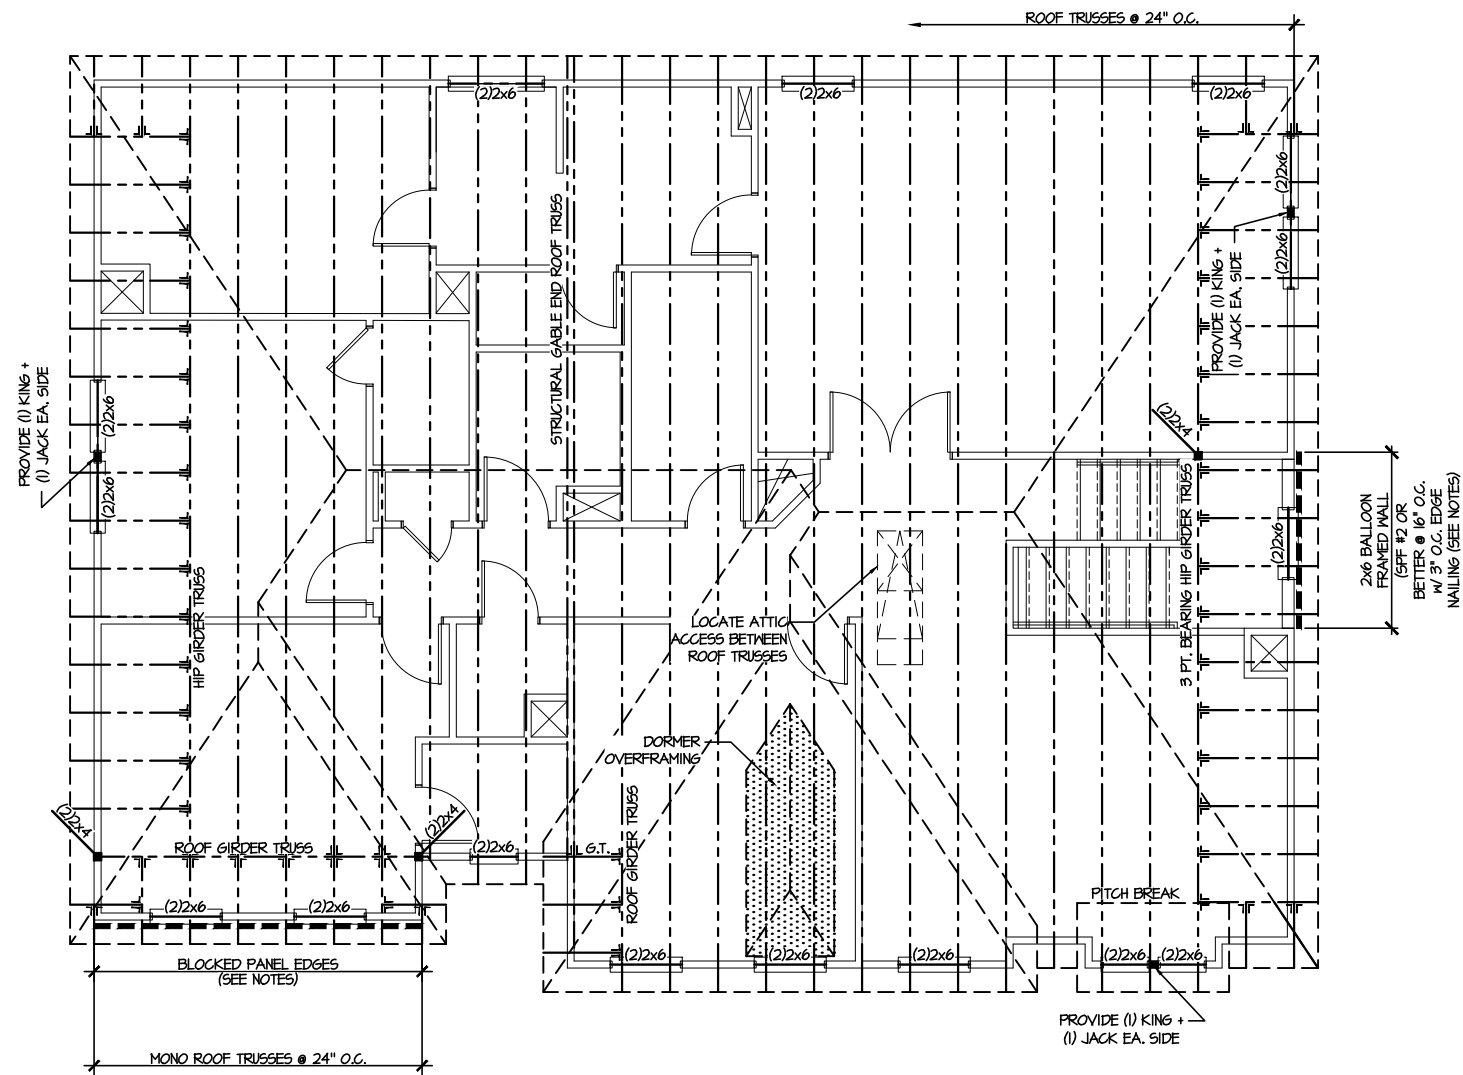
M&K project number:
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project mgr: JTR
drawn by: JAD
issue date: 08-29-24

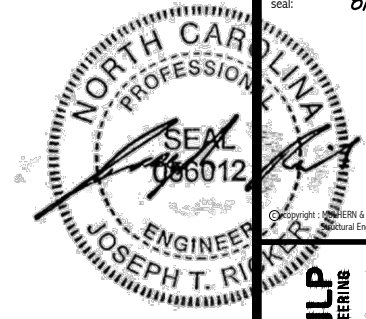REVISIONS:
date: initial:



ROOF FRAMING PLANS
HONEYCUTT HILLS
LOT 36 - STONEFIELD 7
RALEIGH, NC


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1 ROOF FRAMING PLAN
SCALE: 1/8"=1'-0"

LEGEND	
	INTERIOR BEARING WALL
	BEARING WALL ABOVE
	BEAM / HEADER
	INDICATES SHEAR WALL & EXTENT
	EXTENT OF OVERFRAMING
	JL METAL HANGER
	* INDICATES POST ABOVE. PROVIDE SOLID BLOCKING UNDER POST OR JAMB ABOVE.
	INDICATES HOLD-DOWN OR STRAP. REFER TO SCHEDULE.

REFER TO SO.0 FOR
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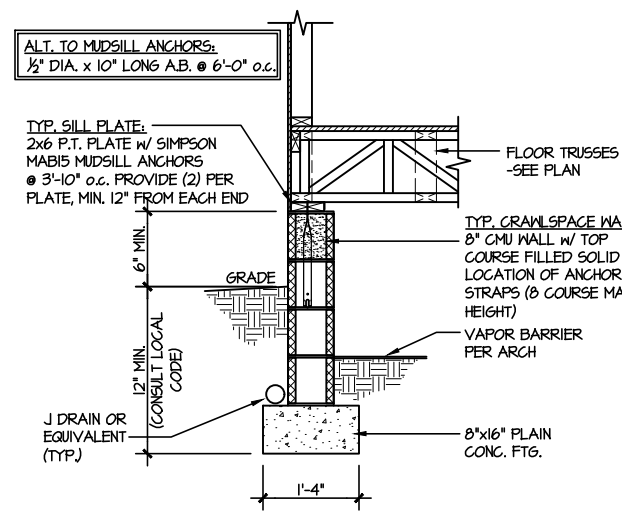
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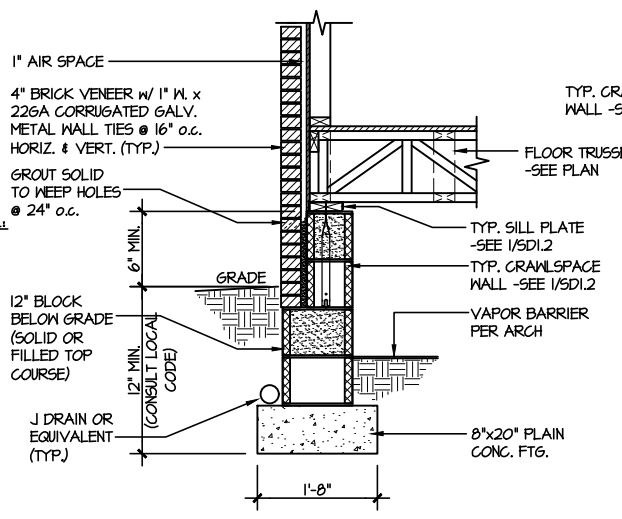
FOUNDATION DETAILS
HONEYCUTT HILLS
LOT 36 - STONEFIELD 7
RALEIGH, NC

LETTERED DETAILS ARE TYPICAL FOR THIS HOME & SHALL BE IMPLEMENTED IN ALL APPLICABLE AREAS. THESE DETAILS ARE NOT "CUT" ON THE PLANS.


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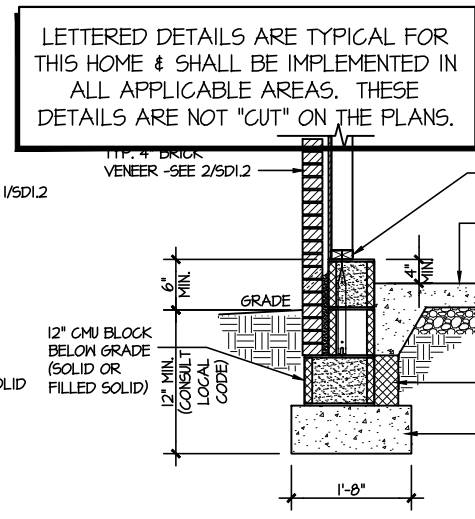
1 TYPICAL CRAWLSPACE FOUNDATION
SCALE: 3/8"=1'-0"

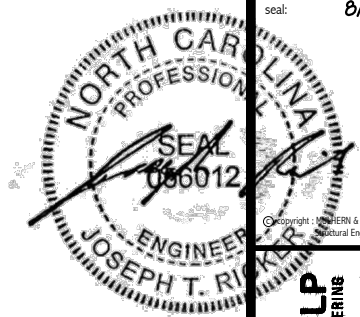


2 TYPICAL CRAWLSPACE FOUNDATION
SCALE: 3/8"=1'-0" w/ BRICK VENEER




3 TYPICAL GARAGE FOUNDATION
SCALE: 3/8"=1'-0"

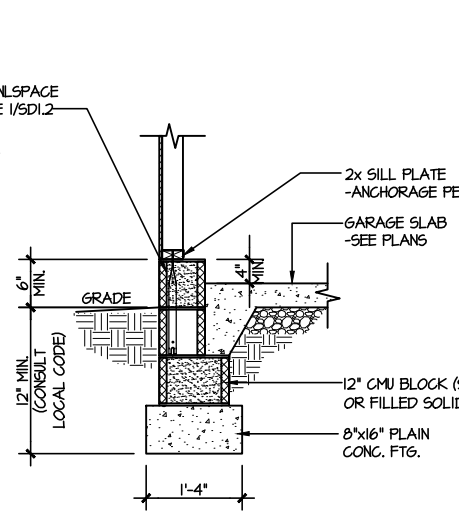


4 TYPICAL GARAGE FOUNDATION
SCALE: 3/8"=1'-0" w/ BRICK VENEER

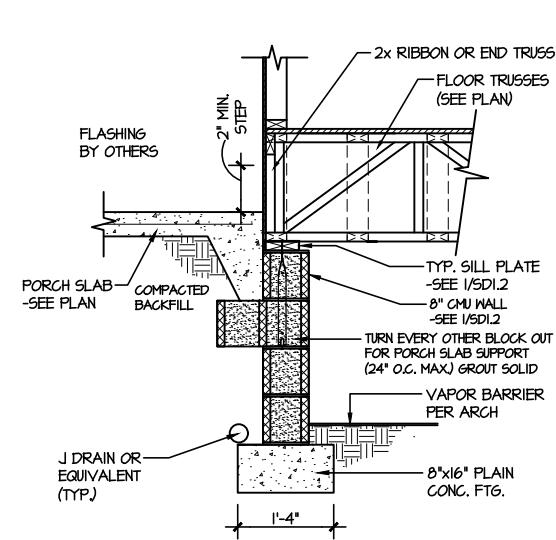


5 TYPICAL CRAWLSPACE FOUNDATION @ PORCH/PATIO SLAB
SCALE: 3/8"=1'-0"
(REFER TO DETAIL 12 FOR WOOD PORCH OPTION)

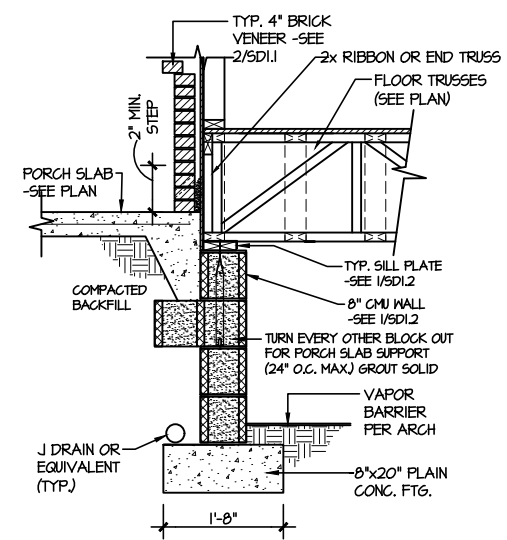


6 TYPICAL CRAWLSPACE FOUNDATION @ PORCH/PATIO SLAB
SCALE: 3/8"=1'-0" w/ BRICK VENEER

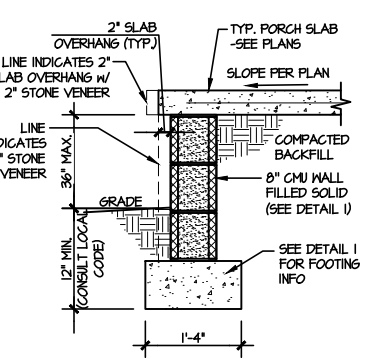


7A TYP. FOOTING @ PORCH SLAB
SCALE: 3/8"=1'-0"

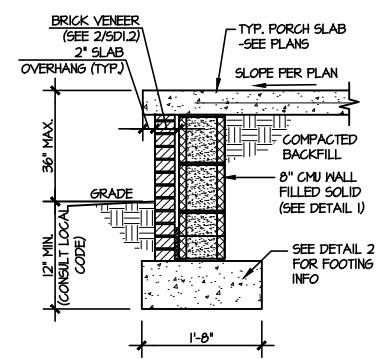


7B TYP. FOOTING @ PORCH SLAB
SCALE: 3/8"=1'-0" w/ BRICK VENEER

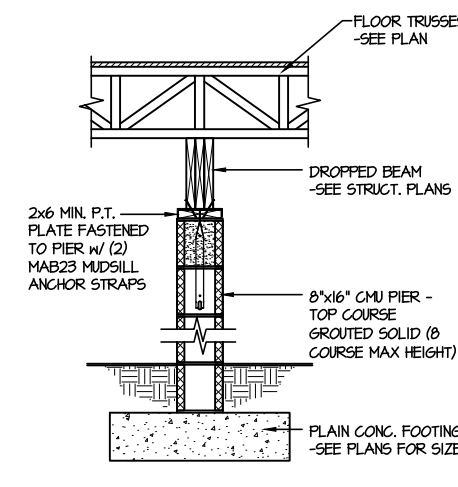


8 TYPICAL CRAWLSPACE FND. @ INTERIOR PIER
SCALE: 3/8"=1'-0"

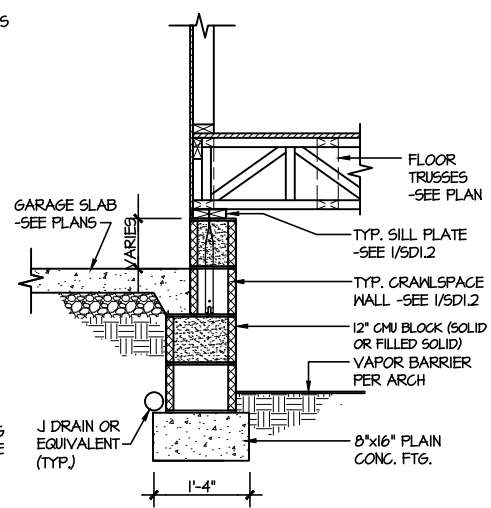


9 TYPICAL CRAWLSPACE FOUNDATION @ GARAGE
SCALE: 3/8"=1'-0"

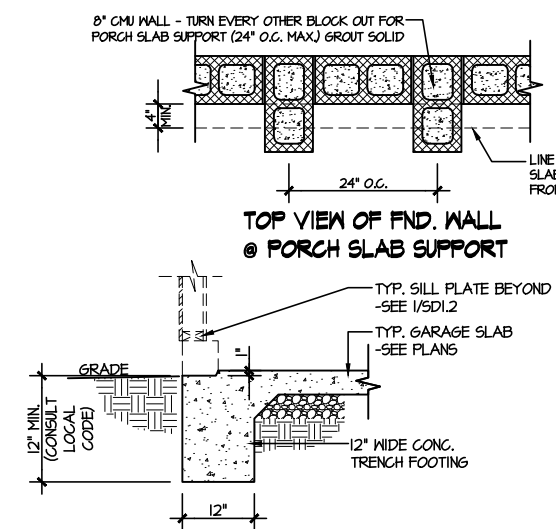


10 TYPICAL SLAB ON GRADE GARAGE ENTRY @ PERIMETER FOOTING
SCALE: 3/8"=1'-0"

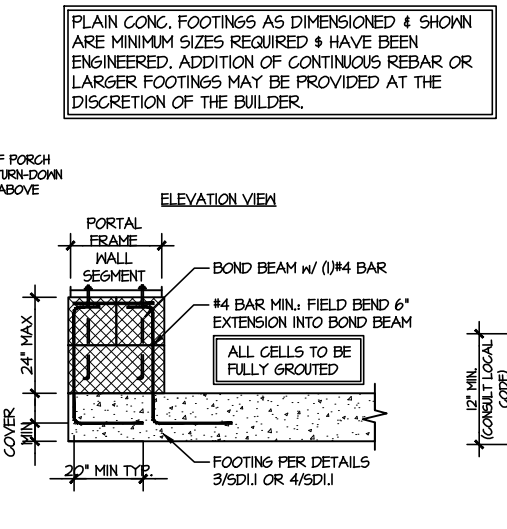


A GARAGE PORTAL FRAME STEM WALL REINFORCEMENT
SCALE: 3/8"=1'-0"

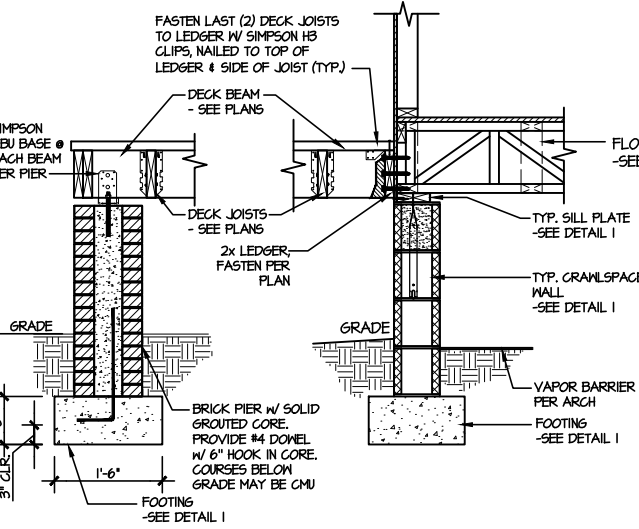

11 TYPICAL CRAWLSPACE FOUNDATION @ WOOD PORCH/DECK w/ PIERS
SCALE: 3/8"=1'-0"

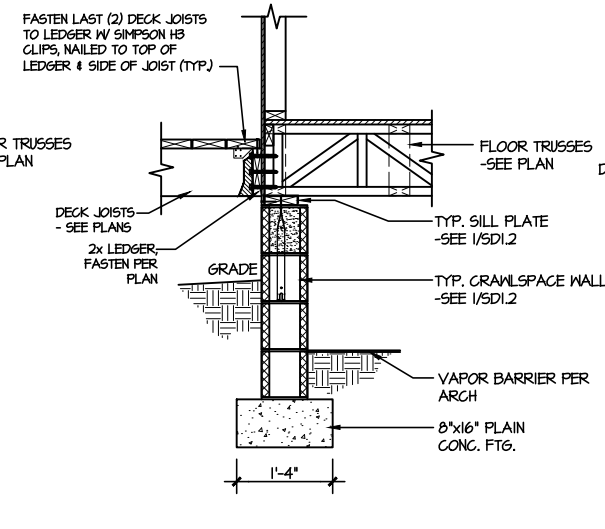


12 TYPICAL CRAWLSPACE FOUNDATION @ WOOD PORCH/DECK
SCALE: 3/8"=1'-0"

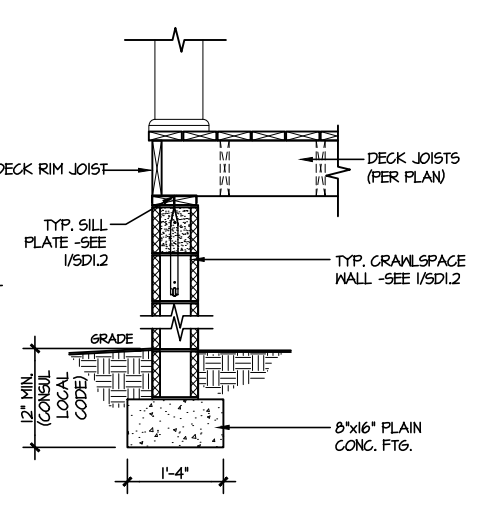

13 TYPICAL CRAWLSPACE FOUNDATION @ WOOD PORCH/DECK PERIMETER
SCALE: 3/8"=1'-0"

FILE: RLH - Honeycutt Hills - Lot 36 - Structural DATE: 8/29/2024 1:40 PM

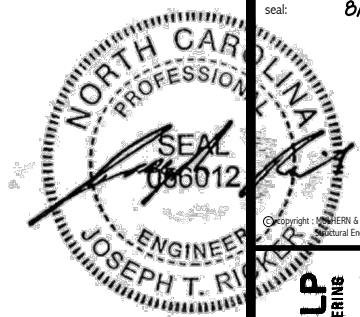

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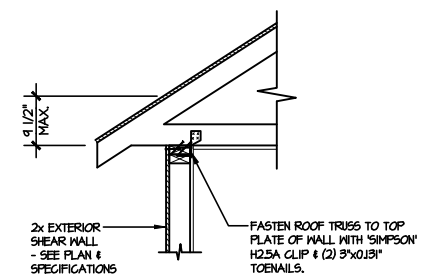
project mgr: **JTR**
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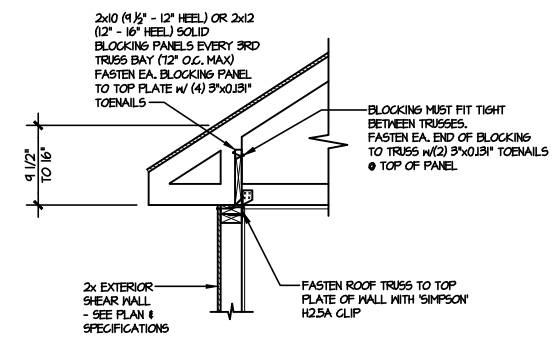
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FRAMING DETAILS
HONEYCUTT HILLS
LOT 36 - STONEFIELD 7
RALEIGH, NC


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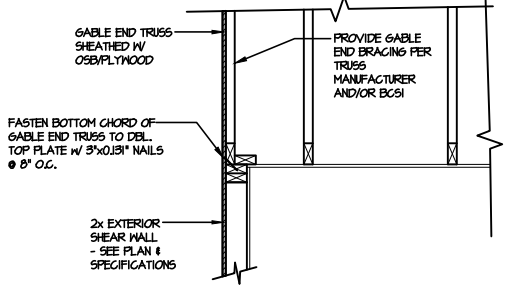
A1 TYPICAL SHEAR TRANSFER DETAIL @ ROOF
SCALE: 3/8"=1'-0"
HEEL HEIGHT LESS THAN 4 1/2"
NO BLOCKING REQ'D




A2 TYPICAL SHEAR TRANSFER DETAIL @ ROOF
SCALE: 3/8"=1'-0"
HEEL HEIGHT BETWEEN 4 1/2" - 16"
BLOCKING REQ'D




A3 TYPICAL SHEAR TRANSFER DETAIL @ RAISED HEEL TRUSS
SCALE: 3/8"=1'-0"
HEEL HEIGHT UP TO 48" MAX.

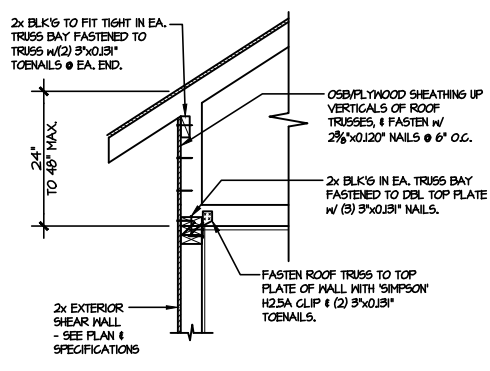


B TYPICAL GABLE END DETAIL
SCALE: 3/8"=1'-0"

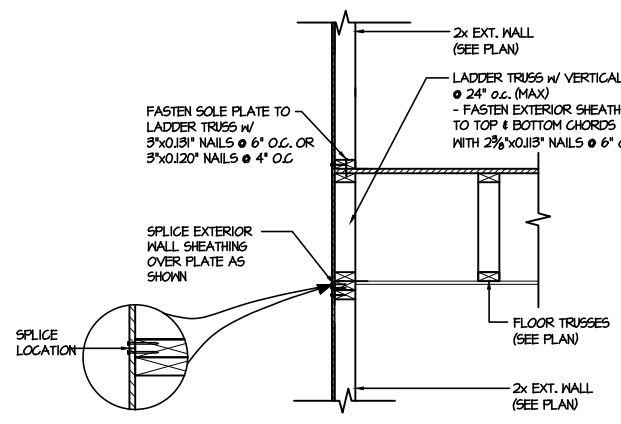


C1 TYPICAL SHEAR TRANSFER DETAIL BETWEEN FLOORS @ EXTERIOR WALL
SCALE: 3/8"=1'-0"
PARALLEL FRMS

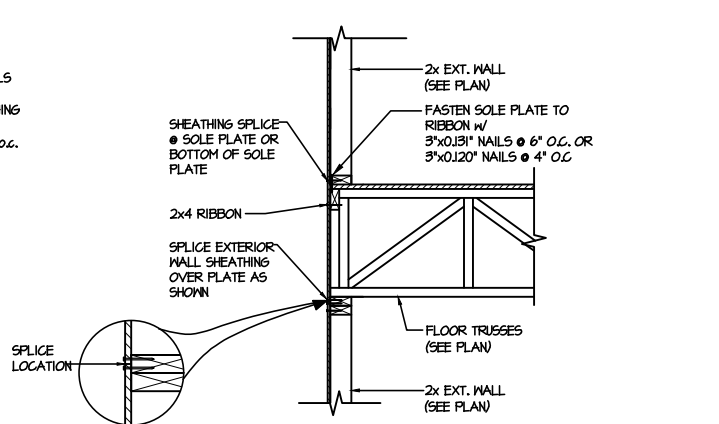


C2 TYPICAL SHEAR TRANSFER DETAIL BETWEEN FLOORS @ EXTERIOR WALL
SCALE: 3/8"=1'-0"
PERPENDICULAR FRMS

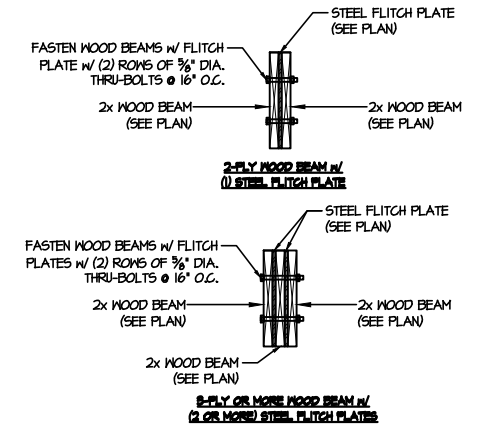


D TYPICAL FLITCH BEAM CONNECTION DETAIL
SCALE: 3/4"=1'-0"

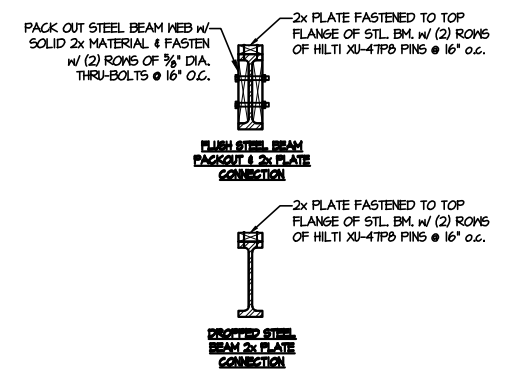

E TYPICAL STEEL BEAM CONNECTION DETAIL
SCALE: 3/4"=1'-0"

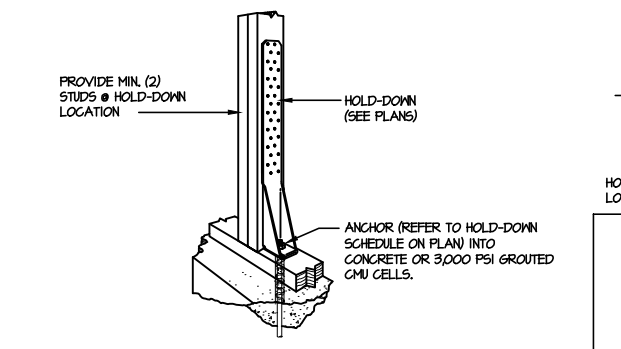


F1 TYPICAL HOLD DOWN INSTALLATION
SCALE: N.T.S.

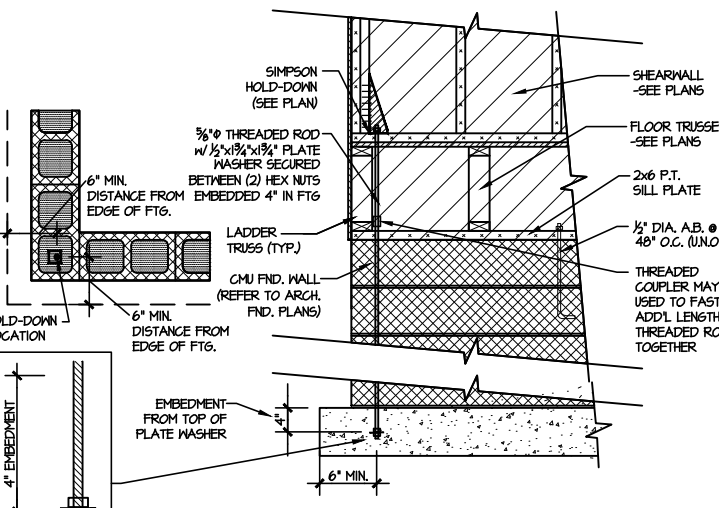

F2 TYPICAL CMU FOUNDATION HOLD-DOWN INSTALLATION
SCALE: N.T.S. (CORNER SHOWN - APPLICABLE TO ALL CONDITIONS)

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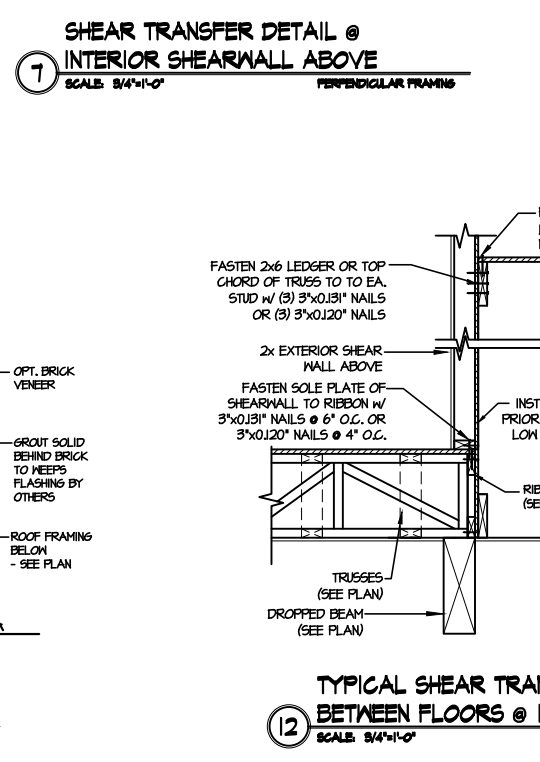
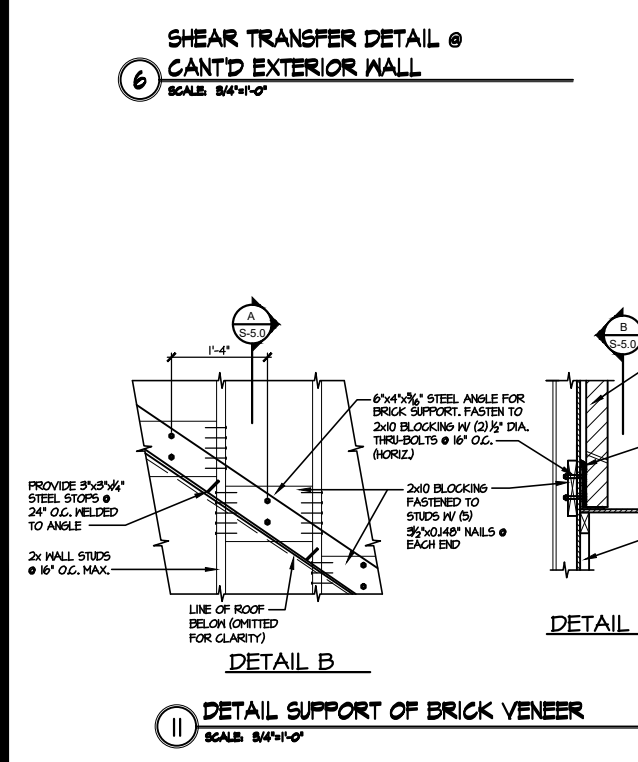
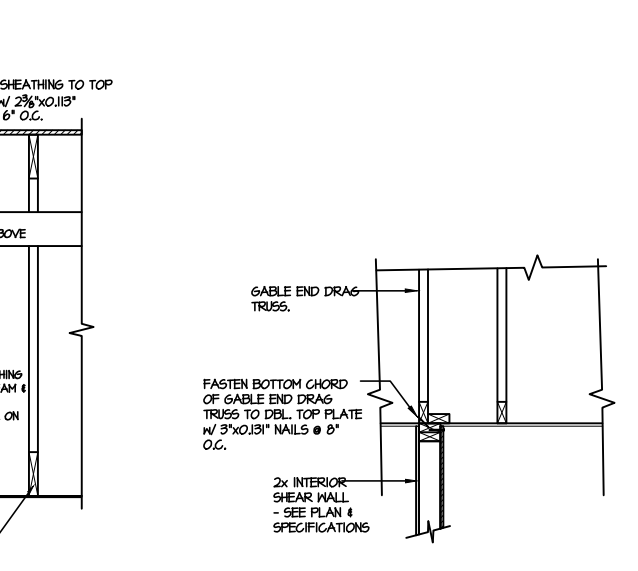
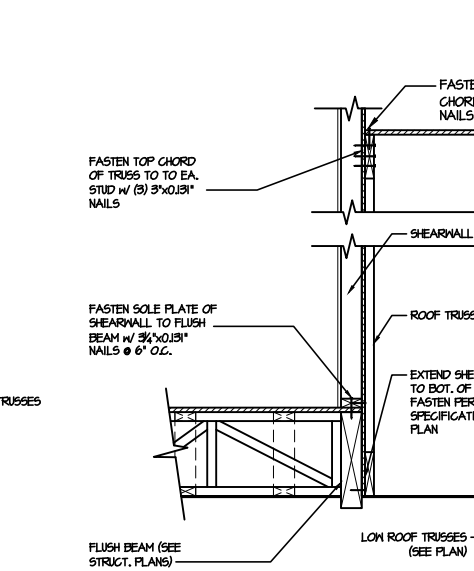
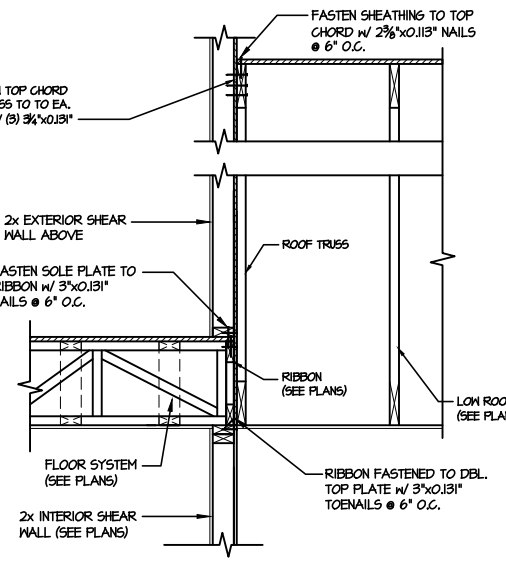
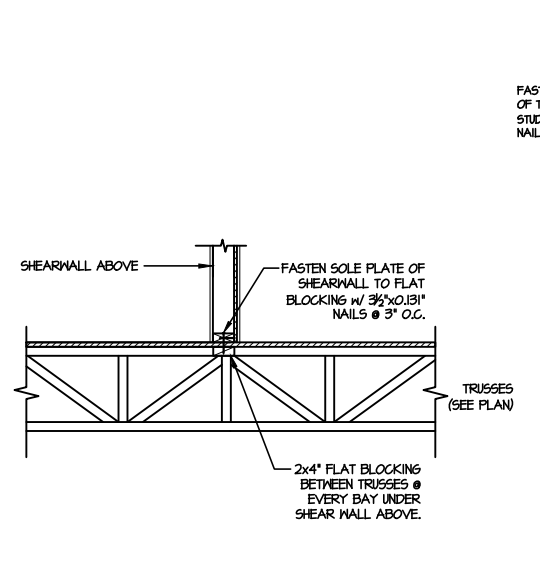
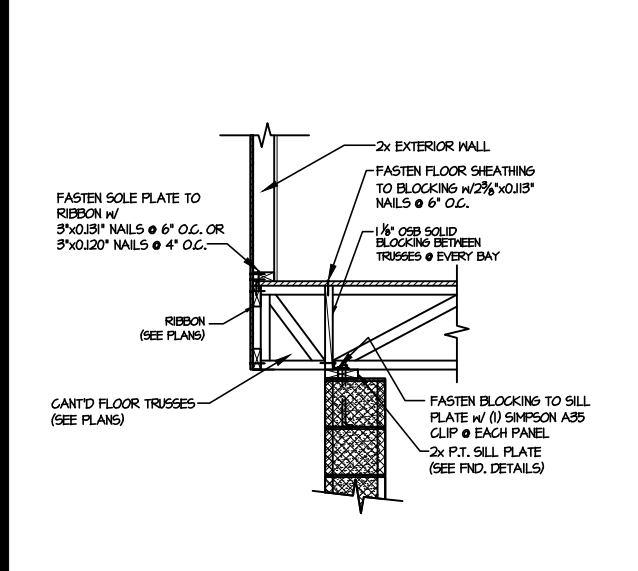
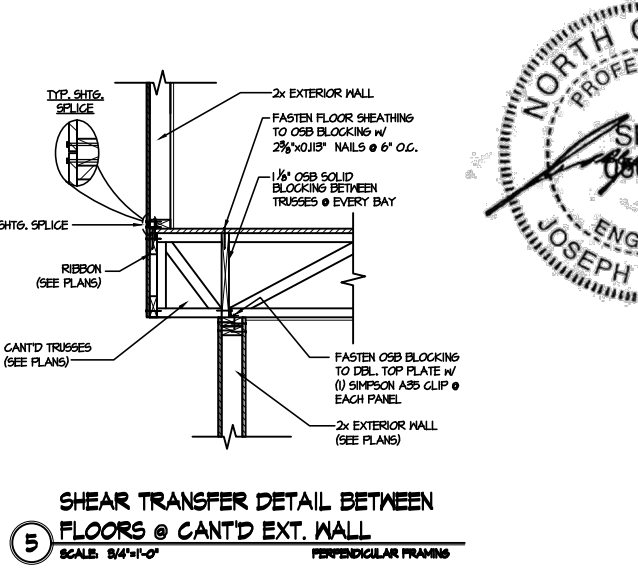
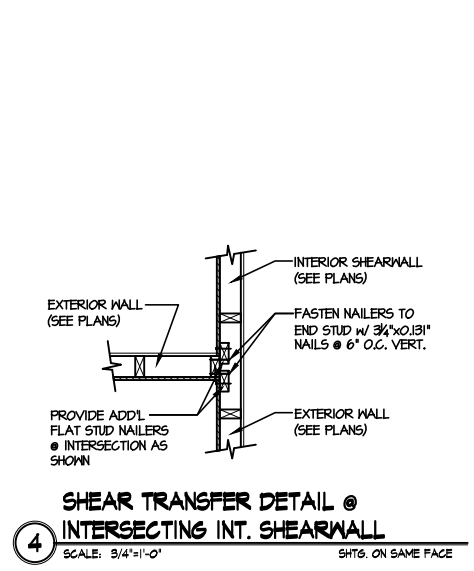
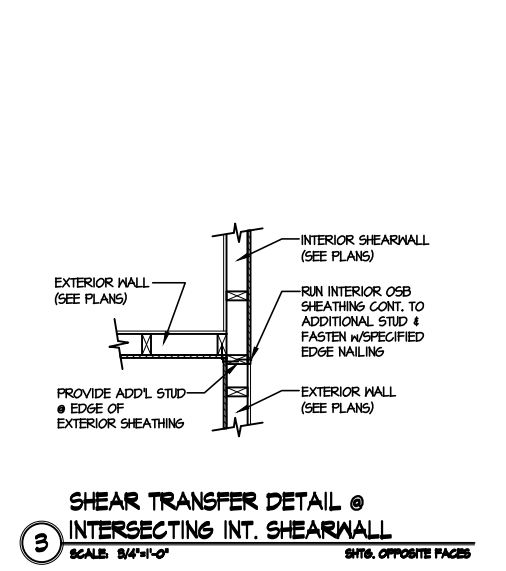
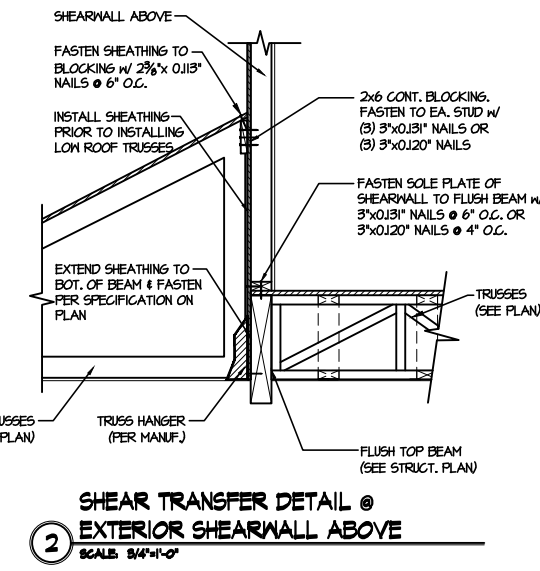
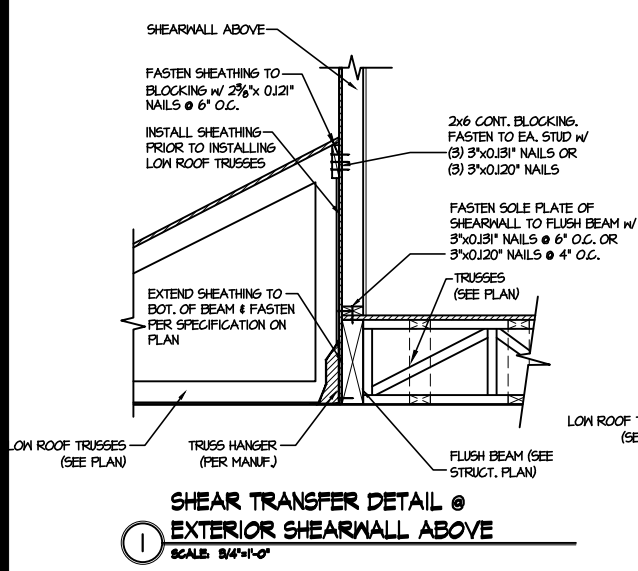



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FRAMING DETAILS
HONEYCUTT HILLS
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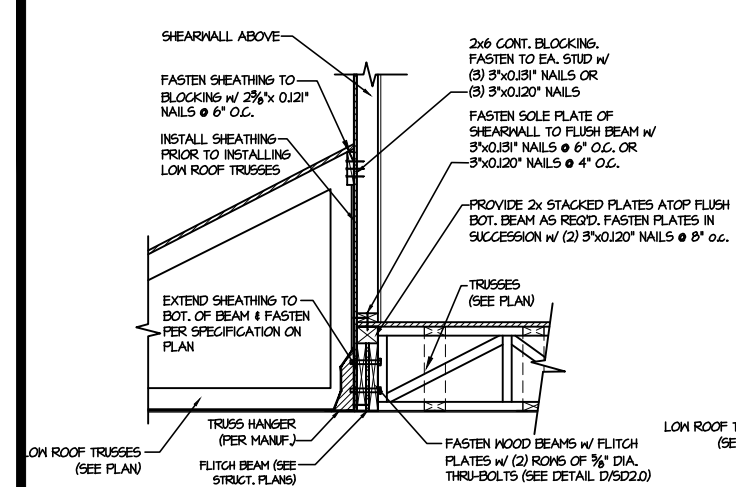
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N.C. LIC. #C-3825

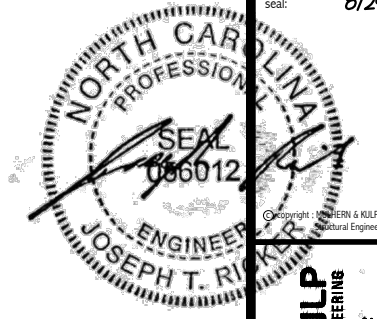M&K project number:
126-23047
project mgr: JTR
drawn by: JAD
issue date: 08-29-24


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date: initial:




FRAMING DETAILS
HONEYCUTT HILLS
LOT 36 - STONEFIELD 7
RALEIGH, NC

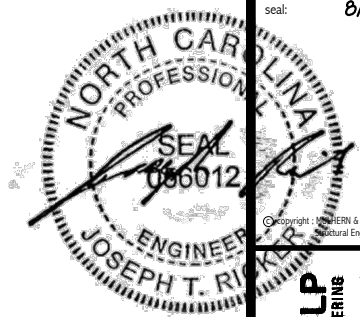


1 SHEAR TRANSFER DETAIL @ EXTERIOR SHEARWALL ABOVE
SCALE: 3/4"=1'-0"

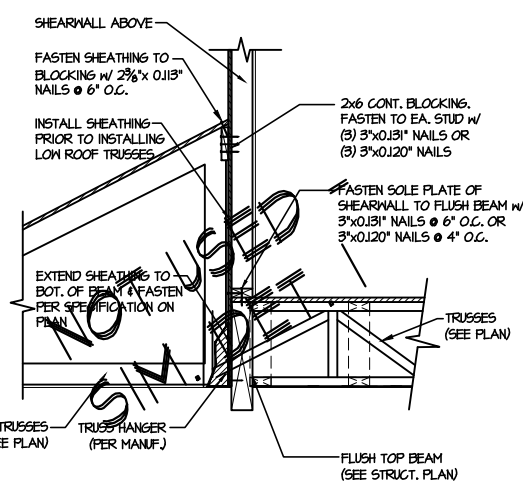


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SCALE: 3/4"=1'-0"

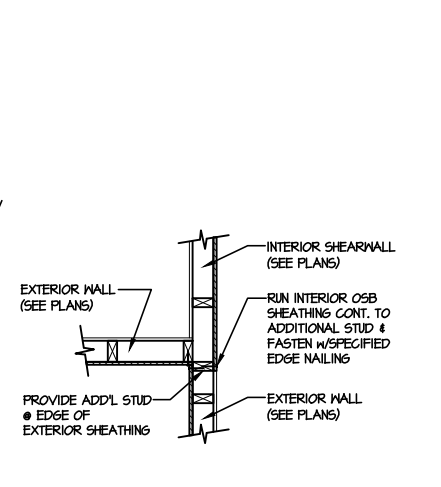


3 SHEAR TRANSFER DETAIL @ INTERSECTING INT. SHEARWALL
SCALE: 3/4"=1'-0" SHTS. OPPOSITE FACES

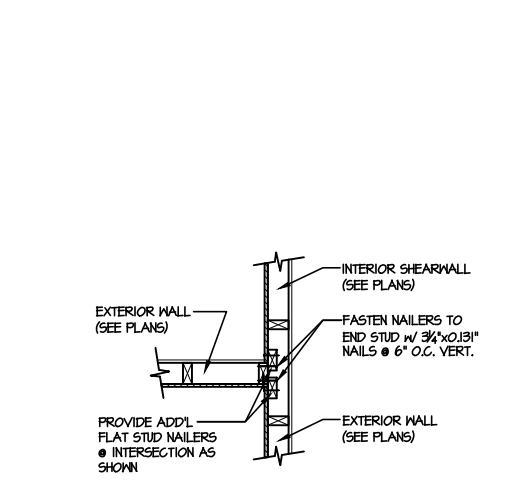


4 SHEAR TRANSFER DETAIL @ INTERSECTING INT. SHEARWALL
SCALE: 3/4"=1'-0" SHTS. ON SAME FACE

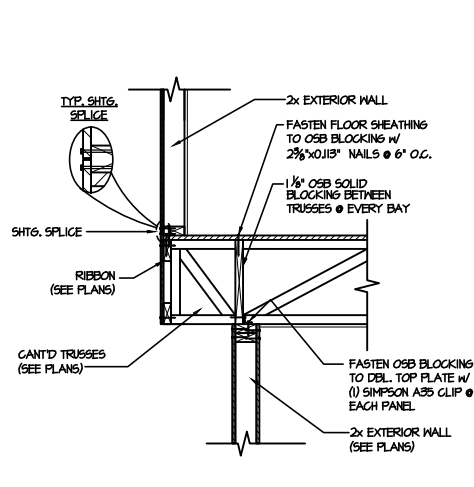


5 SHEAR TRANSFER DETAIL BETWEEN FLOORS @ CANT'D EXT. WALL
SCALE: 3/4"=1'-0" PERPENDICULAR FRAMING

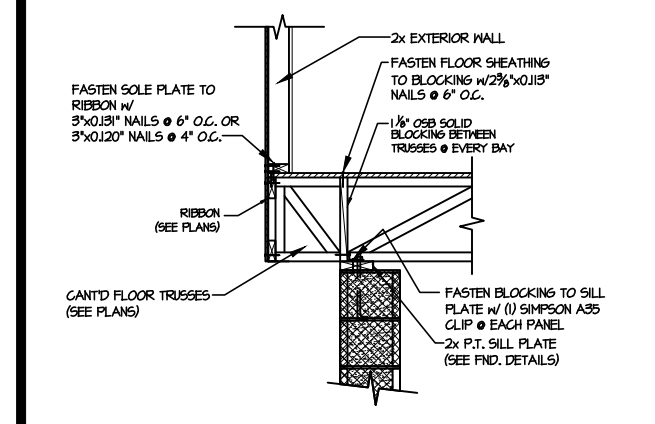


6 SHEAR TRANSFER DETAIL @ CANT'D EXTERIOR WALL
SCALE: 3/4"=1'-0"

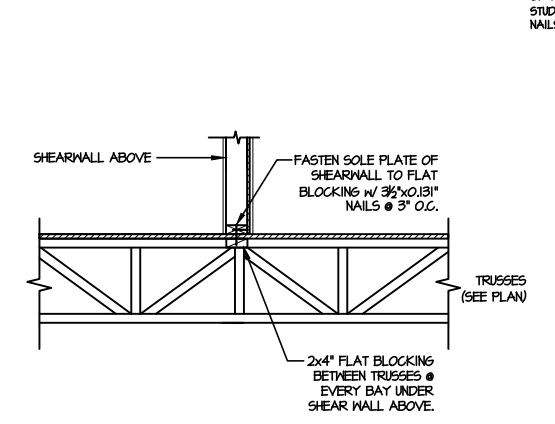


7 SHEAR TRANSFER DETAIL @ INTERIOR SHEARWALL ABOVE
SCALE: 3/4"=1'-0" PERPENDICULAR FRAMING

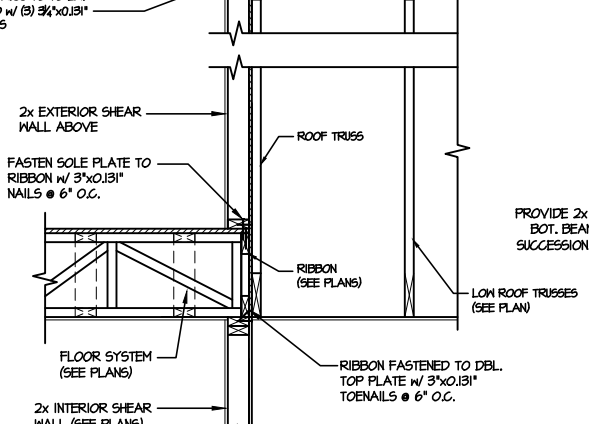


8 TYPICAL SHEAR TRANSFER DETAIL BETWEEN FLOORS @ INTERIOR WALL
SCALE: 3/4"=1'-0"

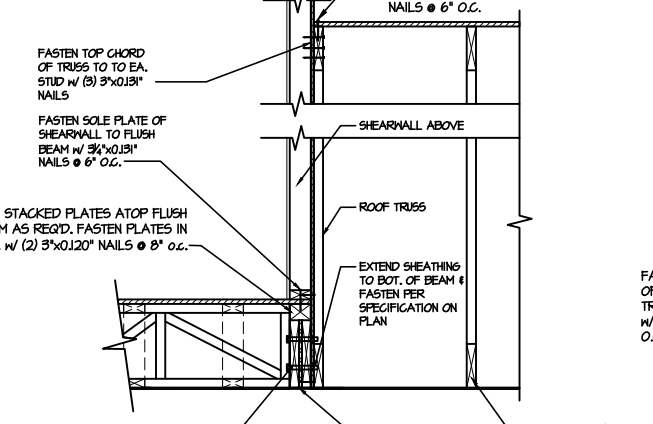


9 SHEAR TRANSFER DETAIL @ EXTERIOR SHEARWALL ABOVE
SCALE: 3/4"=1'-0"

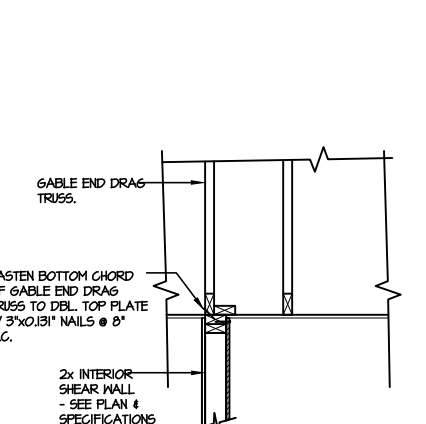


10 INTERIOR GABLE END DETAIL
SCALE: 3/4"=1'-0"

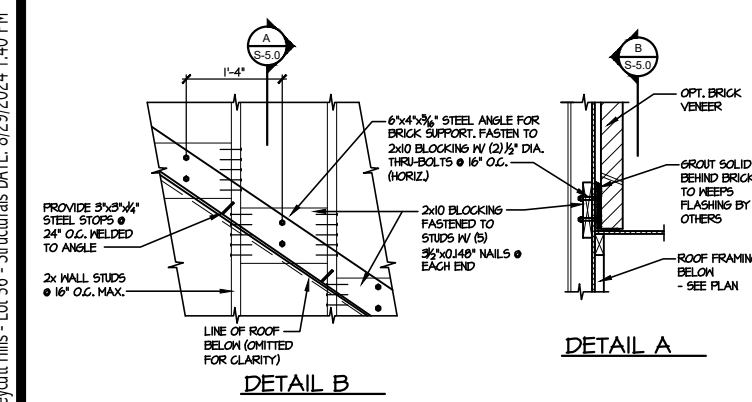


11 DETAIL SUPPORT OF BRICK VENEER
SCALE: 3/4"=1'-0"

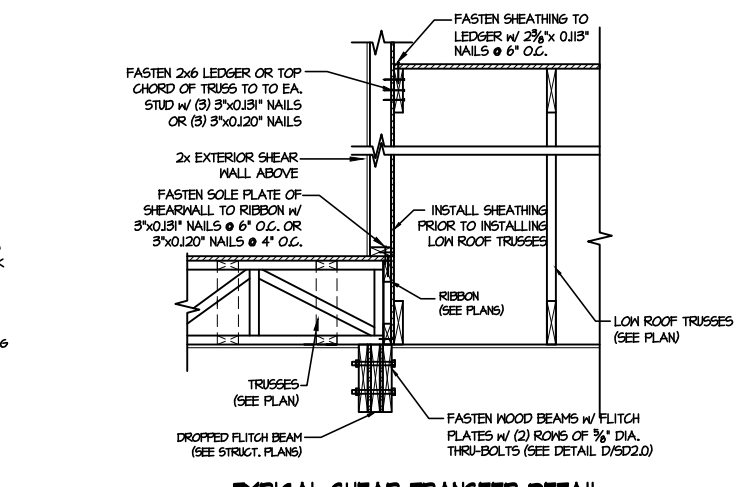

12 TYPICAL SHEAR TRANSFER DETAIL BETWEEN FLOORS @ INTERIOR WALL
SCALE: 3/4"=1'-0"

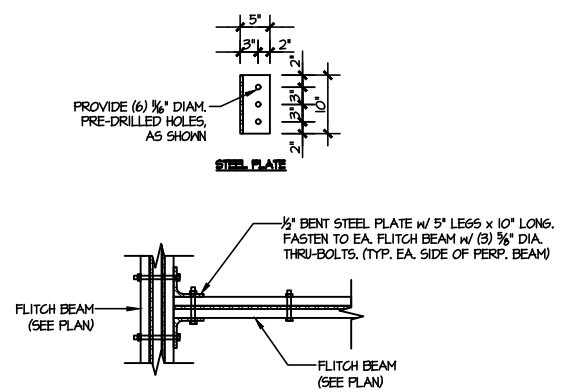

13 TYPICAL FLITCH BEAM TO FLITCH BEAM CONNECTION DETAIL
SCALE: 3/4"=1'-0"

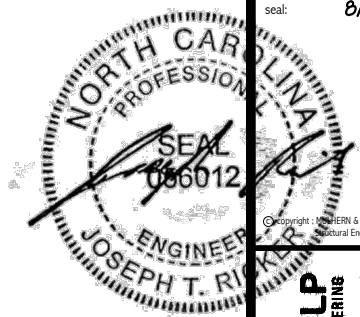

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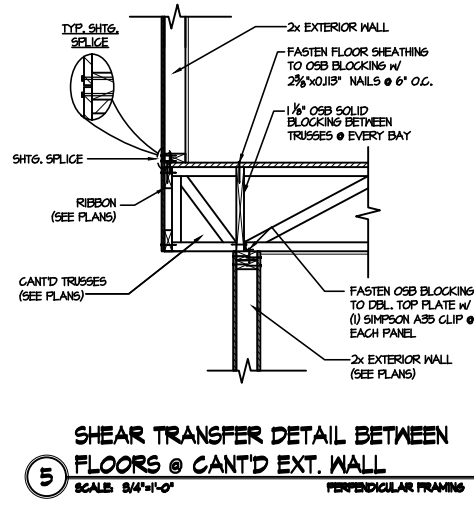
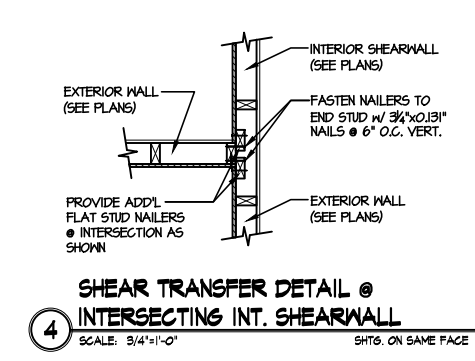
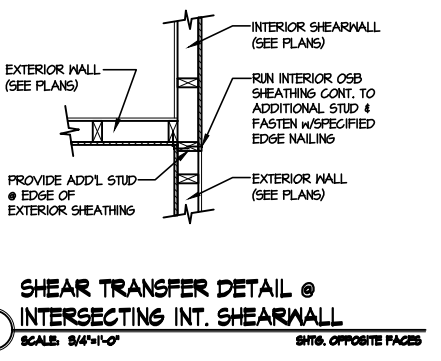
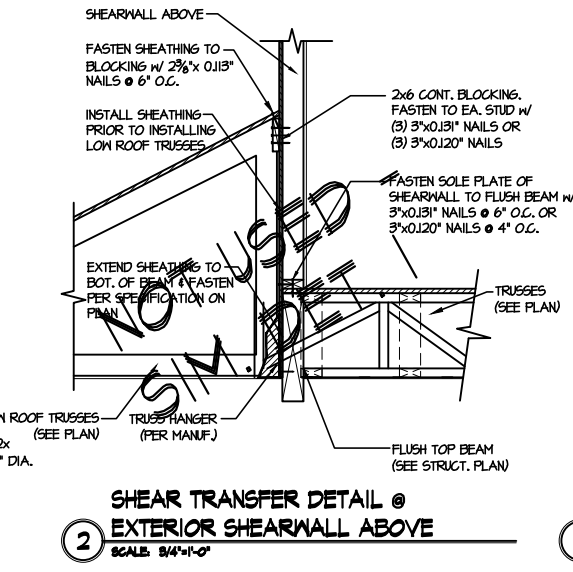
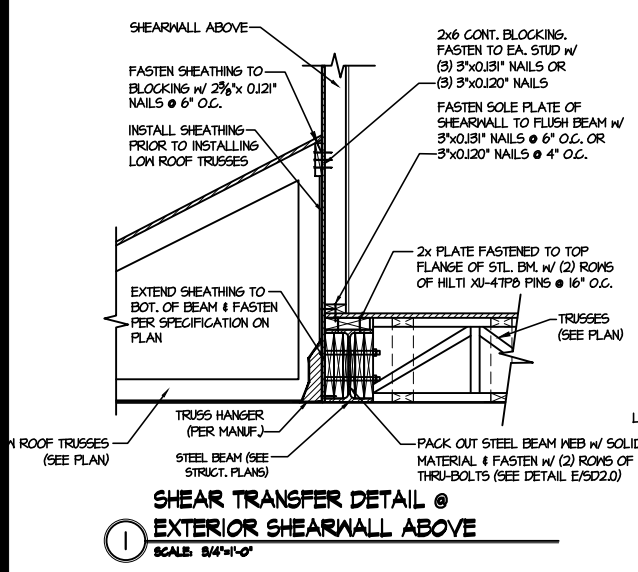
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126-23047
project mgr: JTR
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issue date: 08-29-24

REVISIONS:
date: initial:

DRB
HOMES

FRAMING DETAILS
HONEYCUTT HILLS
LOT 36 - STONEFIELD 7
RALEIGH, NC

sheet:
SD2.1C








1 SHEAR TRANSFER DETAIL @ EXTERIOR SHEARWALL ABOVE
SCALE: 3/4"=1'-0"

2 SHEAR TRANSFER DETAIL @ EXTERIOR SHEARWALL ABOVE
SCALE: 3/4"=1'-0"

3 SHEAR TRANSFER DETAIL @ INTERSECTING INT. SHEARWALL
SCALE: 3/4"=1'-0" SHTS. OPPOSITE PAGES

4 SHEAR TRANSFER DETAIL @ INTERSECTING INT. SHEARWALL
SCALE: 3/4"=1'-0" SHTS. ON SAME FACE

5 SHEAR TRANSFER DETAIL BETWEEN FLOORS @ CANT'D EXT. WALL
SCALE: 3/4"=1'-0" PERPENDICULAR FRAMING

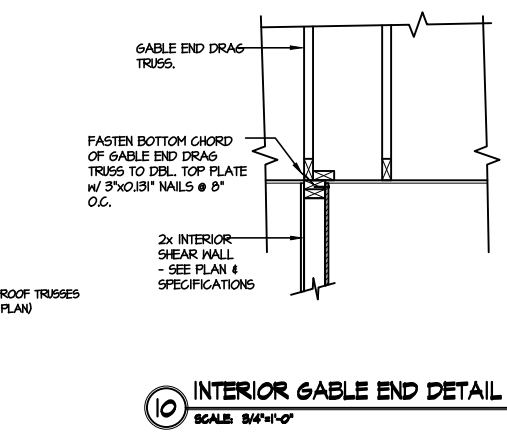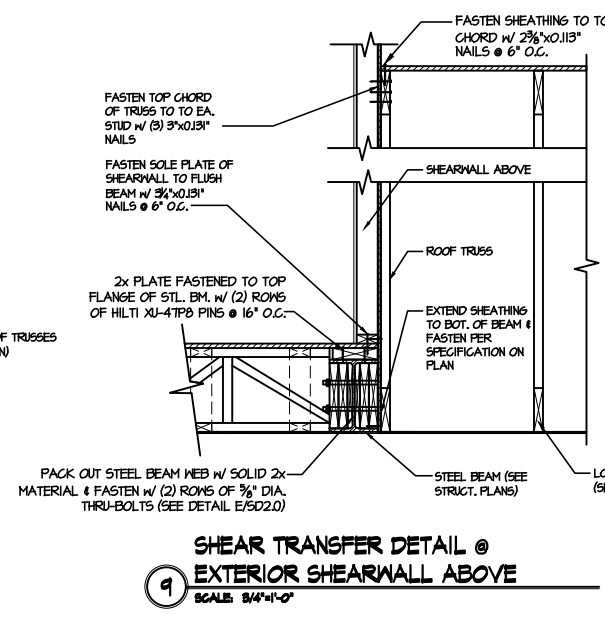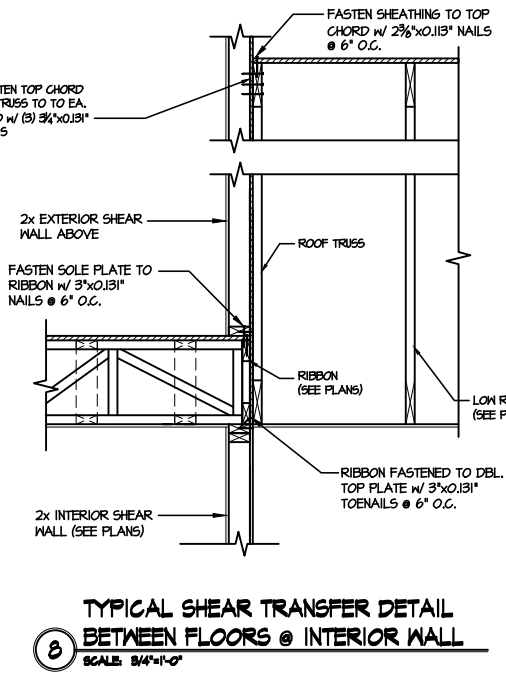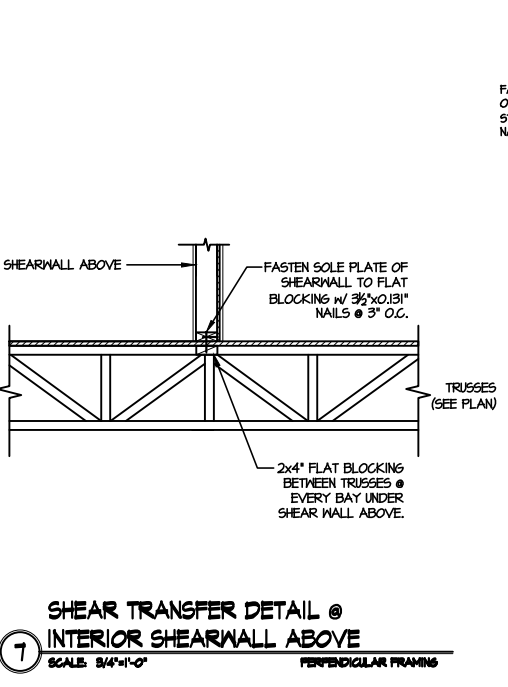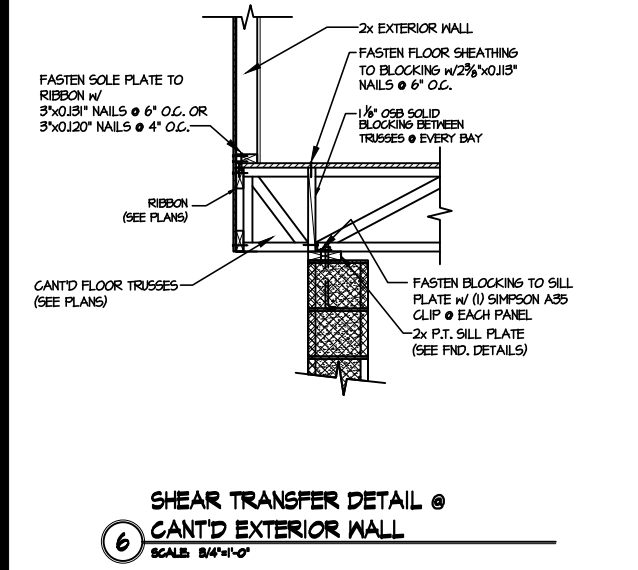



6 SHEAR TRANSFER DETAIL @ CANT'D EXTERIOR WALL
SCALE: 3/4"=1'-0"

7 SHEAR TRANSFER DETAIL @ INTERIOR SHEARWALL ABOVE
SCALE: 3/4"=1'-0" PERPENDICULAR FRAMING

8 TYPICAL SHEAR TRANSFER DETAIL BETWEEN FLOORS @ INTERIOR WALL
SCALE: 3/4"=1'-0"


9 SHEAR TRANSFER DETAIL @ EXTERIOR SHEARWALL ABOVE
SCALE: 3/4"=1'-0"

10 INTERIOR GABLE END DETAIL
SCALE: 3/4"=1'-0"

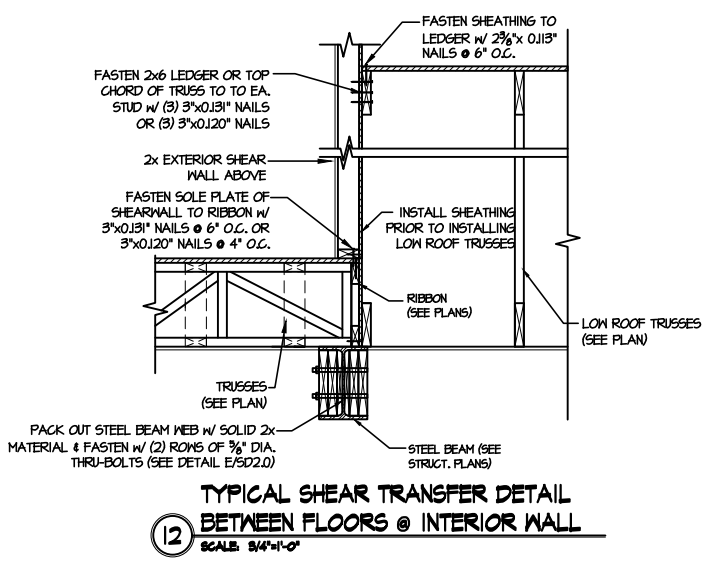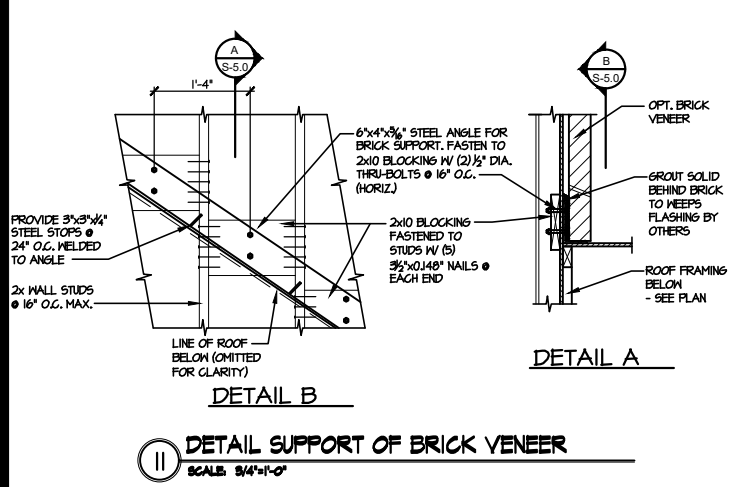

11 DETAIL SUPPORT OF BRICK VENEER
SCALE: 3/4"=1'-0"

12 TYPICAL SHEAR TRANSFER DETAIL BETWEEN FLOORS @ INTERIOR WALL
SCALE: 3/4"=1'-0"

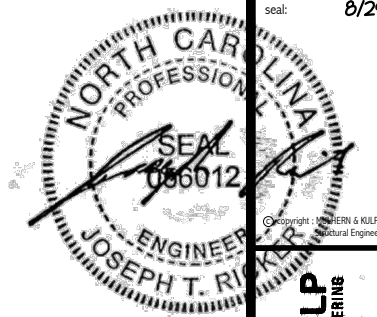



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3803 Beardslee Ave., Building 4 - Asheville, PA 19802
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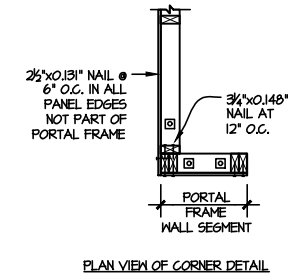
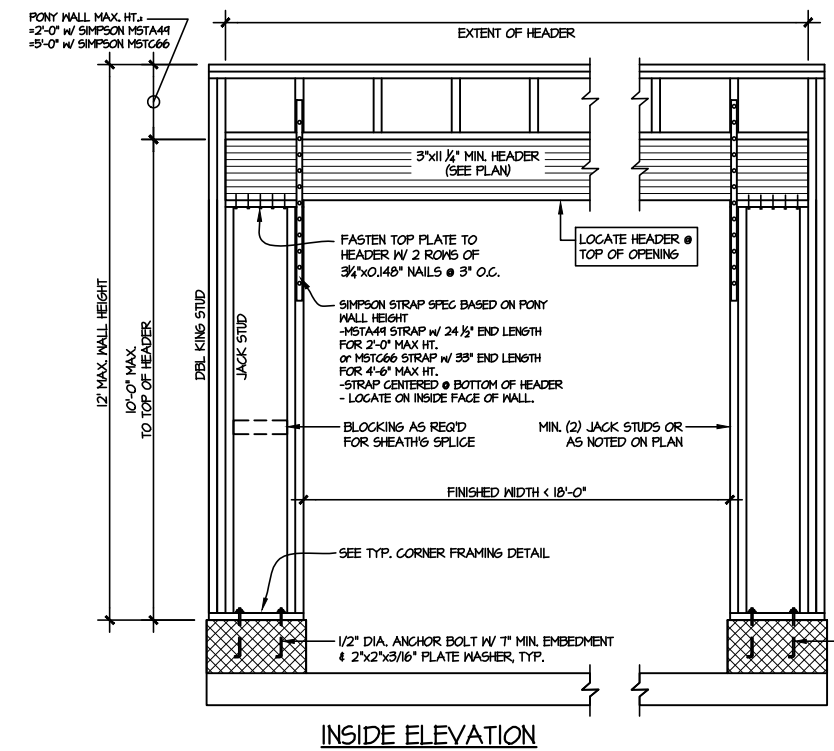
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FRAMING DETAILS
HONEYCUTT HILLS
LOT 36 - STONEFIELD 7
RALEIGH, NC




NOTE: ALL SHEATHABLE AREAS OF EXTERIOR WALL SHALL BE FULLY SHEATHED WITH 1/2" PLYWOOD OR 3/4" OSB



ALTERNATIVE TO 1/2" DIA. ANCHOR BOLT:
1/2" DIA. THREADED ROD EPOXY SET
w/ 4 1/2" EMBED. (MIN UTILIZING HILTI HY200 EPOXY ANCHORING SYSTEM (OR EQUAL))

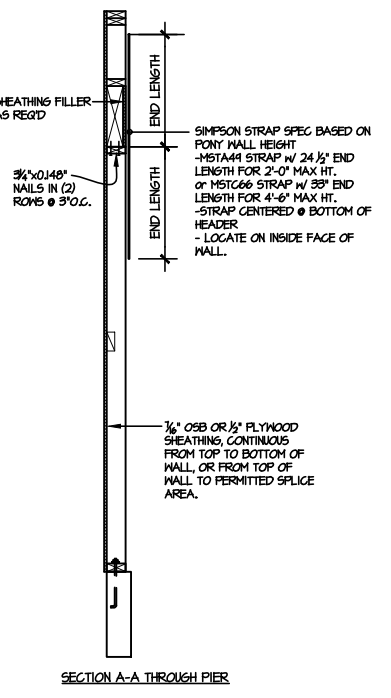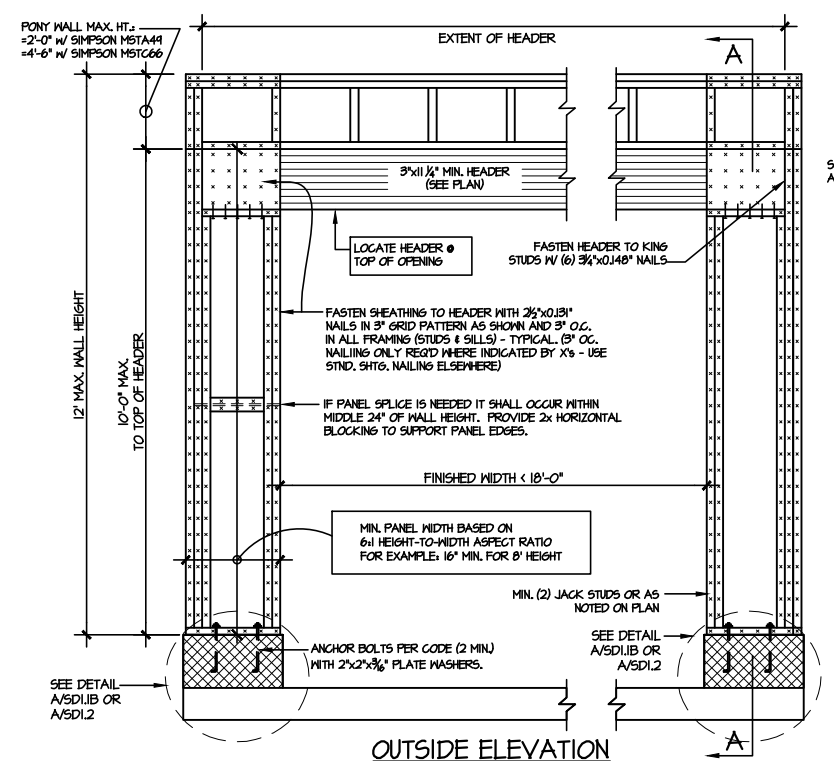② TWO SIDED GARAGE PORTAL FRAME BRACING ELEVATION ON CMU STEM
SCALE: N.T.S.

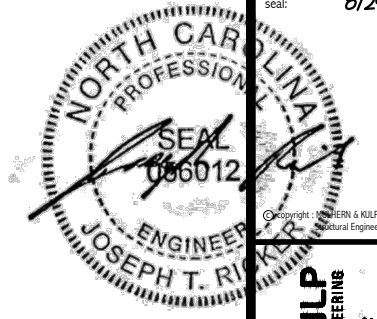

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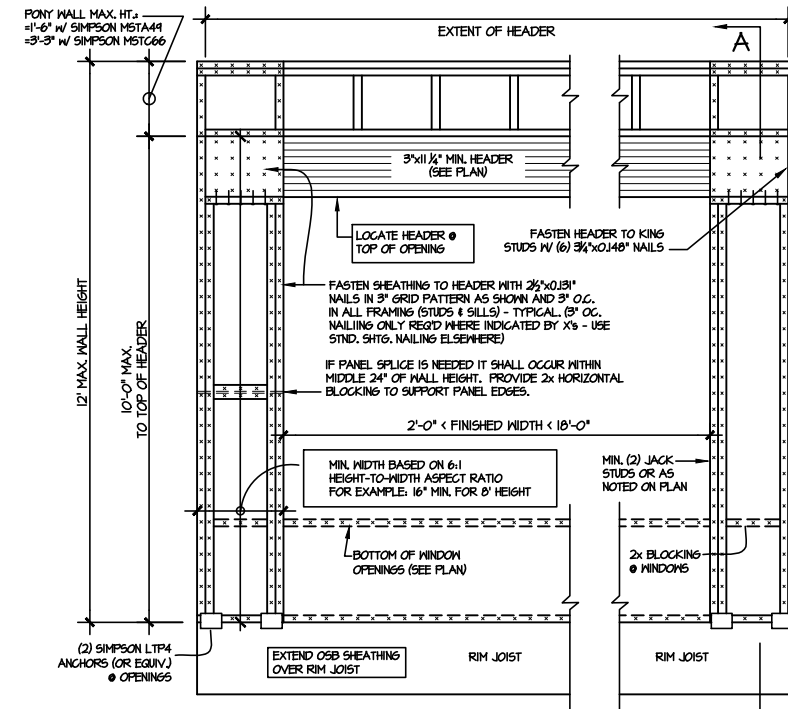
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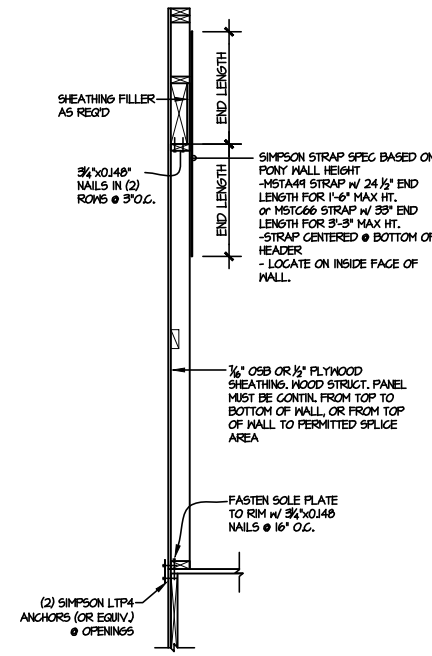
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HOMES

FRAMING DETAILS
HONEYCUTT HILLS
LOT 36 - STONEFIELD 7
RALEIGH, NC


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SD2.3



OUTSIDE ELEVATION




SECTION A-A THROUGH PIER

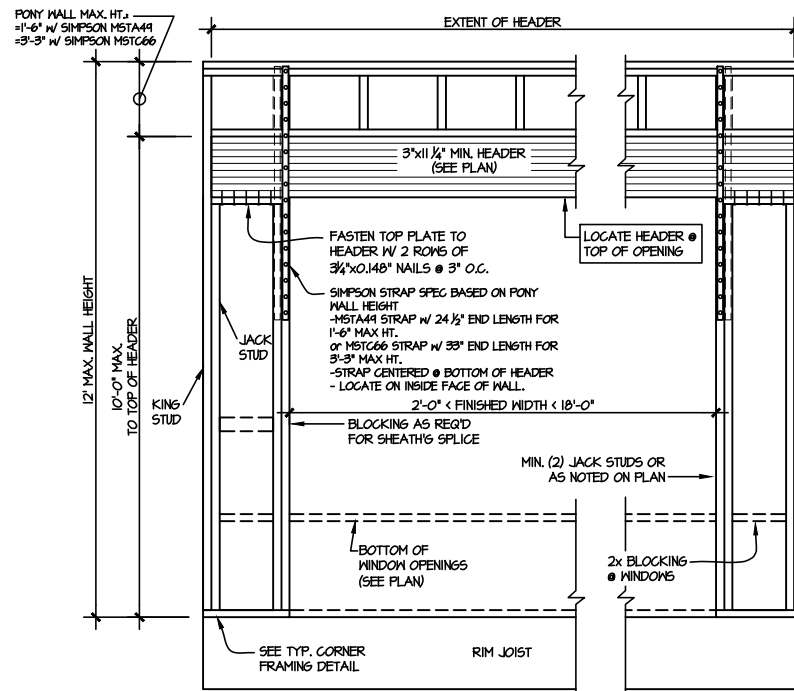


INSIDE ELEVATION

NOTE: ALL SHEATHABLE AREAS OF EXTERIOR WALL SHALL BE FULLY SHEATHED WITH 1/2" PLYWOOD OR 3/8" OSB

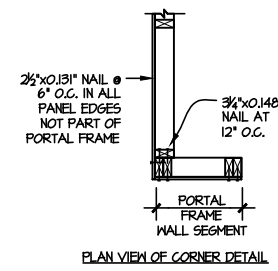

PLAN VIEW OF CORNER DETAIL

DOOR/WINDOW PORTAL FRAME BRACING ELEVATION
SCALE: N.T.S. BOTH SIDES OF OPENING

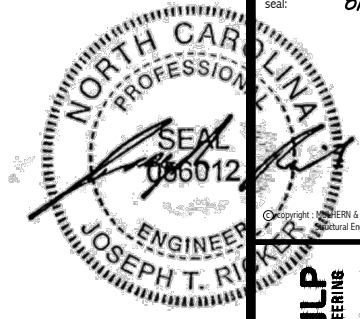

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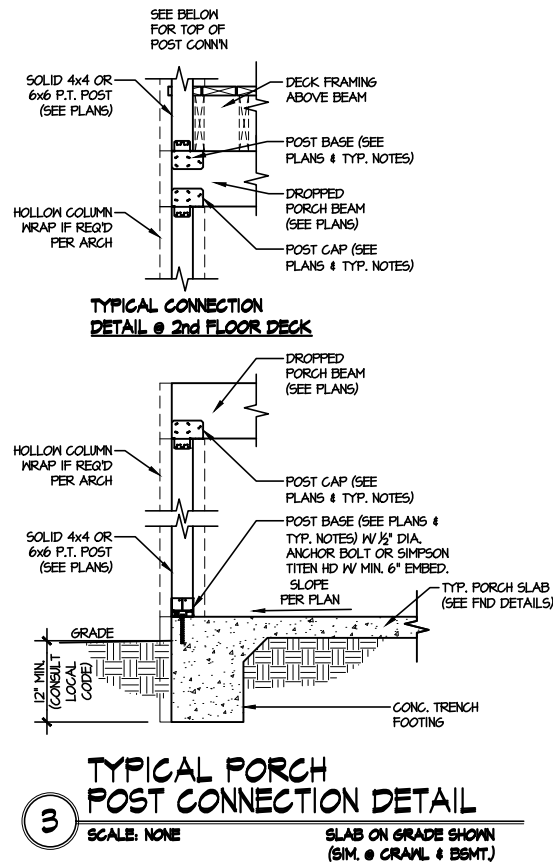
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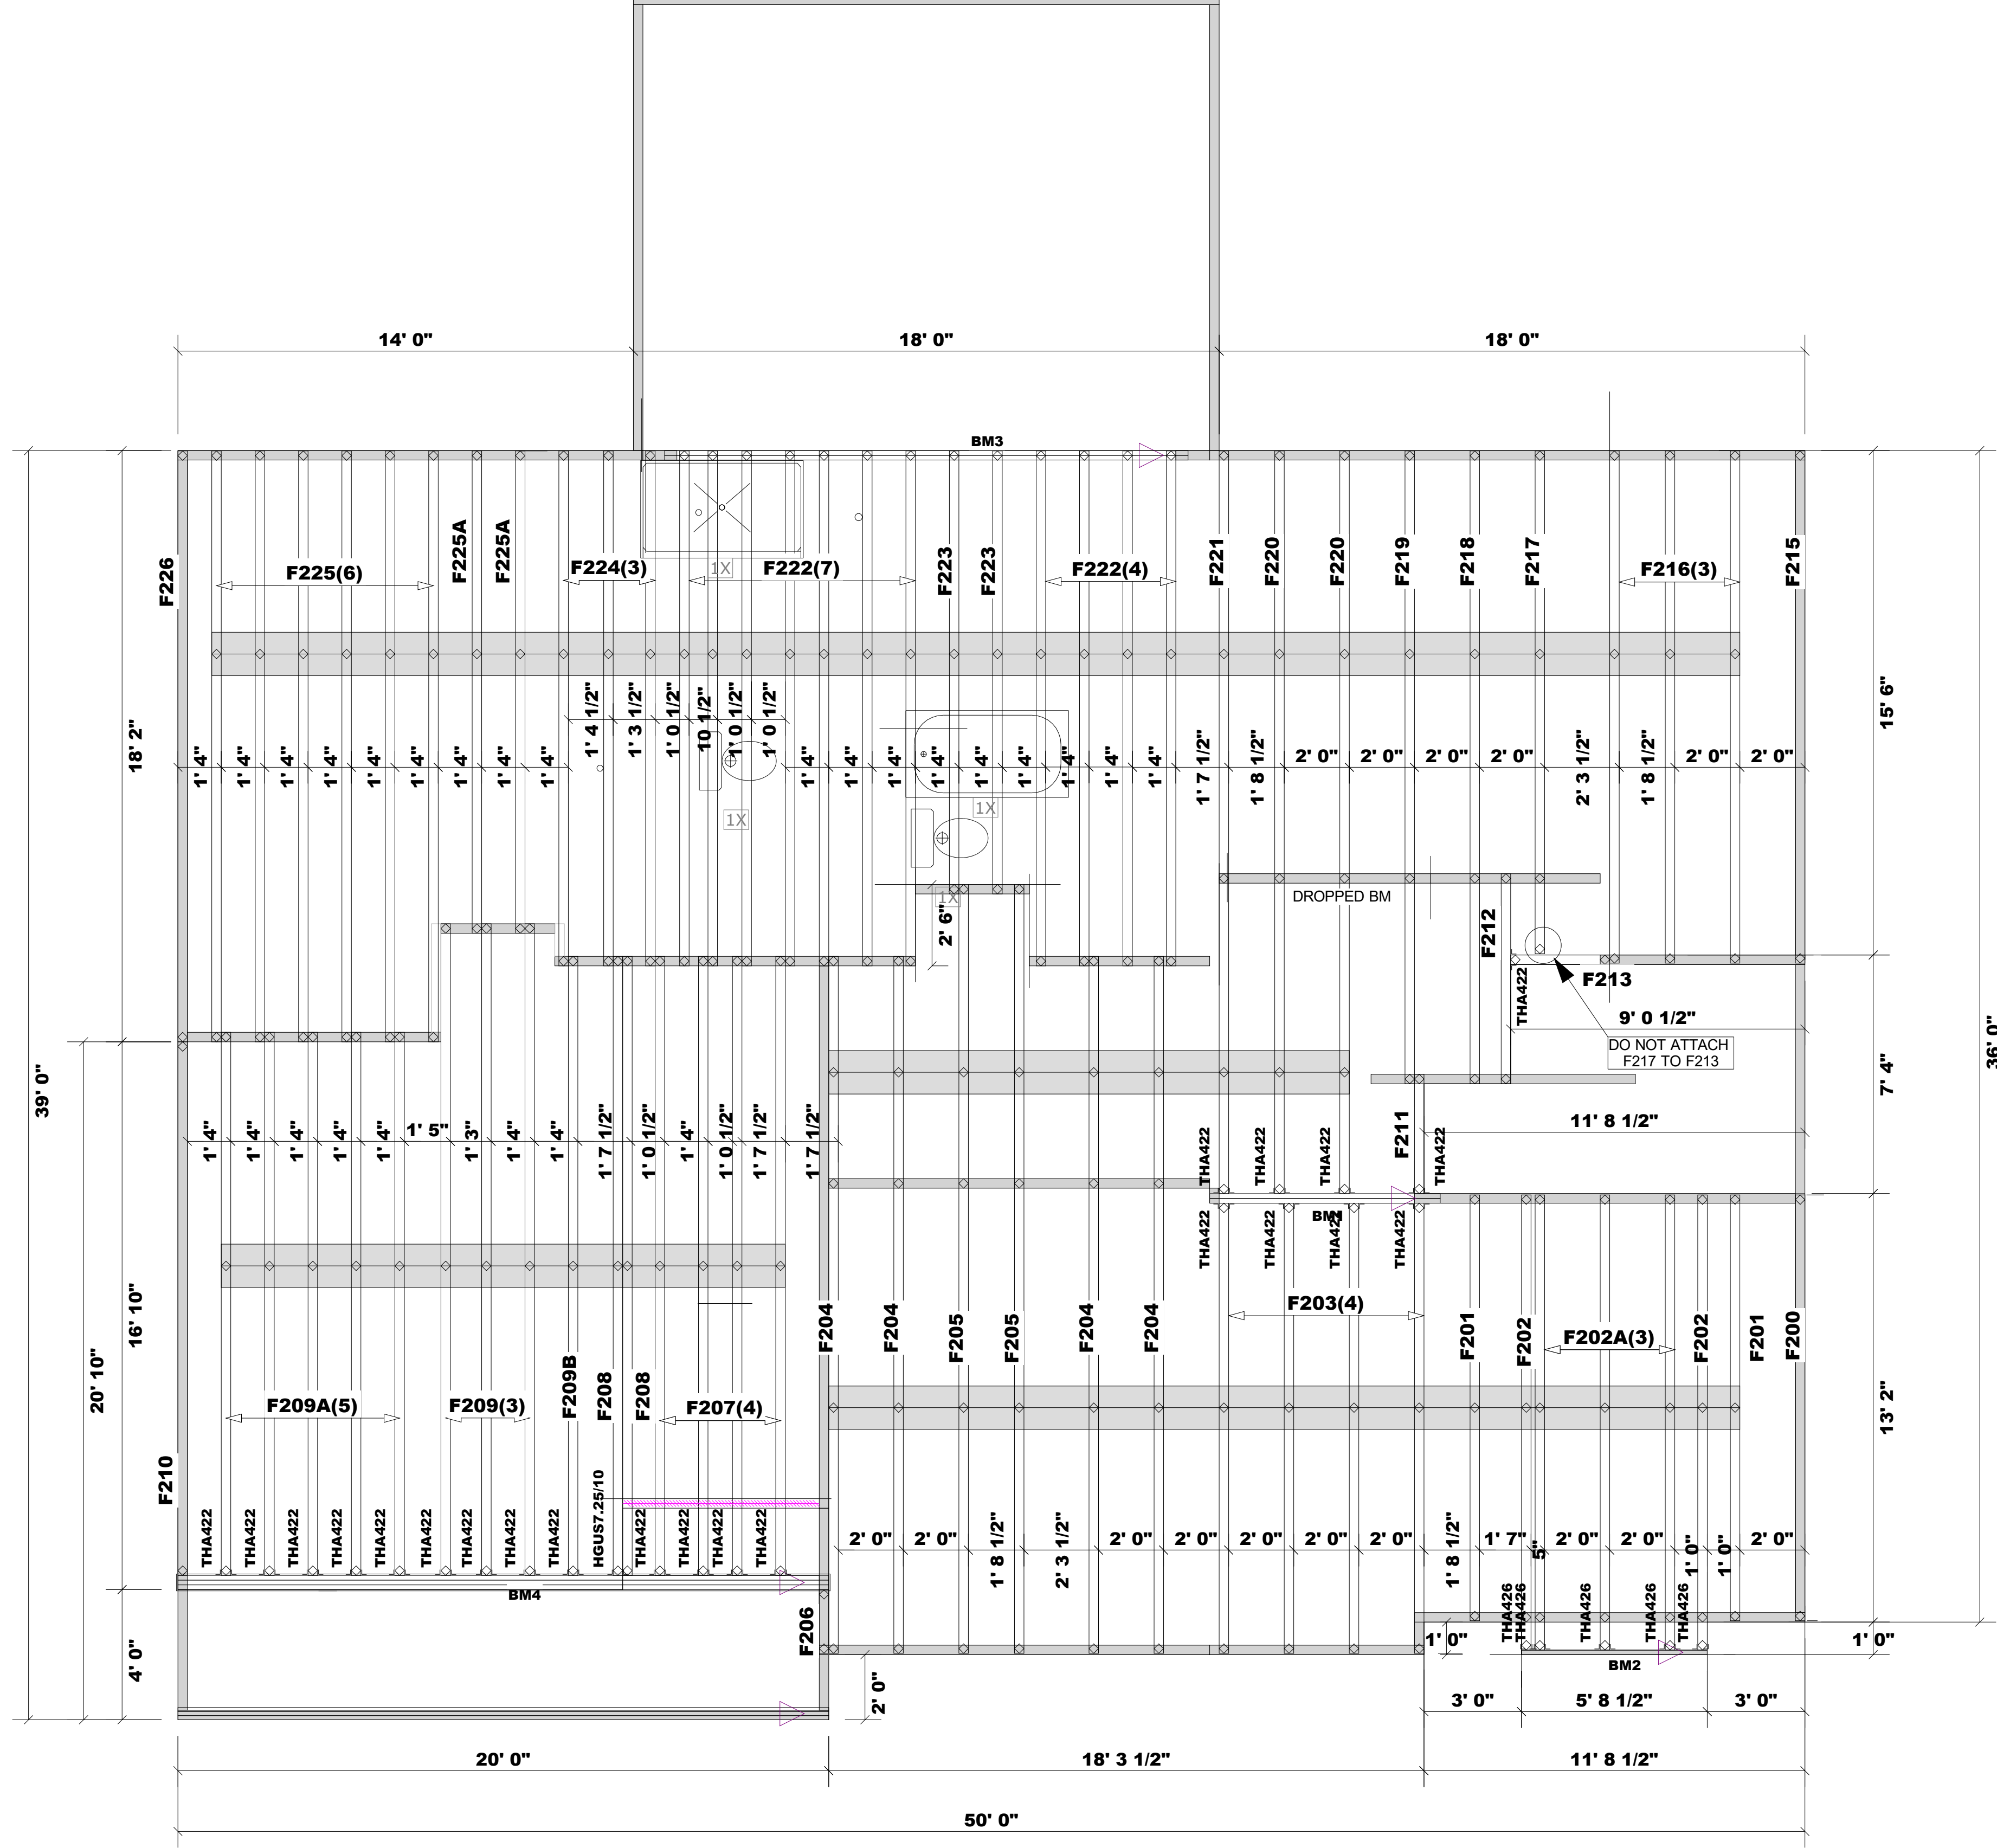


FRAMING DETAILS
 HONEYCUTT HILLS
 LOT 36 - STONEFIELD 7
 RALEIGH, NC



Fab Type	Net Qty	Plies	Products	Product	Length	PlotID
MFD	2	2	1-3/4" x 14" VERSA-LAM® 2.0 3100 SP		8' 0"	BM1
MFD	1	1	1-3/4" x 14" VERSA-LAM® 2.0 3100 SP		6' 0"	BM2
MFD	2	2	1-3/4" x 16" VERSA-LAM® 2.0 3100 SP		17' 0"	BM3
MFD	3	3	1-3/4" x 18" VERSA-LAM® 2.0 3100 SP		20' 0"	BM4

Truss Connector Total List		
Qty	Product	Manuf
1	HGUS7.25/10	
22	THA422	Simpson
5	THA426	Simpson



1998 Cane Gully Road, Moncks Corner SC 29461
 Phone: (800) 475-3999 Fax (843) 565-3193
 Web: www.atlantibcs.com

FOR PERMIT

Client: **DRB GROUP-RALEIGH**
 Job: **LOT 0.0036 HONEYCUTT HILL**
 Plan Information: **STONEFIELD-7**


ROOF

NOT TO SCALE
 Drawn By: CGT
 Date: 1-11-17
 Job #: 24-7417-F02
 Sales Rep: KYLE GIBSON
 Phone: 843-729-3249

For all small open-ended mono roof trusses, use (3) 10d toe nails in the top chord and (3) 10d toe nails in the bottom chord.

Truss Connector Total List		
Qty	Product	Manuf
5	HTU26	Simpson
1	LUC26Z	Simpson
7	LUS24	Simpson
9	LUS26	Simpson

2x4 ledger (by others) connected to floor trusses spaced 24" oc with a minimum of (4) .128x3.25" nails.

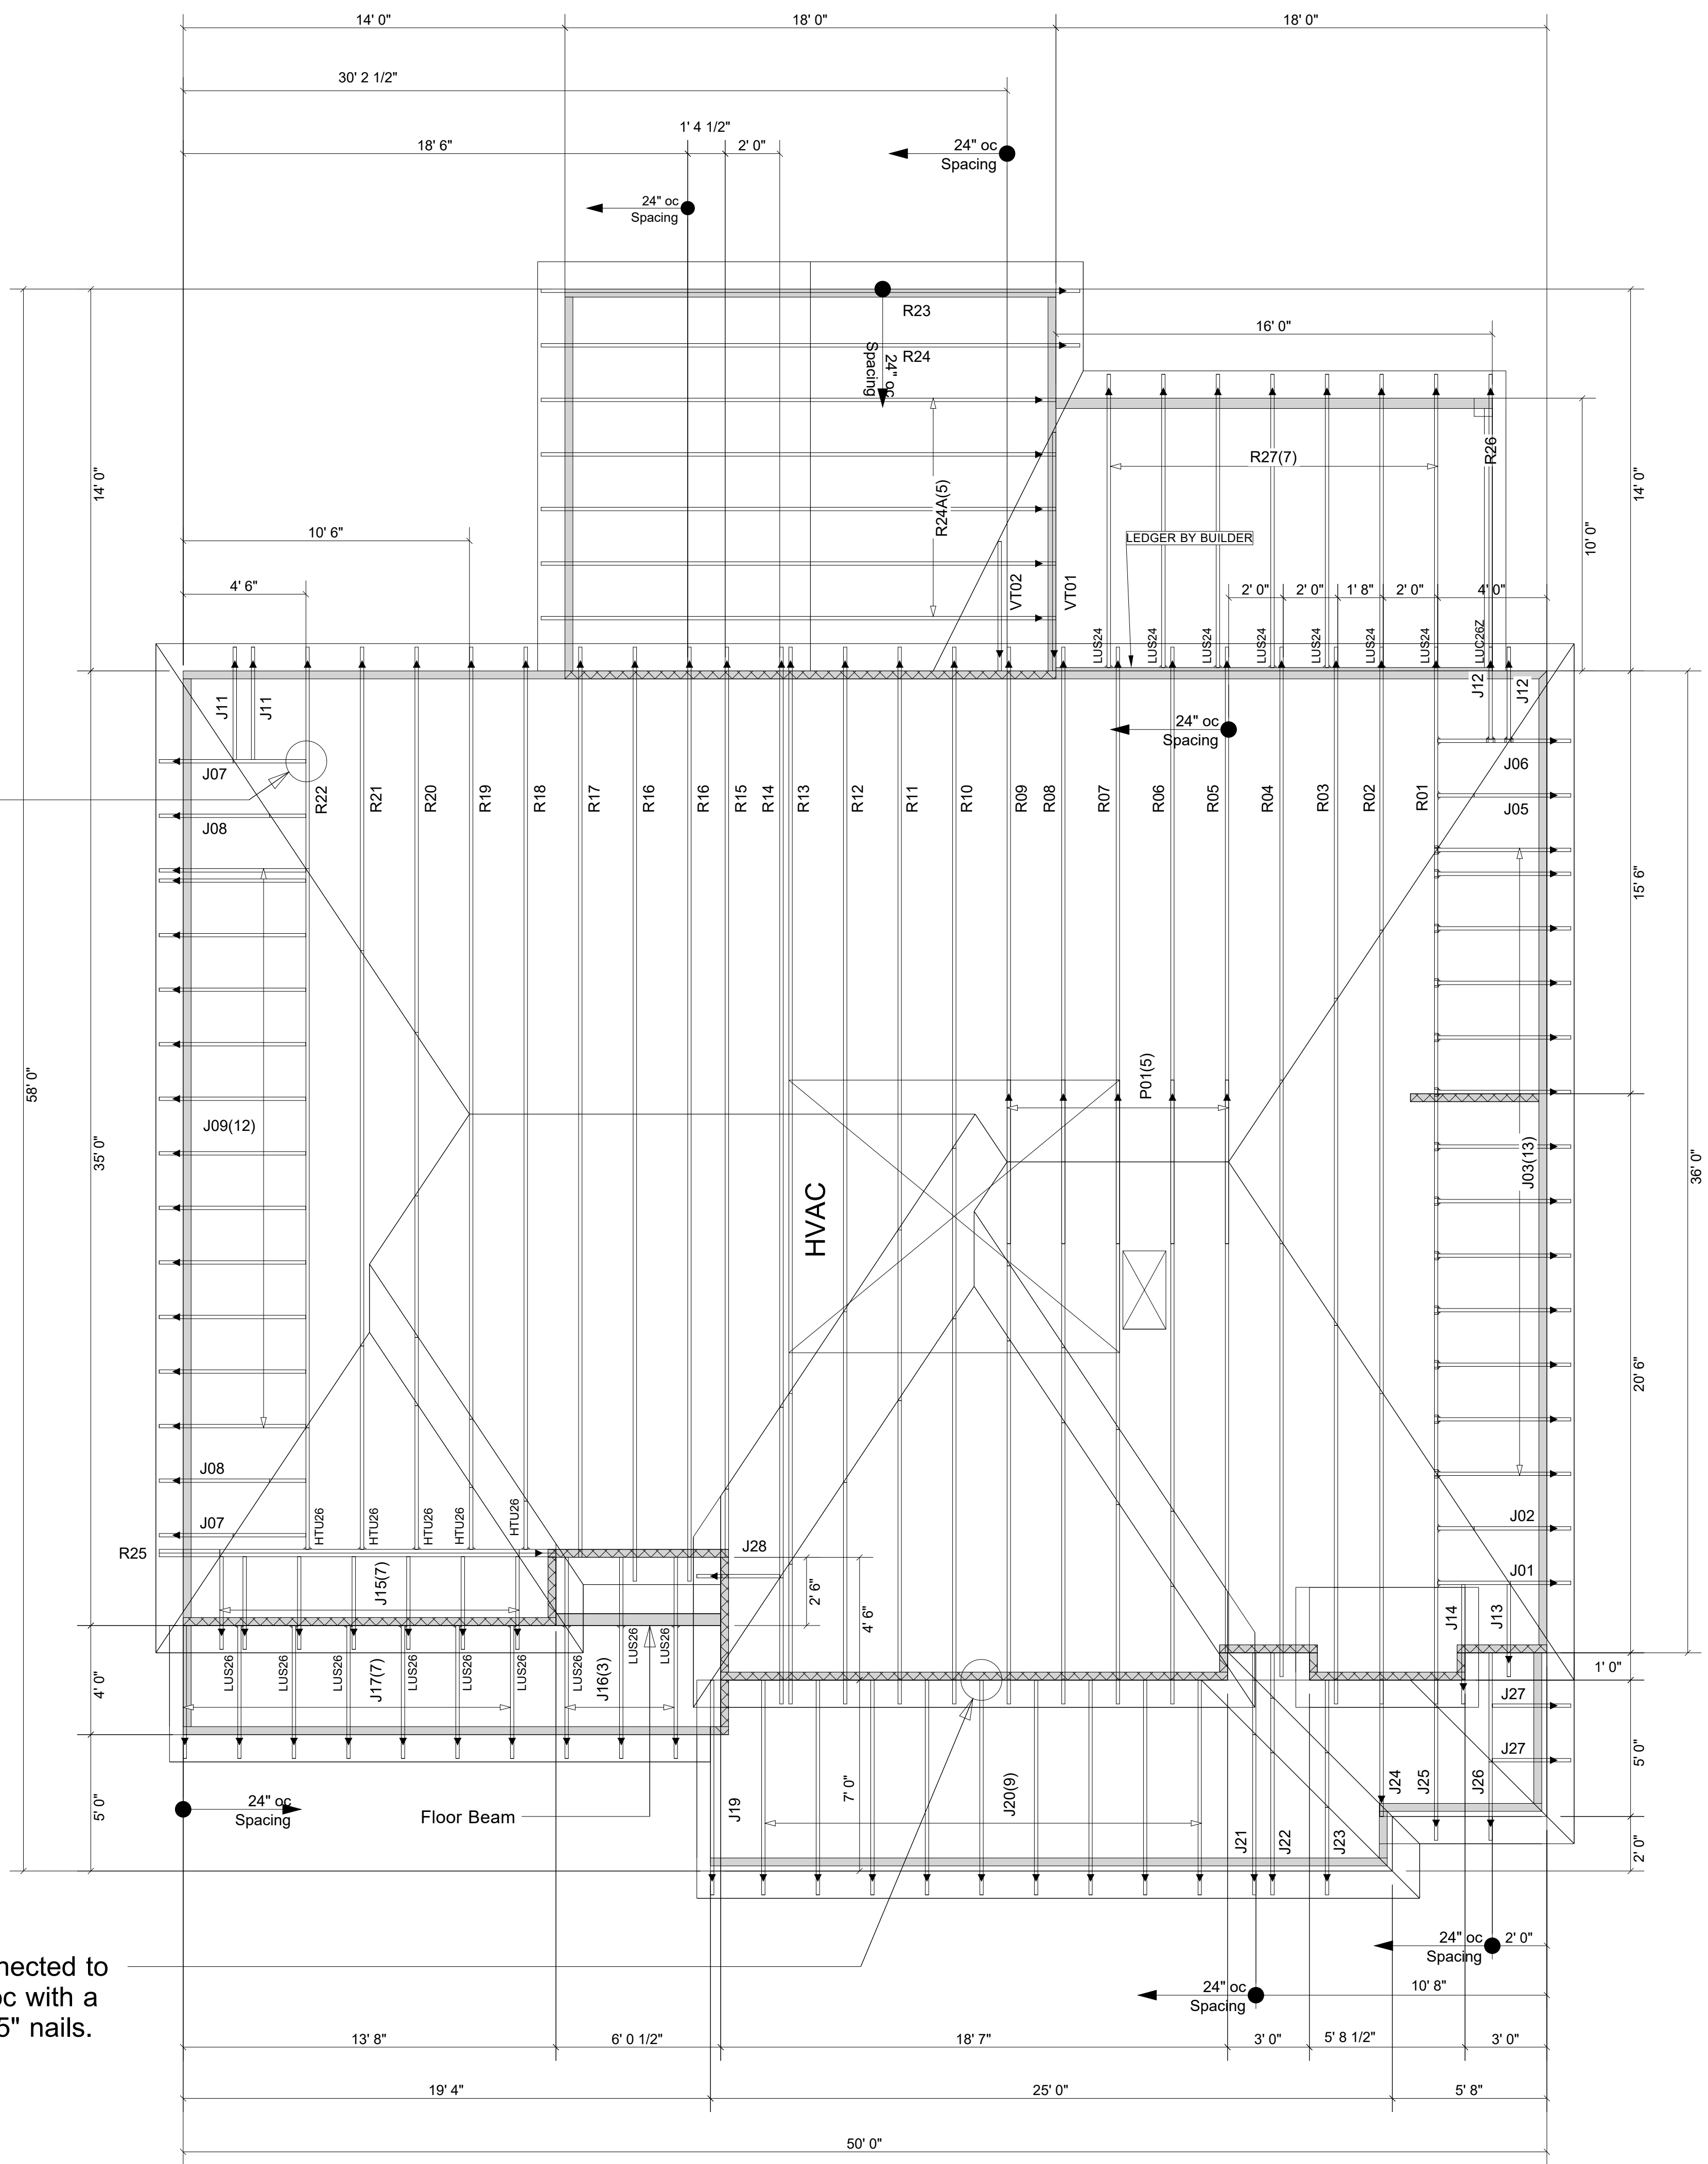

▲ = LEFT END OF TRUSS

FOR PERMIT

REVISIONS:



Moncks Corner/Easley, SC (800) 475-3999
Sparta, NC (336) 372-2226

Client: DRB GROUP-RALEIGH

Job: LOT 0.0036 HONEYCUTT HILL

Plan Information:
STONEFIELD-7

ROOF

NOT TO SCALE

Drawn By: CGT

Date: 08/21/24


Job #: 24-7417-R01

Sales Rep: KYLE GIBSON
Phone:

WARNING! Long span trusses, 60' or greater in length, require extreme care and experience for proper and safe handling and installation. For general handling and installation guidance, see the "Guide to Good Practice for Handling, Installing, Restraining & Bracing of Metal Plate Connected Wood Trusses ("BCSI"), JOINTLY PRODUCED BY SBCA and TPI. For project specific guidance, consult with a registered design professional. ATLANTIC assumes no responsibility for the handling, installation or bracing of trusses.

Product	Length	PlotID
ARD OSB	2' 0"	Blk1

Truss Connector Total List		
Qty	Product	Manuf
10	THA422	

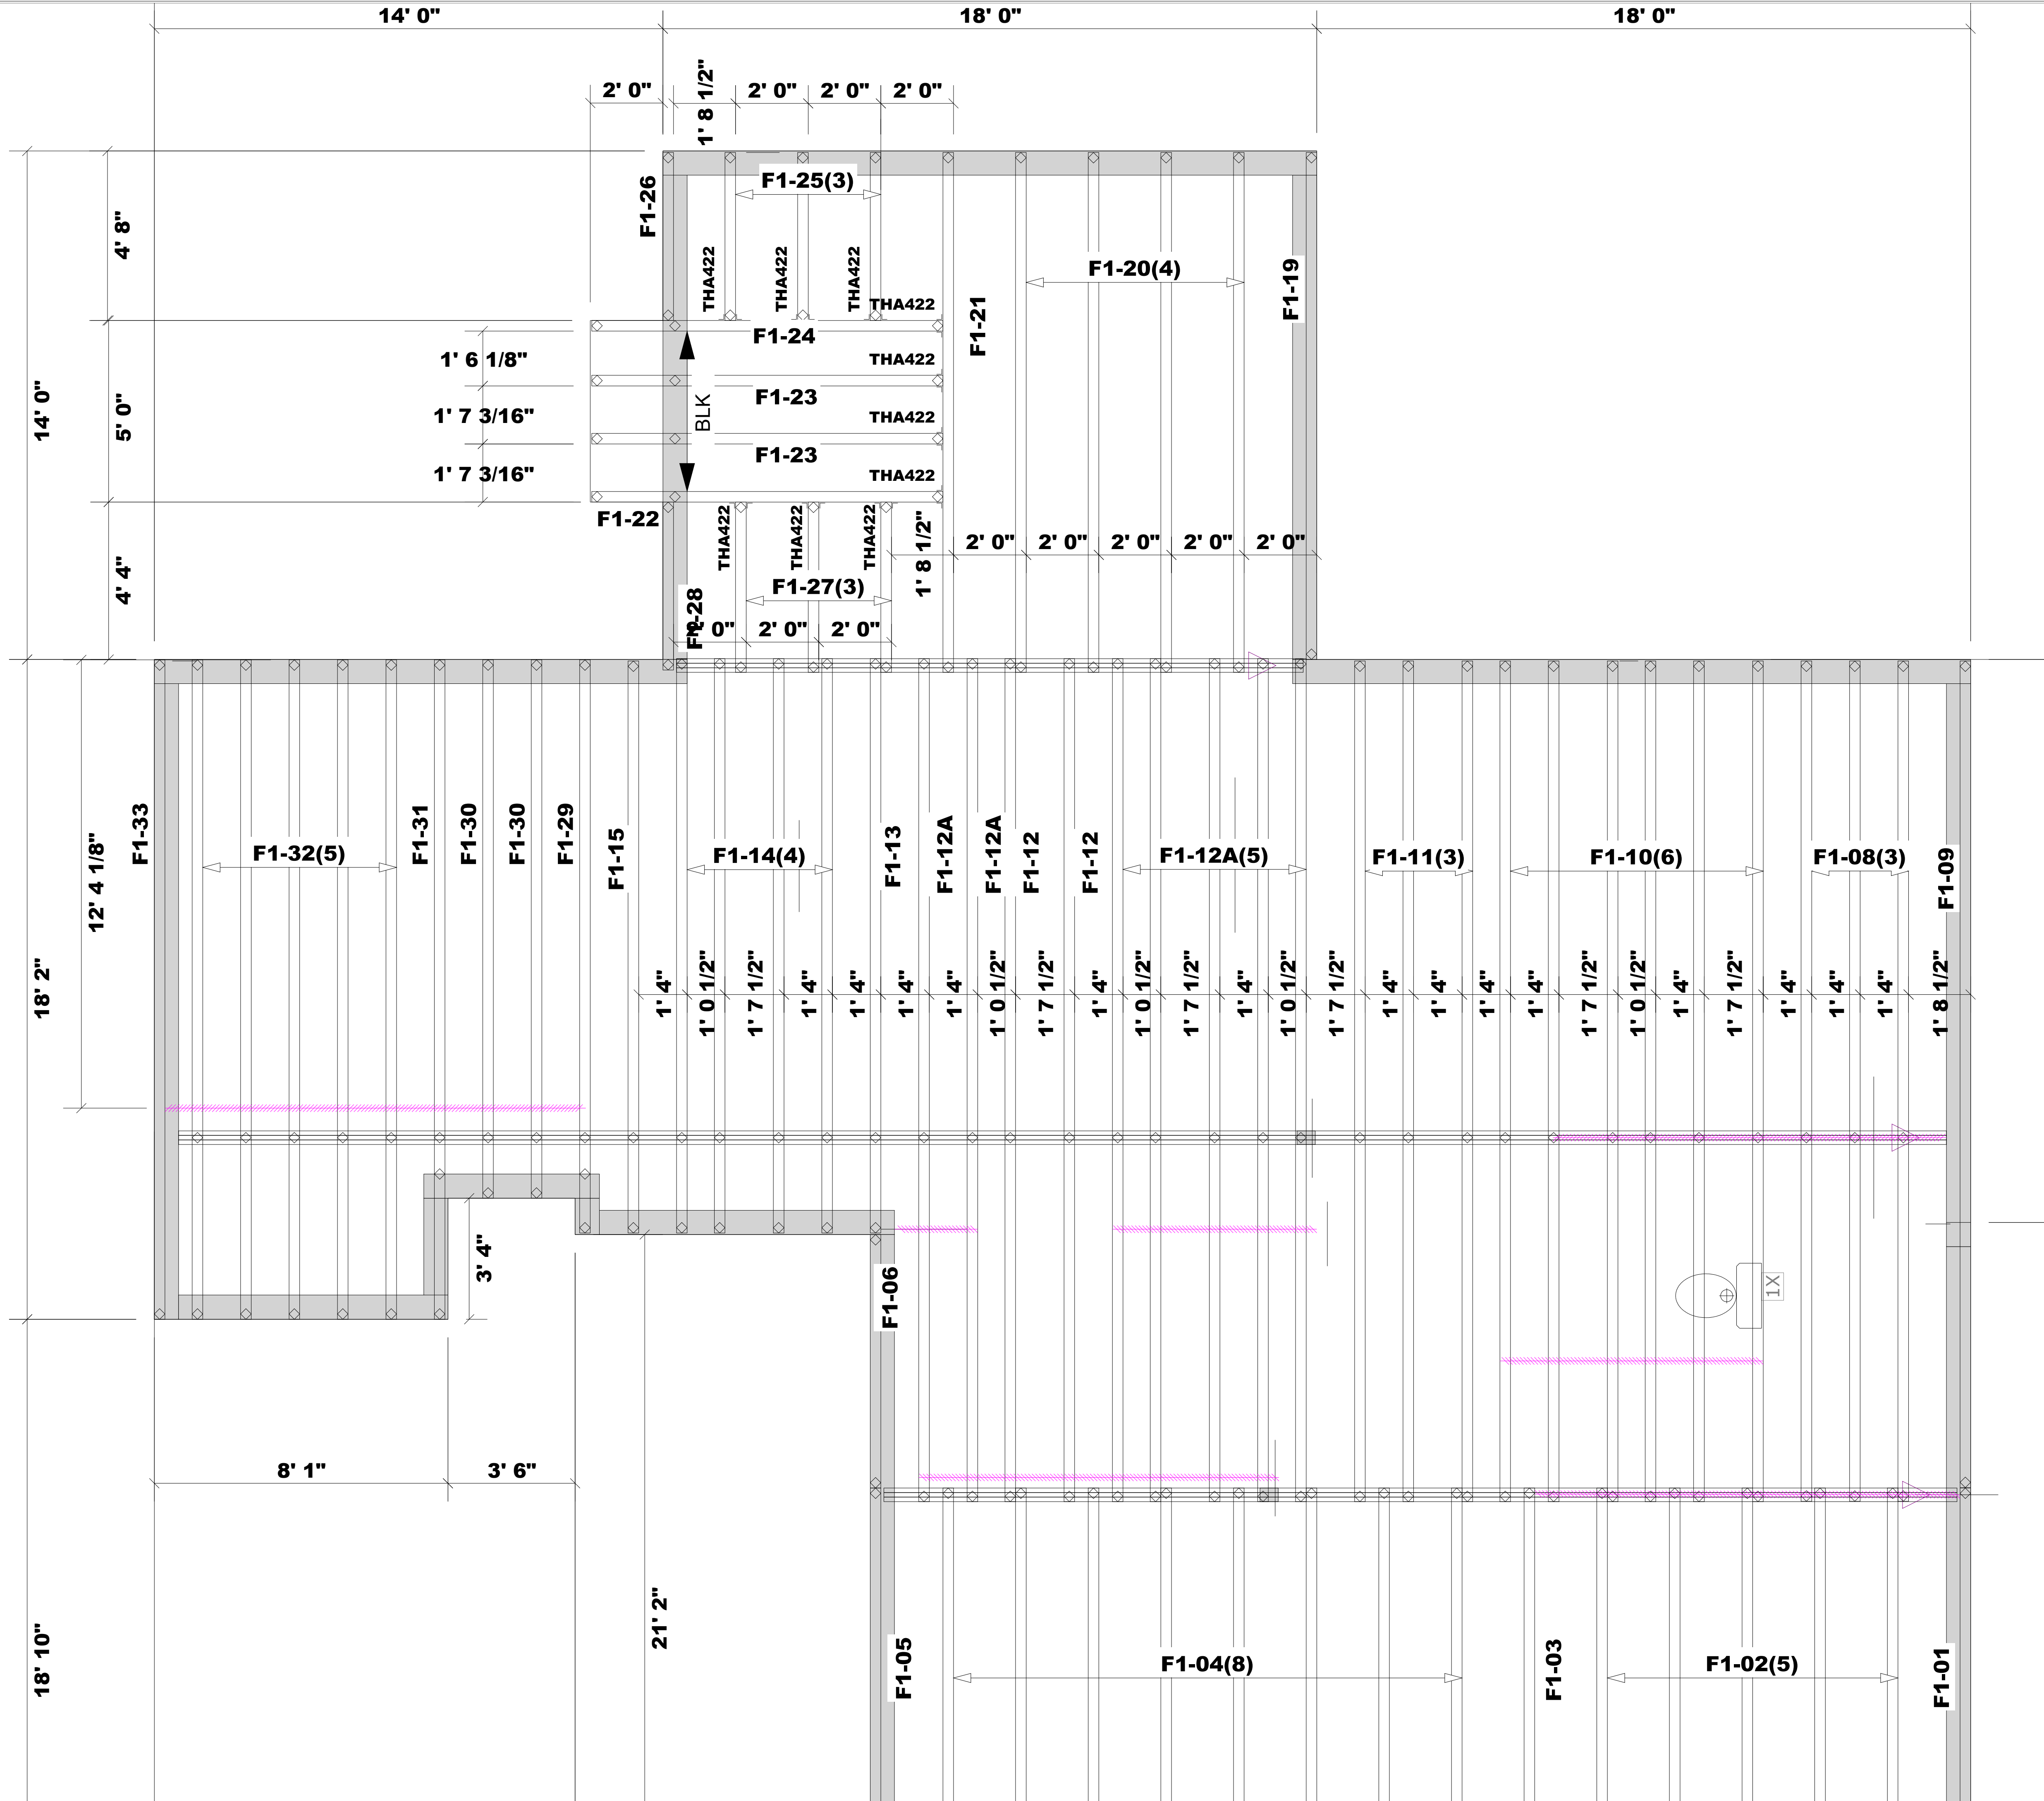

FOR PERMIT

Client: DRB GROUP-RALEIGH

Job: LOT 0.0036 HONEYCUTT HILL

Plan Information: STONEFIELD-7

NOT TO SCALE

Date: 08/21/24

Job #: 24-7417-F01

Drawn By: CGT

Sales Rep: KYLE GIBSON

Phone: 864-304-3282

▲ = LEFT END OF TRUSS

REVISIONS:



Moncks Corner/Easley, SC (800) 475-3999
 Sparta, NC (336) 372-2226

WARNING! Long span trusses, 60' or greater in length, require extreme care and experience for proper and safe handling and installation. For general handling and installation guidance, see the "Guide to Good Practice for Handling, Installing, Restraining & Bracing of Metal Plate Connected Wood Trusses ("BCSI"), JOINTLY PRODUCED BY SBCA and TPI. For project specific guidance, consult with a registered design professional. ATLANTIC assumes no responsibility for the handling, installation or bracing of trusses.