

FRONT ELEVATION



SOUTHERN HOME DESIGNS	SCALE	DATE
106 WALNUT LANE COLUMBIA, TN 38401	1/4"= 1'	
PHONE 931-580-9375 EMAIL dwilliamsshd64@gmail.com	PLAN NO.	PAGE NO.
HOME DESIGNS SINCE 1997	1S-2851-24	


DRAWN BY


Daniel Williams

R. MORAN

6/17/24

1 of 5

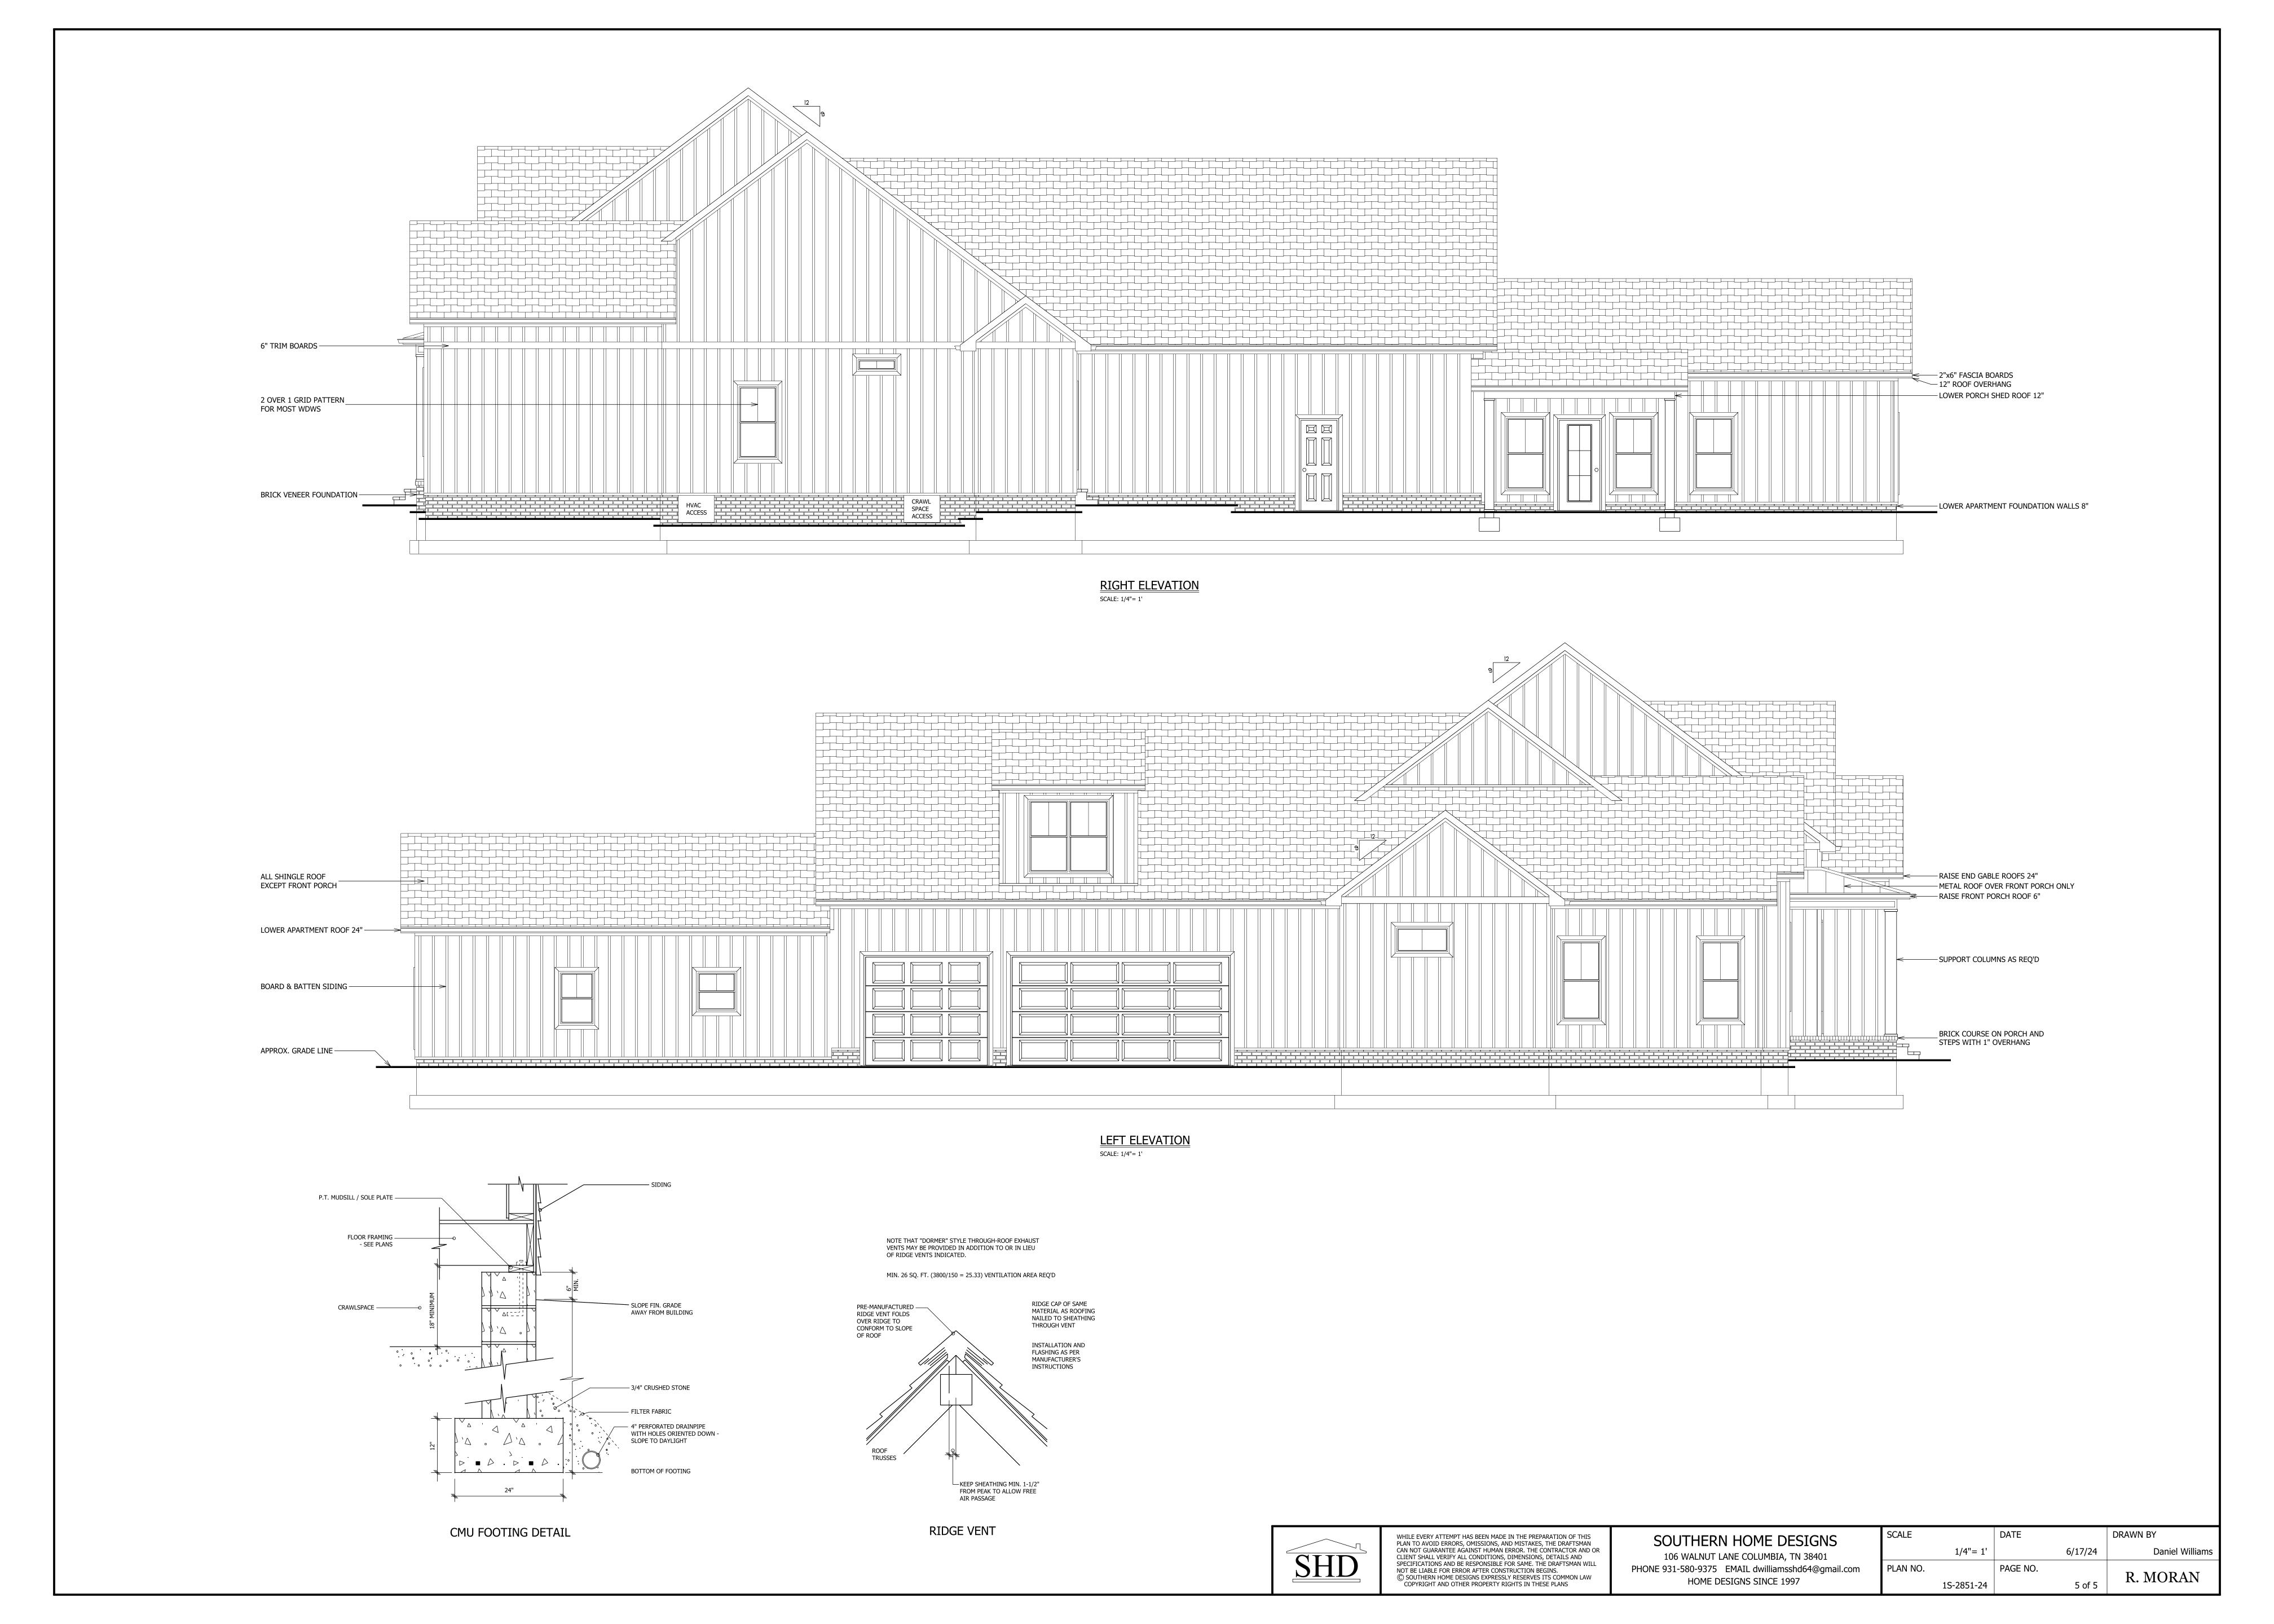

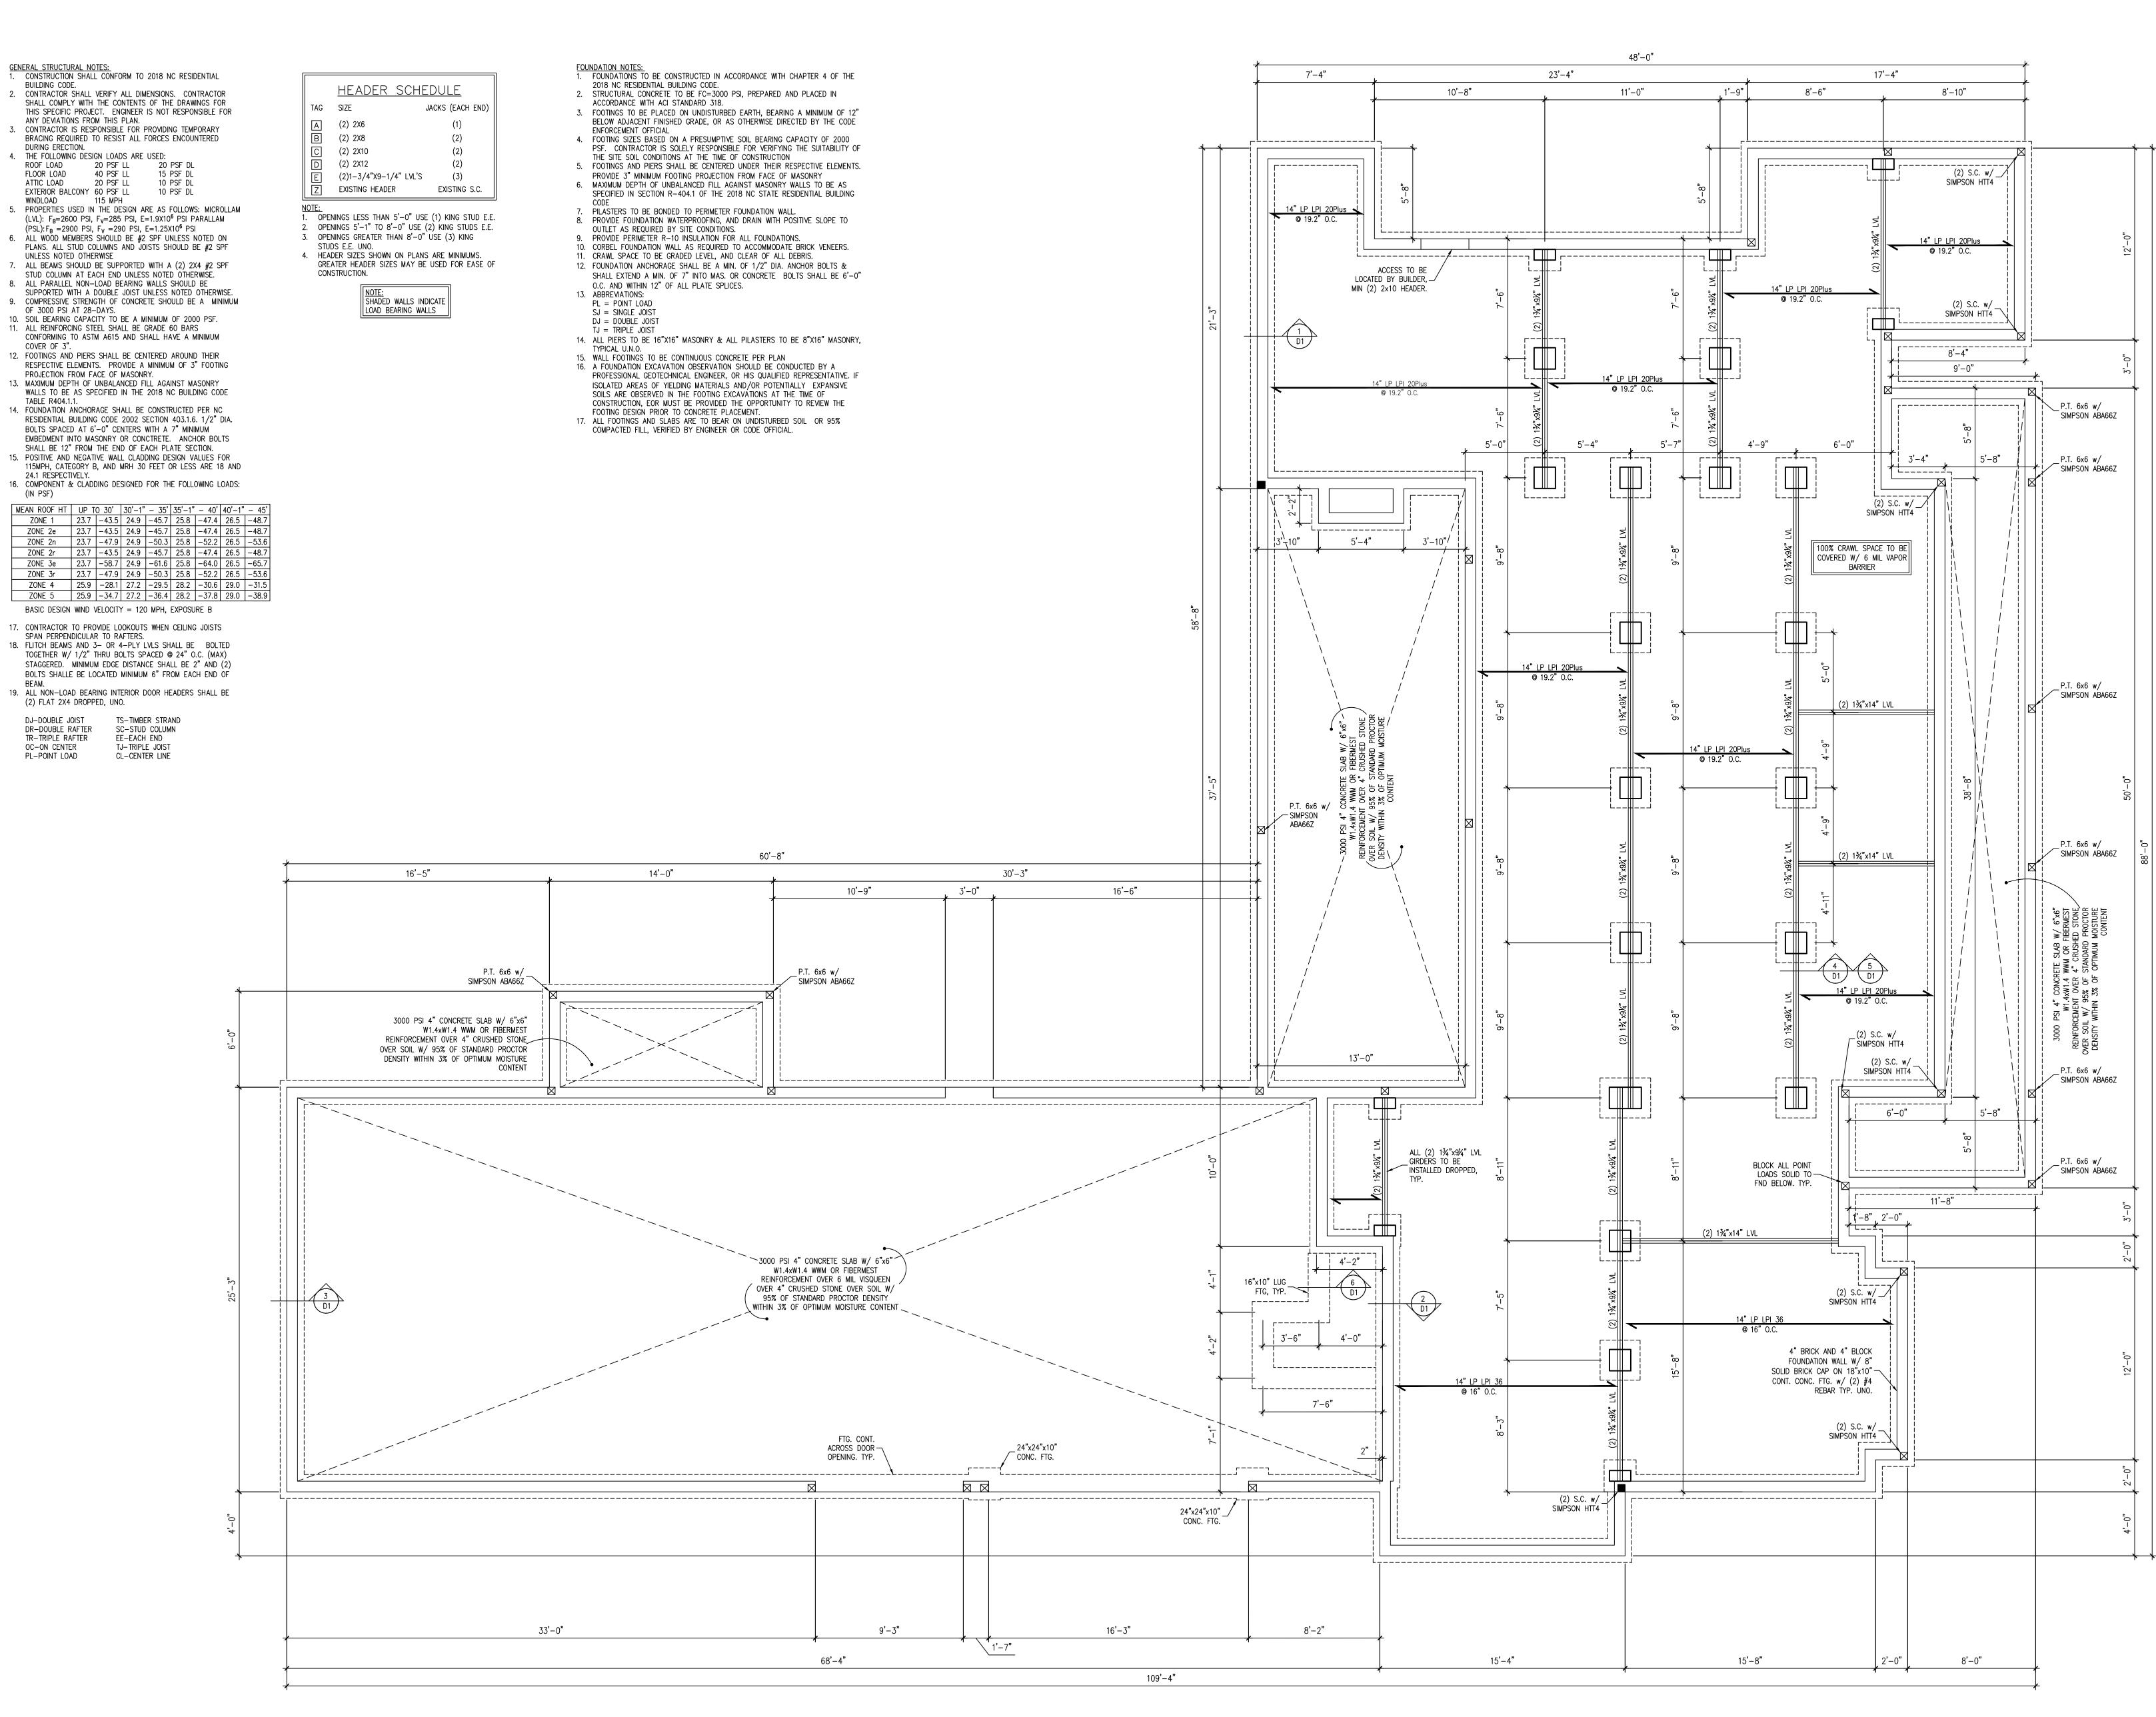


Nix Industries, LLC
2664 Erwin Chapel Road, Dunn, NC 28334
Foundation Plan


FOUNDATION PLAN

1/4" = 1'-0"

S

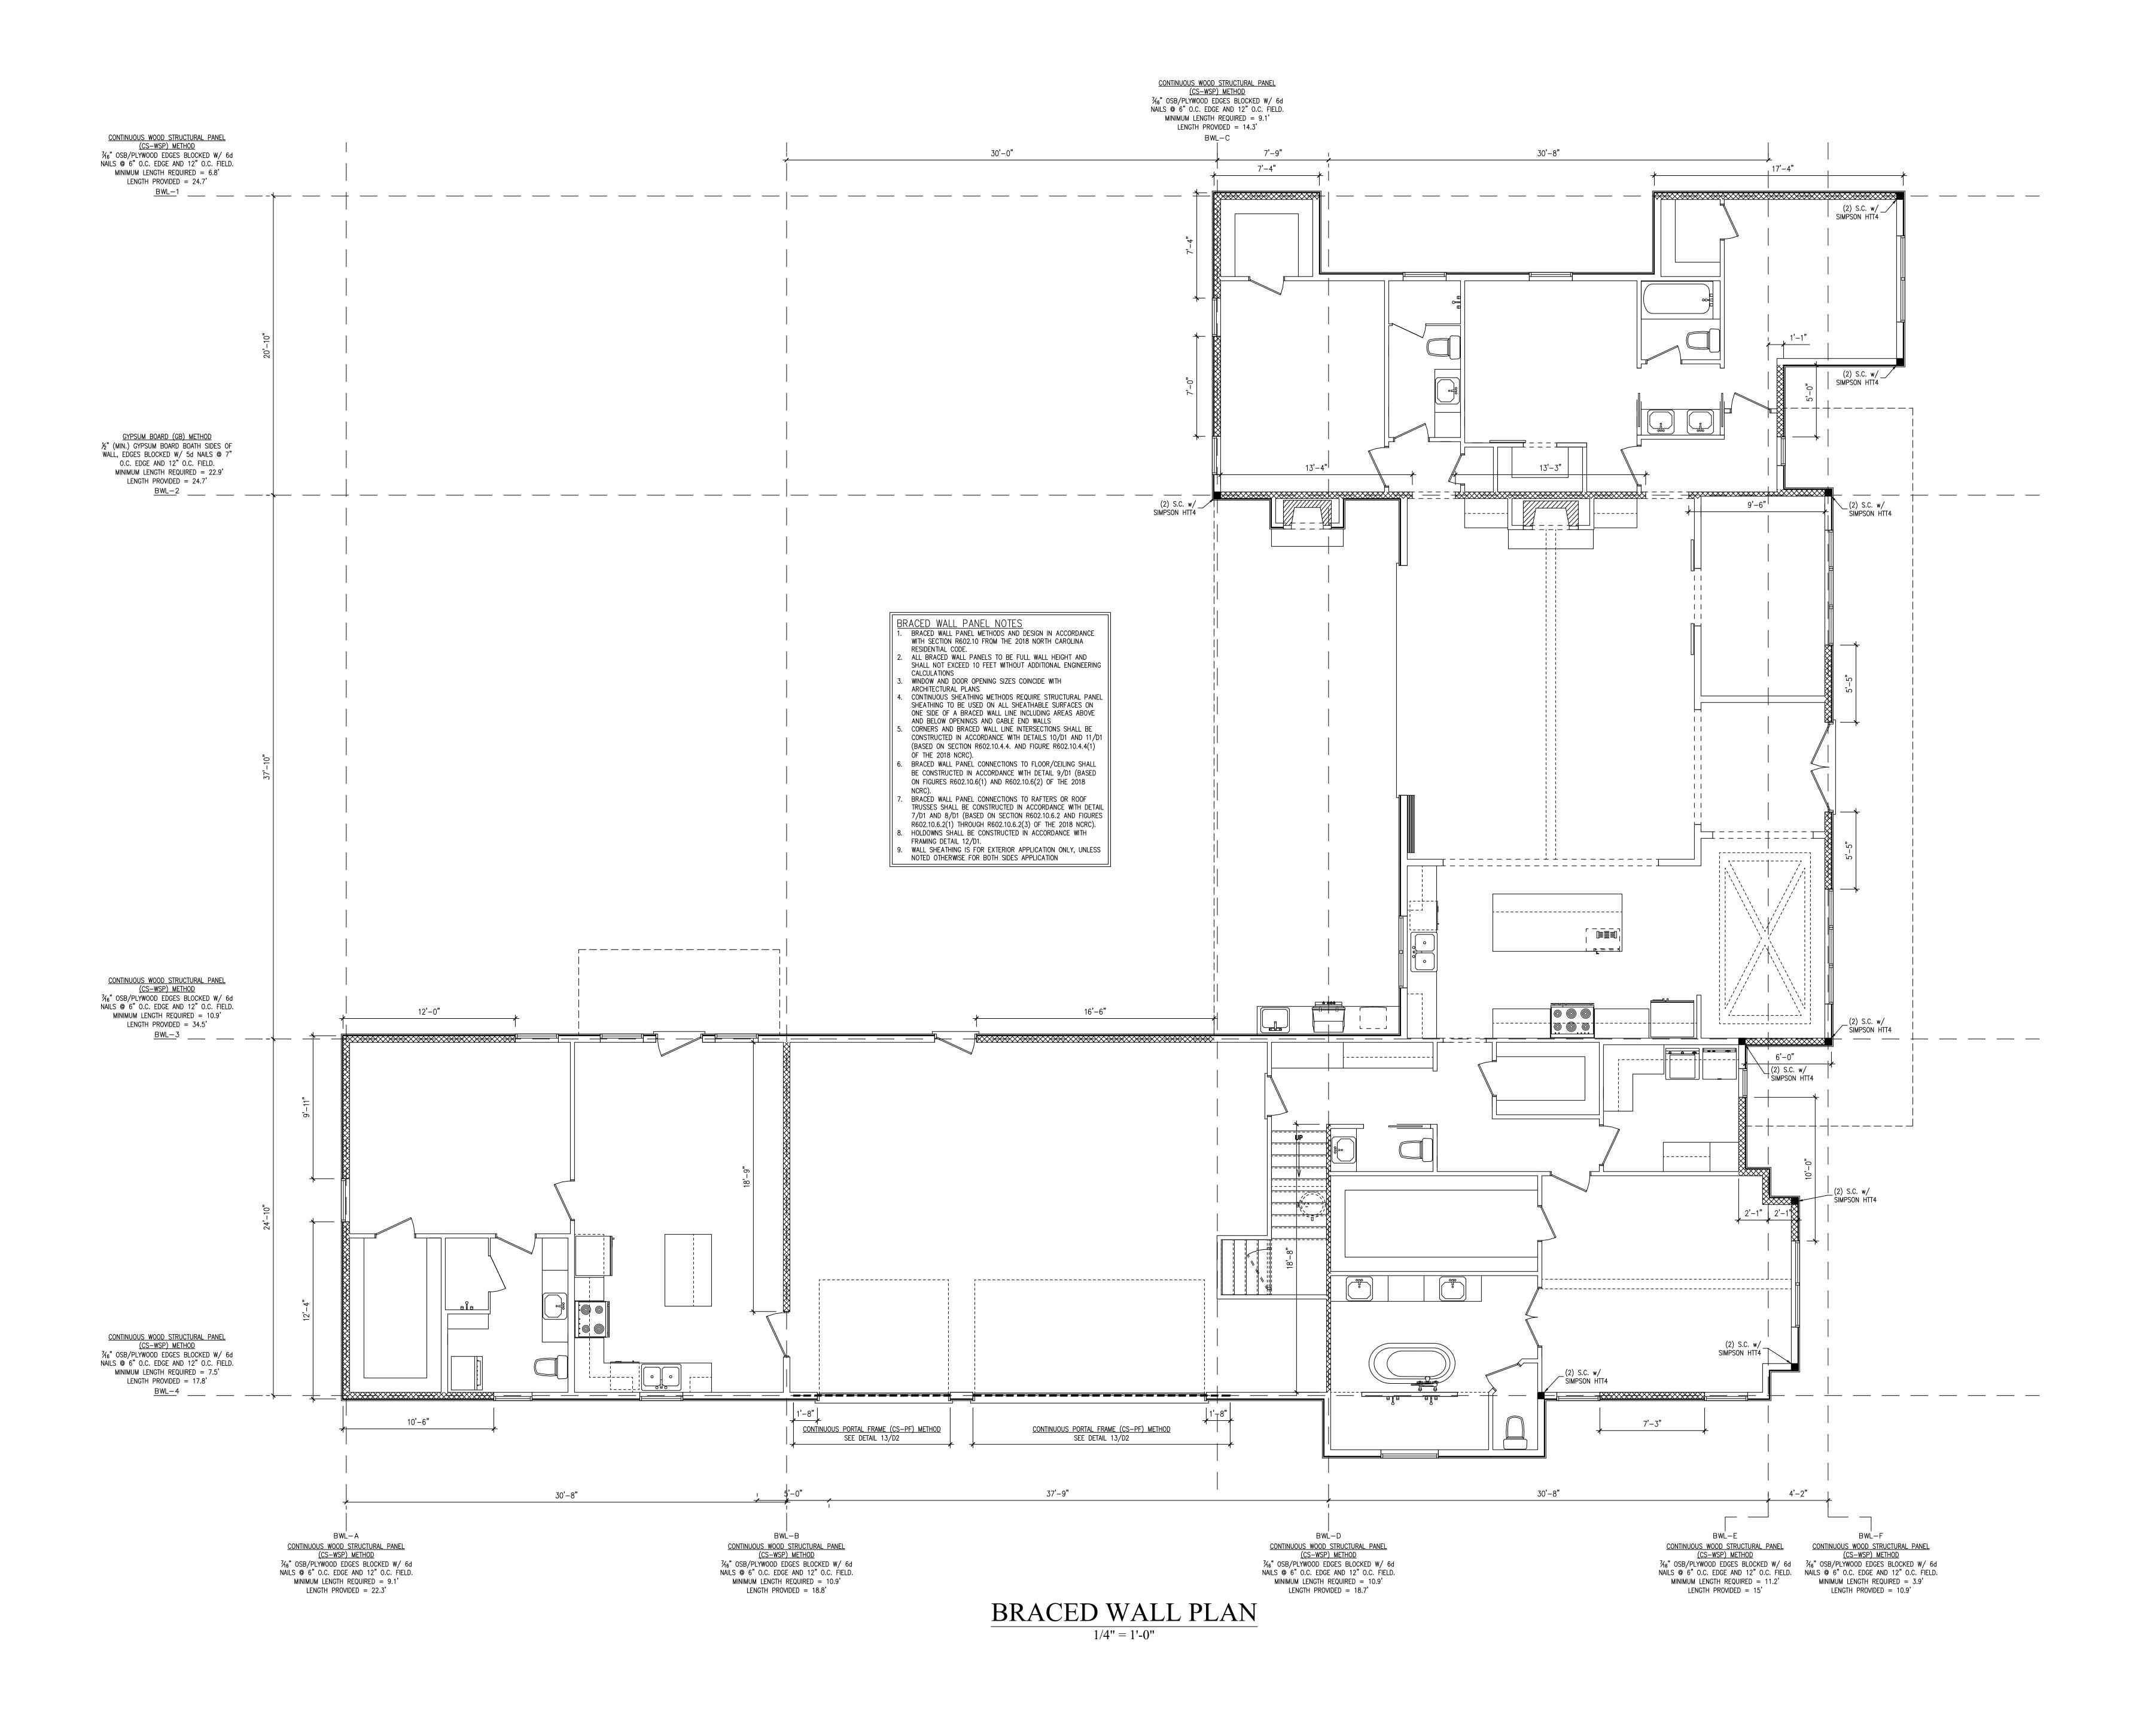

SHEET NUMBER

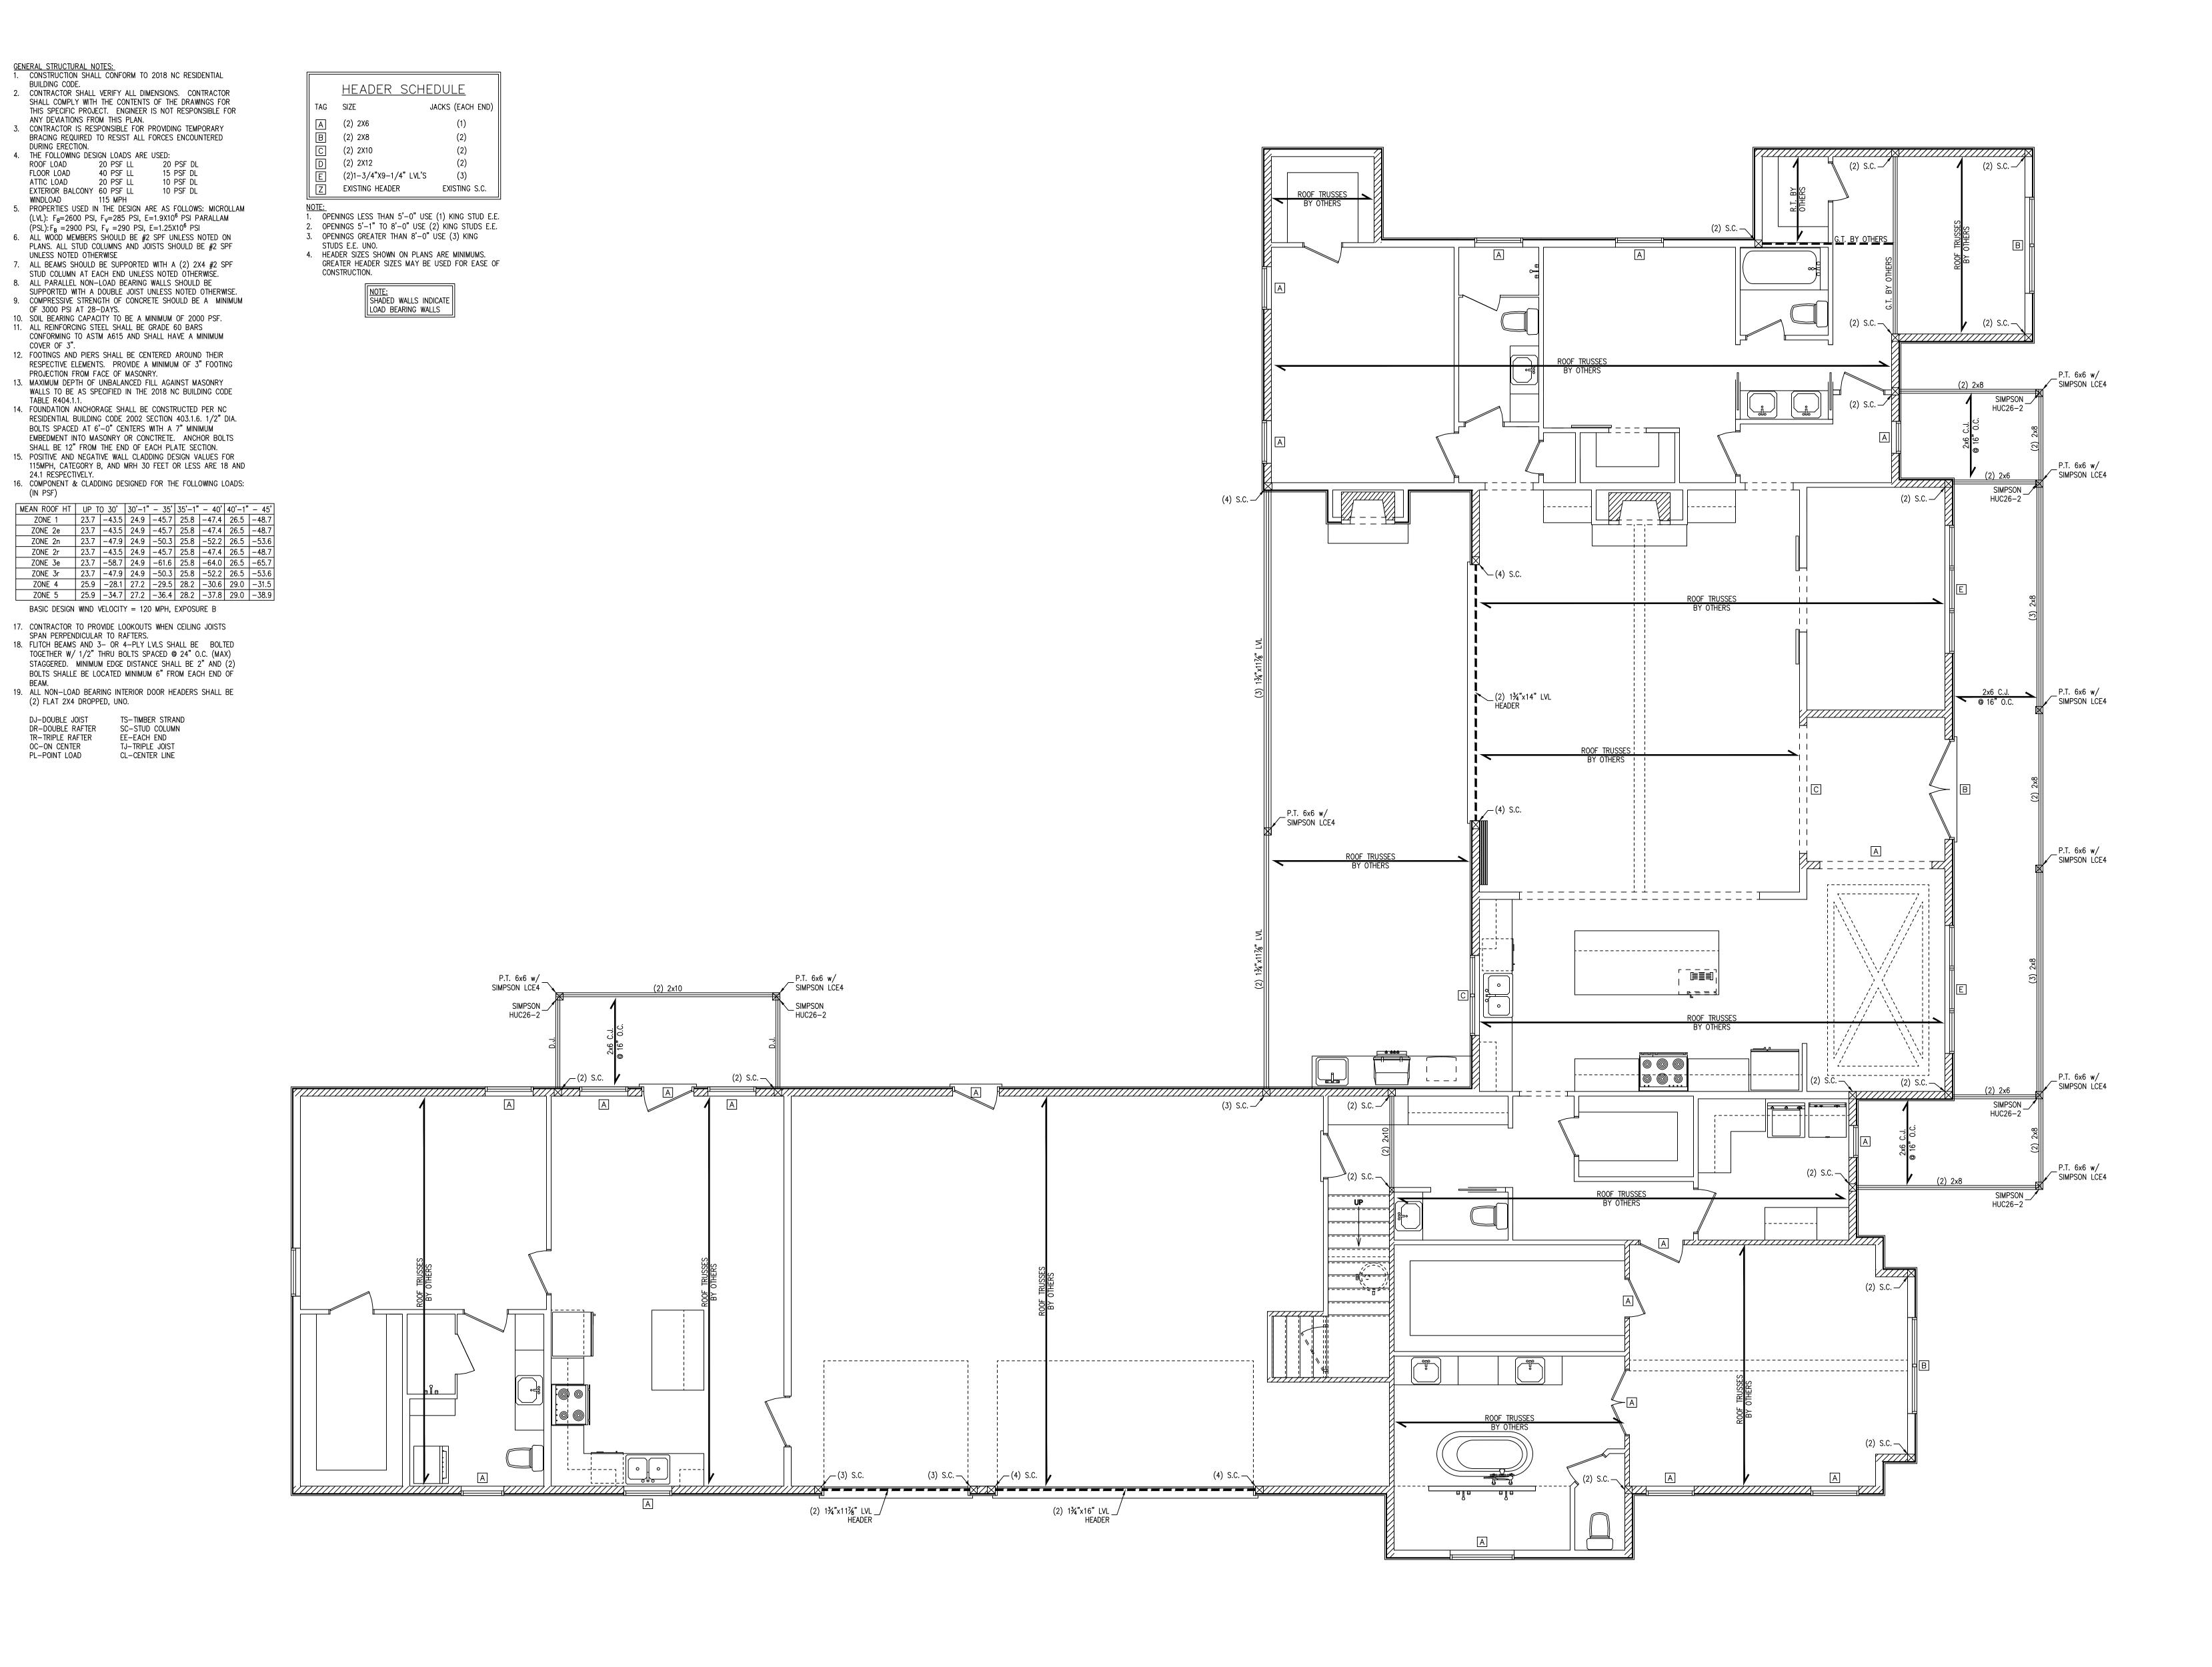

BUILDING CODE.

DURING ERECTION.


TABLE R404.1.1.

24.1 RESPECTIVELY.

(2) FLAT 2X4 DROPPED, UNO.

DR-DOUBLE RAFTER
TR-TRIPLE RAFTER
OC-ON CENTER
PL-POINT LOAD

(IN PSF)

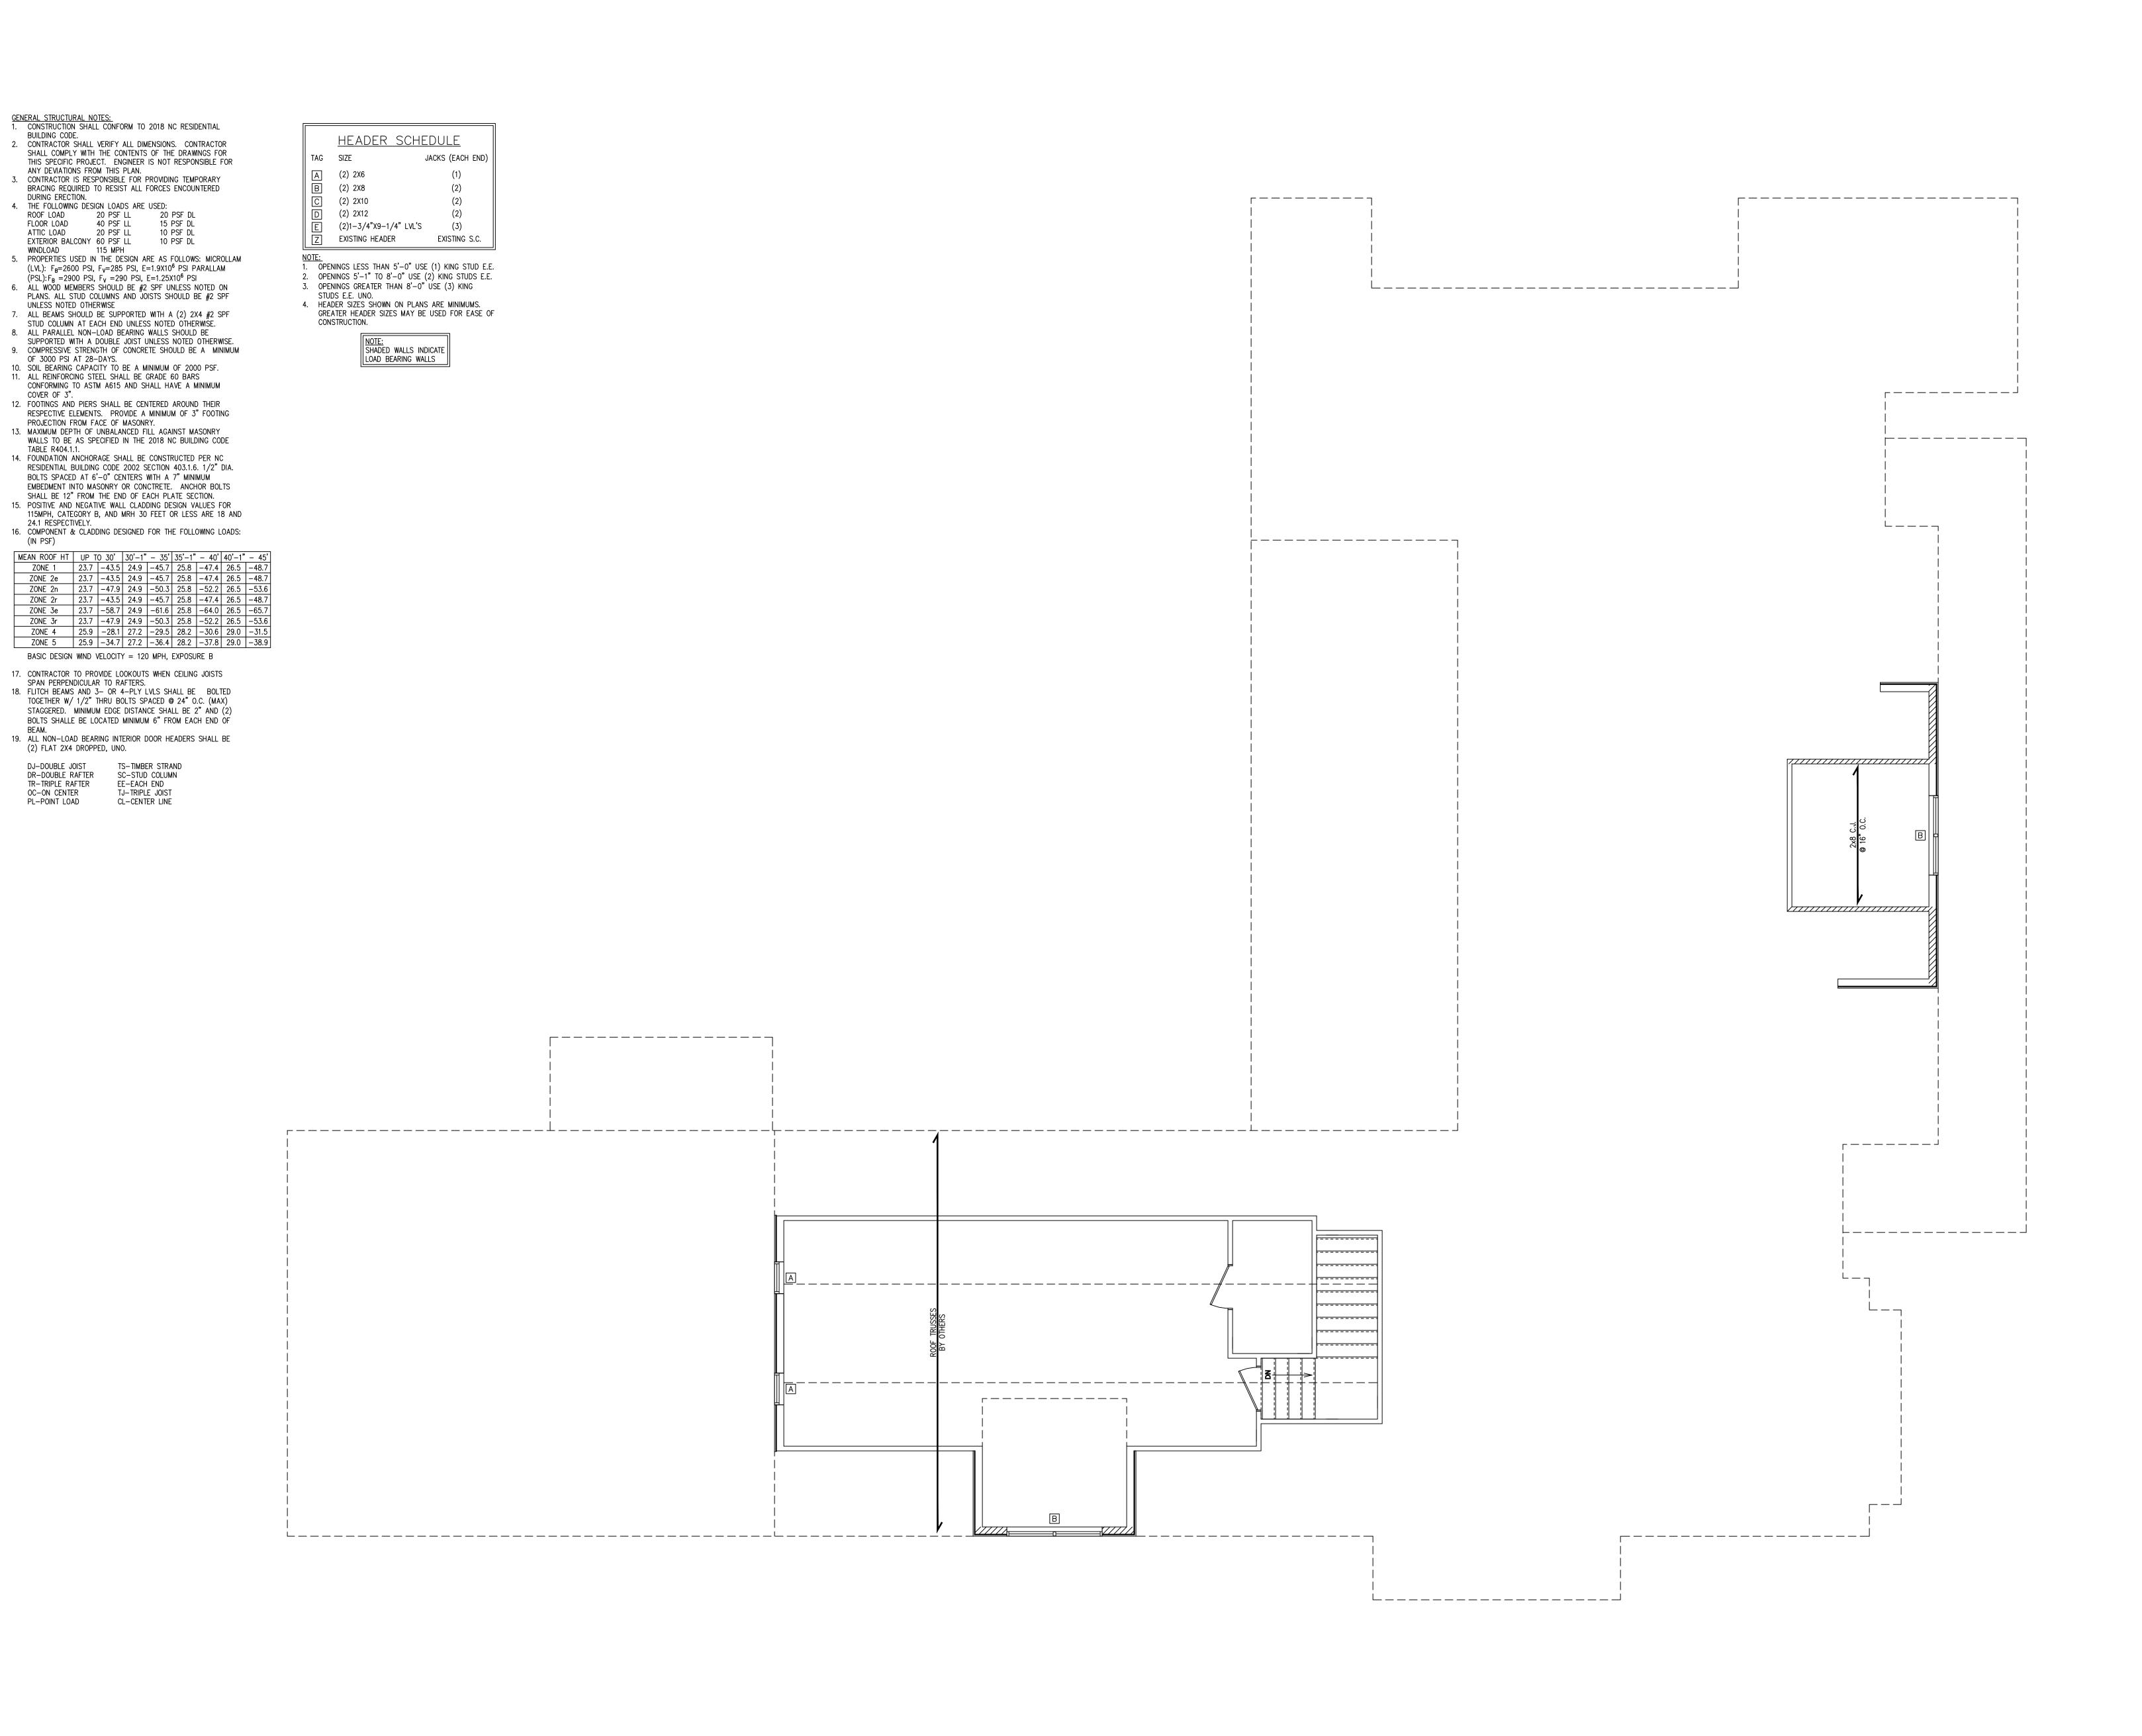

BUILDING CODE.

DURING ERECTION.

WINDLOAD 115 MPH

UNLESS NOTED OTHERWISE

OF 3000 PSI AT 28-DAYS.


COVER OF 3".

TABLE R404.1.1.


24.1 RESPECTIVELY.


(2) FLAT 2X4 DROPPED, UNO.

OC-ON CENTER
PL-POINT LOAD

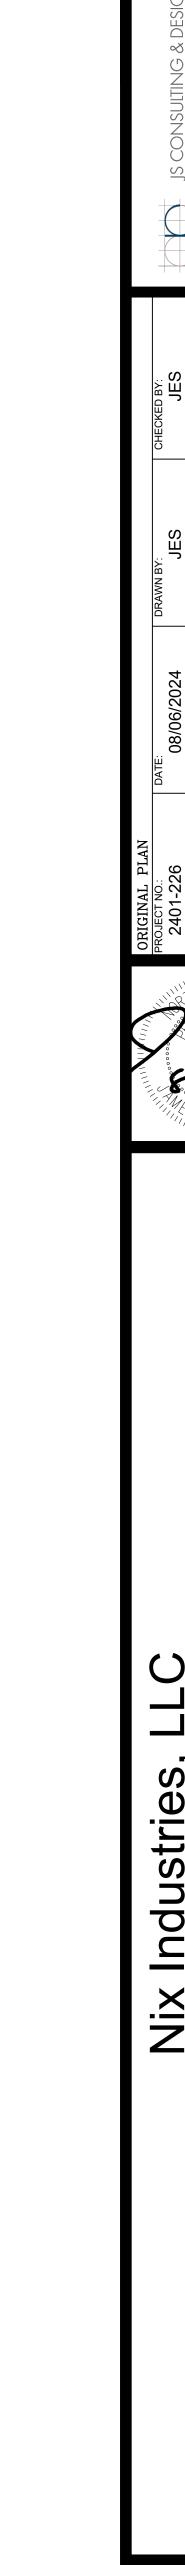



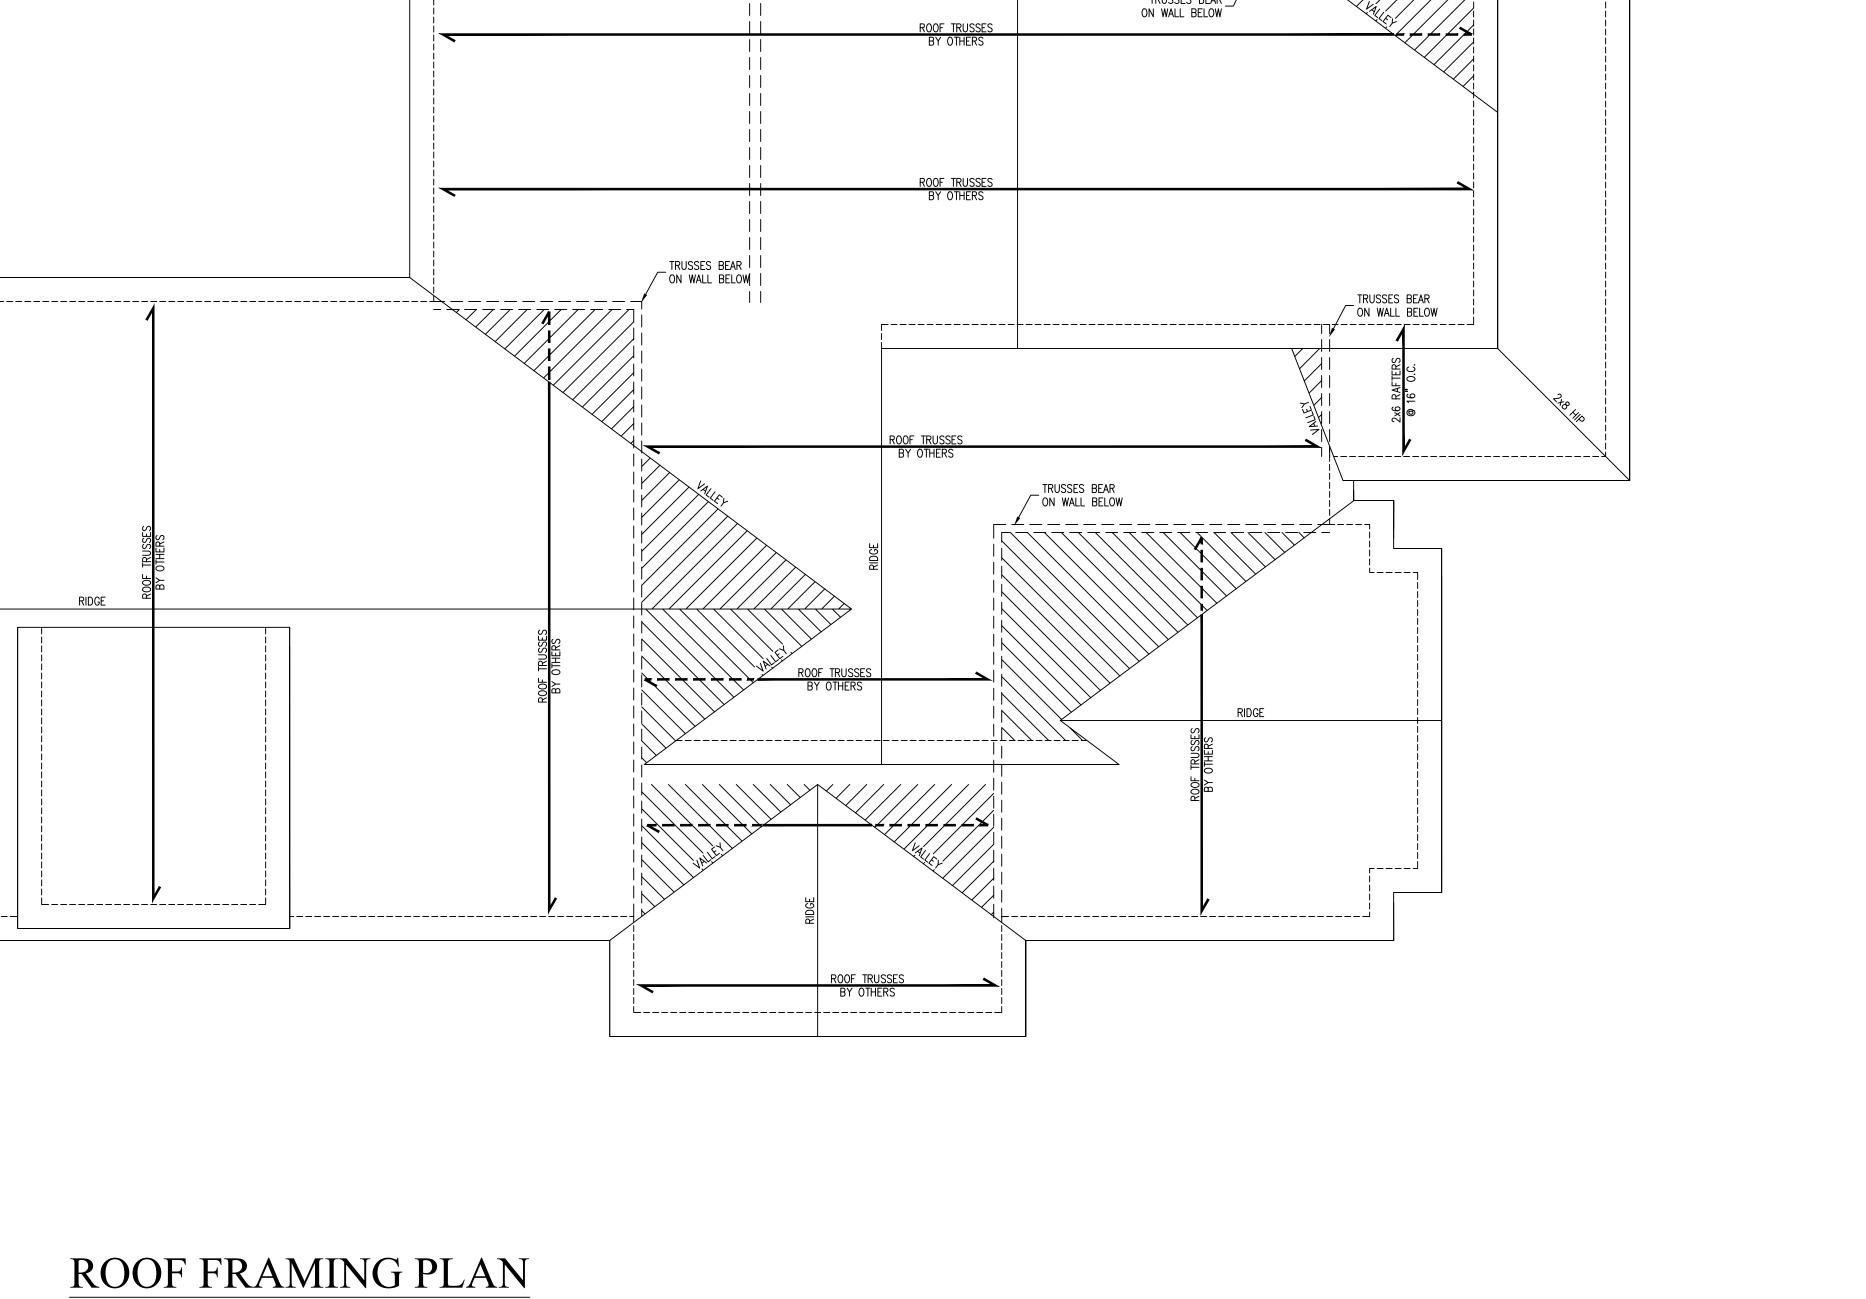

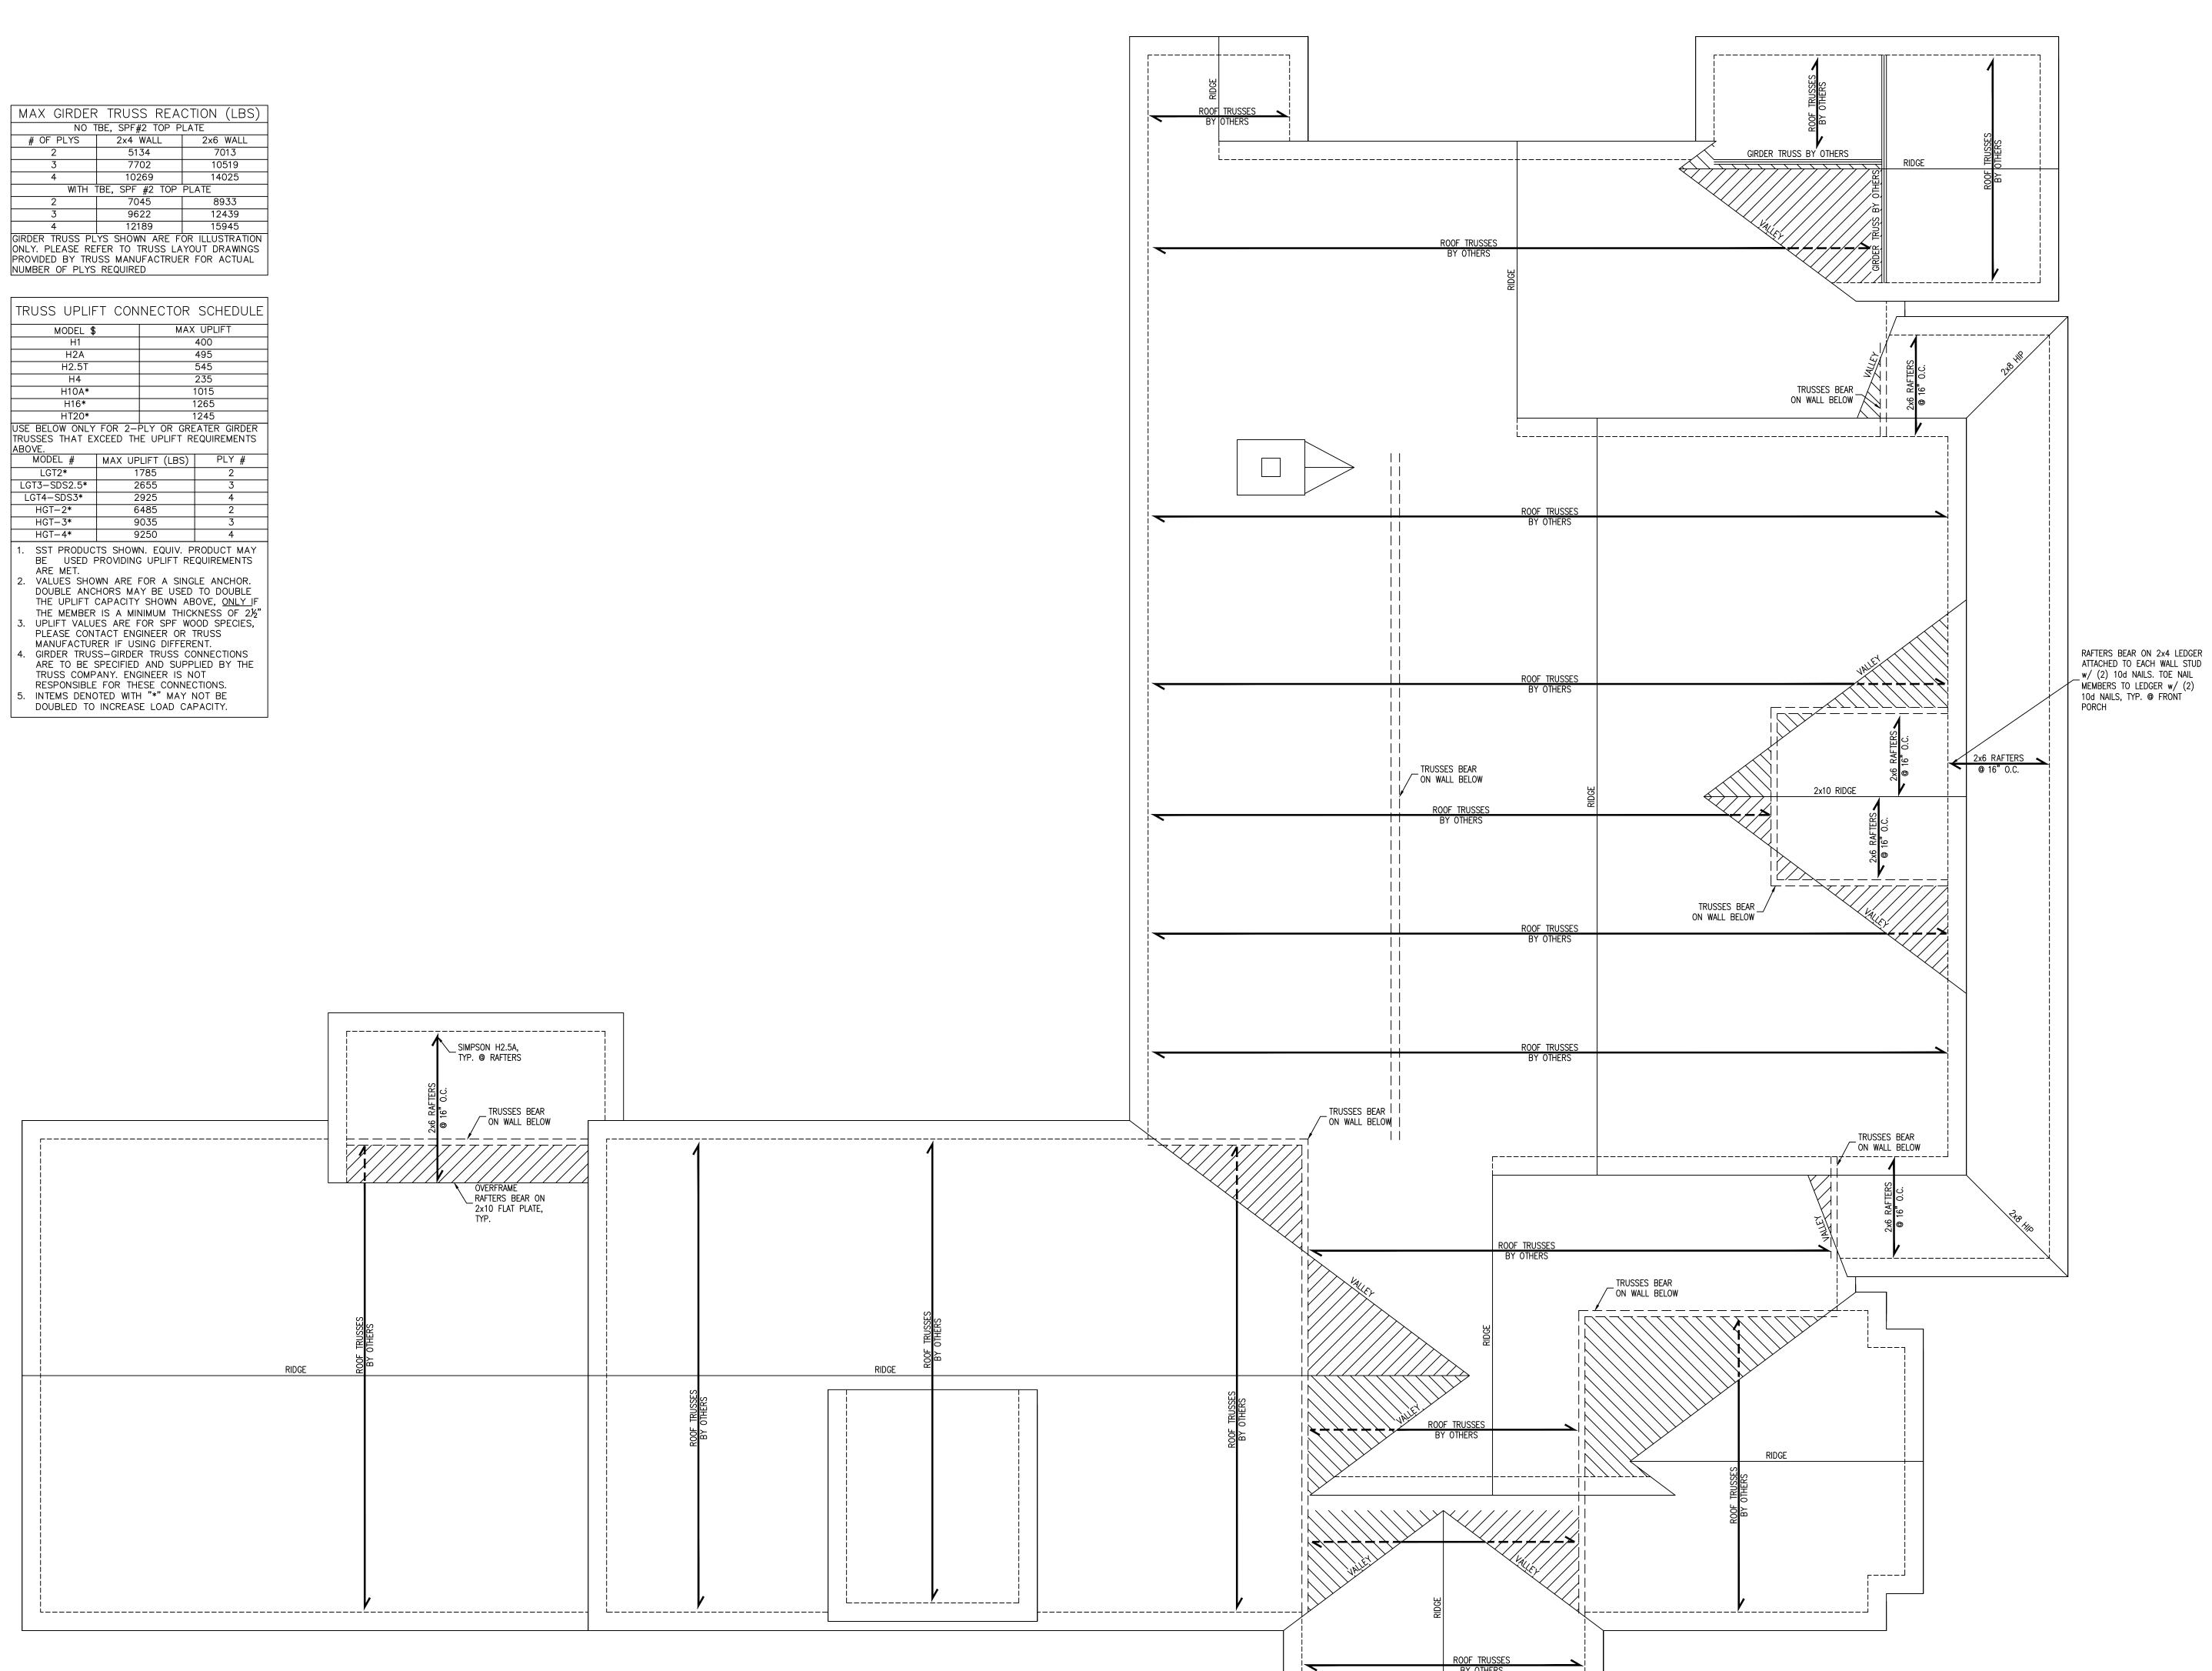



JS CONSUI	ENGINEERING 1	RALEIGH,	P (919) 6	(THE THE PART OF THE INTE
		3			
. S					

|--|





IS CONSULT	ENGINEERING AL	RALEIGH, N	P (919) 67	76 (212) 1	
		3			FLC

IS CONSUL	ENGINEERING	RALEIGH,	P (919) 67	0 (2 2)	CERTIFICATE NUMB


JS CONSULTINE ENGINEERING AN	11703 DURA RALEIGH, N	P (919) 675	70 (/1/)

	SEE PLAN		
· • • • •	4	4 ش س. د ه د د	
	WIDTH. SEE PLAN		

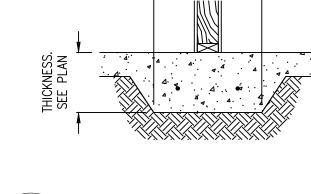

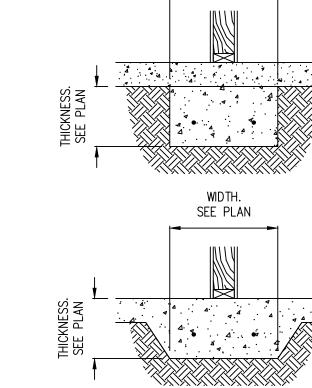




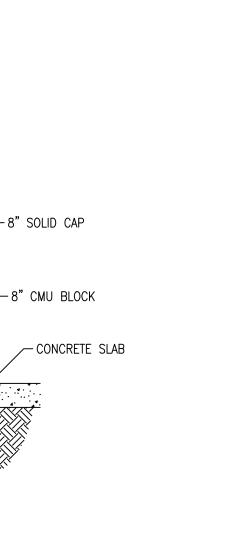


½"ø ANCHOR BOLTS W/ MIN. OF 7" EMBEDMENT @ 6'-0" O.C. AND 12" FROM ENDS OF SILL PLATE.

2x6 P.T. SILL PLATE

FND DRAINAGE PER CODE

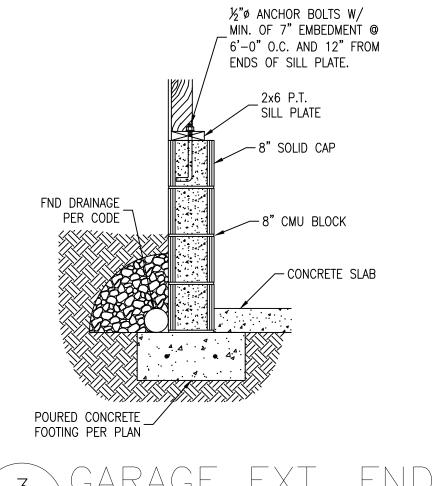

3/4" = 1'-0"

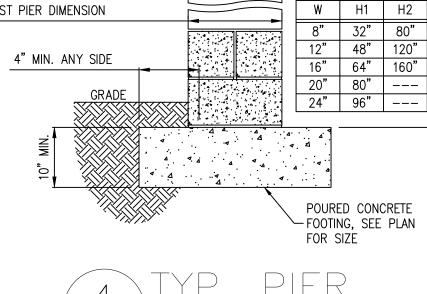


GIRDER SPLICE WITHIN CENTER 1/3 OF PIER

CMU, SEE CHART

'W' = LEAST PIER DIMENSION



2x6 TREATED

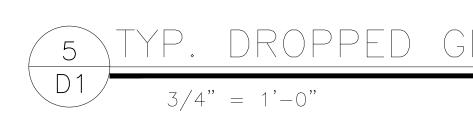


NOTE: FLOOR SHEATHING OMITTED FOR CLARITY

SOLID BLOCKING AT POINT LOADS, TYP.



DROPPED GIRDER,
SEE PLAN FOR
SIZE

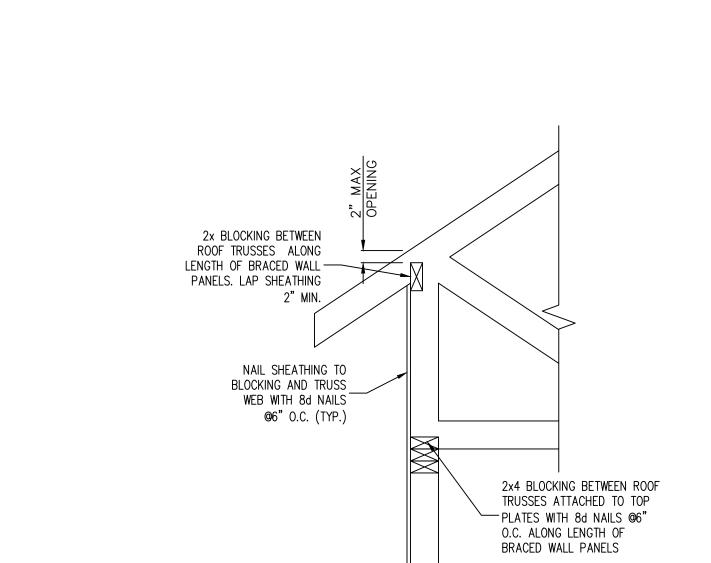

3/4" = 1'-0"


½"Ø ANCHOR BOLTS W/
MIN. OF 7" EMBEDMENT @
6'-0" O.C. AND 12" FROM
ENDS OF SILL PLATE.

POURED CONCRETE FOOTING PER PLAN

3/4" = 1'-0"


8" SOLID _ BRICK CAP


FND DRAINAGE PER CODE

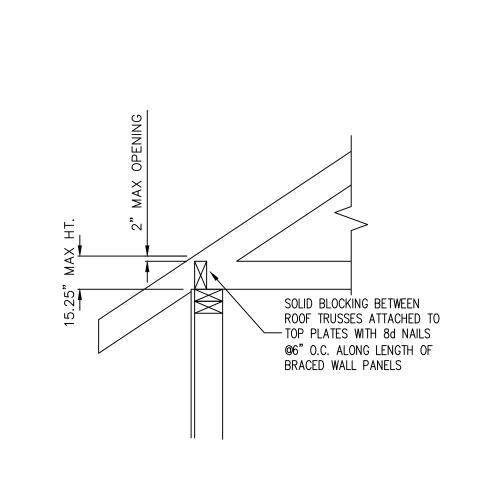


HEEL HEIGHT GREATER THAN 15.25"

HEEL HEIGHT LESS THAN 15.25"

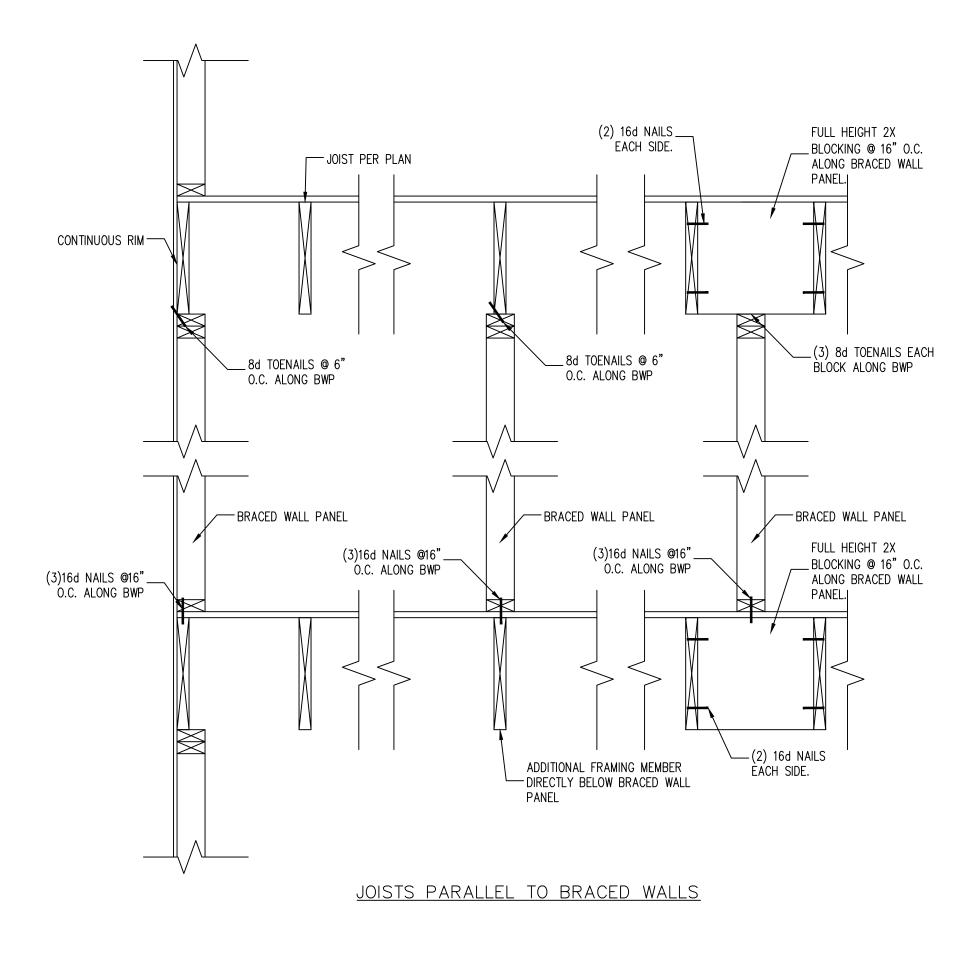


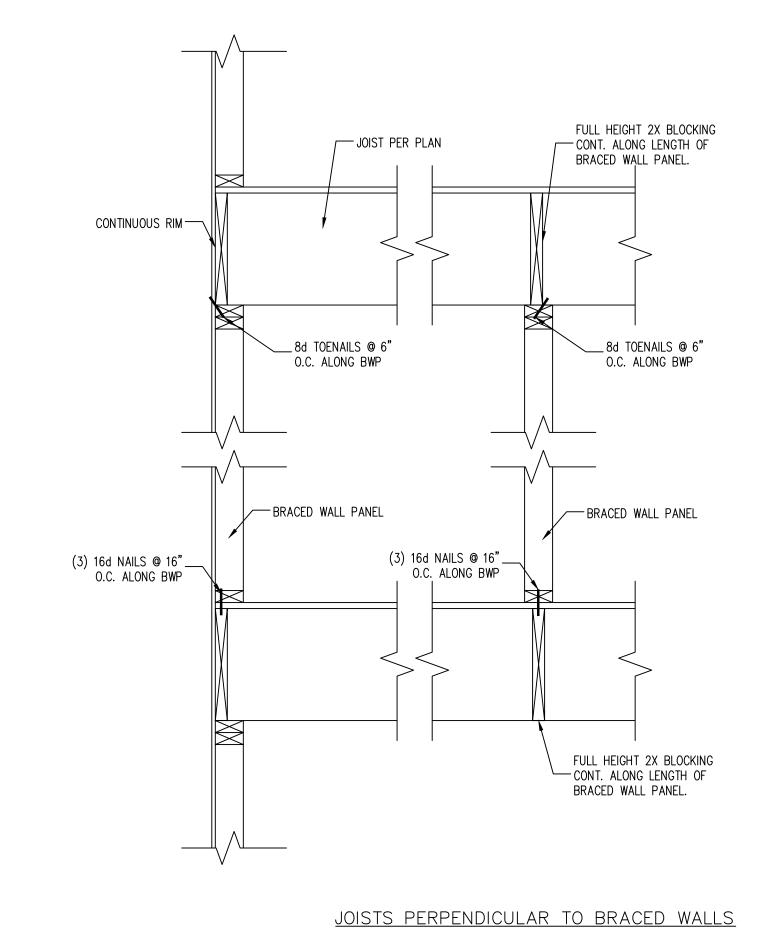


7 TYP. WALL PANEL TO ROOF TRUSS CONNECTION

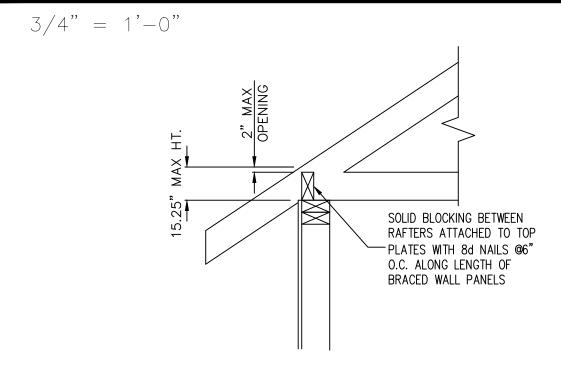



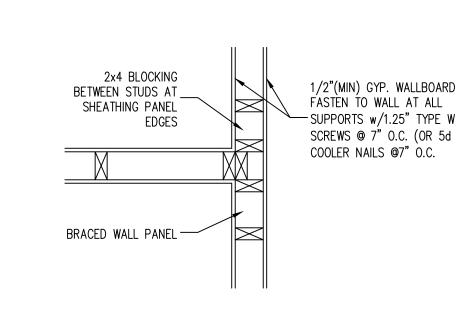

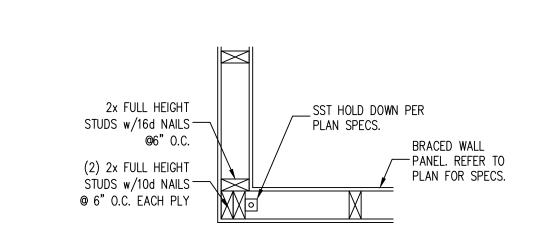

BRACED WALL
PANEL. REFER TO
PLAN FOR SPECS.


2x FULL HEIGHT STUDS w/16d NAILS @6" O.C.

_SST HOLD DOWN PER

11 INT. 3-STUD WALL INTERSECTION 3/4" = 1'-0"



(2)2x FULL HEIGHT STUDS w/10d NAILS @6" O.C. EACH PLY

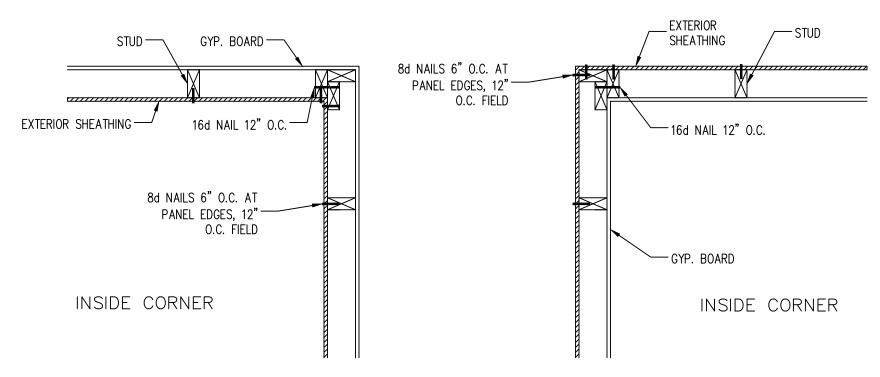


TYP. WALL PANEL TO RAFTER CONNECTION

TYP. EXTERIOR CORNER FRAMING

SHEET NUMBER

Nix Industries, LL Erwin Chapel Road, Dunn,


Details

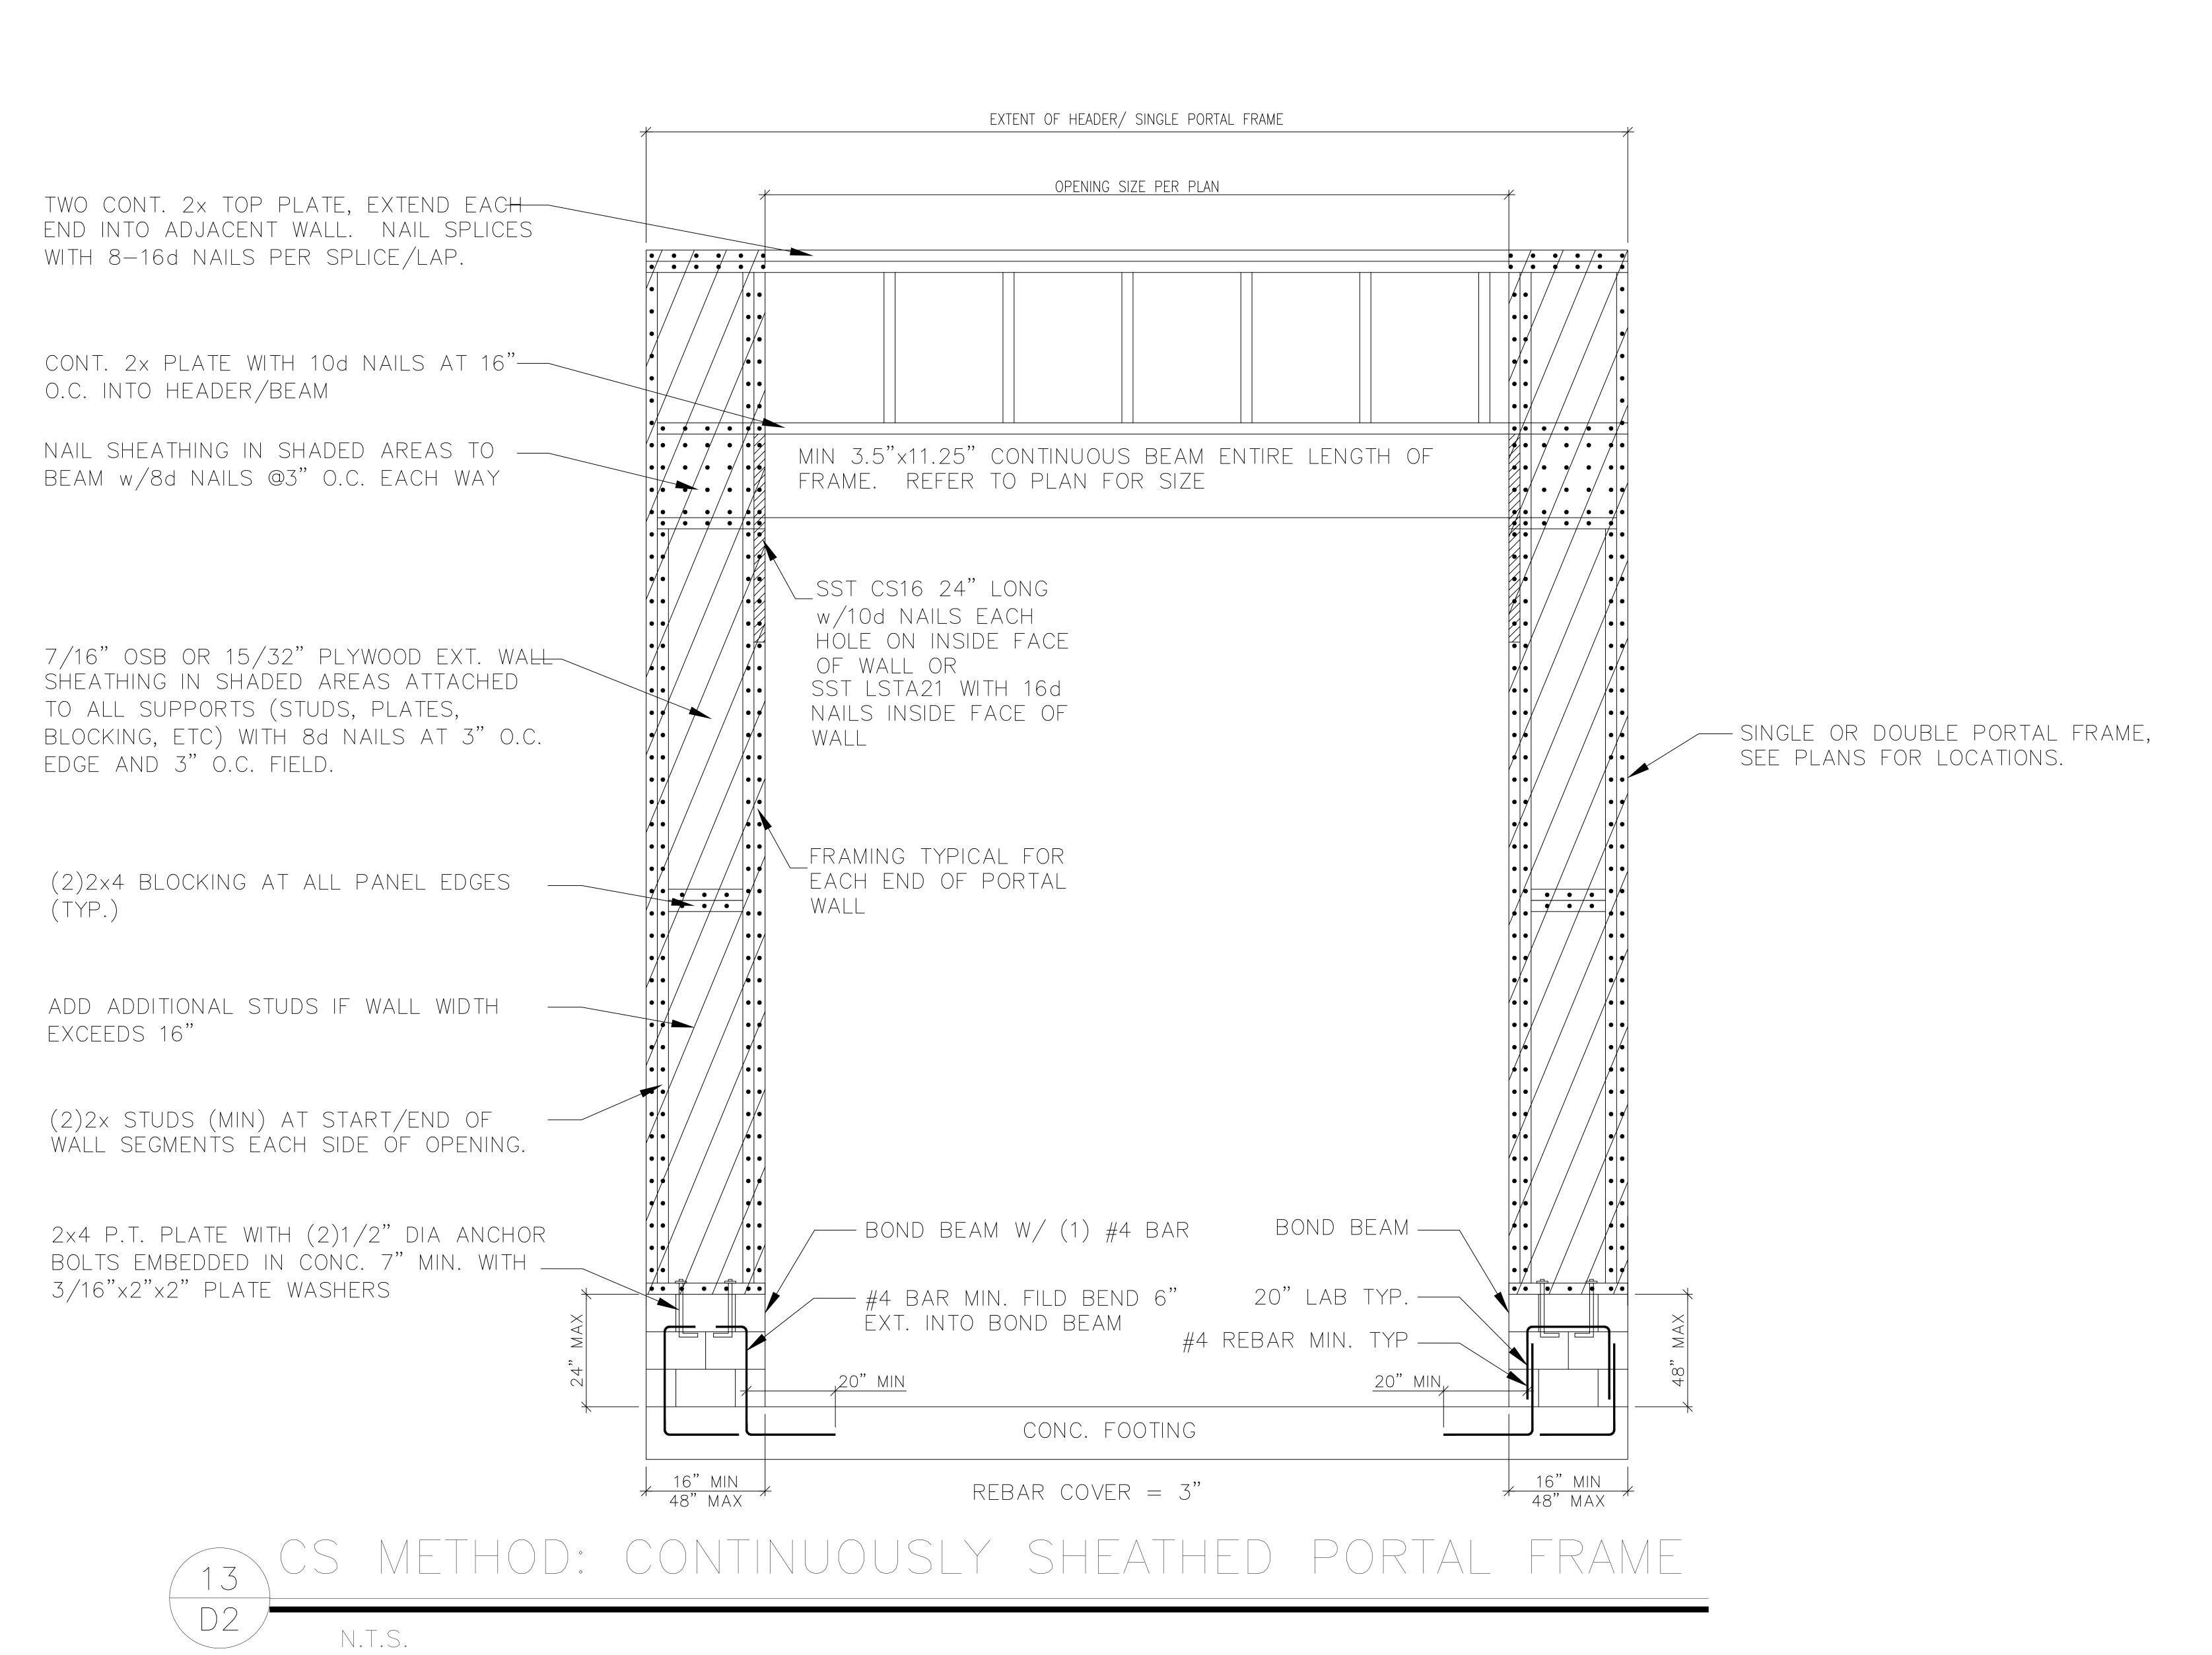


LLC In, NC

SHEET NU

D2

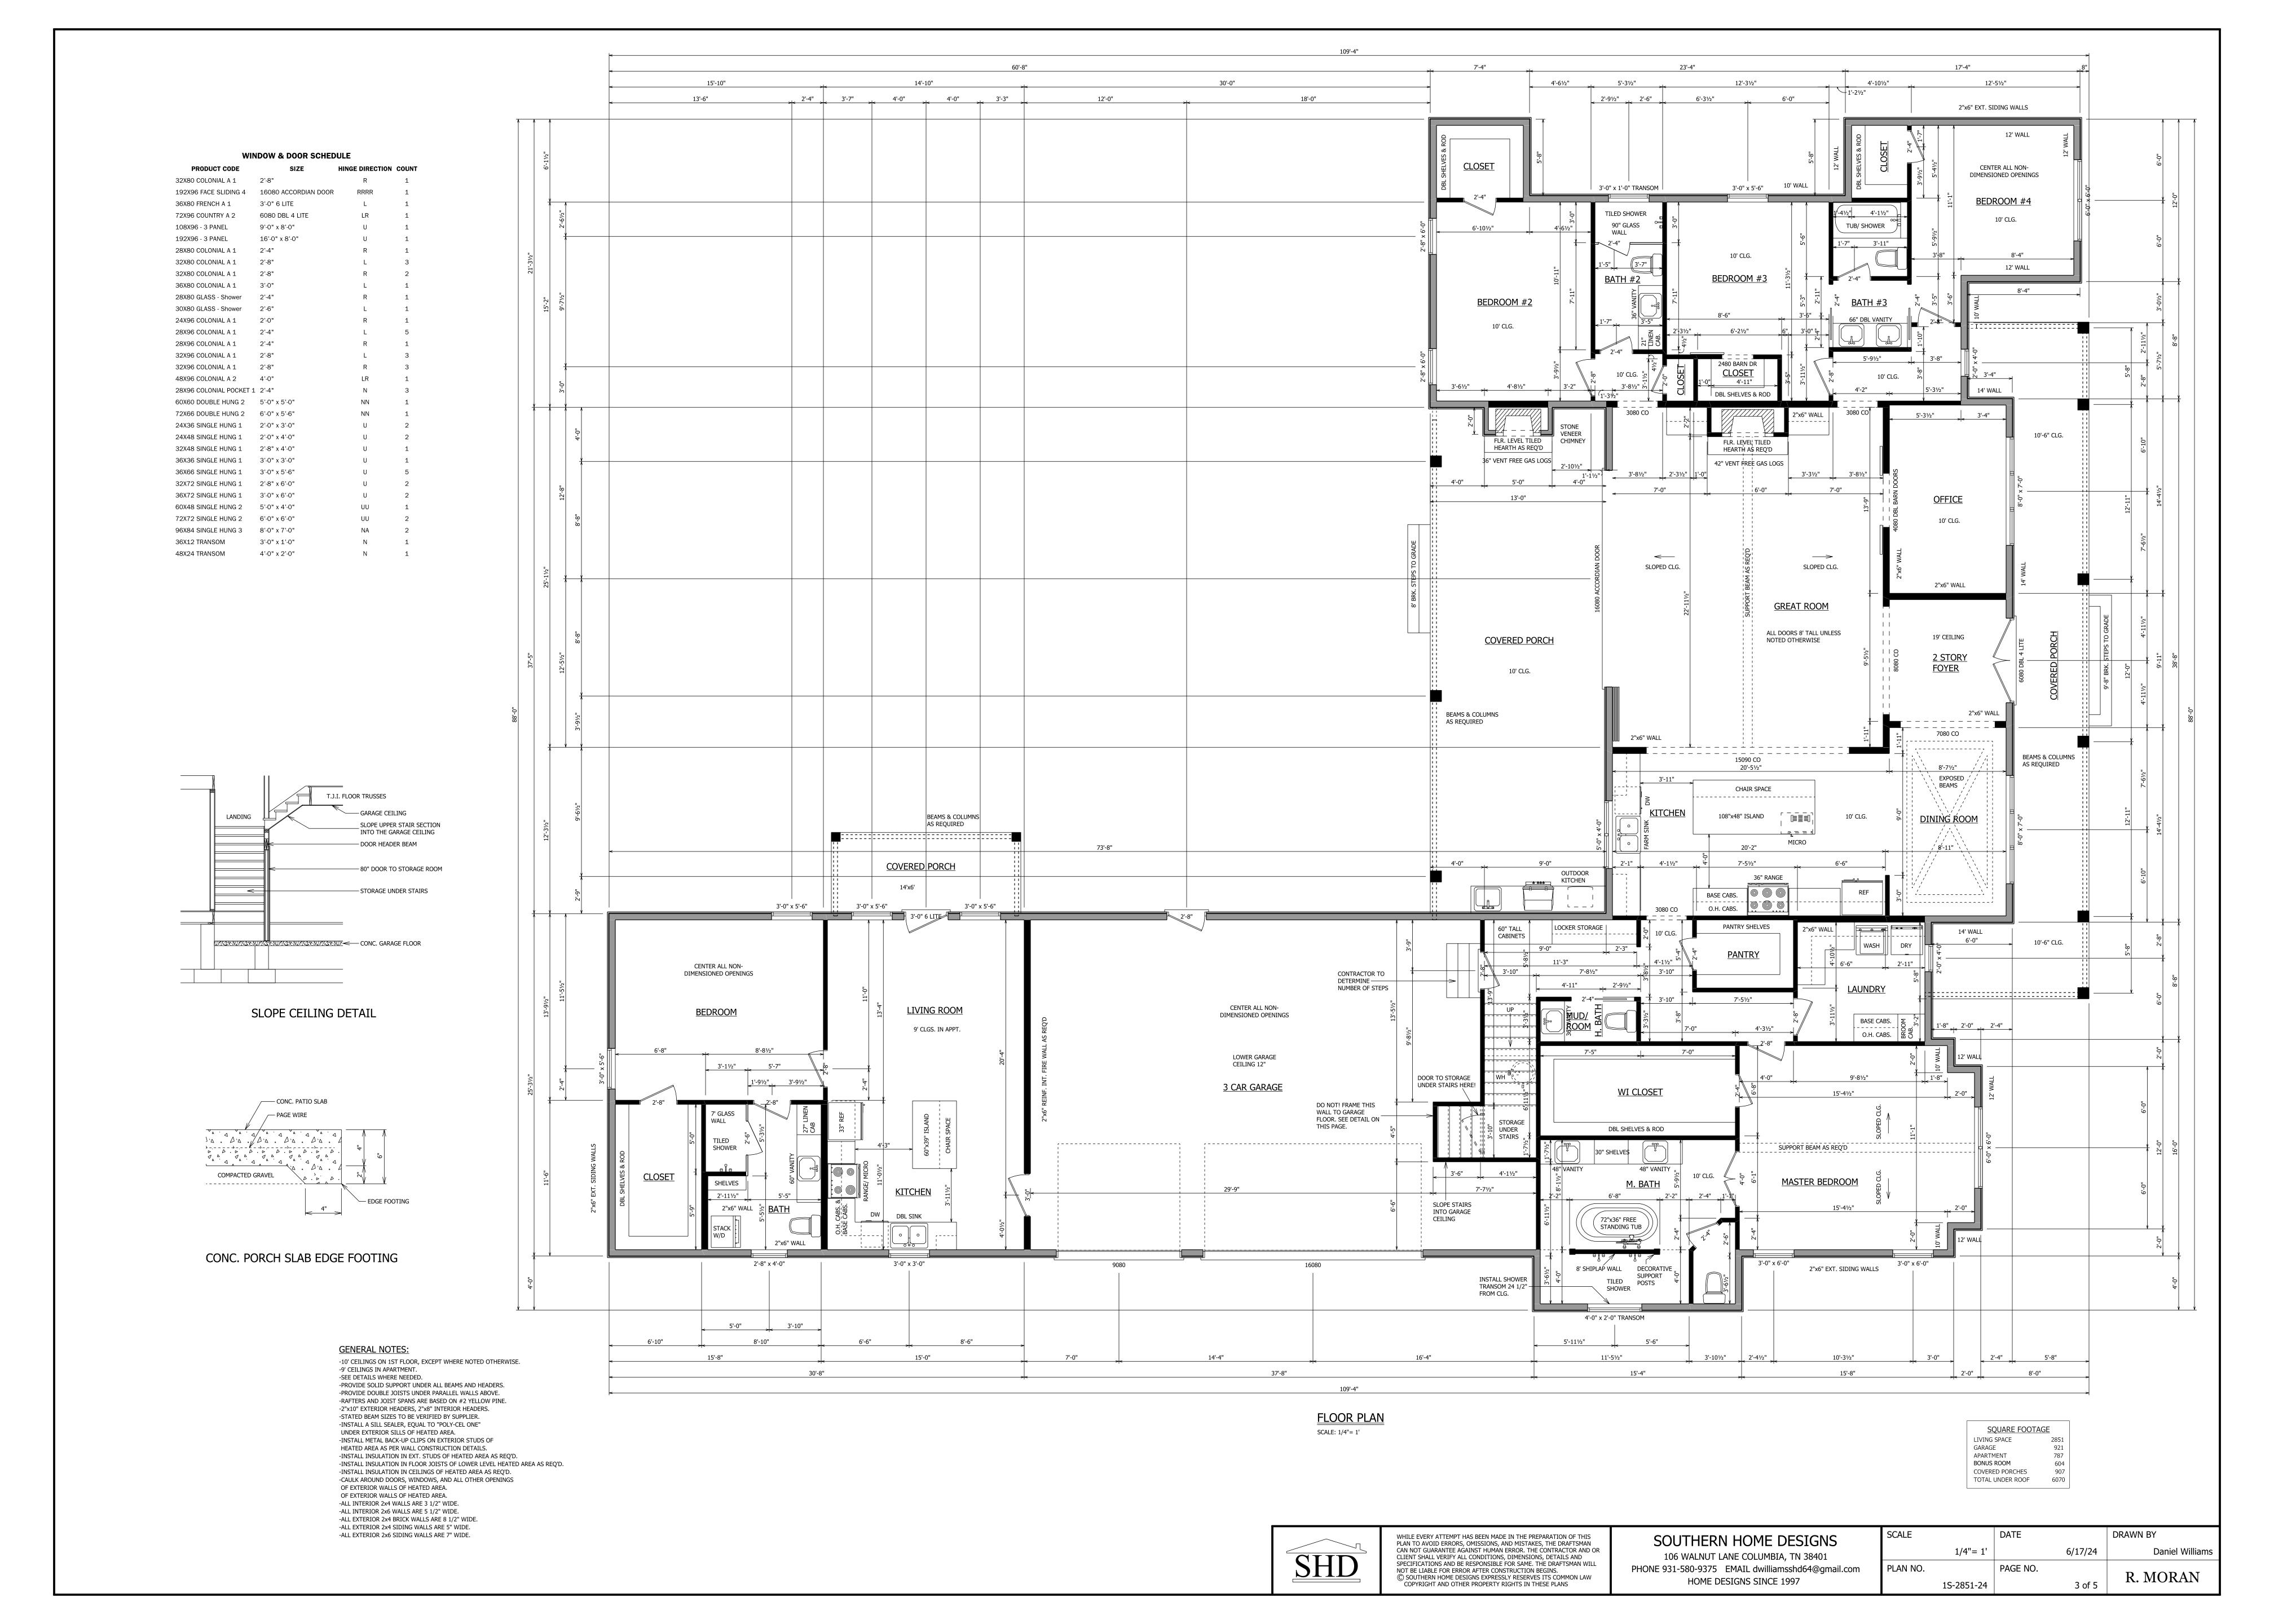

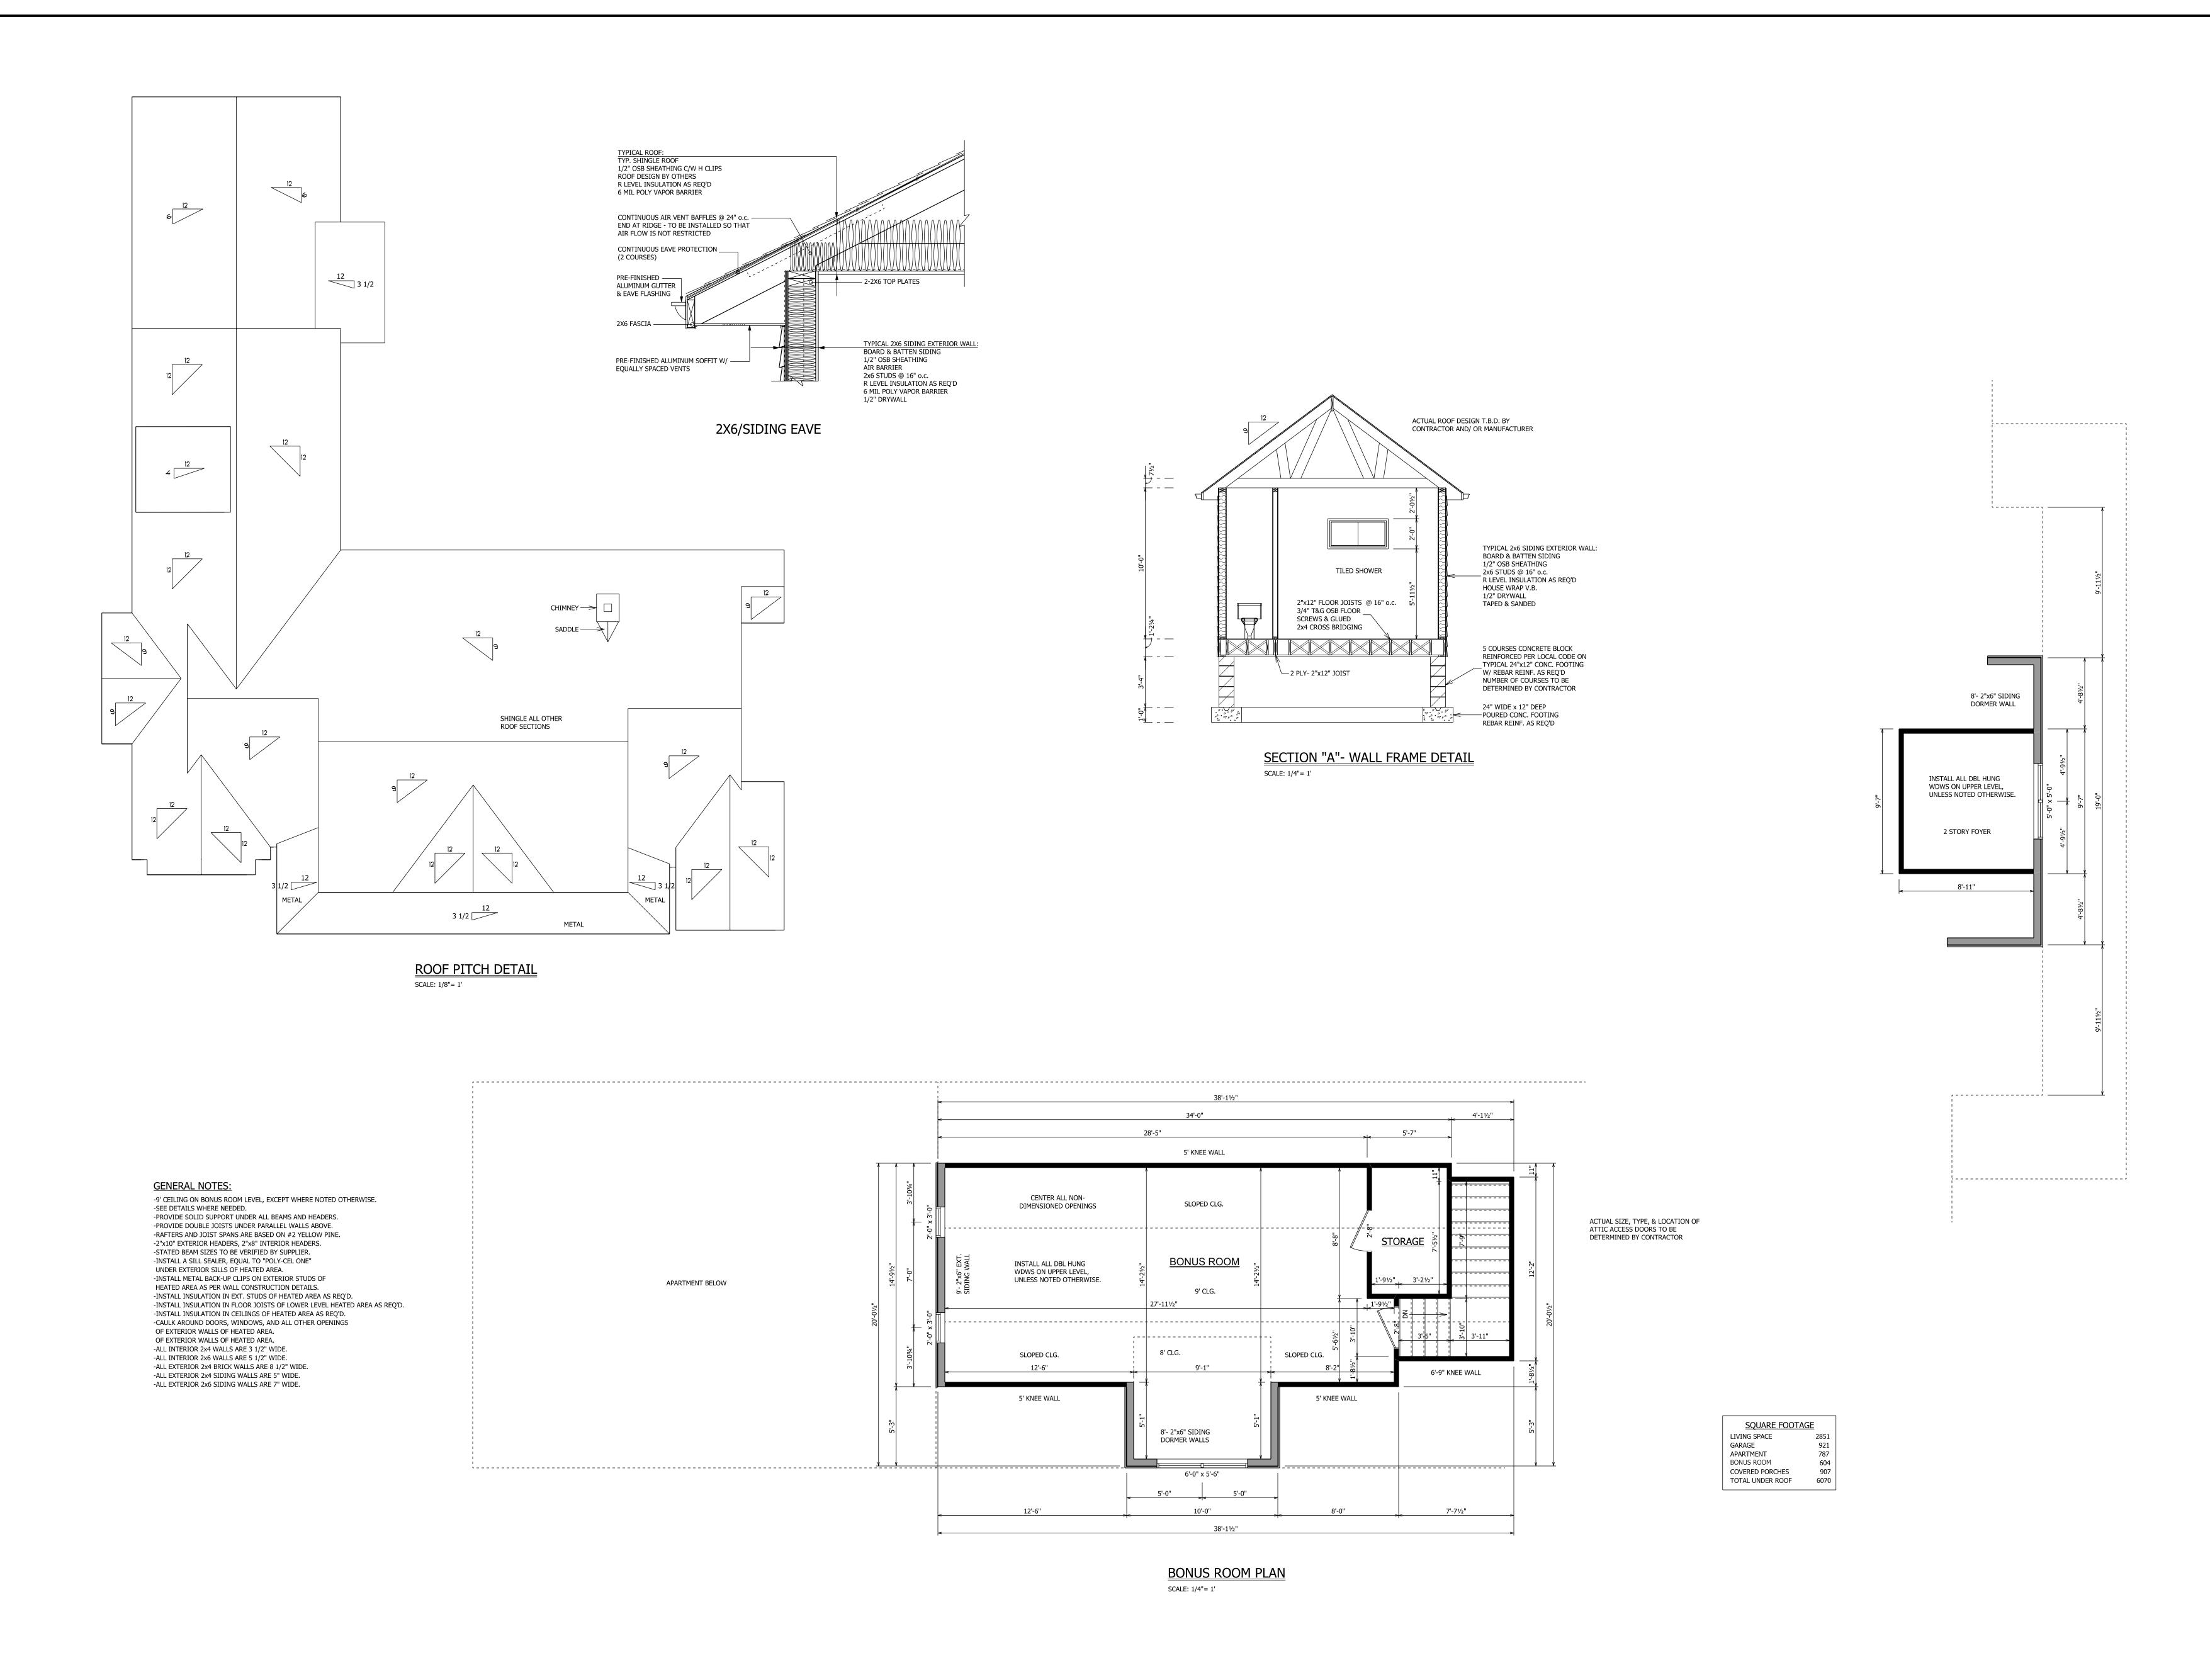

SCALE DRAWN BY WHILE EVERY ATTEMPT HAS BEEN MADE IN THE PREPARATION OF THIS PLAN TO AVOID ERRORS, OMISSIONS, AND MISTAKES, THE DRAFTSMAN SOUTHERN HOME DESIGNS CAN NOT GUARANTEE AGAINST HUMAN ERROR. THE CONTRACTOR AND OR CLIENT SHALL VERIFY ALL CONDITIONS, DIMENSIONS, DETAILS AND SPECIFICATIONS AND BE RESPONSIBLE FOR SAME. THE DRAFTSMAN WILL 1/4"= 1' 6/17/24 Daniel Williams 106 WALNUT LANE COLUMBIA, TN 38401 PHONE 931-580-9375 EMAIL dwilliamsshd64@gmail.com PLAN NO. PAGE NO. NOT BE LIABLE FOR ERROR AFTER CONSTRUCTION BEGINS.

© SOUTHERN HOME DESIGNS EXPRESSLY RESERVES ITS COMMON LAW
COPYRIGHT AND OTHER PROPERTY RIGHTS IN THESE PLANS R. MORAN HOME DESIGNS SINCE 1997 4 of 5 1S-2851-24