Residence for

Garman Homes Lot 0208 Serenity Fuquay Varina, North Carolina

INDEX TO DRAWINGS

COVER SHEET

- FRONT & LEFT SIDE ELEVATIONS **REAR & RIGHT SIDE ELEVATIONS**
- FIRST & SECOND FLOOR PLANS
- FIRST & SECOND FLOOR FLECTRICAL PLANS
- FIRST & SECOND FLOOR MECHANICAL PLANS
- FIRST FLOOR PLUMBING PLAN
- CONSTRUCTION DETAILS

GENERAL NOTES

- 1. ALL WORK TO BE DONE IN STRICT ACCORDANCE WITH NORTH CAROLINA STATE RESIDENTIAL BUILDING CODE, 2018 EDITION (HEREWITH SHOWN AS N.C.S.R.B.C.)
- 2. DIMENSIONS SHOWN ON DRAWINGS GOVERN OVER SCALE.
- 3. STUD WALL DESIGN SHALL CONFORM TO ALL N.C.S.R.B.C.
- 4. CONTRACTOR SHALL USE TEMPERED SAFETY GLASS IN ALL LOCATIONS AS REQUIRED BY N.C.S.R.B.C., 2018 EDITION, SECTION
- 5. ANY HABITABLE ROOM SHALL MEET ALL LIGHT/VENTILATION AND EGRESS AS REQUIRED BY N.C.S.R.B.C. 2018 EDITION, SECTIONS R-303.1 AND R-310.1.
- 6. ALL EXTERIOR WALLS SHOWN ON FLOOR PLANS ARE 2X6 FRAME UNLESS NOTED OTHERWISE. ALL INTERIOR WALLS SHOWN ON FLOOR PLANS ARE 2X4 FRAME UNLESS NOTED OTHERWISE.
- 7. ALL ANGLED WALLS SHOWN ON FLOOR PLANS ARE 45 UNLESS NOTED OTHERWISE.
- 8. ALL WINDOWS SHALL HAVE A MINIMUM DPI RATING OF 25. BUILDER SHALL VERIFY WITH WINDOW MANUFACTURER THAT UNITS INSTALLED MEET THESE REQUIREMENTS AS PER N.C.S.R.B.C., 2018 EDITION, TABLE 301.2(4).
- 9. ENERGY EFFICIENCY REQUIREMENTS FOR THE SPECIFIC CLIMATE ZONE WHERE STRUCTURE IS BEING BUILT SHALL BE IN ACCORDANCE WITH CHAPTER 11 OF THE N.C.S.R.B.C., 2018 EDITION, AS SHOWN IN SECTION N1101.2.

MATERIALS LEGEND

	EARTH/COMPACT FILL	FINISH WOOD
4 4	CONCRETE	ROUGH WOOD
	BRICK	BLOCKING
	CONCRETE BLOCK/STONE	PLYWOOD
	STEEL	BATT INSULATION
	ALUMINUM	RIGID INSULATION

ATTIC VENTILATION REQUIREMENTS

NATURAL ROOF VENTILATION CALCULATIONS

1340 SQ. FT. = 8.93 SQ. FT. VENT REQ'D

BUILDER TO PROVIDE APPROPRIATE VENTILATING AS REQUIRED PER CODE

MECHANICAL ROOF VENTILATION CALCULATIONS

<u>1340 SQ. FT.</u> = 4.47 SQ. FT. VENT REQ'D

BUILDER TO PROVIDE APPROPRIATE VENTILATING AS REQUIRED PER CODE

FOUNDATION PLAN & FIRST FLOOR FRAMING PLAN

- SECOND FLOOR FRAMING PLAN & ROOF FRAMING PLAN STRUCTUAL OPTIONS
- STRUCTURAL OPTIONS
 BRICK FOUNDATION PLAN- LEFT & RIGHT S5B
- STRUCTURAL DETAILS

RESIDENTIAL BUILDING CODE SUMMARY

- 1. PLANS ARE DESIGNED TO THE 2018 N.C.S.R.B.C.
- 2. HOUSE IS DESIGNED FOR 115 MPH ULTIMATE DESIGN WIND SPEED (89 MPH NOMINAL DESIGN WIND SPEED), EXPOSURE B.
- 3. ANCHOR BOLTS SHALL BE MIN. 1/2" DIAMETER AND SHALL EXTEND 7" MIN. INTO MASONRY OR CONCRETE. BOLTS TO BE NO MORE THAN 6' O.C. AND WITHIN 12" FROM THE CORNER.
- 4. MEAN ROOF HEIGHT: 28'-5"
- 5. COMPONENT & CLADDING DESIGNED FOR THE FOLLOWING LOADS:

MEAN ROOF HGT:	UP TO 30'	30'-1" TO 35'	35'-1" TO 40'	40'-1" TO 45
ZONE 1	16.5,-18.0	17.3,-18.9	17.3,-18.9	17.3,-18.9
ZONE 2	16.5,-21.0	17.3,-22.1	17.3,-22.1	17.3,-22.1
ZONE 3	16.5,-21.0	17.3,-22.1	17.3,-22.1	17.3,-22.1
ZONE 4	18.0,-19.5	18.9,-20.5	18.9,-20.5	18.9,-20.5
ZONE 5	18 0 -24 1	18 9 -25 3	18 9 -25 3	18 9 -25 3

- 6. MINIMUM VALUES FOR ENERGY COMPLIANCE: Zone 4
- 7. MAXIMUM GLAZING U-FACTOR: .35
- 8. INSULATING VALUES: CEILING: R-49 / WALLS: R-15 / FLOOR: R-19 SLABS: R-10. CODE REFERENCE: TABLE N1102.1

AREA CALCULATIONS

HEATED (SQ. FT.)		UNHEATED (SQ. FT.)		UNFINISHED (SQ. FT.)	
1ST FLOOR: 2ND FLOOR: TOTAL:	830 1112 1942	FRONT PORCH: GARAGE: PATIO:	85 425 100	BASEMENT: 1ST FLOOR: 2ND FLOOR: ATTIC:	N/A N/A N/A N/A
		TOTAL:	610	TOTAL:	N/A
				OVERALL DIMEN WIDTH: DEPTH:	NSIONS 34'-4" 50'-2"

FOUNDATION VENTILATION CALCULATIONS

(REFERENCE: N.C.S.R.B.C. 2018 EDITION SECTION R408.)

NOT APPLICABLE WITH SLAB FOUNDATIONS



PATIO

10'-0"x10'-0"

KITCHEN

GARAGE

19'-8"x20'-10"

DINING

10'-2"x12'-10"

FAMILY

14'-0"x16'-4"

STUDY


FRONT PORCH

FOYER





Drawn Bv Checked By Date Drawn 3/15/20 **Revision Date** 7/2/20 4/5/22 10/26/22 2/22/23

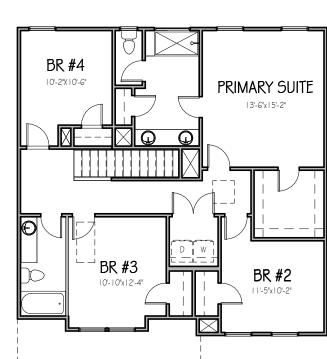

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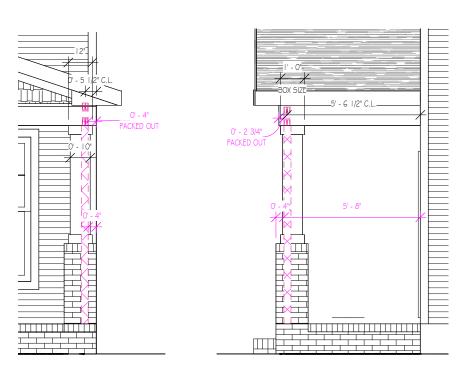
LOT 0208 SERENITY

Homes, Inc. All right

Project Number

Project Number

Plan Number FP-1942



COLUMN DETAILS

ASSUME ALL RESPONSIBILITY TO THE ACCURACY OF THE PLANS AND ANY CHANGES MADE DURING CONSTRUCTION. RIDGE VENT 12 10 / 12 FIBERGLASS SHINGLE ROOF (CLASS 'C' MIN.) 8" TRIM W/ DRIP CAP TRUSS BRIDGE WINDOWS SHAKE SIDING 4" TRIM @ WINDOWS AND DOORS CORNER TRIM AS SPEC 2ND FIN. FLR NOTE: PROVIDE RAILS @ PORCH ONLY IF REQUIRED BY CODE CEMENTITIOUS SIDING -WINDOWS 10" SQ. COL. WITH 12" BOX ON 16" 5Q. BRICK PIER IST FIN. FLR. SLAB (MAIN HOUSE) STEPS TO GRADE BRICK VENEER FND. BRICK FND. WALL @ FRONT NOTE - SLOPE ALL GRADE AWAY FROM HOUSE FOR POSITER DELINAGE

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Project Number Project Number Plan Number FP-1942

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HONEYSUCKI

SER ELEVATION B LOT 0208 SERENITY


15" MIN. HGT. FOUNDATION FRONT

GRADE TO FINISHED FRONT PORCH

THE PURPOSE OF THESE DRAWINGS IS TO SHOW THE INTENT OF THE DESIGN AND CONSTRUCTION OF THIS HOME.
CONTRACTOR SHOULD VERIFY ALL
CONDITIONS AND DIMENSIONS PRIOR TO CONSTRUCTION. ONCE A PERMIT HAS BEEN ISSUED, CONTRACTOR SHALL

FRONT ELEVATION

1/8" = 1'-0"

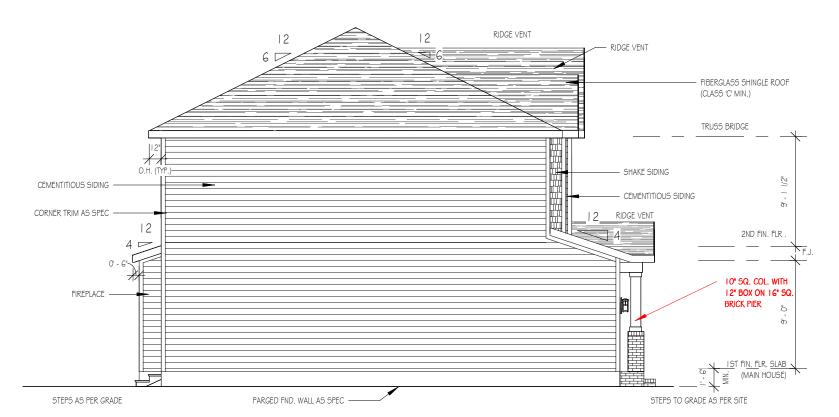

ONLY (TYP. WHERE SHOWN)

LEFT SIDE ELEVATION


1/8" = 1'-0"

Drawn By Checked By CM Date Drawn 4/8/20 **Revision Date** 7/1/20 4/5/22 2/22/23 Sheet

REAR ELEVATION

1/8" = 1'-0"

NOTE - SLOPE ALL GRADES AWAY FROM HOUSE FOR POSITIVE DRAINAGE

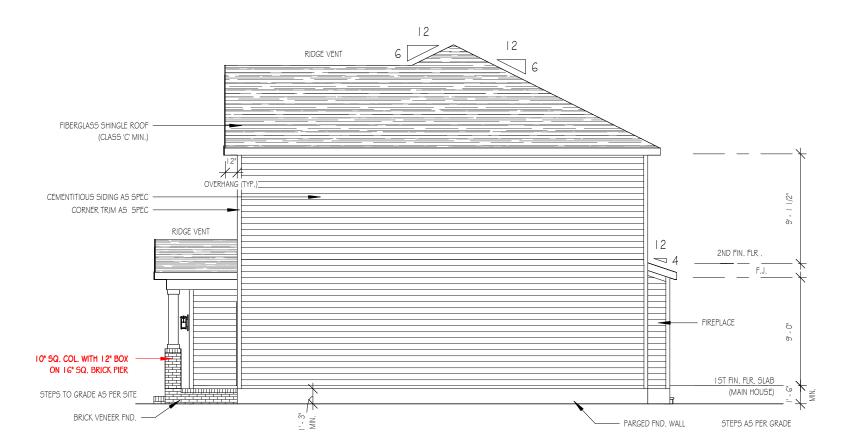

RIGHT SIDE ELEVATION

1/8" = 1'-0"

THE PURPOSE OF THESE DRAWINGS IS TO SHOW THE INTENT OF THE DESIGN AND CONSTRUCTION OF THIS HOME. CONTRACTOR SHOULD VERIFY ALL CONDITIONS AND DIMENSIONS PRIOR TO CONSTRUCTION. ONCE A PERMIT HAS BEEN ISSUED CONTRACTOR SHALL BEEN ISSUED, CONTRACTOR SHALL ASSUME ALL RESPONSIBILITY TO THE ACCURACY OF THE PLANS AND ANY CHANGES MADE DURING CONSTRUCTION.




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HONEYSUCKLE SER ELEVATION B LOT 0208 SERENITY

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Date Drawn	
4/8/20	
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7/1/20	
4/5/22	
2/22/23	



UPGRADE: SHOWER NICHE

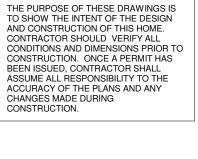3/0x5/0 St

14' - 2"

PRIMARY SUITE

BR #2

11' - 9"

4' - 8"

2-3/0x5/0 SH

5' - 2"

14' - 6"

SHOWER BENCH 20"H

10' - 6"

BR #4

25.5"X54" PDS

BR #3

11' - 2"

DSP 2-3/0x5/0 SH

11 1/2" 3' - 3" 2' - 11 1/2

9' - 2"

19' - 10"

2/0x4/0

SPECIAL FIRE

RATED WALL

ASSEMBLY

 \bigoplus

5' - 4"

34' - 4"

4/0x1/0 FXD

6' - 0"

86" V(N)

5' - 4"

34' - 4"

4' - 10"



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SPECIAL FIRE

RATED WALL

ASSEMBLY

FP-1942

HONEYSUCKL SER ELEVATION B LOT 0208 SERENITY

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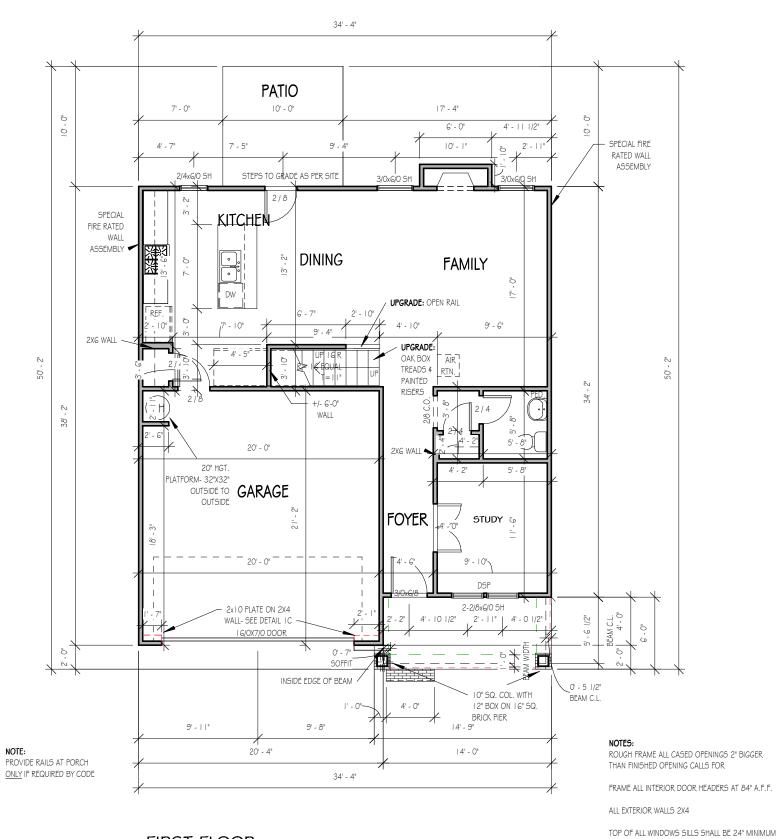
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SECOND FLOOR

1/8" = 1'-0"

9'-0" CLG. HGT. U.N.O.


SET WINDOWS @ 7'-4" U.N.O.




FIRST FLOOR

9'-0" CLG. HGT. U.N.O. SET WNDOWS @ 7'-6" U.N.O. CASED OPENINGS 8'-0" TALL ABOVE THE FINISHED FLOOR <u>OR</u> A FALL PREVENTION DEVICE SHALL BE INSTALLED IN ACCORDANCE WITH SECTION R312.2 OF N.C.S.R.B.C., 2018 EDITION

GBG (GRILL BETWEEN GLASS) TO BE ADDED TO CORNER LOT WINDOWS

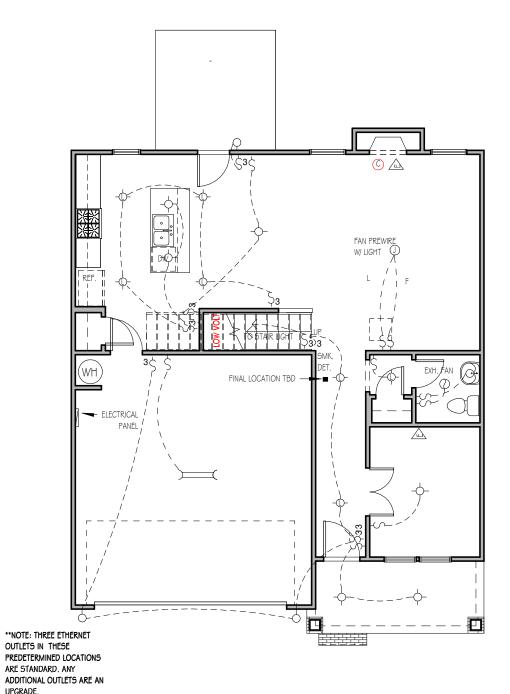

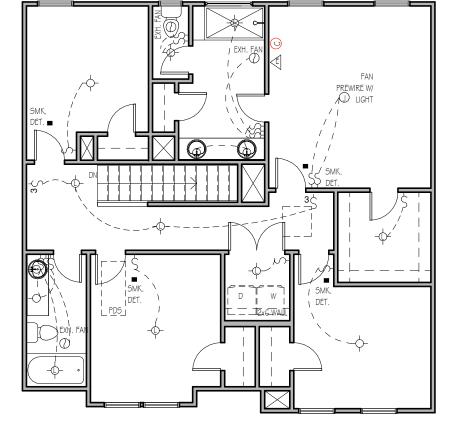

FIRST FLOOR ELECTRICAL PLAN

1/8" = 1'-0"

UPGRADE.

NOTE - ELECTRICAL RECEPTACLE AND SWITCH QUANTITIES AND LOCATIONS SHOWN ON PLAN ARE FOR ILLUSTRATION PURPOSES ONLY. ACTUAL NUMBER AN D LOCATIONS SHALL BE FIELD DETERMINED AS PER CLIENT AND BUILDER EXCEPT WHERE CODE REQUIREMENTS APPLY.

SECOND FLOOR ELECTRICAL PLAN

1/8" = 1'-0"

NOTE - ELECTRICAL RECEPTACLE AND SWITCH QUANTITIES AND LOCATIONS SHOWN ON PLAN ARE FOR ILLUSTRATION PURPOSES ONLY. ACTUAL NUMBER AN D LOCATIONS SHALL BE FIELD DETERMINED AS PER CLIENT AND BUILDER EXCEPT WHERE CODE REQUIREMENTS APPLY.

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ELECTRICAL LEGEND

T THERMOSTAT

O DOORBELL

D.B.

-- LED DISK LIGHT

WALL SCONCE

◆ FLOOD LIGHT

16

Œ

0

- KEYLESS LIGHT

RECESSED CAN LIGHT

CEILING FAN

ETHERNET OUTLET

EXHAUST FAN

CABLE OUTLET SMOKE DETECTOR

FLOOR RECEPTACLE

DUPLEX RECEPTACLE

GFCI RECEPTACLE

■ ELECTRICAL PANEL

220 VOLT RECEPTACLE

3-WAY SWITCH DIMMER SWITCH



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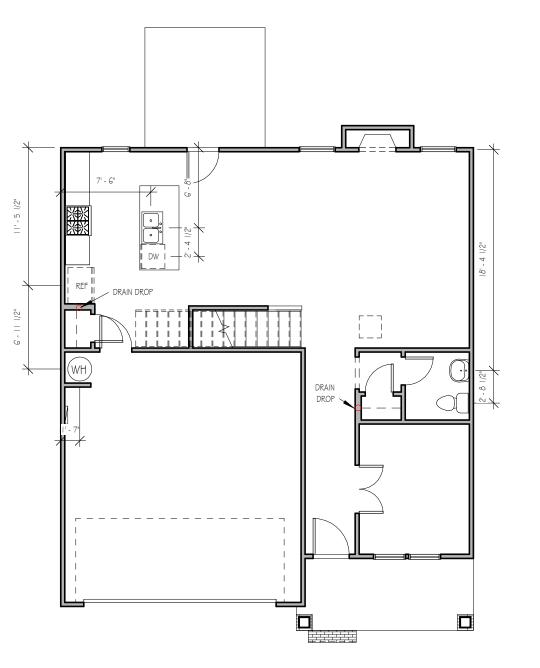
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HONEYSUCKL SER ELEVATION B LOT 0208 SERENITY

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FIRST FLOOR PLUMBING

1/8" = 1'-0"

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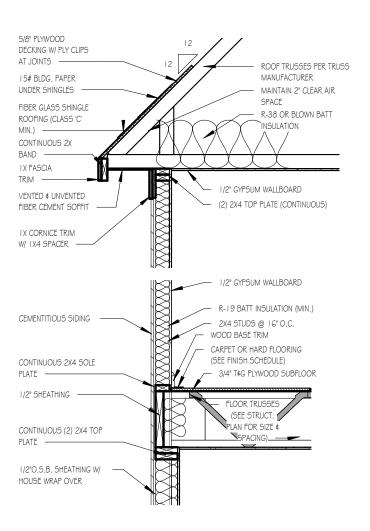
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HONEYSUCKLE SER ELEVATION B LOT 0208 SERENITY

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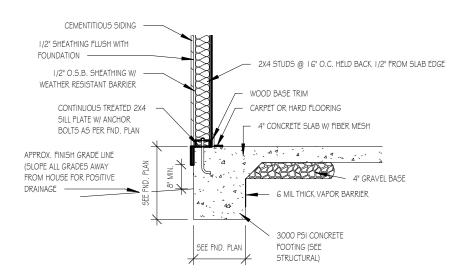
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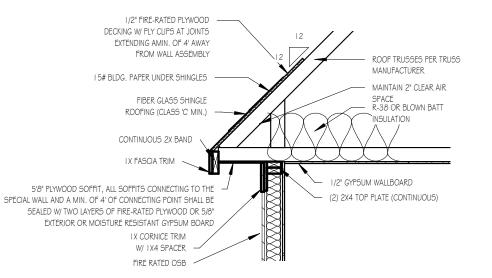
TWO-STORY WALL SECTION

1/2" = 1'-0"




FOUNDATION DETAIL - SLAB

1/2" = 1'-0"




ROOF DETAIL SPECIAL FIRE-RATED WALLS

1/2" = 1'-0"

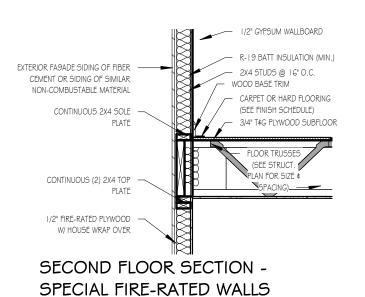

1/2" = 1'-0"

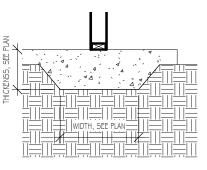

LUG FOOTING


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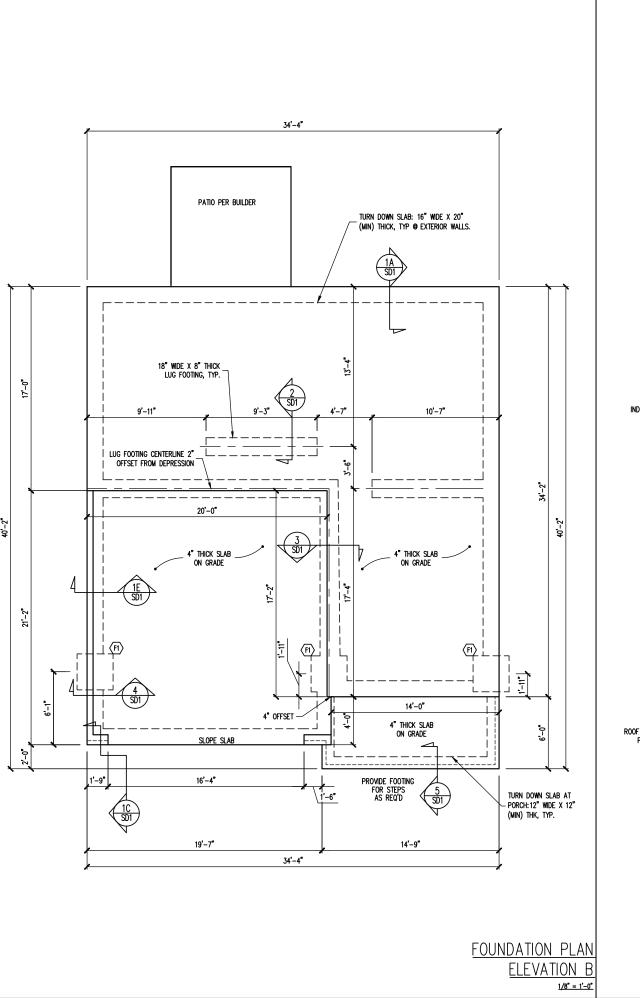
SERENITY COLLECTION




FRONT PORCH COLUMNS SUPPORT ATTACHMENT

Drawn By MMH Checked By JM Date Drawn 10/28/20 **Revision Date** 9/14/22 9/20/22

1/2" = 1'-0"

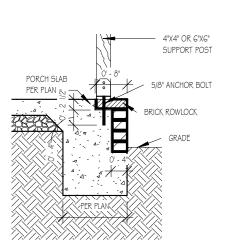

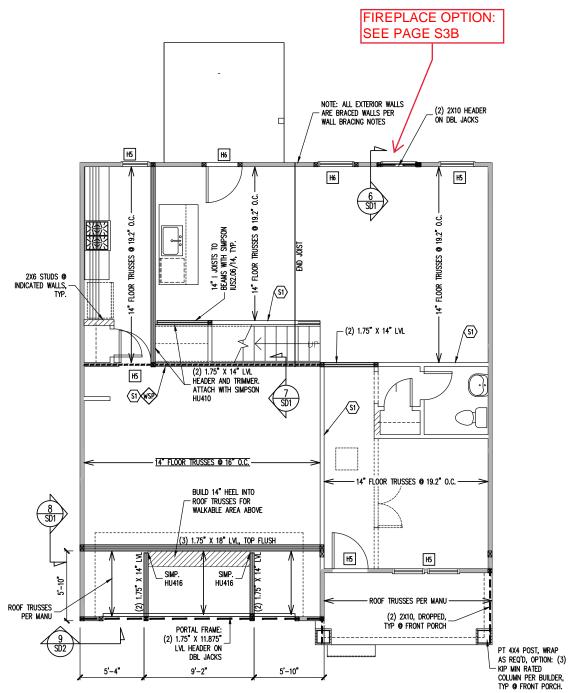

1ST FLOOR FRAMING PLAN **ELEVATION B**

WALLS AND CEILING 1/8" = 1'-0"

FRAMING SCEDULE

INTERIOR LOAD BEARING WALL: SECURE TO THICKENED SLAB BELOW WITH 1/2" FED HEADER ANCHOR (OR EQUAL) @ 6'-0" O.C., 12" MAX FROM ENDS / CORNERS OF WALL, 7 MIN EMBEDMENT INTO SLAB BELOW.

JOIST SUBSTITUTION

14" FLOOR TRUSSES PERMITTED TO BE SUBSTITUTED WITH 14" I-JOISTS.

MAINTAIN MINIMUM SPACING AS CALLED OUT ON PLANS.

SIMP. IUS/ITS3.56/14 HANGERS TO BE SUBSTITUTED WITH SIMP. IUS/ITS2.06/14 HANGER WHEN I-JOISTS HAVE BEEN INSTALLED.

CONSTRUCTION SPECIFICATIONS INSTANT REFERENCES

REFER TO THE CONSTRUCTION SPECIFICATIONS SECTIONS FOR THE FOLLOWING INFORMATION:

PART 1.01: CURRENT GOVERNING CODE

PART 14: STUD SUPPORT FOR BEAMS

PART 17: KING STUDS FOR EXTERIOR WALLS

SEE DETAIL / CONSTRUCTION SPECIFICATIONS SHEETS FOR I-JOISTS ALLOWABLE SUBSTITUTIONS

WALL BRACING

SHADED WALLS:

ALL EXTERIOR STUD WALLS, EXTERIOR SIDE, ARE TO BE CONTINUOUSLY SHEATHED WITH 7/16 APA RATED OSB NAILED TO STUDS WITH 8d NAILS @ 6" O.C. AT PANEL EDGES, 12" O.C. IN PANEL FIELD.

WSP - ONE SIDE OF INTERIOR WALL OR INSIDE OF EXTERIOR WALL WITH 3/8" MIN. THICKNESS WOOD STRUCTURAL PANFLING, ATTACH WSP TO STUD WALL WITH 8d NAILS @ 4" O.C. AT PANEL EDGES, 8" O.C. IN PANEL FIELD.

PROVIDED CONTINUOUS SHEATHING = 155' MIN.

REFERENCE PART 16.02 OF CONSTRUCTION SPECIFICATIONS FOR GENERAL WIND BRACING INFORMATION.

HEADER SCHEDULE

- SINGLE 2X4 TURNED FLAT (A)
- H2 (2) 2X4'S ON SINGLE JACKS (B)
- (2) 2X10'S ON SINGLE JACKS (C)
- (2) 1.75" X 9.25" LVL'S ON DBL JACKS
- (2) 2X8'S ON SINGLE JACKS
- (2) 2X8'S ON DOUBLE JACKS
- TYPICAL FOR INTERIOR NON LOAD BEARING WALLS ONLY, ROUGH OPENING 38" MAX.
- TYPICAL FOR INTERIOR NON LOAD BEARING WALLS ONLY, ROUGH OPNG 38" TO 74" MAX.
- TYPICAL FOR ALL CONDITIONS NOT LISTED IN (A) OR (B) UNO.

-HEADERS IN NON LOAD BEARING INTERIOR WALLS ARE NOT LABELED.

FOUNDATION SCHEDULE

ENLARGE FOOTING TO 36" SQ. X 12" THK

OLES: -HEIGHT AND BACKFILL LIMITATIONS FOR FOUNDATION WALLS ARE TO BE GOVERNED BY THE NCSBC, LATEST EDITION.

SEAL 055544 055146 STRUCTURAL ENGINEERS
License No. C-3870
B W Millbrook Rd Suite 201
leigh, North Carolina 27609
Phone (919) 844-1661

318 W A Raleigh,

MASTER

CMC

TBD


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FRESH PAINT STRUCTURAL ADDENDUM ENG: DATE: 4/10/2024

PROJECT NO. 24-30-029

> SHEET NO. S₁B 1 of 7



TRUSS UPLIFT CONNECTORS

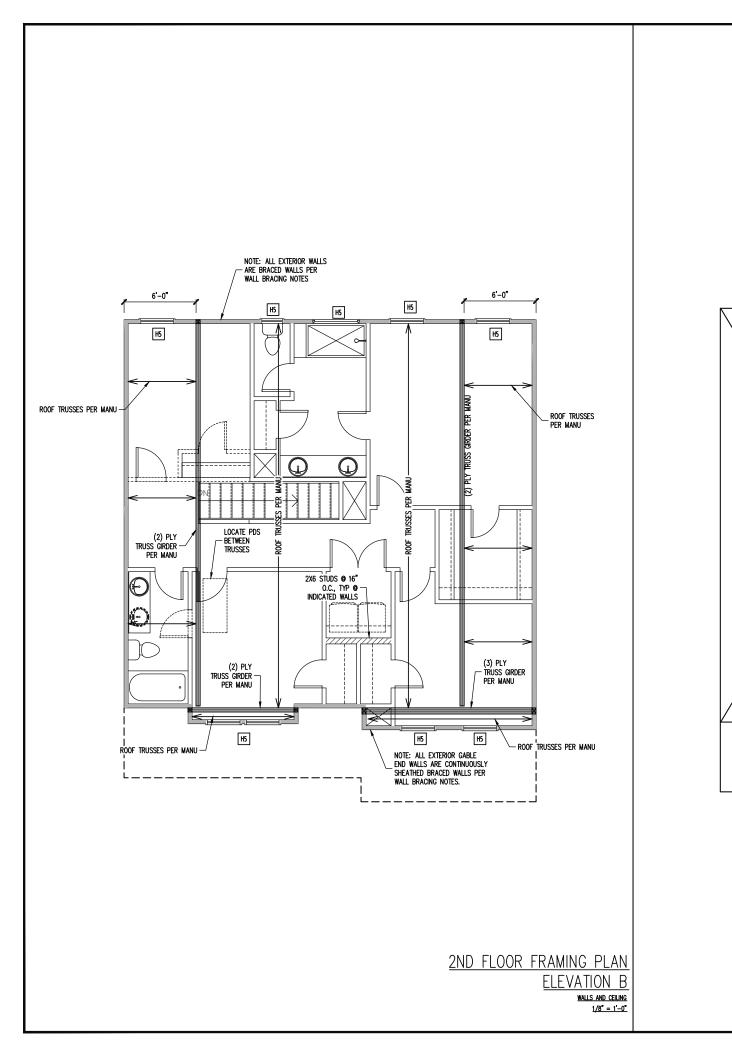TRUSSES SHALL BE ATTACHED TO SUPPORT WALL FOR UPLIFT
RESISTANCE. CONTINUOUS OSB WALL SHEATHING BELOW PROVIDES
CONTINUOUS UPLIFT RESISTANCE TO FOUNDATION. ALL TRUSSES
SUPPORTED BY INTERMEDIATE SUPPORT WALLS, KNEEWALLS OR
BEAMS SHALL BE ATTACHED TO SUPPORTING MEMBER PER SCHEDULE
BELOW.

ROOF SPAN IS MEASURED HORIZONTALLY BETWEEN FURTHEST SUPPORT POINTS.

DN 10:12

DN 10:12

DN 4:12

ROOF FRAMING PLAN

ELEVATION B

1/8" = 1'-0"

OVER 28'

VALLEY SET TRUSSES -

■ DN 10:12

- VALLEY SET TRUSSES

- VALLEY SET TRUSSES

OPTIONAL SCREENED PORCH -

■ DN 10:12

VALLEY

TRUSSES

DN 10:12

DN 10:12

DN 4:12

DN 4:12

(1) SIMPSON H2.5A HURRICANE CLIP TO DBL TOP PLATE OR BEAM

OR (1) SIMPSON H3 CLIP TO SINGLE 2X4 PLATE

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B W Millbrook Rd Suite 201
leigh, North Carolina 27609
Phone (919) 844-1661

318 W A Raleigh,

FRAMING NOTES

-ROOF TRUSSES PER MANU. TYPICAL U.N.O. -VERIFY ALL KNEEWALL HEIGHTS, ROOF PITCHES, AND ARCHITECTURAL OVERHANGS PRIOR TO CONSTRUCTION

CONSTRUCTION SPECIFICATIONS

REFER TO THE CONSTRUCTION SPECIFICATIONS

PART 1.01: CURRENT GOVERNING CODE

PART 17: KING STUDS FOR EXTERIOR WALLS

ALL EXTERIOR STUD WALLS, EXTERIOR SIDE, ARE TO BE CONTINUOUSLY SHEATHED WITH 7/16 APA RATED OSB NAILED TO STUDS WITH 8d NAILS @ 6" O.C. AT PANEL EDGES, 12" O.C. IN PANEL FIELD.

SPECIFICATIONS FOR GENERAL WIND BRACING INFORMATION.

HEADER SCHEDULE

- (2) 2X4'S ON SINGLE JACKS (B)
- (2) 2X10'S ON SINGLE JACKS (C)
- H4 (2) 1.75" X 9.25" LVL'S ON DBL JACKS
- H5 (2) 2X8'S ON SINGLE JACKS
- TYPICAL FOR INTERIOR NON LOAD BEARING WALLS ONLY, ROUGH OPENING 38" MAX.
- TYPICAL FOR INTERIOR NON LOAD BEARING WALLS ONLY, ROUGH OPNG 38" TO 74" MAX.
- IN (A) OR (B) UNO.

WALLS ARE NOT LABELED.

INSTANT REFERENCES

SECTIONS FOR THE FOLLOWING INFORMATION:

PART 14: STUD SUPPORT FOR BEAMS

WALL BRACING

PROVIDED CONTINUOUS SHEATHING = 139' MIN.

REFERENCE PART 16.02 OF CONSTRUCTION

- SINGLE 2X4 TURNED FLAT (A)

- TYPICAL FOR ALL CONDITIONS NOT LISTED

-HEADERS IN NON LOAD BEARING INTERIOR


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STRUCTURAL ADDENDUM
TBD plans are seal date P.A. These MASTER Engine takes property of permitting t ENG: CMC DATE: 4/10/2024

Engineering Trom Engine only. ission listed perm client li written

FOR 1 YEAR ONLY. this plan is the propif construction or pen


PROJECT NO. 24-30-029

SHEET NO. S₂B 2 of 7

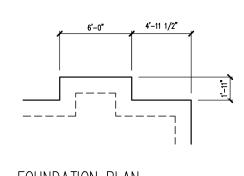


FOUNDATION PLAN OPTIONAL FIREPLACE

1/8" = 1'-0"

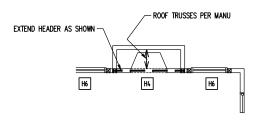

1ST FLOOR FRAMING PLAN OPTIONAL FIREPLACE
1/8" = 1'-0"

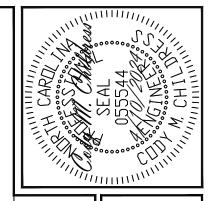

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A. Phone (919) 844-1661 ENGINEERING SEAL VALID FOR 1 YEAR ONLY.


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STRUCTURAL ADDENDUM
TBD
MASTER
HONEYSUCKIT SCOPE

DATE: 4/10/2024

ENG:

CMC

PROJECT NO. 24-30-029 SHEET NO. S₃B 3 of 7

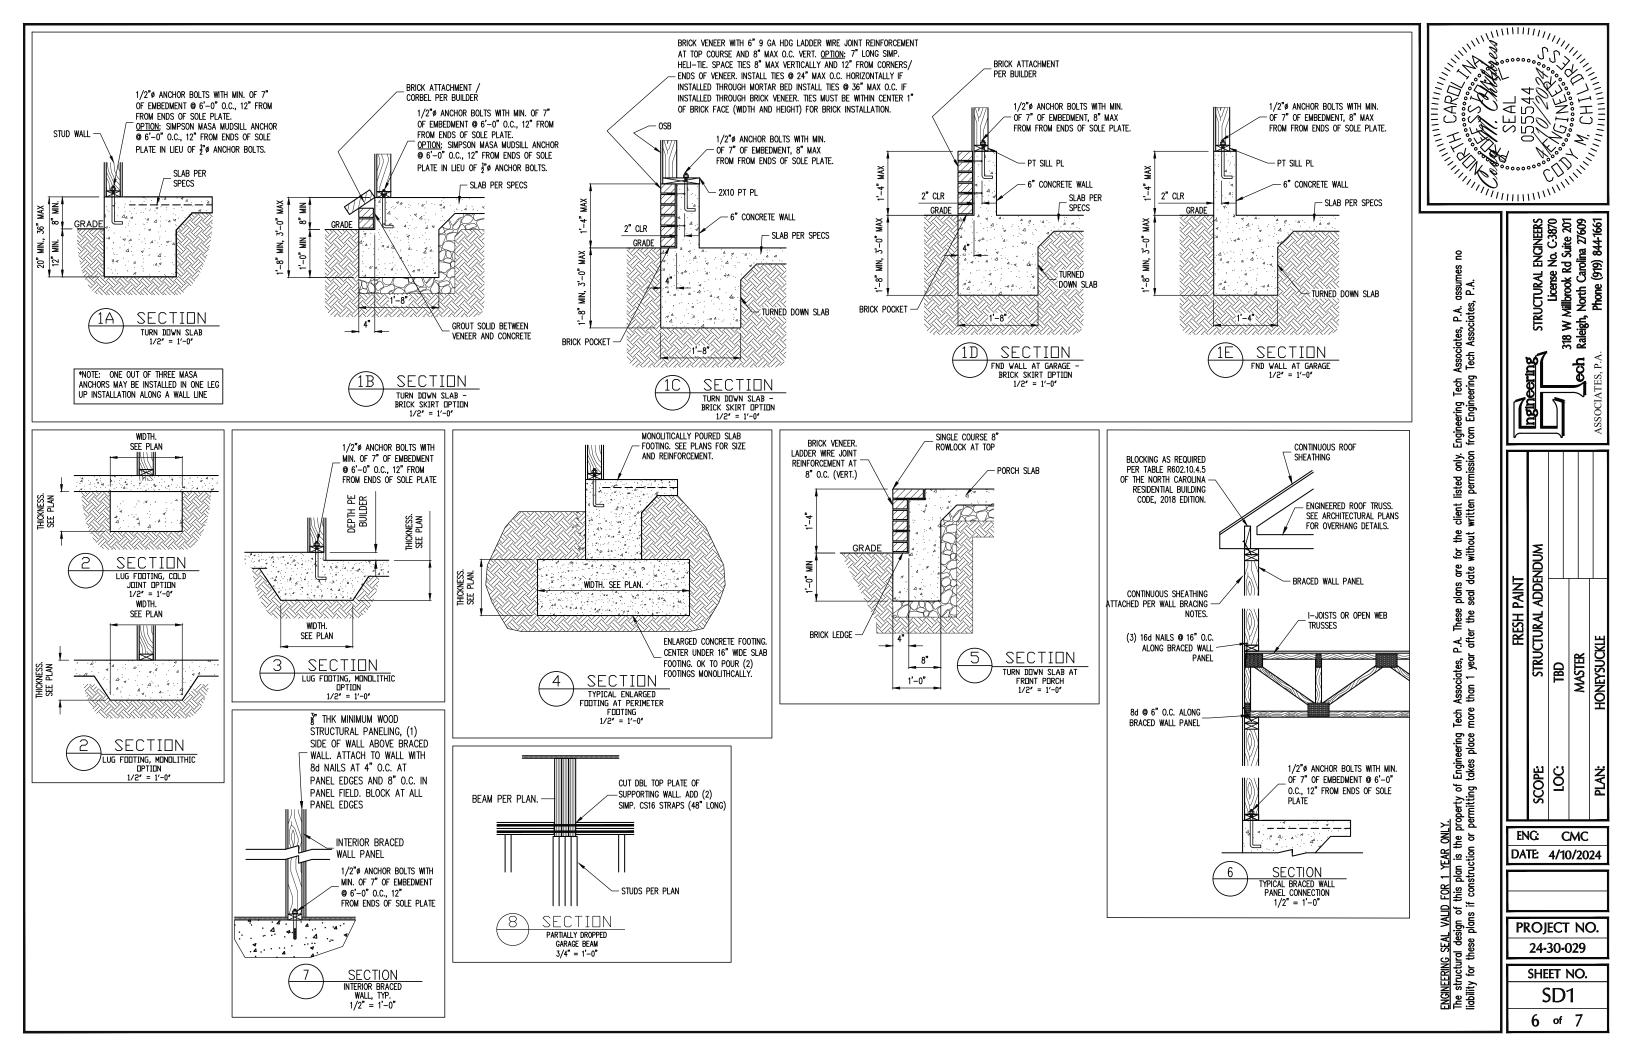

CONSTRUCTION SPECIFICATIONS

PART 1: GENERAL

- CONSTRUCTION SHALL MEET THE REQUIREMENTS OF THE NORTH CAROLINA RESIDENTIAL CODE. 2018 EDITION.
- 1.02 DIMENSIONS SHOWN SHALL GOVERN OVER SCALE ON THESE DRAWINGS.
- METHODS, PROCEDURES AND SEQUENCES OF CONSTRUCTION ARE THE RESPONSIBILITY OF THE CONTRACTOR, WHO SHALL TAKE ALL NECESSARY PRECAUTIONS TO MAINTAIN AND INSURE THE INTEGRITY OF THE STRUCTURE AT ALL STAGES OF CONSTRUCTION.

PART 2: DESIGN LOADS

2.01 DESIGN LOADS SHALL CONFORM WITH THE TABLE BELOW: USE

BALCONIES, DECKS, ATTICS WITH FIXED STAIR ACCESS, DWELLING UNITS INCLUDING ATTICS WITH FIXED STAIR ACCESS, STAIRS, FIRE ESCAPES	40	10
GARAGES (PASSENGER CARS ONLY)	50	
ATTICS (NO STORAGE, LESS THAN 5' HEADROOM)	10	10
ATTICS (WITH STORAGE)	20	10

ROOF

LIVE LOAD (PSF) DEAD LOAD (PSF)

20 10 (15 FOR VAULTS)

- NOTES: INDIVIDUAL STAIR TREADS ARE TO BE DESIGNED FOR THE UNIFORMLY DISTRIBUTED LIVE LOAD OF 40 PSF OR A 300 LB. CONCENTRATED LOAD ACTING OVER AN AREA OF 4 SQ. WHICHEVER PRODUCES THE GREATER STRESS.

 BUILDER TO VERIFY DEAD LOAD DOES NOT EXCEED 10 PSF WHEN HEAVY FLOOR OR
 - ROOF FINISHES SUCH AS TILE OR SLATE ARE UTILIZED. NOTIFY ENGINEERING UNDER
- 2.02 INTERIOR WALLS: 5 PSF LATERAL
- 2.03 BASIC WIND DESIGN VELOCITY OF 120 MPH.
- SOIL BEARING CAPACITY 2000 PSF (PRESUMPTIVE).

PART 5: CONCRETE AND SLABS ON GRADE

- CAST IN PLACE CONCRETE SHALL BE OF NORMAL WEIGHT, 6% AIR ENTRAINMENT, AND SHALL HAVE A MINIMUM COMPRESSIVE STRENGTH OF 3000 PSI AT 28 DAYS TYP UNO. ALL CONCRETE, INCLUDING CONCRETE FOR FOOTINGS, IS TO BE CAST IN PLACE, TYP
- SLABS ON GRADE, IF ANY, SHALL CONTAIN SYNTHETIC POLYPROPYLENE FIBRILLATED MICRO FIBERS, FIBER LENGTH 1 1/2", DOSAGE RATE 1 1/2 LBS/CU YD. SLAB TO BE PLACED ON A 6 MIL VAPOR BARRIER ON 2" MIN GRANULAR FILL ON SOIL WITH 90% ARD PROCTOR DENSITY. VAPOR BARRIER MAY BE OMITTED FOR SLABS NOT

PART 7: MASONRY

- 7.03 MORTAR SHALL BE TYPE S. MORTAR AND GROUT SHALL CONFORM TO ASTM C476, MIN COMPRESSIVE STRENGTH OF 2000 PSI.
- LADDER WIRE REINFORCEMENT SHALL CONFORM TO ASTM A951. 6 MIN LAPS FOR CONTINUOUS WALL APPLICATIONS

PART 8: BOLTS AND LAG SCREWS

8.03 ANCHOR RODS AND BOLTS SHALL CONFORM TO ASTM F1554-15 GRADE 36 UNO. BENT ANCHOR BOLTS SHALL HAVE A 2" MIN HOOK UNO

NAILS, SPIKES AND STAPLES SHALL CONFORM TO ASTM F 1667- 05. NAILS ARE TO BE COMMON WIRE OR BOX

PART 10: DIMENSIONAL LUMBER

SOLID SAWN WOOD FRAMING DESIGN IS BASED ON NO. 2 SPRUCE PINE FIR \underline{OR} SYP #2 FOR JOISTS, RAFTERS, GIRDERS, BEAMS, STUDS, ETC.

PART 11: ENGINEERED LUMBER

- LVL OR PSL MINIMUM ALLOWABLE DESIGN STRESSES ARE AS FOLLOWS: E= 1.9 X 10E6 PSl, Fb = 2600 PSl, Fv = 285 PSl, Fc = 750 PSl LSL MINIMUM ALLOWABLE DESIGN STRESSES ARE AS FOLLOWS: E= 1.3 X 10E6 PSl, Fb = 1700 PSl, Fv = 400 PSl, Fc = 680 PSl
- 11.02 LVL OR PSL MEMBERS MAY BE RIPPED FROM DEEPER MEMBERS TO MATCH THE MEMBER

PART 12: PRESSURE TREATED LUMBER

LUMBER IN CONTACT WITH THE GROUND, CONCRETE OR MASONRY SHALL BE PRESSURE TREATED IN ACCORDANCE WITH AWPA STANDARD C-15. ALL OTHER EXPOSED LUMBER SHALL BE TREATED IN ACCORDANCE WITH AWPA STANDARD C-2 OR BY ANY METHOD GIVING EQUAL PROTECTION. THE BUILDING CODE OFFICE MAY ALSO APPROVE A NATURAL DECAY RESISTANT WOOD PER SECTION 19-6(A)

PART 14: STUD SUPPORTS FOR BEAMS

14.01 STEEL, ENGINEERED LUMBER, AND FLITCH PLATE BEAMS BEARING ON A STUD WALL

- 1-WHEN THE BEAM IS PERPENDICULAR TO, OR SKEWED RELATIVE TO THE WALL, THE BEAM SHALL BEAR <u>FULL WIDTH</u> ON THE SUPPORTING WALL INDICATED AND SHALL BE SUPPORTED BY A MINIMUM OF THREE GANGED STUDS, OR A GANGED STUD COLUMN WITH A NUMBER OF STUDS SUCH THAT THE STUD COLUMN IS AT LEAST AS WIDE AS THE TRUE WIDTH OF THE BEAM BEING SUPPORTED, WHICHEVER IS GREATER, TYP UNO. FOR THE SKEWED CONDITION PARTICULAR CARE SHALL BE TAKEN TO ENSURE STUD COLUMN IS CENTERED ON THE BEAM
 2-BEAMS BEARING ONTO THE END OF A STUD WALL PARTLEL TO THE BEAM SHALL BEAR A MINIMUM OF A 1.0° CONTO THE WALL AND BE SUPPORTED BY A TOPL STUD CANCED.
- A MINIMUM OF 4 1/2" ONTO THE WALL AND BE SUPPORTED BY A TRPL STUD GANGED
- 4.02 DIMENSIONAL LUMBER BEAMS BEARING ON A STUD WALL SHALL BEAR AS FOLLOWS:
- 1-when the beam is perpendicular to, or skewed relative to the wall, the beam shall bear <u>full width</u> on the supporting wall indicated (less 1 1/2" to allow for a continuous rim joist where applicable) and shall be supported by a GANGED STUD COLUMN THE SAME MOTH AS THE BEAM TYP UNO. (E.G. A TRIPLE 2XIO IS TO BE SUPPORTED BY (3) STUDS). FOR THE SKEWED CONDITION PARTICULAR CARE SHALL BE TAKEN TO ENSURE STUD COLUMN IS CENTERED ON THE BEAM 2-BEAMS BEARING ONTO THE END OF A STUD WALL PARALLEL TO THE BEAM SHALL BEAR A MINIMUM OF 3" ONTO THE WALL AND BE SUPPORTED BY A DBL STUD GANGED COLUMN
- 14.03 Extra joists bearing on a stud wall perpendicular to or skewed relative to the beam shall be supported by one additional stud.
- STUDS THAT ARE GANGED TO FORM A COLUMN SHALL HAVE ADJACENT STUDS WITHIN THE COLUMN NAILED TOGETHER WITH ONE ROW OF 10d NAILS AT 8" O.C. (TWO ROWS THE COLOMIN NAILS OF 8" O.C., 3" APART, FOR 2X8 OR 2X10 STUDS) ALL COLUMNS SHALL BE CONTINUOUS DOWN TO THE FOUNDATION OR OTHER PROPERLY DESIGNED STRUCTURAL ELEMENT SUCH AS A BEAM. COLUMNS TRANSFERRING LOADS THROUGH FLOOR LEVELS SHALL BE SOLIDLY BLOCKED FOR THE FULL WIDTH OF THE STUD COLUMN WITHIN THE CAVITY FORMED BY THE

PART 15: NAILING OF MULTI PLY WOOD BEAMS

- SOLID SAWN LUMBER JOISTS THAT ARE GANGED TO FORM A BEAM SHALL HAVE ADJACENT MEMBERS IN THE BEAM NAILED TOGETHER WITH THREE ROWS OF 10d NAILS @ 16" O.C. FOR 2X10 OR LARGER, TWO ROWS OF 10d NAILS @ 16" O.C. FOR 2X8, ONE 15.01 ROW OF 10d NAILS @ 16" O.C. FOR 2X6 OR SMALLER. STAGGER ROWS 5" MIN.
- 15.02 LV. MEMBERS THAT ARE GANGED TO FORM A BEAM SHALL HAVE ADJACENT MEMBERS IN THE BEAM FASTENED TOGETHER PER MANUFACTURERS RECOMMENDATIONS, TYP

PART 16: WALL FRAMING AND BRACING

6.01 STUD WALLS SHALL CONSIST OF 2X4 STUDS SPACED AT 16" O.C. UNO. STUDS SHALL STUD WALLS SHALL CONSIST OF ZXA STUDS SPACED AT 16 O.C. UNO. STUDS SHALL BE CONTINUOUS FROM SOLE PLATE AT FLOOR TO DOUBLE TOP PLATE AT THE CEILING OR ROOF. NO INTERMEDIATE BANDS OR PLATES SHALL CAUSE DISCONTINUITIES IN A STUD WALL EXCEPT AS REQUIRED FOR DOOR OR WINDOW OPENINGS. THE KING STUDS FOR SUCH OPENINGS SHALL BE CONTINUOUS, TYP UNO.

MAX ALLOWABLE WALL HEIGHTS FOR EXTERIOR STUD WALLS, WITH SOLE PLATE AND DBL TOP PLATE AND 7/16" OSB EXTERIOR BRACING AND ROW OF ZXA /

2X6 PURLINS AT 8' HEIGHT (AND AT 16' HEIGHT FOR TALL WALLS), TYP UNO:

16.02 FOR WALL BRACING THE FOLLOWING SHALL APPLY:

-BLOCKING AT UNSUPPORTED PANEL EDGES IS REQUIRED TYP UNO.

-WALL BRACING IS BY ENGINEERED DESIGN AND NOT PRESCRIPTIVE PER SECTION 602.10 OF THE 2018 NCRC. CONTINUOUS SHEATHING HAS BEEN PROVIDED, ALONG WITH ALTERNATIVE METHODS TO INSURE THE MINIMUM INTENT OF SECTION 602.10

WITH ALTERNATIVE METHODS TO INSURE THE MINIMUM INTENT OF SECTION 602.10 OF THE 2018 NORC HAS BEEN MET AND EXCEEDED.

-BRACED WALL PANELS SHALL BE FASTENED IN ACCORDANCE WITH TABLE 602.3(1) TO PROVIDE CONTINUOUS PANEL UPLIFT RESISTANCE AND COMPLIANCE WITH NORBC R602.35.8 AND R802.11 UNLESS NOTED OTHERWISE ON STRUCTURAL PLANS.

-MAY SUBSTITUTE WSP FOR GB
-SINGLE JOIST, CONTINUOUS RIM JOIST, OR BLOCKING OF EQUAL DEPTH IS REQUIRED ABOVE AND BELOW ALL BRACED WALLS. NAIL BLOCKING ABOVE WALL TO TOP PLATE WITH 16d TOE NAILS @ 6° O.C. NAIL SOLE PLATE OF BRACED WALL TO BLOCKING BELOW WITH (3) 16d NAILS @ 16° O.C. BLOCKING AT HORIZONTAL JOINTS IN BRACED WALL LINES ONLY REQUIRED AT SHADED WALLS, UNO. WALL LINES ONLY REQUIRED AT SHADED WALLS, UNO.

17.01 KING STUDS FOR OPENINGS IN EXTERIOR WALLS SHALL BE AS FOLLOWS:


MAX OPENING	WIDTH	5'-0"			ig studs 17'-0"	21'-0"
STUD SIZE	2X4 2X6 2X8	1 1	2 1	3 2 1	4 2 1	5 2

PART 18: SUBSTITUTIONS

MATERIAL OR MEMBER SIZE SUBSTITUTIONS OR PLAN DEVIATIONS REQUIRE THE WRITTEN AUTHORIZATION OF THE DESIGNERS. UNAUTHORIZED DEVIATIONS ARE THE SOLE

PART 19: OWNERSHIP OF STRUCTURAL DESIGN

THE STRUCTURAL DESIGN OF THIS PLAN IS THE PROPERTY OF ENGINEERING TECH ASSOCIATES (ETA). THESE PLANS ARE FOR THE ONE TIME USE AT THE LOCATION INDICATED AND FOR THE CLIENT LISTED, ETA ASSUMES NO LIABILITY FOR THESE PLANS IF THEY ARE REPRODUCED, IN WHOLE OR IN PART, FOR CONSTRUCTION AT ANY OTHER LOCATION

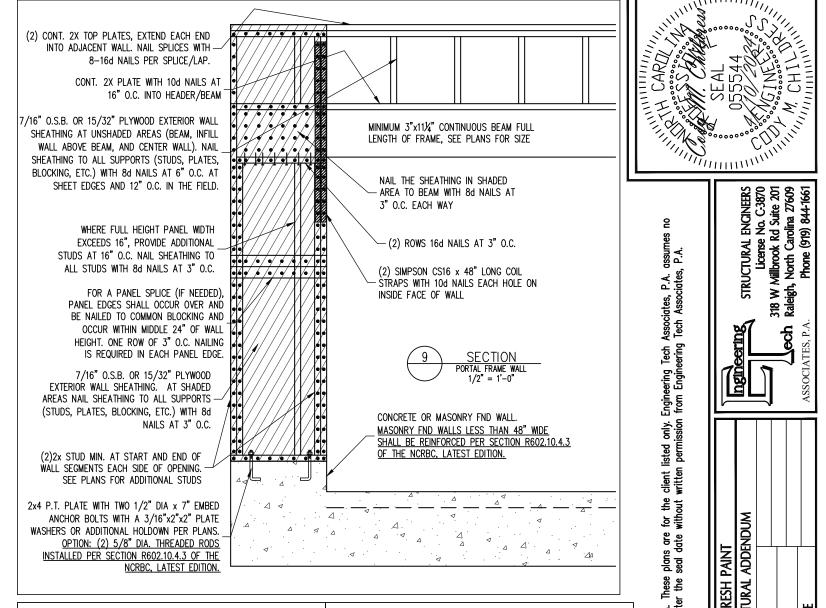

ABBREVIATIONS NOTES THE BUILDER IS RESPONSIBLE FOR REVIEWING PLANS PRIOR TO CONSTRUCTION. THE BUILDER FND FOUNDATION ABV ABOVE TJ TRIPLE JOIST SHALL IMMEDIATELY CONTACT THE ENGINEER OF RECORD (EOR) BEFORE PROCEEDING IF THE TYP TYPICAL FOLLOWING CONDITIONS ARE NOTED BEFORE OR DURING CONSTRUCTION: BOTH FNDS HDG HOT DIPPED TRPL TSP TRIPI F GALVANIZED BTWN BETWEEN 1) THE WORKING PLANS DO NOT BEAR THE SEAL OF THE EOR HGR HANGER CAST IN PLACE UNO UNLESS NOTED 2) THE PLANS CONTAIN DISCREPANT OR INCOMPLETE INFORMATION LVL LAMINATED VENEER CONC CONCRETE OTHERWISE CONTINUOUS SHEATHING XJ EXTRA JOIST ANY ERRORS DUE TO A FAILURE TO FOLLOW THE ABOVE PROCEDURES SHALL NOT BE THE NTS NOT TO SCALE DIA DIAMETER RESPONSIBILITY OF THE FOR, FURTHERMORE, IT IS THE RESPONSIBILITY OF THE BUILDER TO DBL DOUBLE O.C. ON CENTER ENSURE THAN ANY REVISIONS ISSUED BY THE EOR ARE PROMPLY DISTRIBUTED TO THE DOUBLE JOIST PSL PARALLEL STRAND DSP DBI STUD POCKET LUMBER PT PRESSURE TREATED THE EOR DOES NOT PERFORM FENESTRATION OR VENTING CALCULATIONS OR ANY OTHER EA EACH QJ QUAD JOIST CALCULATIONS THAT ARE NOT DIRECTLY RELATED TO STRUCTURAL ENGINEERING. FLG FLANGE SP STUD POCKET L PL FLITCH PLATE SQ SQUARE ROOF AND FLOOR TRUSSES TO BE DESIGNED BY AN ENGINEER REGISTERED BY THE STATE, FINA FIR FLOOR

ALLOWABLE I-JOIST SUBSTITUTION

NOTE: MAINTAIN JOIST DEPTH, DIRECTION, AND SPACING SPECIFIED ON PLANS

TRUSS DRAWING SHOULD BE SUBMITTED TO THE EOR FOR REVIEW

ANUFACTURER	DEPTH	SERIES	SIMPSON FACE MOUNT HGR	SIMPSON TOP FLANGE HGR
LUELINX	14"	BLI 40	IUS2.56/14	ITS2.56/14
OISE CASCADE	14"	BCI 5000s	IUS2.06/14	ITS2.06/14
OISE CASCADE	14"	BCI 6000S	IUS2.37/14	ITS2.37/14
CORP	14"	LPI 20+	IUS2.56/14	ITS2.56/14
ORDIC	14"	NI 40X	IUS2.56/14	ITS2.56/14
OSEBURG	14"	RFPI 40s	IUS2.56/14	ITS2.56/14
EYERHAEUSER	14"	TJI 210	IUS2.06/14	ITS2.06/14
EYERHAEUSER	14"	EEI-20	IUS2.37/14	ITS2.73/14

JOISTS NOT LISTED IN THE ABOVE TABLE MAY BE LISED PROVIDED THEY MEET OR EXCEED THE PROPERTIES OF THOSE LISTED. SUBSTITUTE USP BRAND HANGERS WITH EQUIVALENT VALUES AS DESIRED

TRIPLE STUD POCKE

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carolina 27609 (919) 844-1661

CMC DATE: 4/10/2024

> PROJECT NO. 24-30-029

> > SHEET NO. SD2 7 of 7