

Q I

Project No.: Myrtle Beach - Mirror

JULY 12, 2024 Steven Madden

DESIGNED BY: Steven Madden

COPYRIGHT NOTE: 0 These Plans Are Subject To Federal Copyright Laws And Are To Be Used For The Lot Number And Subdivision Indicated In This Title Block Only. Use On Any Other Site is


OCOPYRICHT 2022


Sheet Title


FLOOR PLAN

Preliminary Dwg

☐ Construction Do

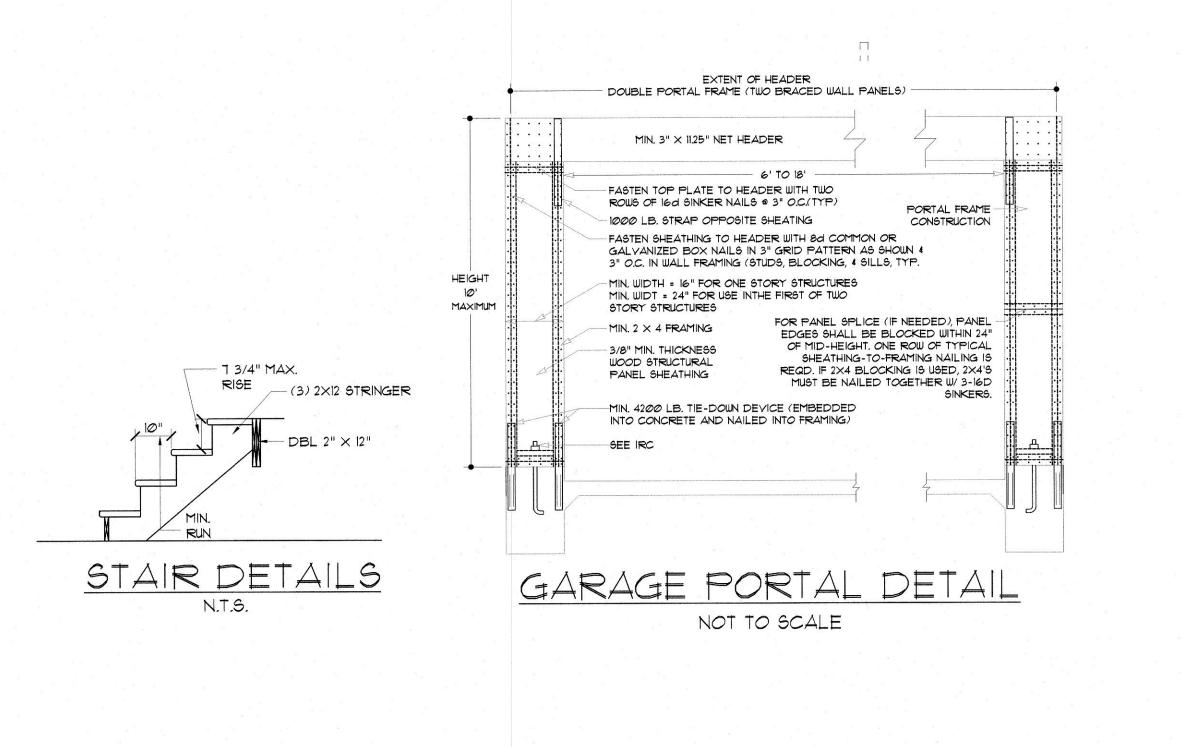

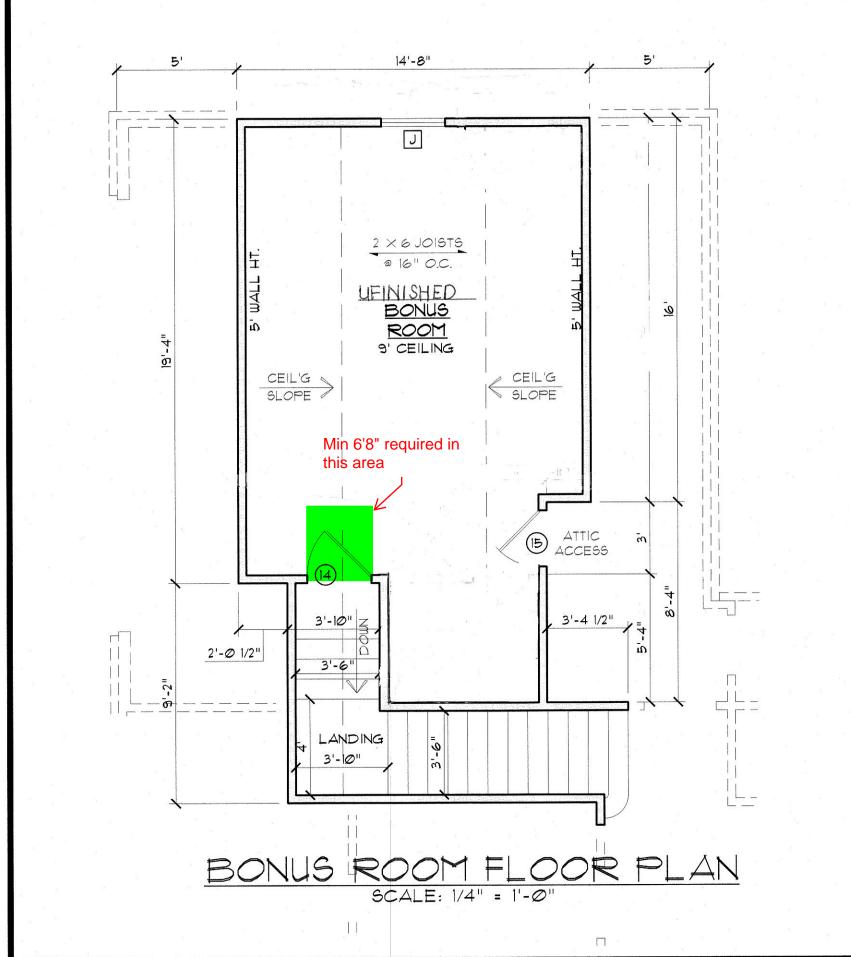

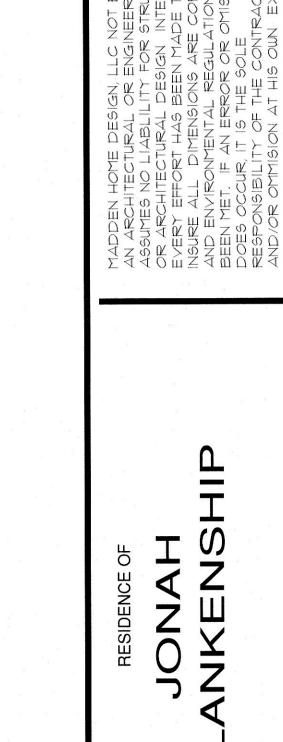

Project No.: Myrtle Beach - Mirror

JULY 12, 2024

Steven Madden

DESIGNED BY: Steven Madden

COPYRIGHT NOTE: (9) These Plans Are Subject To Federal Copyright Laws And Are To Be Used For The Lot Number And Subdivision Indicated In This Title Block Only, Use On Any Other Site is

Prohibited.

Sheet Title

© COPYRICHT 2022

BONUS FPLAN/ INTERIOR ELEVS.

☐ Preliminary Dwg. ☐ Bidding Doc.


☐ Construction Doc




MASTER BATH

SCALE: 3/8" = 1'-0"

MASTER BATH 9CALE: 3/8" = 1'-0"

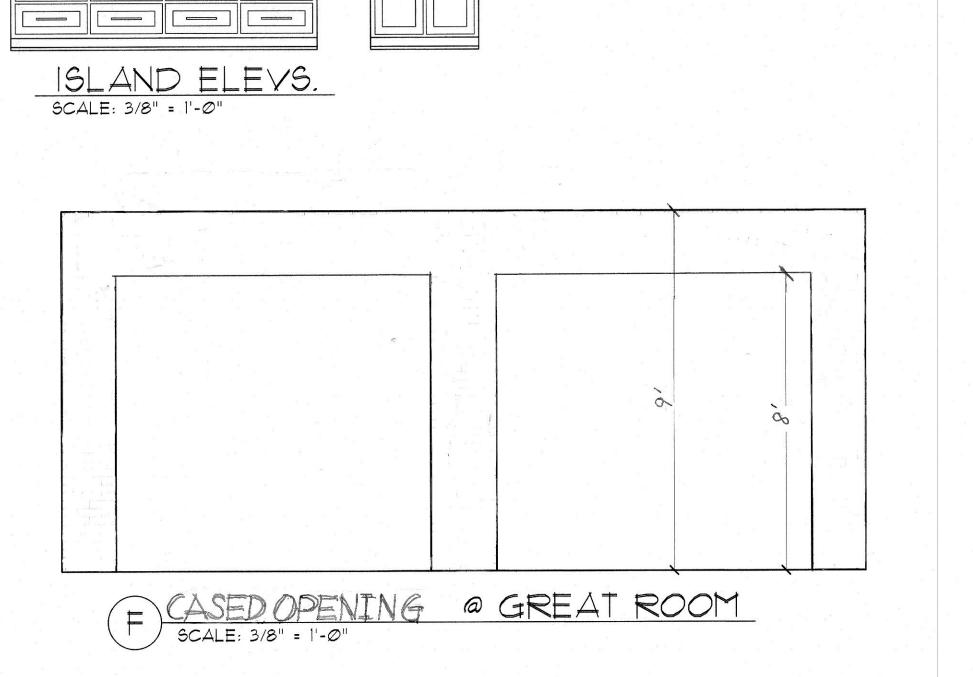

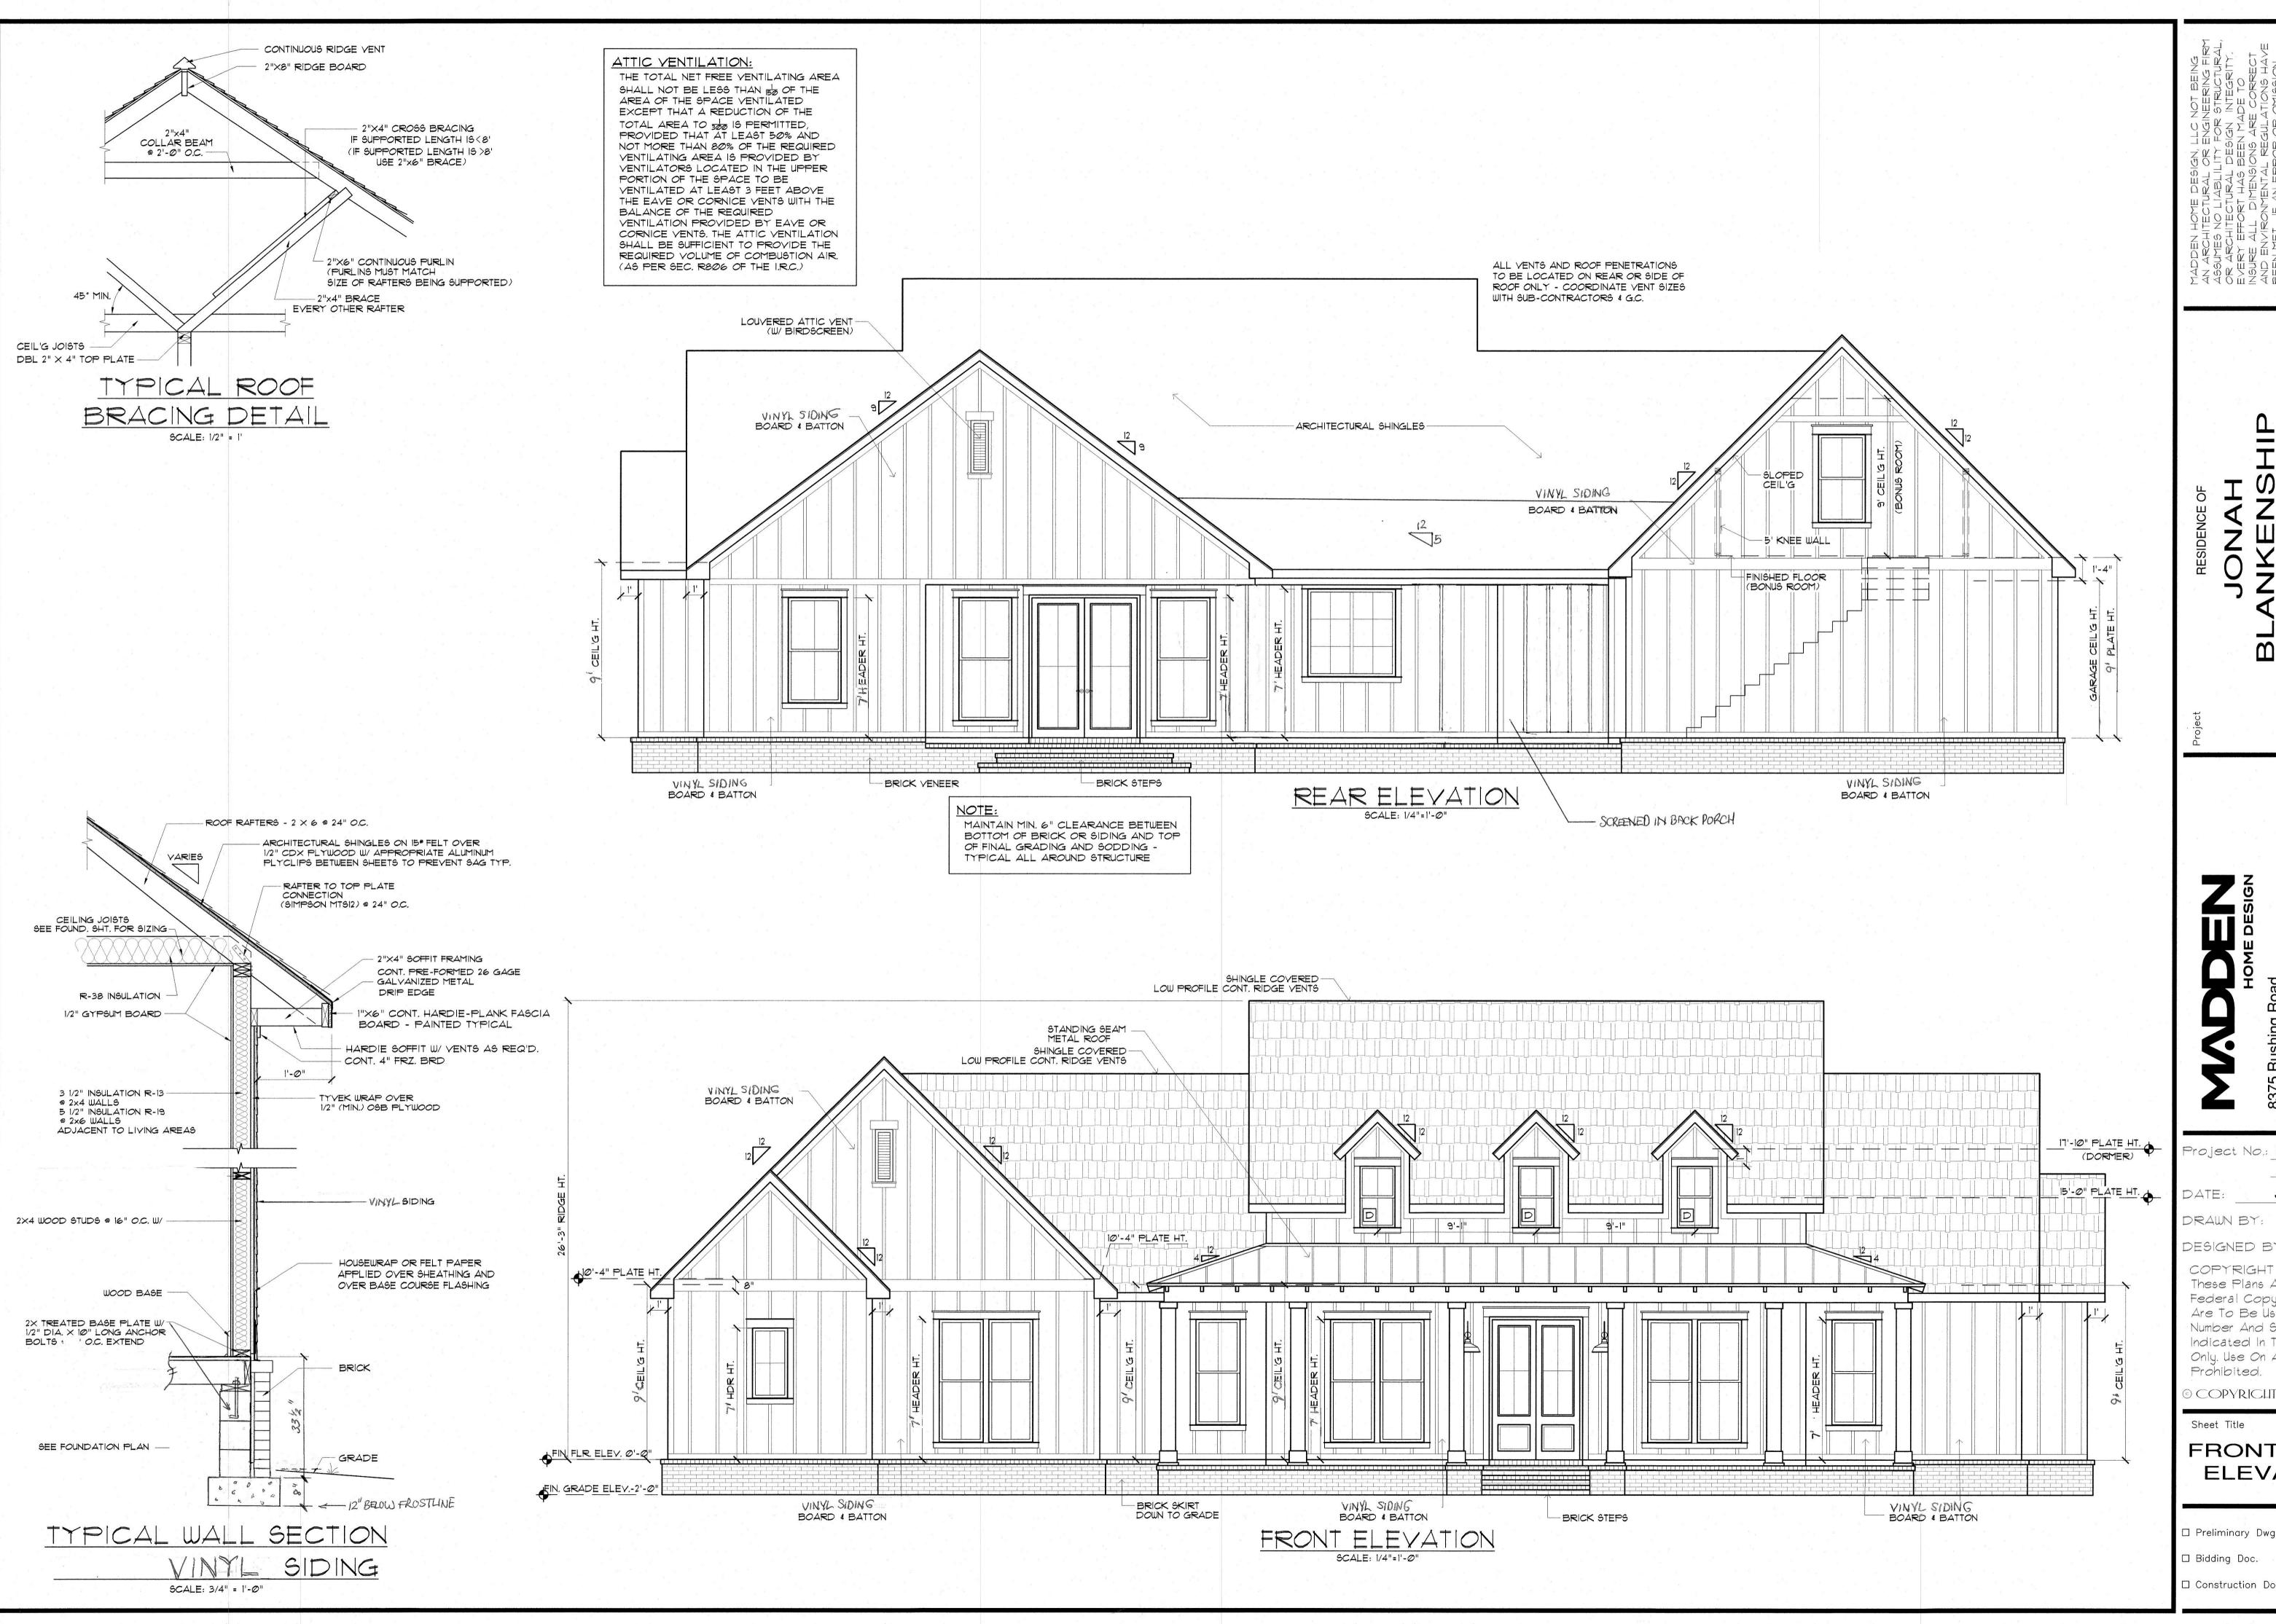

Q m

Project No.: Myrtle Beach - Mirror (Garage)

JULY 12, 2024

Steven Madden

DESIGNED BY: Steven Madden


COPYRIGHT NOTE: © These Plans Are Subject To Federal Copyright Laws And Are To Be Used For The Lot Number And Subdivision

Indicated In This Title Block Only. Use On Any Other Site is Prohibited.

OCOPYRICHT 2022

FRONT & REAR **ELEVATIONS**

□ Preliminary Dwg.

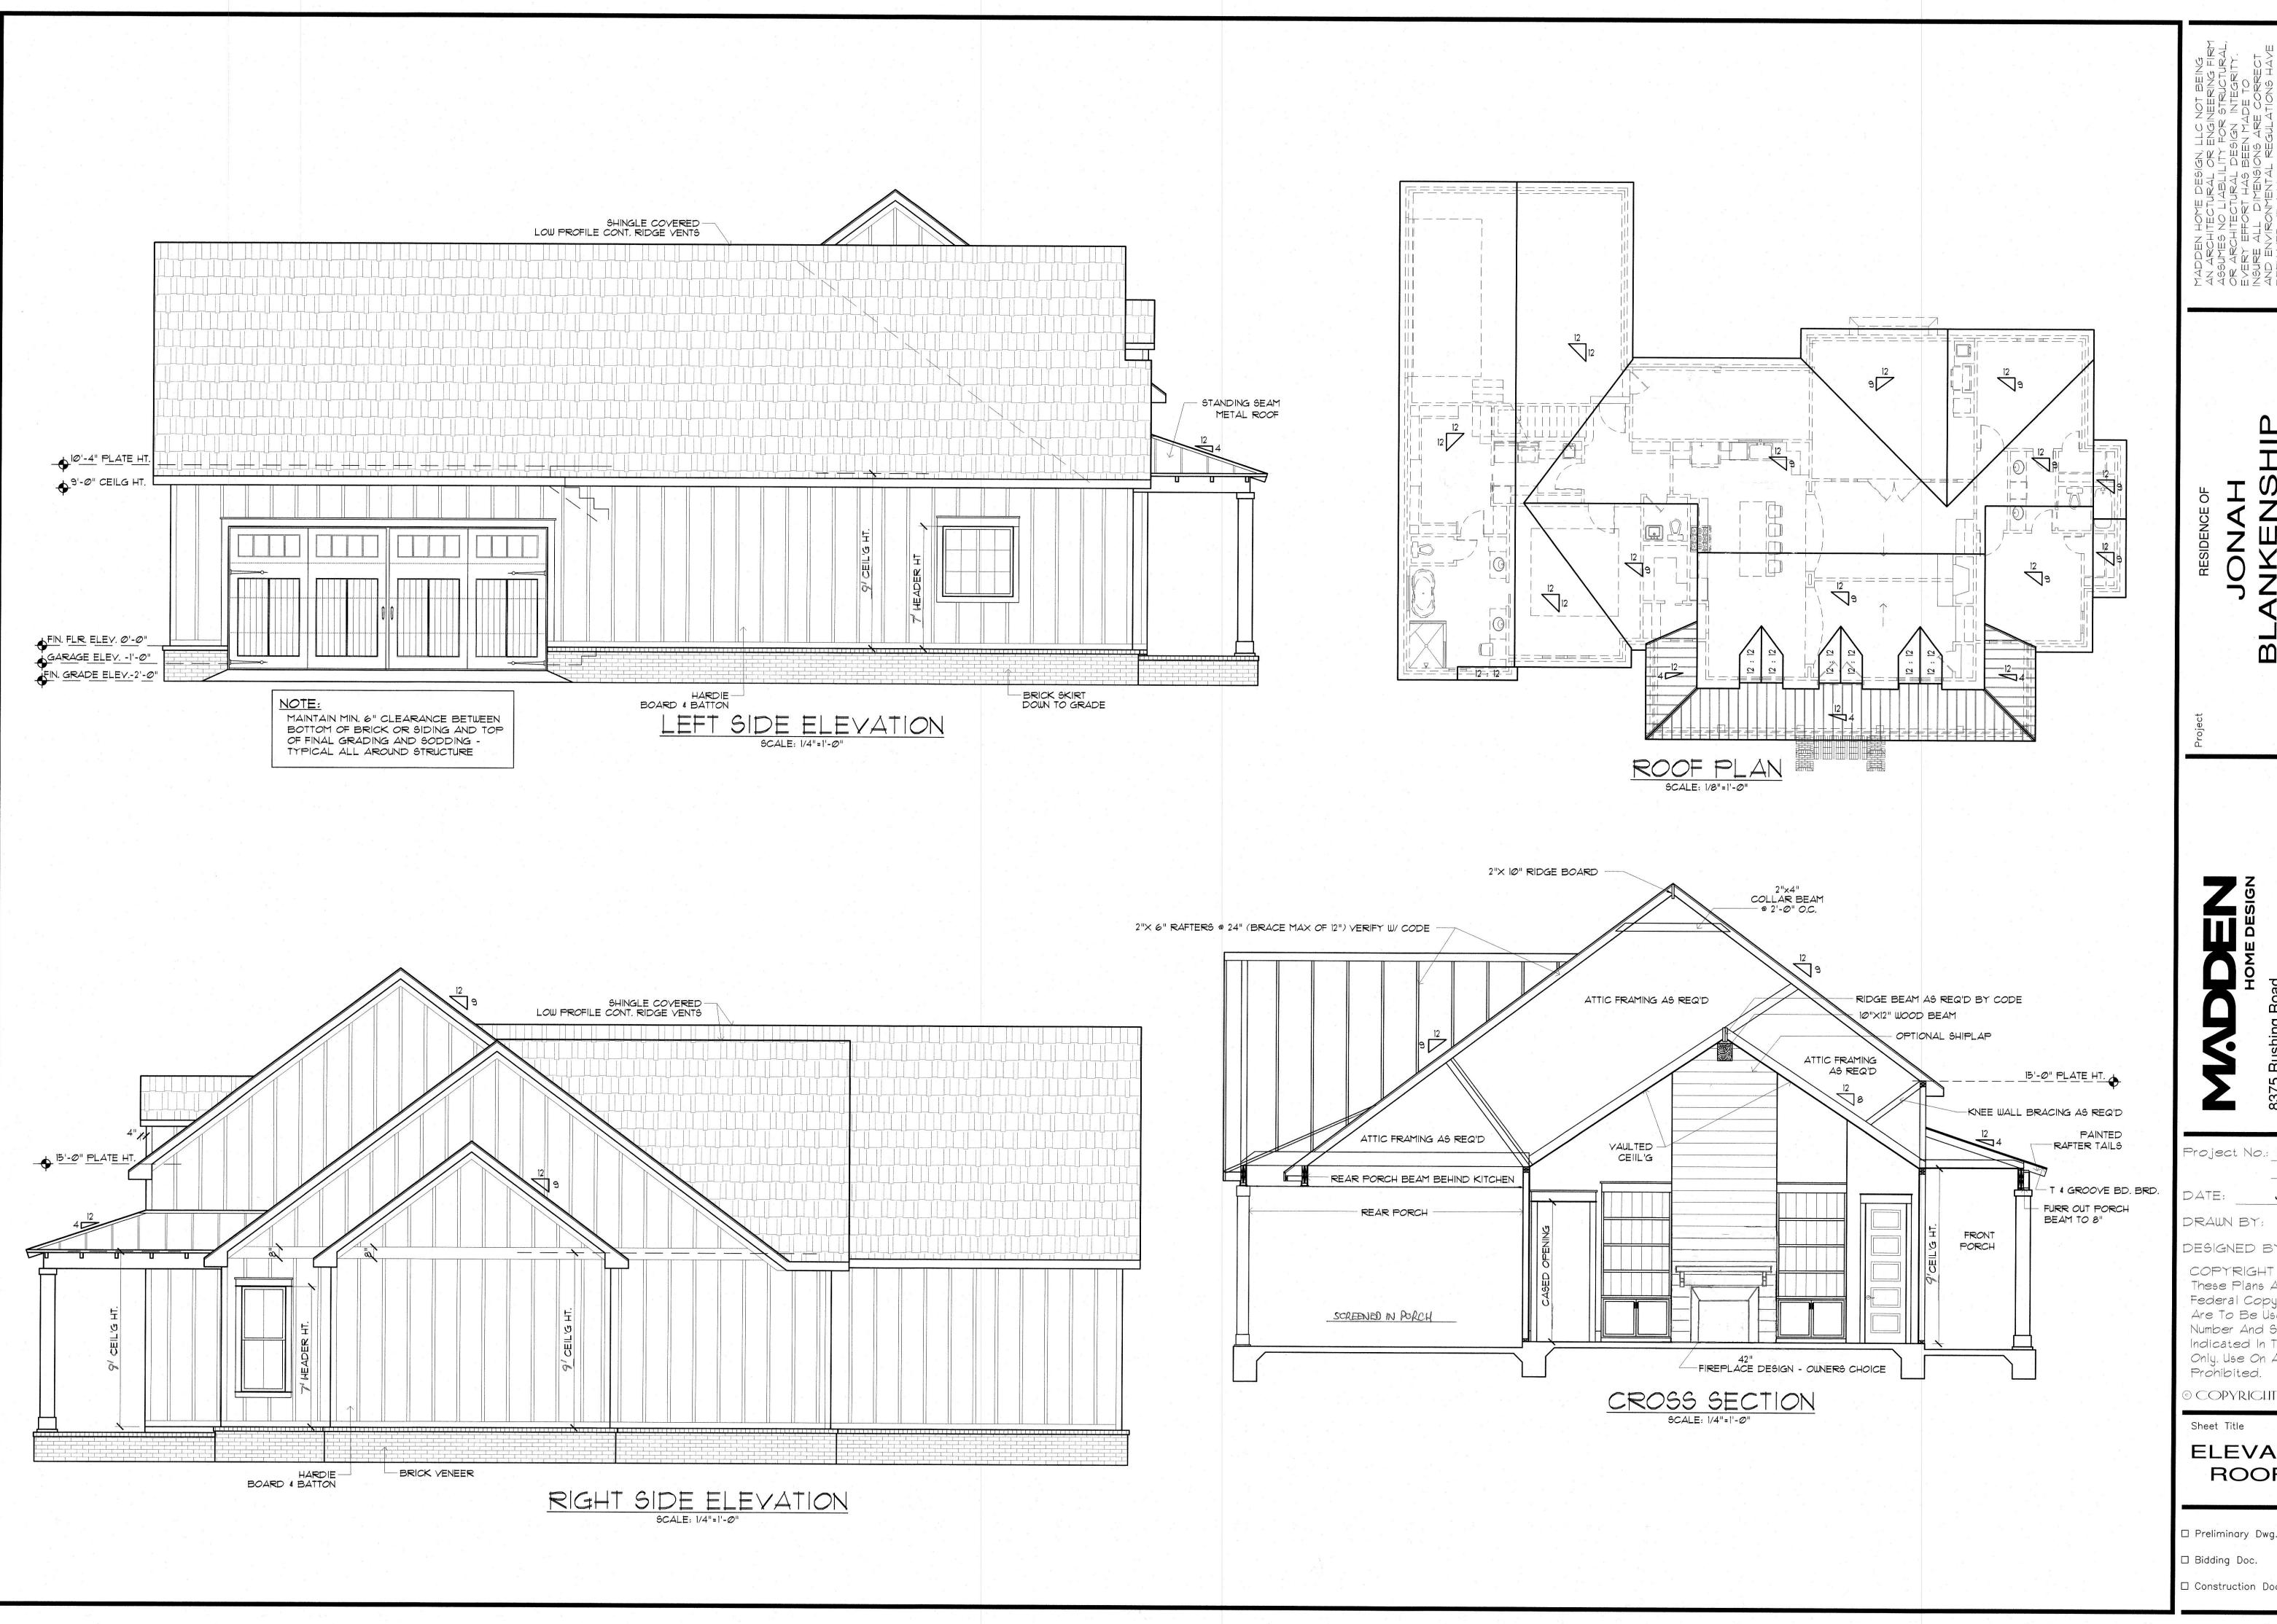

Project No.: Myrtle Beach - Mirror (Garage)

JULY 12, 2024 Steven Madden


DESIGNED BY: Steven Madden

COPYRIGHT NOTE: © These Plans Are Subject To Federal Copyright Laws And Are to Be Used For the Lot Number And Subdivision Indicated in This Title Block Only. Use On Any Other Site is Prohibited.

© COPYRICHT 2022

ELEVATIONS & ROOF PLAN

☐ Preliminary Dwg.

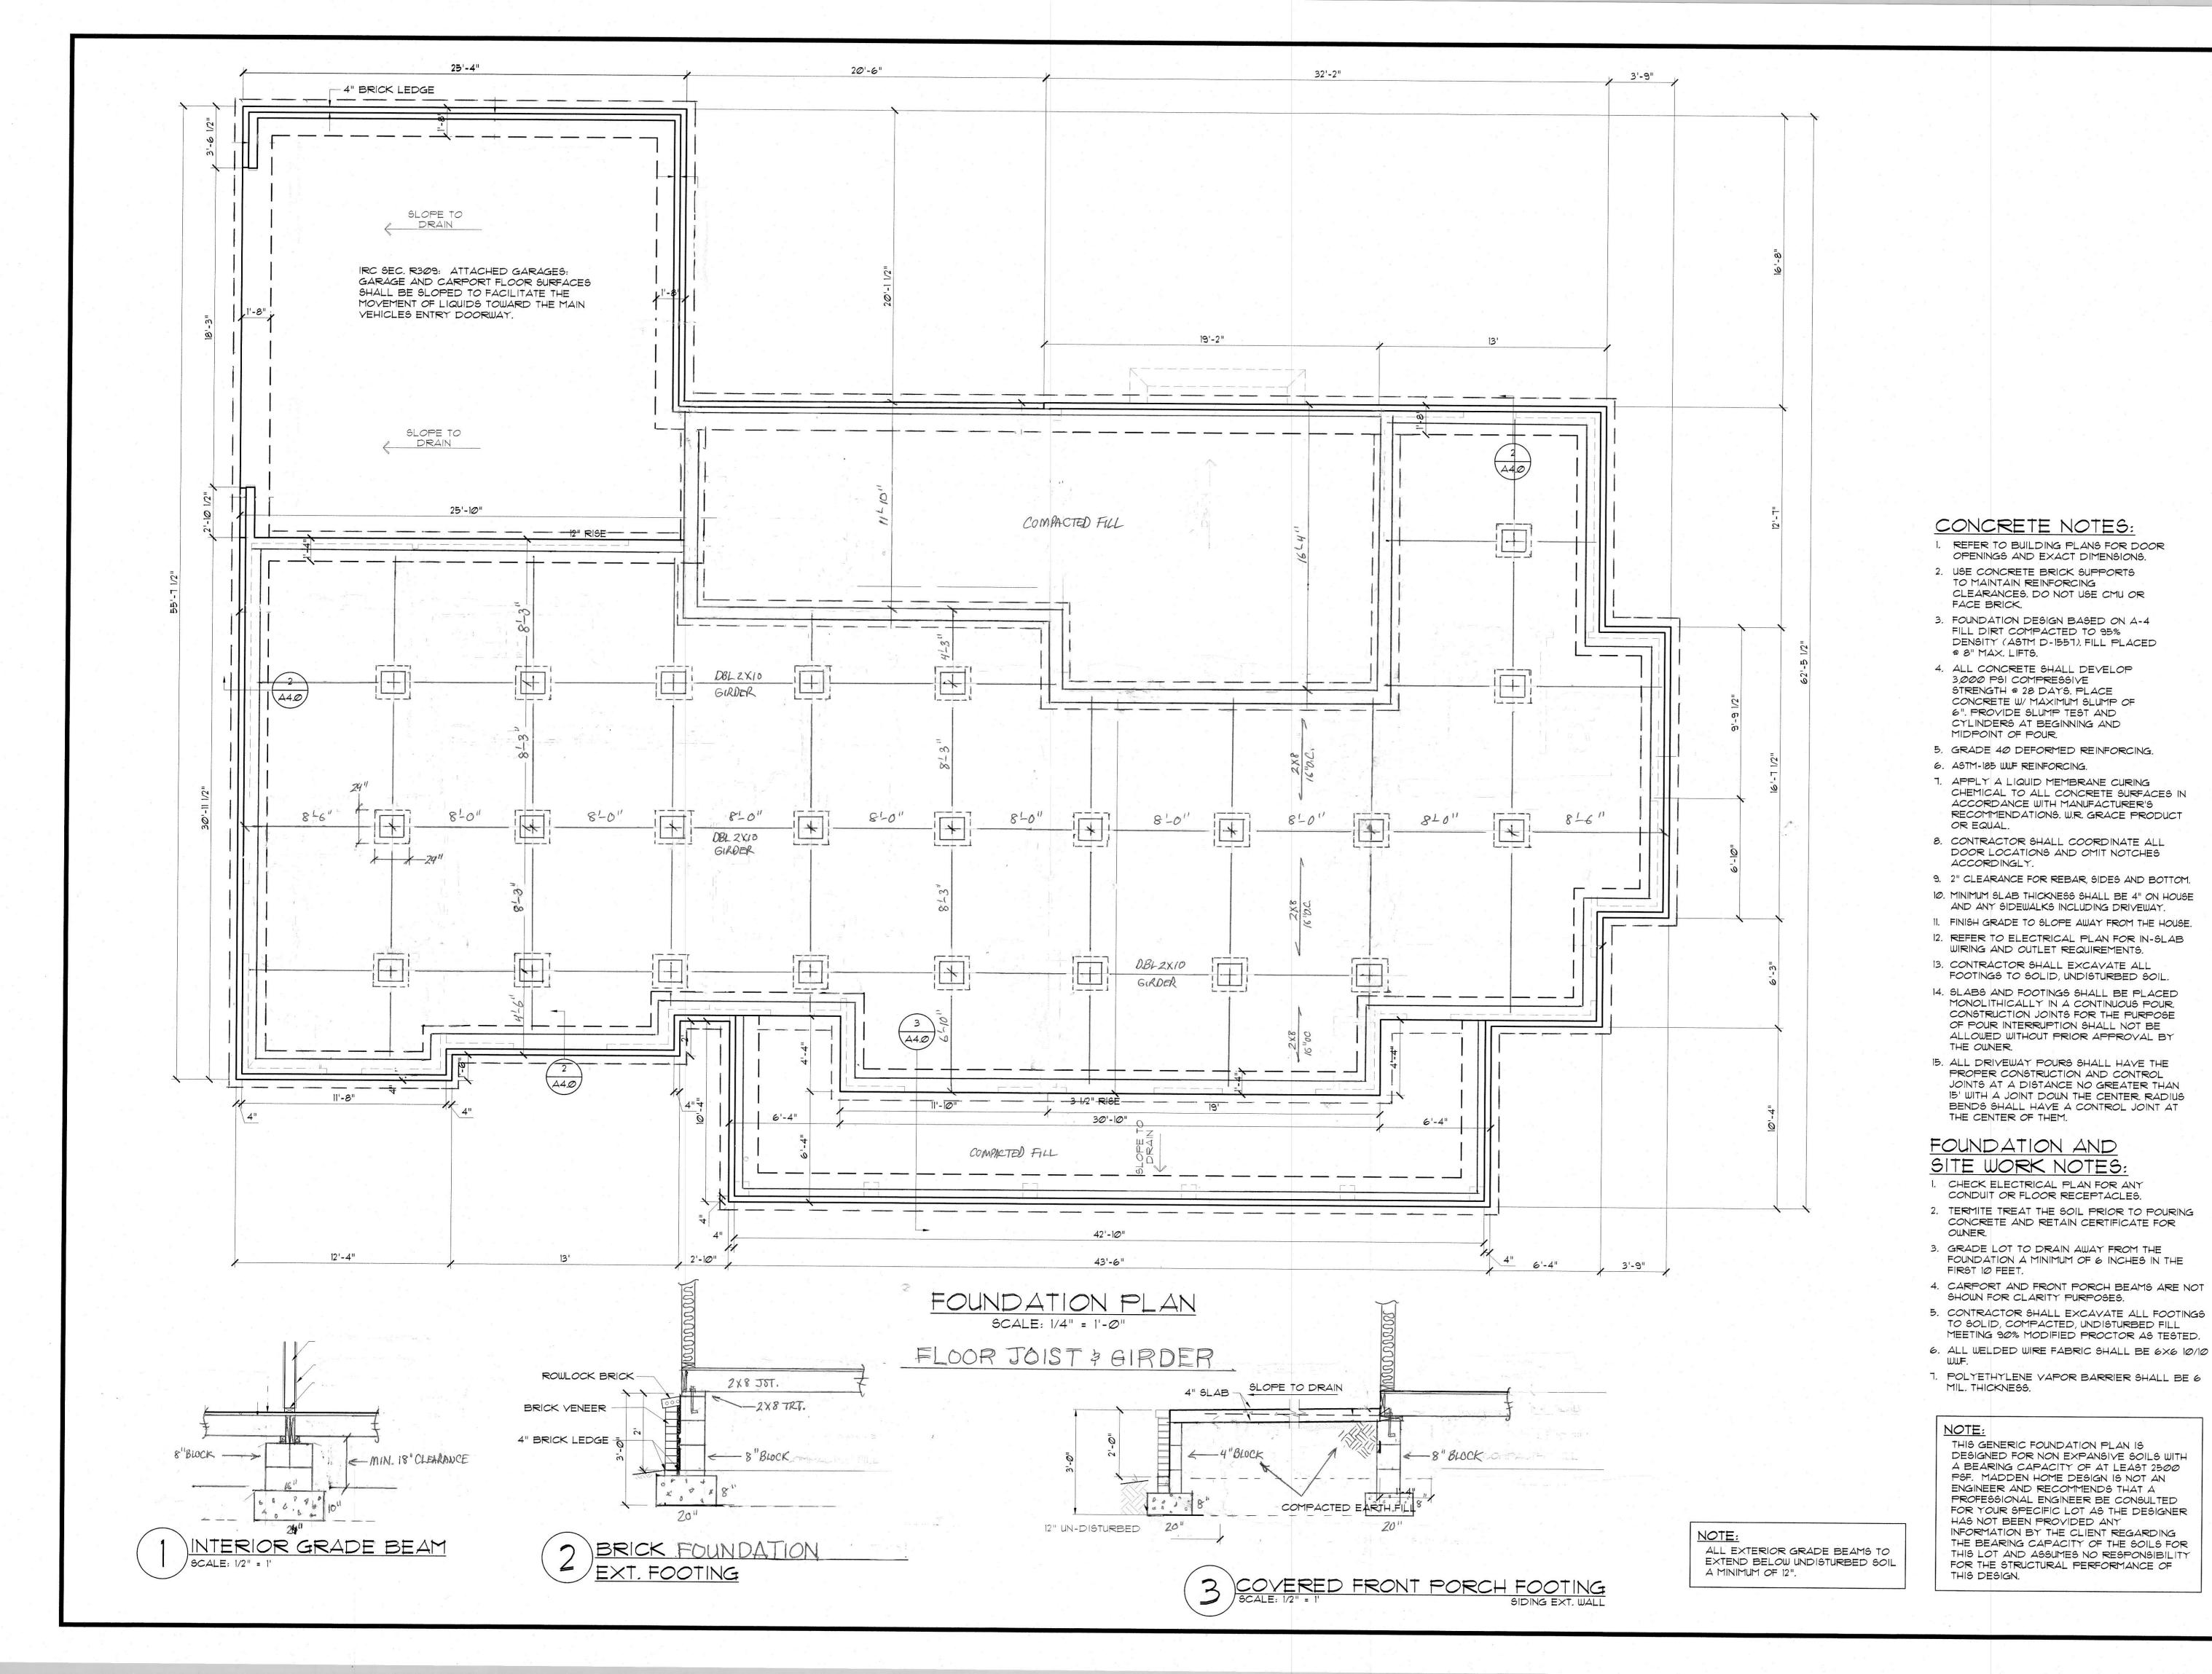

AN ARCHITECTURAL OR ENGINES
ASSUMES NO LIABLILITY FOR ST
OR ARCHITECTURAL DESIGN IN
EVERY EFFORT HAS BEEN MADE
INSURE ALL DIMENSIONS ARE O
AND ENVIRONMENTAL REGULATI
BEEN MET. IF AN ERROR OR OY
DOES OCCUR, IT IS THE SOLE
RESPONSIBILITY OF THE CONTR,
AND/OR OMMISION AT HIS OWN
AND NOT THE RESPONSIBILITY O
DRAFTING SERVICE.
CONTRACTOR IS RESPONSIBLE FOR

JONAH

Project

C

HOME DE: 375 Rushing Road enham Springs, Louisiana

Project No.: Myrtle Beach - Mirror (Garage)

JULY 12, 2024

RAWN BY: Steven Madden

DESIGNED BY: Steven Madden

COPYRIGHT NOTE: ©
These Plans Are Subject To
Federal Copyright Laws And
Are To Be Used For The Lot
Number And Subdivision

Number And Subdivision Indicated In This Title Block Only. Use On Any Other Site is Prohibited.

COPYRICHT 2022

Sheet Title

FOUNDATION PLAN

Preliminary Dwg.

☐ Construction Do

A4.0

IRC 2021 ELECTRICAL BUILDING CODE NOTES:

- E36018 EMERGENCY DISCONNECTS - FOR ONE AND TWO FAMILY DWELLING UNITS, ALL SERVICE CONDUCTORS SHALL TERMINATE IN DISCONNECTING MEANS HAVING A SHORT-CIRCUIT CURRENT RATING EQUAL TO OR GREATER THAN THE AVAILABLE FAULT CURRENT, INSTALLED IN A READILY ACCESSIBLE OUTDOOR LOCATION. IF MORE THAN ONE DISCONNECT IS PROVIDED, THEY SHALL BE GROUPED. EACH DISCONNECT SHALL BE ONE OF THE FOLLOWING:

- SERVICE DISCONNECTS MARKED AS FOLLOWS: "EMERGENCY DISCONNECT, SERVICE DISCONNECT"
- 2. METER DISCONNECT SWITCHES THAT HAVE A SHORT-CIRCUIT CURRENT RATING EQUAL TO OR GREATER THAN THE AVAILABLE FAULT CURRENT AND ALL METAL HOUSINGS AND SERVICE ENCLOSURES ARE GROUNDED IN ACCORDANCE WITH SECTION E3908.7 AND BONDED IN ACCORDANCE WITH SECTION 3609. A METER DISCONNECT SWITCH SHALL BE CAPABLE OF INTERRUPTING THE LOAD SERVED AND SHALL BE MARKED AS FOLLOWS: "EMERGENCY DISCONNECT, METER DISCONNECT, NOT SERVICE
- 3. OTHER LISTED DISCONNECT SWITCHES OR CIRCUIT BREAKERS ON THE SUPPLY SIDE OF EACH SERVICE DISCONNECT THAT ARE SUITABLE FOR USE AS SERVICE EQUIPMENT AND MARKED AS FOLLOWS: "EMERGENCY DISCONNECT, NOT SERVICE EQUIPMENT"

- E3902.9 LAUNDRY AREAS - 125 VOLT THROUGH 250 VOLT RECEPTACLES INSTALLED IN LAUNDRY AREAS AND SUPPLIED BY SINGLE-PHASE BRANCH CIRCUITS RATES 150 VOLTS OR LESS TO GROUND SHALL HAVE GROUND-FAULT CIRCUIT-INTERRUPTER PROTECTION FOR PERSONNEL (NEC 210.8(A)(10))

- E3902.11 KITCHEN DISHWASHER BRANCH CIRCUIT - GROUND-FAULT CIRCUIT-INTERRUPTER PROTECTION SHALL BE PROVIDED FOR OUTLETS SUPPLIED BY BRANCH CIRCUITS RATED 150 VOLTS OR LESS TO GROUND THAT SUPPLY DISHWASHERS IN DWELLING UNIT LOCATIONS. (NEC 422.5(A))


- E36065 SURGE PROTECTION - ALL SERVICES SUPPLYING ONE AND TWO FAMILY DWELLING UNITS SHALL BE PROVIDED WITH A SURGE-PROTECTIVE DEVICE (SPD) INSTALLED IN ACCORDANCE WITH SECTIONS E3606.5.1 THROUGH E3606.5.3


- E3606.5.1 LOCATION - THE SPD SHALL BE AN INTEGRAL PART OF THE SERVICE EQUIPMENT OR SHALL BE LOCATED IMMEDIATELY ADJACENT THERETO. EXCEPTION. THE SPD SHALL NOT BE REQUIRED TO BE LOCATED IN THE SERVICE EQUIPMENT IF LOCATED AT EACH NEXT LEVEL DISTRIBUTION EQUIPMENT DOWNSTREAM TOWARD THE LOAD.

- E3606.52 TYPE - THE SPD SHALL BE A TYPE I OR TYPE 2 SPD.

ELECTRICAL PLAN

SCALE: 1/4" = 1'-0"

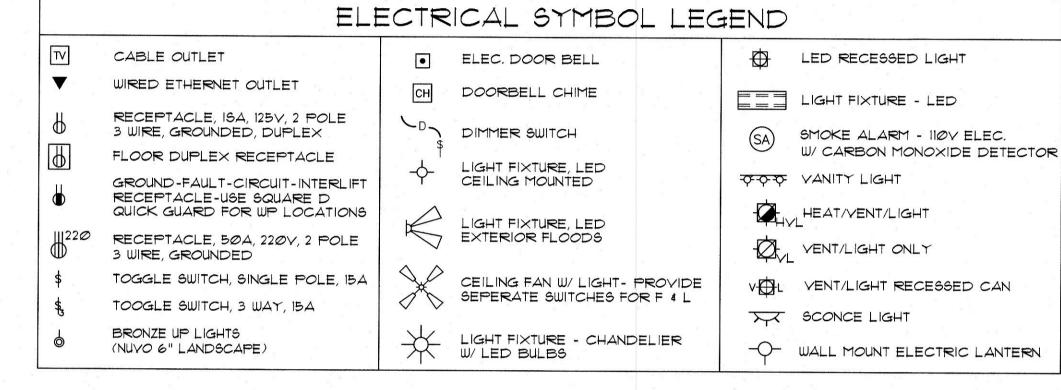


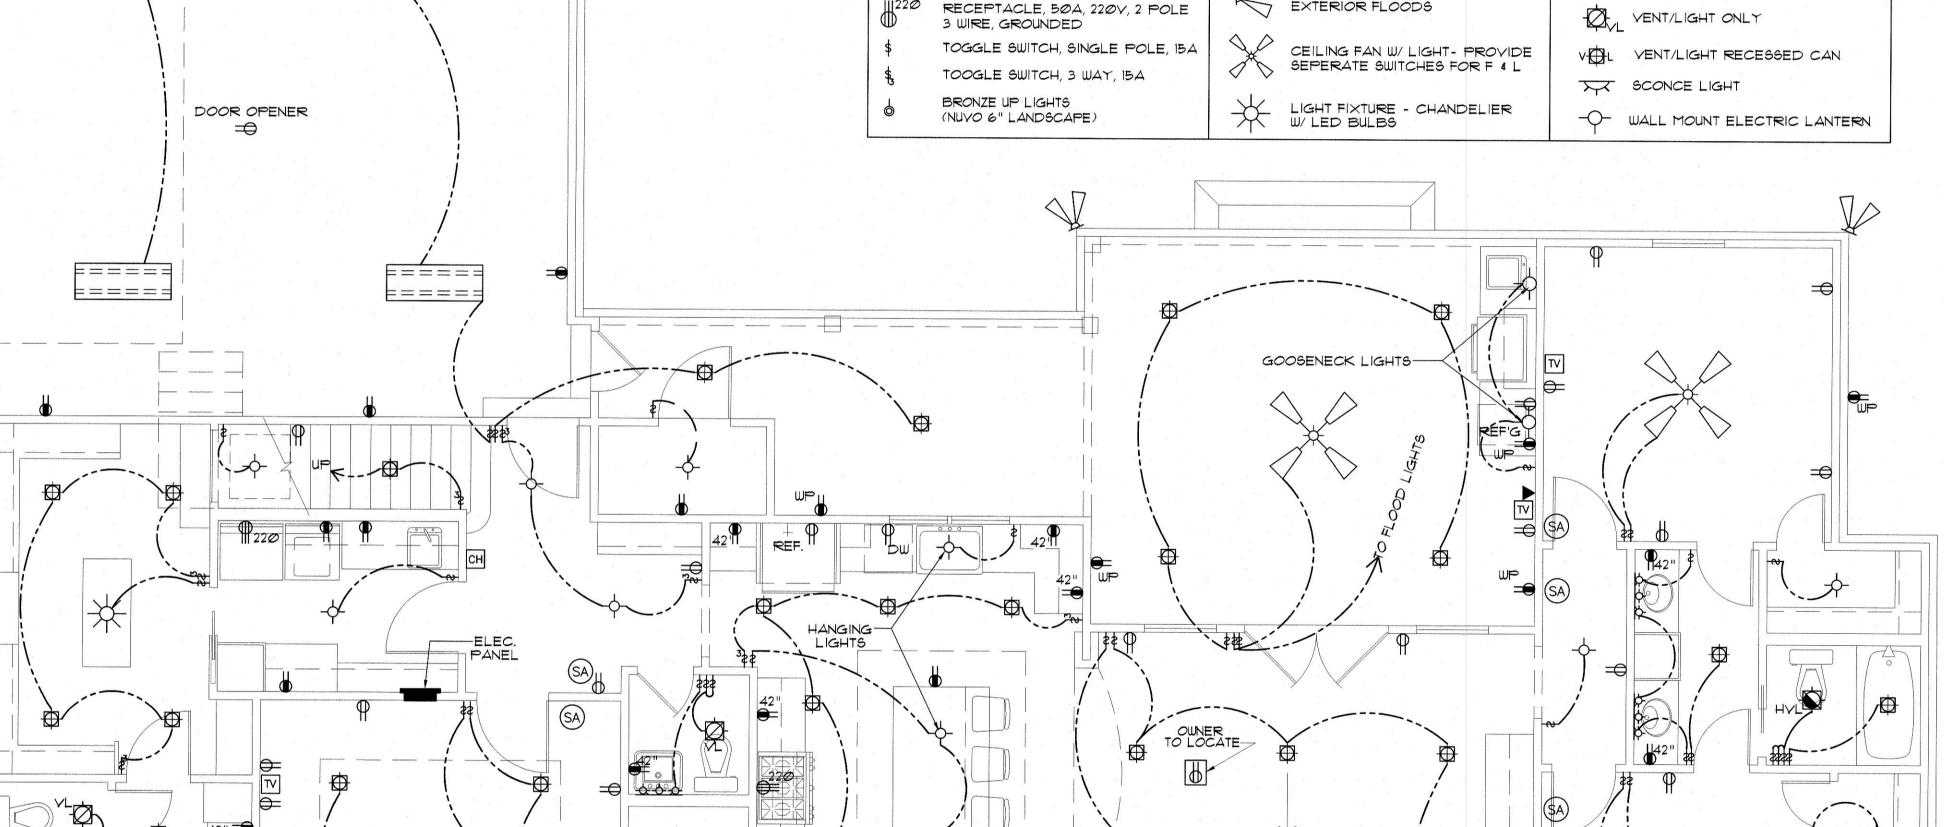

220 OVEN /

 \Rightarrow

====

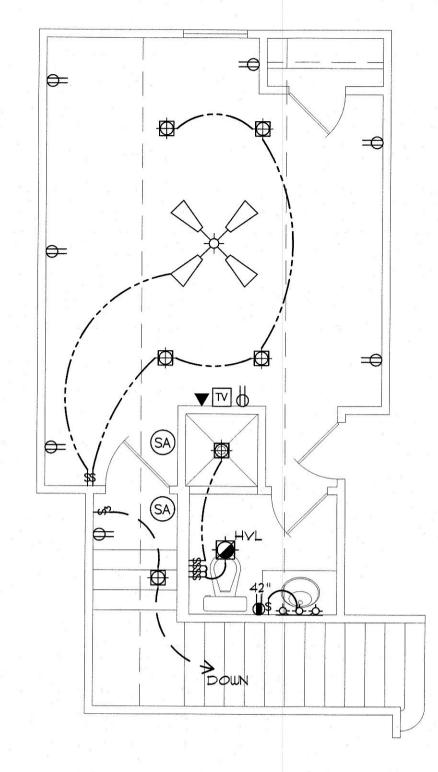

SCALE: 1/4" = 1'-0"

PRE-WIRE FOR THE FOLLOWING:

- TELEPHONE *ONE INCOMING LINE*
- CABLE VISION *ONE OUTLET PER ROOM MINIMUM*
- SECURITY SYSTEM COORDINATE W/ OWNER
- COORDINATE ELECTRICAL SYSTEM WITH MECHANICAL CONTRACTOR
- ALL WIRING TO BE COPPER MIN. 12/2 W/ GROUND
- VERIFY LOCATION OF FLOOR OUTLETS IN FAMILY ROOM
- PROVIDE 110V OUTLET FOR GARBAGE DISPOSAL UNDER KITCHEN SINK - PROVIDE 110V OUTLET FOR WHIRLPOOL TUB MOTOR UNDER WHIRLPOOL
- TUB IN MASTER BATH IF APPLICABLE
- PROVIDE 220V OUTLET FOR CLOTHES DRYER - COORDINATE SURROUND SYSTEM W/ OWNER

ELECTRICAL NOTES:

- MAIN FEED INTO HOUSE TO BE TRENCHED UNDERGROUND FROM SUPPLY POLE TO METER THEN MAIN DISCONNECT OUTSIDE.
- ALL SMOKE DETECTORS TO BE ELECTRIC POWERED WITH BATTERY
- BACKUP AND WIRED TO SET ALL ALARMS OFF IF ONE IS TRIPPED. - ALL EXTERIOR, KITCHEN, AND BATH OUTLETS TO BE GROUND FAULT
- CIRCUIT INTERRUPT EQUIPPED AND ON A SEPARATE CIRCUIT. - ELECTRICAL DISCONNECTS ARE TO BE AT A/C UNIT, CONDENSING UNIT,
- AND WATER HEATER. - HEAT VENT LIGHTS ARE TO BE ON A SEPARATE CIRCUIT.
- OUTLETS, INCLUDING PHONE AND CABLE, MAY BE ADDED OR CHANGED
- UPON OWNERS REQUEST. - ELECTRICAL CONTRACTOR TO VERIFY EQUIPMENT TYPE AND SIZE.
- INSTALL LIGHTS IN ATTIC SPACE W/ SWITCH AT FOOT OF DISP. STAIRS
- ELECTRICAL SERVICE TO BE A 42 CIRCUIT 200 AMP MAIN LOCATED IN
- THE UTILITY. - A SUB-PANEL MAY NEED TO BE ADDED FOR ENOUGH CIRCUITS.
- HOUSE TO BE WIRED FOR A SECURITY SYSTEM.
- ALL KITCHEN OUTLETS ARE TO BE GFI EXCEPT APPLIANCE OUTLETS NOT
- EASILY ACCESSIBLE. - ARC FAULT BREAKERS ARE TO BE USED IN ALL BEDROOMS.
- IF GAS FIRED APPLIANCES ARE USED IN HOME, CARBON MONOXIDE
- ALARMS ARE NEEDED (IRC R315).

Prohibited.

Sheet Title

ELECTRICAL

☐ Preliminary Dwg

☐ Construction Do

Project No.: Myrtle Beach - Mirror (Garage)

DATE: JULY 12, 2024

DRAWN BY: Steven Madden DESIGNED BY: Steven Madden

COPYRIGHT NOTE: © These Plans Are Subject To Federal Copyright Laws And

Are To Be Used For The Lot Number And Subdivision Indicated In This Title Block Only. Use On Any Other Site is

O COPYRIGHT 2022

PLAN

☐ Bidding Doc.



The Myrtle Beach

GENERAL NOTES:

- 1. ALL KITCHEN AND UTILITY COUNTERTOPS ARE SHOWN AS 2'-0" WIDE UNLESS STATED
- 2. ALL BATHROOM LAVATORY COUNTERTOPS SHOWN AS 1'-10" WIDE.
- 3. ATTIC SPACES MUST PROVIDE I SQ. FT. VENTILATION PER 150 SQ. FT. OF AREA UNLESS CONDITIONED SPACE. (ATTICS R.906)
- 4. ALL INTERIOR DIMENSIONS ARE FROM STUD FACE TO STUD FACE.
- 5. ALL INTERIOR WALL THICKNESS SHOWN AS 4" UNLESS NOTED OTHERWISE.
- 6. THE CONTRACTOR SHALL VERIFY ALL DIMENSIONS
- BEFORE COMMENCING WORK. 7. DRYER VENT MUST HAVE MAX LENGTH 25'

OF THIS PLAN.

- 8. PURCHASER OF THIS PLAN ASSUMES LIABILITY FOR ANY MODIFICATIONS MADE TO THE LAYOUT
- 9. ALL WOOD FRAMING SHALL BE NO. 2 GRADE -SOUTHERN PINE LUMBER. ALL CEILING JOISTS SPANS ARE BASED ON TABLE R802.5.1 (2) OF THE I.R.C. 2021 AND ARE DESIGNED FOR ATTICS WITH LIMITED STORAGE. (REFER TO FOUNDATION SHEET FOR
- 10. RE: SEC. 308 GLAZING IN HAZARDOUS LOCATIONS & TEMPERED GLASS FOR WINDOWS THAT ARE WITHIN 24" OF THE DOOR IN THE CLOSED POSITION, PROVIDING THE WINDOW IS LESS THAN 60" ABOVE THE FLOOR (R308 I.R.C. 2021)
- 11. MASONRY VENEER SHALL BE ANCHORED TO THE SUPPORTING WALL WITH CORROSION-RESISTANT METAL TIES SPACED NOT MORE THAN 32" ON CENTER HORIZONTALLY AND 24" VERTICALLY AND SHALL SUPPORT NOT MORE THAN 2.67 SQ. FEET OF WALL PER SECTION RT03.8.4.1 IF APPLICABLE
- 12. VENT HOOD IN KITCHEN MUST VENT TO THE OUTSIDE. MICROWAYE HOODS MUST YENT TO THE OUTSIDE WHERE APPLICABLE.

WIND ZONE NOTES

- VERIFY WINDOW CODE REQUIREMENTS AT EACH BUILDING LOCATION, AND INSTALL WINDOWS AS PER CODE. REQUIREMENTS WILL VARY FROM DOUBLE INSULATED VINYL TO IMPACT RESISTANT DOUBLE INSULATED VINYL WINDOWS. 2. ALL WINDOWS SHALL COMPLY WITH THE GOVERNING IRC/IBC. WINDOWS SHALL BE SELECTED BASED UPON THE COMPONENT AND CLADDING DESIGN
- 3. CONTRACTOR RESPONSIBLE FOR ANCHORAGE OF BOTTOM PLATE AND WALL STUDS TO FOUNDATION IN COMPLIANCE WITH THE GOVERNING EDITION OF IRC/IBC 1609.

FOR LOAD BEARING WALLS:

- SINGLE STORY: 2 PLY 2'X6" 4'-2" MAX 2 PLY 2'X8" 5'-4" MAX 2 PLY 2'XIØ" 7'-6" MAX
- 2 STORY: • 2 PLY 2'X6" 3'X1" MAX 2 PLY 2'X8" 4'X6" MAX
- 2 PLY 2'XIØ" 6'X2" MAX 2 PLY 2X6 HEADERS FOR ALL NON-LOAD BEARING WALLS OSB BETWEEN ALL HEADER PLIES

 NO BOXED HEADERS REFER TO IRC R602.7 (1) AND (2) FOR ADDITIONAL HEADER AND GIRDER

NOTE:

ROOF OVERHANG ON NEW CONSTRUCTION TYPICAL 12" FROM FACE OF STUD UNLESS OTHERWISE NOTED.

PROVIDE ADEQUATE ROOF VENTILATION BUILDING SYSTEMS PER IRC CODE (SECTION R806). SYSTEMS TO BE USED TO MEET ROOF VENTALATION REQUIREMENTS ARE AS FOLLOWS: CONTINUOUS RIDGE VENTS, POWER VENTS, BOX VENTS, AND GABLE/DORMER VENTS WHEN APPROVED BY

GENERAL CONTRACTOR TO

SOFFIT VENTS TO BE USED ONLY IN ACCORDANCE W/ IRC CODE (SECTION R302 AND TABLE R302.1) TO ACCOMMODATE APPROPRIATE FIRE SEPARATION DISTANCES.

GENERAL MATERIALS:

1. EXTERIOR WALLS: -REINFORCED CEMENTITIOUS SIDING

- "TYVEK" BUILDING WRAP -1/2" O.S.B. SHEATHING -R-13 BATT INSULATION

2. INTERIOR WALLS:

-1/2" GYPSUM BOARD INTERIOR -2×4 STUDS @ 1'-4" O.C. -1/2" GYPSUM BOARD ON BOTH SIDES 3. CEILING:

-2× JOISTS @ 1'-4" O.C. -R38 INSULATION 4. ROOF SYSTEM:

-30 YEAR FIBERGLASS SHINGLES -1/2" O.S.B. OR CDX PLYWOOD

-2×6 RAFTERS @ 2'0" O.C.

(CONFIRM W/ LOCAL CODE)

-1/2" GYPSUM BOARD

-2X4 STUDS @ 1'-4" O.C.

NOTE: ALL ROOFING PRODUCTS, MATERIALS AND INSTALLATION, SHALL COMPLY WITH THE REQUIREMENTS UNLESS CHANGED BY GENERAL CONTRACTOR AT OWN DISCRETION.

PROTECTION AGAINST TERMITES

1. SUBTERRANEAN TERMITE CONTROL. IN AREAS FAVORABLE TO TERMITE DAMAGE METHODS OF PROTECTION SHALL BE BY CHEMICAL SOIL TREATMENT, PRESSURE-TREATED WOOD, NATURALLY TERMITE RESISTANT WOOD OR PHYSICAL BARRIERS (SUCH AS METAL OR PLASTIC TERMITE SHIELDS), OR ANY COMBINATION OF THESE METHODS.

2. CHEMICAL SOIL TREATMENT, THE CONCENTRATION, RATE OF APPLICATION AND TREATMENT METHOD OF THE TERMITICIDE LABEL.

3. PRESSURE-TREATED AND NATURALLY RESISTANT WOOD. HEARTWOOD OF REDWOOD AND EASTERN RED CEDAR SHALL BE CONSIDERED TERMITE RESISTANT. PRESSURE-TREATED WOOD AND NATURALLY TERMITE RESISTANT WOOD SHALL NOT BE USED AS A PHYSICAL BARRIER UNLESS A BARRIER CAN BE INSPECTED FOR ANY TERMITE SHELTER TUBES AROUND THE INSIDE AND OUTSIDE EDGES AND JOINTS OF A BARRIER

4. FIELD TREATMENT, FIELD CUT ENDS, NOTCHES, AND DRILLED HOLES OF PRESSURE-TREATED WOOD SHALL BE RETREATED IN THE FIELD ACCORDING TO

WINDOW EGRESS NOTES

- R311.1 MEANS OF EGRESS, DWELLINGS SHALL BE PROVIDED WITH A MEANS OF EGRESS IN ACCORDANCE WITH THIS SECTION. THE MEANS OF EGRESS SHALL PROVIDE A CONTINUOUS AND UNOBSTRUCTED PATH OF VERTICAL AND HORIZONTAL EGRESS TRAVEL FROM ALL PORTIONS OF THE DWELLING TO THE REQUIRED EGRESS DOOR WITHOUT REQUIRING TRAVEL THROUGH A GARAGE. THE REQUIRED EGRESS DOOR SHALL OPEN DIRECTLY INTO A PUBLIC WAY OR TO A YARD OR COURT THAT OPENS TO A PUBLIC WAY.
- R310.2.1 MINIMUM OPENING AREA. EMERGENCY AND ESCAPE RESCUE OPENINGS SHALL HAVE A NET CLEAR OPENING OF NOT LESS THAN 5.7 SQUARE FEET (0.530 M2). THE NET CLEAR OPENING DIMENSIONS REQUIRED BY THIS SECTION SHALL BE OBTAINED BY THE NORMAL OPERATION OF THE EMERGENCY ESCAPE AND RESCUE OPENING FROM THE INSIDE. THE NET CLEAR HEIGHT OPENING SHALL BE NOT LESS THAN 24 INCHES (610 MM) AND THE NET CLEAR WIDTH SHALL BE NOT LESS THAN 20 INCHES (508 MM), EXCEPTION: GRADE FLOOR OR BELOW GRADE OPENINGS SHALL HAVE A NET CLEAR OPENING OF NOT LESS THAN 5 SQUARE FEET (0.465 M2).
- 3. R31023 WINDOW SILL HEIGHT, WHERE A WINDOW IS PROVIDED AS THE EMERGENCY ESCAPE AND RESCUE OPENING, IT SHALL HAVE A SILL HEIGHT OF NOT MORE THAN 44 INCHES (1118 MM) ABOVE THE FLOOR, WHERE THE SILL HEIGHT IS BELOW GRADE, IT SHALL BE PROVIDED WITH A WINDOW WELL IN ACCORDANCE WITH SECTION R310.4.1.
- 4. R310.4.1 WINDOW WELLS. THE HORIZONTAL AREA OF THE WINDOW WELL SHALL BE NOT LESS THAN 9 SQUARE FEET (0.9 M2), WITH A HORIZONTAL PROJECTION AND WIDTH OF NOT LESS THAN 36 INCHES (914 MM), THE AREA OF THE WINDOW WELL SHALL ALLOW THE EMERGENCY ESCAPE AND RESCUE OPENING TO BE FULLY OPENED. EXCEPTION: THE LADDER OR STEPS REQUIRED BY SECTION R310.4.2 -SHALL BE PERMITTED TO ENCROACH NOT MORE THAN 6 INCHES (152 MM) INTO THE REQUIRED DIMENSIONS OF THE WINDOW WELL.

- 5. R310.42 LADDER AND STEPS. WINDOW WELLS WITH A VERTICAL DEPTH GREATER THAN 44 INCHES (III8 MM) SHALL BE EQUIPPED WITH A PERMANENTLY AFFIXED LADDER OR STEPS USABLE WITH THE WINDOW IN THE FULLY OPEN POSITION, LADDERS OR STEPS REQUIRED BY THIS SECTION SHALL NOT BE REQUIRED TO COMPLY WITH SECTION R311.7, LADDERS OR RUNGS SHALL HAVE AN INSIDE WIDTH OF NOT LESS THAN 12 INCHES (305 MM), SHALL PROJECT NOT LESS THAN 3 INCHES (16 MM) FROM THE WALL AND SHALL BE SPACED NOT MORE THAN 18 INCHES (457 MM) ON CENTER VERTICALLY FOR THE FULL HEIGHT OF THE WINDOW WELL.
- 6. R312.2 WINDOW FALL PROTECTION, WINDOW FALL PROTECTION SHALL BE PROVIDED IN ACCORDANCE WITH SECTIONS R312.2.1 AND R312.2.2.
- R312.2.1 WINDOW OPENING HEIGHT, IN DWELLING UNITS. WHERE THE TOP OF THE SILL OF AN OPERABLE WINDOW OPENING IS LOCATED LESS THAN 24 INCHES (610 MM) ABOVE THE FINISHED FLOOR AND GREATER THAN 72 INCHES (1829 MM) ABOVE THE FINISHED GRADE OR OTHER SURFACE BELOW ON THE EXTERIOR OF THE BUILDING, THE OPERABLE WINDOW SHALL COMPLY WITH ONE OF THE FOLLOWING:
 - 1. OPERABLE WINDOW OPENINGS WILL NOT ALLOW A 4-INCH-DIAMETER (102 MM) SPHERE TO PASS THROUGH THE OPENING WHERE THE OPENINGS ARE IN THEIR LARGEST OPENED POSITION.
 - 2. OPERABLE WINDOWS ARE PROVIDED WITH WINDOW FALL PREVENTION DEVICES THAT COMPLY WITH ASTM F2090.
- 8. R312.2.2 EMERGENCY ESCAPE AND RESCUE OPENINGS. WINDOW OPENING CONTROL DEVICES SHALL COMPLY WITH ASTM F 2090. THE WINDOW OPENING CONTROL DEVICE. AFTER OPERATION TO RELEASE THE CONTROL DEVICE ALLOWING THE WINDOW TO FULLY OPEN, SHALL NOT REDUCE THE NET CLEAR OPENING AREA OF THE WINDOW UNIT TO LESS THAN THE AREA REQUIRED BY SECTIONS R310.2.1 AND R310.2.2.

CODE DISCLAIMER:

- THESE PLANS WERE DESIGNED TO MEET IRC 2021 AT THE TIME OF THEIR CREATION AND MORE SPECIFICALLY THE MINIMAL LOCAL CODES OF THE SOUTH LOUISIANA AREA. IT IS HIGHLY RECOMMENDED THAT THESE PLANS BE REVIEWED BY A LOCAL STRUCTURAL ENGINEER PRIOR TO CONSTRUCTION.
- 2. BEAMS AND FLOOR JOISTS ARE NOT SIZED DUE TO THE MANY GEOGRAPHIC LOCATIONS THESE PLANS ARE SOLD. THESE ITEMS SHALL BE SIZED BY A LOCAL ENGINEER OR MANUFACTURER
- 3. ALL CEILING & FLOOR JOISTS (IF CONVENTIONAL FRAMING) SHOULD BE SIZED USING THE LATEST VERSION OF THE IRC OR APPLICABLE CODES AT SITE TO MEET THE LOCAL REQUIREMENTS SUCH AS SNOW LOADS AND OTHER FACTORS. THE CEILING JOIST SIZES LABELED (IF PRESENT) WERE SIZED USING THE 2021 IRC AT THE TIME OF THEIR CREATION. THEY MUST BE VERIFIED AND MODIFIED AS REQUIRED TO MEET THE LATEST EDITION OF THE (IRC) INTERNATIONAL RESIDENTIAL CODE.
- 4. ALL FOUNDATION AND FOOTING DETAILS SHALL BE REVIEWED AND APPROVED BY A LOCAL ENGINEER.
- 5. CONTRACTOR SHALL PROVIDE ALL HIGH WIND STRAPPING AND ANCHOR BOLTS AS REQUIRED BY THE LOCAL CODE REQUIREMENTS AND THE LATEST VERSION OF THE IRC.

 $\bar{\mathbf{x}}$

375 inha 726 ir

Project No.: Myrtle Beach - Mirror (Garage) JULY 12, 2024

Steven Madden

DESIGNED BY: Steven Madden

COPYRIGHT NOTE: (9) These Plans Are Subject To Federal Copyright Laws And Are To Be Used For The Lot Number And Subdivision Indicated In This Title Block Only. Use On Any Other Site is

Prohibited. COPYRICHT 2022

Sheet Title

COVER SHEET

□ Preliminary Dwa Bidding Doc.

☐ Construction Do

