REVISION LOG DATE: 6/20/2022

1. ADD OPT. EXTENDED CAFE W/ COVERED PATIO/DECK

REVISION:003 DATE: 7/22/2022

REVISION:001

REVISION:002

ADD STEM WALL SLAB FOUNDATION SHEETS AND SIEM WALL SLAB POUNDATION SHEETS.

ADD "STEM WALL" TO CRAWL ELEVATION TITLES AND ADD NOTE "SEE FOUNDATION PAGES FOR FOUNDATION TYPE". UPDATE SHEET TITLES

DATE: 7/05/2022

DATE: 11/2/2023

ADD SIDE LOAD GARAGE PLAN FOR EXTENDED CAFE W/ MESSY KITCHEN
ADD FOUNDATION FOR SIDE LOAD GARAGE FOR EXTENDED CAFE W/ MESSY KITCHEN
REMOVE END CABINET OF MESSY KITCHEN
ADDED THREE 2/0x2/0 window option for the extended cafe
REMOVED PULL DOWN STARS FROM THE SECOND FLOOR STAIR TO THIRD FLOOR
OPTIONS.

Redlines completed 18-Apr-24 - DP

Lot 14 - Duncan's Creek

161 Beacon Hill Road Lillington, NC 27546

NC.



Total Heated: 2120

Total Unheated: 689

THIS PLAN IS TO BE BUILT IN CONFORMANCE WITH THE 2018 NORTH CAROLINA STATE BUILDING CODE: RESIDENTIAL CODE

DESIGN CRITERIA:

DIMENSIONS SHALL GOVERN OVER SCALE, AND CODE SHALL GOVERN OVER DIMENSIONS.

Smithfield - LH

'ENGLISH COUNTRY' ELEVATION

Sheet No.	Sheet Description
0.0	Cover Sheet
1.1	Foundation (Slab)
1.1.1	Foundation Options (Slab)
1.1.2	Foundation Options (Slab)
1.2.1	Foundation (Crawl) Foundation Options (Crawl)
1.2.1	Foundation Options (Crawl)
1.2.2	Foundation (Stem Wall Slab))
	Foundation Options (Stem Wall Slab)
1.3.1	Foundation Options (Stern Wall Slab)
1.3.2	, , ,
2.1	First Floor Plan
2.1.1	First Floor Plan Options
2.2	Second Floor Plan
2.2.1	Second Floor Plan Options
2.3	Opt. Third Floor
2.4	Covered Patio Plans & Elevations (Slab)
2.4.1	Covered Deck Plans & Elevations (Crawl/ Stem Wall)
2.5	Extended Cafe Elevations & Roof Plan (Slab)
2.5.1	Extended Cafe Elevations & Roof Plan (Crawl/ Stem Wall)
2.6	Extended Cafe w/ Covered Patio Elevations & Roof Plan (Slab)
2.6.1	Extended Cafe w/ Cov. Deck Elev. & Roof Plan (Crawl/ Stem Wall)
2.7	2-Car Sideload Garage Plans
2.7.1	2-Car Sideload Garage Elevations
3.1	Front & Rear Elevations (Slab)
3.1.1	Front & Rear Elevations (Crawl/ Stem Wall)
3.1.2	Front & Rear Elevations (Slab) Attic Option
3.1.3	Front & Rear Elevations (Crawl/ Stem Wall) Attic Option
3.2	Side Elevations (Slab)
3.2.1	Side Elevations (Crawl/ Stem Wall)
3.2.2	Side Elevations (Slab) Attic Option
3.2.3	Side Elevations (Crawl/ Stem Wall) Attic Option
3.3	Roof Plan
5.1	First Floor Electrical
5.2	
	Second Floor Electrical Second Floor Options Electrical
5.2.1	Opt. Third Floor Electrical

	SQUARE	FOOT	4GE
		ENGLISH (COUNTRY
		UNHEATED	HEATED
	FIRST FLOOR	0	846
	SECOND FLOOR	0	1154
	FRONT PORCH	56	0
	2 CAR GARAGE	414	0
-	PATIO	144	0
	SUBTOTALS	614	2000
7	TOTAL UNDER ROOF	26	14
	OI	PTIONS	
		UNHEATED S.F.	
		UNITER IED 3.F.	HEATED S.F.
	UNFIN. THIRD FLOOR	UNHEATED 3.F.	HEATED S.F.
	UNFIN. THIRD FLOOR		HEATED S.F.
	UNFIN. THIRD FLOOR FINISHED THIRD FLOOR EXTENDED CAFE	1554	Û
	UNFIN. THIRD FLOOR FINISHED THIRD FLOOR EXTENDED CAFE PATIO W/ EXT CAFE	1554	0
		+554 0 -144	0 -551 +120
	PATIO W/ EXT CAFE	-144 +150	+120 0





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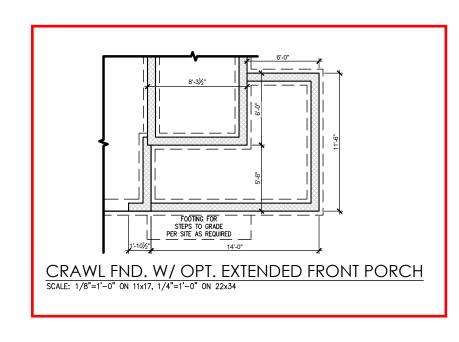
Cover Sheet 'English Country

DRAWN BY: South Designs/J.Jones ISSUE DATE: CURRENT REVISION DATE

THE SMITHFIELD



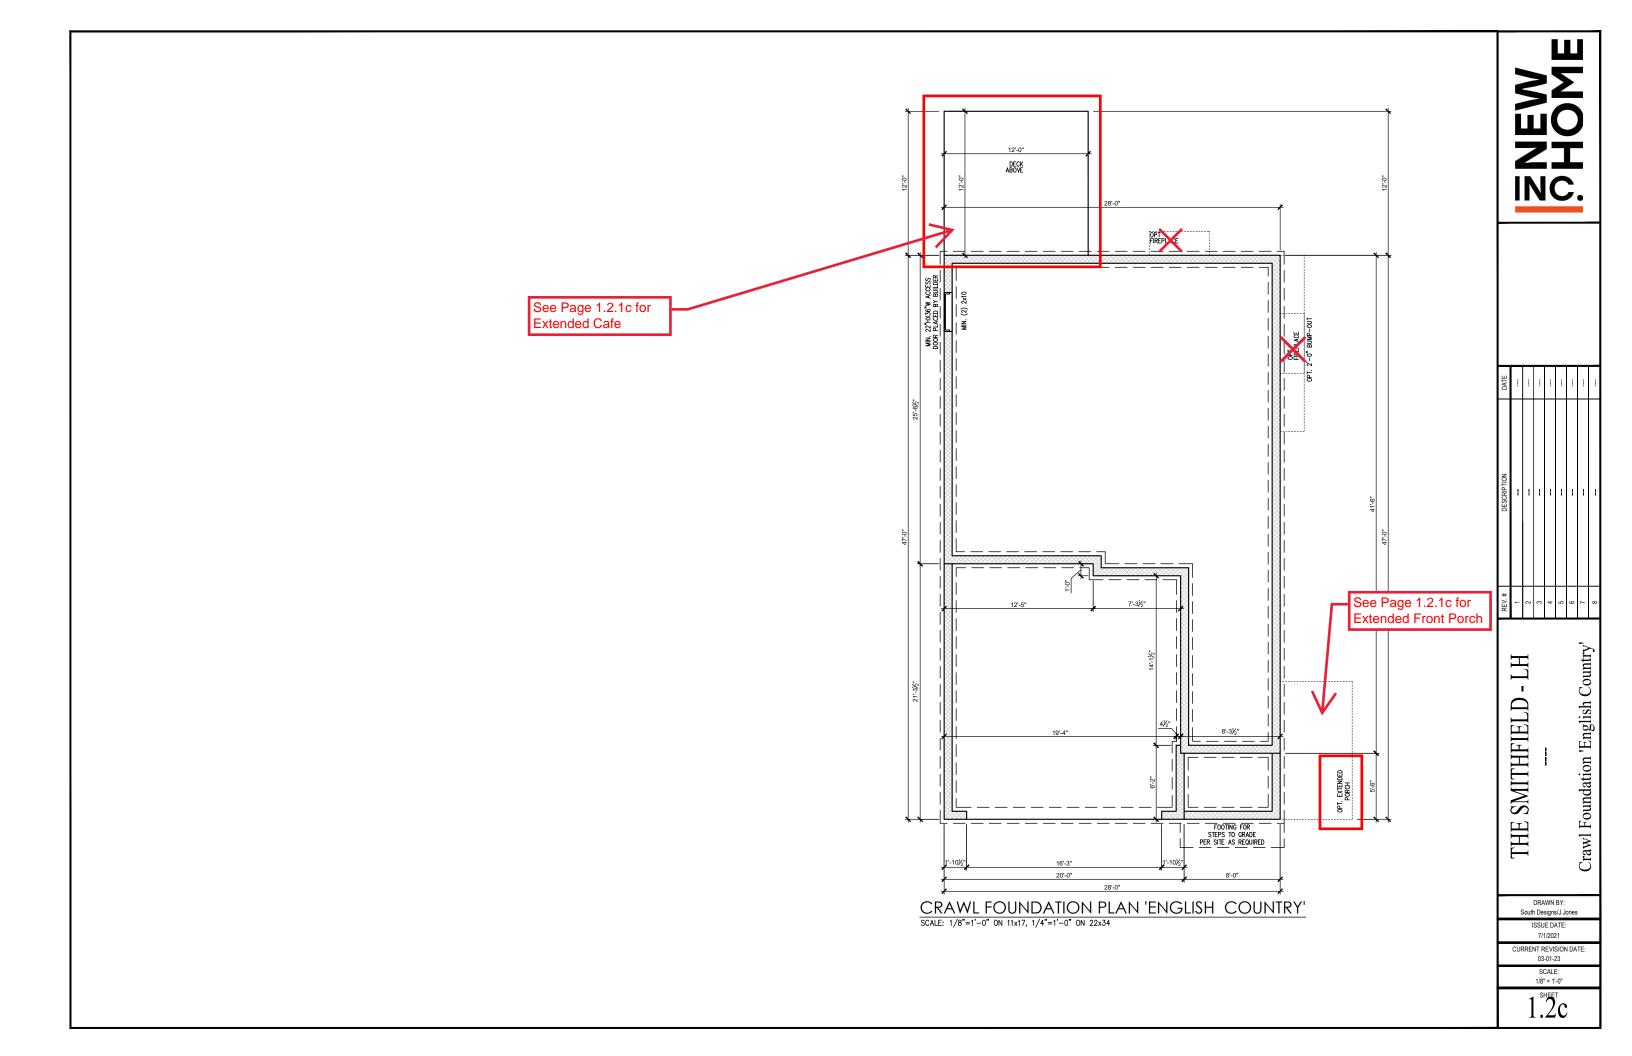

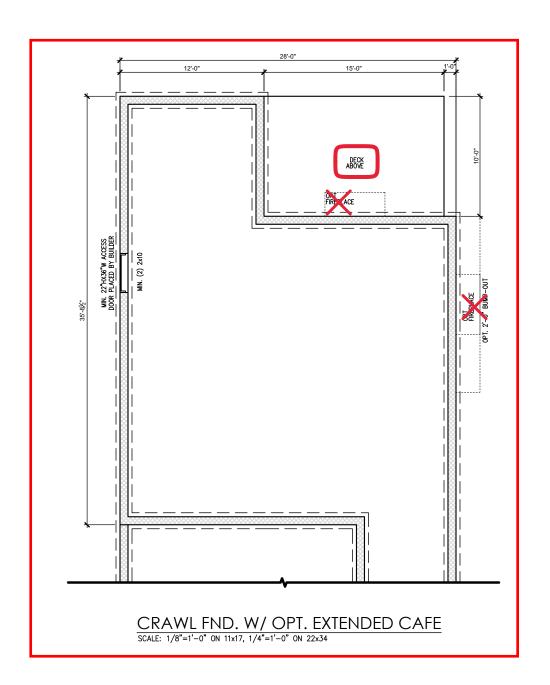



DATE									
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REV. #	1	2	3	4	2	9	7	8	

THE SMITHFIELD - LH
--Crawl Foundation Options 'English Country'

DRAWN BY: South Designs/J.Jones

South Designs/J.Jo ISSUE DATE: 7/1/2021


7/1/2021 CURRENT REVISION DATE: 03-01-23

SCALE: 1/8" = 1'-0"

1.2.1c

General Floor Plan Notes shall apply unless noted otherwise on plan.

- Wall Heights: Typically 9°-1 1/2" at first floor, 8'-1 1/2" at second floor, and 8'-1 1/2" at affics U.N.O. All walls are constructed using a double top plate. Splices at Double Top Plate do not need to accur at Vertical Studs but must be at least 24" apart from Joint in other Top Plate layer. Special wall heights are noted on plans where they occur.
- Wall Thickness is typically 3 1/2". 2x6 frame shall be used at walls that back up to plumbing fixtures.
 Walls greater than 10' high shall be framed with 2x6 framing or greater and will be noted as a special condition where it occurs on plan.
- 3. Typical header height shall be 6'-11" AFF at First Floor, and 6'-11" AFF at Second Floor U.N.O.
- Jacks: Openings up to 3'-4" wide shall have (1) 2x4 jack stud SPF on each side. Openings greater than 3'-4" wide shall have (2) 2x4 jack studs SPF on each side.
- Soffits, Coffered Ceilings, Trey Ceilings and other significant ceiling plan elements are shown on the floor plans and are denoted as single dashed lines. Unless specifically call out as included, Kitchens do not include soffits over wall cabinetry.
- Door & Window Frames, where occurring near corners, shall be a minimum of 4 1/2" from corner. Except for walk-in closets with doors near a corner, doors at closets shall be centered on closet.
- Windows: Shall have at least (1) window in each sleeping room, that meets egress. Shall be provided with tempered glass at hazardous glazing areas. False windows shall be installed with obscure glazing.
- Closets for clothing or coat storage shall be equipped with 1 rod/shelf. Closets for linen shall have 4 open equal shelves. Closets for pantities shall have 4 equal wood shelves, painted.
- Stair treads shall be a min of 9" deep, risers shall be a maximum of 8 1/4", unless noted otherwise, per the current North Carolina Residential Code
- 10. Handrails and Guards at stairs shall be 34" above the finished surface of the ramp surface of the stair. Handrails at landings and overlooks of multilevel spaces shall be 36" above finished floor. Guards (pickets or balusters) shall be spaced with no more than 4" between quards.
- 11. Attic Access shall be provided at all attic area with a height greater than 30". Minimum clear attic access shall be 20" x 30". Pull down stairs and access doors in knee walls meeting minimum criteria are also acceptable.
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- 13. Garage Walls, as a minimum, shall be separated from living space by installing 1/2" gypsum board on the garage side of the wall. With habitable space above, the inside of all garage walls require 1/2" GWB supporting 5/8" type X GWB on ceiling.

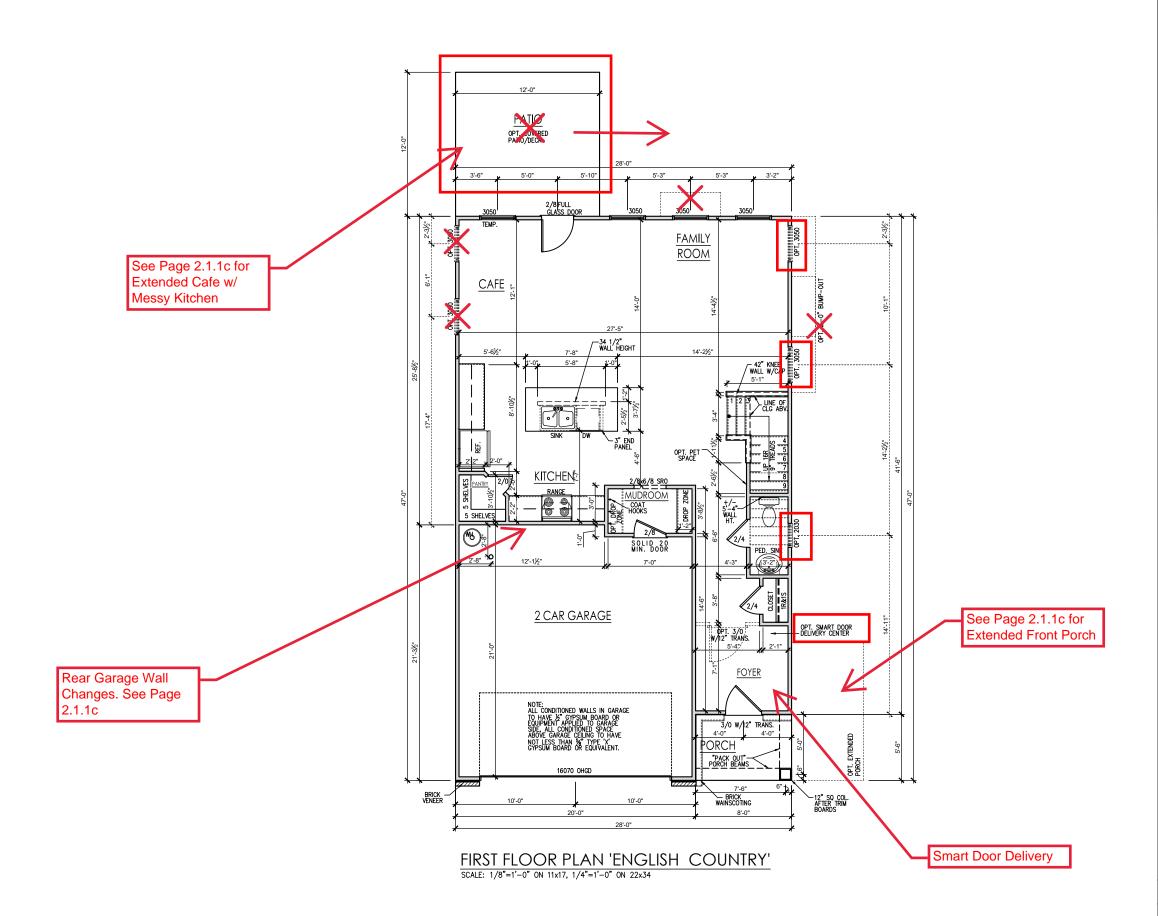

First Floor Plan 'English Country'

- IH

SMITHFIELD

THE

DRAWN BY:


South Designs/J.Jones
ISSUE DATE:
7/1/2021

CURRENT REVISION DATE
03-01-23


SCALE:
1/8" = 1'-0"

General Floor Plan Notes shall apply unless noted otherwise on plan.

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Sink and Window at Messy Kitchen

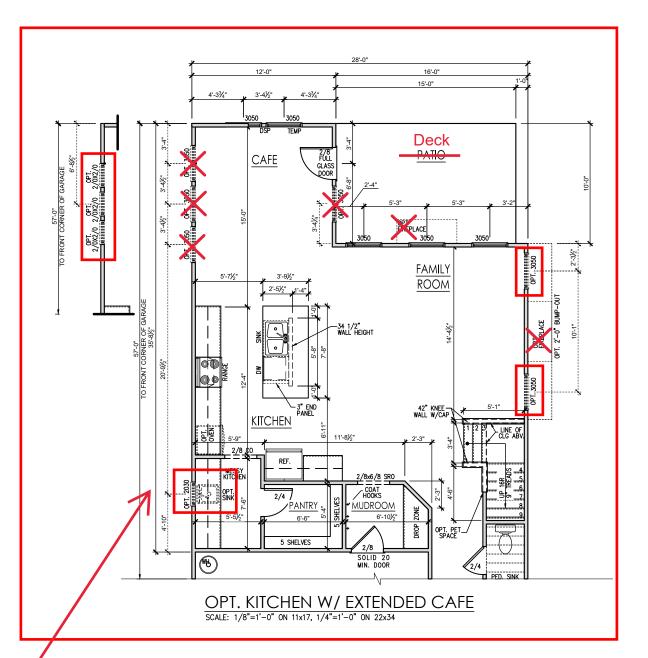

SCALE: 1/8"=1'-0" ON 11x17, 1/4"=1'-0" ON 22x34

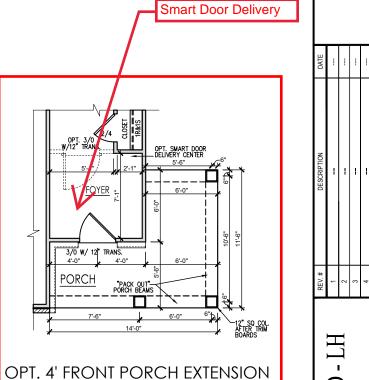Country'

'English

First Floor Options

DRAWN BY: South Designs/J.Jones ISSUE DATE:

SMITHFIELD


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7/1/2021 CURRENT REVISION DATE 03-01-23

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DRAWN BY: South Designs/J.Jones

Country'

Plan 'English

Floor

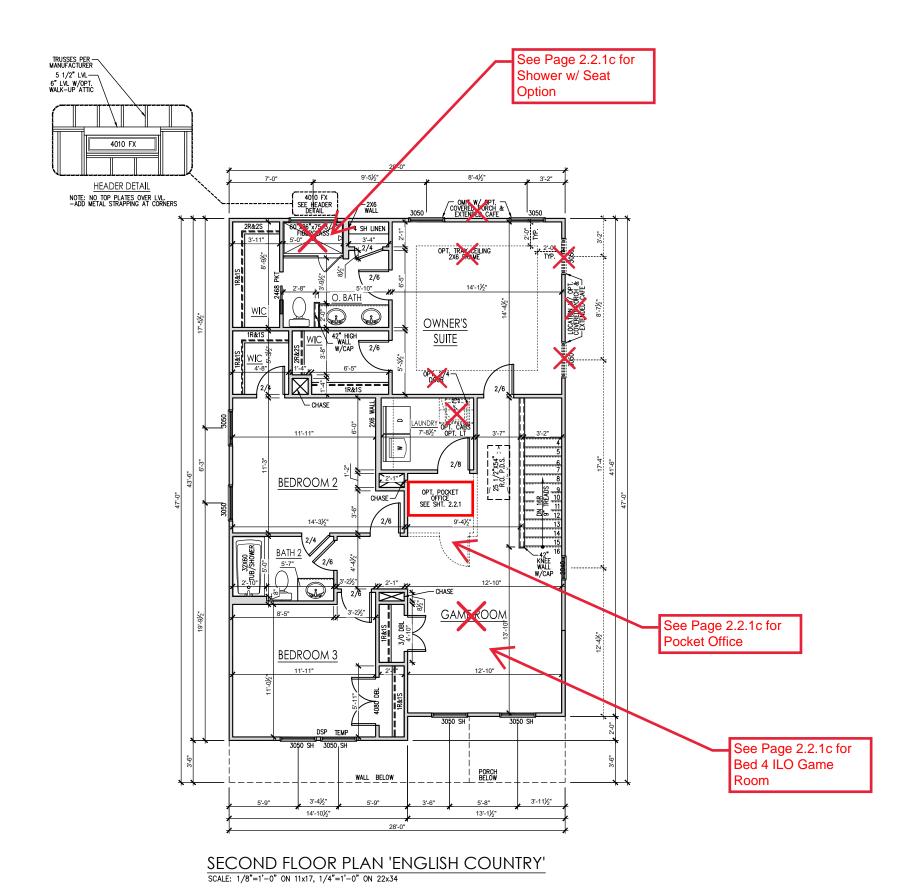Second

- IH

SMITHFIELD

THE


ISSUE DATE: 7/1/2021 CURRENT REVISION DATE 03-01-23


> SCALE: 1/8" = 1'-0"


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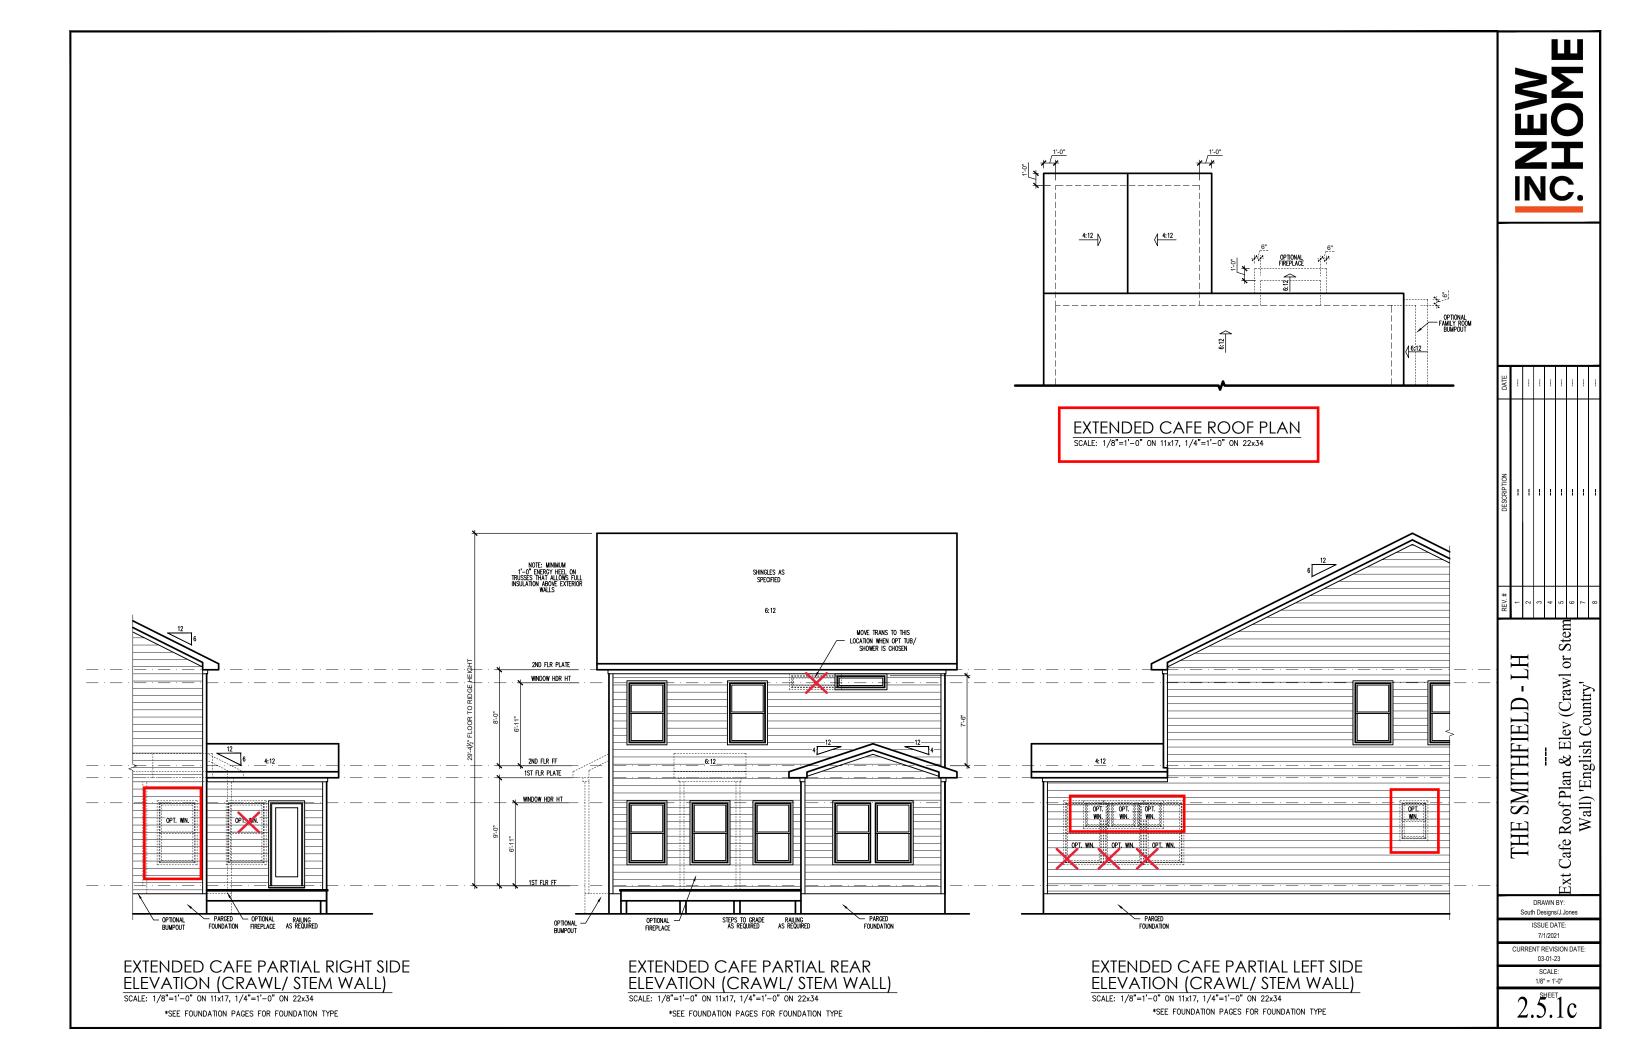
Second Floor Plan Options 'English Country' SMITHFIELD THE

- LH

DRAWN BY: South Designs/J.Jones

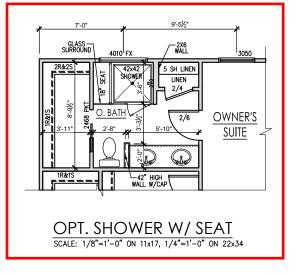ISSUE DATE: 7/1/2021 CURRENT REVISION DATE 03-01-23
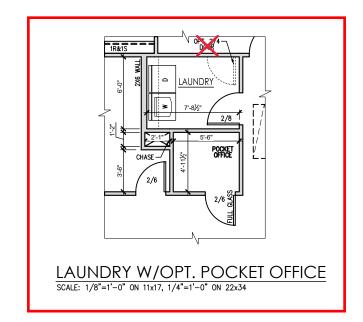
> SCALE: 1/8" = 1'-0"

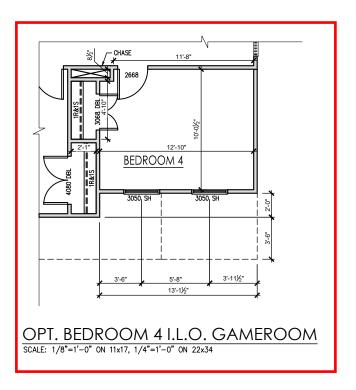

General Elevation Notes

General Elevation Notes shall apply unless noted otherwise on plan.


- Roof shall be finished with architectural composition shingles with slopes as noted on plan.
- Ridge Vent shall be provided and installed on all ridges greater than 6' in length per manufacturer's specifications.
- 3. Soffit Vent shall be continuous soffit vent
- House Wrap, "tyvek" or approved equal shall be installed over entire exterior wall per manufacturer's specifications and recommendations.
- Flashing shall be provided above all door and window openings, above finish wall material changes and at wall surfaces where lower roof areas abut vertical wall surfaces.
- Porch Railings shall be provided at all porch walking surfaces greater than 30" above adjacent finished grade. It shall be 36" high with guards spaced no more than 4" apart. Consult community specifications for material.
- Finish Wall Material shall be as noted on elevation drawings.
- 8. Brick Veneer, if included on elevation shall be tied to wall surface with galvanized corrugated metal ties at a rate of 24" oc horizontally and 16" oc vertically so that no more than 2.67st of brick is supported by (1) tie. Space between face of wall and back face of brick shall be limited to a maximum of 1". Flashing shall be provided behind brick above all wall openings and at base of brick wall. Flashing shall be a minimum of 6-mil poly or other corrosion resistant material and shall be installed so that it laps under the house wrap material a minimum of 2".


 Weepholes shall be provided at a rate of 48" oc and shall not be less than 3/16" in diameter and shall be located immediately above (fashing.
- Brick Veneer Support Lintels shall be provided if brick veneer is included on elevation. Lintels shall be provided as listed in the following schedule and shall have a minimum bearing length of 6". Masonry Lintels shall be provided so that deflection is limited to L/600.

Masonry Opening Lintel Schedule

Opening Size Angle

up to 4'-0"	3-1/2" x 3-1/2" x 5/16
4'-1" to 5'-6"	4" x 3-1/2" x 5/16" LL
5'-7" to 6'-6"	5" x 3-1/2" x 5/16" LL
6'-7" to 8'-4"	6" x 3-1/2" x 5/16" LL
8'-5" to 16'-4"	7" x 4" x 3/8" LLV

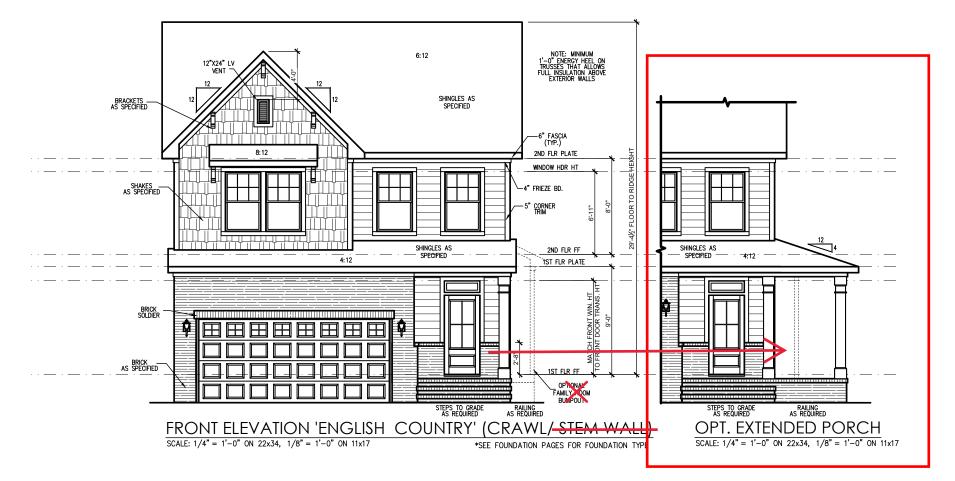

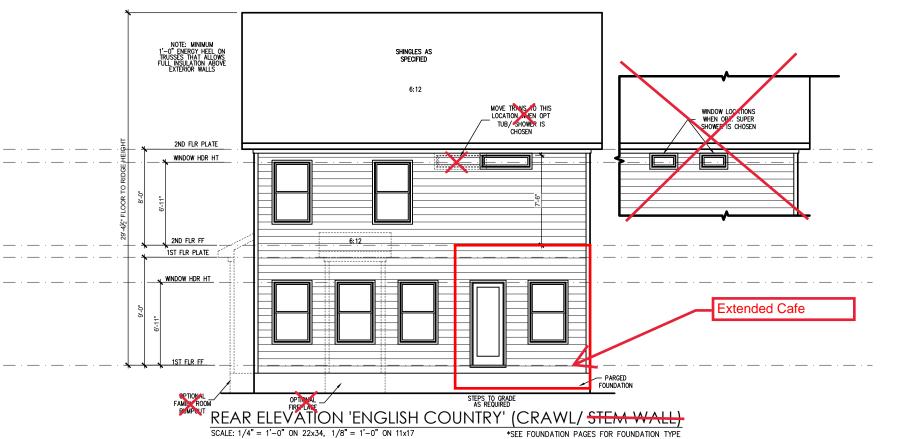



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THE SMITHFIELD - LH

--Front & Rear Elev (Crawl or Stem Wall)
'English Country'

DRAWN BY: South Designs/J.Jones ISSUE DATE: 7/1/2021

CURRENT REVISION DATE 03-01-23 SCALE: 1/8" = 1'-0"


3.1.1c

General Elevation Notes General Elevation Notes shall apply unless noted otherwise on plan. Roof shall be finished with architectural composition shingles with slopes as noted on plan. Ridge Vent shall be provided and installed on all ridges greater than 6' in length per manufacturer's specifications. SHINGLES AS SPECIFIED 3. Soffit Vent shall be continuous soffit vent House Wrap, "tyvek" or approved equal shall be installed over entire exterior wall per manufacturer's specifications and recommendations. 12:12 Flashing shall be provided above all door and Porch Railings shall be provided at all porch walking surfaces greater than 30" above adjacent finished 2ND FLR PLATE grade. It shall be 36" high with guards spaced no more than 4" apart. Consult community specifications for material. WINDOW HDR HT Finish Wall Material shall be as noted on elevation Brick Veneer, if included on elevation shall be tied to wall surface with galvanized corrugated metal ties at a rate of 24" oc horizontally and 16" oc vertically so a rate of 24" oc horizontally and 16" oc vertically so that no more than 2.67st of brick is supported by (1) the. Space between face of wall and back face of brick shall be limited to a maximum of 1". Flashing shall be provided behind brick above all wall openings and at base of brick wall. Flashing shall be a minimum of 6-mil poly or other corrosion resistant material and shall be installed so that it laps under the house wrap material a minimum of 2". Weepholes shall be provided at a rate of 48" oc and shall no be less than 3716" in diameter and shall be located immediately above flashing. 2ND FLR FF <u>6</u>:12 1ST FIR PLATE WINDOW HDR HT Brick Veneer Support Lintels shall be provided if brick veneer is included on elevation. Lintels shall be provided as listed in the following schedule and shall have a minimum bearing length of 6". Masonry Lintels shall be provided so that deflection is limited to L/600. Opening Size OFFICIAL OFF RAILING AS REQUIRED up to 4'-0" 4'-1" to 5'-6" 5'-7" to 6'-6" 6'-7" to 8'-4" 8'-5" to 16'-4" 3-1/2" x 3-1/2" x 5/16" OPT. EXTENDED PORCH SCALE: 1/4" = 1'-0" ON 22x34, 1/8" = 1'-0" ON 11 17 SCALE: 1/4" = 1'-0" ON 22x34, 1/8" = 1'-0" ON 11x17 *SEE FOUNDATION PAGES FOR FOUNDATION TYPE SHINGLES AS 12:12 Side Elevations (Crawl or Stem Wall) 'English Country' 2ND FLR PLATE SMITHFIELD Extended Cafe w/ 1ST FLR PLATE Messy Kitchen and THE Window WINDOW HDR HT DRAWN BY: South Designs/J.Jones ISSUE DATE: 7/1/2021 CURRENT REVISION DATE PARGED — FOUNDATION 03-01-23 LEFT SIDE ELEVATION 'ENGLISH COUNTRY' (CRAWL/ STEM WALL) SCALE:


SCALE: 1/4" = 1'-0" ON 22x34, 1/8" = 1'-0" ON 11x17

*SEE FOUNDATION PAGES FOR FOUNDATION TYPE

1/8" = 1'-0"

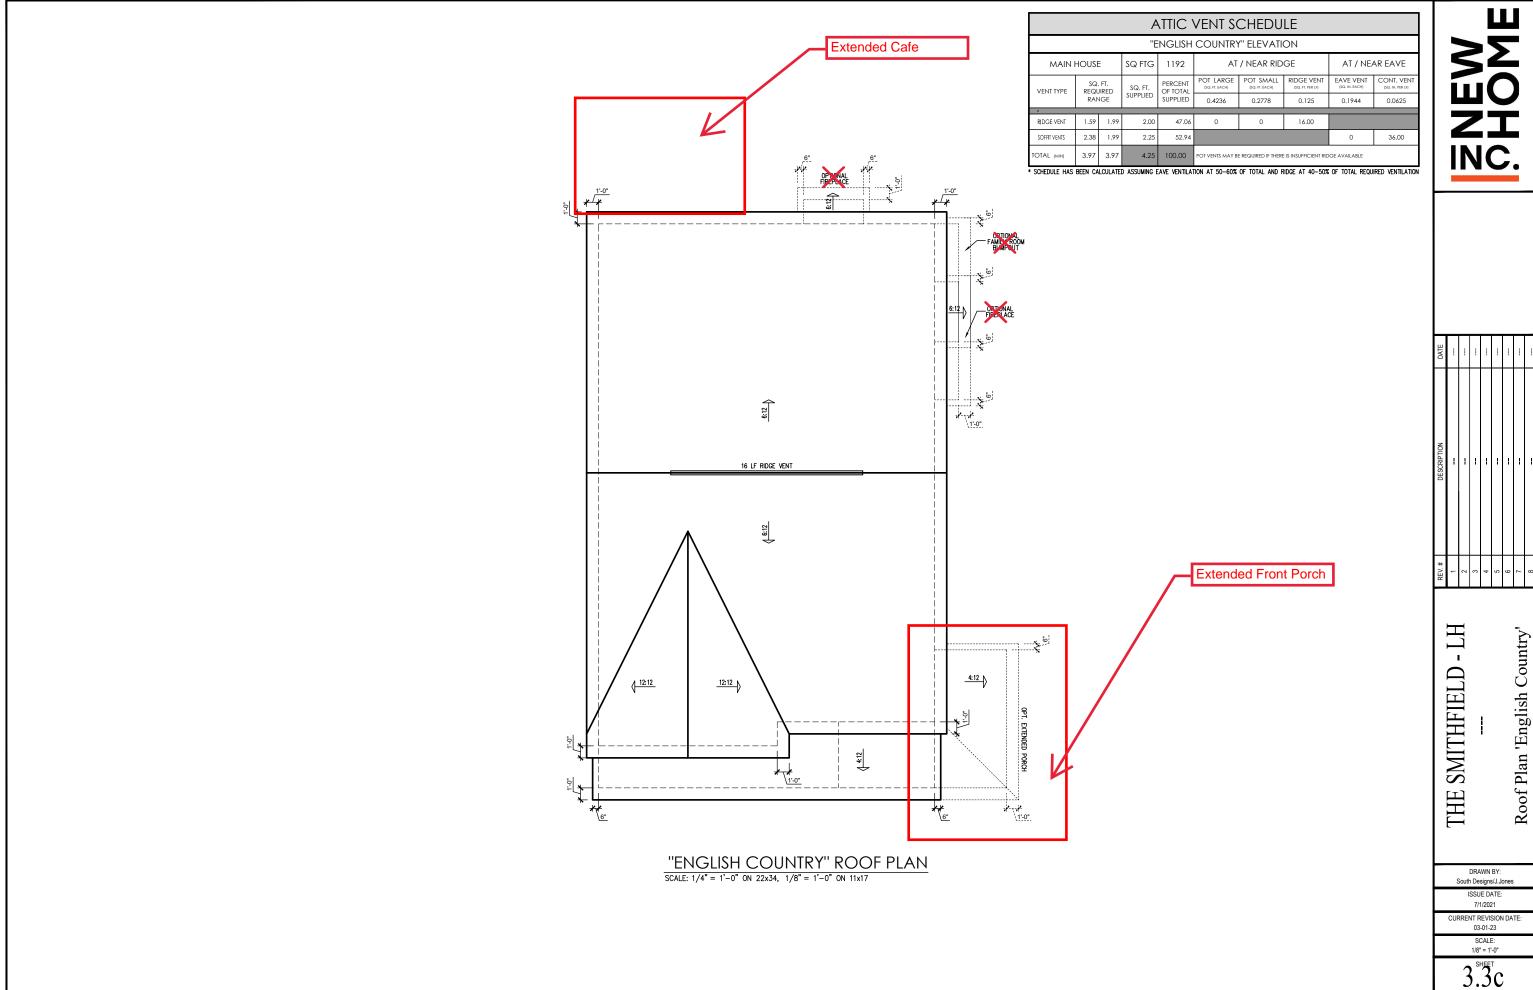


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	RISER HEIGHTS PER STAIR CONFIGURATION												
	PLATE HEIGHT	10" FLOOR SYSTEM	14" FLOOR SYSTEM	16" FLOOR SYSTEM									
1	01.1.1/01	14 RISERS @ 7 11/16"	15 RISERS @ 7 1/2"	15 RISERS @ 7 5/8"									
	8'-1 1/2"	14 KISERS @ / 11/16	15 KISERS @ 7 1/2	15 KISEKS @ 7 5/8									
	9'-1 1/2"	16 RISERS @ 7 1/2"	16 RISERS @ 7 3/4"	17 RISERS @ 7 7/16"									
	10'-1 1/2"	17 RISERS @ 7 3/4"	18 RISERS @ 7 9/16"	18 RISERS @ 7 11/16"									

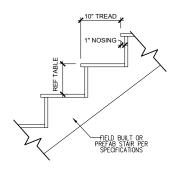TYPICAL STAIR DETAIL


SCALE: 1" = 1'-0" ON 22x34, 1/2" = 1'-0" ON 11x17



IMPORTANT REMINDER: THE LOWEST PITCH ROOF ALWAYS MANDATES THE CONDITION. FOR EXAMPLE, A ROOF WITH A 4:12 PITCH AND A 6:12 PITCH WOULD FOLW THE 7 "ABOVE PLATE HEIGHT RULE. THE HEEL FOR THE 6:12 ROOF IN THIS CONDITION WILL DIFFER FROM WHAT IS LISTED HERE.

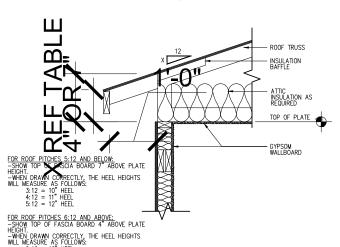
ENERGY HEEL DETAIL: CZ 2 & 3


SCALE: 1'' = 1'-0'' ON 22x34, 1/2'' = 1'-0'' ON 11x17

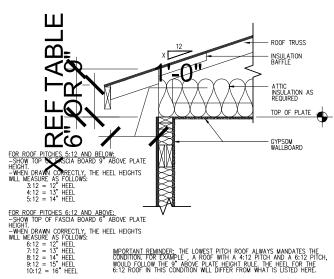

IMPORTANT REMINDER: THE LOWEST PITCH ROOF ALWAYS MANDATES THE CONDITION. FOR EXAMPLE, A ROOF WITH A 4:12 PITCH AND A 6:12 PITCH WOULD FOLLOW THE 9" ABOVE PLATE HEIGHT RULE. THE HEEL FOR THE 6:12 ROOF IN THIS CONDITION WILL DIFFER FROM WHAT IS LISTED HERE.

ENERGY HEEL DETAIL: CZ 4 & 5 SCALE: 1'' = 1'-0'' ON 22x34, 1/2'' = 1'-0'' ON 11x17

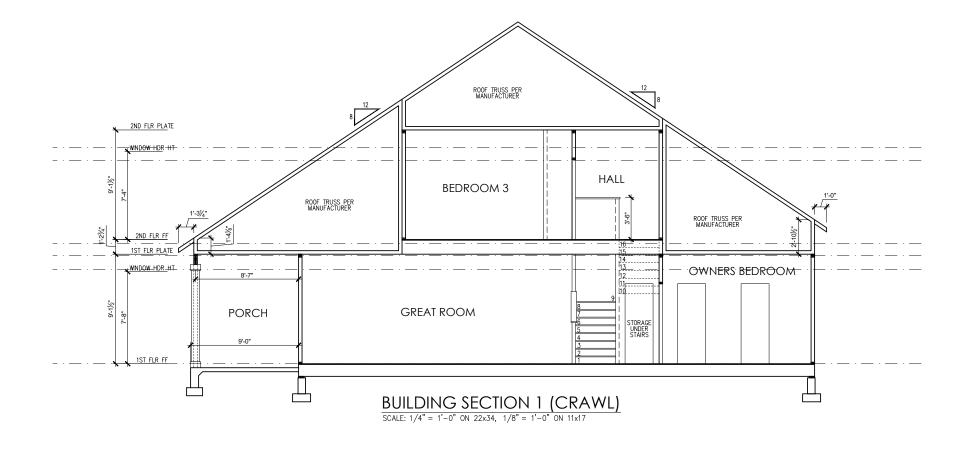

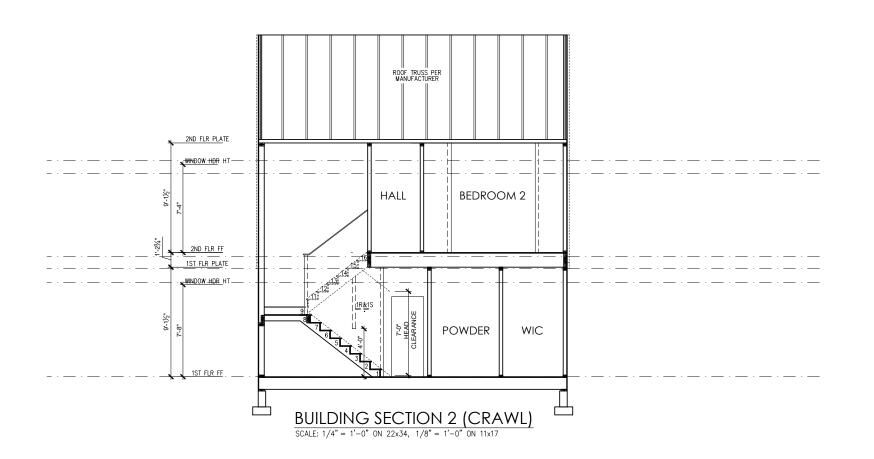



HT Building Sections 'English Country'_Crawl THE SMITHFIELD

> DRAWN BY: South Designs/J.Jones ISSUE DATE: 7/1/2021

CURRENT REVISION DATE: 03-01-23 SCALE: 1/8" = 1'-0"

 $4.0^{\text{\tiny MEET}}\!1c$

TRUSS SYSTEM REQUIREMENTS NC (2016 NCRC): Wlind: 115-120 mph

- TRUSS SYSTEM LAYOUTS (PLACEMENT PLANS) SHALL BE DESIGNED IN ACCORDANCE WITH SEALED STRUCTURAL PLANS, ANY NEED TO CHANGE TRUSSES SHALL BE COORDINATED WITH SOUTHERN ENGINEERS.
- TRUSS SCHEMATICS (PROFILES) SHALL BE PREPARED
 AND SEALED BY TRUSS MANUFACTURER.
- 3. ALL TRUSSES SHALL BE DESIGNED FOR BEARING ON SPF #2 OR #3 PLATES OR LEDGERS (UNO).
- ALL REQUIRED ANCHORS FOR TRUSSES DUE TO UPLIFT OR BEARING SHALL MEET THE REQUIREMENTS AS SPECIFIED ON THE TRUSS SCHEMATICS.

FOUNDATION STRUCTURAL NOTES NG (2018 NGRC): Wind: 115-120 mph - CRAWL

- I. (3)2xIO SYP#2, SPF#2, OR HEM-FIR#2 GIRDER (TYPICAL, U.N.O.)
- 2. CONCRETE BLOCK PIER SIZE SHALL BE:
- •• SIZE HOLLOW SOLID
 •• 8xl6 UP TO 32" UP TO 5'-0"
 •• 12xl6 UP TO 48" UP TO 9'-0"
 •• 16xl6 UP TO 64" UP TO 12'-0"
- •• 24x24 UP TO 96" • WITH 30" x 30" x IO" CONCRETE FOOTING, UNO.
- 3. WALL FOOTING AS FOLLOWS

DEPTH: 8" - UP TO 2 STORY IO" - 3 STORY


•• <u>MIDTH:</u>
•• SIDING:


16" - UP TO 2 STORY 20" - 3 STORY

BRICK: 16" - I STORY


20" - 2 STORY 24" - 3 STORY

- FOR FOUNDATION WALL HEIGHT AND BACKFILL
 REQUIREMENTS, REFER TO CODE TABLE R404.I.I (I
 THRU 4) NOTE: ASSIMED SOIL BEARING CAPACITY =
 2000 PSF. CONTRACTOR MUST VERIFY SITE
 CONDITIONS AND CONTACT SOILS ENGINEER IF
 MARGINAL OR UNSTABLE SOILS ARE ENCOUNTERED.
- 4. (4) 2xIO SPF #2 OR SYP #2 GIRDER
- 5. (2) 1.75x4.25 LVL OR LSL GIRDER
- 6. (3) 1.75x9.25 LVL OR LSL GIRDER
- " " DESIGNATES A SIGNIFICANT POINT LOAD TO HAVE SOLID BLOCKING TO PIER. SOLID BLOCK ALL BEAM BEARING POINTS NOTED TO HAVE THREE OR MORE STUDS TO FIND, TYPICAL.
- B. ABBREVIATIONS:
- "SJ" = SINGLE JOIST
- "DJ" = DOUBLE JOIST
 "TJ" = TRIPLE JOIST
- ADJUST SUBFLOOR THICKNESS OR JOIST SPACING AS REQ'D FOR FLOOR FINISH MATERIALS.

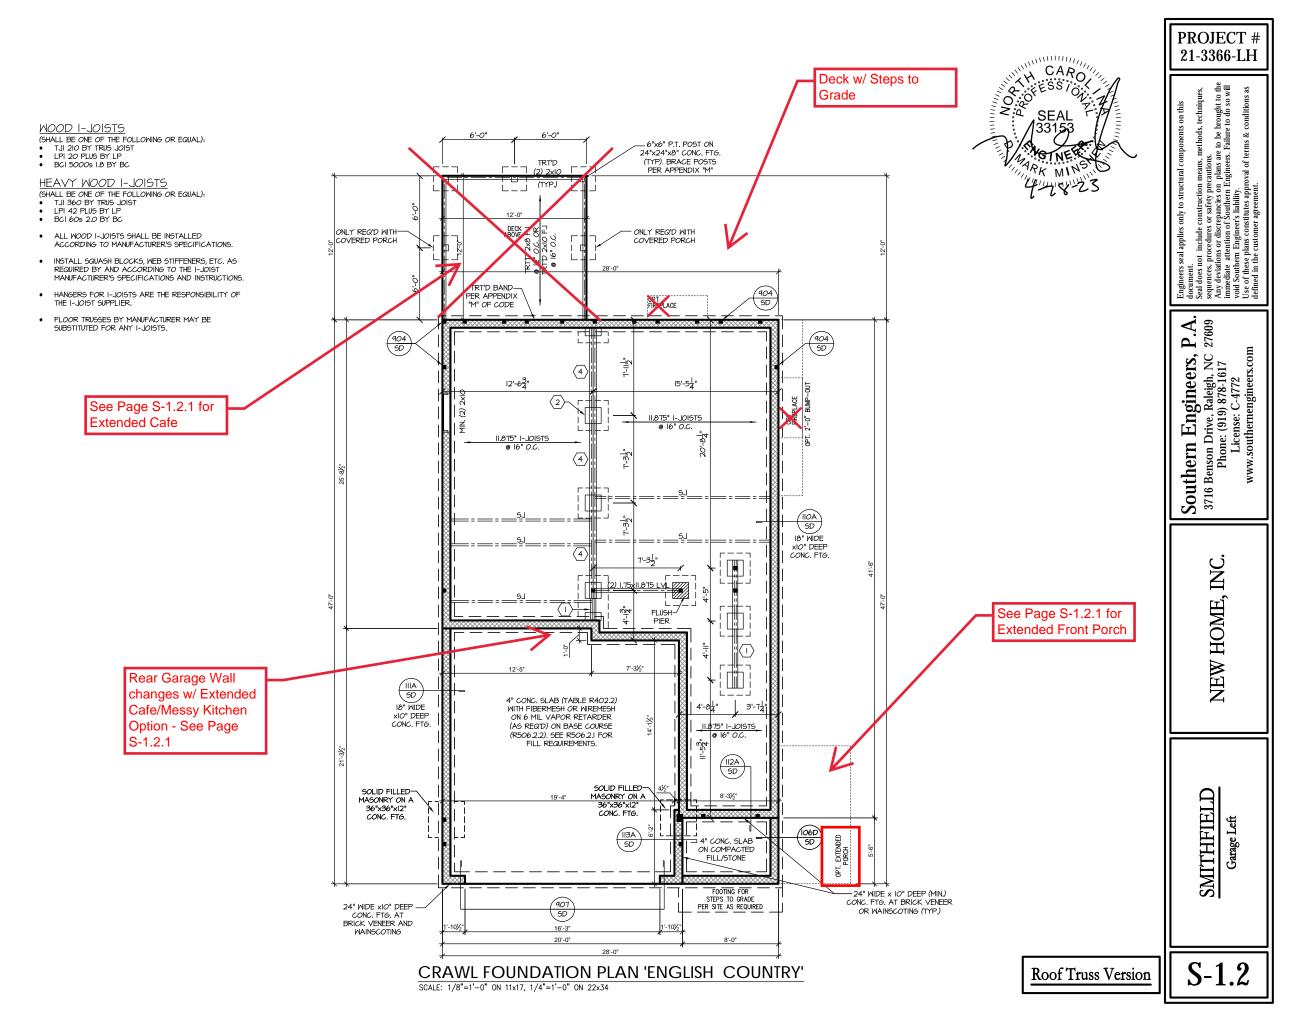

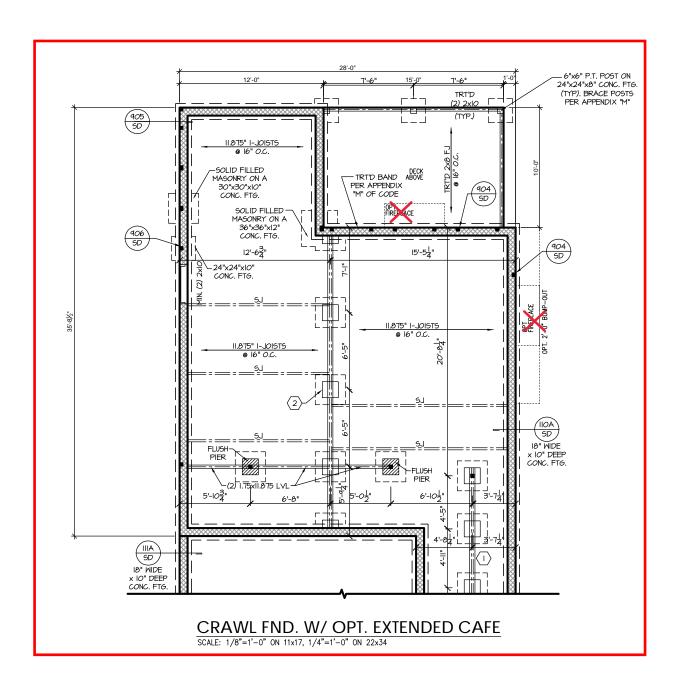



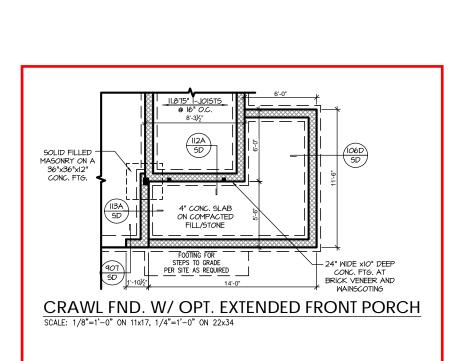

Southern Engineers, P.A.

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License: C-4772
www.southernengineers.com

Engineers seal applies only to structur document.
Seal docs not include construction m sequences, procedures or safety preacting the construction of souther Engineers I shalling.
Use of these plans constitutes approvaled the customer agreement.

PROJECT # 21-3366-LH

NEW HOME, INC.

SMITHFIELD

S-1.2.

Roof Truss Version

TRUSS SYSTEM REQUIREMENTS NC (2018 NCRC): Wind: 115-120 mph

- TRUSS SYSTEM LAYOUTS (PLACEMENT PLANS) SHALL BE DESIGNED IN ACCORDANCE WITH SEALED STRUCTURAL PLANS. ANY NEED TO CHANGE TRUSSES SHALL BE COORDINATED WITH SOUTHERN ENGINEERS
- TRUSS SCHEMATICS (PROFILES) SHALL BE PREPARED AND SEALED BY TRUSS MANUFACTURER.
- ALL TRUSSES SHALL BE DESIGNED FOR BEARING ON SPF #2 OR #3 PLATES OR LEDGERS (UNO).
- ALL REQUIRED ANCHORS FOR TRUSSES DUE TO UPLIET OR BEARING SHALL MEET THE REQUIREMENTS AS SPECIFIED ON THE TRUSS SCHEMATICS.

HEADER/BEAM & COLUMN NOTES

- ALL EXTERIOR AND LOAD BEARING HEADERS SHALL BE MIN. (2)2x6 (4" WALL) OR (3)2x6 (6" WALL) WITH (1) SUPPORT STUD, UNLESS NOTED OTHERWISE.
- THE NUMBER SHOWN AT BEAM AND HEADER SUPPORTS INDICATES THE NUMBER OF SUPPORT STUDS REQUIRED IN STUD POCKET OR COLUMN. THE NUMBER OF KING STUDS AT EACH END OF HEADERS IN EXTERIOR WALLS SHALL BE ACCORDING TO ITEM "d" IN TABLE R602.3(5) OR AS BELOW PER NCDOI COMMENTARY "KING STUDS AT WALL OPENINGS" REVISED 1-9-2020:
- UP TO 3' SPAN: (I) KING STUD
- OVER 3' UP TO 6' SPAN: (2) KING STUDS OVER 6' UP TO 9' SPAN: (3) KING STUDS
- OVER 9' UP TO 12' SPAN: (4) KING STUDS
- OVER 12' UP TO 15' SPAN: (5) KING STUDS

FRAMING NOTES

NC (2018 NCRC): Wind: 115-120 mph

- BRACING METHOD AND TYPE: CONTINUOUSLY SHEATHED WSP: CS-WSP, NOTE THAT THE WALL BRACING AMOUNT PROVIDED ON THE PLANS (DETAILS AND SPECIFICATIONS) IS GREATER THAN THE AMOUNT OF WALL BRACING REQUIRED BY SECTION R602.10 OF THE CODE. SEE NOTES BELOW FOR DETAILS AND SPECIFICATIONS FOR WALL BRACING AND WALL FRAMING.
- EXTERIOR WALL SHEATHING: WALLS SHALL BE BRACED BY SHEATHING WALLS ON ALL STORIES WITH WOOD STRUCTURAL PANEL SHEATHING (WSP) (EXPOSURE B: 1/16". EXPOSURE C: 15/32"). SHEATHING SHALL BE ATTACHED WITH 8d NAILS AT A 6"/12" NAILING PATTERN (6" OC AT PANEL EDGES AND 12" OC AT INTERMEDIATE SUPPORTS). INSTALL BLOCKING AT ALL PANEL
- WSP SHEATHING SHALL EXTEND TO THE UPPERMOST DOUBLE BEARING PLATE. BLOCK AT ROOF PER SECTION R602.10.4.5 AND ATTACH BRACED WALLS PER CODE. WSP SHEATHING BETWEEN FLOORS SHALL BE SPLICED ALONG CONTINUOUS BAND OR THE WSP SHEATHING MAY BE SPLICED ACROSS STUDS (CONTINUOUS ACROSS FLOOR SYSTEM) WITH BLOCKING AT PANEL EDGES. (MINIMUM 12" BEYOND FLOOR BREAK) OR OTHER APPROVED
- 4. "HD" = HOLDOWN: HOLD-DOWN DEVICE (NOTED AS "HD" ON PLANS)
 SHALL BE AN 800 POUND CAPACITY ASSEMBLY AS NOTED ON
 PLANS. SEE DETAILS FOR HD ASSEMBLY.
- **GROUND/FIRST FLOOR: USE "HD HOLD-DOWN DETAIL" ON SD SHEET (OR EQUIV.)
- STEEL (OR EXONY).

 **UPPER ELOORS: ATTACH BASE OF KING STUD WITH A SIMPSON C522 STRAP DOWN ACROSS THE BAND AND DOWN TO A STUD BELOW OR HEADER BELOW. EXTEND STRAP 7" MIN ALONG EACH STUD (OR HEADER) AND ATTACH EACH END W (7) 8d NAILS.
- 5. INTERIOR BRACED WALL: (NOTED AS "IBW" ON PLANS) ATTACH I/2" GYPSUM BOARD (GB) ON EACH SIDE OF WALL WITH A MIN. OF 5d. COOLER NAILS OR #6 SCREMS @ 7" O.C. ALONG THE EDGES AND AT INTERMEDIATE SUPPORTS.
- 6. INTERIOR BRACED WALL-WOOD STRUCTURAL PANEL: (NOTED AS "I<u>BW-MSP</u>" ON PLANS), ATTACH ONE SIDE WITH 7/6" MSP SHEATHING WITH 8'd NAILS AT A 6"/12" NAILING PATTERN (6" OC AT PANEL EDGES AND 12" OC AT INTERMEDIATE SUPPORTS). INSTALL BLOCKING AT ALL PANEL EDGES. ATTACH GB OVER WSP AS REQUIRED. ATTACH OPPOSITE SIDE WITH 1/2" GB WITH A MIN. OF 5d COOLER NAILS OR #6 SCREWS @ 7" OC ALONG THE EDGES AND AT INTERMEDIATE SUPPORTS.

MOOD I-JOISTS

- (SHALL BE ONE OF THE FOLLOWING OR EQUAL):
- TJI 210 BY TRUS JOIST LPI 20 PLUS BY LP
- BCI 5000s I.8 BY BC


HEAVY WOOD I-JOISTS

- (SHALL BE ONE OF THE FOLLOWING OR EQUAL):


 TJI 360 BY TRUS JOIST
- I PL 42 PLUS BY LE
- BCI 60s 2.0 BY BC
- ALL WOOD I-JOISTS SHALL BE INSTALLED ACCORDING TO MANUFACTURER'S SPECIFICATIONS.
- INSTALL SQUASH BLOCKS, WEB STIFFENERS, ETC. AS REQUIRED BY AND ACCORDING TO THE 1-JOIST MANUFACTURER'S SPECIFICATIONS AND INSTRUCTIONS
- HANGERS FOR I-JOISTS ARE THE RESPONSIBILITY OF
- FLOOR TRUSSES BY MANUFACTURER MAY BE SUBSTITUTED FOR ANY I-JOISTS.

PORCH POST NOTES:

- 4"x4" (6"x6") TRT'D POST (OR EQUAL).
- ATTACH TRUSSES (RAFTERS) AT PORCH WITH HURRICANE
- POST CAP: SIMPSON AC4-MAX (AC6-MAX)
 POST CAP AT CORNER: (2) SIMPSON LCE4 (MITER HEADER
- AT CORNER). HIGH WIND; ADD (I) SIMPSON H6. POST BASE: SIMPSON ABU44 (ABU66).
- MONO: %" ANCHOR (EMBED 7")
- CMU: 5%" ANCHOR (EXTEND TO FOOTING HIGH WIND ONLY)
- 4. <u>POST BASE:</u> WOOD FOUNDATION: (2) SIMPSON CSI6 STRAPS AT POSTS. EXTEND I2" ONTO EACH POST (UPPER AND LOWER) OR TO GIRDER.
- NOTE: EQUIVALENT POST CAP AND BASE ACCEPTABLE.

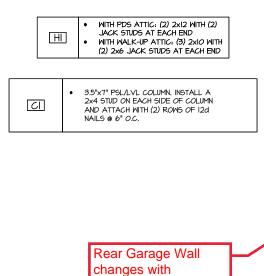

Extended Cafe Option

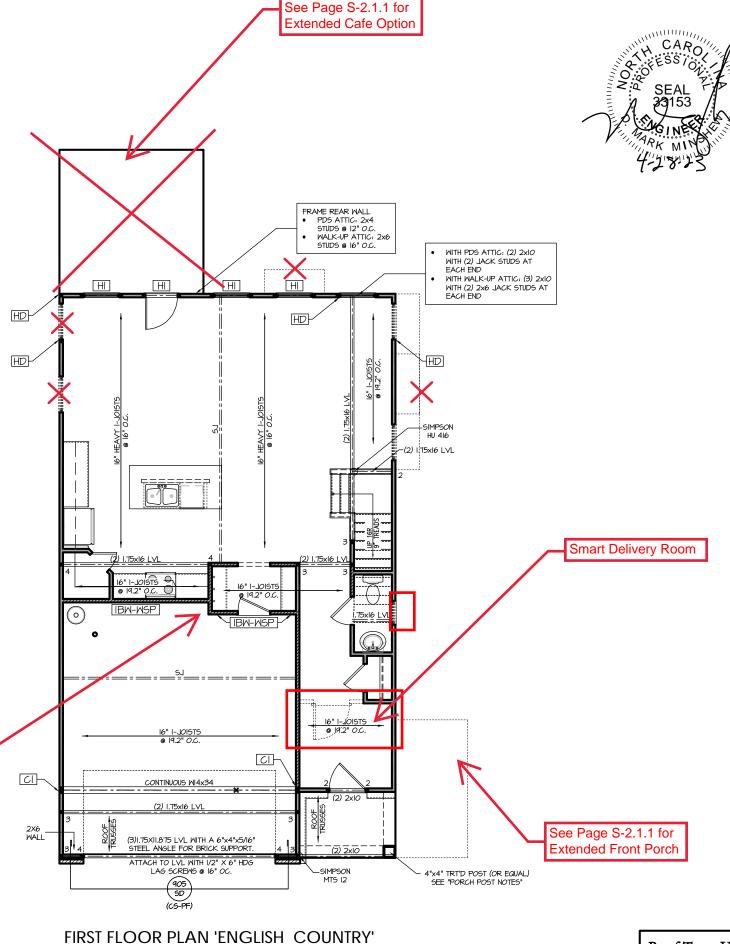

SCALE: 1/8"=1'-0" ON 11x17, 1/4"=1'-0" ON 22x34

PROJECT # 21-3366-LH

brought e to do s to be l Failure

P.A. 27609

Engineers, Drive, Raleigh, NC Drive, R. ne: (919) Southern E
3716 Benson Dri
Phone: (

Adding (3) 2/0x2/0 Windows at Extended Cafe

Adding Sink and Window at Messy

Kitchen

905 5D (CS-PF) Deck ⊢(4) 2×4 STVD POCKET -HD (5) 2x6-(3) 2x10 (3) 1.75x16 LVL 906 SD 2x6 STVDS ~ @ 16" O.C. -CUT TOP PLATE AND SET BEAM DIRECTLY ON (5)
STUDS DOWN TO HEADER. -SIMPSON HU 416 (2) 1,75x16 LVL (2) 2x10-IBW-WSP IBM-WSP \odot OPT. KITCHEN W/ EXTENDED CAFE
SCALE: 1/8"=1'-0" ON 11x17, 1/4"=1'-0" ON 22x34


HI

WITH PDS ATTIC: (2) 2x12 WITH (2)
JACK STUDS AT EACH END
WITH WALK-UP ATTIC: (3) 2x10 WITH
(2) 2x6 JACK STUDS AT EACH END

CI

3.5"x1" PSL/LVL COLUMN. INSTALL A 2x4 STUD ON EACH SIDE OF COLUMN AND ATTACH WITH (2) ROWS OF I2d NAILS @ 6" O.C.



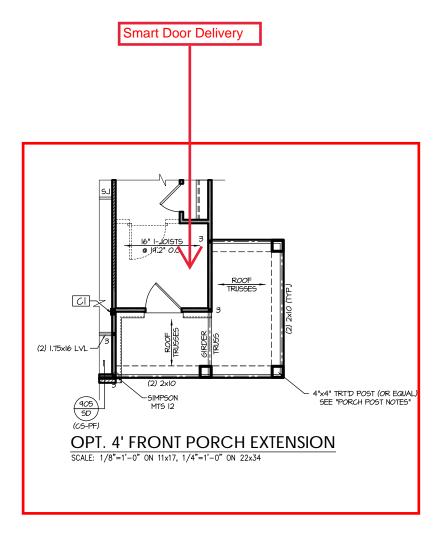

21-3366-LH

PROJECT #

Southern Engineers, P.A. 3716 Benson Drive, Raleigh, NC 27609 Phone: (919) 878-1617 License: C-4772 www.southernengineers.com

NEW HOME, INC.

SMITHFIELD

Roof Truss Version

TRUSS SYSTEM REQUIREMENTS

NC (2018 NCRC): Wind: 115-120 mph

- TRUSS SYSTEM LAYOUTS (PLACEMENT PLANS) SHALL BE DESIGNED IN ACCORDANCE WITH SEALED STRUCTURAL PLANS. ANY NEED TO CHANGE TRUSSES SHALL BE COORDINATED WITH SOUTHERN ENGINEERS
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- OVER 9' UP TO 12' SPAN: (4) KING STUDS OVER 12' UP TO 15' SPAN: (5) KING STUDS


FRAMING NOTES

NC (2018 NCRC): Wind: 115-120 mph

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- WSP SHEATHING SHALL EXTEND TO THE UPPERMOST DOUBLE BEARING PLATE. BLOCK AT ROOF PER SECTION R602.10.4.5 AND ATTACH BRACED WALLS PER CODE. WSP SHEATHING BETWEEN FLOORS SHALL BE SPLICED ALONG CONTINUOUS BAND OR THE WSP SHEATHING MAY BE SPLICED ACROSS STUDS (CONTINUOUS ACROSS FLOOR SYSTEM) WITH BLOCKING AT PANEL EDGES. (MINIMUM 12" BEYOND FLOOR BREAK) OR OTHER APPROVED
- 4. "HD" = HOLDOWN: HOLD-DOWN DEVICE (NOTED AS "HD" ON PLANS) SHALL BE AN 800 POUND CAPACITY ASSEMBLY AS NOTED ON PLANS. SEE DETAILS FOR HD ASSEMBLY.
- **GROUND/FIRST FLOOR: USE "HD HOLD-DOWN DETAIL" ON SD SHEET (OR EQUIV.)
- SHEET (CK EXXIV).

 **UPPER FLOORS: ATTACH BASE OF KING STUD WITH A SIMPSON C522 STRAP DOWN ACROSS THE BAND AND DOWN TO A STUD BELOW OR HEADER BELOW. EXTEND STRAP 1" MIN ALONG EACH STUD (OR HEADER) AND ATTACH EACH END W (7) 8d NAILS.
- 5. INTERIOR BRACED WALL: (NOTED AS "IBM" ON PLANS) ATTACH I/2" GYPSUM BOARD (GB) ON EACH SIDE OF WALL WITH A MIN. OF 5d COOLER NAILS OR #6 SCREWS @ 7" O.C. ALONG THE EDGES AND AT INTERMEDIATE SUPPORTS.
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WITH PDS ATTIC: (5) 2x4 COLUMN WITH WALK-UP ATTIC: (6) 2x4 COLUMN CI

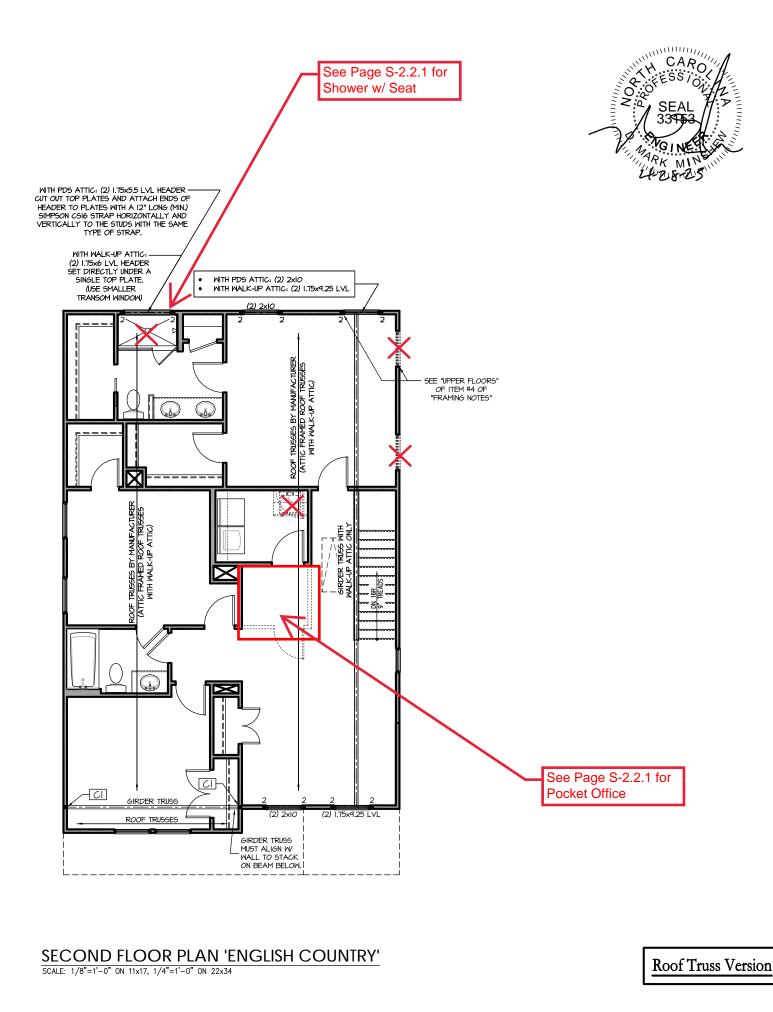

PROJECT # 21-3366-LH

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P.A. 27609


Southern Engineers, F 3716 Benson Drive, Raleigh, NC 2' Phone: (919) 878-1617


HOME,

NEW

SMITHFIELD

S-2.2

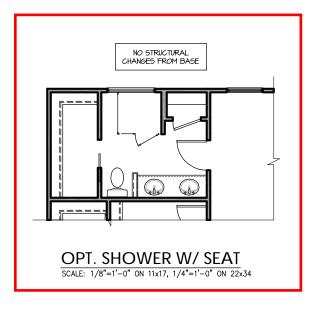

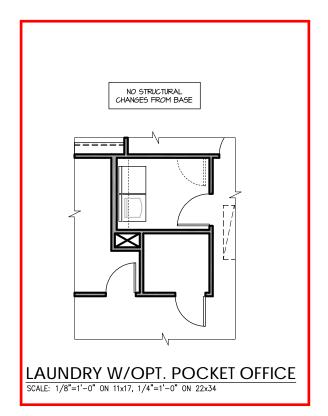

NO STRUCTURAL CHANGES FROM BASE

OPT. BEDROOM 4 I.L.O. GAMEROOM

SCALE: 1/8"=1'-0" ON 11x17, 1/4"=1'-0" ON 22x34



E, INC.

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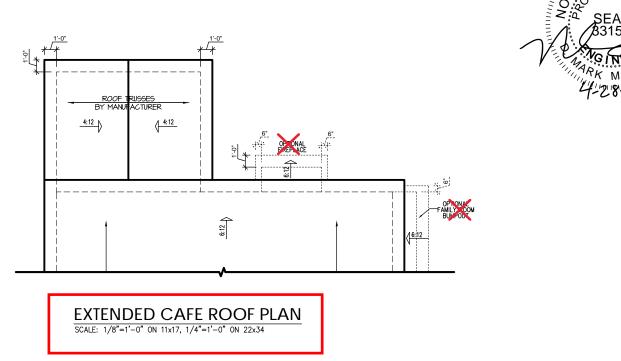
PROJECT # 21-3366-LH


NEW HOME, INC.

SMITHFIELD

Roof Truss Version

S-2.2.



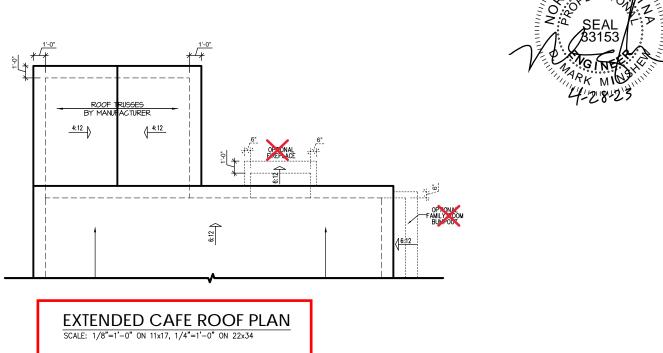



PROJECT # 21-3366-LH

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NEW HOME, INC.

SMITHFIELD

S-2.5

Roof Truss Version

TRUSS SYSTEM REQUIREMENTS NC (2018 NCRC): Wind: 115-120 mph

TRUSS SYSTEM LAYOUTS (PLACEMENT PLANS) SHALL BE DESIGNED IN ACCORDANCE WITH SEALED STRUCTURAL PLANS. ANY NEED TO CHANGE TRUSSES SHALL BE COORDINATED WITH SOUTHERN ENGINEERS.

Extended Cafe - See

Page S-2.5

- 2. TRUSS SCHEMATICS (PROFILES) SHALL BE PREPARED AND SEALED BY TRUSS MANUFACTURER.
- ALL TRUSSES SHALL BE DESIGNED FOR BEARING ON SPF #2 OR #3 PLATES OR LEDGERS (UNO).
- 4. ALL REQUIRED ANCHORS FOR TRUSSES DUE TO UPLIFT OR BEARING SHALL MEET THE REQUIREMENTS AS SPECIFIED ON THE TRUSS SCHEMATICS.

ROOF FRAMING NOTES:


NC (2018 NCRC): Wind: 115-120 mph


- 1. 2x8 RAFTERS @ 16" O.C. WITH 2x10 RIDGE, UNO.
- (2) 2xIO OR I.75xII.675 LYL HIP. (2) 2xIO HIPS MAY BE SPLICED WITH A MIN. 6'-O" OVERLAP AT CENTER
- (2) 2x10 OR 1.75x9.25 LVL VALLEY. DO NOT SPLICE VALLEYS
- 4) 1.75x11.875 LVL OR (2)1.75x4.25 LVL VALLEY
- 5) FALSE FRAME VALLEY ON 2xIO FLAT PLATE
- 6 2x6 RAFTERS @ 16" O.C. W 2x8 RIDGE, UNO.
- 7) 2xIO RAFTERS @ I6" O.C. W 2xI2 RIDGE, UNO.
- EXTEND RIDGE 12" BEYOND INTERSECTION


- "SR" = SINGLE RAFTER
 "DR" = DOUBLE RAFTER
 "TR" = TRIPLE RAFTER
 "RS" = ROOF SUPPORT
 "B" = (3) STUD OR 4x4 POST FOR ROOF SUPPORT (USE
 2X6 STUDS OR 6X6 POST FOR SUPPORT OVER IO'-O' IN
- HEIGHT)
 ATTACH VAULTED RAFTERS WITH HURRICANE CLIPS;
 SIMPSON "H-2.5A" OR EQUIVALENT. TIES TO BE INSTALLED
 ON THE OUTSIDE FACE OF FRAMING.
 INSTALL RAFTER TIES AND COLLAR TIES PER SECTION
 R802.3.I OF THE 2018 NC RESIDENTIAL CODE.


	ATTIC VENT SCHEDULE													
	"ENGLISH COUNTRY" ELEVATION													
MAIN	HOUSE	Ξ	SQ FTG	1192	AT	AT / NEAR RIDGE			AR EAVE					
VENT TYPE			SQ. FT. REQUIRED SQ. FT.		PERCENT OF TOTAL	POT LARGE (SQ. FT. EACH)	POT SMALL (SQ. FT. EACH)	RIDGE VENT (SQ. FT. PER LF)	EAVE VENT (SQ. N. EACH)	CONT. VENT (SQ. IN. PER LF)				
	RAN		SUPPLIED	SUPPLIED	0.4236	0.2778	0.125	0.1944	0.0625					
RIDGE VENT	1.99	2.00	47.06	0	0	16.00								
SOFFIT VENTS	2.38	1.99	2.25	52.94	0 36.0				36.00					
TOTAL (MIN)	3.97	3.97	4.25	100.00	POT VENTS MAY BE REQUIRED IF THERE IS INSUFFICIENT RIDGE AVAILABLE									


^{*} SCHEDULE HAS BEEN CALCULATED ASSUMING EAVE VENTILATION AT 50-60% OF TOTAL AND RIDGE AT 40-50% OF TOTAL REQUIRED VENTILATION

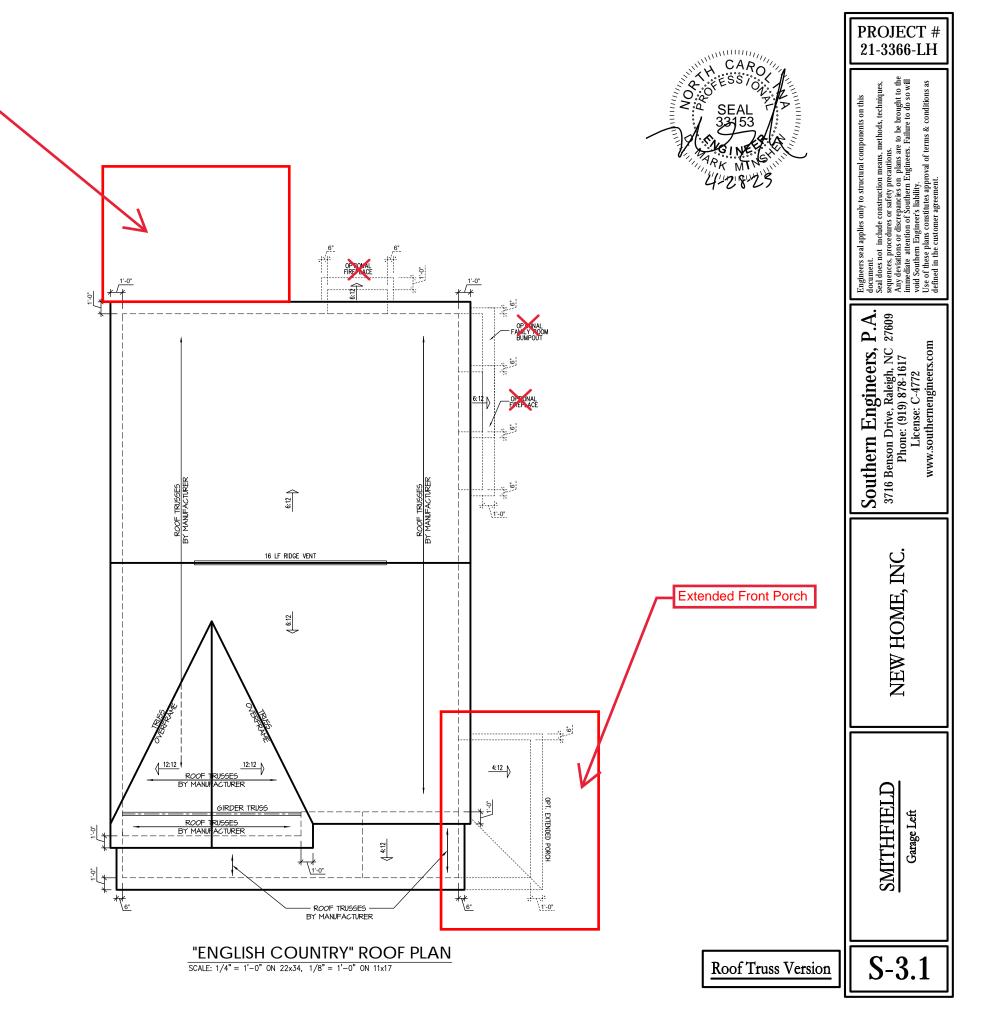

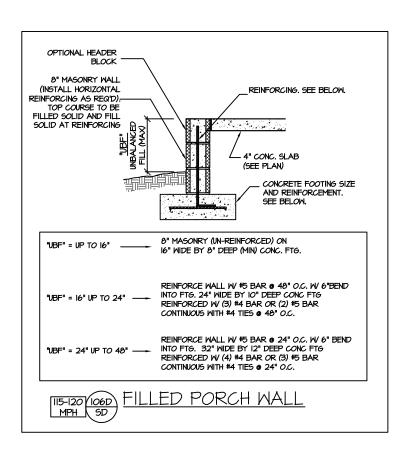


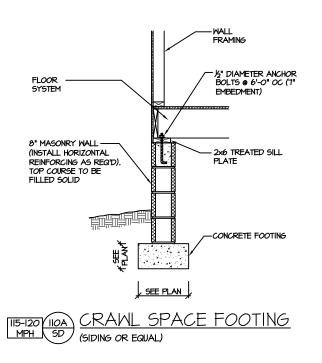


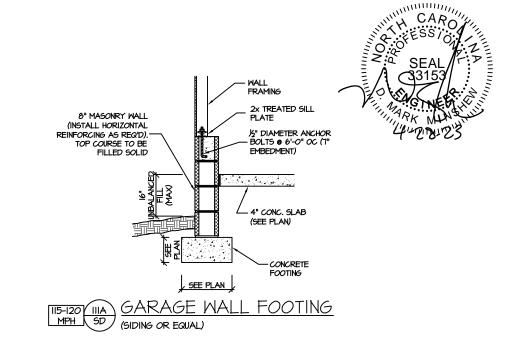

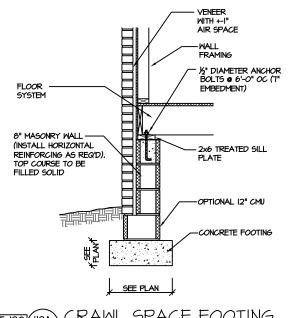



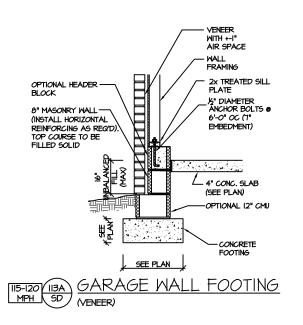

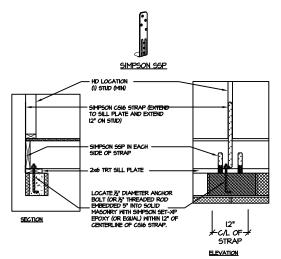

BRACED WALL END CONDITION " HD" HOLD-DOWN DETAIL

NOTE: SIMPSON DTT-IZ IS ACCEPTABLE ALTERNATE NOTE: ALTERNATE HD HOLD-DOWN DEVICES OR SYSTEMS MAY BE USED TO MEET THE CODE REQUIRED 800 LB CAPACITY IN LIEU OF THE ABOVE DETAIL.

CRAWL SPACE FOUNDATION

PROJECT # 21-3366

P.A. 27609 www.southernengineers.com

Southern Engineers, P 3716 Benson Drive, Raleigh, NC 27 Phone: (919) 878-1617 License: C-4772

NEW HOME,

PLAN SMITHFIELD

SD

- ENGINEER'S SEAL APPLIES ONLY TO STRUCTURAL COMPONENTS INCLUDING ROOF RAFTERS, HIPS, VALLEYS, RIDGES, FLOORS, WALLS, BEAMS AND HEADERS, COLUMNS, CANTILEVERS, OFFSET LOAD BEARING WALLS, PIER & GIRDER SYSTEM, FOOTING, AND PILING SYSTEM. ENGINEER'S SEAL DOES NOT CERTIFY DIMENSIONAL ACCURACY OR ARCHITECTURAL LAYOUT INCLUDING ROOF SYSTEM, ALL REQUIREMENTS FOR PROFESSIONAL CERTIFICATION SHALL BE PROVIDED BY THE APPROPRIATE PROFESSIONAL. SOUTHERN ENGINEERS, P.A. CERTIFIES ONLY THE STRUCTURAL COMPONENTS AS SPECIFICALLY STATED.
- ALL CONSTRUCTION SHALL CONFORM TO THE LATEST REQUIREMENTS OF THE 2018 NC RESIDENTIAL CODE, PLUS ALL LOCAL CODES AND REGULATIONS, THE STRUCTURAL ENGINEER IS NOT RESPONSIBLE FOR, AND WILL NOT HAVE CONTROL OF, CONSTRUCTION MEANS, METHODS, TECHNIQUES, SEQUENCES OR PROCEDURES, OR FOR SAFETY PRECAUTIONS AND PROGRAMS IN CONNECTION WITH THE CONSTRUCTION WORK, NOR WILL THE ENGINEER BE RESPONSIBLE FOR THE CONTRACTOR'S FAILURE TO CARRY OUT THE CONSTRUCTION WORK IN ACCORDANCE WITH THE CONTRACT DOCUMENTS. "CONSTRUCTION REVIEW" SERVICES ARE NOT PART OF OUR CONTRACT. ALL MEMBERS SHALL BE FRAMED ANCHORED, TIED AND BRACED IN ACCORDANCE WITH GOOD CONSTRUCTION PRACTICE AND THE BUILDING CODE.

- STAIRS: (40 PSF, IO PSF, L/360)
- DECKS AND EXTERIOR BALCONIES: (40 PSF, 10 PSF, L/360)
- PASSENGER VEHICLE GARAGES: (50 PSF, IO PSF, L/360)
- WALLS SHALL BE BRACED BY SHEATHING WALLS ON ALL STORIES WITH WOOD STRUCTURAL PANELS, SEE FRAMING NOTES FOR THICKNESS AND NAILING REQUIREMENTS.
- 5. SEE APPENDIX M (DCA6) FOR EXTERIOR DECK REQUIREMENTS INCLUDING ATTACHMENTS FOR
- ALLOWABLE SOIL BEARING PRESSURE ASSUMED TO BE 2000 PSF. THE CONTRACTOR MUST CONTACT A GEOTECHNICAL ENGINEER AND THE STRUCTURAL ENGINEER IF UNSATISFACTORY SUBSURFACE CONDITIONS ARE ENCOUNTERED. THE SURFACE AREA ADJACENT TO THE FOUNDATION WALL SHALL BE PROVIDED WITH ADEQUATE DRAINAGE, AND SHALL BE GRADED SO AS TO DRAIN SURFACE WATER AWAY FROM FOUNDATION WALLS.
- TREATED LUMBER SHALL BE SYP # 2. PLATE MATERIAL MAY BE SPF # 3 OR SYP #3 (Fc(perp) =
- 9. L.Y.L. SHALL BE LAMINATED VENEER LUMBER: Fb=2600 PSI, Fv=285 PSI, E=1.9xI0 PSI.
- ALL STRUCTURAL STEEL SHALL BE ASTM A-36, STEEL BEAMS SHALL BE SUPPORTED AT EACH END MITH A MINIMUM BEARING LENGTH OF 3 1/2" INCHES AND FULL FLANGE WIDTH, PROVIDE SOLID BEARING FROM BEAM SUPPORT TO FOUNDATION. BEAMS SHALL BE ATTACHED TO EACH SUPPORT WITH TWO LAG SCREWS (1/2" DIAMETER x 4" LONG). LATERAL SUPPORT IS CONSIDERED ADEQUATE PROVIDING THE JOIST ARE TOE NAILED TO THE SOLE PLATE, AND SOLE PLATE IS NAILED OR BOLTED TO THE BEAM FLANGE @ 48" O.C. ALL STEEL TUBING SHALL BE AGTM A500.
- WITH 2 BOLTS LOCATED AT 6" FROM EACH END.
- I4. BRICK LINTELS (WHEN REQUIRED) SHALL BE 3 I/2"x3 I/2"x1/4" STEEL ANGLE FOR UP TO 6'-0" SPAN AND 6"x4"x5/16" STEEL ANGLE WITH 6" LEG VERTICAL FOR SPANS UP TO 9'-0". SEE PLANS FOR SPANS OVER 9'-0". SEE ALSO SECTION R703.8.3 LINTELS.



PROJECT # 21-3366

P.A. 27609

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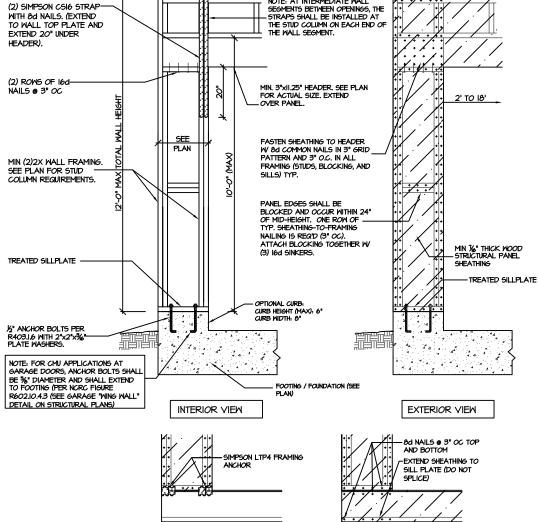
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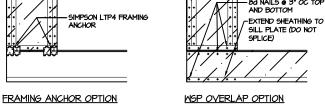
HOME

NEW

- DESIGN LOADS (LISTED AS: LIVE LOAD, DEAD LOAD, DEFLECTION)
- ROOMS OTHER THAN SLEEPING ROOMS; (40 PSF, IO PSF, L/360) SLEEPING ROOMS; (30 PSF, IO PSF, L/360)
- ATTIC WITH PERMANENT STAIR: (40 PSF, 10 PSF, L/360)
 ATTIC WITHOUT PERMANENT STAIR: (20 PSF, 10 PSF, L/360)
- ATTIC WITHOUT STORAGE: (IO PSF, IO PSF, L/240)

- CONCRETE SHALL HAVE A MINIMIM 26 DAY STRENGTH OF 3000 PSI AND A MAXIMUM SLUMP OF 5 INCHES INLESS NOTED OTHERWISE (INO). AIR ENTRAINED PER TABLE 402.2. ALL CONCRETE SHALL BE PROPORTIONED, MIXED, HANDLED, SAMPLED, TESTED, AND PLACED IN ACCORDANCE WITH ACI STANDARDS, ALL SAMPLES FOR PIMPING SHALL BE TAKEN FROM THE EXIT END OF THE PIMP. CONTROL JOINTS IN SLABS SHALL BE SPACED ON A GRID OF +30 TIMES THE DEPTH (D). CONTROL JOINTS SHALL BE SANCUT TO A DEPTH OF I/D. (I.E. 4" CONCRETE SLABS SHALL HAVE 1/4" DEEP CONTROL JOINTS SAWCUT IN SLAB ON A +-10'-0" x +-10'-0" GRID).
- 8. ALL FRAMING LUMBER SHALL BE SPF #2 (Fb = 875 PSI) UNLESS NOTED OTHERWISE (UNO). ALL
- P.S.L. SHALL BE PARALLEL STRAND LUMBER: FD=2400 PSI, FV=240 PSI, E=1.20x10 PSI, L.S.L. SHALL BE LAMINATED STRAND LUMBER: FD=2250 PSI, FV=400 PSI, E=1.55x10 PSI. INSTALL ALL CONNECTIONS PER MANUFACTURERS INSTRUCTIONS.
- IO. ALL ROOF TRUSS AND I-JOIST LAYOUTS SHALL BE PREPARED IN ACCORDANCE WITH THE SEALED STRUCTURAL DRAWINGS, TRUSSES AND I-JOISTS SHALL BE INSTALLED ACCORDING TO THE MANUFACTURE'S SPECIFICATIONS, ANY CHANGE IN TRUSS OR I-JOIST LAYOUT SHALL BE COORDINATED WITH SOUTHERN ENGINEERS.
- 12. REBAR SHALL BE DEFORMED STEEL, ASTM615, GRADE 60. LAP ALL REBAR SPLICES 30 BAR
- 13. FLITCH BEAMS SHALL BE BOLTED TOGETHER USING (2) ROWS OF 1/2" DIAMETER BOLTS (ASTM A325) WITH MASHERS PLACED UNDER THE THREADED END OF BOLT, BOLTS SHALL BE SPACED AT 24" O.C. (MAX), AND STAGGERED AT THE TOP AND BOTTOM OF BEAM (2" EDGE DISTANCE),






NOTE: AT INTERMEDIATE WALL

CS-PF - OVER WOOD FLOOR

CS-PF: CONTINUOUS PORTAL FRAME CONSTRUCTION DETAIL AND APPLICATION BASED ON NORC FIGURE R602.10.1 - PORTAL FRAME CONSTRUCTION

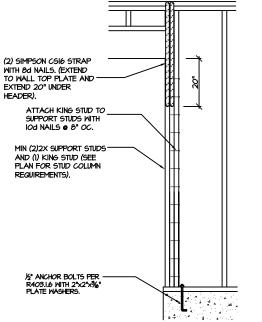

CS-PF: END CONDITION DETAIL (FOR USE WITH SINGLE CS-PF CONDITION) DETAIL AND APPLICATION BASED ON NORC FIGURE R602.IO.I - PORTAL FRAME CONSTRUCTION

SD

SMITHFIELD