
THIS PLAN HAS BEEN DRAWN TO CONFORM TO THE 2018 NORTH CAROLINA RESIDENTIAL CODE


CONTRACTOR SHALL VERIFY ALL DIMENSIONS AND CONDITIONS PRIOR TO BEGGINING WORK. CONTRACTOR IS RESPONSIBLE FOR COMPLIANCE WITH ALL STATE AND LOCAL BUILDING CODES AND ORDINANCES. KADS CUSTOM HOME DESIGNS ASSUMES NO LIABILITY FOR SITE CONDITIONS, CONSTRUCTION METHODS OR ANY DEVIATION OF THESE PLANS.

NOTE:
ALL WINDOWS TO BE INSTALLED MUST MEET
A MAXIMUM OF .32 U VALUE OR BETTER, UNLESS
ENERGY CALCULATIONS ARE SUBMITTED WITH PLANS
PROVIDED BY BUILDER AT TIME OF PLAN REVIEW.



# FRONT ELEVATION SCALE: 1/4"=1'-0"

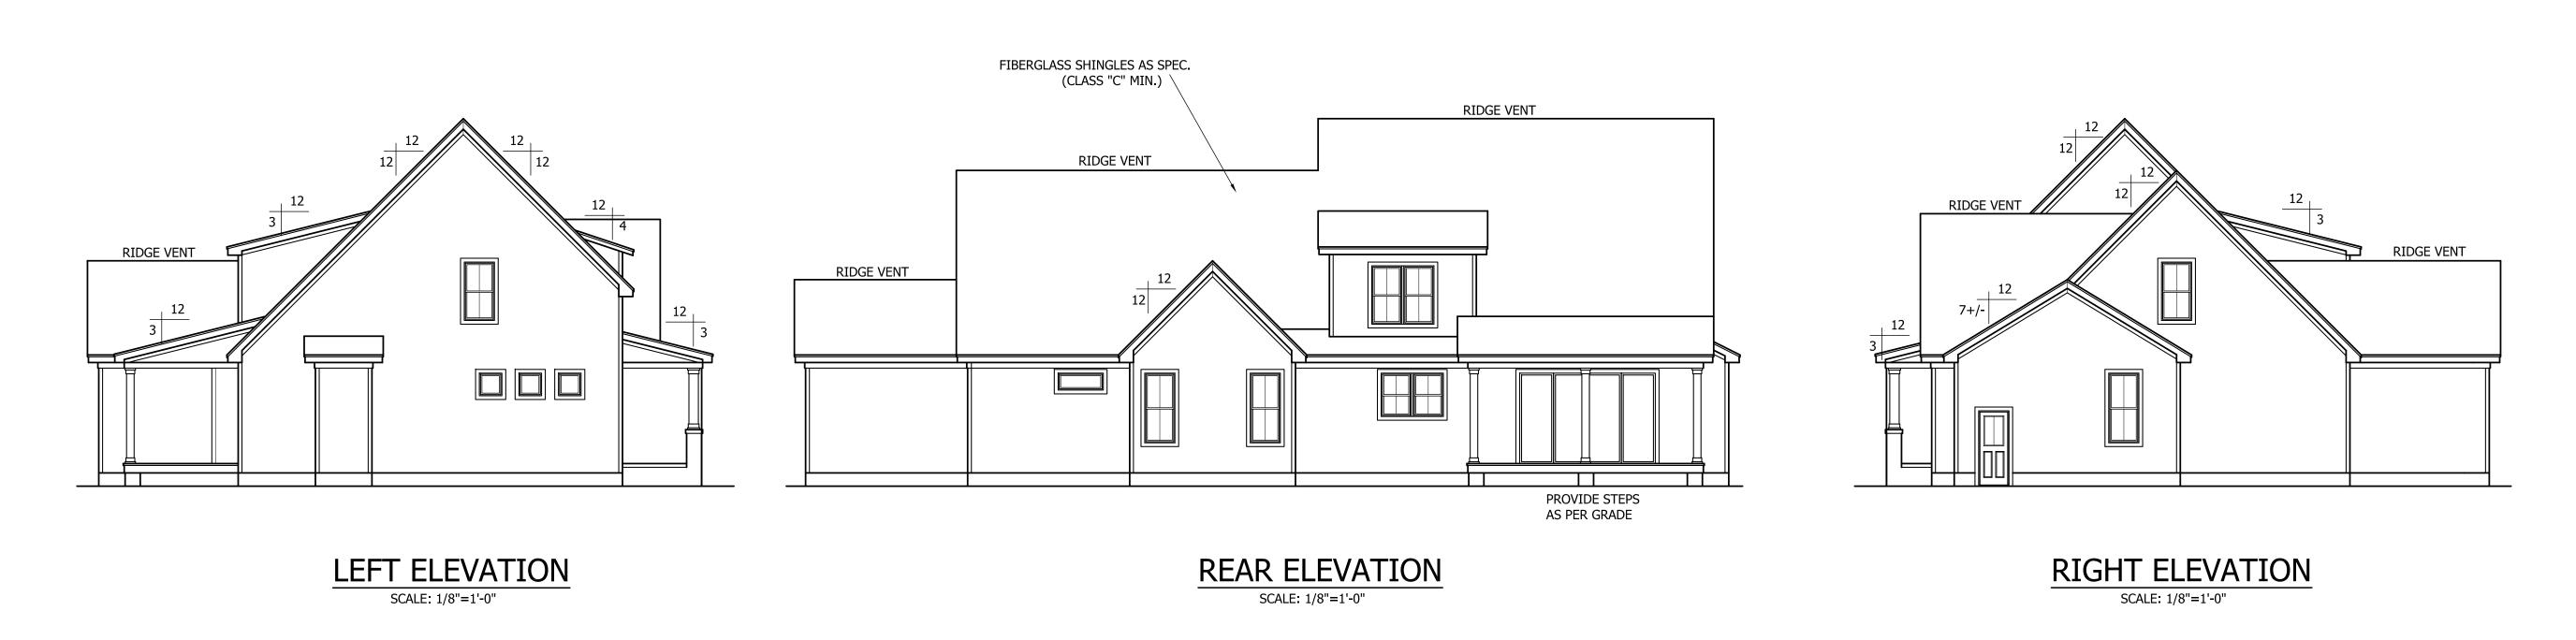

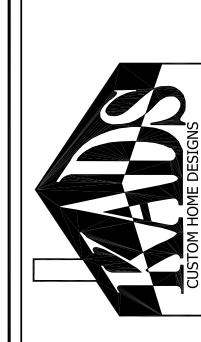

ANGIER, NC 919-369-7181

DRAWN BY: D.W.O.


DATE: 4/30/24

PAGE NO


**1**OF

0F **4** 

PLAN NO. DK3341

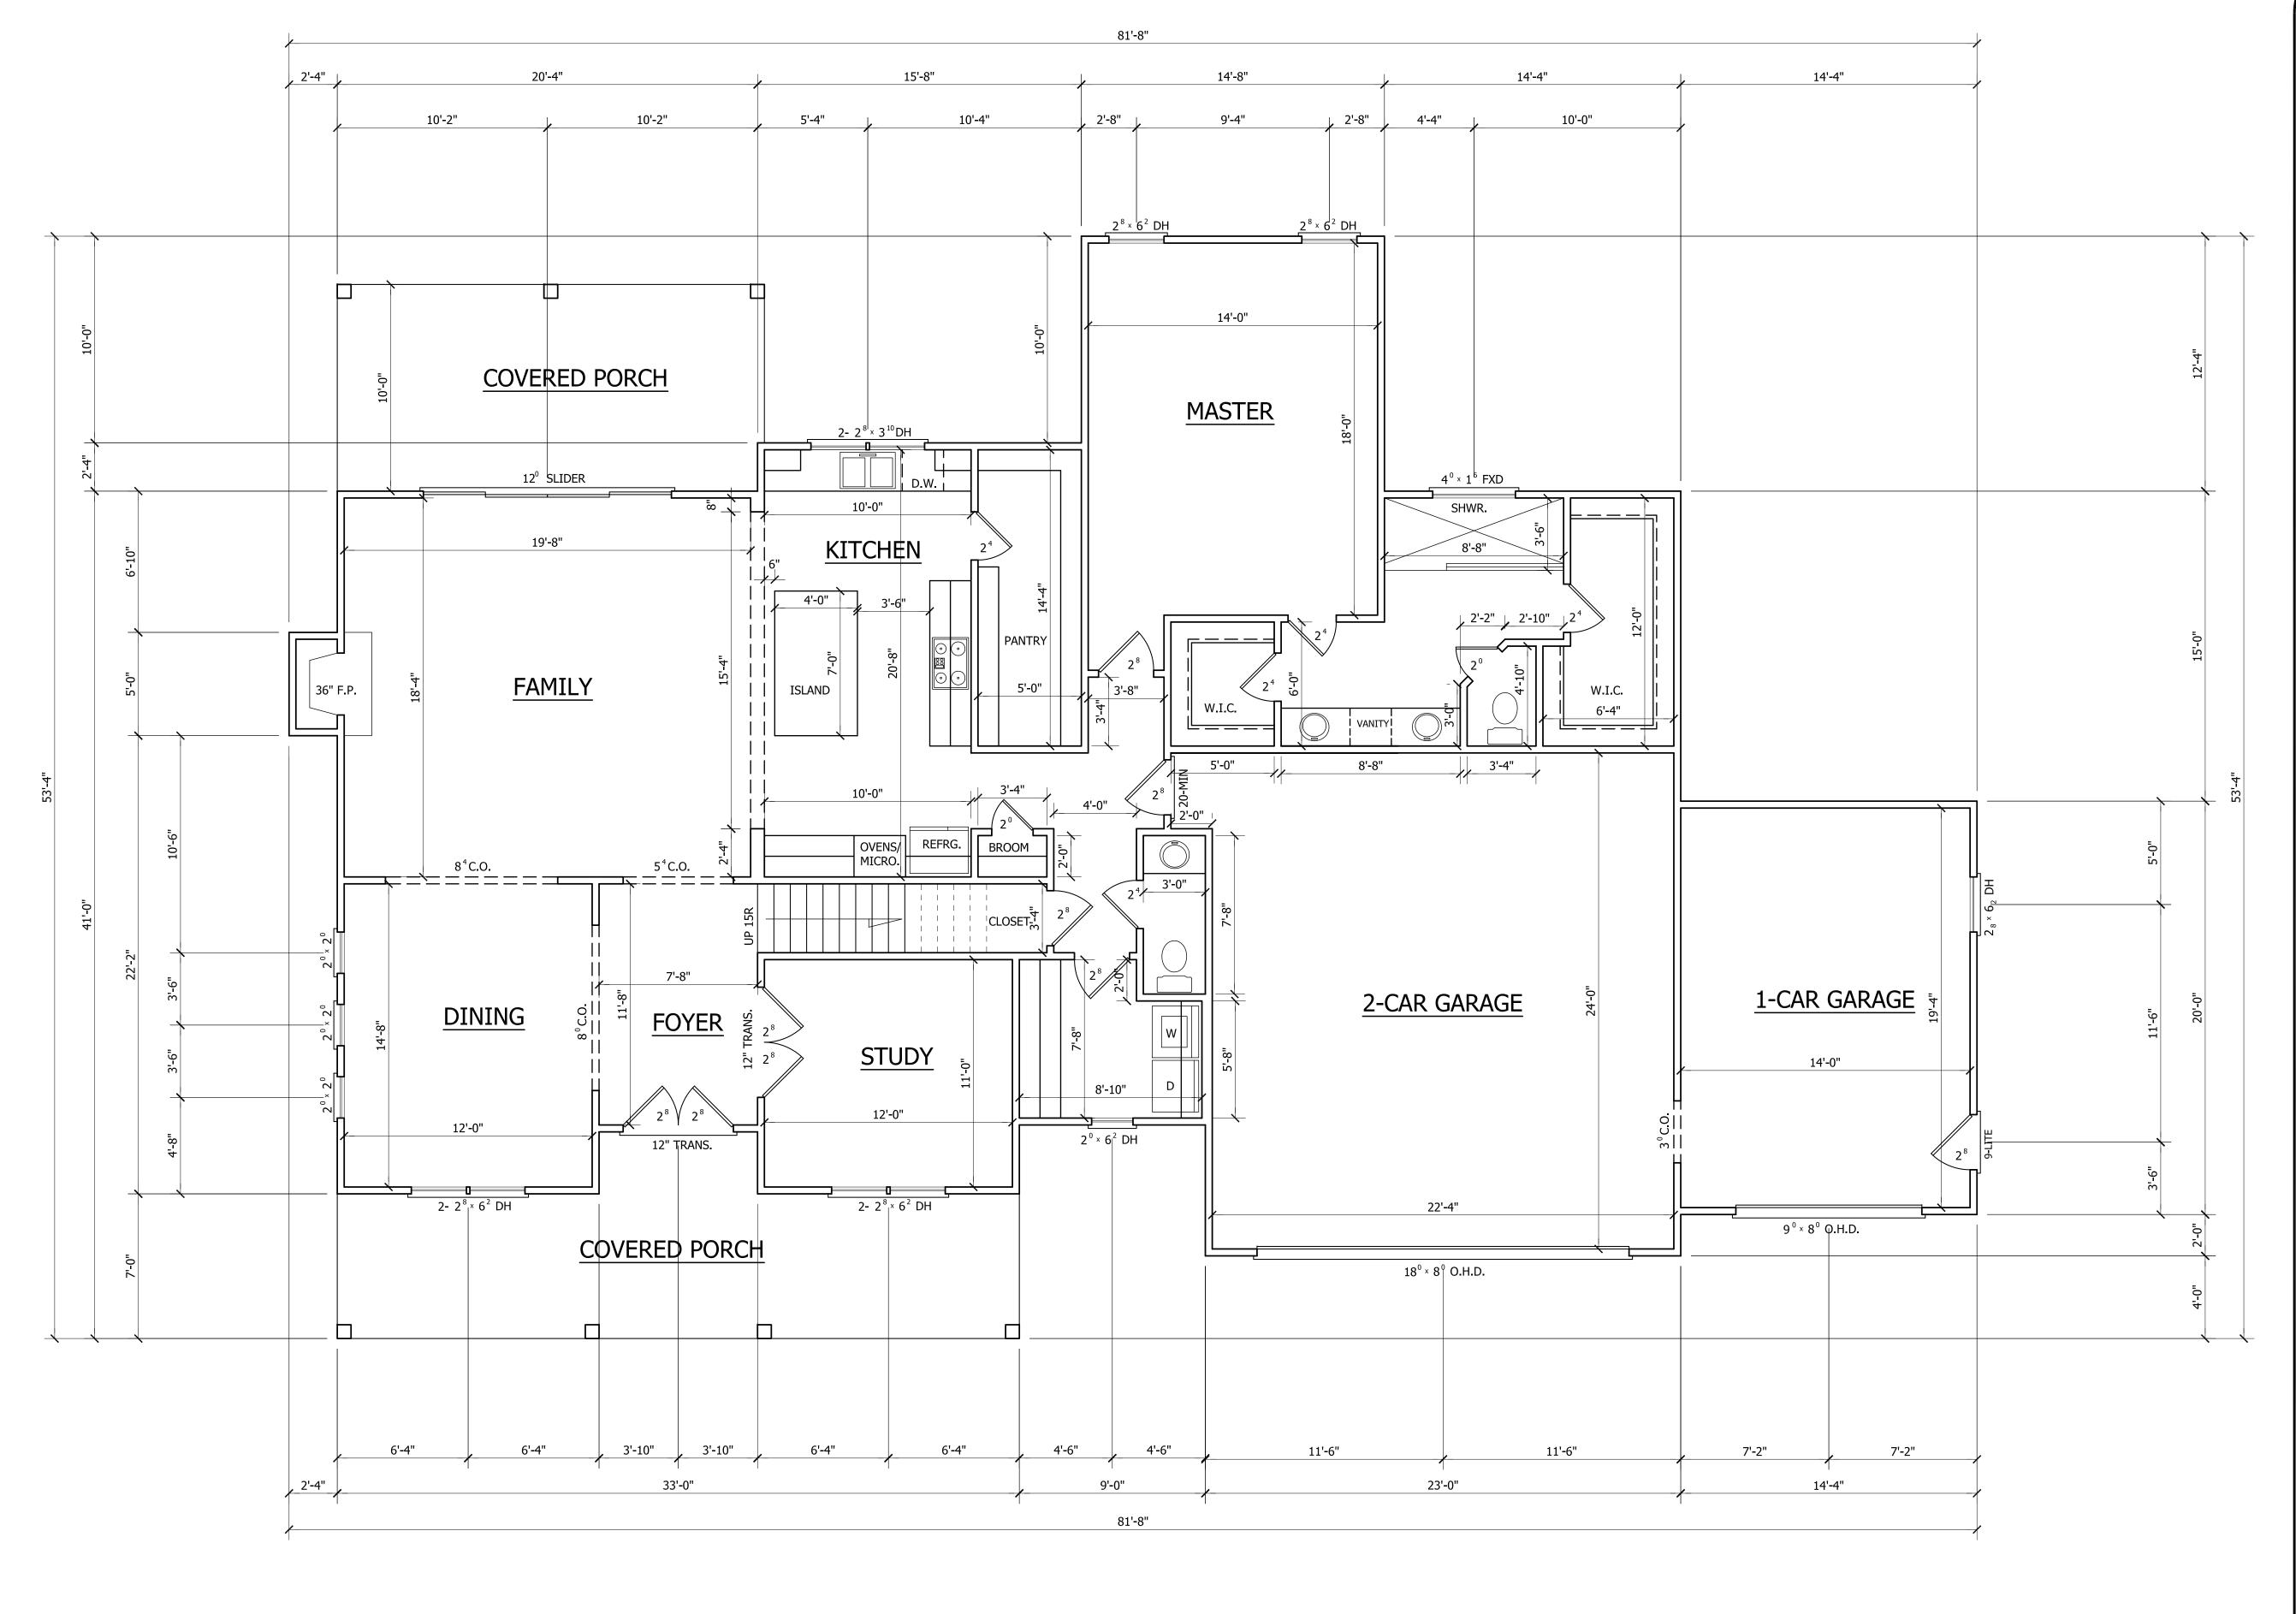

STEPHENSON BUILDERS, INC LOT 13 LANE FARMS

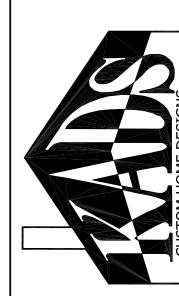

ANGIER, NC 919-369-7181

DRAWN BY: D.W.O.

DATE: 4/30/24

PAGE NO

HEATED

FIRST FLOOR HTD. SQ. FT. = 1882

SECOND FLOOR HTD. SQ. FT. = 897

REC. RM. HTD. SQ. FT. = 562

= 3341

= 254 = 206

= 848

= 179

FIRST FLOOR PLAN

SCALE: 1/4"=1'-0"

SET WINDOWS AT 8'-0" A.F.F.

9'-0" CLG. HGT.

TOTAL HEATED SQ. FT.

FRONT PORCH SQ. FT.

REAR PORCH SQ. FT.

GARAGE SQ. FT.

STORAGE SQ. FT.


<u>UNHEATED</u>

2

0F **4** 

PLAN NO. DK3341

# TEPHENSON BUILDERS, INC LOT 13 LANE FARMS

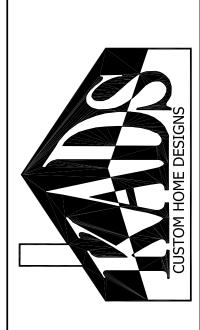

ANGIER, NC 919-369-7181

DRAWN BY:

DATE: 4/30/24

PAGE NO

3

OF

PLAN NO.

DK3341

SECOND FLOOR PLAN

SCALE: 1/4"=1'-0" 9'-0" CLG. HGT. SET WINDOWS AT 7'-4" A.F.F.

SIDING

INSUL.

GRADE VARIES

EXPANSION JOINT NEEDED IF SLAB IS TO BE UNHEATED

Stairways shall not be less than 36 inches

in clear width at all points above the permitted

Handrails shall not project more than 4.5 inches

a handrail is installed on one side and 27 inches

where handrails are provided on both sides

STAIR DETAIL

handrail height and below the required headroom height.

on either side of the stairway and the minimum clear width

of the stairway at and below the handrail height, including


treads and landings, shall not be less than 31-1/2 inches where

1/2" DIA X 15" EMBEDED ÁNCHOR BOLTS @ 6'-0" O.C.

SHEATHING

2"x4" SILL



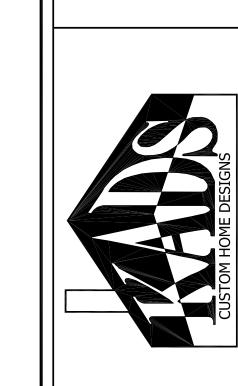

ANGIER, NC 919-369-7181


> DRAWN BY: D.W.O.

DATE: 4/30/24

PAGE NO

OF

PLAN NO. DK3341

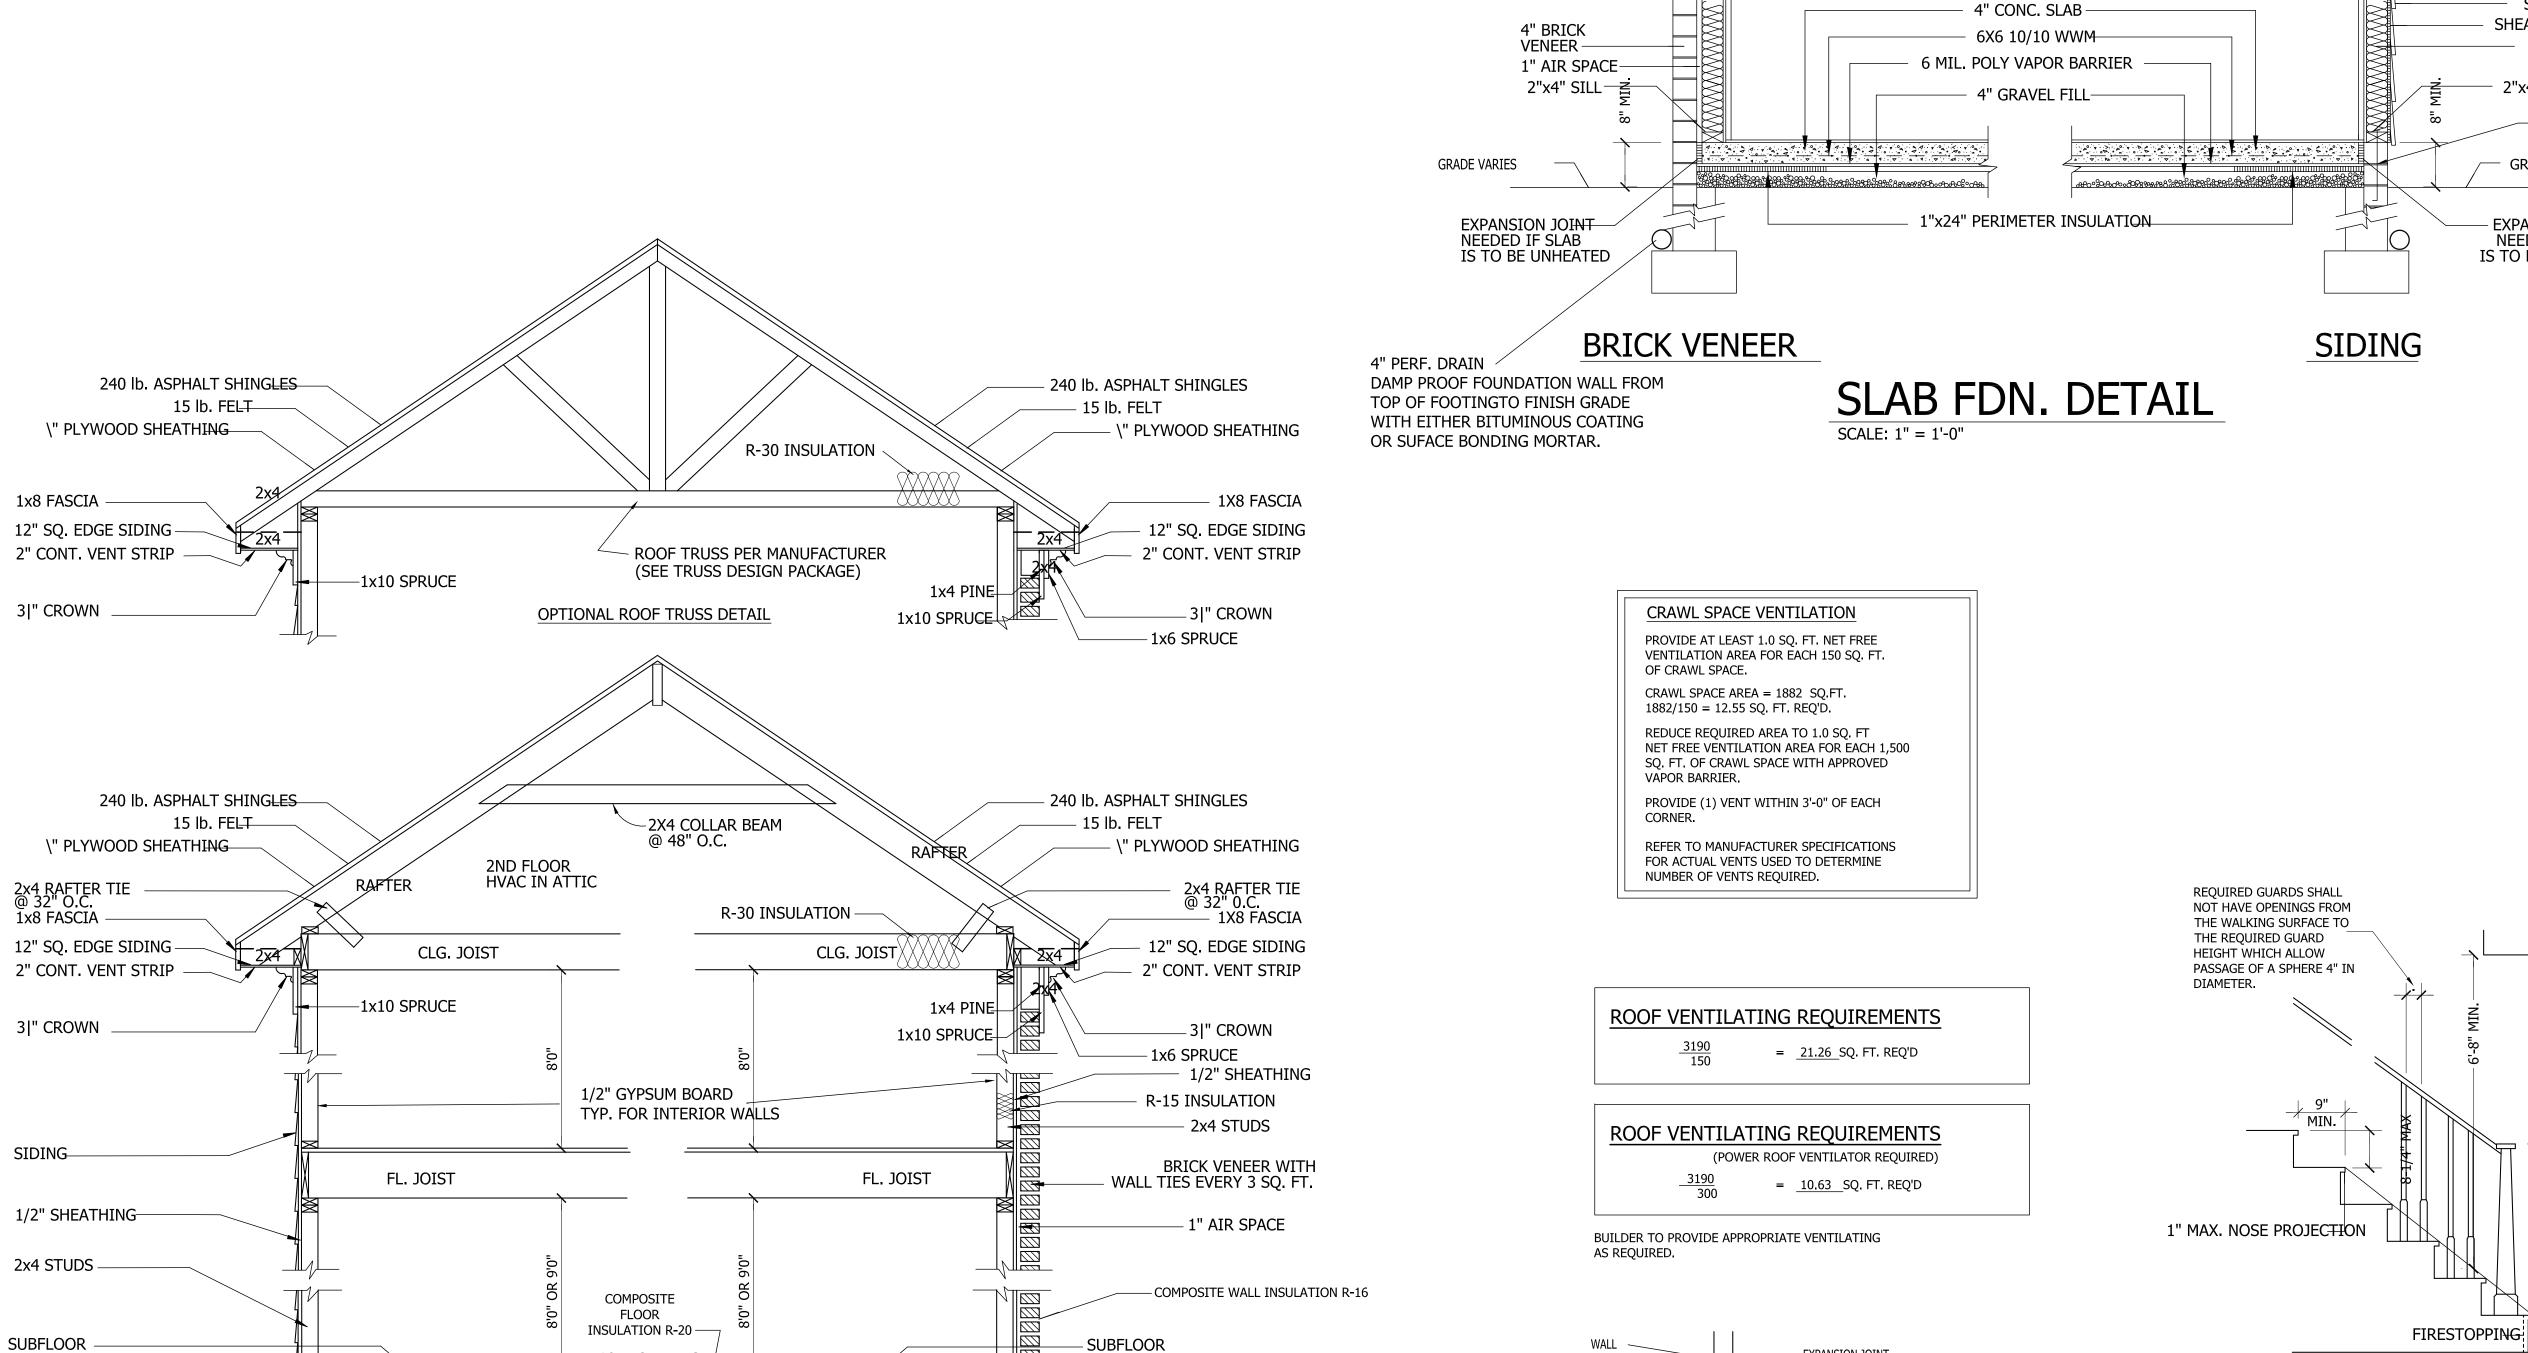

- FINISH FLOOR

- 2 X BAND

WEEP HOLES 48" O.C.

— 30# FELT OR FLASHING UP 6" BEHIND SHEATHING

1/2" DIA X 15" EMBEDED ANCHOR BOLTS @ 6'-0" O.C.

4" PERF. DRAIN

DAMP PROOF FOUNDATION WALL FROM

TOP OF FOOTINGTO FINISH GRADE

OR SUFACE BONDING MORTAR.

WITH EITHER BITUMINOUS COATING

EXPANSION JOINT 4" CONC. SLAB WITH FIBERMESH OR WIREMESH ON 6 MIL. VAPOR FOUNDATION BARRIER ON 4" CRUSHED STONE GRADE -2965,5565,5565,5565,5565 2965,5565,5565,5565,5565 - 8" CONC. BLK. WALL — 8"x16" CONC. FTG.

**GARAGE SLAB** 

WALL SECTION SCALE: \" = 1'-0"

R-19 INSULAT<del>IQ</del>N

FL. JOIST

3" MIN. PROJECTION MAX. - THICKNESS OF

**FOOTING** 

SIDING SECTION

TREATED SILL

- 8" SOLID CAP FOR 2 STORY

4" SOLID CAP FOR 1 STORY

- GIRDER

FL. JOIST

1ST FLOOR HVAC IN CRAWL SPACE

(MIN. 22" CLEARANCE)

BRICK SECTION

TREATED SILL

CORBEL BRICK

8" SOLID CAP

- CONC. BLOCK

AS SHOWN BELOW

FINISH FLOOR

FINISH GRADE -

1/2" DIA X 15" EMBEDED ANCHOR BOLTS @ 6'-0" O.C.

2 X BAND



STRUCTURAL DESIGN IN ACCORDANCE WITH: NORTH CAROLINA STATE RESIDENTIAL CODE 2018 EDITION IRC ENGINEER'S SEAL APPLIES TO STRUCTURAL COMPONENTS ONLY AND DOES NOT CERTIFY ARCHITECTURAL LAYOUT OR DIMENSIONAL ACCURACY. SEAL APPLIES ONLY FOR LOT NUMBER INDICATED AND SIGNED PLANS MAY NOT BE COPIED. FAILURE TO NOTIFY THE ENGINEER OF ADDITIONAL USE OF THE PLANS WILL VOID THE LIABILITY OF ROSS LINDEN ENGINEERS PC.

FOUNDATION & FIRST FLOOR FRAMING SCALE: 1/4" = 1'-0"

2'-4"

9'-0"

81'-8"

33'-0"

18'-4"

23'-0"

, 2'-4"

, 2'-6"

9'-4"

14'-4"

2'-6"

709 W. JONES STREET

RALEIGH, NC 27603 TEL 919.832.5680 FAX 919.832.5675 WWW.ROSSLINDEN.COM

ROSS LINDEN ENGINEERS PC ASSUMES NO LIABILITY FOR CHANGES OR MODIFICATIONS MADE TO THESE PLANS BY OTHERS, OR FOR CONSTRUCTION METHODS, OR FOR ANY DEVIATION FROM THESE PLANS.

PLAN ENGINEERING REMAINS THE PROPERTY OF ROSS LINDEN ENGINEERS PC AND ANY UNAUTHORIZED USE OR DUPLICATION IN WHOLE OR PART IS STRICTLY PROHIBITED.

WHOLE OR PART IS STRICTLY PROHIBITED.
THESE DRAWINGS ARE OFFERED TO THE
CLIENT FOR A CONDITIONAL ONE TIME USE.
THE CONDITIONAL USE IS LIMITED TO THE
LOT OR PROPERTY AS SPECIFIED HEREIN, AND ONLY FOR THE SAID LOCATION.

STEPHENSON BUILDERS LOT 13 LANE FARMS

PROJECT NO. R240501

DESIGN BY LLR

REVISION

28 MAY 2024

DATE

FOUNDATION & FIRST FLOOR

SHEET NO.

OF S5

WALL BRACING SHALL BE IN ACCORDANCE WITH SECTION R602.10.3
CONTINUOUS SHEATHING. BRACING METHOD CS-WSP SHALL BE USED IN ACCORDANCE WITH TABLE R602.10.1.

THE REQUIRED LENGTH OF BRACING FOR EACH SIDE OF A RECTANGLE CIRCUMSCRIBED AROUND THE PLAN OR A PORTION OF THE PLAN AT EACH STORY LEVEL SHALL BE IN ACCORDANCE WITH TABLE R602.10.3 AND FIGURE R60.10.3(1). UNLESS NOTED OTHERWISE, THE ENTIRE STRUCTURE IS ASSUMED TO CIRCUMSCRIBED WITHIN A SINGLE

MINIMUM PANEL WIDTH IS 24". SEE SECTION R602.10.3 FOR ADDITIONAL INFORMATION. CONNECTION CRITERIA SHALL BE IN ACCORDANCE WITH TABLE R602.10.1. PORTAL FRAME CONSTRUCTION SHALL BE IN ACCORDANCE WITH FIGURE R602.10.1

HOLD DOWN DEVICE SHALL BE AS FOLLOWS: SIMPSON LSTA24 STRAP (OR EQUIVALENT) BETWEEN FLOORS EXTENDING FROM BOTTOM OF FLOOR BAND UP STUDS WHERE SHOWN. SIMPSON HD3B HOLDOWN (OR EQUIVALENT) WHERE REQUIRED TO CONNECT DIRECTLY TO FOUNDATION.

### WIND SPEED: 115 mph

RECTANGLE 1 EAVE TO RIDGE HEIGHT: 15.0 ft

FIRST FLOOR: SHORT SIDE LENGTH OF CIRCUMSCRIBED RECTANGLE: 49.33 ft REQUIRED LENGTH OF BRACING = 13.5 ftPROVIDED LENGTH OF BRACING =  $\frac{28.33 \text{ ft}}{}$ 

LONG SIDE LENGTH OF CIRCUMSCRIBED RECTANGLE: 67.33 ft REQUIRED LENGTH OF BRACING = 18.0 ftPROVIDED LENGTH OF BRACING =  $\overline{25.0 \text{ ft}}$ 

RECTANGLE 2 EAVE TO RIDGE HEIGHT: 6.67 ft

FIRST FLOOR: SHORT SIDE LENGTH OF CIRCUMSCRIBED RECTANGLE: 14.33 ft REQUIRED LENGTH OF BRACING = 2.0 ftPROVIDED LENGTH OF BRACING =  $\frac{14.33}{1}$  ft

LONG SIDE LENGTH OF CIRCUMSCRIBED RECTANGLE: 20.0 ft REQUIRED LENGTH OF BRACING = 2.5 ftPROVIDED LENGTH OF BRACING =  $\frac{5.0 \text{ ft}}{}$ 

CANTILEVER -


(2) 1 3/4" x 9 1/4" LVL

(2) 1 3/4" x 9 1/4" LVL

(2) 1 3/4" x 16" LVL

(2) 1 3/4" x 9 1/4" LVL

(2) 1 3/4" x 9 1/4" LVL

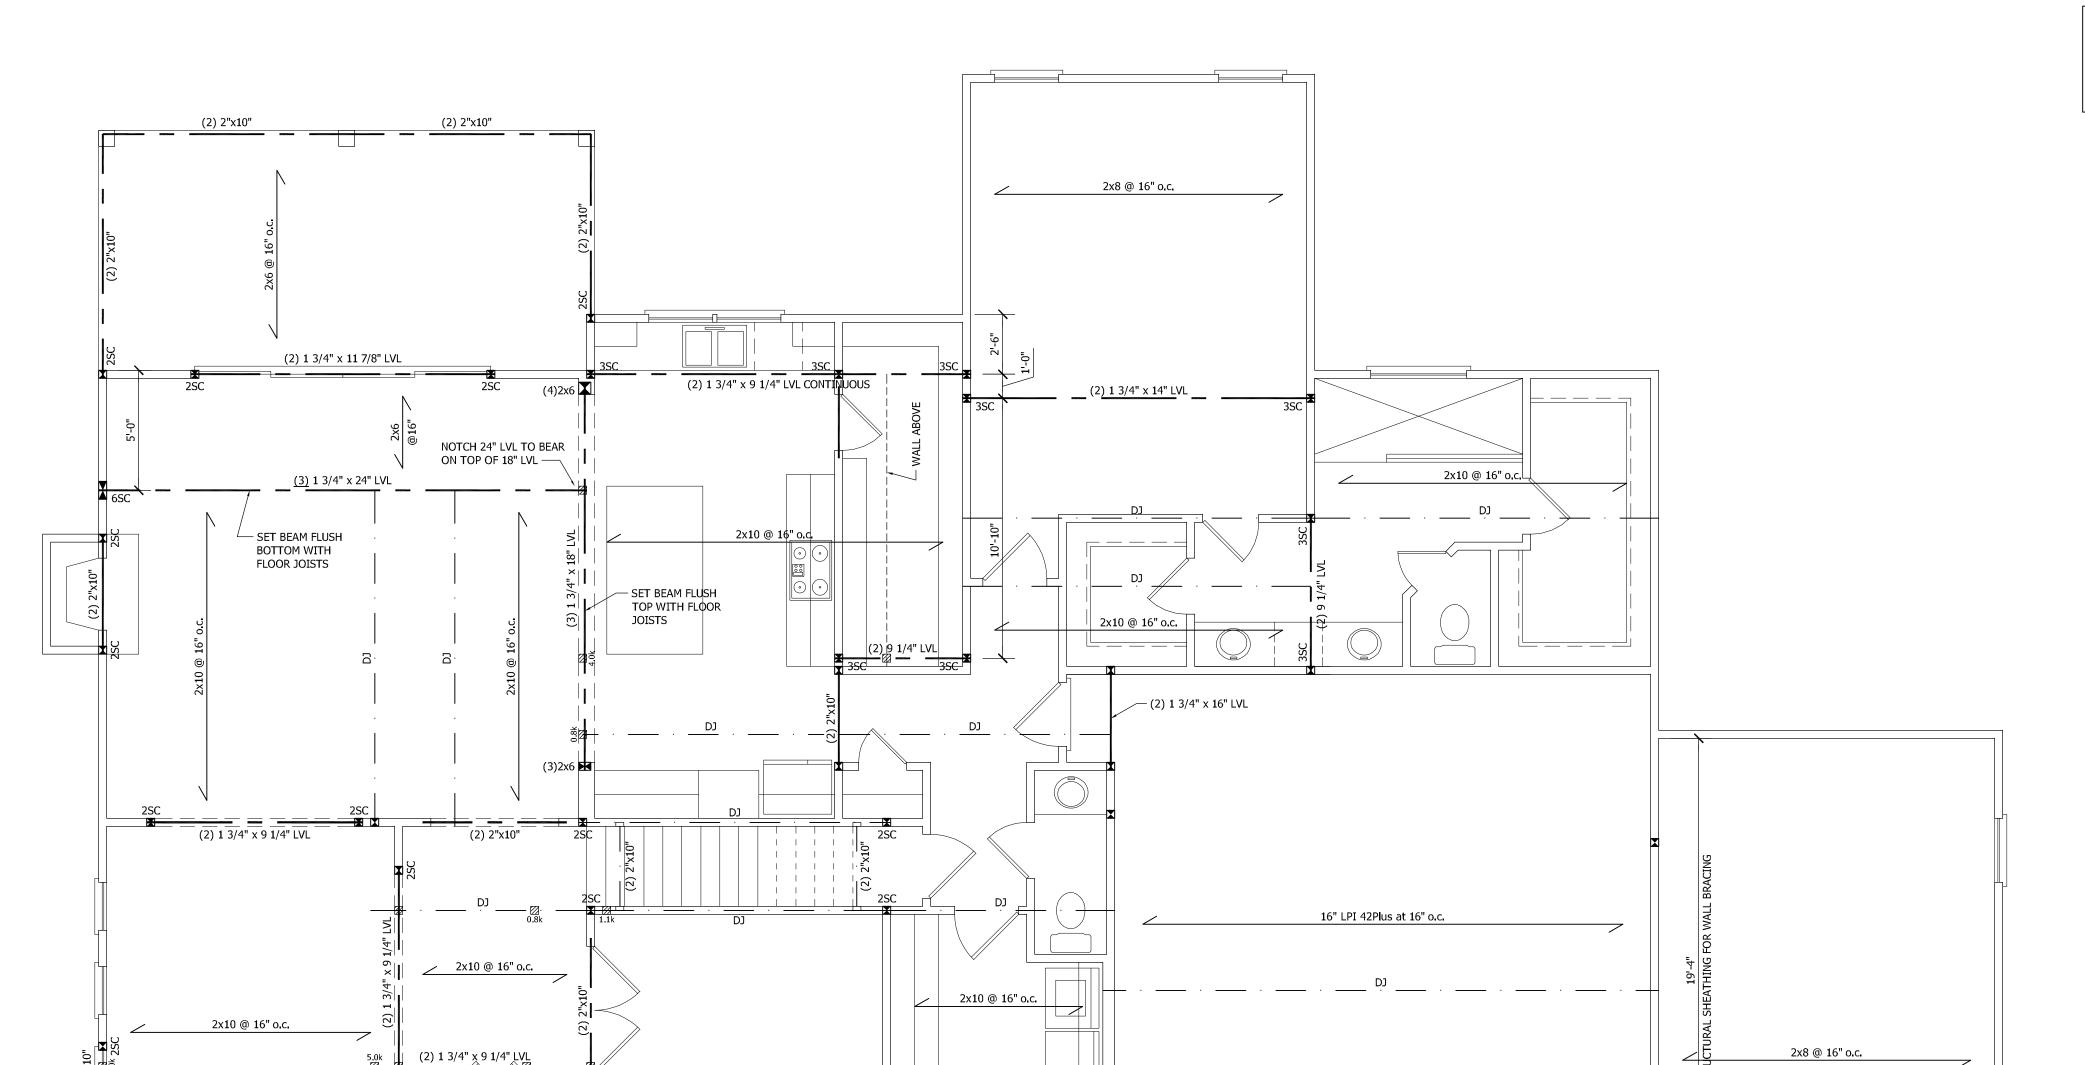

# FRAMING NOTES

1. STRUCTURAL NOTES SHEET S5.

2. FRAMING SHALL BE #2 SPF OR #2 SYP OR BETTER WITH A MINIMUM Fb = 800 psi

3. EXTERIOR AND BEARING HEADERS (2) 2"x10" u.n.o.

4. ■ DENOTES POINT LOAD. SEE CONSTRUCTION NOTE #4 ON S5.

FRAMING SYSTEM
JOIST LAYOUT AND PLACEMENT BY MANUFACTURER TO COINCIDE WITH THE SUPPORT LOCATIONS SHOWN. JOISTS SHALL BE DESIGNED FOR MAXIMUM L/480 LIVE LOAD DEFLECTION, JOIST LAYOUT SHALL BE PROVIDED FOR REVIEW AND COORDINATED WITH THE ENGINEER OF RECORD. INSTALLATION SHALL BE IN ACCORDANCE WITH THE MANUFACTURER'S INSTRUCTIONS.

EXTEND HEADER AND PROVIDE CS-PF PORTAL FRAME PANEL PER FIG. R602.10.1. PROVIDE LSTA24 STRAP (OR EQUIVALENT) EACH SIDE AS SHOWN. FASTEN SHEATHING TO HEADER AND WALL FRAMING (EACH STUD) WITH 8d NAILS AT 3" o.c. AS SHOWN, SEE FIG. R602.10.1 FOR ADDITIONAL REQUIREMENTS. SEE SHEET S5

ENGINEERS PC. SEAL NOT VALID UNLESS SIGNED AND DATED LOT 13 LANE FARMS ONLY

(2) 1 3/4" x 11 7/8" LVL

EXTEND HEADER AND PROVIDE CS-PF PORTAL FRAME BOTH ENDS. SEE NOTE ABOVE.

> STRUCTURAL DESIGN IN ACCORDANCE WITH: NORTH CAROLINA STATE RESIDENTIAL CODE 2018 EDITION IRC ENGINEER'S SEAL APPLIES TO STRUCTURAL COMPONENTS ONLY AND DOES NOT CERTIFY ARCHITECTURAL LAYOUT OR

DIMENSIONAL ACCURACY. SEAL APPLIES ONLY FOR LOT NUMBER INDICATED AND SIGNED PLANS MAY NOT BE COPIED. FAILURE TO NOTIFY THE ENGINEER OF ADDITIONAL USE OF THE PLANS WILL VOID THE LIABILITY OF ROSS LINDEN

FIRST CEILING FRAMING SCALE: 1/4" = 1'-0"

(2) 1 3/4" x 14" LVL

709 W. JONES STREET RALEIGH, NC 27603 TEL 919.832.5680 FAX 919.832.5675

WWW.ROSSLINDEN.COM

ROSS LINDEN ENGINEERS PC ASSUMES NO LIABILITY FOR CHANGES OR MODIFICATIONS MADE TO THESE PLANS BY OTHERS, OR FOR CONSTRUCTION METHODS, OR FOR ANY DEVIATION FROM THESE PLANS.

PLAN ENGINEERING REMAINS THE PROPERTY OF ROSS LINDEN ENGINEERS PC AND ANY UNAUTHORIZED USE OR DUPLICATION IN WHOLE OR PART IS STRICTLY PROHIBITED. THESE DRAWINGS ARE OFFERED TO THE CLIENT FOR A CONDITIONAL ONE TIME USE. THE CONDITIONAL USE IS LIMITED TO THE LOT OR PROPERTY AS SPECIFIED HEREIN, AND ONLY FOR THE SAID LOCATION.

STEPHENSON BUILDERS LOT 13 LANE FARMS

PROJECT NO.

R240501

DESIGN BY LLR 28 MAY 2024

DATE REVISION

> FIRST CEILING FRAMING

SHEET NO.


OF S5


1. STRUCTURAL NOTES SHEET S5.

2. FRAMING SHALL BE #2 SPF OR #2 SYP OR BETTER WITH A MINIMUM Fb = 800 psi

3. EXTERIOR AND BEARING HEADERS (2) 2"x10" u.n.o.


4. 🗷 DENOTES POINT LOAD. SEE CONSTRUCTION NOTE #4 ON S5.

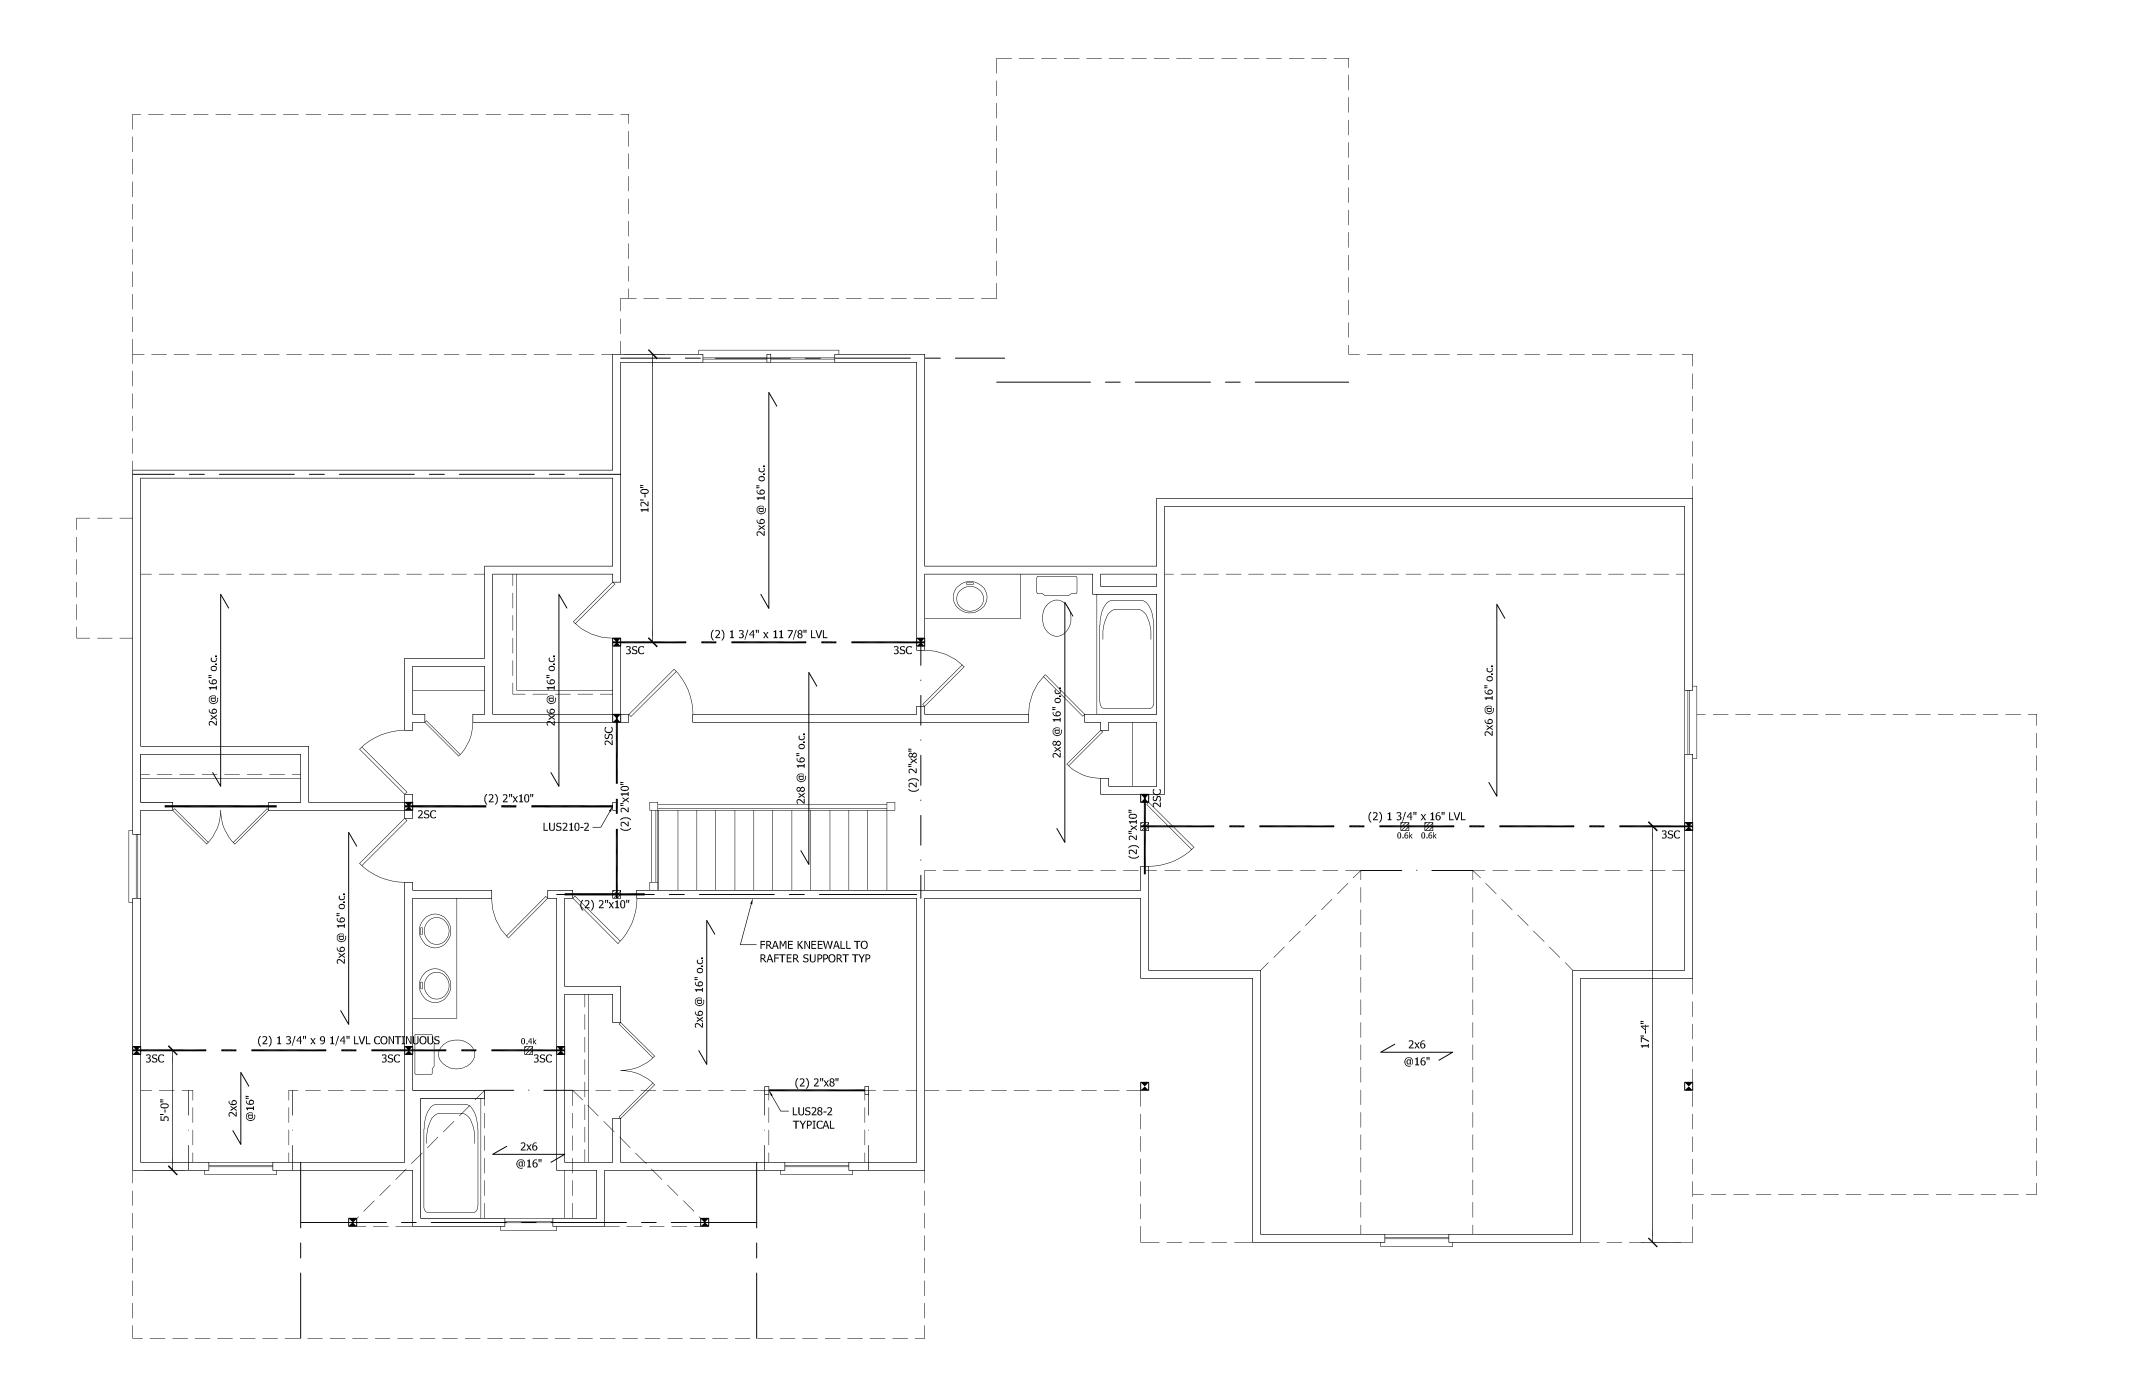

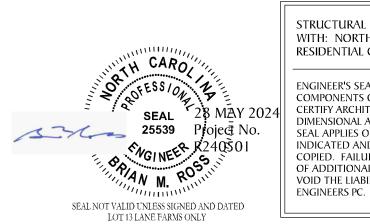

STRUCTURAL DESIGN IN ACCORDANCE WITH: NORTH CAROLINA STATE RESIDENTIAL CODE 2018 EDITION IRC

ENGINEER'S SEAL APPLIES TO STRUCTURAL COMPONENTS ONLY AND DOES NOT CERTIFY ARCHITECTURAL LAYOUT OR DIMENSIONAL ACCURACY.
SEAL APPLIES ONLY FOR LOT NUMBER INDICATED AND SIGNED PLANS MAY NOT BE COPIED. FAILURE TO NOTIFY THE ENGINEER OF ADDITIONAL USE OF THE PLANS WILL VOID THE LIABILITY OF ROSS LINDEN

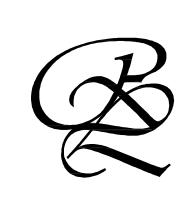

709 W. JONES STREET RALEIGH, NC 27603 TEL 919.832.5680 FAX 919.832.5675 WWW.ROSSLINDEN.COM

ROSS LINDEN

ROSS LINDEN ENGINEERS PC ASSUMES NO LIABILITY FOR CHANGES OR MODIFICATIONS MADE TO THESE PLANS BY OTHERS, OR FOR CONSTRUCTION METHODS, OR FOR ANY DEVIATION FROM THESE PLANS.

PLAN ENGINEERING REMAINS THE PROPERTY OF ROSS LINDEN ENGINEERS PC AND ANY UNAUTHORIZED USE OR DUPLICATION IN WHOLE OR PART IS STRICTLY PROHIBITED. THESE DRAWINGS ARE OFFERED TO THE CLIENT FOR A CONDITIONAL ONE TIME USE. THE CONDITIONAL USE IS LIMITED TO THE LOT OR PROPERTY AS SPECIFIED HEREIN, AND ONLY FOR THE SAID LOCATION.

STEPHENSON BUILDERS LOT 13 LANE FARMS

PROJECT NO.

R240501


DESIGN BY LLR 28 MAY 2024

REVISION DATE
- - -

SECOND CEILING FRAMING

SHEET NO.

O. S3

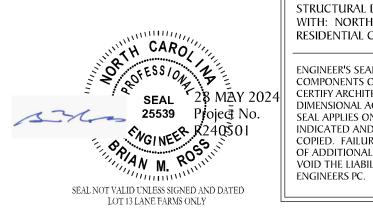

STRUCTURAL DESIGN IN ACCORDANCE WITH: NORTH CAROLINA STATE RESIDENTIAL CODE 2018 EDITION IRC ENGINEER'S SEAL APPLIES TO STRUCTURAL COMPONENTS ONLY AND DOES NOT CERTIFY ARCHITECTURAL LAYOUT OR DIMENSIONAL ACCURACY.
SEAL APPLIES ONLY FOR LOT NUMBER
INDICATED AND SIGNED PLANS MAY NOT BE COPIED. FAILURE TO NOTIFY THE ENGINEER OF ADDITIONAL USE OF THE PLANS WILL VOID THE LIABILITY OF ROSS LINDEN

ROOF FRAMING NOTES

1. STRUCTURAL NOTES SHEET S5.

2. FRAMING SHALL BE #2 SPF OR #2 SYP OR BETTER WITH A MINIMUM Fb = 800 psi

3. PROVIDE 2x4 COLLAR TIES AT 48" o.c. AT UPPER THIRD OF RAFTERS u.n.o. ON PLAN.

4. FUR RIDGES FOR FULL RAFTER CONTACT

5. ■ DENOTES POINT LOAD. SEE CONSTRUCTION NOTE #4 ON S5.

DENOTES OVERFRAMED AREA

709 W. JONES STREET RALEIGH, NC 27603 TEL 919.832.5680 FAX 919.832.5675 WWW.ROSSLINDEN.COM

ROSS LINDEN ENGINEERS PC ASSUMES NO LIABILITY FOR CHANGES OR MODIFICATIONS MADE TO THESE PLANS BY OTHERS, OR FOR CONSTRUCTION METHODS, OR FOR ANY DEVIATION FROM THESE PLANS.

PLAN ENGINEERING REMAINS THE PROPERTY OF ROSS LINDEN ENGINEERS PC AND ANY UNAUTHORIZED USE OR DUPLICATION IN WHOLE OR PART IS STRICTLY PROHIBITED.
THESE DRAWINGS ARE OFFERED TO THE
CLIENT FOR A CONDITIONAL ONE TIME USE.
THE CONDITIONAL USE IS LIMITED TO THE
LOT OR PROPERTY AS SPECIFIED HEREIN, AND ONLY FOR THE SAID LOCATION.

STEPHENSON BUILDERS LOT 13 LANE FARMS

PROJECT NO.

R240501

DESIGN BY LLR 28 MAY 2024


DATE REVISION


> **ROOF PLAN** FRAMING

SHEET NO.

OF S5

ROOF PLAN FRAMING SCALE: 1/4" = 1'-0"

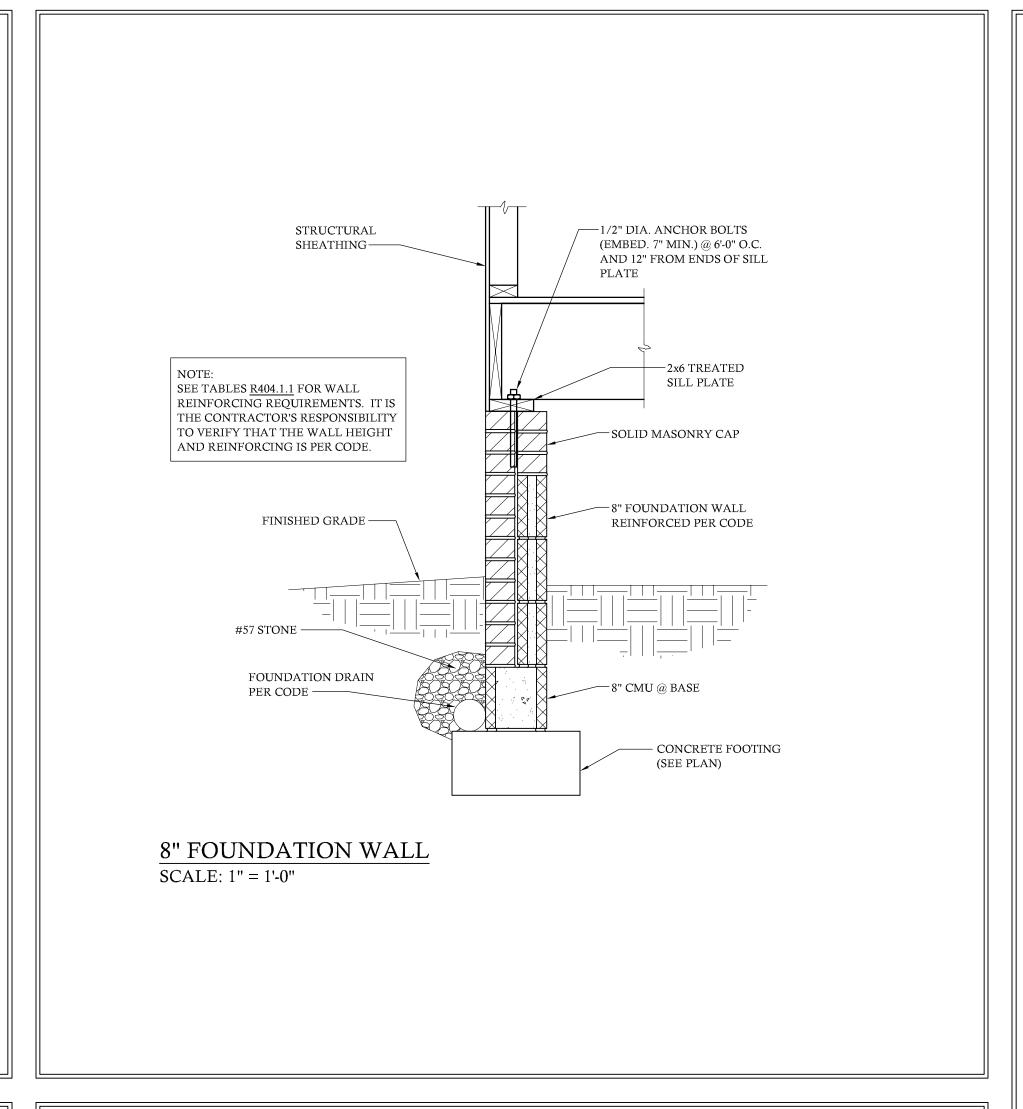

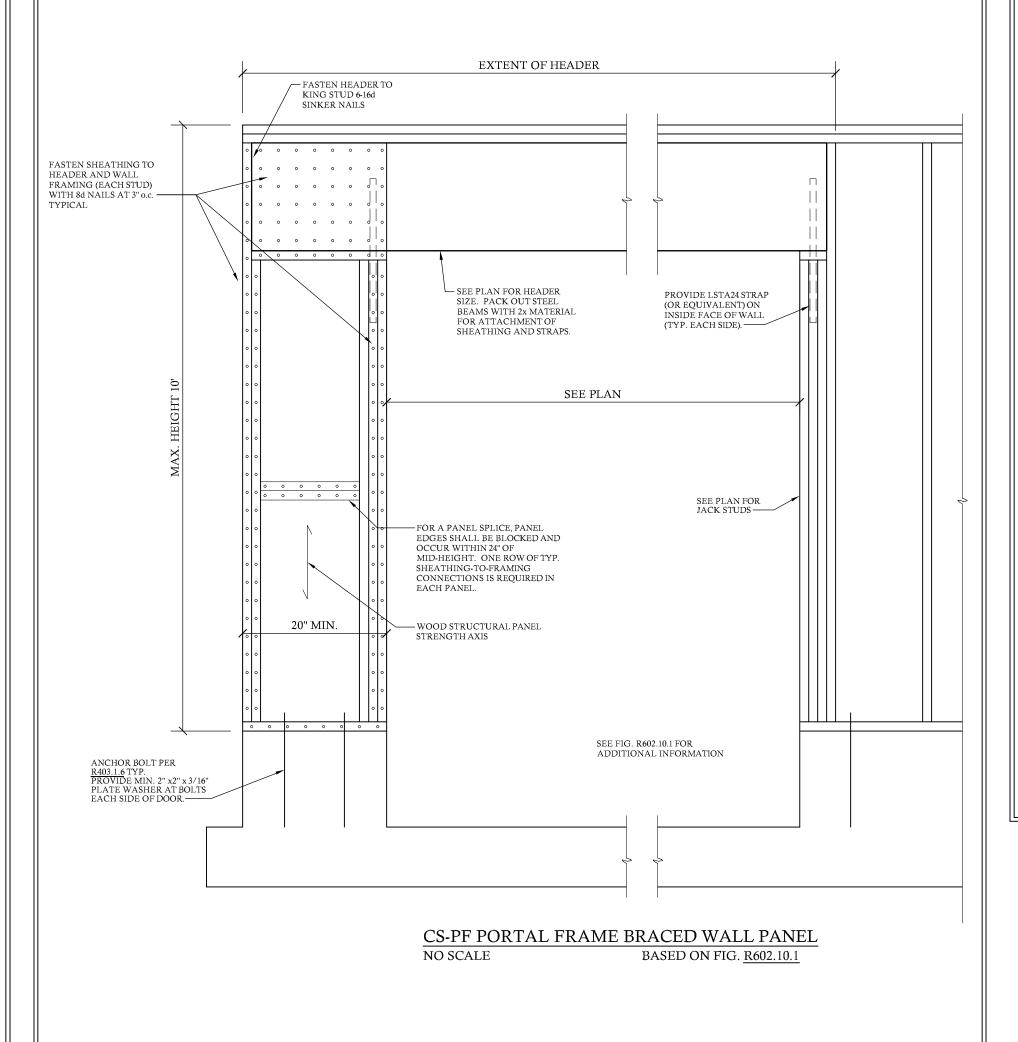

# STRUCTURAL NOTES

### GENER

1. ENGINEER'S SEAL APPLIES TO STRUCTURAL COMPONENTS ONLY AND DOES NOT CERTIFY ARCHITECTURAL LAYOUT OR DIMENSIONAL ACCURACY. ROSS LINDEN ENGINEERS PC ASSUMES NO LIABILITY FOR CHANGES OR MODIFICATIONS MADE TO THESE PLANS BY OTHERS, OR FOR CONSTRUCTION METHODS, OR FOR ANY DEVIATION FROM THE PLANS.

2. ALL CONSTRUCTION, WORKMANSHIP, MATERIAL QUALITY AND SELECTION SHALL BE IN ACCORDANCE WITH THE NORTH CAROLINA STATE BUILDING CODE - RESIDENTIAL CODE 2018 EDITION FROM THE INTERNATIONAL RESIDENTIAL CODE 2015 (IRC), AND LOCAL CODES AND REGULATIONS. DIMENSIONS SHALL GOVERN OVER SCALE AND CODE SHALL GOVERN OVER DIMENSIONS.

3. CONTACT THE ENGINEER PRIOR TO CONSTRUCTION IF ANY DISCREPANCIES ARE NOTED ON THE PLANS.

4. ONLY CURRENT SEALED DRAWINGS ARE TO BE USED FOR CONSTRUCTION.

	LIVE LOAD	DEAD LOAD
TABLE R301.4	(PSF)	(PSF)
DWELLING UNITS	40	10
SLEEPING ROOMS	30	10
ATTICS WITH STORAGE	20	10
ATTICS WITHOUT STORAGE	10	10
ROOF SNOW	20	10
STAIRS	40	10
DECKS	40	10
EXTERIOR BALCONIES	60	10
PASSENGER VEHICLE GARAGES	50	
FIRE ESCAPES	40	10
GUARDRAILS AND HANDRAILS	200	

# ADDITIONAL LOADS

AS FOLLOWS:

TABLE R301.2(4) - BASIC DESIGN WIND SPEED 115 MPH
TABLE R301.2(7) - SEISMIC DESIGN CATEGORY B

TABLE R301.2(6) - DESIGN POSITIVE AND NEGATIVE PRESSURE FOR DOORS AND WINDOW FOR A MEAN ROOF HEIGHT OF 35 FEET OR LESS SHALL BE 25 PSF

TABLE R301.2(2) - COMPONENT AND CLADDING LOADS FOR A BUILDING LOCATED IN EXPOSURE B

ROOF VALUES BOTH POSITIVE AND NEGATIVE SHALL BE DESIGNED BASED ON ROOF PITCHES AND MEAN ROOF HEIGHT

 ROOF PITCH
 0-30 FT
 35 FT
 40 FT

 0:12 TO 2.25:12
 45.4 PSF
 47.7 PSF
 49.5 PSF

 2.25:12 TO 7:12
 34.8 PSF
 36.5 PSF
 37.9 PSF

 7:12 TO 12:12
 21.0 PSF
 22.1 PSF
 22.9 PSF

WALL CLADDING SHALL BE DESIGNED FOR A 24.1 PSF POSITIVE AND NEGATIVE PRESSURE

# MATERIALS

1. FRAMING LUMBER SHALL BE #2 SPRUCE PINE FIR (SPF) OR #2 SOUTHERN YELLOW PINE (SYP) OR BETTER WITH THE FOLLOWING MINIMUM DESIGN PROPERTIES:

Fb = 800 PSI Fv = 135 PSI E = 1.4E6 PSI

2. FRAMING LUMBER EXPOSED TO WEATHER OR IN CONTACT WITH THE GROUND, CONCRETE OR MASONRY SHALL BE #2 SOUTHERN YELLOW PINE (SYP) TREATED IN ACCORDANCE WITH AWPA C22 WITH THE FOLLOWING MINIMUM DESIGN PROPERTIES:  $Fb = 800 \ PSI$   $Fv = 175 \ PSI$   $E = 1.4E6 \ PSI$ 

3. ENGINEERED WOOD BEAMS SHALL BE LAMINATED VENEER LUMBER (LVL) OR PARALLEL STRAND LUMBER (PSL) WITH THE FOLLOWING MINIMUM DESIGN PROPERTIES:

Fb = 2600 PSI Fv = 285 PSI E = 1.9E6 PSI

THE FOLLOWING PRODUCTS MEET OR EXCEED THE ABOVE SPECIFICATIONS AND MAY BE USED AT THE LOCATION INDICATED ON THE PLANS:

BROADSPAN 1.9E-2750Fb LVL BY GEORGIA PACIFIC iLEVEL TRUS JOIST 1.9E MICROLLAM LVL BY WEYERHAUSER

4. STRUCTURAL STEEL WIDE FLANGE BEAMS SHALL CONFORM TO ASTM A992 OR A572, GRADE 50. ALL OTHER STRUCTURAL STEEL SHALL CONFORM TO ASTM A36.

5. BOLTS SHALL CONFORM TO A325 MINIMUM GRADE.

6. REBAR SHALL BE DEFORMED STEEL CONFORMING TO ASTM A615 GRADE 60.

7. SEE <u>TABLE R602.3(1)</u> FOR STRUCTURAL MEMBER FASTENING REQUIREMENTS.

8. POURED CONCRETE SHALL HAVE A MINIMUM SPECIFIED COMPRESSIVE STRENGTH OF 3000 PSI AT 28 DAYS. MATERIALS USED TO PRODUCE CONCRETE SHALL COMPLY WITH THE APPLICABLE STANDARDS LISTED IN ACI 318 OR ASTM C 1157.

9. CONCRETE LOCATED PER <u>TABLE R402.2</u> SHALL BE AIR ENTRAINED WITH THE TOTAL AIR CONTENT NOT LESS THAN 5 PERCENT OR MORE THAN 7 PERCENT.

10. MASONRY UNITS SHALL CONFORM TO ACI 530/ASCE 5/TMS 402 AND MORTAR SHALL COMPLY WITH ASTM C 270.

## CONSTRUCTION

1. STEEL BEAMS SHALL BE SUPPORTED AT EACH END WITH A MINIMUM BEARING LENGTH OF 3 1/2" AND FULL FLANGE WIDTH. BEAMS MUST BE ANCHORED AT EACH END WITH A MINIMUM OF FOUR 16d NAILS OR TWO 1/2" x 4" LAG SCREWS.

2. ENGINEERED WOOD BEAMS SHALL BE INSTALLED WITH ALL CONNECTIONS PER MANUFACTURER'S INSTRUCTIONS.

3. ALL BEAMS SHALL BE CONTINUOUSLY SUPPORTED LATERALLY AND SHALL BEAR FULL WIDTH ON THE SUPPORTING WALLS OR COLUMNS INDICATED WITH A MINIMUM OF THREE STUDS.

4. SOLID BLOCKING SHALL BE PROVIDED AT ALL POINT LOADS TO TRANSFER LOADS THROUGH FLOOR LEVELS. COLUMNS SHALL BE CONTINUOUS TO THE FOUNDATION OR TO OTHER STRUCTURAL ELEMENTS.

5. ENGINEERED WOOD FLOOR SYSTEMS AND ROOF TRUSS SYSTEMS SHALL BE PROVIDED FOR REVIEW AND COORDINATED WITH THE ENGINEER OF RECORD. INSTALLATION SHALL BE IN ACCORDANCE WITH THE MANUFACTURER'S INSTRUCTIONS. ROOF TRUSS DRAWINGS SHALL BE SIGNED AND SEALED BY THE MANUFACTURER AND REVIEWED BY THE ENGINEER OF RECORD PRIOR TO CONSTRUCTION.

6. WALL BRACING REQUIREMENTS SHALL BE IN ACCORDANCE WITH SECTION R602.10 OF THE NORTH CAROLINA RESIDENTIAL

A. EXTERIOR WALLS ARE ASSUMED TO BE BRACED WALL LINES.
ADDITIONAL INTERIOR WALLS MAY ALSO BE USED AS
BRACED WALL LINES WHERE APPLICABLE. SEE PLAN FOR
LOCATIONS.

B. THE EXTERIOR OF THE STRUCTURE SHALL BE CONTINUOUSLY SHEATHED WITH 1/2" WOOD STRUCTURAL SHEATHING (PLYWOOD OR OSB) PER CODE SECTION R602.10.3. EXTERIOR BRACED WALL LINES ARE ASSUMED TO BE BRACED WITH CS-WSP (WOOD STRUCTURAL PANEL) BRACED WALL PANELS. ALTERNATE BRACING METHODS, IF USED, MUST BE INSTALLED IN ACCORDANCE WITH THE APPLICABLE SECTIONS OF THE CODE AND MUST BE REVIEWED BY THE ENGINEER PRIOR TO CONSTRUCTION.

C. INTERIOR BRACED WALL LINES ARE CONSIDERED TO BE BRACED WITH 1/2" GB (GYPSUM BOARD) BRACED WALL PANELS. SEE TABLE R602.10.2 FOR CONNECTION CRITERIA.

D. SEE PLANS FOR SPECIAL WALL BRACING REQUIREMENTS
FOR GARAGE WALLS AND OTHER WALLS WITH MULTIPLE
OR LARGE OPENINGS.

7. STEEL FLITCH BEAMS SHALL BE FASTENED TOGETHER WITH 1/2"
DIAMETER BOLTS WITH WASHERS PLACED UNDER THE

MAXIMUM 24" o.c. STAGGERED TOP AND BOTTOM OF BEAM WITH A MINIMUM 2" EDGE DISTANCE. TWO BOLTS SHALL BE LOCATED AT 6" FROM EACH END OF FLITCH BEAM.

8. BRICK LINTELS SHALL BE 3 1/2 x 3 1/2 x 1/4 STEEL ANGLE FOR UP

TO 6'-0" MAXIMUM SPAN AND 6 x 4 x 5/16 FOR SPANS GREATER

THREADED END OF THE BOLT. BOLTS SHALL BE SPACED AT

9. BRICK LINTELS AT SLOPED AREAS SHALL BE 4 x 3 1/2 x 1/4 STEEL ANGLE WITH 16d NAILS IN 3/16" HOLES IN 4" ANGLE LEG AT 12" o.c. TO TRIPLE RAFTER. WHEN THE SLOPE EXCEEDS 4:12 A MINIMUM OF 3 x 3 x 1/4 PLATES SHALL BE WELDED AT 24" o.c. ALONG THE STEEL ANGLE.

# FOUNDATION

THAN 6'-0".

1. MINIMUM ALLOWABLE SOIL BEARING CAPACITY IS ASSUMED TO BE 2000 PSF. IT IS THE CONTRACTOR'S RESPONSIBILITY TO VERIFY SOIL BEARING CAPACITY.

2. CONCRETE AND MASONRY FOUNDATION WALLS SHALL BE SELECTED AND CONSTRUCTED IN ACCORDANCE WITH THE PROVISIONS OF <u>SECTION R404</u> OR IN ACCORDANCE WITH ACI 318, NCMA TR68-A, OR ACI 530/ASCE 5/TMS 402.

3. MASONRY AND POURED CONCRETE WALL REINFORCEMENT SHALL BE IN ACCORDANCE WITH <u>TABLES R404.1.1 (1 THROUGH 4)</u> OF THE NORTH CAROLINA RESIDENTIAL CODE.

A. PER R404.1.3, TABLES ASSUME THAT WALLS HAVE PERMANENT LATERAL SUPPORT AT THE TOP AND BOTTOM.

B. WALL REINFORCING SHALL BE PLACED ACCORDING TO FOOTNOTE (c) OF THE TABLES (REINFORCING IS NOT

C. FOUNDATION DRAINS ARE ASSUMED AT ALL WALLS PER  $\underline{\text{R405}}$ .

4. WOOD SILL PLATES SHALL BE ANCHORED TO THE FOUNDATION WITH 1/2" ANCHOR BOLTS WITH MINIMUM 7" EMBEDMENT SPACED A MAXIMUM OF 6'-0" o.c. AND WITHIN 12" FROM THE ENDS OF EACH PLATE SECTION.

NOT EXCEED TEN TIMES THEIR LEAST DIMENSION. UNFILLED HOLLOW PIERS MAY BE USED IF THE UNSUPPORTED HEIGHT IS NOT MORE THAN FOUR TIMES THEIR LEAST DIMENSION.

6. CENTERS OF PIERS SHALL BEAR IN THE MIDDLE THIRD OF THE

5. THE UNSUPPORTED HEIGHT OF SOLID MASONRY PIERS SHALL


FOOTINGS, AND GIRDERS SHALL CENTER IN THE MIDDLE THIRD OF THE PIERS.

7. ALL FOOTINGS SHALL HAVE MINIMUM 2" PROJECTION ON EACH


SIDE OF FOUNDATION WALLS.

CENTERED IN WALL).

CONC CONCRETE CONT CONTINUOUS DBL DOUBLE DJ DOUBLE JOIST DSP DOUBLE STUD POCKET EA EACH FL PT FLAT PLATE FTG FOOTING HGR HANGER LVL LAMINATED VENEER LUMBER NTS NOT TO SCALE OC ON CENTER PT PRESSURE TREATED RS RAFTER SUPPORT SC STUD COLUMN SP STUD POCKET TJ TRIPLE JOIST TYP TYPICAL UNO UNLESS NOTED OTHERWISE XJ EXTRA JOIST	ABBREVIATIONS	
DBL DOUBLE DJ DOUBLE JOIST DSP DOUBLE STUD POCKET EA EACH FL PT FLAT PLATE FTG FOOTING HGR HANGER LVL LAMINATED VENEER LUMBER NTS NOT TO SCALE OC ON CENTER PT PRESSURE TREATED RS RAFTER SUPPORT SC STUD COLUMN SP STUD POCKET TJ TRIPLE JOIST TYP TYPICAL UNO UNLESS NOTED OTHERWISE	CONC	CONCRETE
DJ DOUBLE JOIST DSP DOUBLE STUD POCKET EA EACH FL PT FLAT PLATE FTG FOOTING HGR HANGER LVL LAMINATED VENEER LUMBER NTS NOT TO SCALE OC ON CENTER PT PRESSURE TREATED RS RAFTER SUPPORT SC STUD COLUMN SP STUD POCKET TJ TRIPLE JOIST TYP TYPICAL UNO UNLESS NOTED OTHERWISE	CONT	CONTINUOUS
DSP DOUBLE STUD POCKET  EA EACH  FL PT FLAT PLATE  FTG FOOTING  HGR HANGER  LVL LAMINATED VENEER LUMBER  NTS NOT TO SCALE  OC ON CENTER  PT PRESSURE TREATED  RS RAFTER SUPPORT  SC STUD COLUMN  SP STUD POCKET  TJ TRIPLE JOIST  TYP TYPICAL  UNO UNLESS NOTED OTHERWISE	DBL	DOUBLE
EA EACH FL PT FLAT PLATE FTG FOOTING HGR HANGER LVL LAMINATED VENEER LUMBER NTS NOT TO SCALE OC ON CENTER PT PRESSURE TREATED RS RAFTER SUPPORT SC STUD COLUMN SP STUD POCKET TJ TRIPLE JOIST TYP TYPICAL UNO UNLESS NOTED OTHERWISE	DJ	DOUBLE JOIST
FL PT FLAT PLATE FTG FOOTING HGR HANGER LVL LAMINATED VENEER LUMBER NTS NOT TO SCALE OC ON CENTER PT PRESSURE TREATED RS RAFTER SUPPORT SC STUD COLUMN SP STUD POCKET TJ TRIPLE JOIST TYP TYPICAL UNO UNLESS NOTED OTHERWISE	DSP	DOUBLE STUD POCKET
FTG FOOTING HGR HANGER LVL LAMINATED VENEER LUMBER NTS NOT TO SCALE OC ON CENTER PT PRESSURE TREATED RS RAFTER SUPPORT SC STUD COLUMN SP STUD POCKET TJ TRIPLE JOIST TYP TYPICAL UNO UNLESS NOTED OTHERWISE	EA	EACH
HGR HANGER LVL LAMINATED VENEER LUMBER NTS NOT TO SCALE OC ON CENTER PT PRESSURE TREATED RS RAFTER SUPPORT SC STUD COLUMN SP STUD POCKET TJ TRIPLE JOIST TYP TYPICAL UNO UNLESS NOTED OTHERWISE	FL PT	FLAT PLATE
LVL LAMINATED VENEER LUMBER  NTS NOT TO SCALE  OC ON CENTER  PT PRESSURE TREATED  RS RAFTER SUPPORT  SC STUD COLUMN  SP STUD POCKET  TJ TRIPLE JOIST  TYP TYPICAL  UNO UNLESS NOTED OTHERWISE	FTG	FOOTING
NTS NOT TO SCALE OC ON CENTER PT PRESSURE TREATED RS RAFTER SUPPORT SC STUD COLUMN SP STUD POCKET TJ TRIPLE JOIST TYP TYPICAL UNO UNLESS NOTED OTHERWISE	HGR	HANGER
OC ON CENTER PT PRESSURE TREATED RS RAFTER SUPPORT SC STUD COLUMN SP STUD POCKET TJ TRIPLE JOIST TYP TYPICAL UNO UNLESS NOTED OTHERWISE	LVL	LAMINATED VENEER LUMBER
PT PRESSURE TREATED  RS RAFTER SUPPORT  SC STUD COLUMN  SP STUD POCKET  TJ TRIPLE JOIST  TYP TYPICAL  UNO UNLESS NOTED OTHERWISE	NTS	NOT TO SCALE
RS RAFTER SUPPORT SC STUD COLUMN SP STUD POCKET TJ TRIPLE JOIST TYP TYPICAL UNO UNLESS NOTED OTHERWISE	OC	ON CENTER
SC STUD COLUMN  SP STUD POCKET  TJ TRIPLE JOIST  TYP TYPICAL  UNO UNLESS NOTED OTHERWISE	PT	PRESSURE TREATED
SP STUD POCKET  TJ TRIPLE JOIST  TYP TYPICAL  UNO UNLESS NOTED OTHERWISE	RS	RAFTER SUPPORT
TJ TRIPLE JOIST TYP TYPICAL UNO UNLESS NOTED OTHERWISE	SC	STUD COLUMN
TYP TYPICAL UNO UNLESS NOTED OTHERWISE	SP	STUD POCKET
UNO UNLESS NOTED OTHERWISE	TJ	TRIPLE JOIST
	TYP	TYPICAL
XJ EXTRA JOIST	UNO	UNLESS NOTED OTHERWISE
	XJ	EXTRA JOIST

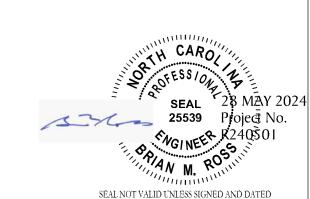

LOT 13 LANE FARMS ONLY

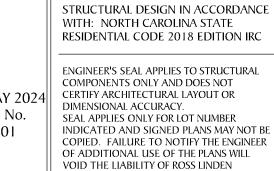

ENGINEERS PC.



709 W. JONES STREET RALEIGH, NC 27603 TEL 919.832.5680 FAX 919.832.5675 WWW.ROSSLINDEN.COM

> ROSS LINDEN ENGINEERSPC

ROSS LINDEN ENGINEERS PC ASSUMES NO LIABILITY FOR CHANGES OR MODIFICATIONS MADE TO THESE PLANS BY OTHERS, OR FOR CONSTRUCTION METHODS, OR FOR ANY DEVIATION FROM THESE PLANS.

PLAN ENGINEERING REMAINS THE PROPERTY OF ROSS LINDEN ENGINEERS PC AND ANY UNAUTHORIZED USE OR DUPLICATION IN WHOLE OR PART IS STRICTLY PROHIBITED. THESE DRAWINGS ARE OFFERED TO THE CLIENT FOR A CONDITIONAL ONE TIME USE. THE CONDITIONAL USE IS LIMITED TO THE LOT OR PROPERTY AS SPECIFIED HEREIN, AND ONLY FOR THE SAID LOCATION.

STEPHENSON BUILDER

PROJECT NO.

R24050

R240501

DESIGN BY LLR 28 MAY 2024

REVISION DATE

- - 
- - 
- - -

STRUCTURAL NOTES & DETAILS

SHEET NO.

S5

OF S5