COLLEX599InventoryMarkedPlan

SOUTHPORT

SOUTHPORT **REVISION LIST - STRUCTURAL:**

- COMBINED WILMINGTON AND WILMINGTON II PLANS. (2-18)
- ADDED BRICK OPTION ON SECOND FLOOR. (2-18)
- CALLED OUT SERIES/SPACING OF HOISTS ON BASEMENT. (2:18)
- 2018 NCRC UPDATE (6:19)
- 2018 SC IRC (2-15-20)
- ADDED ELEVATION A.2 (BRICK WATERTABLE W/ SIDING ABOVE). & ELEVATION A.3 (STONE WATERTABLE W/ SIDING ABOVE). (2-15-20)

SOUTHPORT **REVISION LIST - ARCHITECTURAL:**

- CREATED ELEVATIONS TO BE IN STANDARDS WITH OTHER PLANS (SEE SHEETS A-1 THROUGH A-3.5)
- CHANGED COLUMNS ON ELEVATIONS TO STANDARD COLUMNS
- CHANGED GARAGE DOORS TO REPRESENT STANDARD GARAGE DOOR FOR EACH ELEVATION
- FIXED COVERED PORCH TO KEEP COLUMNS FROM OVERLAPPING EDGE OF CONCRETE
- REMOVED GRIDS FROM TRANSOMS ABOVE FRONT DOOR
- ADDED NOTE FOR GARAGE DOOR "GARAGE DOOR PER SPECIFICATIONS AND GLASS INSERT (TOP PANEL ONLY)"
- MOVED ROOF PLANS TO SHEETS A-8 & A-8.1
- CREATED SLAB INTERFACE PLAN (SEE SHEET A-4 THROUGH A-4.2)
- MOVED ALL OPTIONS OFF BASE PLAN AND PLACED ON SEPARATE SHEET
- ADDED NOTE FOR FILISH COUNTERTOR ON ISLAND
- CHANGED PATTO SIZE TO STANDARD 12'X10
- ADDED OPTIONAL GAS LINE
- 13.
- ADDED 2ND HOSE BIB
- CALLED OUT '45' WALL WITH CAP' AS STANDARD
- CHANGED ALL EXTERIOR WALLS FROM 2X6 TO 2X4 EXCEPT WHERE SHADED
- ADDED NOTE 'OPT REF.'
- REMOVED NUMBERS ON STAIRS
- ADDED NOTE 'WASHER ALWAYS TO BE LOCATED TO THE LEFT OF DRYER
- VERIFIED VENTILATION AND LIGHT REQUIREMENTS AT OWNER'S BEDROOM MEETS CODE (11-01-20)
- SOUARE FOOTAGES ARE UPDATED AND CHANGED DUE TO MOVEMENT OF WALLS FROM 2X6 TO 2X, TO KEEP IOGS IN ROOMS, EXTERIOR WALL MOVED MEANING ROOF LINES HAVE CHANGED
- SQUARE FOOTAGE OF COVERED PORCH CHANGED DUE TO KEEPING COLUMNS FROM OVERLAPPING CONCRETE EDGE
- CREATED PARTIAL PLANS FOR B & C ELEVATIONS (FLOOR, SLAB, & ELECTRICAL)
- REMOVED ALL WALL OUTLETS
- REMOVED ALL PHONE OUTLETS
- REMOVED ALL TV OUTLETS
- PLACED STANDARD 3 BULB LIGHT IN KITCHEN
- VERIFIED COACH LIGHT LOCATIONS (SEE ELEVS. FOR DIMS.)
- PLACED DASHED FANS WHERE APPLICABLE WITH NOTE "STD. LIGHT, OPT. FAN/LT PREWIRE"
- UPDATED ELECTRICAL KEY
- VERIFIED CO2 DETECTOR LOCATIONS
- SHOWED PENDANT LIGHTS AS OPTIONAL
- SHOWED CAN LIGHTS IN KITCHEN AND FAMILY ROOM AS 'OPTIONAL CAN LIGHTS'
- PLACED OPTIONAL FLOOD LIGHTS
- PLACED OPTIONAL FLOOR OUTLET IN FAMILY ROOM
- PLACED CALCULATIONS FOR SOFFIT AND RIDGE VENT REQUIREMENTS
- UPDATED STAIR LAYOUT TO KEEP MAIN WALL AT KITCHEN FROM MOVING WHEN OPTIONAL BASEMENT SELECTED



COVER SHEET


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ATE: SEPTEMBER 16,

DRAWN BY:





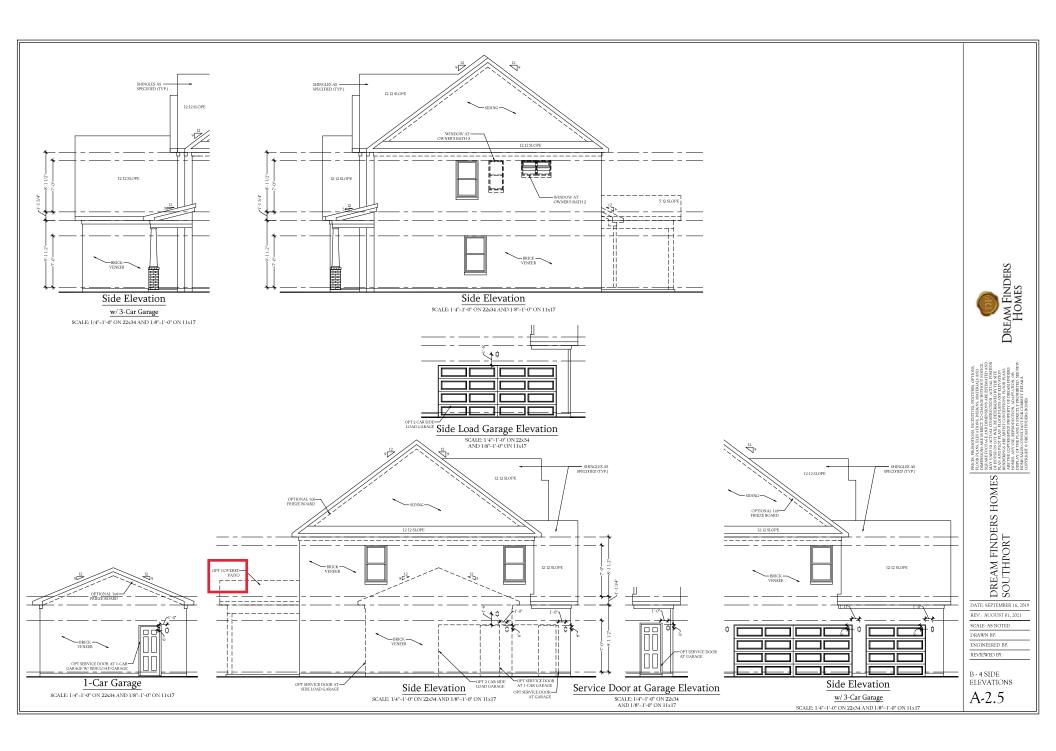

Dream Finders Homes

DREAM FINDERS HOMES SOUTHPORT


DATE: SEPTEMBER 16, 2019 REV:: AUGUST 01, 2021


SCALE: 1/4"-1'0" DRAWN BY:


ENGINEERED BY: REVIEWED BY:

SLAB INTERFACE PLAN

A-4

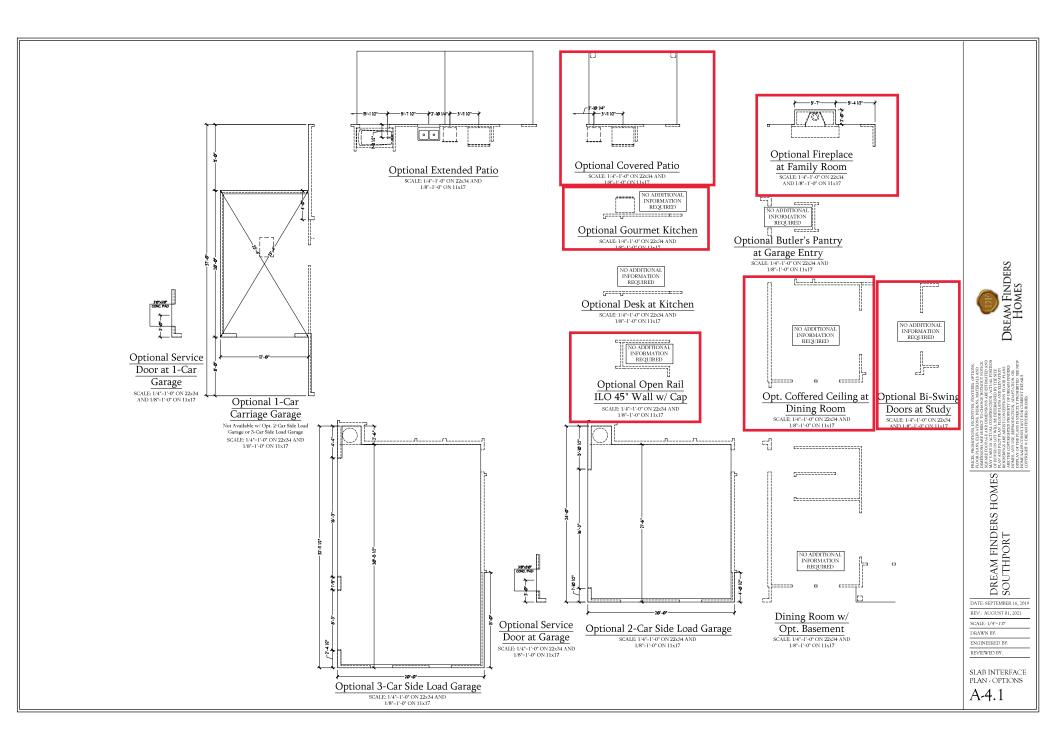

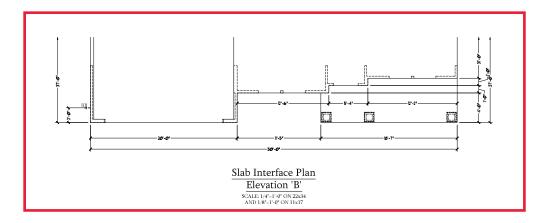

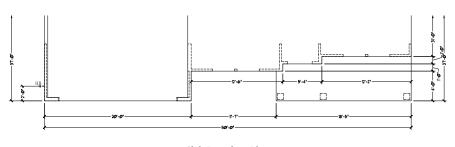

Slab Interface Plan
Elevation 'C'
SCALE: 1/4"-1"-0" ON 22x34
AND 1/8"-1"-0" ON 11x17

Dream Finders Homes

DREAM FINDERS HOMES SOUTHPORT


DATE: SEPTEMBER 16, 2019 REV.: AUGUST 01, 2021


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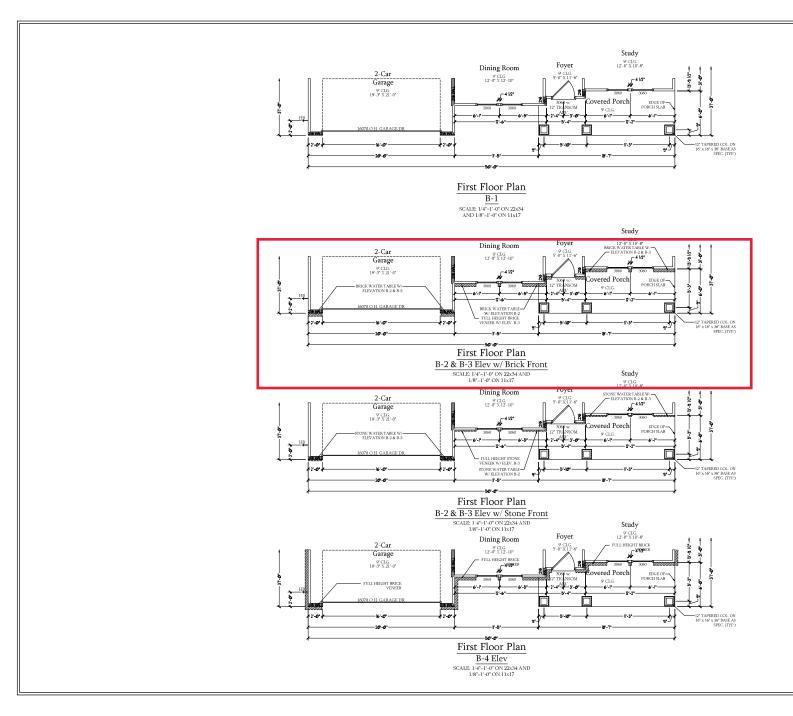
DRAWN BY: ENGINEERED BY: REVIEWED BY:

SLAB INTERFACE PARTIAL PLANS

A-4.2



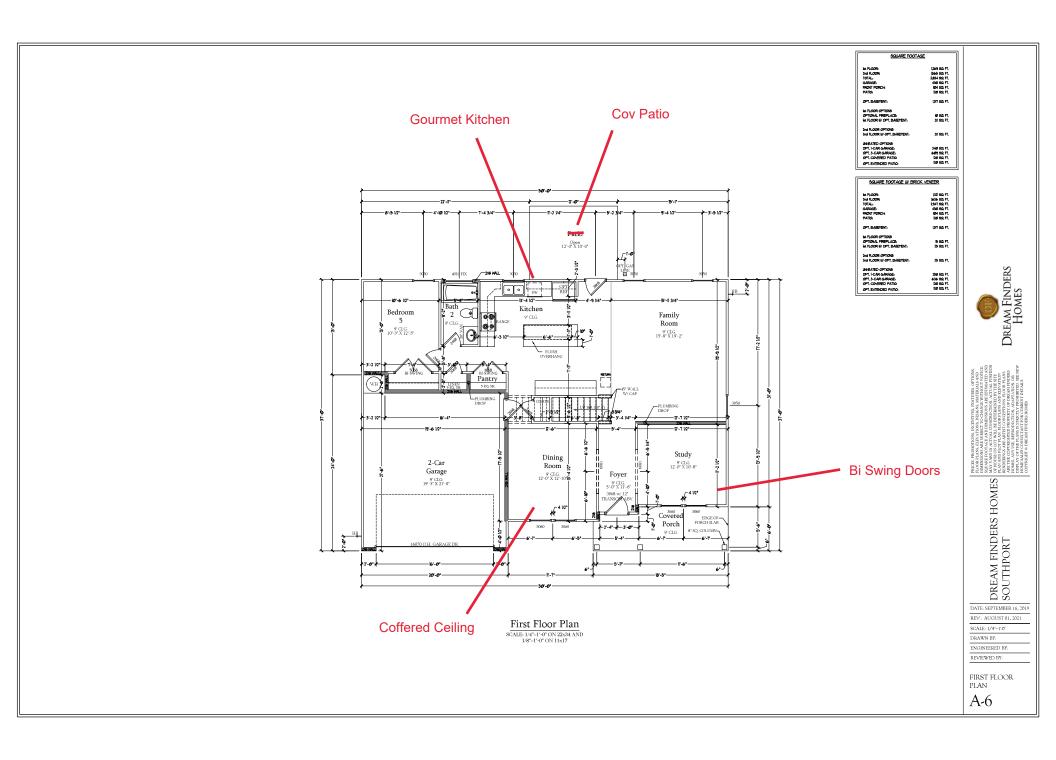

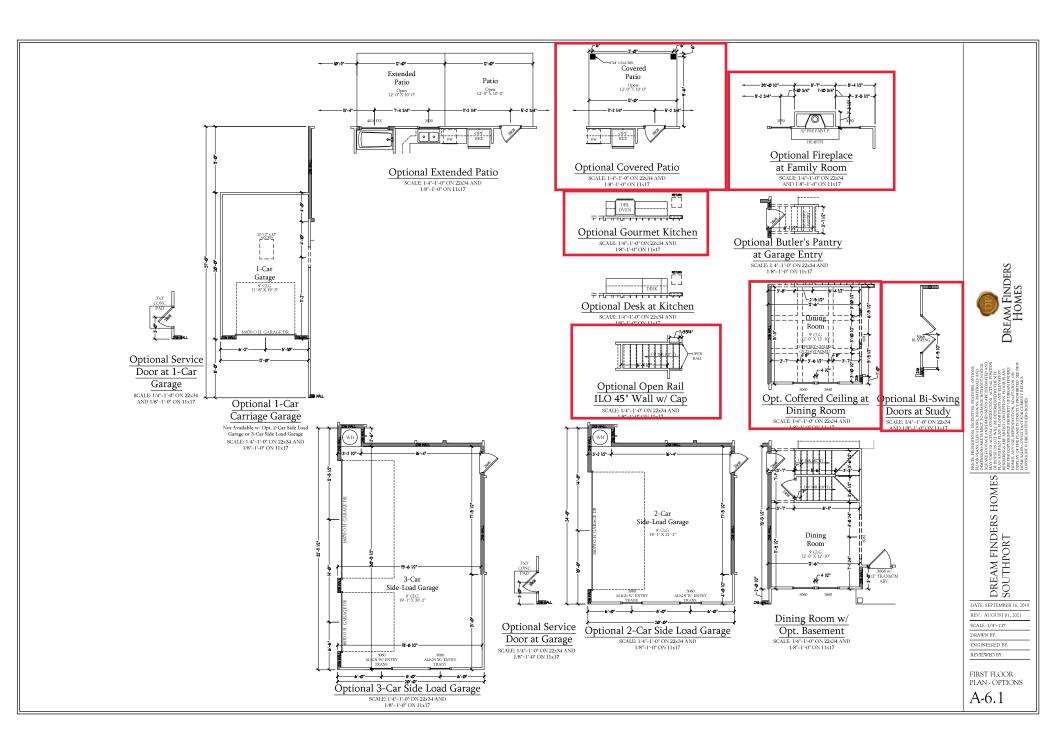



INCOME AND CONTROLLED RETURNS OF THOSE AND CONTROLLED RETURNS OF THE AND CONTROLLED RETURNS OF THE AND CONTROLLED ROOM OF THE AND

DREAM FINDERS HOMES ROW SOUTHPORT

DATE: SEPTEMBER 16, 2019 REV.: AUGUST 01, 2021


SCALE: 1/4"-1"0"


DRAWN BY: ENGINEERED BY:

REVIEWED BY: B ELEVATION

FIRST FLOOR PARTIAL PLANS

A-6.3

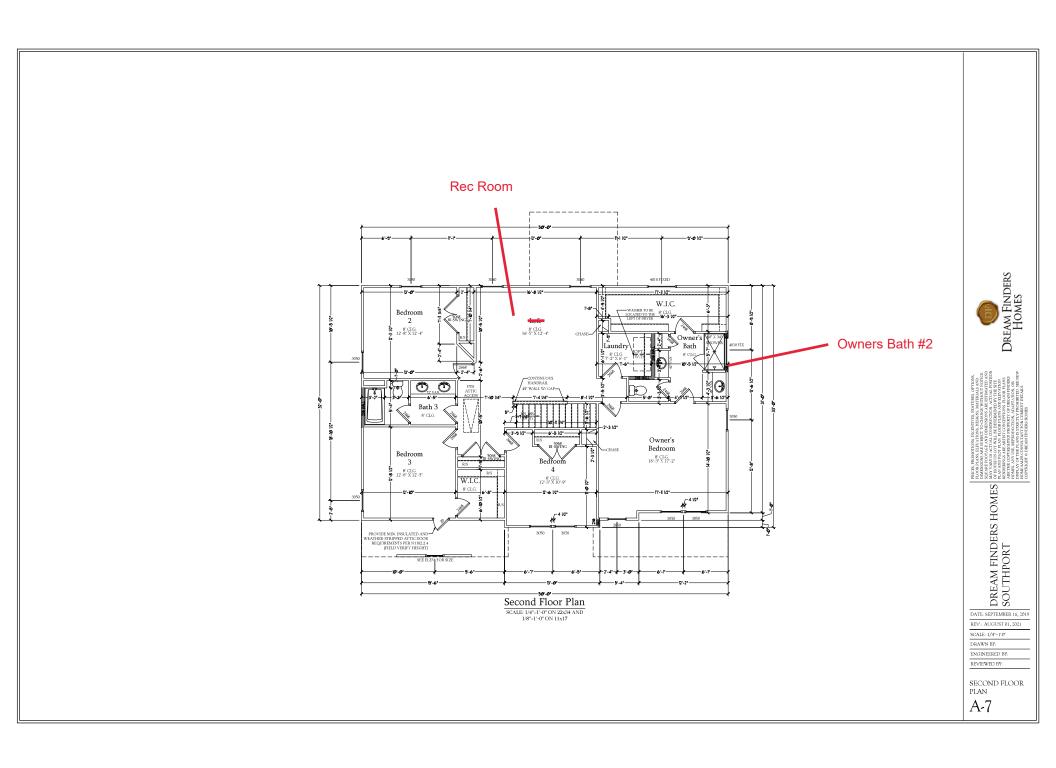

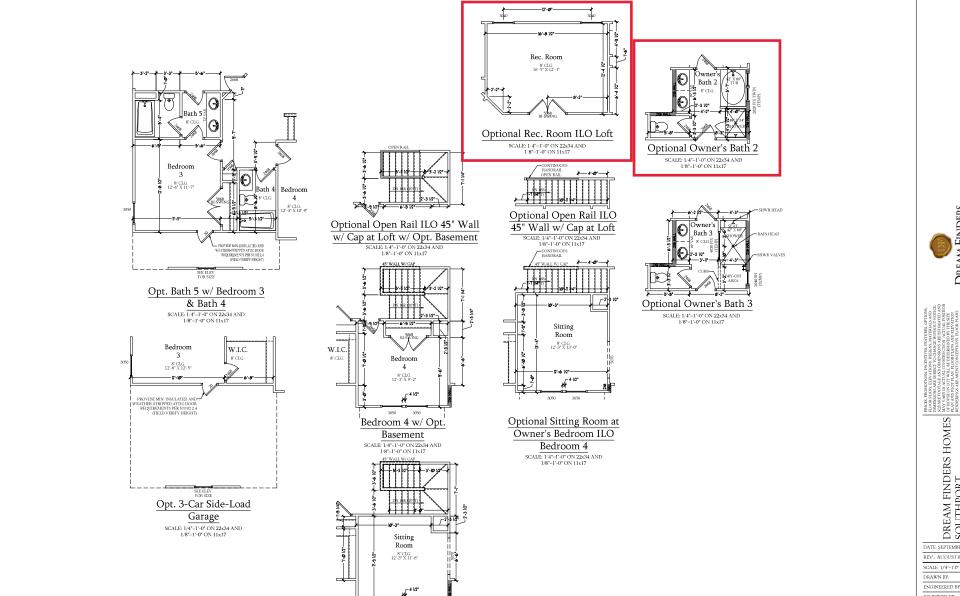

Optional Sitting Room at Owner's

Bedroom ILO Bedroom 4 w/ Opt Basement

SCALE: 1/4"-1'-0" ON 22x34 AND 1/8"=1'-0" ON 11x17

Dream Finders Homes

PRICES, PROMO
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DREAM FINDERS HOMES SOUTHPORT

DATE: SEPTEMBER 16, 2019

REV.: AUGUST 01, 2021


DRAWN BY:

ENGINEERED BY:

REVIEWED BY:

SECOND FLOOR PLAN - OPTIONS

A-7.1

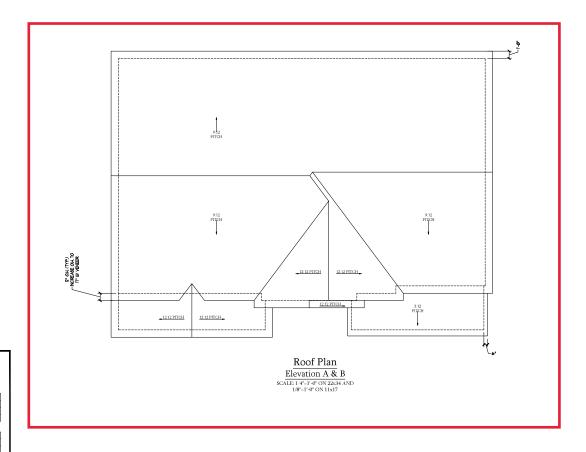

TOTAL UNDER ROOF AREA: $\frac{1600}{LOWER:} \underbrace{\frac{1600}{2.66}}_{\text{LOWER:}} \underbrace{\frac{1600}{5.33}}_{\text{UPPER:}} \underbrace{\frac{1600}{2.66}}_{\text{UPPER:}} \underbrace{\frac{1600}{2.66}}_{\text{UPPER:}} \underbrace{\frac{1600}{5.33}}_{\text{UPPER:}}$ VENTING AREA REQUIRED: TOTAL REQUIREMENTS: LOWER AREA VENTING SOFFIT VENT LOWER AREA VENTING PROVIDED: UPPER AREA VENTING
RIDGE VENT PER UNIT: # UNITS: PROVIDED: .125 SF/LF 49'-0" 6.125 UPPER AREA VENTING PROVIDED:

TOTAL AREA PROVIDED
SOFFIT AND RIDGE VENT

10.162

Dream Finders Homes

PRICES, PROMOTIONS, ILLOY, PRICES, PROMOTIONS, ILLOY, PROMESSION ARE SUBJECTED AND AND TOTAL OF HOUSE ON LOT WILL OF HOUSE AND PLOY PLAN, RENDERINGS ARE AFTER COPPARIED TO MENTAL AND THE PLAN, POMES, AND USE, REPROMESS, AND USE, REPROMESS, AND USE REPROMES, AND USE REPROMESS, AND USE REPROMESS. AND USE AND THE CONSTITUTION OF THE PLANS HOMES AND TH

DREAM FINDERS HOMES SOUTHPORT

DATE: SEPTEMBER 16, 2019

REV.: AUGUST 01, 2021 SCALE: 1/4"-1'40"


DRAWN BY:

ENGINEERED BY:

REVIEWED BY:

ELEVATIONS A & B ROOF PLAN

A-8

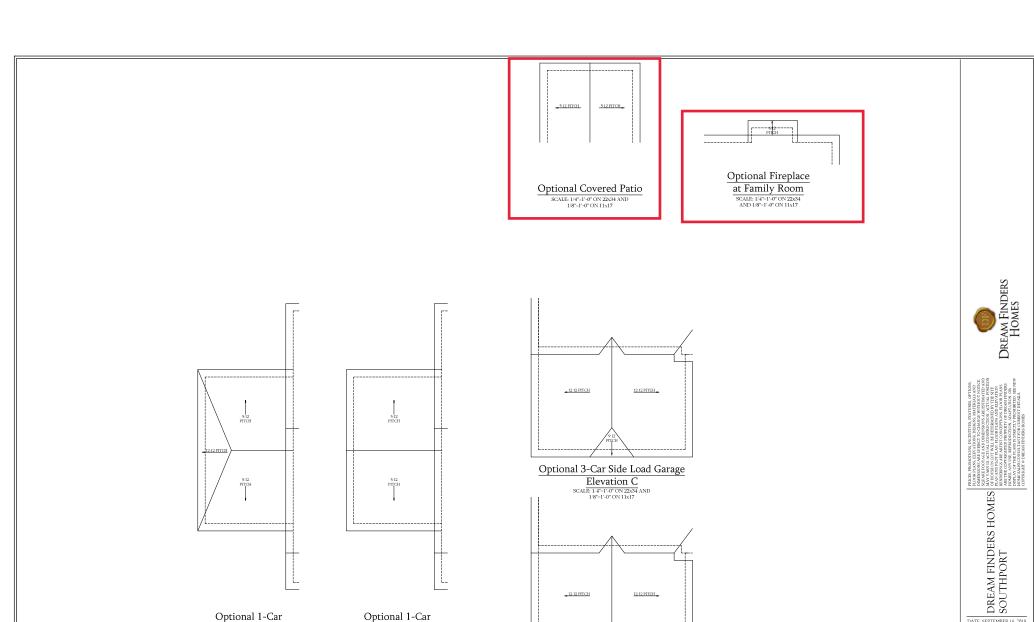

Optional 3-Car Side Load Garage

Elevation A & B SCALE: 1/4"-1"-0" ON 22x34 AND 1/8"=1"-0" ON 11x17

Carriage Garage

Elevation A & B

Not Available w/ Opt. 2-Car Side Load Garage or 3-Car Side Load Garage SCALE: 1/4"=1'-0" ON 22x34 AND 1/8"=1'-0" ON 11x17

Carriage Garage

Elevation C


Not Available w/ Opt. 2-Car Side Load Garage or 3-Car Side Load Garage SCALE: 1.4"=1"-0" ON 22x34 AND 1.78"=1"-0" ON 11x17 DATE: SEPTEMBER 16, 2019 REV.: AUGUST 01, 2021


SCALE: 1/4"-1'0" DRAWN BY:


ENGINEERED BY: REVIEWED BY:

ROOF PLAN OPTIONS

A-8.2

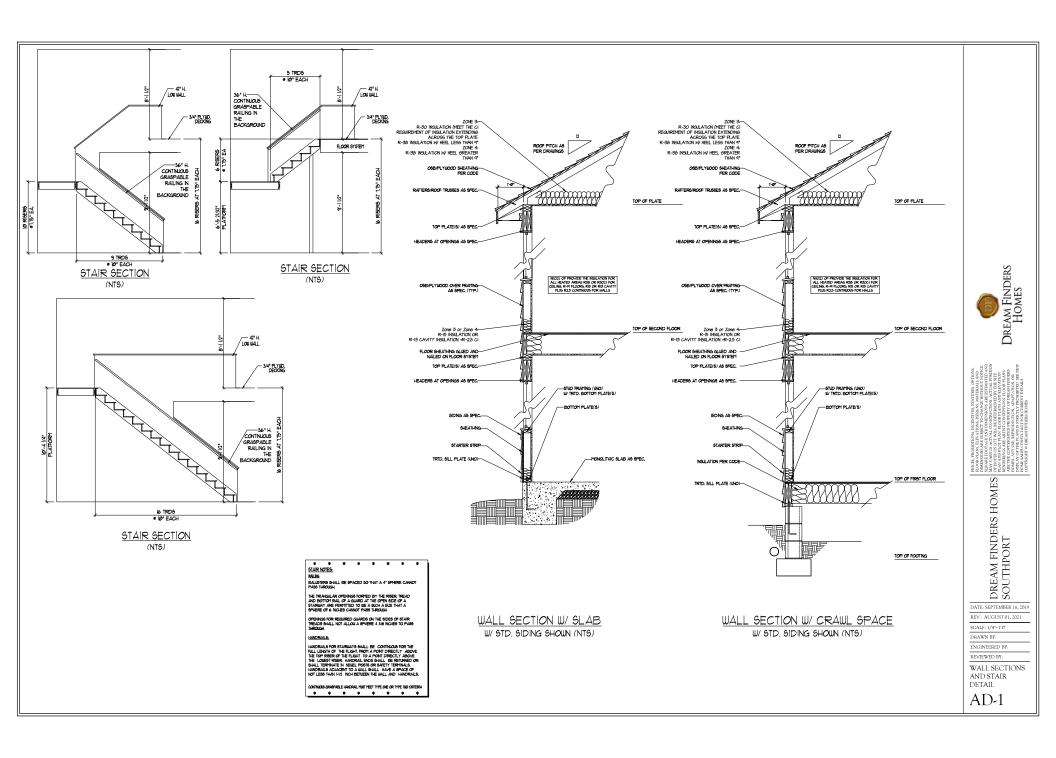

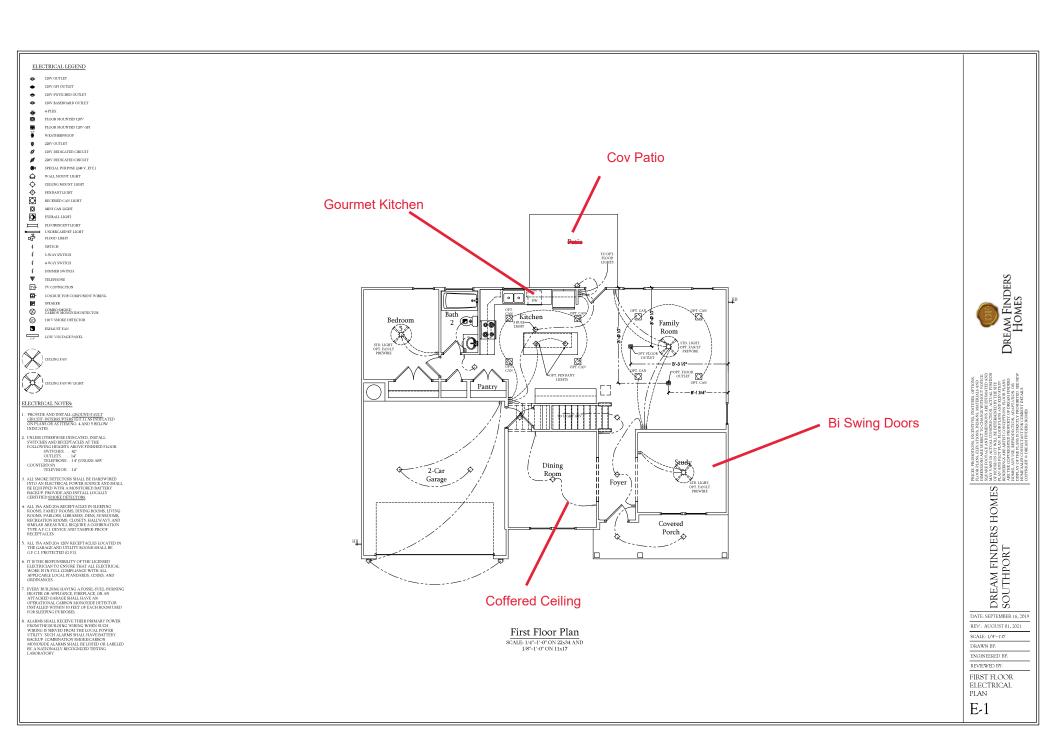

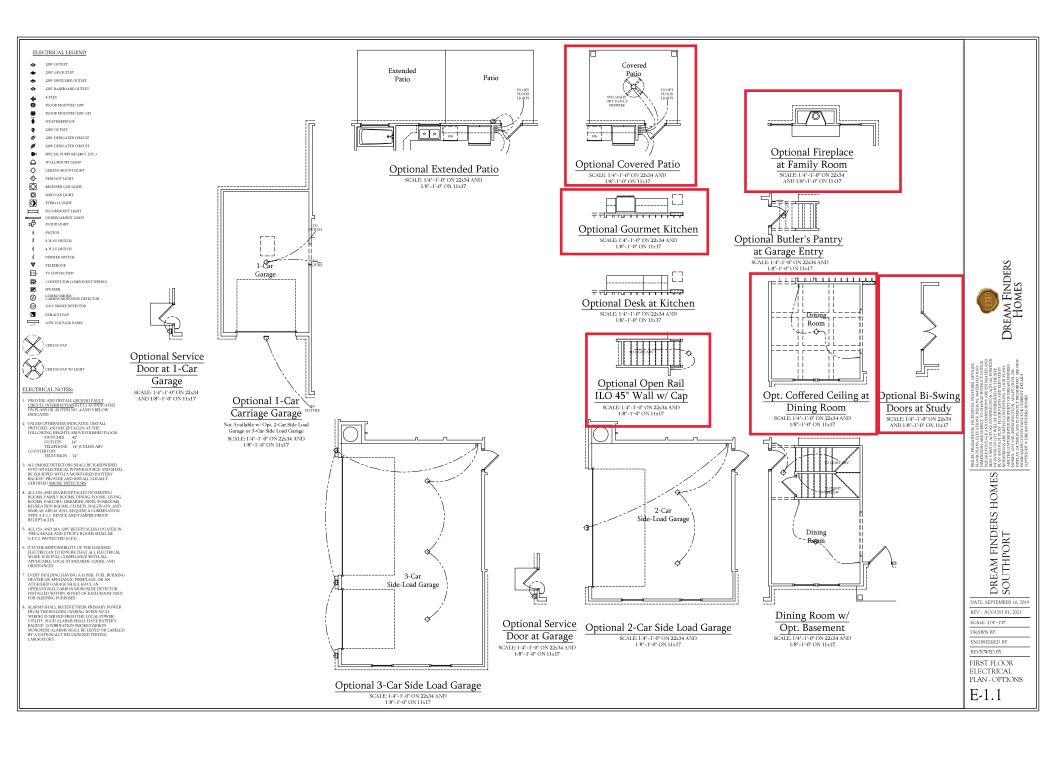

120V GFI OUTLET

120V BASEBOARD OUTLET

4-PLEX

FLOOR MOUNTED 120V

FLOOR MOUNTED 120V GFI

120V DEDICATED CIRCUIT 220V DEDICATED CIRCUIT

SPECIAL PURPOSE (240 V, ETC.)

WALL MOUNT LIGHT CEILING MOUNT LIGHT

PENDANT LIGHT

RECESSED CAN LIGHT

Ø **⊙** MINI CAN LIGHT

EVERALL LIGHT

FLUORESCENT LIGHT \equiv

UNDERCABINET LIGHT
FLOOD LIGHT

SWITCH 3-WAY SWITCH

4-WAY SWITCH

DIMMER SWITCH

TELEPHONE

TV CONNECTION

-CONDUIT FOR COMPONENT WIRING SPEAKER

Ø COMBO SMOKE: CARBON MONOXIDE DETECTOR

110 V SMOKE DETECTOR



ELECTRICAL NOTES:

PROVIDE AND INSTALL GROUND FAULT CIRCUIT-INTERRUPTERS [G.F.L] AS INDICATED ON PLANS OR AS ITEM NO. 4 AND 5 BELOW INDICATES.

UNLESS OTHERWISE INDICATED, INSTALL
SWITCHES AND RECEPTACLES AT THE
FOLLOWING HEIGHTS ABOVE FINISHED FLOORSWITCHES ... 42*
OUTLETS ... 14*
COUNTY LIEEPHONE ... 14* (UNLESS ABV

COUNTERTOP)
TELEVISION . . . 14"

ALL SMOKE DETECTORS SHALL BE HARDWIRED INTO AN ELECTRICAL POWER SOURCE AND SHALL BE EQUIPPED WITH A MONITORED BATTERY BACKUP PROVIDE AND INSTALL LOCALLY CERTIFIED SMOKE DETECTORS.


ALL 15A AND 20A RECEPTACLES IN SLEEPING ROOMS, FAMILY ROOMS, DINING ROOMS, LIVING ROOMS, FAMILY ROOMS, DINING ROOMS, LIVING ROOMS, PECREATION ROOMS, CLOSETS, HALLWAYS, AND SIMILAR RAEAS WILL REQUIRE A COMBINATION TYPE AF GL DEVICE AND TAMPER-PROOF RECEPTACLES.


ALL 15A AND 20A 120V RECEPTACLES LOCATED IN THE GARAGE AND UTILITY ROOMS SHALL BE G.F.C.I. PROTECTED (G.F.I).

IT IS THE RESPONSIBILITY OF THE LICENSED ELECTRICIAN TO ENSURE THAT ALL ELECTRICAL WORK IS IN FULL COMPILANCE WITH ALL APPLICABLE LOCAL STANDARDS, CODES, AND ORDINANCES.

EVERY BUILDING HAVING A FOSSIL-FUEL-BURNING HEATER OR APPLIANCE. FIREPLACE, OR AN ATTACKED GARAGE SHALL HAVE AN OPERATIONAL CARBON MONOXIDE DETECTOR INSTALLED WITHIN 10 FEET OF EACH ROOM USED FOR SLEEPING PURPOSES.

ALARMS SIALL RECEIVE THEIR PRIMARY POWER FROM THE BILLIDING WIRING WHEN SICH WIRING IS SEND THE BILLIDING WIRING WHEN SICH WIRING IS SENDED FROM THE LOCAL POWER UTILITY. SUCH ALARMS SHALL HAVE BATTERY BACKLEP COMBINATION SMOKECK, CARBON MONOXIDE ALARMS SHALL BE LISTED OR LABELED BY A NATIONALLY RECOGNIZED TESTING LABORATORY.

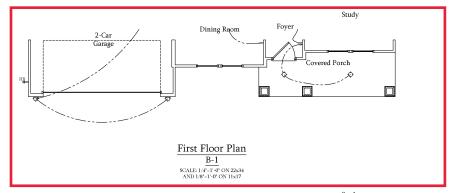

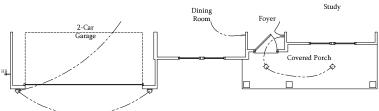

First Floor Plan C-1

SCALE: 1/4"-1'-0" ON 22x34 AND 1/8"-1'-0" ON 11x17

Dream Finders Homes

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DREAM FINDERS HOMES SOUTHPORT

DATE: SEPTEMBER 16, 2019 REV.: AUGUST 01, 2021


SCALE: 1/4"-1'-0"

DRAWN BY:

ENGINEERED BY-REVIEWED BY:

FIRST FLOOR ELECTRICAL PARTIAL PLANS

E-1.2

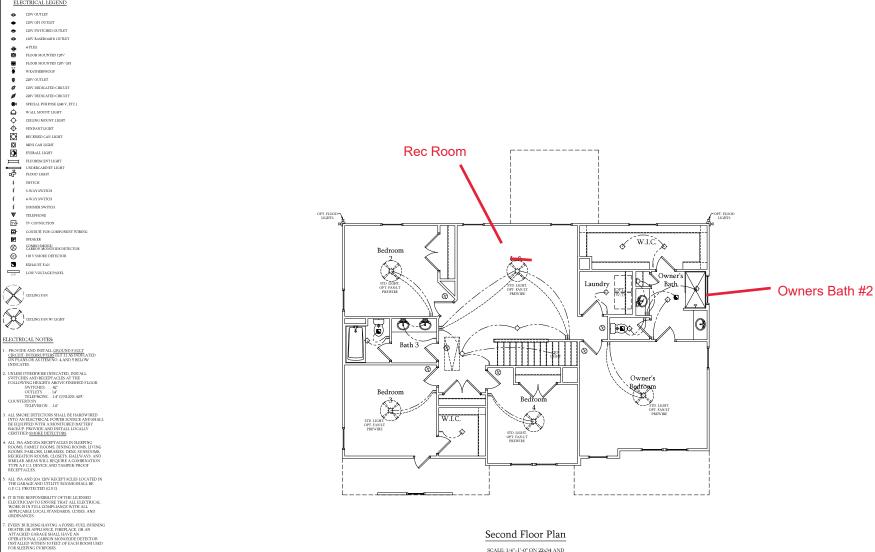

SCALE: 1/4"=1'-0" ON 22x34 AND 1/8"-1'-0" ON 11x17

DREAM FINDERS HOMES SOUTHPORT

PRICES, PROMOTONS, ELECAR PLANS, AND ELECAR PLANS, ELECAR PL

Dream Finders Homes

DATE: SEPTEMBER 16, 2019 REV.: AUGUST 01, 2021

SCALE: 1/4"-1'-0"

DRAWN BY:

ENGINEERED BY-REVIEWED BY:

SECOND FLOOR ELECTRICAL PLAN

E-2

ELECTRICAL LEGEND

ALARMS SHALL RECEIVE THEIR PRIMARY POWER FROM THE BILLDING WIRING WHEN SUCH WIRING IS SHOULD FROM THE BILLDING WIRING WHEN SUCH WIRING IS SHOULD FROM THE LOCAL POWER UTILITY. SUCH ALARMS SHALL HAVE BRITTERY BACKLEP COMBINATION SMOKECK, ARBON MONOXIDE ALARMS SHALL BE LISTED OR LABELED BY A NATIONALLY RECOGNIZED TESTING LABORATORY.

120V GFI OUTLET

4-PLEX

FLOOR MOUNTED 120

FLOOR MOUNTED 128V GFI

220V OUTLET

SPECIAL PURPOSE (240 V, ETC.)

WALL MOUNT LIGHT

CEILING MOUNT LIGHT

PENDANT LIGHT

ф О

Ø

EVERALL LIGHT

FLUORESCENT LIGHT \equiv

烃 UNDERCABINET LIGHT

FLOOD LIGHT SWITCH

3-WAY SWITCH

4-WAY SWITCH DIMMER SWITCH

₽-CONDUIT FOR COME

SPEAKER

Ø COMBO SMOKE/ CARBON MONOXIDE DETECTOR

110 V SMOKE DETECTOR

EXHAUST FAN



ELECTRICAL NOTES:

PROVIDE AND INSTALL GROUND FAULT GROUNT-INTERRUPTERS (G.F.1) AS INDICATED ON PLANS OR AS ITEM NO. 4 AND 5 BELOW INDICATES.

UNLESS OTHERWISE INDICATED, INSTALL
SWITCHES AND RECEPTACLES AT THE
FOLLOWING HEIGHTS ABOVE FINISHED FLOORSWITCHES ... 42*
OUTLETS ... 14*
COUNTY LIEEPHONE ... 14* (UNLESS ABV

COUNTERTOP) TELEVISION...14"

ALL SMOKE DETECTORS SHALL BE HARDWIRED INTO AN ELECTRICAL POWER SOURCE AND SHALL BE DQUIPPED WITH A MONITORED BATTERY BACKUP PROVIDE AND INSTALL LOCALLY CERTIFIED SMOKE DETECTORS.


ALL 15A AND 20A RECEPTACLES IN SLEEPING ROOMS, FAMILY ROOMS, DINING ROOMS, LIVING ROOMS, DINING ROOMS, LIVING ROOMS, DENS, SUNROOMS, RECREATION ROOMS, CLOSETS, HALLWAYS, AND SIMILAR RAEAS WILL REQUIRE A GOMBINATION TYPE A F.C.I. DEVICE AND TAMPER-PROOF RECEPTACLES.

G.F.C.I. PROTECTED (G.F.I).

IT IS THE RESPONSIBILITY OF THE LICENSED ELECTRICIAN TO ENSURE THAT ALL ELECTRICAL WORK IS IN FULL COMPLIANCE WITH ALL APPLICABLE LOCAL STANDARDS, CODES, AND ORDINANCES.


EVERY BUILDING HAVING A FOSSIL-FUEL-BURNING HEATER OR APPLIANCE, FIREPLACE, OR AN ATTACHED CARAGE SHALL HAVE AN OPERATIONAL CARBON MONOXIDE DETECTOR INSTALLED WITHIN 16 FEET OF EACH ROOM USED FOR SLEEPING TURPOSES.

ALARMS SHALL RECEIVE THEIR PRIMARY POWER FROM THE BUILDING WHENS WHEN SUCH WIRING SESSEVED FROM THE LOCAL POWER UTILITY. SUCH ALARMS SHALL HAVE BATTERY BACKUP. COMMINATION SMOKEABON MOXOMIE ALARMS SHALL BE LISTED OR LABELED BLANK ALLY RECONSIDED TESTING. LABORATORY

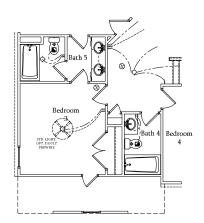

Opt. Bath 5 w/ Bedroom 3 & Bath 4


SCALE: 1/4"=1'-0" ON 22x34 AND 1/8"=1'-0" ON 11x17

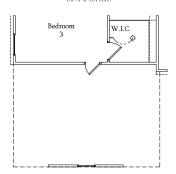


Opt. 3-Car Side-Load

Garage

SCALE: 1/4*=1'-0* ON 22x34 AND 1/8*-1'-0* ON 11x17

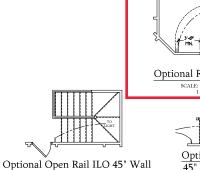

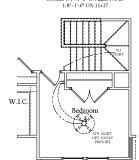


w/ Cap at Loft w/ Opt. Basement

SCALE: 1/4"=1'-0" ON 22x34 AND

Bedroom 4 w/ Opt.

Basement SCALE: 1/4"=1'-0" ON 22x34 AND

1/8"=1'-0" ON 11x17

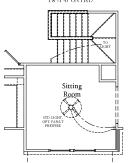


Optional Sitting Room at Owner's Bedroom ILO Bedroom 4 w/ Opt Basement

SCALE: 1/4"-1'-0" ON 22x34 AND 1/8"=1'-0" ON 11x17






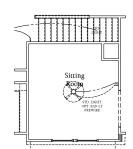

Optional Sitting Room at Owner's Bedroom ILO Bedroom 4

SCALE: 1/4"=1"-0" ON 22x34 AND 1/8"-1"-0" ON 11x17



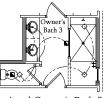

Optional Owner's Bath 3

SCALE: 1/4"=1'-0" ON 22x34 AND 1/8"=1'-0" ON 11x17

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Dream Finders Homes

DREAM FINDERS HOMES SOUTHPORT

DATE: SEPTEMBER 16, 2019


REV.: AUGUST 01, 2021 SCALE: 1/4"-1'-0"

DRAWN BY: ENGINEERED BY-

REVIEWED BY: SECOND FLOOR

ELECTRICAL PLAN - OPTIONS

E-2.1

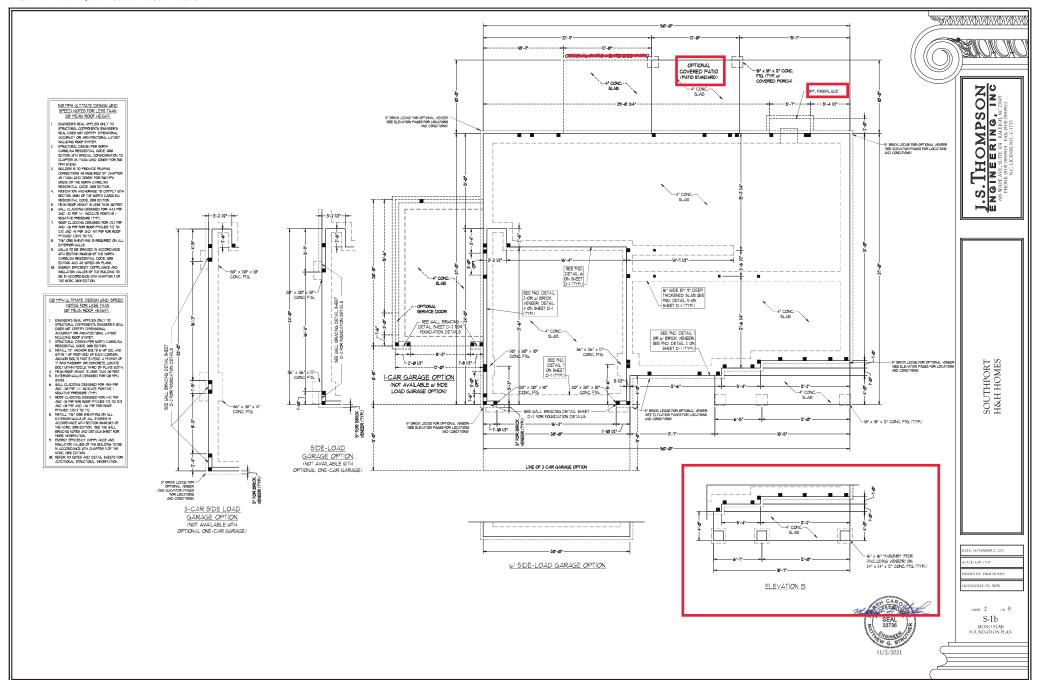

LINTEL SCHEDULE FOR BRICKNATURAL STONE SUPPORT		
LBNGTH (FT.)	SIZE OF LINTEL	
UP TO 4 FT.	L 3 1/2 x 3 1/2 x 1/4	
4-8	L 5 x 3 l/2 x 5/l6 LLV	

BRICK SUPPORT NOTES:

- 8 AND GREATER L 6 x 4 x 5/16 LLV

- SICK_SHOOKI NOTIES.

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NOTE:

BCI 4500s-18 JOISTS MAY BE USED IN LIEU OF TJI 10 JOISTS AT THE DEPTH AND SPACING NOTED ON THE PLAN.

BRACED WALL DESIGN NOTES:

- REACED UNIL DESIGN NOTES.

 1 BRACED UNIL DESIGN FER SECTION RISKUP OF THE NORC 200 BUTTON.
 200 BUTTON.

NOTE:


- I. FER SECTION REGULAGE OF THE 1008 NORC, THE AHOUNT OF BRACKIN REQUIRED ON THE MUKE OUT BASEFORT MULLS DUCEDED THE AHOUNT OF BRACKING ON THE MULL ADOVE THE THE ED BY A FACTOR OF 18. SHEARTH ALL DETROOK MULLS WITH TWO OBS SHEATHING ATTACHED WITH 80 VAILS AT 6" OC. ALONG PANEL EDGES AND 2" OC. IN THE FELD.

STRUCTURAL NOTES:

- ALL RAZING LIPERT TO BE 7 SPF (LNO). ALL
 TREATED LIPERS TO BE 7 S SPF (LNO)
 AND ALL AND ETRACE ALOSI NUDER MILLS PARALLEL. TO
 FLOOR, 2005 MERRE MOTEO ON THE PLANS, MILLS
 AND ALL AND ETRACE ALOSI NO BE FLANS, MILLS
 AND ALL AND ETRACE ALOSI NO BE FLANS, MILLS
 ALOKE SPR (LNO) TO REACHED TO BE FLANS, MILLS
 ALOKE SPR (LNO) TO REACHED ALL AND SHALL SOLD
 ELOCKING TO GROSE OR FOLKACIÓN, MIPPORT
 UNISTECTIBO PT. LOCOS ALONG RIVITED MILLS (T)
 UNISTECTIBO PT. LOCOS ALONG RIVITED MILLS (T)
 ALL LOCOS BERNAN HADERS TO BE (3.7 % 10 (NO))

TABLE R602.15 MINIMUM NUMBER OF RULL HEIGHT STUDS AT EACH END OF HEADERS IN EXTERIOR WALLS

HEADER SPAN	MAXIMUM STUD SPACING (INCHES) (PER TABLE RE6023(5)	
(FEEI)	16	24
UP TO 31	1	- 1
4'	2	1
8'	3	2
12"	5	3
16"	6	4

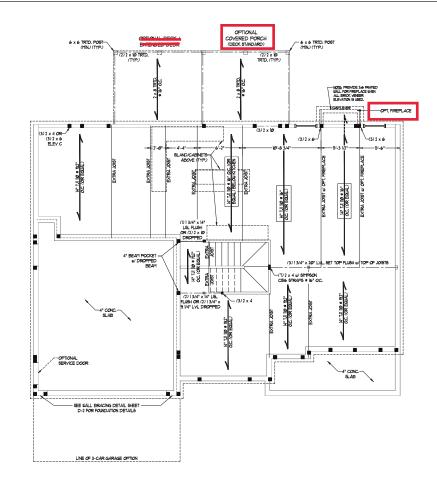

SON LINCZIGOS J.S. THOMPS ENGINEERING,

SOUTHPORT H&H HOMES

DATE: NOVEMBER 2, 2021

NGINEERED BY: WFB

S-2 FIRST FLOOR FRAMING PLAN



BRACED WALL DESIGN NOTES: SACED MALL DEBOM NOTES. PRIACED MALL DEBOM NEW SECTION REGULD OF THE NICKO 2005 EDITION. SOUTH RETERNS TO CONTINUOUS SECRITING. SOUTH COLUMN THE STATEMENT OF CONTINUOUS SECRITING. SOUTH COLUMN THE STATEMENT OF CONTINUOUS SECTION TO THE STATEMENT OF COLUMN THE SECRITING THE STATEMENT OF THE SECRITING THE SECRITING

BRACED WALL DESIGN RECTANGLE B

RECTANGLE A TOTAL REQUIRED LENGTH: 15 TOTAL PROVIDED LENGTH: IT& SIDE 2A
HETHOD: CS-USP
TOTAL REQUIRED LENGTH: IS'
TOTAL PROVIDED LENGTH: 206'

TOTAL REQUIRED LENGTH: 2.85' TOTAL PROVIDED LENGTH: 6'

SIDE IB METHOD: PF/CS-USP

(4) 2 x 4 OR

(3)2×6

(2) 2 x 10 CONT. DINING ROOM w/ OPTIONAL BASEMENT

*NOTE: ALL EXTERIOR WALLS AND ATTIC WALLS ARE TO BE 2 x 6 @ 16" O.C. (UNO), 2 x 4 @ 16" O.C. EXTERIOR WALLS MAY BE CONSTRUCTED IN LIEU OF 2 x 6 WALLS (UNO), ALL INTERIOR LOAD BEARING WALLS ARE TO BE 2 x 4 @ 16" O.C. (UNO) AND NON-LOAD 2 x 4 @ 24" O.C. (UNO).

LINTEL SCHEDULE FOR BRICK-NATURAL STONE SUPPORT		
LENGTH (FT.)	SIZE OF LINTEL	
UP TO 4 FT.	L 3 1/2 x 3 1/2 x 1/4	
4-8	L 5 x 3 l/2 x 5/l6 LLV	
8 AND GREATER	L 6 x 4 x 5/16 LLV	
BRICK SUPPORT NOTES:		

LINTEL SCHEDULE APPLIES TO ALL

- LINTEL SCHEDULE APPLIES TO ALL
 OPENNAGE IN BECK VENERR (IND. SEE
 ARCH DUBG, FOR SIZE AND LOCATION OF
 OPENNAG.
 (LLIV) LOVAL LEG VERTICAL
 LEWIGHT CLEAR OPENNAG
 EYNED ALL ANGLE IROXA PIN 4" EACH
 SDEE NIO VENERR TO PROVIDE BEARING.
 FOR ALL HEADERS 8-0" AND GREATER
 IN LEWISH, ATTOM STEEL ANGLE
 IN LEWISH, ATTOM
 IN LIVE ANGLE ANGLE
 IN LIVE ANGLE
- HEADER WITH LAS SCREWS 6°TO CG.
 FOR ALL ENCLOSING TO SOME LINES,
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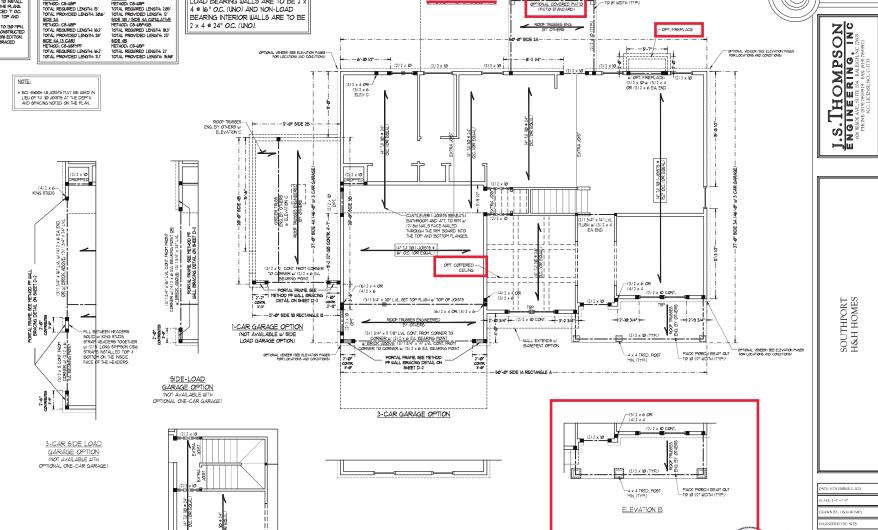
STRUCTURAL NOTES:

- ALL FRAMING LUMBER TO BE 6FF 12 (UNO), ALL TREATED LIMBER TO BE 5YP 12 (UNO.)
 ALL LOAD BEARING HEADERS TO BE (2) 2 x 6
- UNDOW AND DOOR HEADERS TO BE
- LINDOU AND DOOR HEADERS TO BE SIMPOPHED WIT JUSC SIDD AND (I) KINS SIDD AND DISTORTING SIDD AND DISTORTING
- FOR HIGH WIND ZONES, SECURE ALL EXTERIOR WILL SHEATING PANELS FOR DOUBLE TOP PLATES, BLANDS, JOISTS, AND GIRDERS WITH (2) ROUS OF 88 ANLES STAGESTED AT 3" OC. PANELS SHALL EXTEND 2" BEYOND CONSTRUCTION JOINTS AND SHALL OVERLAP GIRDERS AND DOUBLE BILL PLATES THER FULL
- ALL 4 x 4 POSTS SHALL BE ANCHORED TO
- ALL 4 x 4 POSTS SHALL BE ANCIONED TO SALBB WITH STORY ALBERT FOR THE SALB FOR THE S
- ADDITIONAL STRUCTURAL INFORMATION

"TSP" INDICATES TRIPLE STUD POCKET BETWEEN WINDOW UNITS.

TABLE R602.7.5
MINIMUM NUMBER OF FULL HEIGHT STUDS
EACH END OF HEADERS IN EXTERIOR WA

AT EACH END OF READERS IN EXTENSIVE WALLS			
HEADER SPAN	MAXIMUM STUD SPACING (INCHES) (PER TABLE R647.3(5)		
(FEE)	16	24	
UP TO 31	1		
4'	2	1	
8'	3	2	
121	5	3	
161	6	4	



4 x 4 TRTD, P06T-MIN, (TYP)

SEAL 33736

S-3 SECOND FLOOR FRAMING PLAN

BRACED WALL DESIGN NOTES:

NOTE:

- FER SECTION R60/10/31 OF THE 20/8 NCRC, THE AYOMT OF BRACKING ON THE SECOND FLOOR EXCEEDS THE AYOMT SEQUIRED FOR THE FRIST FLOOR AND DISPACED WILL ANALYSIS IS REQUIRED. SHALLS SITH THE OSS SHEATHING SHEATH ALL THEORY WILLS SITH THE OSS SHEATHING AND THE FIELD.

LINTEL SCHEDULE FOR BRICK/NATURAL STONE SUPPORT	
LENGTH (FT.)	SIZE OF LINTEL
UP TO 4 FT.	L 3 1/2 x 3 1/2 x 1/4
4-8	L 5 x 3 1/2 x 5/16 LLV
8 AND GREATER	L 6 x 4 x 5/16 LLV

BRICK SUPPORT NOTES:

- ROCS DIFFORT NOTION

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STRUCTURAL NOTES:

- STRUCTURAL NOTICE

 ALL REPORTS (1998 TO 98 987 F (100)

 ALL TRANSITURERS TO 98 P (

"TSP" NDICATES TRIPLE STUD POCKET BETWEEN WINDOW UNITS.


TABLE R602.15
MINIMUM NUMBER OF FULL HEIGHT STUDS

	AT EACH END	A HEADEND IN E	VIEWOK WATER	
	HEADER SPAN (REET)	MAXIMUM STUD SPACING (INCHES) (PER TABLE R6/03.3/5)		
		16	24	
	UP 10 31	1	1	
	4'	2	1	
	8'	3	2	
	12'	5	3	
	16	6	4	

AT OWNER'S BEDROOM

OPTIONAL SITTING ROOM AT OWNER'S BEDROOM (WITH

OPTIONAL BASEMENT)

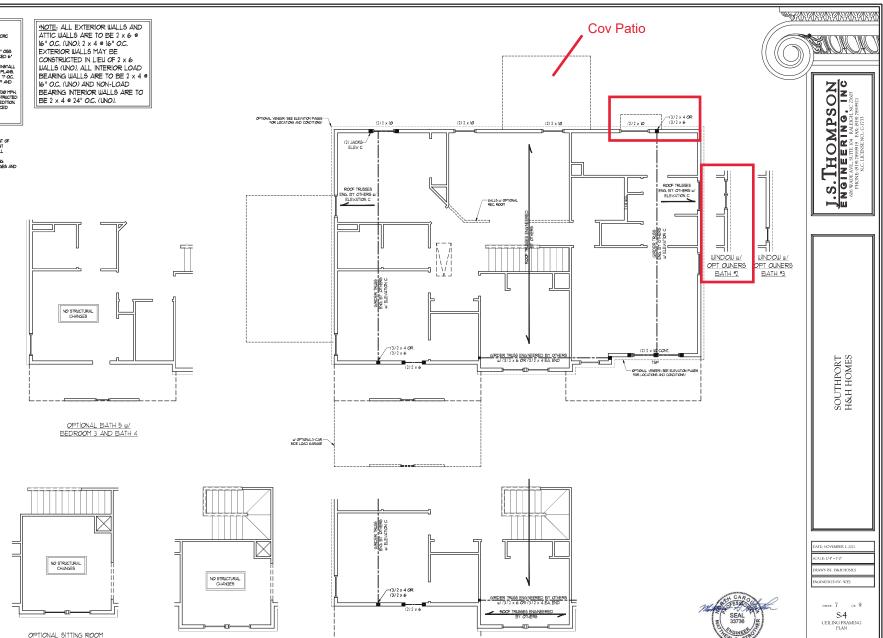

BEDROOM #4

(WITH OPTIONAL BASEMENT)

BRICK SUPPORT NOTE:

PRICE SOFTWAY NOTE:

1. MASTER (2) 2 19 ELOCOMA BETHER MALL
51LDS 41 (4) 10 MMLS FER F1. F4.5FS. M.
51LDS 41 (4) 10 MMLS FER F1. F4.5FS. M.
51LDS 41 (4) 10 MMLS FER F1. F4.5FS. M.
51LDS 41 (4) MMLS F1. MALE 17 (2) 2 19
61LDC 51LDS 41 (4) MMLS F1. MALE 17 (2) 2 19
61LDC 51LDS 41 (4) MMLS 41 (4) MMLS 41 (4)
61LDS 41 (4) MMLS 41 (4) MMLS 41 (4)
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61LDS 41 (4) MMLS 41 (4) MMLS 41 (4)

STRUCTURAL NOTES:

STRUCTURAL NOTES:

ALL ROWING LUPBER TO DE *7

SET (MO). TOPIC 10 12 x 9 POSTS


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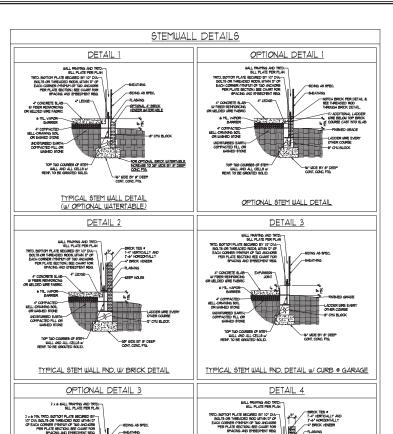
OF (MO). TOPIC 10 12 x 9 POSTS

OF (MO). TOPIC 10 12 x 9 POSTS

NEW EDORS HER TO BE SPACED.

NEW EDORS HER TOPIC 10 TOP



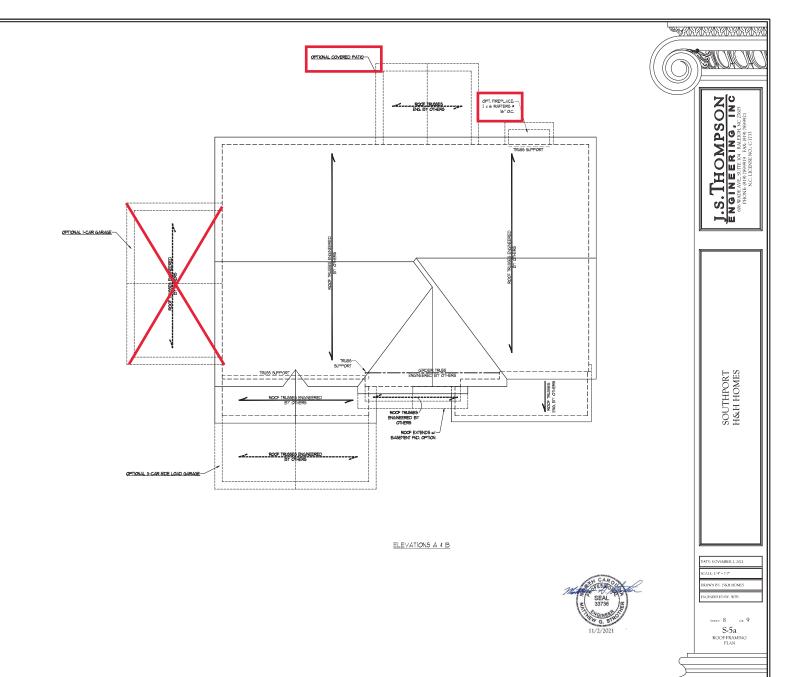

6 ML VAPOR-BARRER

NSIDE EDGE OF MASONRY STEMUALL

PRICK MARCHEY -

OUTSIDE EDGE OF BRICK AND STICK FRAMED WALL ABOVE-

TYPICAL STEM WALL FND, DETAIL W/ BRICK

AND CURB @ GARAGE DETAIL 8


THREADED ROD THROUGH BRICK MASONRY

1/2" ANCHOR ROD

4" COMPACTED-WELL-DRANING SOIL OR WASHED STONE

6 ML VAPOR BARRIER

OPTIONAL STEM WALL FND. DETAIL W/ CURB @ GARAGE

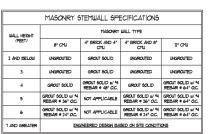

STRUCTURAL NOTES:

- I. MALL HEIGHT MEASURED PROT FOR PRODUCTS TO FOR ITS MALL.

 2. THE MALTINE STRINGS TOGETHER WITH LOCKING AT MY OCC. MERTICALLY.

 3. THE MALTINE STRINGS TOGETHER WITH LOCKING AT MY OCC. MERTICALLY.

 5. THE MALTINE STRINGS THE MALL AND ALL TO COLUMN TO THE MALL.

 5. DALOCALL OF LOCAL MY TO THE MALL OF STRICE STALL DEVIALENT FOR THE MALL OF TH

	ANCHOR SPACING AND	EMBEDMENT
WIND ZONE 120 MPH		13Ø MPH
6PACING	6'-Ø" O.C.	4'-0" O.C.
EMBEDMENT 1'		5" INTO MASONRY T [®] INTO CONCRETE

GINEERED BY: JES

D-1 FOUNDATION DETAILS



NON CONTRACTOR S OMPS ERING. 工口 S. TE

WIND SPEED MPH ULTIMATE DESIGN FOUNDATION DETAILS 1301 20


DATE: NOVEMBER 14, 2018


BRACED WALL NOTES AND DETAILS AND PF DETAIL

GENERAL WALL BRACING NOTES:

- WILL BRACING DESIGNED IN ACCORDANCE WITH CHAPTER 6 OF THE 1008 NC RESIDENTIAL BUILDING CODE (NCRC.)
 TABLES AND FRANCES REFERNICED AND RINGTH CHAPTER 6 OF THE 1008 NCRC. FOR ADDITIONAL INFORMATION AS NEEDED.
 SEE HIS SEET FOR CREATED WILL LOCATIONS DITEISMONS, ROLD DOWN THE AND LOCATIONS REVIEW WITH THE RESIDENCE WILL LOCATION BRACED WILL INFORM THE RESIDENCE TO THE RESIDENCE OF THE RESIDENCE OF
- ALL EXTERIOR WALLS ARE TO BE SHEATHED WITH CS-WSP IN ACCORDANCE WITH SECTION REGIZIOZ UNLESS NOTED


- A LESTEROR BULLS ARE TO BE SHARHED WITH G-MERN IN ACCORDINGE BITH SECTION RISKINDS NAMES NOTIFE TO SEE PLANTING BY A LESTEROR BOY BY A LESTEROR BY A DIVISION RELIAND. SECTION RISKINDS AND RESPONDED TO SEE PLANTING DESCRIPTION RELIAND. SECTION RELIAND RISKINDS AND RELIAND RELIAND RELIAND RELIAND RISKINDS AND RESERVE AND RESIDENCE AND RESIDENCE

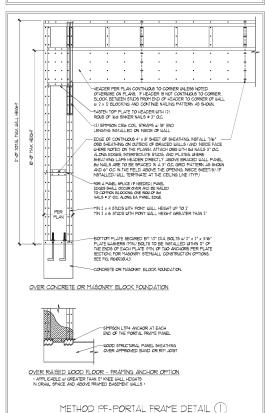

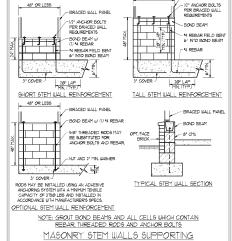


48" OR LESS

- BRACED WALL PANEL

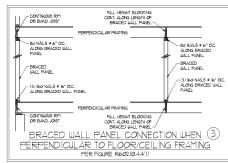



BRACED WALL PANELS (2)


PER FIGURE R602.10.4.3

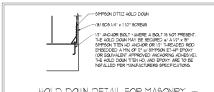

HOLD DOWN DETAIL FOR MASONRY FOUNDATION OR MONOLITHIC SLAB · APPLICABLE ONLY WHERE SPECIFIED ON PLAN:

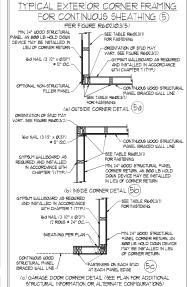

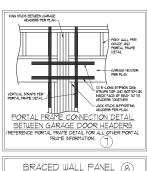

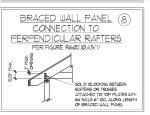

BRACED WALL PANEL

CONNECTION TO

PERPENDICULAR ROOF


TRUSSES


PER FIGURE R602.00.45(3)

(OR ALTERNATIVE: FIGURE R602.10.4.5(2))

-2 × BLOCKING

NAILING PER

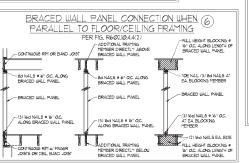

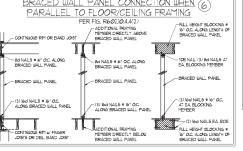

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S.Tr

GENERAL NOTES

- 1 ENGINEER'S SEAL APPLIES ONLY TO STRUCTURAL COMPONENTS INCLUDING ROOF RAFFERS HIPS VALLEYS RIGGES FLOORS HALLS BEAMS HEADERS, COLLINS, CANTILEVERS, OFFSET LOAD BEARNS WILLS, PERS, GIRDER SYSTEM AND FOOTNS. INSIGERS'S EAL DOES NOT CERTIFY DIMENSIONAL ACCURACY OF ARCHITECTURAL LAYOUT INCLUDING ROOF. ENGINEER'S EAL DOES NOT APPLY TO 1-JOIST OR FLOOR/ROOF TRUSS
- ALL CONSTRUCTION SHALL CONFORM TO THE LATEST REQUIREMENTS OF THE NORTH CAROLINA RESIDENTIAL CODE INDEX.) 20% EDITION, PLUS ALL LOCAL CODES AND REGULATIONS. THE STRUCTURAL ENGINEERS IN OTHER PROVISIONED FOR ANY DILL NOT HAVE CONTROL OF, CONSTRUCTION PEANS, HETCHOS, ELCANOLISE SEQUENCES OR RECOGNIZED AS SAFETY PRECULTIONS AND PROSCARS TO CONSECTION WITH THE CONSTRUCTION. WORK, NOR WILL THE ENGINEER BE RESPONSIBLE FOR THE CONTRACTORS FAILURE TO CARRY OUT THE CONSTRUCTION WORK IN ACCORDANCE WITH THE CONTRACT DOCUMENTS
- 3. STRUCTURAL DESIGN BASED ON THE PROVISIONS OF THE NORC, 2018 EDITION (RGØ1.4 RGØ1.1)

DESIGN CRITERIA:	LIVE LOAD (PSF)	DEAD LOAD (PSF)	DEFLECTION (IN)
ATTIC WITH LIMITED STORAGE	20	lø	L/240 (L/360 w/ BRITTLE FINISHES)
ATTIC WITHOUT STORAGE	lø	lØ	L/36Ø
DECKS	40	iø	L/36Ø
EXTERIOR BALCONIES	40	1Ø	L/36Ø
FIRE ESCAPES	40	10	L/36Ø
HANDRAILS/GUARDRAILS	200 LB OR 50 (PLF)	IØ	L/36Ø
PASSENGER VEHICLE GARAGE	50	iø	L/36Ø
ROOMS OTHER THAN SLEEPING ROOM	40	10	L/36Ø
SLEEPING ROOMS	30	iø	L/36Ø
STAIRS	40	10	L/36Ø
UND LOAD	(BASED ON TABLE R3012)	4) JUND ZONE AND EXPOSURE	
GROUND SNOW LOAD: Pg	2Ø (PSF)		

- I-JOIST SYSTEMS DESIGNED WITH 12 PSF DEAD LOAD AND DEFLECTION (IN) OF L/480
- 4. FOR 115 AND 130 MPH WIND ZONES, FOUNDATION ANCHORAGE 15 TO COMPLY WITH SECTION RADAGE OF THE NORG, 20'9 EDITION. FOR 150 MPH, IAO MPH, IAO 150 MPH WIND ZONES, FOUNDATION ANCHORAGE 15 TO COMPLY WITH SECTION 4504 OF THE NORG, 20'9 EDITION.
- 5. ENERGY EFFICIENCY COMPLIANCE AND INSULATION VALUES OF THE BUILDING TO BE IN ACCORDANCE WITH CHAPTER II OF THE NORC. 2018 EDITION.

FOOTING AND FOUNDATION NOTES

- 1. FOUNDATION DEBIGN BASED ON A MINIMUM ALLOWABLE BEARING CAPACITY OF 2000 P6F. CONTACT GEOTECHNICAL ENGINEER IF BEARING CAPACITY IS NOT ACHEVED.
- PROFERLY DEMATER EXCAVATION PRIOR TO POURNIS CONCRETE WHEN BOTTOM OF CONCRETE SLAB IS AT OR BELOW WATER TABLE.
 APPLICABLE, 34" In DEEP CONTROL JONES AND TO BE SAMED WITHIN 4 TO BE HOURS OF CONCRETE FINISHING AND WALL LOCATIONS BEEN MARKEY, AUDIST WHEN NECESSARY.
- 4. CONCRETE SHALL COPPORT TO SECTION RADGE OF THE NORC, 1908 EDITION. CONCRETE REINFORCING STELL TO BE ASTH ASS GRADE 60. BELDED LIREF PARRIED TO BE ASTH ASS. MARKINAL A MINIMAL CONCRETE CONFER ASOLID REINFORCING STELL OF 3° IN PROTINGS ASD 10° IN SUB-ASS. FOR PROTED CONCRETE BLUE, SOURCESTE CONFER REINFORCING STELL PARKED FORT THE MOSTE PARKED OF THE BLUEL SHALL NOT BE LESS THAN 314°. CONCRETE COPPER FOR REINFORCING STELL PERSONED FROM THE CUTSIDE FACE OF THE BLUEL. SHALL NOT BE LESS THAN 114° FOR SHAD SHOOT LARKER.
- MASONRY UNITS TO CONFORM TO ACE 530/ASCE 5/TMS 402. MORTAR SHALL CONFORM TO ASTM CITIE.
- 6. THE UNSUPPORTED HEIGHT OF MASONRY PIERS SHALL NOT EXCEED FOUR TIMES THEIR LEAST DIMENSION FOR CAPILLED HOLLOW CONCRETE MASONRY UNITS AND TEN TIMES THEIR LEAST DIMENSION FOR SOLD OR SOLID FILLED FIRED. FERSE MAY BE FILLED SOLID WITH CONCRETE OR TYPE IN OR S YOUTH, PIERS AND WALLS SHALL BE CAPPED WITH 8" OF S OLID MASONRY.
- THE CENTER OF EACH OF THE PIERS SHALL BEAR IN THE MIDDLE THIRD OF ITS RESPECTIVE FOOTING, EACH GIRDER SHALL BEAR IN THE MIDDLE THIRD OF THE PIERS.
- ALL COPERTE AID MASSIFF FORDATION ALLS LIFE OF BE CONTINCED IN ACCORDANCE WITH THE PROPRIOS OF SECTION AND IT HE LIVER, THE SECTION OF IN ACCORDANCE WITH ALT 38, ACL 333, NOTA 1984-A OR ACE BOUAGE INTO A OR 1, MASSIFF ROMATION UNLIL DATE TO BE REPORTED THE TILE OF BOUAGE INTO A OR ACCORDANCE THE TILE OF BOUAGE INTO A OR ACCORDANCE THE TILE OR ACCORDANCE THE TILE OF THE MASSIFF AND ALTON AND A OR ACCORDANCE TO A OR ACCORDANCE TO A OR ACCORDANCE AND ALTON OF THE MORE AND ALTON AND A OR ACCORDANCE TO A OR ACCORDANCE TO A OR ACCORDANCE TO A OR ACCORDANCE TO A OR ACCORDANCE AND ALTON AND A OR ACCORDANCE TO A OR ACCORDANCE TO A OR ACCORDANCE AND ALTON AND A OR ACCORDANCE TO ACCORDANCE AND ACCORDANCE TO ACCORDANCE

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FRAMING NOTES

- L. ALL FRAMING LIMPER 9-IALL BE 12 9FF MINIMUM (Fig. 875 PS) Fy : 375 PS) E : 16/00/2/2 PS) UNLESS NOTED OTHERUSE (UNC). ALL TREATED LUMBER SHALL BE 12 SYP MINMUM (FIG. # 915 PS), FV #175 PS), E # 16000000 PS)) UNLESS NOTED OTHERWISE (UND
- 2. LATINATED VENEER LIMBER (LIV.) SHALL HAVE THE FOLLOUNG MINITUM PROFERITIES. Fo. 12600 PSI, Fo. 1265 PSI, E. 1. PROGOOD PSI, LATINATED STRAND LIMBER (SLJ.) SHALL HAVE THE FOLLOUNG MINITUM PROFERITIES fo. 1250 PSI, Fo. 1950000 PSI, PARALLEL STRAND LIMBER (PSIL) TO TO PSITH SHALL HAVE THE FOLLOUNG MINITUM PROFERITIES fo. 1250 PSI E. 1260000 PSI, PARALLEL STRAND LIMBER (PSIL) MORE THAN 17 DEPTH SHALL HAVE THE FOLLOUNG MINITUM PROFERITIES fo. 1200 PSI E. 120000000 PSI, INSTALL ALL CONNECTIONS PER MANUFACTURER'S SPECIFICATIONS.
- 3. STRUCTURAL STEEL SHALL CONFORM TO THE FOLLOWING ASTM SPECIFICATIONS

Α.	W AND WI SHAPES:	ASITI ASSV
В.	CHANNELS AND ANGLES:	ASTM A36
C.	PLATES AND BARS:	ASTM A36
D.	HOLLOW STRUCTURAL SECTIONS:	ASTM A500 GRADE B
E.	STEEL PIPE:	ASTM A53, GRADE B. TYPE E OR S

4. STEEL BEAMS SHALL BE SUPPORTED AT EACH END WITH A MINIMUM BEARING LENGTH OF 3 I/2" AND FULL FLANGE WIDTH (UNO), PROVIDE SOLID BEARNS FROM BEAM SUPPORT TO FOUNDATION, BEAMS SHALL BE ATTACHED AT THE BOTTOM FLANGE TO EACH SUPPORT AS FOLLOUS (UNO)

A, WOOD FRAMING (2) 12° DIA, x 4° LONG LAG SCREUS (2) 12° DIA, x 4° WEDGE ANCHORS (2) 12° DIA, x 4° LONG SIMPSON TITEN HD ANCHORS

LATERAL SUPPORT IS CONSIDERED ADEQUATE PROVIDING THE JOISTS ARE TOE NALED TO THE 5X NAILER ON TOP OF THE STEEL BEAM, AND THE 2x NATURE IS SECURED TO THE TOP OF THE STEEL SEAM w/ (2) ROUS OF SELF TAPPING SCREUS ■ 16" OC. OR (2) ROUS OF IZ" DIAMETER BOLTS * I6* O.C. F 12* BOLTS ARE USED TO FASTEN THE NAILER. THE STEEL BEAM SHALL BE FABRICATED w/ (2) ROUS OF 9/16* DIAMETER HOLES # 16" O.C.

- SQUARES DENOTE POINT LOADS WHICH REQUIRE SOULD BLOCKING TO GIRDER OR FOUNDATION, SHADED SQUARES DENOTE POINT LOADS FROM ABOVE WHICH REQUIRE SOULD BLOCKING TO SUPPORTING MEMBER BELOW.
- 6. ALL LOAD BEARING HEADERS TO CONFORM TO TABLE R602.1(1) AND R602.1(2) OF THE NORC, 2018 EDITION OR BE (2) 2 x 6 WITH (1) JACK AND (I) KING STUD EACH END (UNO), WHICHEVER IS GREATER ALL HEADERS TO BE SECURED TO EACH JACK STUD WITH (4) 8d NAILS, ALL BEAMS TO BE SUPPORTED WITH (2) STUDS AT EACH BEARING FOINT (UNO). INSTALL KING STUDS PER SECTION R6(02):15 OF THE NORTH CAROLINA RESIDENTIAL CODE 2018 EDITION
- 1. ALL BEAMS, HEADERS, OR GRODER TRUSSES PARALLEL TO WALL ARE TO BEAR RULLY ON (1) JACK OR (2) STUDS THINMTH OR THE NUMBER OF JACKS OR STUDS NOTES. ALL BEAMS OR GRODER TRUSSES FREEDOLGLAR TO WALL AND SUPPORTED BY (1) STUDS OR LESS ARE TO MAKE (1)? MAND MEANING MEANING AND, ALL BEAMS OR GRODER TRUSSES FREEDOCULAR TO WALL AND SUPPORTED BY TO WEET HAN (3) STUDS OR OTHER MOTED COUNTS, ARE TO BEAR RULLY ON SUPPORT DO YOUR TRUSS FREEDOM FOR DATE. ANOTHER ARE TO EACH BEAR EQUAL LENGTHS (UNO).
- 8. FLITCH BEAMS SHALL BE BOLTED TOGETHER USING 101 DIAMETER BOLTS (ASTM A3@1) WITH WASHERS PLACED AT THREADED END OF BOLT. BOLTS SHALL BE SPACED AT 24" CENTERS (MAXIMUM), AND STAGGERED AT TOP AND BOTTOM OF BEAM (2" EDGE DISTANCE), WITH (2) BOLTS LOCATED AT 6" PROM EACH END (UNO).
- ALL I-JOIST OR TRUSS LAYOUTS ARE TO BE IN COMPLIANCE WITH THE OVERALL DESIGN SPECFED ON THE PLANS. ALL DEVIATIONS ARE TO BE BROUGHT TO THE ATTENTION OF THE ENGINEER OF RECORD PRIOR TO INSTALLATION.
- 10. BRACED WALL PANELS SHALL BE CONSTRUCTED ACCORDING TO THE NORTH CAROLINA RESIDENTIAL CODE 2018 EDITION WALL BRACING CRITERIA THE AMOUNT, LENGTH, AND LOCATION OF BRACING SHALL COMPLY WITH ALL APPLICABLE TABLES IN SECTION REGION.
- II PROVIDE DOUBLE JOST UNDER ALL WALLS PARALLEL TO FLOOR JOSTS. PROVIDE SUPPORT UNDER ALL WALLS PARALLEL TO FLOOR 5 PER MANUFACTURER'S SPECIFICATIONS. INSTALL BLOCKING BETWEEN JOISTS OR TRUSSES FOR POINT LOAD SUPPORT FOR ALL POINT LOADS ALONG OFFSET LOAD LINES.
- FOR ALL HEADERS SUPPORTING BRICK VENEER THAT ARE LESS THAN 8"-0" IN LENGTH, REST A 6" x 4" x 5/6" STEEL ANGLE WITH 6" MINIMUM EMBEDMENT AT SIDES FOR BRICK SUPPORT (UNO). FOR ALL HEADERS 8'-8" AND GREATER IN LENGTH, BOLT A 6" x 4" x 5'/6" STEEL ANGLE TO HEADER WITH IVE LAG SCREUS AT 12' O.C. STAGGERED FOR BRICK SUPPORT. FOR ALL BRICK SUPPORT AT ROOF LINES, BOLT A 6" x 4" x 5/16" STEEL ANGLE TO (2) 2 x 10 BLOCKING INSTALLED W (4) 12d NAILS EA, PLY BETWEEN WALL STUDG WITH (2) PROUS OF 1/2" LAG SCREWS AT 12" O.C. STAGGERED AND IN ACCORDANCE WITH SECTION RTØ3.8.2.) OF THE NORC, 2018 EDITION
- 13. FOR STICK FRAMED ROOFS; CIRCLES DENOTE (3) 2 x 4 POSTS FOR ROOF MEMBER SUPPORT, HIP SPLICES ARE TO BE SPACED A MINIMUM OF SHOULD NOT SELF-SECTION LIFELIZED LICENSES 120 / X = TUDITS FOR ROCK PIETEER BLIPPORT, HIP SELECES ARE TO BE SPACED A MINIMA 8-01, FASTEN MEMBERS LITH THREE ROUS OF 12d NALES AT 161 O.C., FRAME DORMER WALLS ON TOP OF DOUBLE OR TRIME RAFTERS AS SHOUN (IAO).
- 14. FOR TRUSSED ROOFS: FRAME DORMER WALLS ON TOP OF 2 x 4 LADDER FRAMING AT 24" OC. BETWEEN ADJACENT ROOF TRUSSES. STICK FRAME OVER-FRAMED BOOF SECTIONS WITH 2 x 8 RIDGES, 2 x 6 RAFTERS AT 16" O.C., AND FLAT 2 x 10 VALLEYS (LNO.);
- 15. ALL 4 x 4 AND 6 x 6 POSTS TO BE INSTALLED WITH TWO LIB CAPACITY UPLIFT CONNECTORS TOP AND BOTTOM (UNO.) POSTS MAY BE SECURED USING ONE SIMPSON HE OR LITIST UPLET CONNECTOR FASTENED TO THE BAND AT THE BOTTOM AND THE BEAM AT THE TOP OF EACH POST. ONE IN SECTION OF SIMPSON CASE COLL STRANGING WITH (8) SEL HOS NALE AT EACH END MAY BE USED IN LIBU OF EACH MUST STRUP P DESIDED. FOR MASONIX OR CONCRETE PONDATION USE STRYON POST BASE.

WIND SPEED · 130 MPH ULTIMATE DESIGN WIN STANDARD STRUCTURAL NOTES MPH

DATE: NOVEMBER 14, 2018

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GINEERED BY: 157

S-0 STRUCTURAL NOTES