## COLLEX593InventoryMarkedPlan

# Dream Finders Homes JORDAN

## JORDAN

REVISION LIST - STRUCTURAL:

- CODE UPDATE TO SCRC 2018 (1-20)
- 2. CHANGE 2X6 EXTERIOR WALLS TO 2X4 EXTERIOR WALLS. (3-5-20)
- 3. ADDED BASEMENT PLAN WHICH EXTENDS GARAGE FRONT 2'-0". (5-1-20)
- 4 UPDATING SC CODE FROM 2018 TO 2021 (11-28-22).

# JORDAN

REVISION LIST - ARCHITECTURAL:

- 2. CHANGED ATTIC ACCESS FROM 2/0 4/0 TO 22 1/2" X 38"
- 3. OPTIONAL BRICK/STONE WATERTABLE ADDED TO SIDE & REAR ELEVATIONS
- 4. REMOVED DIMENSIONS FROM ATTIC DOORS IN OPT. BEDROOM 4 ILO STUDY & SECOND FLOOR PLAN STUDY 7-12-23


DREAM FINDERS HOMES

COVER SHEET

DREAM FINDERS HOMES

PD.: NOVEMBER 28, 202 DRAWN BY: ENGINEERED BY:

CS

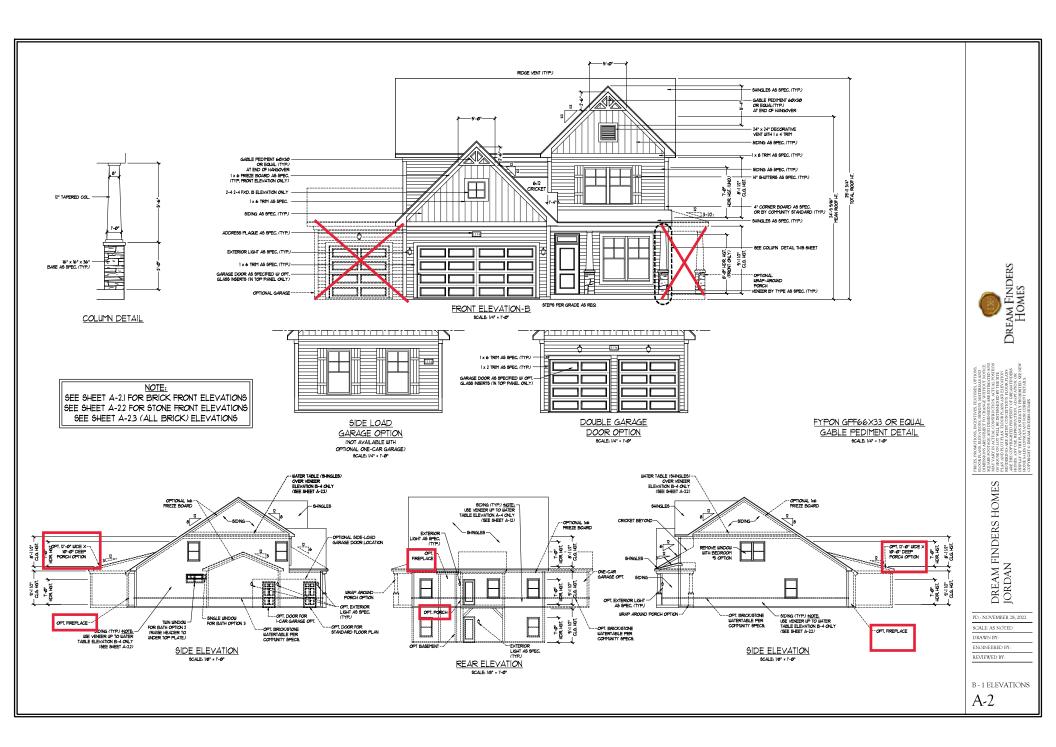



I PRICE JEGORIONA (CENTRO BERTINES, CPUOSA
FLOOR THAN ELEVATIONS DESIGNED MATERIALS WID
DIMENSIONS SER SIRET TO CLARE WITHOUT STORY
STANDER FOR ACT AND DESIGNED WITHOUT SHOULD
STANDER FOR ACT AND DESIGNED WITH SER TITLE
FLOOR ACT AND TO THAN TO CORT AND STORY
FLOOR ACT AND TO THAN TO CORT AND STORY
FLOOR ACT AND TO THAN TO THE ACT AND THAN TO SEE ACT
FROM THE ACT AND THAN TO THE ACT AND THAN TO SEE ACT
FROM THE ACT AND THE ACT AND THAN TO SEE ACT
FROM THE ACT AND THE ACT AND THE ACT AND THE ACT
FROM THE ACT AND THE ACT AND THE ACT AND THE ACT
FROM THE ACT AND THE ACT AND THE ACT AND THE ACT
FROM THE ACT AND THE ACT AND THE ACT AND THE ACT
FROM THE ACT AND TH

DREAM FINDERS HOMES JORDAN

PD.: NOVEMBER 28, 2022 SCALE: AS NOTED

DRAWN BY:

ENGINEERED BY: REVIEWED BY:

B - 2 & B - 3 ELEVATIONS WITH STONE

A-2.1



FORTE, BORROPORA, REPURSOR, BE FURBER, GOTON FUNDOR LASS, ELEMANDES, BORROS MARRIALAS KOD DIMENSON SAR SUBBETT CORRACT WITHOUT NOTICE SACARRE DOT CORF. AND DIMENSON SALE BIRTHOUTH NO POPENSON OF CORP. AND DIMENSON SALE BIRTHOUTH NO POPENSON OF CORP. AND DIMENSON SALE BIRTHOUTH NO POPENSON OF CORP. AND THE SALE SALE BIRTHOUTH SALE FULL AND FOR THE TABLE STORY READON LASS ROBERS AND THE TABLE STORY REPURSOR TO SALE AND THE BIRTHOUTH OF THE TABLE STORY ROBERT SETS WAS BURNES OF THE TABLE STORY THE ROBERT SETS WAS BURNES OF THE TABLE STORY THE ROBERT SETS WAS BURNES OF THE TABLE STORY THE ROBERT SETS WAS BURNES OF THE TABLE STORY THE STORY THE SALE AND THE SALE AND THE SALE STORY THE SALE AND THE SALE AND THE BURNES OF THE TABLE STORY THE SALE AND THE SALE AND THE BURNES OF THE SALE AND THE SALE AND THE SALE AND THE BURNES OF THE SALE AND THE SALE AND THE SALE AND THE BURNES OF THE SALE AND THE SALE AND THE SALE AND THE SALE AND THE BURNES OF THE SALE AND THE SALE AND THE SALE AND THE SALE AND THE BURNES OF THE SALE AND THE SALE AND THE SALE AND THE SALE AND THE BURNES OF THE SALE AND THE SALE AND

DREAM FINDERS HOMES JORDAN


PD.: NOVEMBER 28, 2022


SCALE: 1/4"=1'-0" DRAWN BY:


ENGINEERED BY: REVIEWED BY:

SLAB INTERFACE PLAN


A-4

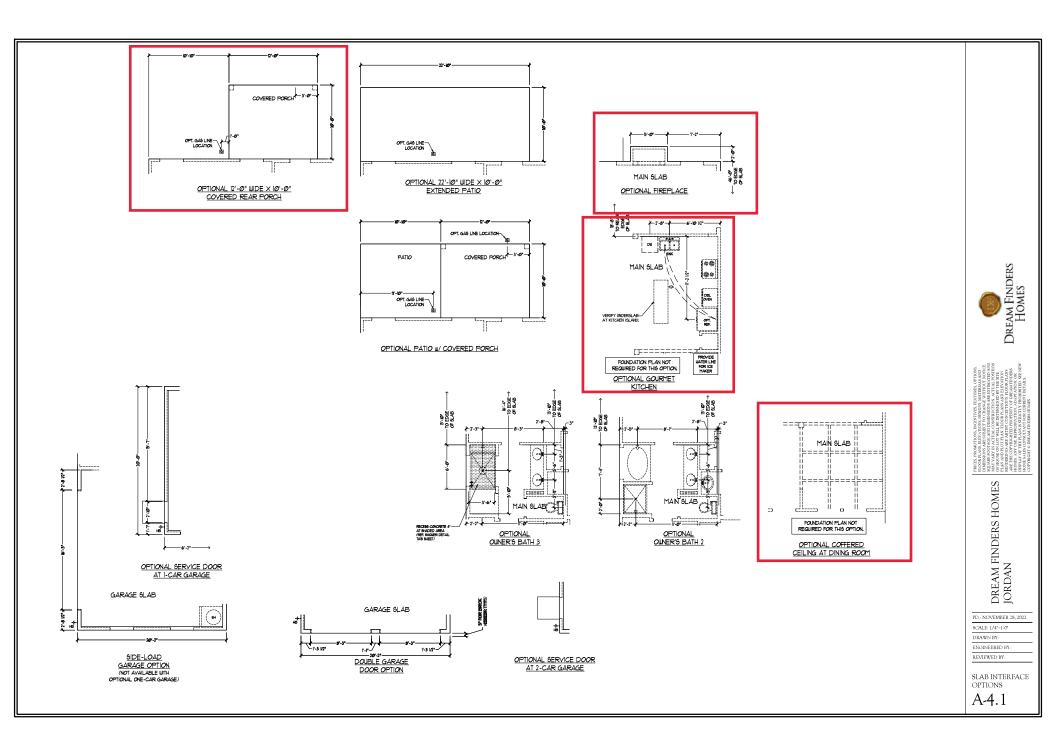

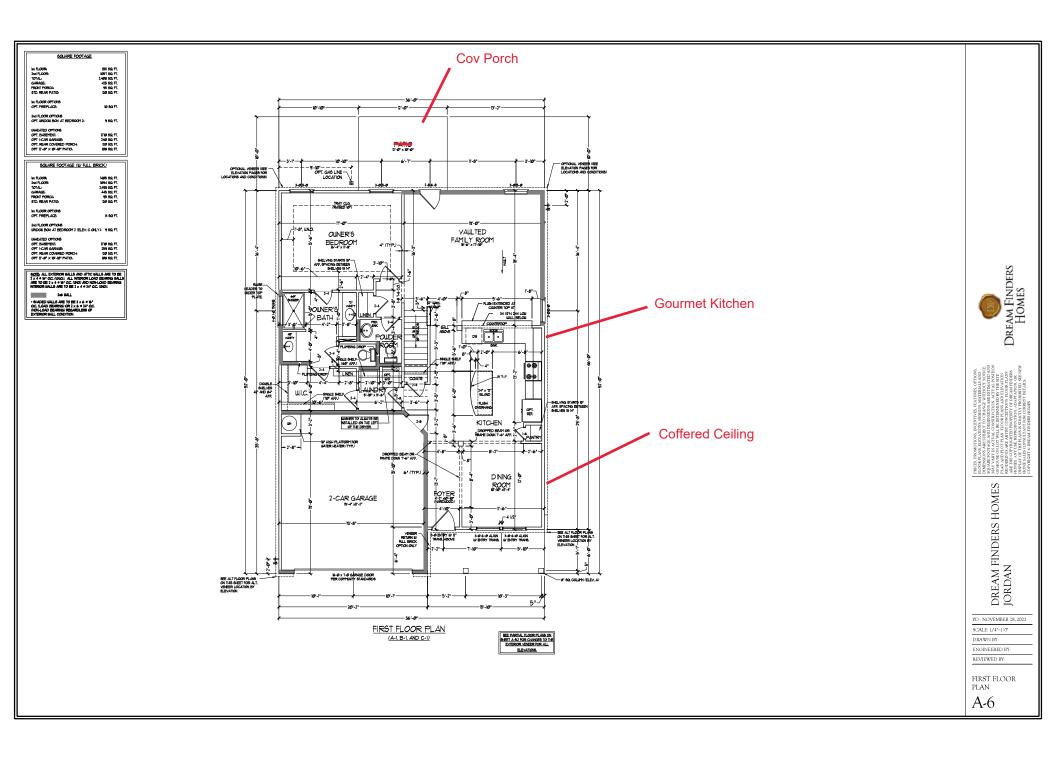

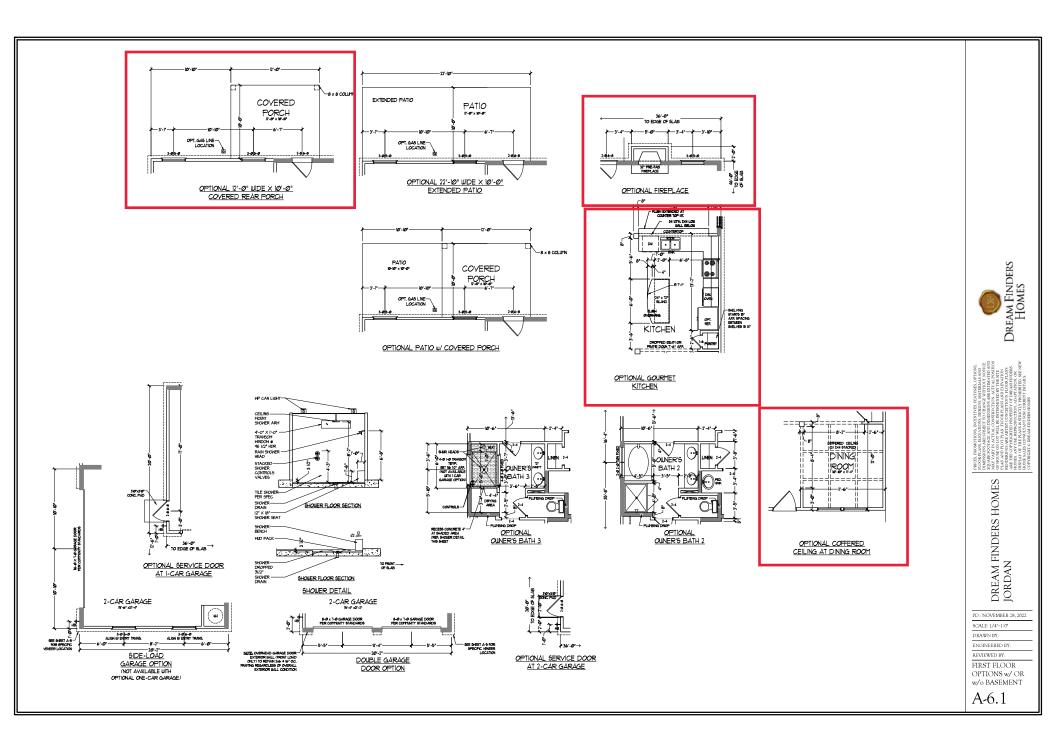



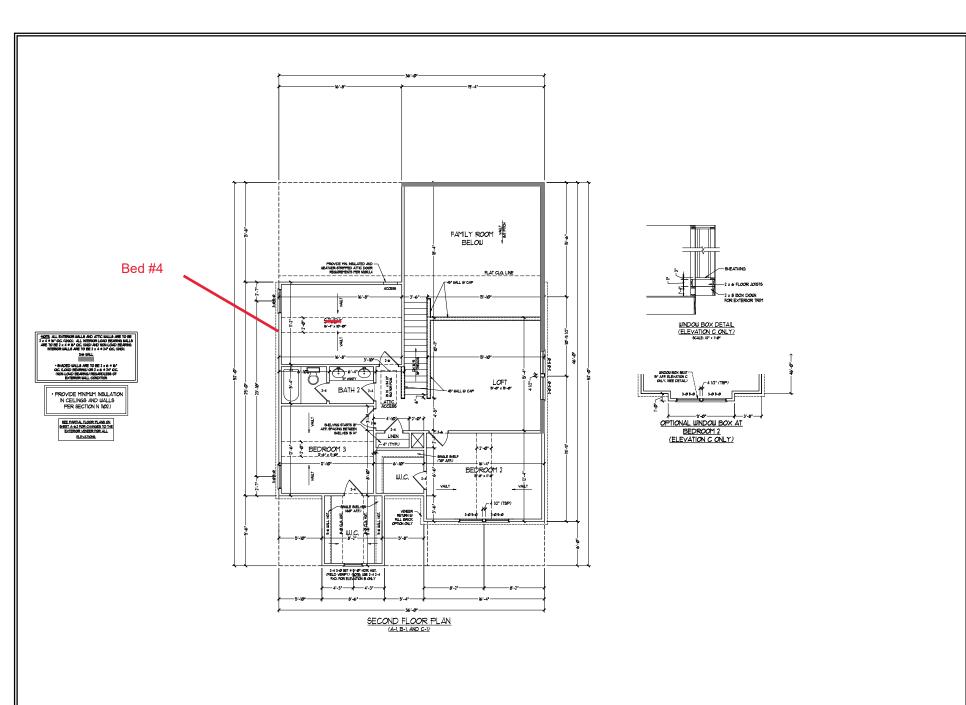

Dream Finders Homes

FORTE, BORROPORA, REPURSOR, BE FURBER, GOTON FUNDOR LASS, ELEMANDES, BORROS MARRIALAS KOD DIMENSON SAR SUBBETT CORRACT WITHOUT NOTICE SACARRE DOUGHT, AND DIMENSON SALE BIRTHOUTH NO POPENSON OF THE MARRIAL STREET TO SACAR TO SACA

DREAM FINDERS HOMES JORDAN


PD.: NOVEMBER 28, 2022


SCALE: 1/4"=1'-0" DRAWN BY:

ENGINEERED BY: REVIEWED BY:

SECOND FLOOR PLAN

A-7

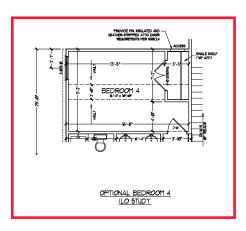

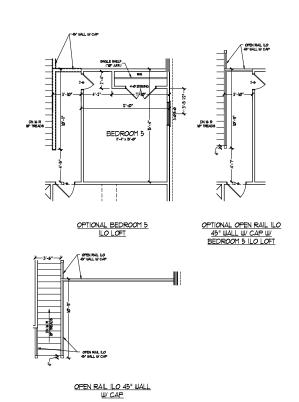



FOR PARAM, ENGLAPTIONS DESCRIBE AND RETURNAL AND COURSE OF A CONTRIBUTION OF A CONTR

DREAM FINDERS HOMES JORDAN


PD.: NOVEMBER 28, 2022 SCALE: 1/4"=1'-0"

DRAWN BY:


ENGINEERED BY: REVIEWED BY:

SECOND FLOOR OPTIONS

A-7.1

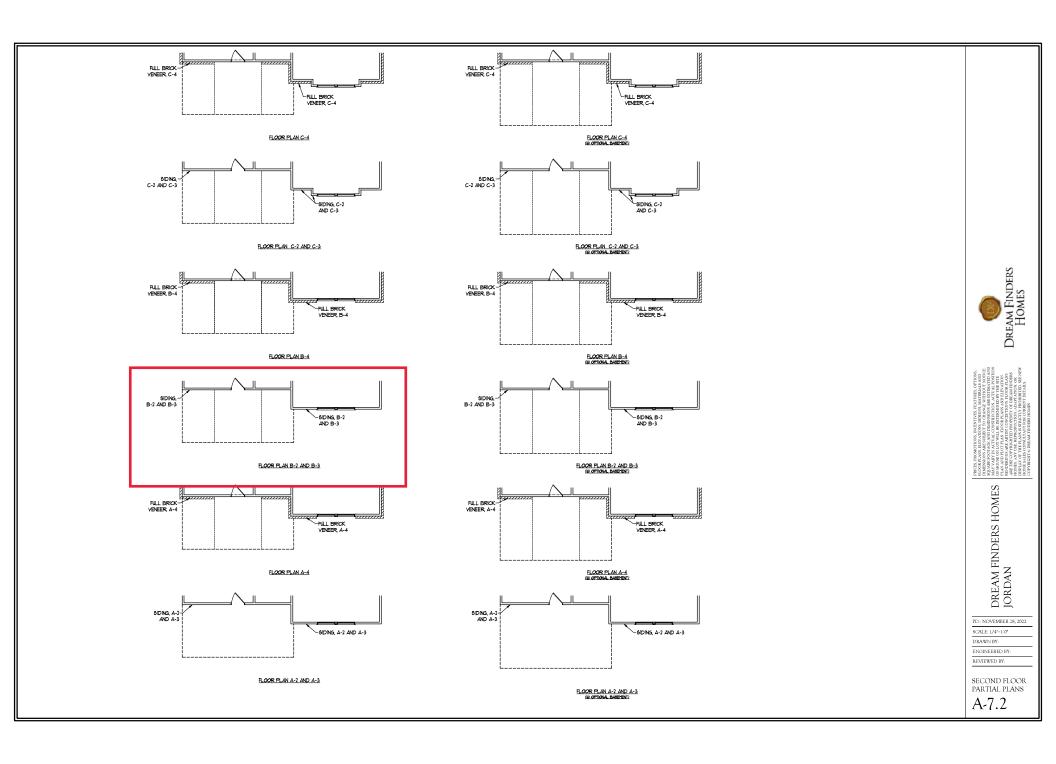



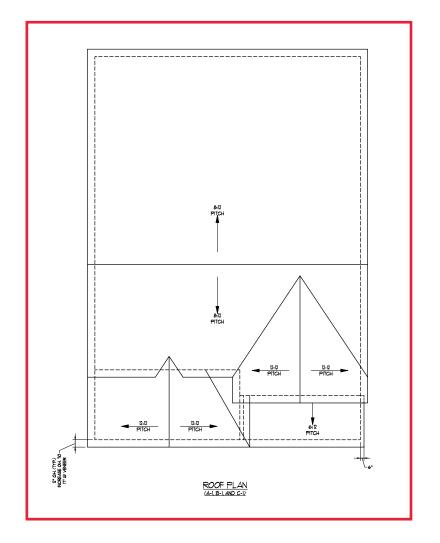





DREAM FINDERS HOMES JORDAN

PD.: NOVEMBER 28, 2022 SCALE: 1/4"=1'.0" DRAWN BY: ENGINEERED BY:

REVIEWED BY:
ROOF PLAN
ELEVATIONS
A&B

A-8

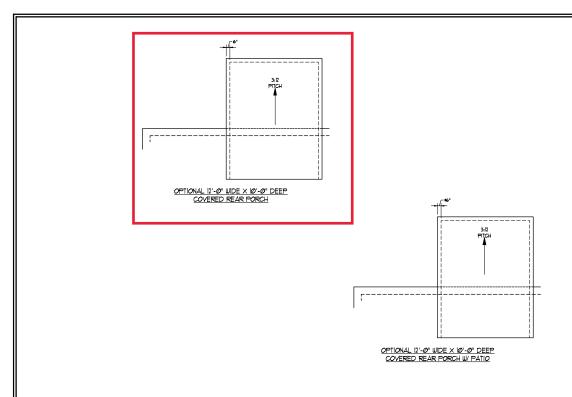

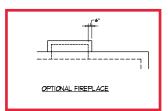



DREAM FINDERS HOMES JORDAN

PD.: NOVEMBER 28, 2022


SCALE: 1/4"=1'-0"

DRAWN BY:

ENGINEERED BY:

REVIEWED BY:
ROOF PLAN
ELEVATION - A/B

A-8.2

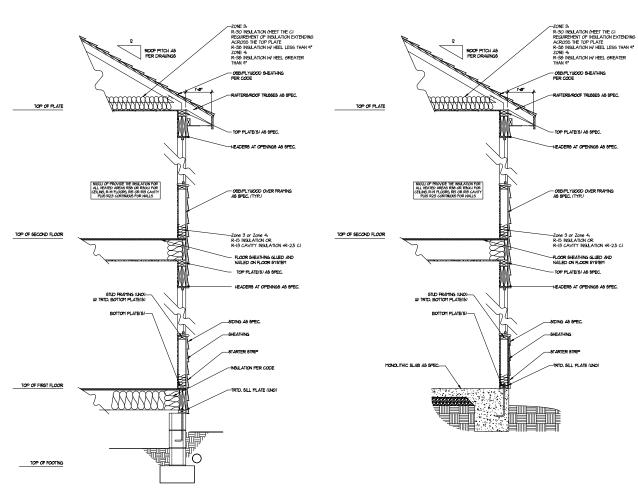

LOW WALL — 3/4" PLYUD. DECKING FLOOR SYSTEM BEYOND FLOOR SYSTEM 36" H. CONTINUOUS I' NOSING (TYP.) GRASPABLE RAILING IN — RFΔM-BACKGROUND IX TREADS AND 9 TREADS AT 10" EACH

> TYPICAL STAIR DETAIL (NTS)

THE TRIANGLEAR OPENINGS FORMED BY THE RISER, TREAD AND BOTTOM RAIL OF A GLIARD AT THE OPEN SIDE OF A STANBLAY ARE PERMITTED TO BE A SICH A SIZE THAT A SPHENE OF 6 INCHES CANNOT PASS THROUGH

OPENINGS FOR REQUIRED GUARDS ON THE SIDES OF STAIR TREADS SHALL NOT ALLOW A SPHERE 4 3/8 INCHES TO PASS THROUGH

HADRALIS FOR STAIRLIAYS SHALL BE CONTINUOUS FOR THE RILL LEWSTIM OF THE FLIGHT TO A POINT DIRECTLY ABOVE THE TOP RISER THE FLIGHT TO A POINT DIRECTLY ABOVE THE LOUEST RISER. HADRALL ENDS SHALL BE RETURNED OR SHALL TERMINED IN NEELE, POINT OR SHAPTLY TERMINED AN HADRALIS AGUACIST TO A WALL SHALL MAY A SPICE OF NOT LESS THAN 17 NOH SETEMBER THE WILL AD MANDRALIS.

WALL SECTION W/ SLAB W/ STD, SIDING SHOWN (NTS)

DREAM FINDERS HOMES JORDAN PD.: NOVEMBER 28, 2022

SCALE: 1/4"=1'-0"

DRAWN BY:

REVIEWED BY:

WALL SECTIONS AND STAIR

DETAIL AD-1


WALL SECTION W/ CRAWL SPACE W/ STD, SIDING SHOWN (NTS)



PRICES, PROMO!
PLOOR PLANS, EF
PLOOR PLANS, EF
PLOOR PLANS, EF
PLANS AND PLOT
PLAN AND PLOT
PLOMES, ANY USE
PLOM



ELECTRICAL LEGEND		
-	TO Y CUTLET	
△	WALL MOUNT LIGHT	
<b>~</b>	CEILING MOUNT LIGHT	
•	PENDANT LIGHT	
Ø	RECESSED CAN LIGHT	
Ø	MINI CAN LIGHT	
<b>®</b>	EYEBALL LIGHT	
	FLUORESCENT LIGHT	
	2 LAMP, 4' FLUORESCENT LIGHT	
썀	FLOOD LIGHT	
į.	SUITCH	
l i	3-MAY SMITCH	
8	4-WAY SUITCH	
8	DIMMER SUITCH	
<u>a</u> -	CONDUIT FOR COMPONENT LIRING	
₽	6PEAKER	
₽-	DOORBELL CHIME	
₽	160 V SMOKE DETECTOR	
<b>20</b>	CO DETECTOR	
9	EXHAUST FAN	
	LOW VOLTAGE PANEL	
$\otimes$	CEILING FAN	
	CELLING FAN IV LIGHT	

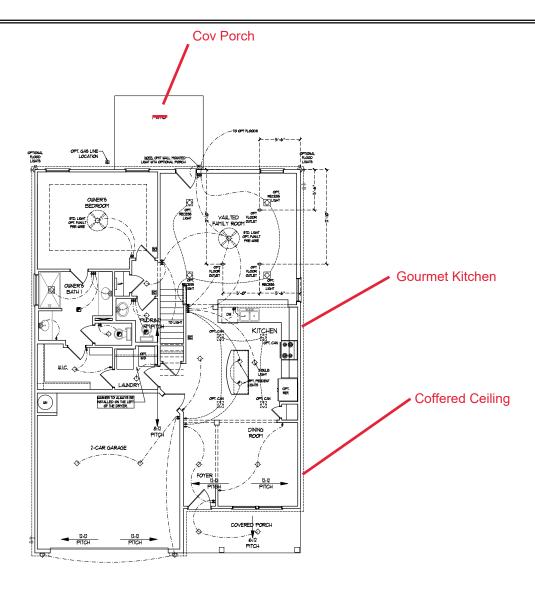

FIRST FLOOR PLAN (A-1, B-1, AND C-1) DREAM FINDERS HOMES

CHOOR LAST BETWINGON SIGNS, AMERIDALE AND
CHARGEONS ARE SUBJECT TO CHANGE WHITON NOTICE
CHARGEON AND CHARGE AND DIMEDIOUS AND STATEST DAYS

WHICH AND THE ADMINISTRATION OF ACTIVATE PORTION
OF ACTIVATION OF ACTIVA

DREAM FINDERS HOMES JORDAN

PD.: NOVEMBER 28, 2022


SCALE: 1/4"=1'-0" DRAWN BY:

ENGINEERED BY:

REVIEWED BY:

FIRST FLOOR ELECTRICAL PLAN


E-1

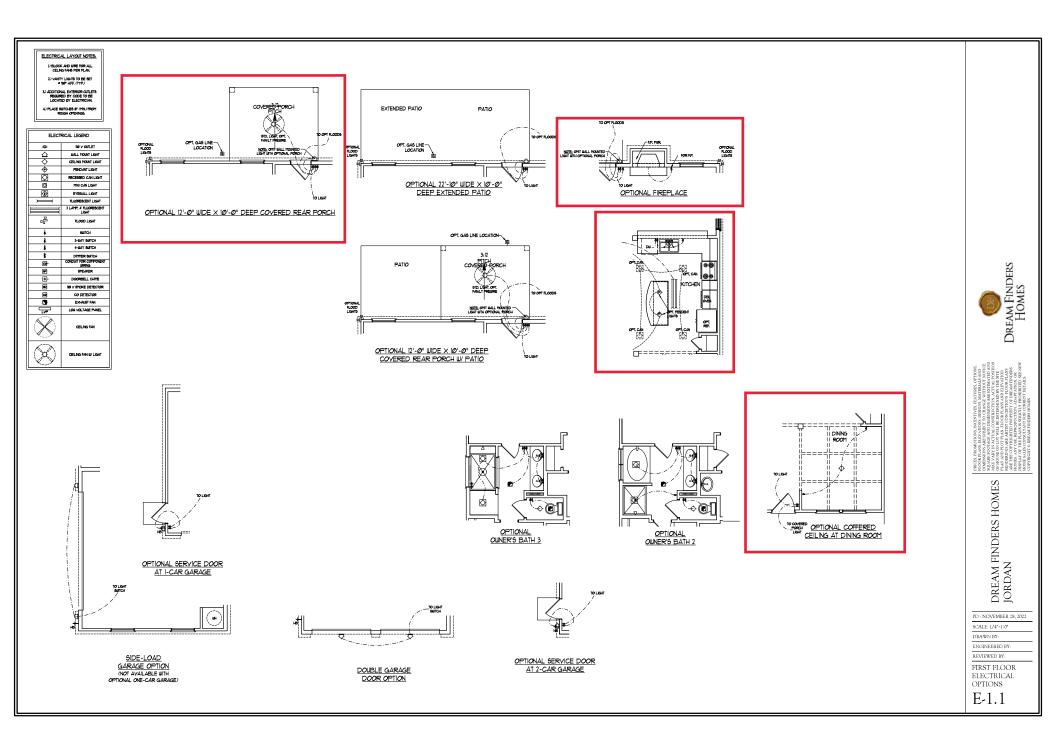

ELECTRICAL LAYOUT NOTES.

U BLOCK AND UNE FOR ALL
CELNO FAR FIRE FLAX
2) WART LEWIS TO BE SET
4 SET AFF. (TP)
3) ADDITIONAL DISEORE OUTLETS
REQUIRED BY CODE TO BE
LOCATED BY ELECTRICAL
4) FLACE SUITCES BY CHAUPROM
ROUGH OPENNEA.

ELECTRICAL LEGEND		
•	16 Y CUTLET	
↔	WALL MOUNT LIGHT CELING MOUNT LIGHT	
<b>\Q</b>		
•	PENDANT LIGHT	
Ø	RECEMBED CAN LIGHT	
0	HINI CAN LIGHT	
<b>®</b>	EYEBALL LIGHT	
	FLUORESCENT LIGHT	
	2 LAMP, 4' FLUORESCENT LIGHT	
峄	FLOOD LIGHT	
ė.	SUITCH	
1	3-WAY SWITCH	
i i	4-WAY SUITCH	
B	DIMER SUITCH	
@-	CONDUIT FOR COMPONENT URRING	
•	SPEAKER	
<b>D</b> -	DOORBELL CHIME	
80	TIØ V SMOKE DETECTOR	
<b>∞</b>	CO DETECTOR	
3	EXHAUST FAN	
LVP	LOW VOLTAGE PANEL	
$\otimes$	CELING FAN	
(8)	CELING FAN W LIGHT	

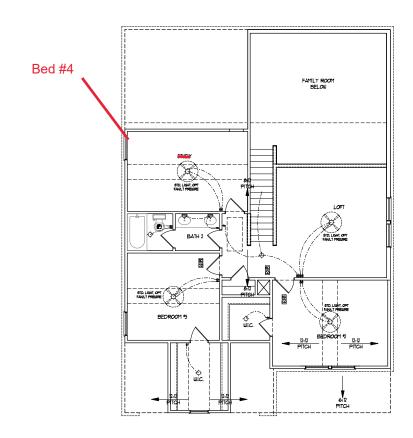



SECOND FLOOR PLAN (A-1, B-1, AND C-1)



WINESHOON SEASURED TO COLUMN WITHOUT NOTICE.

BY ENDOS OF USE SERVED TO COLUMN WITHOUT NOTICE.

WHICH SEASURED THE RETERRINGED BY THIS STILL WE ARE THE COPPLETED BY THIS STILL WE ARE THE COPPLETED BY THIS STILL WE WERE THE COPPLETED BY THE STILL WE WERE THE COPPLETED BY THE STILL WE WERE THE COPPLETED BY CHAPTED BY CORPET OF DELAM PRIOR SEASURED STILL WE WERE STILL WE WENT THE SERVED WITH SEASURED STILL WE WERE STILL WE WENT THE SEASURED STILL WE WERE STILL WE WE WE WERE STILL WE WIN WE WE WIN WE WE WIN WE WE WERE STILL WE WIN WE WE WIN WE WE WE WIN WE WE WIN WE WE WE WIN WE WE WIN WE WIN WE WE WANT WE WE WANT WE WE WE WE WE WANT WE WE WE WANT WE WE WE WE WE WE WANT WE WE WE WE WANT WE WE WE WE WE WE WANT WE WE WE WE WE WE WANT WE WE WE WE WANT WE WE WE WE WE WANT WE WE WE WA

DREAM FINDERS HOMES JORDAN

PD.: NOVEMBER 28, 2022 SCALE: 1/4"=1'-0"

DRAWN BY:

ENGINEERED BY: REVIEWED BY:

SECOND FLOOR ELECTRICAL PLAN

E-2

ELECTRICAL LATOUT NOTES

U BLOCK AND WEE FOR ALL
CELNG FARS FIRST LA.
2 JAWN'T LAURING TO BE SET

3 JACK TOTAL DETERMINE OF LEET


3 JACK TOTAL DETERMINE OF LEET


REQUIRED BY COOK TO BE
LOCATED BY ELECTRICAN


A PLACE SELECTES I'M HAVE FROM


ROUGH OPENINGA.

ELECTRICAL LEGEND		
*	TO Y CUTLET	
Φ.	WALL MOUNT LIGHT	
<b></b>	CEILING MOUNT LIGHT	
•	PENDANT LIGHT	
Ø	RECEMBED CAN LIGHT	
Ø	MINI CAN LIGHT	
<b>®</b>	EYEBALL LIGHT	
	FLUORESCENT LIGHT	
	2 LAMP, 4' PLUORESCENT LIGHT	
帮	FLOOD LIGHT	
ė.	SUTCH	
ı	3-MAY SUITCH	
i i	4-WAY SUITCH	
B	DIMMER SUTCH CONDUIT FOR COMPONENT LIRING	
<u>-</u>		
₽	SPEAKER	
₽	DOORBELL CHIME NO Y SMOKE DETECTOR	
•		
<b>6</b>	CO DETECTOR	
131	EXHAUST FAN	
LVP	LOU VOLTAGE PANEL	
$\otimes$	CELLING FAN	
(8)	CELLING FAN IV LIGHT	

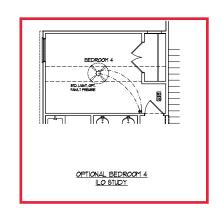

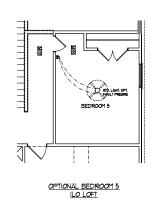

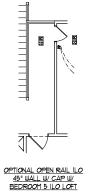

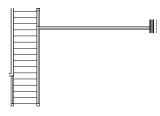


OPEN RAIL ILO 45" WALL

W CAP

SECOND FLOOR ELECTRICAL OPTIONS

E-2.1

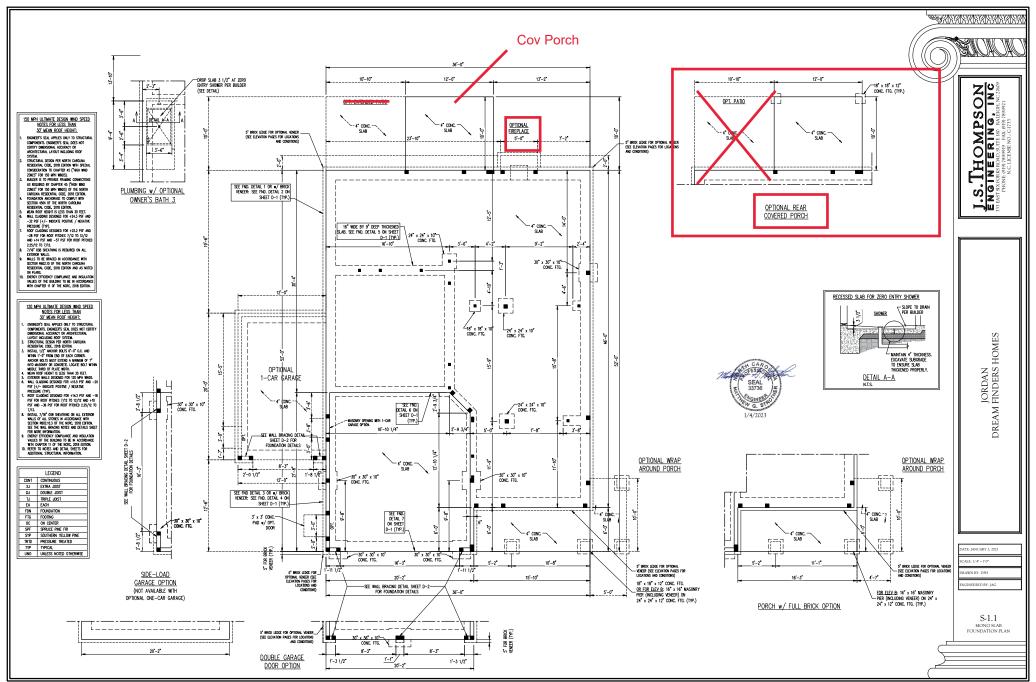

## TABLE R602.7.5 MINIMUM NUMBER OF FULL HEIGHT KING STUDS AT EACH END OF HEADERS IN EXTERIOR WALLS

AT EACH DID OF TEMPERS IN EXIDION WHE			
HEADER SPAN (FEET)	MINIMUM NUMBER OF FULL HEIGHT STUDS (KINGS)		
UP TO 3'	1		
> 3' 10 6'	2		
> 6° TO 9°	3		
> 9' TO 12'	4		
> 12° TO 15°	5		

#### STRUCTURAL NOTES:

- all framing lumber to be: //2 spf (uno). All load bearing headers to be: (3) 2  $\times$  8 (uno). Sources denote point loads which bequire solid blocking to grober or foundation. Support unspecified Pt. Loads along framed walls w/ (2) FOMBAIDM. SEPPER UNSPECTIBLE PIT. LUNDA ALLAW FORMER MALLS PY, VILLED TO ROOM AND THE METERS OF THE PROPERTY OF THE PARTY OF THE PARTY

- FOR HIGH WIND ZONES, ALL DICTEROR WALLS TO BE SHEATHED WITH 7/16" OS SHEARNEN WITH JOHN SERVICED WITH 50 MINS AT 3" OL. ALONG EXCESS AND 6" OLD. HITE FEELD. WITH SERVICES TO DURLE THE PLATES BANKE, ADSTA, BOUR GRINGS TO JOHNES THE PLATES BANKE, ADSTA, BOUR GRINGS WITH (2) ROWGE OF HAUS STRACKERD AT 3" OLD. PRINCES SHALL EXTEND 12" BRYONG FOR MINS STRACKERD AT 3" OLD. PRINCES SHALL EXTEND 12" BRYONG FOR MINS STRACKERD AT 3" OLD. PRINCES SHALL EXTEND 12" BRYONG FOR MINS STRACKERD AT 3" OLD. PRINCES SHALL EXTEND 12" BRYONG FOR MINS STRACKERD AT 3" OLD. PRINCES SHALL EXTEND 12" BRYONG FOR MINS STRACKERD AT 3" OLD. PRINCES SHALL EXTEND 12" BRYONG FOR MINS STRACKERD AT 3" OLD. PRINCES SHALL EXTEND 12" BRYONG FOR MINS STRACKERD AT 3" OLD. PRINCES SHALL EXTEND 12" BRYONG FOR MINS STRACKERD AT 3" OLD. PRINCES SHALL EXTEND 12" BRYONG FOR MINS STRACKERD AT 3" OLD. PRINCES SHALL EXTEND 12" BRYONG FOR MINS STRACKERD AT 3" OLD. PRINCES SHALL EXTEND 12" BRYONG FOR MINS STRACKERD AT 3" OLD. PRINCES SHALL EXTENDED 12" BRYONG FOR MINS STRACKERD AT 3" OLD. PRINCES SHALL EXTEND 12" BRYONG FOR MINS STRACKERD AT 3" OLD. PRINCES SHALL EXTEND 12" BRYONG FOR MINS STRACKERD AT 3" OLD. PRINCES SHALL EXTEND 12" BRYONG FOR MINS STRACKERD AT 3" OLD. PRINCES SHALL EXTEND 12" BRYONG FOR MINS STRACKERD AT 3" OLD. PRINCES SHALL EXTEND 12" BRYONG FOR MINS STRACKERD AT 3" OLD. PRINCES SHALL EXTEND 12" BRYONG FOR MINS STRACKERD AT 3" OLD. PRINCES SHALL EXTEND 12" BRYONG FOR MINS STRACKERD AT 3" OLD. PRINCES SHALL EXTEND 12" BRYONG FOR MINS STRACKERD AT 3" OLD. PRINCES SHALL EXTEND 12" BRYONG FOR MINS STRACKERD AT 3" OLD. PRINCES SHALL EXTEND 12" BRYONG FOR MINS STRACKERD AT 3" OLD. PRINCES SHALL EXTEND 12" BRYONG FOR MINS STRACKERD AT 3" OLD. PRINCES SHALL EXTEND 12" BRYONG FOR MINS STRACKERD AT 3" OLD. PRINCES SHALL EXTEND 12" BRYONG FOR MINS STRACKERD AT 3" OLD. PRINCES SHALL EXTEND 12" BRYONG FOR MINS STRACKERD AT 3" OLD. PRINCES SHALL EXTEND 12" BRYONG FOR MINS STRACKERD AT 3" OLD. PRINCES SHALL EXTEND 12" BRYON
- 3. ALL 4 4 POSTS SHALL EX MONORED TO SLABS by SURPOIN MEMALE POST MASS (NR FOLDAL) MAG 6 & POSTS TO SE MISSTALLE WITH 70 CR FOLKS (NR FOLK) MAG 6 POSTS TO SE MISSTALLE WITH 70 CR FOLKS AT 10 CM (NR FOLKS) A

#### BRACED WALL DESIGN NOTES:

- BRACES MALL ESSEN MOTES:

  1. BRACED WALL DESCRIPE OF STOTION REGISTRO OF THE NICHO: 2016 EDITION.

  2. CHAPP STITES TO "CONTRIGUOUS SHATHING" MODD STRICTURE.

  ATTINISED OF THE NICHOLOGY OF OLD ALL DETERMENT WALLS STATIONED / SO NALL DETERMENT OF WALLS STATIONED / SO NALL DETERMENT WALL DETERMENT WALLS STATIONED / SO NALL DETERMENT WALLS WALL DETERMENT WALLS WALL DETERMENT WALL DET


- PER SECTION R602.10.4.6 OF THE 2018 NCRC, THE AMOUNT OF BRACING REQUIRED ON THE WALK OUT BASEMENT WALLS EXCEEDS THE AMOUNT

	OF BRACING ON THE WALL ABOVE MULTIPLIED BY A FACTOR OF 1.15.
2.	SHEATH ALL EXTERIOR WALLS WITH 7/16" OSB SHEATHING ATTACHED
	WITH 8d NAILS AT 6" O.C. ALONG PANEL EDGES AND 12" O.C. IN THE FIELD.

LINTEL SCHEDULE FOR BRICK/NATURAL STONE SUPPORT		
LENGTH (FT.) SIZE OF LINTEL		
UP TO 4 FT.	L 3 1/2 x 3 1/2 x 1/4	
4-8	L 5 x 3 1/2 x 5/16 LLV	
8 AND GREATER	L 6 x 4 x 5/16 LLV	
BRICK SUPPORT NOTES:		
LINTEL SCHEDULE APPLIES TO ALL OPENINGS IN BRICK VENEER (UND), SEE ARCH DWGS, FOR SIZE AND LOCATION OF OPENINGS.		

- AND LOCATION LOT OF PRINCES OF MINES, THE SEA MINISTER OF THE SEA OF THE SEA



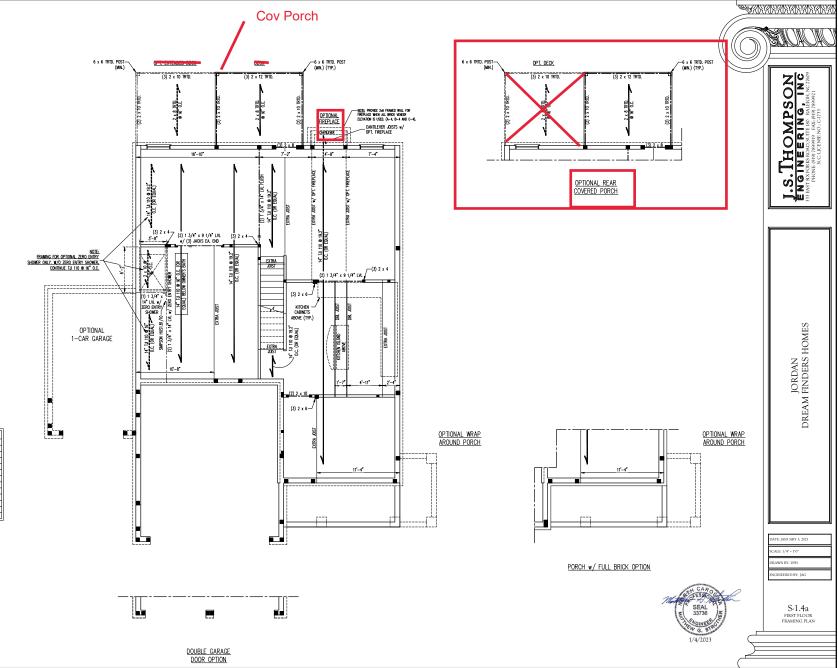

CONTR. 2-1 1/2

FILL BETWEEN HEADERS SOLID w/ KING STUDS. STRAP HEADER: TOGETHER w/ (2) 5' LONG SWIPSON CS16 STRAPS INSTALLED TO & BOTTOM ON THE INSIDE FACE OF THE HEADERS

CONTR. 2'-0"

DOUBLE GARAGE

DOOR OPTION

OI= Š HOMPS J.S. TE

SEAL 33736

UP TO 4 FT. L 3 1/2 x 3 1/2 x 1/4 L 5 x 3 1/2 x 5/16 LLV 4-8

8 AND GREATER

L 6 x 4 x 5/16 LLV

ATE: IANUARY 3, 2023

JORDAN FINDERS HOMES

DREAM


GINEERED BY: 1AC

S-2 SECOND FLOOR FRAMING PLAN

WINDOW BOX DETAIL

x 8 FLOOR JOISTS @

Frame Down Per Detail on Second Floor Architectural Sheet.

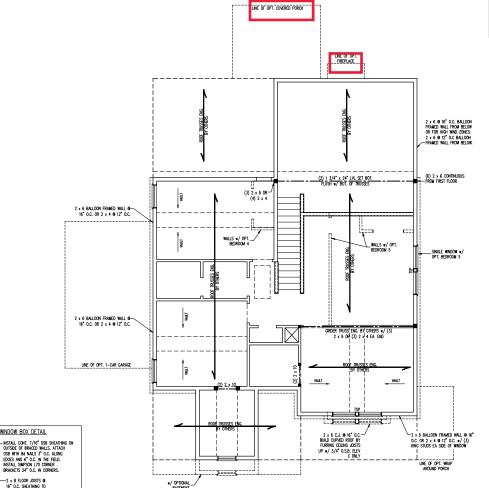

BRACED WALL ESSAIR NOTES.

I BRACED WALL ESSAIR PER SECTION PROZ.10 OF THE MORE 2018 EDITION.

2. CS-WED RETERS TO "CONTINUOUS SECRIFING.— WOOD STRUCTURAL PARALS" CONTINUES ES TO INSTALL TIANGE SEE ON LESS AND 12 OCC. IN THE FIRST.

ATTACHED W/ 88 ANALS SPACED 6" CD. ALONG PARAL EINES AND 12 OCC. IN THE FIRST.

3. "ASR RETERS TO "CRITICATION DESIRED" CONTINUED ON THE ARKS INSTALL 1/2" (MAN. OFFSMI MALL BOMD WEER WRITED ON THE PLANK INSTALL 1/2" (MAN. OFFSMI MALL BOMD WEER WRITED ON THE PLANK INSTALL 1/2" (MAN.)

GHISMI MALL BANDO MENG NOTED ON THE PLANS YASIEN MEN HIM IN 1/4" SOERIES OF 15 MEN SHAPE OF O.C. ALMOR PAREL EDES AND IN THE FIELD INCLIDIOS TOP AND BOTTOM PLATES.

BRACED MALL DESAN PAPEL DN IND YOURS UP TO 130 MPH. FOR HICH MIN ZORES, BRACE MALLS ARE TO SE CONSTRUCTED IN ACCORDANCE WHILE AND THE OWNER OF SECONSTRUCTED IN ACCORDANCE WHILE AND CONTROL OF THE OWNER OF SECONSTRUCTED IN ACCORDANCE WHILE AND CONTROL OF THE OWNER OF THE OWNER OF THE OWNER OWNER.

SEE NOTES AND DETAIL SHEETS FOR AUDITIONAL BRACED MALL INFORMATION.

NOTE:

PER SECTION R802/10.3.2 OF THE 2018 NORC, THE AMOUNT OF BRAIDNS ON THE SECOND FLOOR DICKEDS THE AMOUNT REQUIRED FOR THE RRST FLOOR AND ON BRACED WAIL ANNIYSS IS REQUIRED.
 SHEATH ALL EXTERIOR WAILS WITH 7/8° COB SHEATHING ATTACHED WITH BU MAILS AT 6° O.C. ALONG PANEL EDGES AND 12° O.C. IN THE FEED.

HEADER SPAN	MININUM NUMBER OF FULL
(FEET)	HEIGHT STUDS (KINGS)
UP TO 3'	1
> 3' 10 6'	2
> 6' 10 9'	3
> 9' TO 12'	4
> 12' TO 15'	5

\*NOTE: ALL EXTERIOR WALLS AND ATTIC WALLS ARE TO BE 2 x 6 @ 16" O.C. (UNO). 2 x 4 @ 16" O.C. EXTERIOR WALLS MAY BÉ CONSTRUCTED IN LIEU OF 2 x 6 WALLS (UNO). ALL INTERIOR LOAD BEARING WALLS ARE TO BE 2 x 4 @ 16" O.C. (UNO) AND NON-LOAD BEARING INTERIOR WALLS ARE TO BE 2 x 4 @ 24" O.C. (UNO).

LINTEL SCHEDULE FOR BRICK/NATURAL STONE SUPPORT	
LENGTH (FT.)	SIZE OF LINTEL
UP TO 4 FT.	L 3 1/2 x 3 1/2 x 1/4
4-8	L 5 x 3 1/2 x 5/16 LLV
8 AND GREATER	L 6 x 4 x 5/16 LLV
BRICK SUPPORT NOTES:	

#### LINTEL SCHEDULE APPLIES TO ALL OPENINGS IN BRICK VENEER (UNO). SEE ARCH DWGS. FOR SIZE AND LOCATION OF OPENINGS.

(LLV) = LONG LEG VERTICAL LENGTH = CLEAR OPENING

3. LINGHT - GLER CREAM - LACH SEE NO NAME - LACH SEE NAME - LA

#### STRUCTURAL NOTES:

all framing lumber to be SPF  $_4$ 2 (uno). All treated lumber to be SYP  $_4$ 2 (uno.) All load bearing headers to be (2) 2 x 6 (uno). Window and door headers to be supported  $_{\rm w}/$  (1)

JACK STUD AND (J) KING STUD EA. END (UNO.). SEE TABLE R602.7.5 FOR ADDITIONAL KING STUD REQUIREMENTS. SQUARES DENOTE POINT LOADS WHICH REQUIRE SOLID BLOCKING TO GRODER OR FOUNDATION. ALL SQUARES TO

BLOOMED TO GREER OR FOUNDAME. ALL SOURCES TO FEE (9) STUDE (MILL DETERMINED TO BE FEE (9) STUDE (MILL DETERMINED TO BE FEE (9) STUDE (MILL DETERMINED TO BE FEE (10) STUDE (

	LEGEND
CONT	CONTINUOUS
X.J	EXTRA JOIST
DJ	DOUBLE JOIST
TJ	TRIPLE JOIST
EA	EACH
()	NUMBER OF STUDS
DSP	DOUBLE STUD POCKET
TSP	TRIPLE STUD POCKET
0C	ON CENTER
SPF	SPRUCE PINE FIR
SYP	SOUTHERN YELLOW PINE
TRTD	PRESSURE TREATED
TYP	TYPICAL
UNO	UNLESS NOTED OTHERWISE

ATE: IANUARY 3, 2023 AWN BY: DE GINEERED BY: 1AC

> S-3 CEILING FRAMING PLAN





JORDAN FINDERS HOMES DREAM

#### BRICK SUPPORT NOTE:

- 1. FASTEN (1) 2: 10 BOOMS ETHEN WILL STUDS (4) 10 BOOMS ETHEN WILL STUDS (4) 10 BOOMS ETHEN WILL STUDS (4) 10 BOOMS (4) BOOMS (5) ETHEN A  $6^{+}$  ×  $7^{+}$ /8 TEROIN POTAL 20: 10 BOOMS (4) (2) 1/2 LUS SSEES 6 12 10 BOOMS (4) (2) 1/2 LUS SSEES 6 12 10 BOOMS (4) (2) 1/2 LUS SSEES 6 12 10 BOOMS (4) ETHEN FORMATION.

  2. MEETER ROOT SOURCE SUCRED 71/2 BOOMS (3) BOOMS (3) BOOMS (3) BOOMS (4) BOOMS (

#### STRUCTURAL NOTES:


- STRUCTURAL NOTICS.


  ALL FRAMING LIMBERT TO BE \$12.5PF.

  (MON).

  (MON).

LEGEND	
XT	EXTRA TRUSS
TS	TRUSS SUPPORT
XR	EXTRA RAFTER
RS	RAFTER SUPPORT
CONT	CONTINUOUS
EA	EACH
00	ON CENTER
SPF	SPRUCE PINE FIR
SYP	SOUTHERN YELLOW PINE
ΠP	TYPICAL
UNO	UNLESS NOTED OTHERWISE

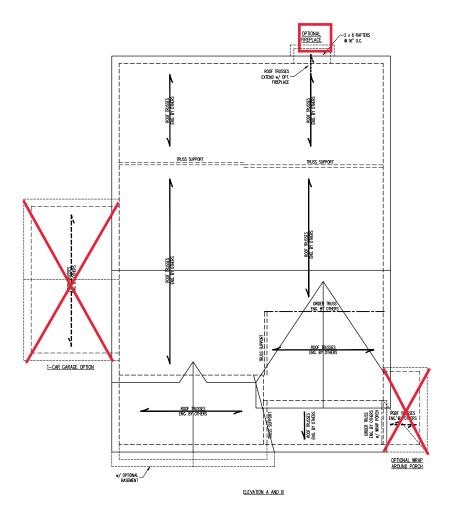

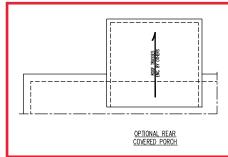

I.S. THOMPSON

ENGINEERING, INC.
HOLEGING SAME CALLOR
HOLEGING SAME CALLOR
HOLEGING SAME CALLOR

FOR ENGINEERING SAME CALLOR

FOR EN

JORDAN FINDERS HOMES DREAM I

DATE: JANUARY 3, 2023 NGINEERED BY: IAG


S-4a ROOF FRAMING PLAN



ENGINEERED BY: JST

D.1

FOUNDATION DETAILS

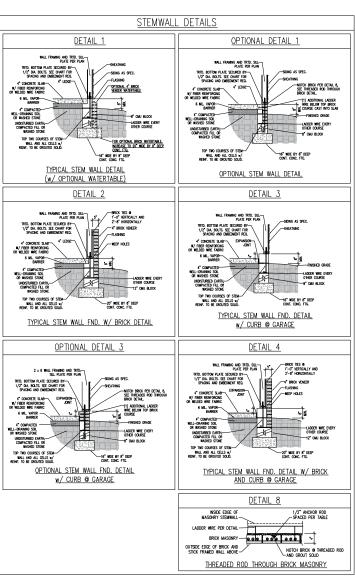

MONOLITHIC SLAB DETAILS

DETAIL 2

1-4

1'-4"

GARAGE CURB BRICK LEDGE DETAIL

DETAIL 6

6 1-0 6 6

STEP IN GARAGE DETAIL

BRICK VENEER DETAIL

DETAIL 4

-5" LEDGE

2-8 HOMEONIALT 4 BROCK VENEER

FLASHING

VEEP HOLES

G

5 LEDGE

To §

" CONCRETE SLAB W/ FIBER REINFORCIN

TRTD. BOTTOM PLATE SECURED BY— 1/2" DIA. BOLTS. SEE CHART FOR SPACING AND EMBEDMENT REQ.

4" CONCRETE SLAB-

UNDISTURBED EARTH, COMPACTED— FILL OR WASHED STONE

COMPACTED WELL-DRAWING-

NOISTURBED EARTH, COMPACTED—

TRTD. BOTTOM PLATE SECURED BY-1/2" DIA. BOLTS. SEE CHART FOR SPACING AND EMBEDMENT REQ.

4" CONCRETE SLAB

DETAIL 1

TYPICAL SLAB DETAIL

DETAIL 3

-SDNC AS SPEC

WALL FRAMING AND TRTD. SILL— PLATE PER PLAN

GARAGE CURB DETAIL

DETAIL 5

5" PER PLAN 5"

THICKENED SLAB DETAIL

DETAIL 7

1-4

SLAB AT GARAGE DOOR DETAIL

SLOPE SLAB 1/8" PER FOOT \$

" CONCRETE SLAR-

6 ML VAPOR BARRER

UNDISTURBED EARTH, COMPACTED—


4" CONCRETE SLAR-

6 ML VAPOR BARRIER— 4" COMPACTED WELL-DRAWING— SOIL OR WASHED STONE

COMPACTED WELL-DRAINING-SOIL OR WASHED STONE

WALL FRAMING AND TRTD. SILL— PLATE PER PLAN

4" CONCRETE SLAB-

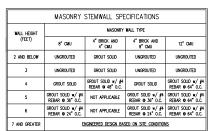

- WALL HEIGHT MEASURED FROM TOP OF FOOTING TO TOP OF THE WALL.
  TIE MULTIFLE WYTHES TOSETHER WITH LADGER MISE AT 16" O.C. VERTICALLY,
  O'LART APPLICABLE FOR HOUSE FOUNDATION <u>ONLY</u>, CONSULT ENGINEER FOR DESIGN OF GARAGE
  FOUNDATION NOT COMMON TO HOUSE.

- FOUNDATION HOT COMMON TO HOUSE.

  BOCKFILL OF CAMEN TO HOUSE SAME IS TONE IS ALLOWABLE.

  BOCKFILL OF WILL BRANDED OR SAME GRAVE, MOTHER SOLS (45 PS\*/FT BELOW GRADE) CLASSIFIED AS GROUP I ACCORDANCE WITH JEBUS PHÁSAL OF THE 2018 INTERNATIONAL RESIDENTIAL CODE ARE ALLOWABLE.

  FOR THE 2018 INTERNATIONAL RESIDENTIAL CODE ARE ALLOWABLE.

  FOR SALE PARE BREAKEL AND RESIDES, 24 ARE OF THE 2018 INTERNATIONAL RESIDENTIAL CODE.

- MINIONING 24 THE DESCRIPTION DESCRIPTION WALL.

  LOCATE REAR IN CENTER OF FOUNDATION WALL.

  LOCATE REAR IN CENTER OF FOUNDATION WALL.

  GROUTING METHOD REQUIRED WHEN FILLING WALLS WITH GROUT AT HEIGHTS OF 5' AND GREATER.

		ANCHOR SPACING AND EMBEDMENT				
l	WIND ZONE		120 MPH	130 MPH		
			INSTALL MIN. (2) ANCHORS PER PLATE SECTION AND (1) ANCHOR	4'-0" O.C. Install Min. (2) Anchors Per Plate Section and (1) Anchor Within 12" of Corners		
		EMBEDMENT	ブ	15" INTO MASONRY 7" INTO CONCRETE		

#### NOTE:

Threaded roo with epoxy, smpson titen HD, or approved anchors spaced as required to provide equivalent anchorage to  $1/2^{\circ}$  diameter anchor bolts may be used in Lieu of  $1/2^{\circ}$  anchor bolts.

hitectural pages or shop draw or others is a punishable offer under N.C. Statute § 89C2:



NON-ഗ HOMPS S. IL

> SPEED DESIGN WIND S S AND DETAILS S HOMES ) MPH ULTIMATE DI BRACING NOTES A DREAM FINDERS H - 130 'ALL I MPH.

ATE: NOVEMBER 28, 2022

OKNEERED BY IST

D-2 BRACED WALL NOTES AND DETAILS AND PF DETAIL


GENERAL WALL BRACING NOTES:


USING THE CONTROL OF THE CORE WAS CONTROLLED FOR THE CORE FOR CRESCHILD BUILDING CODE (ICNSC). TABLES AND THE STRENGT OF THE CORE FOR CRESCHILD BUILDING CODE (ICNSC). TABLES AND THE STRENGT OF THE CORE FOR CRESCHILD BUILDING CODE (ICNSC). TABLES AND THE STRENGT OF THE CORE FOR CRESCHILD BUILDING CODE (ICNSC). TABLES AND THE CORE FOR CRESCHILD BUILDING CODE (ICNSC). THE SEED OF THE CORE FOR CRESCHILD BUILDING CODE (ICNSC) AND THE CRESCHILD BUILDING CODE (ICNSC). THE SEED OF THE CORE FOR CRESCHILD BUILDING CODE (ICNSC) AND THE CRESCHILD BUILDING CODE (ICNSC). THE CORE FOR CRESCHILD BUILDING CODE (ICNSC) AND THE CRESCHILD BUILDING CODE (ICNSC) AND THE CRESCHILD BUILDING CODE (ICNSC). THE CORE FOR CRESCHILD BUILDING CODE (ICNSC) AND THE CRESCHILD BUILDING CODE (ICNSC). THE CORE FOR CRESCHILD FOR TABLE FOR CASE.

ALL CREENED AND INTERER MUST ON THAT I'S CRESCHILD FOR TABLE FOR CASE.


ALL CREENED AND INTERER MUST ON THAT I'S CRESCHILD FOR TABLE FOR CASE.


COS-WER PEREZE TO THE "CONTINUOUS SEALANING— WOOD STRUCTURAL PRACES" WILL BRACING METHOD. 7/16" OSS SEATANING— WOOD STRUCTURAL PRACES" WILL BRACING METHOD. 7/16" OSS SEATANING— WOOD STRUCTURAL PRACES" WILL BRACING METHOD. 7/16" OSS SEATANING— WOOD STRUCTURAL PRACES" WILL BRACING METHOD. 7/16" OSS SEATANING SOON SEATANING— WOOD TO CO. THE CREDITION AND SEATANING SOON SEATANING— WOOD TO CO. THE CREDITION OF THE CONTINUOUS PRACES WILL BRACING METHOD. 7/16" OSS SEATANING— WOOD TO CO. THE CREDITION OF THE CONTINUOUS PRACES WILL BRACING METHOD. TO CONTINUOUS PRACES WILL BRACING WILL

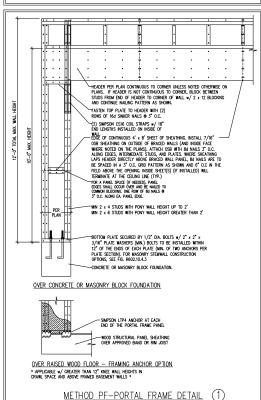

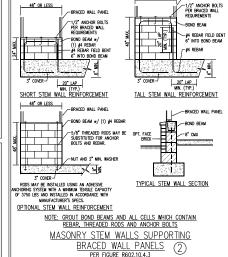


48\* OR LESS \_\_\_ BRACED WALL PANEL

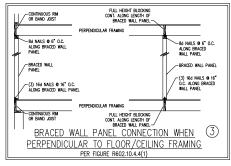


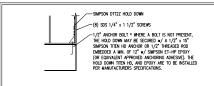


HOLD DOWN DETAIL FOR MASONRY FOUNDATION OR MONOLITHIC SLAB


\* APPLICABLE ONLY WHERE SPECIFIED ON PLAN \*

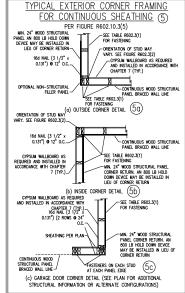

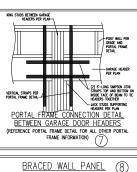

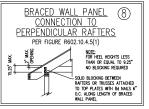

BRACED WALL PANEL CONNECTION WHEN PARALLEL (6) TO FLOOR/CEILING FRAMING PER FIG. R602.10.4.4(2) FULL HEIGHT BLOCKING @ 16" O.C. ALONG LENGTH OF BRACED WALL PANEL 8d nails @ 6" O.C. Along -8d NAILS @ 6" O.C. ALONG BRACED WALL PANEL BRACED WALL PANEL -RRACED WALL PANEL -BRACED WALL PANEL (3) 16d NAILS @ 16\* O.C. AT EA. BLOCKING WEMBER (3) 16d NAILS @ 16" O.C. -(3) 16d NAILS @ 16" O.C. ALONG BRACED WALL PANEL ALONG BRACED WALL PANEL (2) 16d NAILS EA. SIDE ADDITIONAL FRAMING MEMBER DIRECTLY BELOW BRACED WALL PANEL FULL HEIGHT BLOCKING & 16 O.C. ALONG LENGTH OF HOUS PIN w/ FINCES JOISTS OR DBL. BAND JOIST BRACED WALL PANEL

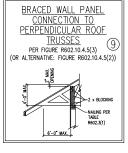

is sealed more is to be used in conjunction with a full plan set envineered by L ns season page is to be used in conjunction with a tou jurn set engineered by j.

Thompson Engineering, Inc. only. Use of this individual seaded page within

Thompson Engineering, Inc. only. Use of this individual seaded page within

Thompson Engineering, Inc. only. Use of this individual seaded page within

Thompson Engineering, Inc. only. Use of this individual season Engineering

Thompson Engineering, Inc. only. Use of this individual season Engineering

Thompson Engineering

Thompson



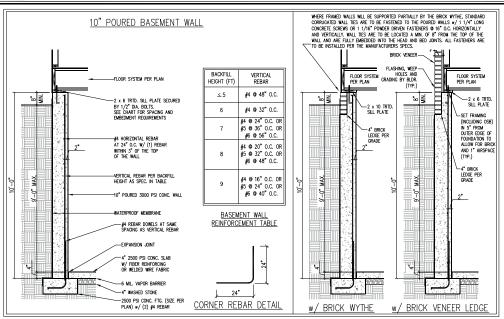

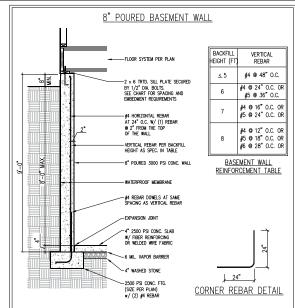

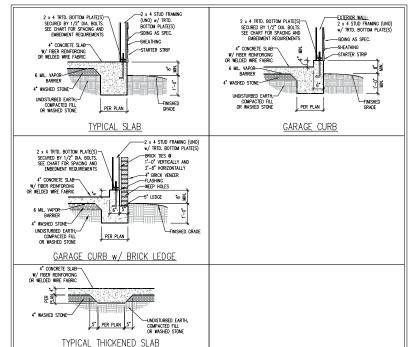

	ANCHOR SPACING AND	EMBEDMENT	NOTE:
WIND ZONE	120 MPH	130 MPH	THREADED ROD WITH EPOXY,
SPACING	6'-0" O.C. INSTALL MIN. (2) ANCHORS PER PLATE SECTION AND (1) ANCHOR WITHIN 12" OF CORNERS	4'-0" O.C. INSTALL MIN. (2) ANCHORS PER PLATE SECTION AND (1) ANCHOR WITHIN 12" OF CORNERS	SIMPSON TITEN HD, OR APPROVED ANCHORS SPACED AS REQUIRED TO PROVIDE EQUIVALENT ANCHORAGE TO 1/2" DIAMETER ANCHOR BOLTS
EMBEDMENT	7"	15" INTO MASONRY 7" INTO CONCRETE	MAY BE USED IN LIEU OF 1/2" ANCHOR BOLTS.

#### IMPORTANT NOTE:

FOUNDATIONS AS DENOTED IN THESE DETAILS ARE <u>NOT</u> SUITABLE FOR SUPPORT OF ADDITIONAL SURCHARGE LOADING FROM ADJACENT STRUCTURES OR DRIVEWAYS. FOUNDATIONS WITH EXTRA LATERAL LOADING IN THESE SCENARIOS WILL REQUIRE LOT SPECIFIC DESIGN ON A CASE BY CASE BASIS, CONSULT THE ENGINEER OF RECORD WHEN PLANNING TO BUILD IN CLOSE PROXIMITY TO THE FOUNDATION AS WE WILL NOT BE HELD LIABLE FOR FOUNDATION FAILURE. SEE R403.1.9 OF THE 2018. NCRC FOR ADDITIONAL INFORMATION.

#### STRUCTURAL NOTES:

- . FOR #4 REBAR, 24" MINIMUM REBAR LAP SPLICE LENGTH. FOR #5 REBAR, 32" MINIMUM REBAR LAP SPLICE

- FOR JA FEBRA, 24' MINIMAM REBAR LAP SPLOE LINCHH. FOR JA FEBRA, 32' MINIMAM REBAR LAP SPLE LENCHT. FOR JAR FEBRA, 25' MINIMAM LEBBAR LAP SPLOE LENCH REBAR TO MANTAIN A MINIMAM CONNECTE COVER OF 3' (MINO.) SOIL BERANC CAPACITY IS REQUIRED TO BE 2000 PS' MINO. SOIL BERANC CAPACITY IS REQUIRED TO BE 2000 PS' MINO. SOIL BERANC CAPACITY IS REQUIRED TO BE 2000 PS' MINO. SOIL BERANC CAPACITY AND THE STATE OF THE STATE OF THE SECOND TO ALLOW THE CONNECTE TO GUIRE BEFORE THE BACKEL CAPACITY CAPACITY OF BACKFUL IS RECOMMENDED TO BE PARTED IN THE BACKFUL CAPACITY AND THE STATE LID. THE BACKFUL IS RECOMMENDED TO BE
- PLACED IN 12" LIFTS AND CAREFULLY TAMPED.
- PLACED IN 12. LIFES AND CAMEDILLY TAMPED.

  A 4 "LEDIE IS TO BE PROVIDED FOR THE PORCH SLAB. THE WALLS ARE REQUIRED TO BE BONDED TO THE SLABS USING \$4 \times 50" REBAR DOWERS 32" O.C. DIRECTOR 4" NITO THE CONC. USING FORY.

  WHERE THE FLOOR JUSTIS ARE PARALLEL TO THE WALLS, 2 \times 4 BLOCKING IS TO BE INSTALLED 24" O.C. BETWEEN THE BOTTOM FLANCES OF THE 1"-OISTS FOR A MIN. OF 6"-0" AWAY FROM THE WALL OR. DIAGONAL 2 x 6 BLOCKS MAY BE INSTALLED 24" O.C. FROM THE EDGE OF THE SILL PLATE TO THE TOP FLANGE AND SUBFLOORING, ATTACHED W/ (3) 12d NAILS EACH END.

#### NOTE TO FOUNDATION CONTRACTOR:

ALTERNATE REINFORCED CONCRETE POURED WALL DESIGNS ENGINEERED BY OTHERS MAY BE CONSTRUCTED. NO CONTINUOUS FOOTINGS OR LUG FOOTINGS MAY BE REDUCED IN SIZE.



This sealed page is to be used in conjunction with a full plan set engineered by J.S. Thompson Engineering, Inc. only. Use of this individual sealed page within rchitectural pages or shop drawings by others is a punishable offense under N.C. Statute § 89C-23

N N N ത് THOMPS INEERING, S S

> 130 MPH ULTIMATE DESIGN WIND SPEED WALL BASEMENT FOUNDATION DETAILS DREAM FINDERS HOMES 120 MPH.
> POURED

DATE: NOVEMBER 29, 2022

OWNEERED BY: JST

FOUNDATION DETAILS D-3

## ATE: JUNE 17, 2022

CONSERED BY IST

S-0 STRUCTURAL NOTES

GENERAL NOTES

- ENGINEER'S SEAL APPLIES ONLY TO STRUCTURAL COMPONENTS INCLUDING ROOF RAFTERS, HIPS, VALLEYS, RIDGES, FLOORS, WALLS, BEAMS, HEADERS, COLUMNS, CANTILEVERS, OFFSET LOAD BEARING WALLS, PIERS, GROER SYSTEM AND FOOTING. ENGINEER'S SEAL DOES NOT CRITIFY DIMENSIONAL ACCURACY OF ARCHITECTURAL LAYOUT INCLUDING ROOF. ENGINEER'S SEAL DOES NOT APPLY TO 1-JOIST OR FLOOR/ROOF TRUSS LAYOUT DESIGN AND
- 2. ALL CONSTRUCTION SHALL CONFORM TO THE LATEST REQUIREMENTS OF THE NORTH CAROLINA RESIDENTIAL CODE (NORC), 2018 EDITION, PULS ALL LOCAL CODES AND REQUIATIONS. THE STRUCTURE MEMBER IS NOT RESPONSIBLE FOR, AND MILL NOT HAVE CONTROL OF, CONSTRUCTION HORS, METHODS, TECHNIQUES, CORPORATINGS, OR PROFESSIONAL IN CONSISTENT METHOD RECORD WRISE. OR PREFET PROFESSIONAL IN CONSISTENT METHOD RECORD WRISE. AND MILL THE CONSTRUCTION WORK IN ACCORDANCE WITH THE CONTRACT DOCUMENTS.
- 3. STRUCTURAL DESIGN BASED ON THE PROVISIONS OF THE NCRC, 2018 EDITION (R301.4 R301.7)

DESIGN CRITERIA:	LIVE LOAD (PSF)	DEAD LOAD (PSF)	DEFLECTION (IN)
ATTIC WITH LIMITED STORAGE	20	10	L/240 (L/360 w/ BRITTLE FINISHES)
ATTIC WITHOUT STORAGE	10	10	L/360
DECKS	40	10	L/360
EXTERIOR BALCONIES	40	10	L/360
FIRE ESCAPES	40	10	L/360
HANDRAILS/GUARDRAILS	200	10	L/360
PASSENGER VEHICLE GARAGE	50	10	L/360
ROOMS OTHER THAN SLEEPING ROOM	40	10	L/360
SLEEPING ROOMS	30	10	L/360
STAIRS	40	10	L/360
WIND LOAD	(BASED ON TABLE R301.2(4) WIND ZONE AND EXPOSURE)		
GROUND SNOW LOAD: Pa	20 (PSF)	-(,,,	

- I–JOIST SYSTEMS DESIGNED WITH 12 PSF DEAD LOAD AND DEFLECTION (IN) OF L/480 FLOOR TRUSS SYSTEMS DESIGNED WITH 15 PSF DEAD LOAD
- 4. FOR 115 AND 120 MPH WIND ZONES, FOUNDATION ANCHORAGE IS TO COMPLY WITH SECTION R403.1.6 OF THE NORC, 2018 EDITION. FOR 130 MPH, 140 MPH, AND 150 MPH WIND ZONES, FOUNDATION ANCHORAGE IS TO COMPLY WITH SECTION 4504 OF THE NCRC, 2018 EDITION.
- 5. ENERGY EFFICIENCY COMPLIANCE AND INSULATION VALUES OF THE BUILDING TO BE IN ACCORDANCE WITH CHAPTER 11 OF THE NCRC, 2018 EDITION.

#### FOOTING AND FOUNDATION NOTES

- 1. FOUNDATION DESIGN BASED ON A MINIMUM ALLOWABLE BEARING CAPACITY OF 2000 PSF. CONTACT GEOTECHNICAL ENGINEER IF BEARING CAPACITY IS NOT ACHIEVED.
- 2. FOR ALL CONSIDETE SLABS AND FORDING, THE AREA, WHINE THE PRESENCE OF THE BULDING DIRECTOR SHALL HAVE ALL MECHANIC TO SOIL AND FORSION MARKEN. THE BULDING HE OWNERFOR THE STATE OF THE LINGHIE OF COMPONENT TO ASSISTE UNKNOW SEPPORT OF THE STAN, AND EXCEPT WARREN SEPPORT OF THE STAN, AND EXCEPT WARREN APPROVED THE FILL KEPING SHALL NOT EXCEPT OF THE OWNERFOR THE AREA. AND THE STAN SHALL SHALL
- 3. PROPERLY DEWATER EXCAVATION PRIOR TO POURING CONCRETE WHEN BOTTOM OF CONCRETE SLAB IS AT OR BELOW WATER TABLE. IF APPLICABLE, 3/4" 1" DEEP CONTROL JOINTS ARE TO BE SAMED WITHIN 4 TO 12 HOURS OF CONCRETE FINISHING AND WALL LOCATIONS HAVE BEEN MARKED. ADJUST INVERE NECESSARY.
- 4. CONCRETE SHALL CONFORM TO SECTION PRO2.2 OF THE NORC, 2018 EDITION. CONCRETE REINFORMS STEEL TO BE ASTM A615 GRADE 60. NELDED WIRE FARRIC TO BE ASTM A615 GRADE 60. NELDED WIRE FARRIC TO BE ASTM A615. MANITAN A MANUMUL CONCRETE COVER ADDIOUR DESTROPENDE STEEL OF 3" IN FOOTINGS AND 1.1/2" IN SAME TO REFUSE OF REPORT OF THE TOWN THE NORE FACE OF THE WALL JAM TO BE LESS THAN 3.4". CONCRETE COVER FOR REPORTIONS STEEL MASSING FROM THE OUTSIDE FACE OF THE WALL SHALL NOT BE LESS THAN 1.1/2" FOR JAMES OF MALELY, AND NOT LESS THAN 2" FOR JAMES OF MALET.
- 5. MASONRY UNITS TO CONFORM TO ACE 530/ASCE 5/TMS 402. MORTAR SHALL CONFORM TO ASTM C270.
- 6. THE UNSUPPORTED HEIGHT OF MASONRY PIERS SHALL NOT EXCEED FOUR TIMES THEIR LEAST DIMENSION FOR UNFILLED HOLLOW CONCRETE MASONRY UNITS AND TON TIMES THEIR LEAST DIMENSION FOR SULD OR SOLID PIERD FIESD. FORS MAY BE FLIED SULD WITH CONCRETE OR TYPE M OR S MORTAR. PIERS AND WALLS SHALL BE CAPPED WITH 8" OF SOLID MASONRY
- THE CENTER OF EACH OF THE PIERS SHALL BEAR IN THE MIDDLE THIRD OF ITS RESPECTIVE FOOTING, EACH GROER SHALL BEAR IN THE MIDDLE THIRD OF THE PIERS.
- A. LL COMENTE MA MASSIME FOUNDAMENTAL MALE TO BE CONSTRUCTED IN ACCOUNTED THE THE PROPERTIES OF SECTION AND OF THE MORE, THE DETRING HE MASSIMENT AND ALL AND ASSIMENT AND ASSIMENT AND ASSIMENT AND ASSIMENT FOUNDAMENT AND ASSIMENT FOUNDAMENT AND ASSIMENT FOUNDAMENT AND ASSIMENT FOUNDAMENT FOUNDAMENT FOUNDAMENT FOUNDAMENT FOUNDAMENT FOUNDAMENT FOUNDAMENT AND ASSIMENT FOUNDAMENT FOUNDAMEN WALLS AT 16" O.C. WHERE CRADE PERMITS (UNO).

This sealed page is to be used in conjunction with a full plan set engineered by LS. Thompson Engineering Inc. only. Use of this individual sealed page within architectural pages or shop drawings by others is a punishable offense under N.C. Statute § 89C-23

- FRAMING NOTES ALL FRAMING LUMBER SHALL BE #2 SPF MINIMUM (Fb = 875 PSI, Fv = 375 PSI, E = 1600000 PSI) UNLESS NOTED OTHERWISE (UNO). ALL
  TREATED LUMBER SHALL BE #2 SYP MINIMUM (Fb = 975 PSI, Fv = 175 PSI, E = 1600000 PSI) UNLESS NOTED OTHERMISE (UNO).
- LAMMATED VENEZE LUMBER (LVL) SHALL HAVE THE FOLLOWING MINAUM PROPERTIES: Fo =2000 PSI, Fv = 285 PSI, E = 1900000 PSI. LAMMATED STRAND LUMBER (LSL) SHALL HAVE THE FOLLOWING MINAUM PROPERTIES: Fo = 2025 PSI, F = 310 PSI, E = 150000 PSI. PARALLE STRAND LUMBER (PSI.) PTO 7 FORTH SHALL HAVE THE FOLLOWING MINAUM PROPERTIES: F = 2020 PSI, F = 1000000 PSI. PARALLEL STRAND LUMBER. (PSL) MORE THAN 7" DEPTH SHALL HAVE THE FOLLOWING MINIMUM PROPERTIES: Fc = 2900 PSI, E = 2000000 PSI. INSTALL ALL CONNECTIONS
- 3. STRUCTURAL STEEL SHALL CONFORM TO THE FOLLOWING ASTM SPECIFICATIONS

A.	W AND WT SHAPES:	ASTM A992
В.	CHANNELS AND ANGLES:	ASTM A36
C.	PLATES AND BARS:	ASTM A36
D.	HOLLOW STRUCTURAL SECTIONS:	ASTM A500 GRADE B
E.	STEEL PIPE:	ASTM A53, GRADE B. TYPE E OR S

4. STEEL BEAMS SHALL BE SUPPORTED AT EACH END WITH A MINIMUM BEARING LENGTH OF 3 1/2" AND FULL FLANGE WIDTH (UNO). PROVIDE SOLID REARING FROM REAM SUPPORT TO FOUNDATION. BEAMS SHALL BE ATTACHED AT THE BOTTOM FLANGE TO EACH SUPPORT AS FOLLOWS (UND):

A. WOOD FRAMING	(2) 1/2" DIA. x 4" LONG LAG SCREWS
B. CONCRETE	(2) 1/2" DIA. x 4" WEDGE ANCHORS
C. MASONRY (FULLY GROUTED)	(2) 1/2" DIA. x 4" LONG SIMPSON TITEN HD ANCHORS
D. STEEL PIPE COLUMN	(4) 3/4 DIA. A325 BOLTS OR 3/16 FILLET WELD

LATERAL SUPPORT IS CONSIDERED ADEQUATE PROVIDING THE JOISTS ARE TOE NAILED TO THE 2x NAILER ON TOP OF THE STEEL BEAM, AND THE 2x NAILER IS SECURED TO THE TOP OF THE STEEL BEAM  $\mathbf{w}/(2)$  rows of self tapping screws  $\mathbf{o}$  16" o.c. or (2) rows of 1/2" diameter bolts  $\mathbf{o}$  16" o.c. if 1/2" bolts are used to fasten the nailer, the steel beam shall be fabricated  $\mathbf{w}/(2)$  rows of 9/16" diameter holes  $\mathbf{o}$ 

- 5. SQUARES DENOTE POINT LOADS WHICH REQUIRE SOLID BLOCKING TO GIRDER OR FOUNDATION. SHADED SQUARES DENOTE POINT LOADS FROM ABOVE WHICH REQUIRE SOLID BLOCKING TO SUPPORTING MEMBER BELOW.
- 6. ALL LOAD BEARING HEADERS TO CONFORM TO TABLE R602.7(1) AND R602.7(2) OF THE NCRC, 2018 EDITION OR BE (2) 2 x 6 WITH (1) JACK AND (1) KING STUD EACH END (UNO), WHICHEVER IS GREATER ALL HEADERS TO BE SECURED TO EACH JACK STUD WITH (4) 8d NAILS. ALL BEAMS TO E SUPPORTED WITH (2) STUDS AT EACH BEARING POINT (UNO). INSTALL KING STUDS PER SECTION R602.7.5 OF THE NORTH CAROLINA
- 7. ALL BEAMS, HEADERS, OR GIRDER TRUSSES PARALLEL TO WALL ARE TO BEAR FULLY ON (1) JACK OR (2) STUDS MINIMUM OR THE NUMBER OF JACKS OR STUDS NOTED. ALL BEAMS OR GROER TRUSSES PERPENDICULAR TO WALL AND SUPPORTED BY (3) STUDS OR LESS ARE TO HAVE 1 1/2" MINMUM BEARING (UNO). ALL BEAMS OR GROER TRUSSES PERPENDICULAR TO WALL AND SUPPORTED BY MORE THAN (3) STUDS OR OTHER NOTED COLUMN ARE TO BEAR FULLY ON SUPPORT COLUMN FOR ENTIRE WALL DEPTH (UNO). BEAM ENDS THAT BUTT INTO ONE ANOTHER ARE TO
- 8. FLITCH BEAMS SHALL BE BOLTED TOGETHER USING 1/2" DIAMETER BOLTS (ASTM A307) WITH WASHERS PLACED AT THREADED END OF BOLT. BOLTS SHALL BE SPACED AT 24" CENTERS (MAXIMUM), AND STAGGERED AT TOP AND BOTTOM OF BEAM (2" EDGE DISTANCE), WITH (2) BOLTS LOCATED AT
- 9. ALL 1-JOIST OR TRUSS LAYOUTS ARE TO BE IN COMPLIANCE WITH THE OVERALL DESIGN SPECIFIED ON THE PLANS. ALL DEWATIONS ARE TO BE BROUGHT TO THE ATTENTION OF THE ENGINEER OF RECORD PRIOR TO INSTALLATION.
- BRACED WALL PANELS SHALL BE CONSTRUCTED ACCORDING TO THE NORTH CAROLINA RESIDENTIAL CODE 2018 EDITION WALL BRACING CRITERIA. THE
  AMOUNT, LENGTH, AND LOCATION OF BRACING SHALL COMPLY WITH ALL APPLICABLE TABLES IN SECTION R602.10.
- 11. PROVIDE DOUBLE JOIST UNDER ALL WALLS PARALLEL TO FLOOR JOISTS. PROVIDE SUPPORT UNDER ALL WALLS PARALLEL TO FLOOR TRUSSES OR I-JOISTS PER MANUFACTURER'S SPECIFICATIONS. INSTALL BLOCKING BETWEEN JOISTS OR TRUSSES FOR POINT LOAD SUPPORT FOR ALL POINT LOADS ALONG OFFSET LOAD LINES.
- 12. FOR ALL HEADERS SUPPORTING BRICK VENEER THAT ARE LESS THAN 8'-0" IN LENGTH REST A 6" v 4" v 5/16" STEEL ANGE WITH 6" MINIMUM TWA MALE PROJECTS STORY WINDOWS AND A STATE OF THE PROJECT OF THE STELL ANGLE TO (2) 2 x 10 BLOCKING INSTALLED #/ (4) 12d HAILS EA. PLY BETWEEN WALL STUDS WITH (2) ROWS OF 1/2" LAG SCREWS AT 12" O.C. STAGGERED AND IN ACCORDANCE WITH SECTION R703.8.2.1 OF THE NCRC, 2018 EDITION.
- 13. FOR STICK FRAMED ROOFS: CIRCLES DENOTE (3) 2 x 4 POSTS FOR ROOF MEMBER SUPPORT. HIP SPLICES ARE TO BE SPACED A MINIMUM OF 8'-0". FASTEN WEMBERS WITH THREE ROWS OF 12d NAILS AT 16" O.C. FRAME DORMER WALLS ON TOP OF DOUBLE OR TRIPLE RAFTERS AS SHOWN
- 14. FOR TRUSSED ROOFS: FRAME DORMER WALLS ON TOP OF 2 x 4 LADDER FRAMING AT 24" O.C. BETWEEN ADJACENT ROOF TRUSSES. STICK FRAME OVER-FRAMED ROOF SECTIONS WITH 2 x 8 RIDGES, 2 x 6 RAFTERS AT 16" O.C. AND FLAT 2 x 10 VALLEYS (UNO).
- ALL 4 x 4 AND 6 x 6 POSTS TO BE INSTALLED WITH 700 LB CAPACITY UPUFF CONNECTORS TOP AND BOTTOM (NNO.) POSTS MAY BE SECURED USING ONE SUMPSION HO ITSEZ UPUFF CONNECTOR FASTENED TO THE BAND AT THE BOTTOM AND THE BOAM AT THE TOP OF EACH POST. ONE SECTION, OF SUMPSION COSTS COLD, SEPAPON WITH (6) BUT ON INAS AT EACH DOWN ATE VEILED BUT OF EACH THIS STRIPP IT ESSEND. FOR MASONRY OR CONCRETE FOUNDATION USE SIMPSON POST BASE.

