COLLEX403INVENTORYMARKEDPLAN


KENT

KENT REVISION LIST - STRUCTURAL:

KENT REVISION LIST - ARCHITECTURAL:

- ADDED NOTE TO EXTEND STAIR CLIP IN POWDER ROOM THE LENGTH OF THE ROOM (\$4.19).
- SHOWED AHU AND MECH. LOCATIONS ON SECOND FLOOR (3-19)
- UPDATED PLAN TO NEW CAD FORMAT AND ADDED COVER SHEET (3-19)
- UPDATED CUTSHEETS (3:19)
- CHANGED FIREPLACE FROM STANDARD TO OPTIONAL (7-25)
- CHANGE FIREPLACE FROM 36" TO 32". (11-21-19)
- ADDED ROOM DIMENSIONS, (11-21-19)
- CHANGE ROOM NAMES FROM MASTERS TO OWNERS. (11-21-19)
- VERIFIED AND UPDATED SQUARE FOOTAGE ON FIRST AND SECOND FLOOR. (11-21-19)
- ADDED ROOF VENTING CALCULATIONS FOR ELEV A. B. AND C. (11-29-19)
- ADDED GOURMET KITCHEN LAYOUT OPTION. (12-23-19)
- CHANGE FIREPLACE FROM STANDARD TO OPTIONAL. (12-23-19)
- REMOVE GLASS INSERTS AT GARAGE DOORS. (12-23-19) REMOVE METAL ACCESSORIES AT GARAGE DOORS, (12/23/19)
- UPDATED CUTSHEETS PER H&H STANDARDS. (1-16-20)
- CHANGE FIREPLACE FROM STANDARD TO OPTIONAL. (1-16-20) CALLED OUT REFRIGERATOR, WASHER, AND DRYER ARE OPTIONAL COMPONENTS. (1-16-20)
- VERIFIED COACH LIGHT LOCATIONS ON ALL ELEVATIONS (03-30-20)
- REMOVED GRIDS FROM WINDOWS AND DOORS ON ALL SIDE AND REAR ELEVATIONS (03-30-20)
- REMOVED ROOF HATCH FROM ALL ELEVATIONS (03:30:20)
- CHANGED NOTE FOR ALL GARAGES ON ELEVATIONS TO UPDATED NOTE (03-30-20)
- UPDATED HATCHES ON ALL ELEVATIONS TO REPRESENT STONE BETTER (03-30-20)
- ADDED ELEVATIONS TO SHOW STONE AND BRICK OPTIONS ON A-2, A-3, B-2, B-3, C-2, & C-3 (03-30-20)
- ADDED COLUMN DETAIL FOR B ELEVATIONS (03-30-20)
- FIXED WINDOW TRIM AND BRICK ROWLOCK ON B-3 & B-4 (03-30-20)
- VERIFIED AND UPDATED SQUARE FOOTAGE WITH & WITHOUT BRICK (03-30-20) ADDED DIAGONAL DIMENSIONS TO SLAB INTERFACE PLAN (03-30-20)
- ADDED OWNER'S BATH 2 & 3 IN OPTIONS SHEET (03-30-20)
- REPLACED OWNER'S BATH WITH OWNER'S BATH 1 ON BASE PLAN (03-30-20)
- CHANGED ALL WALLS FROM 2x6 TO 2x4 EXCEPT WHERE SHADED (03-30-20)
- CHANGED ROOM NAME "NOOK" TO "DINING ROOM" (03-30-20)
- ADDED HOSE BIB LOCATIONS TO OPPOSITE SIDES OF THE HOUSE ON FRONT AND REAR (03-30-20)
- CHANGED STANDARD PATTO TO 12'x10' (03-30-20)
- NOTED "TEMP." WINDOWS IN OWNER'S BATH (03-30-20)
- MOVED ALL OPTIONS TO SEPARATE SHEET (03-30-20)
- SHOWED DORMER WINDOWS ON SECOND FLOOR (03-30-20)
- ADDED NOTE FOR ATTIC ACCESS DOOR ON SECOND FLOOR (03-30-20) NOTED "TEMP." WINDOWS IN BEDROOM 2 AND BEDROOM 4 (03-30-20)
- CHANGED STANDARD LIGHT IN KITCHEN TO FLUORESCENT LIGHT (03-30-20)
- NOTED PENDANT LIGHTS AS OPTIONAL (03-30-20)
- ADDED OPTIONAL FLOOR OUTLETS IN FAMILY ROOM (03-30-20)
- REMOVED ALL OUTLETS EXCEPT OPTIONAL FLOOR OUTLET (03-30-20)
- VERIFIED ALL COACH LIGHT LOCATIONS (03:30:20)
- NOTED ALL FANS AS 'STD LIGHT, OPT FAN/LT PREWIRE" IN ALL BEDROOMS (03-30-20)
- UPDATED ELECTRICAL LEGEND (03-30-20)
- NOTED FLOOD LIGHTS AS OPTIONAL (03-30-20)
- 47. UPDATED OWNER'S BATHROOM WINDOWS TO REAR ELEVATIONS (08-29-22)
- OPTIONAL BRICK/STONE WATERTABLE ADDED TO SIDE & REAR ELEVATIONS (05-01-23)



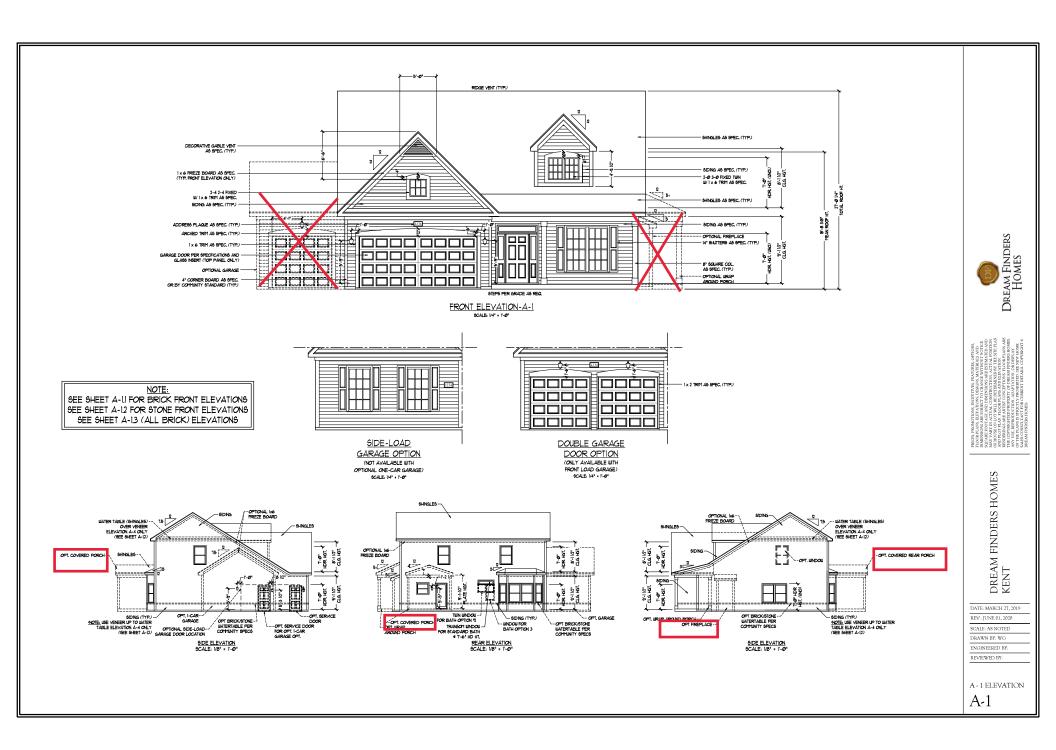



THE CASE THAT SET AT THE CHORN TO THOSE THAT SET AT THE CHORN TO CASE LAND THE CASE LA

DREAM FINDERS HOMES KENT

DATE: MARCH 27, 2019 REV.: JUNE 01, 2020

SCALE: AS NOTED
DRAWN BY: WG

ENGINEERED BY: REVIEWED BY:


A - 2 & A - 3 ELEVATION W/ BRICK


A-1.1


ENGINEERED BY: REVIEWED BY:


SLAB INTERFACE PLAN

A-5

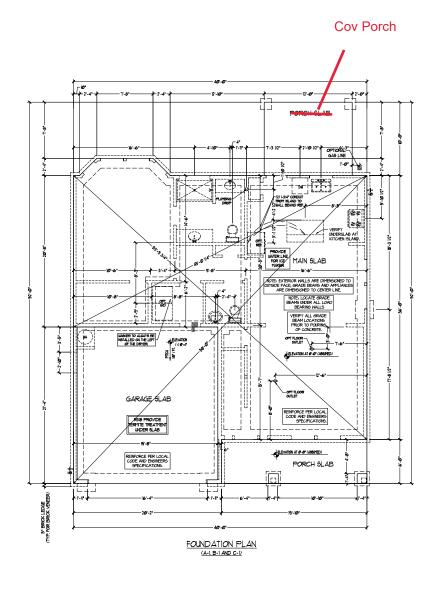

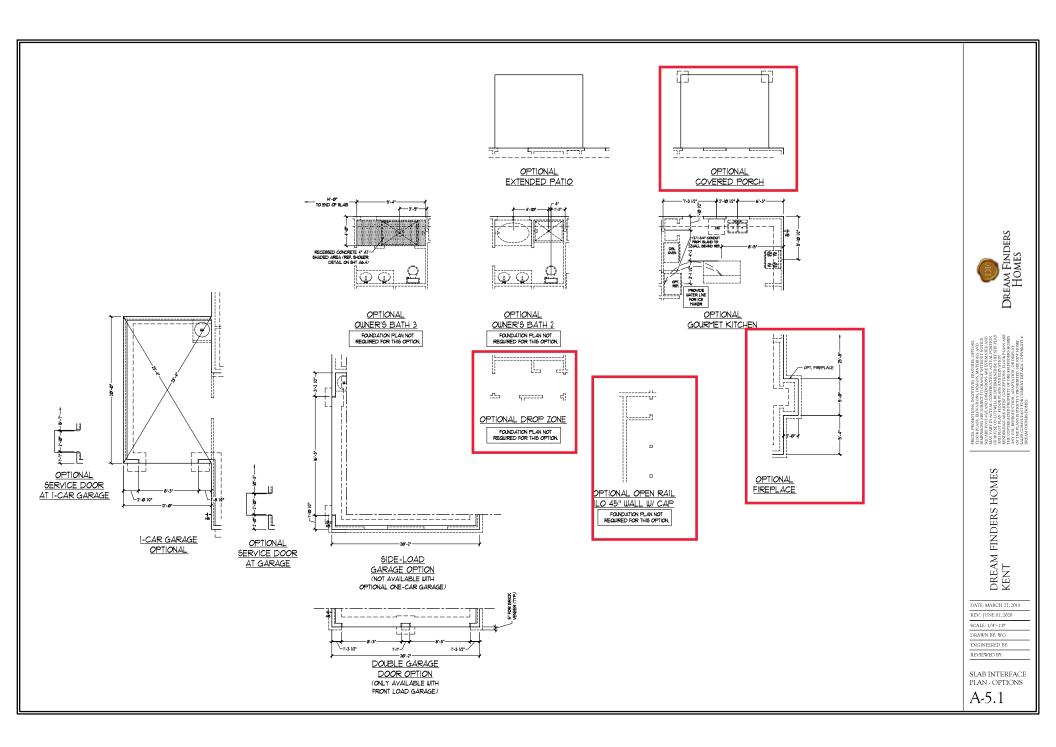

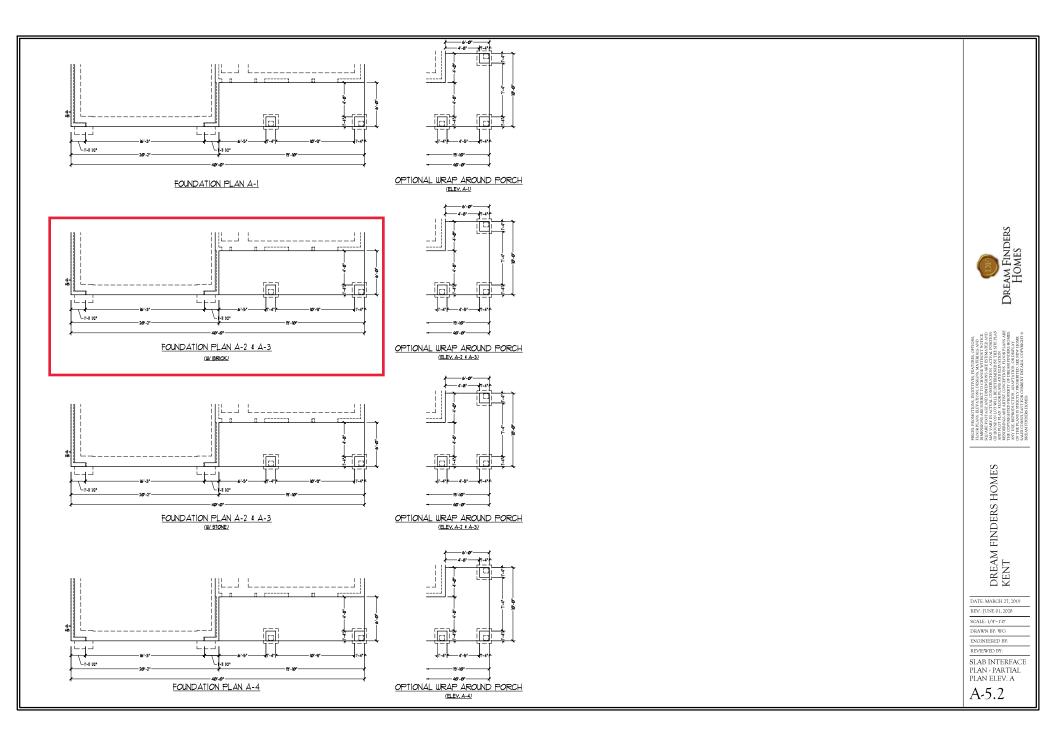

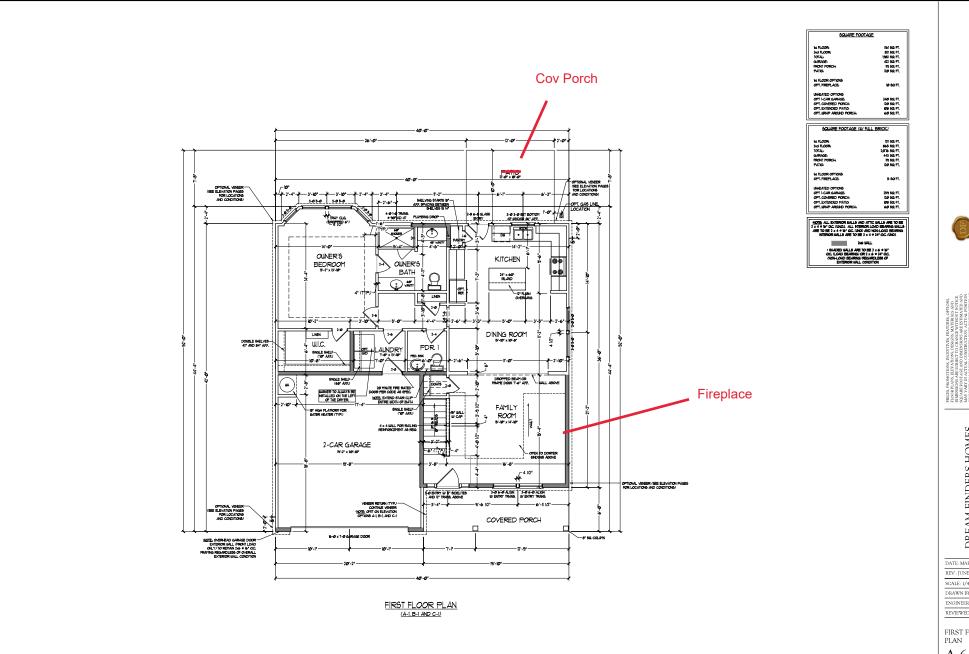



PRICES, PROMOTIONS
PROCES PROMOTIONS
PLONG PLANS REEVA
MONESCORE AS REEVA
SQUARE PROTING AGE
OF HOUSE ON LOT WA
AND HOUSE AND AS
THE COPYRIGHTED I
AND TOSE REPRODIT
OF THE PLANS IS STE
SALES OUT THE PLANS IS STE
SALES OUT THE PLANS IS STE
DREAM FINDERS HC

DREAM FINDERS HOMES KENT


DATE: MARCH 27, 2019 REV.: JUNE 01, 2020


SCALE: 1/4"-1'-0" DRAWN BY: WG ENGINEERED BY:

REVIEWED BY:

FIRST FLOOR

A-6

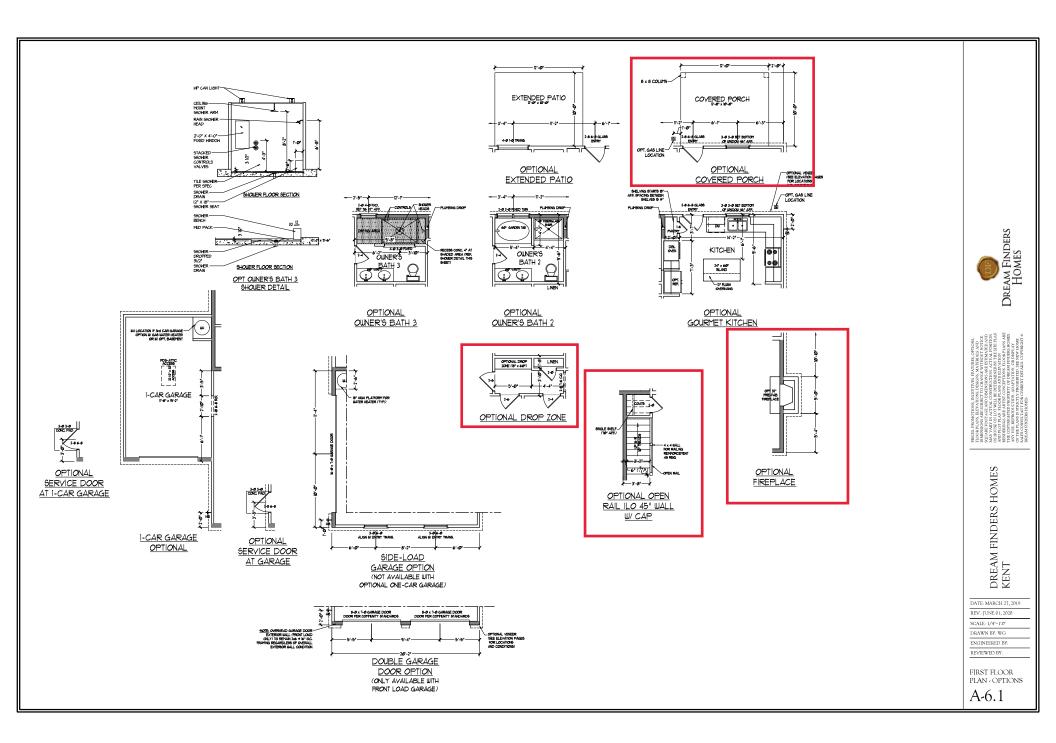


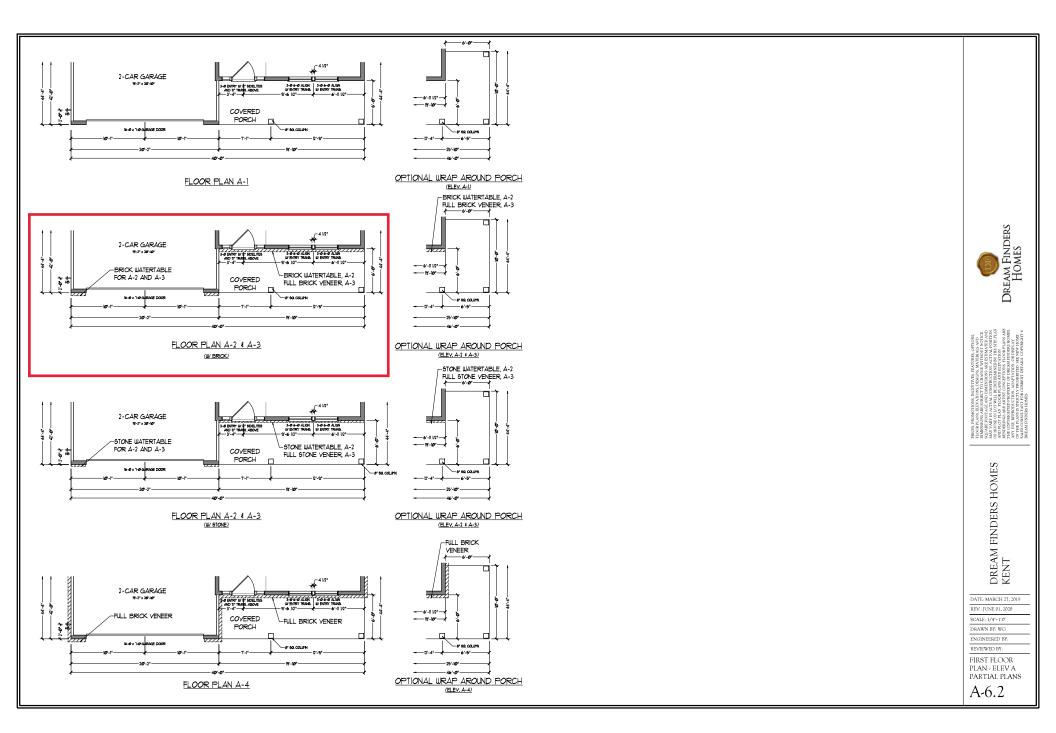

PRICE, PROGRAM, RECTIFICE, PETERTING, PETERS, PETERS,

SECOND FLOOR

PLAN A-7

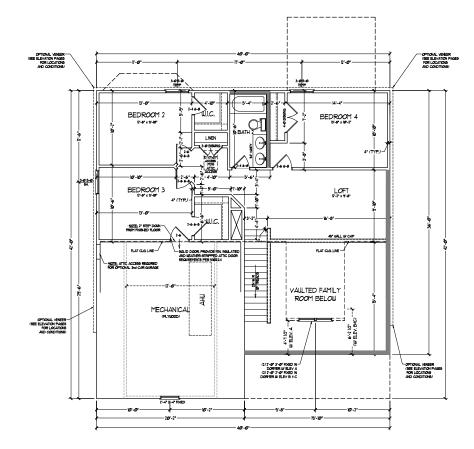

SECOND FLOOR PLAN



DREAM FINDERS HOMES KENT

DATE: MARCH 27, 2019

REV.: JUNE 01, 2020


SCALE: 1/4"-1'-0"


DRAWN BY: WG ENGINEERED BY:


REVIEWED BY:

SECOND FLOOR PLAN - OPTIONS

A-7.1

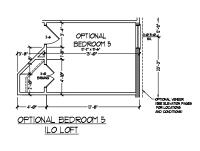

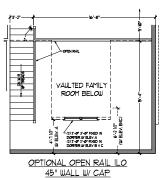

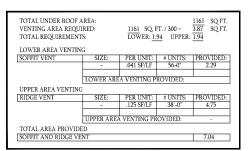



TO THE CONTRIBUTE OF THE CONTR

DREAM FINDERS HOMES KENT

DATE: MARCH 27, 2019 REV:: JUNE 01, 2020

SCALE: 1/4"-1'-0"


DRAWN BY: WG


ENGINEERED BY:


REVIEWED BY:


ROOF PLAN ELEVATION - A

A-8

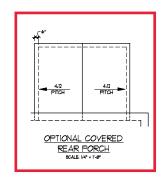

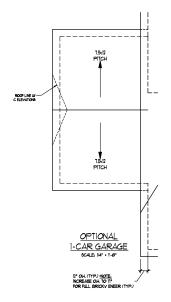

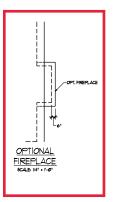

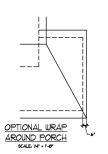



DREAM FINDERS HOMES KENT

DATE: MARCH 27, 2019


REV.: JUNE 01, 2020 SCALE: 1/4"-1'-0"

DRAWN BY: WG ENGINEERED BY:

REVIEWED BY:

ROOF PLAN
OPTIONS

A-8.3

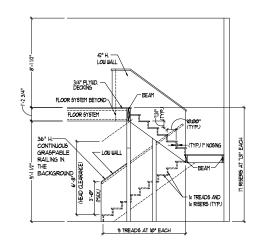

TYPICAL STAIR DETAIL (NTS)

STAIR NOTES:


THE TRIANSILLAR OPENNSS FORMED BY THE RISSER, TREAD AND BOOTHOM RAIL OF A GUIARD AT THE OPEN SIDE OF A STAIRBIAY ARE PERMITTED TO BE A SUCH A SIZE THAT A SPHERE OF 6 INCHES CANNOT PASS THROUGH

OPENINGS FOR REQUIRED GLIARDS ON THE SIDES OF STAIR TREADS SHALL NOT ALLOW A SPHERE 4 3/8 INCHES TO PASS TURNING!

CONTINUOUS GRASPABLE HANDRALL MIST MEET TYPE ONE OR TYPE TUD CRITERIA

ZONE 3R-30 INSULATION (MEET THE CI
REGUIREMENT OF INSULATION EXTENDING
ACROSS THE TOP PLATE
R-30 INSULATION MY HEEL LESS THAN 9'
ZONE 4.
R-30 INSULATION MY HEEL ACATER
THAN 9' ROOF PITCH AS PER DRAWINGS 06B/PLYWOOD SHEATHING-PER CODE RAFTERS/ROOF TRUSSES AS SPEC. TOP OF PLATE TOP PLATE(5) AS SPEC Zone 3 or Zone 4-R-15 INSULATION OR R-13 CAVITY INSULATION +R-2.5 CI TOP OF SECOND FLOOR FLOOR SHEATHING GLUED AND-NAILED ON FLOOR SYSTEM TOP PLATE(6) AS SPEC. HEADERS AT OPENINGS AS SPEC: -STUD FRAMING (UNO) UV TRTD. BOTTOM PLATE(S) BOTTOM PLATE(6) TRTD. SILL PLATE (UNO -MONOLITHIC SLAB AS SPEC.

> WALL SECTION W/ SLAB W/ STD. SIDING SHOWN (NTS)

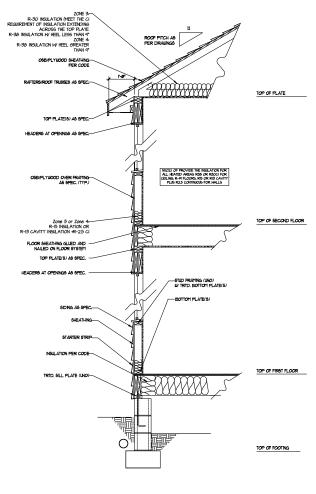

WALL SECTION W/ CRAWL SPACE W/ STD. SIDING SHOWN (NTS)

Dream Finders Homes

PRICES, PROMO
PLOOR PLANS, E
DIMBUSIONS AR
SQUARE FOODA
MAY VARY IN A
OFF HOUSE ON LA
AND PLOT PLANS
RENDERINGS AR
THE COPPURED
ANY USE, REPRE
OF THE PLANS IS
ALES CONSULTS.

DREAM FINDERS HOMES KENT

DATE: MARCH 27, 2019 REV.: JUNE 01, 2020

SCALE: 1/4"-1'-0" DRAWN BY: WG

ENGINEERED BY-REVIEWED BY:

WALL SECTIONS AND STAIR DETAIL

AD-1

ELECTRICAL LAYOUT NOTES U BLOCK AND WIFE FOR ALL CELING FANG PER PLAN

ELECTRICAL LEGEND		
*	10 V OUTLET	
Δ-	WALL MOUNT LIGHT	
\(\rightarrow \)	CEILING MOUNT LIGHT	
•	PENDANT LIGHT	
Ø	RECESSED CAN LIGHT	
Ø	MINI CAN LIGHT	
(i)	EYEBALL LIGHT	
	FLUORESCENT LIGHT	
=	2 LAMP, 4' FLUORESCENT LIGHT	
峄	FLOOD LYGHT	
	BUTTCH	
i i	3-MAY SUTTCH	
ė	4-MAY BUTCH	
8	DIMMER BUTCH	
@-	CONDUIT FOR COMPONENT URDNS	
•	6PEAKER	
p-	DOORBELL CHINE	
	10 V SMOKE DETECTOR	
∞	CO DETECTOR	
(9)	EXHAUST FAN	
LVP	LOU VOLTAGE PANEL	
\otimes	CELING FAN	
(%)	CELLING FAN UV LIGHT	

DREAM FINDERS HOMES KENT

DATE: MARCH 27, 2019 REV.: JUNE 01, 2020


SCALE: 1/4"-1'0" DRAWN BY: WG

ENGINEERED BY: REVIEWED BY:


FIRST FLOOR ELECTRICAL PLAN

E-1

FIRST FLOOR PLAN (A-1, B-1 AND C-1)

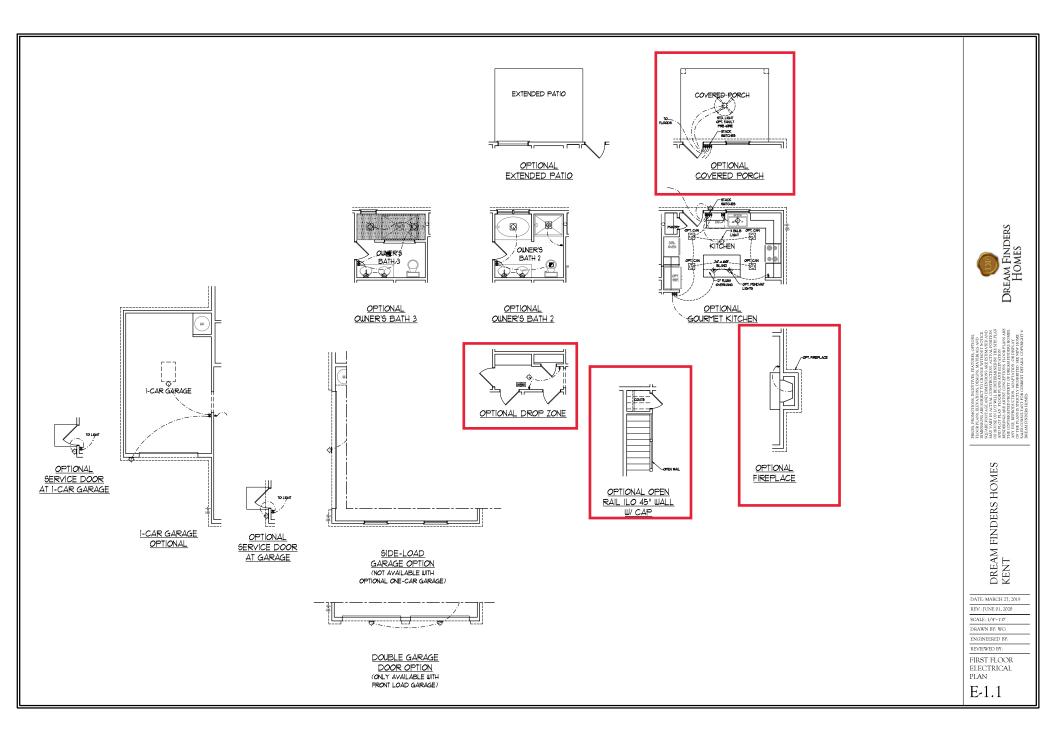


REVIEWED BY:
FIRST FLOOR
ELECTRICAL
PLANS PARTIAL
PLANS
E-1.2

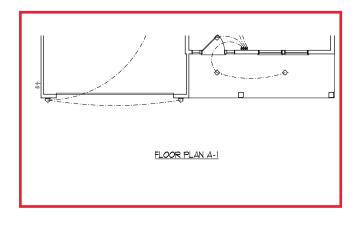




OPTIONAL WRAP AROUND PORCH (ELEV. A-1)

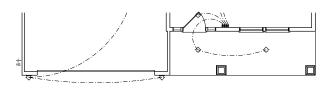



FLOOR PLAN B-I

OPTIONAL WRAP AROUND PORCH

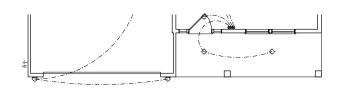



FLOOR PLAN C-1

OPTIONAL WRAP AROUND PORCH

SECOND FLOOR PLAN

ELECTRICAL LAYOUT NOTES: 1) BLOCK AND WRE FOR ALL CELING FANG PER PLAN.

ELECTRICAL LEGEND		
•	NO V OUTLET	
≏	WALL MOUNT LIGHT	
~	CEILING MOUNT LIGHT	
•	PENDANT LIGHT	
Ø	RECESSED CAN LIGHT	
Ø	MINI CAN LIGHT	
0	EYEBALL LIGHT	
$\overline{}$	PLUORESCENT LIGHT	
	2 LAMP, 4' FLUORESCENT LIGHT	
妤	FLOOD LIGHT	
ė.	битсн	
ł	3-MAY BUTCH	
ě	4-MAY BUTCH	
8	DIMMER SUTTCH	
@-	CONDUIT FOR COMPONENT URRNS	
€	6PEAKER	
D-	DOORBELL CHINE	
60	10 Y SMOKE DETECTOR	
@	CO DETECTOR	
•	EXHAUST FAN	
LVP	LOU VOLTAGE PANEL	
\otimes	CELING FAN	
(**)	CELING FAN W LIGHT	



DREAM FINDERS HOMES KENT

DATE: MARCH 27, 2019


REV.: JUNE 01, 2020 SCALE: 1/4"-1'-0"

DRAWN BY: WG ENGINEERED BY:

REVIEWED BY:

SECOND FLOOR ELECTRICAL PLAN

E-2

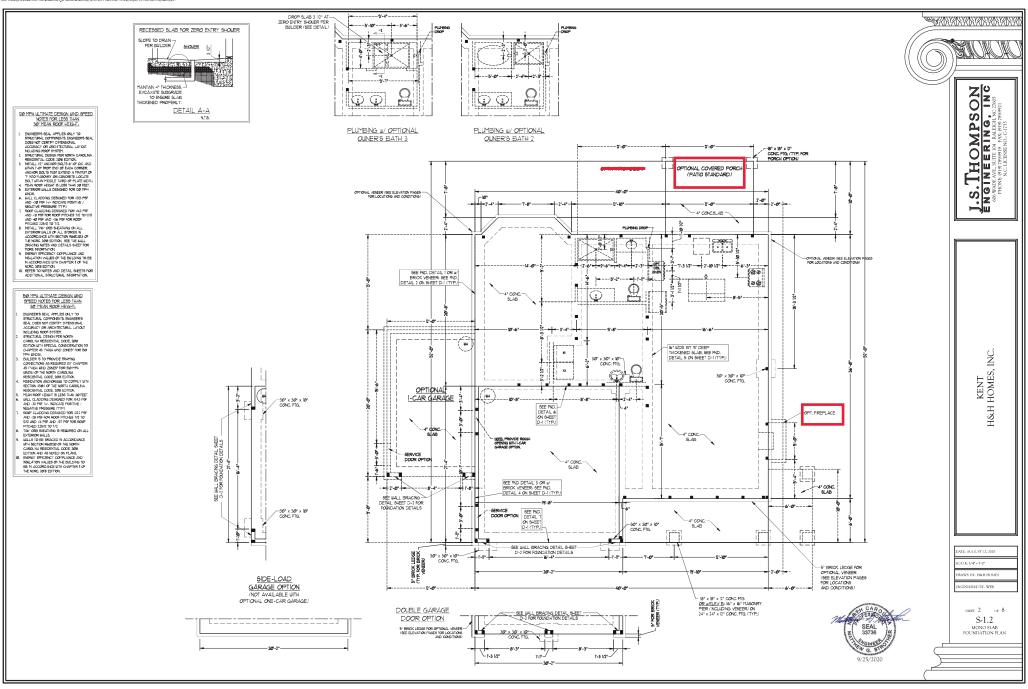

NOTE: ALL EXTERIOR WALLS AND ATTIC WALLS ARE TO BE 2 x 6 @ 16" O.C. MIN. (UNO), 2 x 4 @ 16" O.C. EXTERIOR WALLS MAY BE CONSTRUCTED IN LIEU OF 2 x 6 WALLS (UNO), ALL INTERIOR LOAD BEARING WALLS ARE TO BE 2 x 4 * 16" O.C. (UNO) AND NON-LOAD BEARING INTERIOR WALLS ARE TO BE 2 x 4 @ 24" O.C. (UNO).

LINTEL SCHEDULE FOR BRICKNATURAL STONE SUPPORT	
LENGTH (FT.)	SIZE OF LINTEL
UP TO 4 FT.	L 3 1/2 x 3 1/2 x 1/4
4-8	L 5 x 3 1/2 x 5/16 LLV
8 AND GREATER	L 6 x 4 x 5/16 LLV

BRICK SUPPORT NOTES:

- LINTEL SCHEDULE APPLIES TO ALL OPENINGS IN BRICK VENEER (UNO), SEE ARCH DUGS, FOR SIZE AND LOCATION OF OPENINGS.
- OPENNIS.
 (ILLV) = LONG LEG VERTICAL
 LEWGTH = CLEAR OPENNIG
 EPBED ALL ANGLE IRONS MIN. 4" EACH
 SIDE NTO VENER TO PROVIDE BEARNIG.
 FOR ALL HEADERS 9":0" AND GREATER
 N LEWGTH, ATTACH STEEL ANGLE TO
 HEADER WI 12" LAG SCREUS 12" OC.
 914GGEREU
- FOR ALL BRICK SUPPORT # ROOF LINES FOR ALL BRICK SUPPORT # ROOF LINES, FASTEN (27 x 00 ELOCKING PETRET). FASTEN STUDS ut (4) TRAINLES FER PLY FASTEN OF ELOCKING W (7) (17 LLAG OCERSIS # 12" OL. STAGGERED, SEE SECTION PROBABI OF THE 100 N.CRE FOR ADDITIONAL BRICK SUPPORT INFORMATION. PRECASE RENORCED CONCRETE LINES DINNESSED SY OTHERS HAY BE USED IN LIBE OF STEEL LINES.

STRUCTURAL NOTES:

- ALL FRAMING LUMBER TO BE SPF 12 (UNO). ALL
- ALL REALTH LIPERT TO BE 59° 7 (NO). ALL TECRITOL THERE FOR 55° 9° (NO).
 ALL LOAD EELAND EELDES TO BE (7)° 2 × 6 (NO).
 PROVIDE AN EXPANSI HELDES TO BE (7)° 2 × 6 (NO).
 REVOLUE AND DOOR HELDES TO BE (7)° 2 × 7 (NO).
 REVOLUE AND DOOR HELDES TO BE CHAPPORTED OF THE PLANS.
 REVOLUE FOR EXPANSION TO THE PLANS.
 REVOLUE FOR THE THE SALE THE SA

- ALONG EDGES AND 6" O.C. IN THE FIELD.
 FOR HIGH WIND ZONES, SECURE ALL EXTERIOR WALL FOR HIGH WIND ZONES, SECURE ALL EXTERIOR WALL, SHEATHING PARKES TO DOLDE TOP PLATES, BANDS, JOISTS, AND GIRDERS WITH (2) ROWS OF 8d NAILS STAGGERED AT 3" OD. PARKES SHALL EXTEND 2" BEYOND CORSTRUCTION SONTS AND SHALL EXTEND 2" GRODERS AND DOUBLE SILL PLATES THEIR RILL

- REFER TO NOTES AND DETAIL SHEETS FOR ADDITIONAL STRUCTURAL INFORMATION.

DSP' NDICATES DOUBLE STUD POCKET BETWEEN WINDOW UNITS.

NOTE, BCI 4500%-18 JOISTS MAY BE NSTALLED IN LIEU OF TII IN JOISTS AT THE DEPTH AND SPACING INDICATED ON THE PLAN

BRACED WALL DESIGN NOTES:

- BRACED WALL DESIGN PER SECTION R602.00 OF THE NORC
- BRALED MALL DEMON PER SECTION REGISIO OF THE NORC DIPS EDITION.
 CO-MUP REPERS TO CONTINUOUS SHEATHING MORE DITION.
 CO-MUP REPERS TO CONTINUOUS TO TO INSTALL THE PERSON.
 CO. ALADIE PARIEL EDIDES AND IT OF AN INTERPLET OF A MARKET MORE DITION.
 CO. ALADIE PARIEL EDIDES AND IT OF AN INTERPLET OF A MARKET MORE DITION.
 TO THIS MALL EDIDES AND IT OF AN INTERPLET OF A MARKET MORE DITION.
 THE SECRET MALL EDIDES AND IT OF AN INTERPLET TO CONTINUE TO A MARKET MARKET MALL HE SOCIETY OF A MARKET MALL THE SOCIETY OF AN INTERPLET OF A MARKET MALL PERSON APPLE DIT NIND ZINES IN TO BE PHANCED MALL DESIGNAL FINE MALL SECRET DITION.
 MACKET MALL SITE OF A MARKET MALL SECRET MAL

BRACED WALL DESIGN

RECTANGLE A	RECTANGLE B
SIDE IA (FRONT LOAD)	SIDE IB
METHOD: CS-WSP/GB/PF	METHOD: PF/C9-WSP
TOTAL REQUIRED LENGTH: 13.581	TOTAL REQUIRED LENGTH: 2,85"
TOTAL PROVIDED LENGTH: 2016"	TOTAL PROVIDED LENGTH: 6"
SIDE 2A	SIDE 2B
METHOD: CS-WSP/GB	METHOD: CS-WSP
TOTAL REQUIRED LENGTH 13.581	TOTAL REQUIRED LENGTH 285"
TOTAL PROVIDED LENGTH: 16.831	TOTAL PROVIDED LENGTH: 12"
SIDE 3A	SIDE 3B / 4A SHARED

METHOD: C8-U8P

TOTAL REQUIRED LENGTH: 12.35'

TOTAL PROVIDED LENGTH: 12.35'

TOTAL PROVIDED LENGTH: 24.45 SIDE 4A (SIDE LOAD)
METHOD: CS-USP/PF SIDE 4B
METHOD: CS-IUSP
TOTAL REQUIRED LENGTH: 2.1 TOTAL PEGLIPPED I PAGELL 1235 TOTAL PROVIDED LENGTH: 2445' TOTAL PROVIDED LENGTH: 1556


TABLE R602,15
MINIMUM NUMBER OF FULL HEIGHT STUDS
AT EACH END OF HEADERS IN EXTERIOR WALLS

HEADER SPAN (FEET)	MAXIMUM STUD SPACING (INCHES) (IPER TABLE R6023(5)	
(VEEL)	16	24
UP TO 31	1	1
4'	2	1
8'	3	2
121	5	3
161	6	4




SIDE-LOAD GARAGE OPTION (NOT AVAILABLE WITH



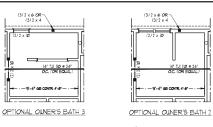

DOUBLE GARAGE DOOR OPTION

> 1'-5" CONTR 2'-1 1/2" FILL BETWEEN JACK STUDS W KING STUDS, SECURE— HEADERS TOGETHER W (2) 4" LONG CSG STRAPS, INSTALL (1) STRAP ACROSS TOP AND (1) STRAP ACROSS BOTTOM OF HEADERS ON INSIDE FACE.

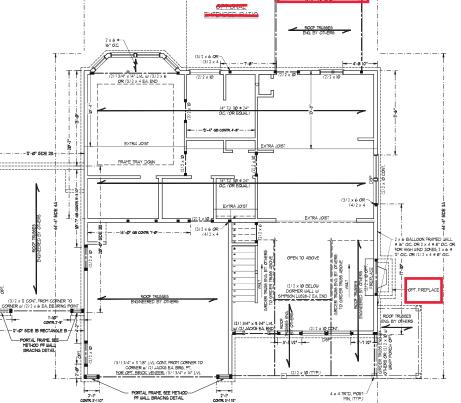

40'-0" SIDE IA RECTANGLE A -

40'-0" SIDE 2A-

PTIONAL COVERED PORCH

(PATIO STANDARD)



NO -

I.S. THOMPS

INC

KENT H&H HOMES,]

DATE: AUGUST 12, 2020

AWN BY: H&H HOMES

UNEERED BY: WFB

S-2

SECOND FLOOR FRAMING PLAN

S

ROOF TRUSSES ENG. BY OTHERS (2) I 3/4" x 9 I/4" LVL w/ (2) JACK5 EA. BND ELEVATION B 4x4 TRTD, POST-/

*NOTE: ALL EXTERIOR WALLS AND ATTIC WALLS ARE TO BE 2 x 6 @ 16" O.C. MIN. (UNO), 2 x 4 @ 16" O.C. EXTERIOR WALLS MAY BE CONSTRUCTED IN LIEU OF 2 x 6 WALLS (UNO), ALL INTERIOR LOAD BEARING WALLS ARE TO BE 2 x 4 @ 16" O.C. (UNO) AND NON-LOAD BEARING INTERIOR WALLS ARE TO BE 2 x 4 @ 24" O.C. (UNO).

BRACED WALL DESIGN NOTES:

BRACED WALL DESIGN PER SECTION R6/02/0 OF THE NORC

- BRACED WILL DESIGN FER SECTION RIGIDIO OF THE NEXT OBSERVING SECTION RIGIDIO OF THE NEXT OBSERVING SECTION RIGIDIO OF THE NEXT OBSERVING SECTION OF THE NEXT OBSERVING SECTION RIGIDIO OF THE NEXT OBSERVING SECTION OF THE NEXT OBSERVING SECTION OF THE NEXT OBSERVING SECTION OF THE PLANE AND OF THE NEXT OBSERVING OF THE NEXT OBSERVING SECTION OF THE PLANE AND OBSERVING OF THE PLANE AND OBSERVING SECTION OF THE PLANE AND OBSERVING SECTION OF THE PLANE AND OBSERVED WILL DESIGN APPLIED IN UNDO ZODES OF THE NEXT OBSERVED WILL DESIGN APPLIED IN UNDO ZODES OBTAINED ON ACCORDANCE OF THE NEXT OBSERVED WILL DESIGN APPLIED IN THE NEXT OBSERVED WILL DESIGN OF THE NEXT OBSERVED WILL DESIGN OF THE NEXT OBSERVED WILL NO OFFINAL SPOUNDS WILL INFORMATION.

- FER SECTION R6601033 OF THE 1098 NCRC, THE AYONT OF BRACKS ON THE SECOND FLOOR EXCEEDS THE AYONT REQUIRED FOR THE PRIST FLOOR ON NO BRACKED MALL ANALYSIS IS REQUIRED. SHOULD WITH THE O'CO SHEATHING SHEATH ALL DEFINED WALLS WITH THE 'O'CO SHEATHING ATTICKED WITH SOT NALLS ATT 6" OCC. ALONG PAREL EDGES AND U'CO. AN THE BROCK SHEAT SHEAT SHEAT SHEAT SHEAT U'CO. AN THE SHEAT SHE

	LINTEL SCHEDULE FOR BRICK-NATURAL STONE SUPPORT		
	LENGTH (FT.)	SIZE OF LINTEL	
	UP TO 4 FT.	L 3 1/2 x 3 1/2 x 1/4	
	4-8	L 5 x 3 1/2 x 5/16 LLV	
	8 AND GREATER	L 6 x 4 x 5/16 LLV	
- 1			

BRICK SUPPORT NOTES:

- SUCS SEPTION INDES:

 LINTEL SCALEDE A PRIES TO ALL
 OPENINGS IN BRICK YEMER (MOV. SEE
 ACH DUGS. FOR SEE AND LOCATION OF
 OPENINGS.

 LINY INDEX LESS YESTICAL
 LINY INDEX LESS YESTICAL
 LINY INDEX LESS YESTICAL
 LINY INDEX LESS YESTICAL
 ETTE DALL DAVIG FROM IN 4" EACH
 ETTE DAVIG SCENES IN 1" OC.
 STAGESTED

 TO BE LOCATION ETTE LINES IN 1" OC.
 STAGESTED

 TO BE LOCATION ETTE LINES

 TO BE LOCATION ETTE

 TO BE LOCATION ETTE LINES

 TO BE LOCATION
- PRICK SUPPORT INFORMATION
 PRECAST REINFORCED CONCRETE
 LINTELS ENGINEERED BY OTHERS MAY BE
 USED IN LIEU OF STEEL LINTELS.

STRUCTURAL NOTES:

- ALL RAPING LINETED TO BE SET 9 (MO)

 ALL TRACING LINETED TO BE SET 9 (MO)

 ALL TOAL TOAL THERE TO BE SET 97 (MO)

 ALL TOAL TOAL THERE TO BE SET 97 (MO)

 A LLOAD EBERKEN HEADERS TO BE

 SEPTIMED WITH ALLOAD TO LOAD

 SERVICE SIDUE COLONICATION GROUPS

 FOR ADDITIONAL OF SIDUE SEALED TO BE TO

 TO BE SEATHED WITH ALLOAD TO LOAD

 TO BE SEATHED WITH ALLOAD TO LOAD

 AND MALE AT 3" OC. ALLOAD EDGES AND 6"


 OC. N. THE FELLO.
- 26 MILS A 13" OC. ALONG EDGES AND 6"
 OC. N THE FELL.
 FOR HIGH IND. ZORES, SECURE ALL
 EVEROPE ALL SHEATHING PARES TO
 DOUBLE FOR FILLE SHEATHING PARES TO
 DOUBLE FOR FILES BANDS, JOSTIS, AND
 GROUPES WITH JOSTIGS FOR MALES
 STACKERS AT 3" OC. PARES SHALL
 EVERY AND SHEATHING FOR THE SHALL
 AND SHALL OPERATE GROUPES AND
 DOUBLE SILL PAINES HERE RAIL DEFIN
 EVERT TO NOTE AND DETAIL SHEETS FOR
 ADDITIONAL STRUCTURAL INFORMATION

TABLE R&02.15

MNMM NUMBER OF FULL HEIGHT STUDS

AT EACH END OF HEADERS IN EXTERIOR WALLS

HEADER SPAN	MAXMUM STUD SPACING (NCHES) (PER TABLE R6023/5)		
112211	9,	24	
UP TO 31	- 1	1	
14	2	1	
'8	ε	2	
.2	ē	ε	
LAI			

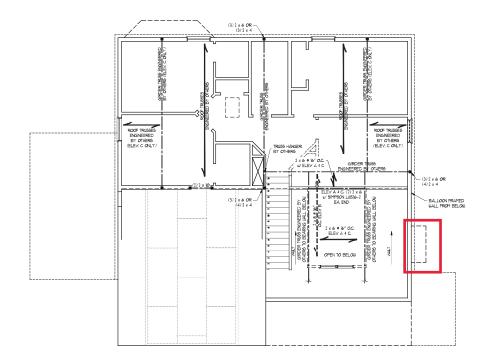





INC KENT H&H HOMES, I

DATE: AUGUST 12, 2020


AWN BY: H&H HOMES NOINEERED BY: WFB

S-3 CEILING FRAMING PLAN

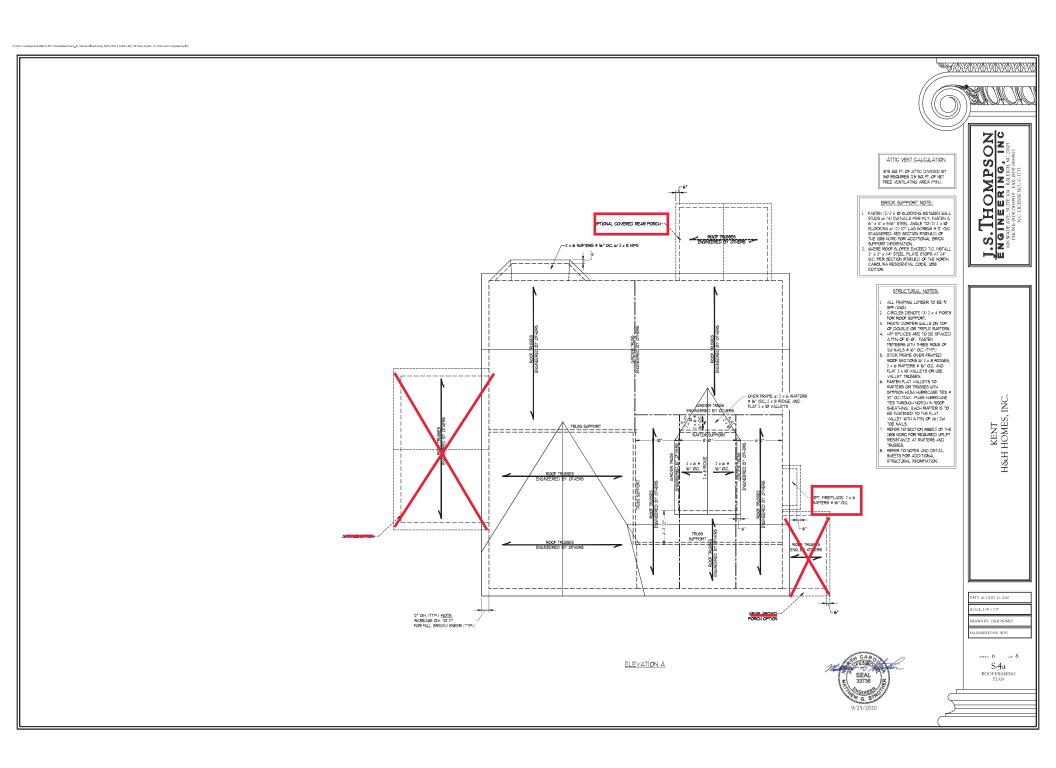


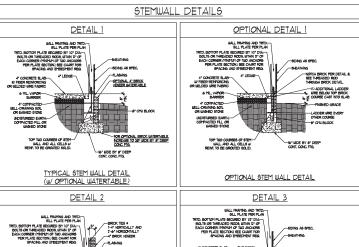


6 ML VAPOR-BARRIER B' CHU BLOCK -99" UDE BY 8" DEEP

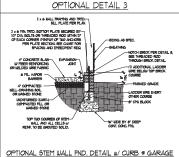


TYPICAL STEM WALL FND. W/ BRICK DETAIL

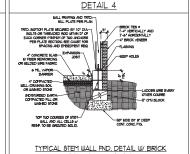

TYPICAL STEM WALL FND. DETAIL W/ CURB @ GARAGE

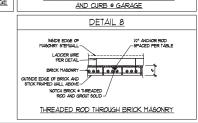

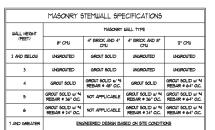

STRUCTURAL NOTES:

- I. MALL HEIGHT MEASURED PROT FOR PRODUCTION TO TOP OF THE MALL.

 2. THE MALTINE STRINGS TOGETHER WITH LOCKING AT MY OCC. MERTICALLY.

 3. THE MALTINE STRINGS TOGETHER WITH LOCKING AT MY OCC. MERTICALLY.

 5. THE MALTINE STRINGS TOGETHER WITH LOCKING AT THE MARKET FOR DEBIGN OF GARAGE
 FOR ADMINISTRATION AND CONTROL OF THE MALL TOWERS AND LOCKING AND ADMINISTRATION AND CONTROL OF THE MALL THAT WE SOLD (A PEFFF BELOW GRADE)

 5. BLOOGIL OF UELL DRAWDED OR BAND GRANEL THAT WES SOLD (A PEFFF BELOW GRADE)

 5. BLOOGIL OF UELL DRAWDED OR THE MALL THAT WES COLD AND ADMINISTRATION AND AD

_			
ANCHOR SPACING AND EMBEDMENT			EMBEDMENT
	WIND ZONE	12Ø MPH	13/0 MPH
	6PACING	6'-Ø" O.C.	4'-0" O.C.
	EMBEDMENT	יד	B" INTO MASONRY T" INTO CONCRETE

WIND SPEED

DATE: NOVEMBER 14, 2018

D-1 FOUNDATION DETAILS



S OMPS ERING. 工口 I.S. TE

NON CONTRACTOR

MPH ULTIMATE DESIGN FOUNDATION DETAILS 1301 20

ATE: NOVEMBER 14, 2018


GINEERED BY: 18


D-2 BRACED WALL NOTES AND DETAILS AND PF DETAIL



- WILL BRACING DESIGNED IN ACCORDANCE WITH CHAPTER 6 OF THE 1008 NC RESIDENTIAL BUILDING CODE (NCRC.)
 TABLES AND FRANCES REFERNICED AND RINGTH CHAPTER 6 OF THE 1008 NCRC. FOR ADDITIONAL INFORMATION AS NEEDED.
 SEE HIS SEET FOR CREATED WILL LOCATIONS DITEISMONS, ROLD DOWN THE AND LOCATIONS REACED WILL
 THE RET WITH WILL LIDENS ASSISTANT OF REACIDED NOTATIONS FOR EACH DUTLING AND THE FOR THE AND THE STATE OF THE PROPERTY OF THE FOR THE THE FORMATION AND THE PROPERTY OF THE FORMATION AND THE PROPERTY OF THE FORMATION AND THE FORMATION AND THE FORMATION AND THE PROPERTY OF THE FORMATION AND THE FORMATION AN
- ALL EXTERIOR WALLS ARE TO BE SHEATHED WITH CS-WSP IN ACCORDANCE WITH SECTION REGIZIOZ UNLESS NOTED

- A LESTEROR BULLS ARE TO BE SHARHED WITH G-MERN IN ACCORDINGE WITH SECTION RISKINDS NAMES NOTIFE TO SEE PLANTING WITH SHARP AND A LESTEROR AND INTERCOR WALLS OF A UNITED THE RISKIND PER TABLE RISKINDS. TO HAVE TO GOTHER FOR STRICTURE, PARKES WALL BRACKEN TETLION, "No GOE PLANTING PER TABLE RISKINDS AND A SHARP AND A STRICTURE, PARKES WALL BRACKEN TETLION," NO GOE SHARP AND A STRICTURE, PARKES WALL BRACKEN TETLION, "OF SHARP AND A STRICTURE," AND A STRICTURE AND A STRICTURE OF SHARP AND A STRICTURE AND A ST

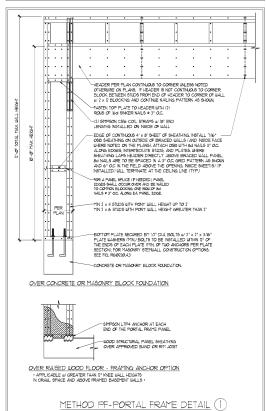


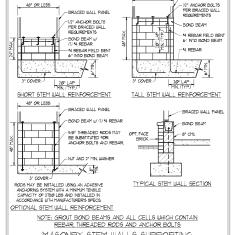


48" OR LESS


- BRACED WALL PANEL


MASONRY STEM WALLS SUPPORTING BRACED WALL PANELS (2) PER FIGURE R602.10.4.3

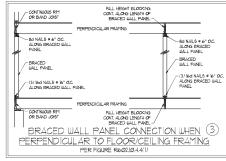


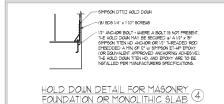

· APPLICABLE ONLY WHERE SPECIFIED ON PLAN:

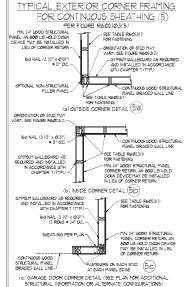

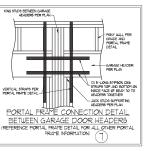

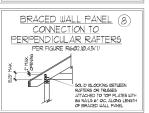

BRACED WALL PANEL

CONNECTION TO


PERPENDICULAR ROOF


TRUSSES

PER FIGURE R6@2.I@.4.5(3)

-2 × BLOCKING


NAILING PER

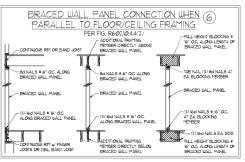

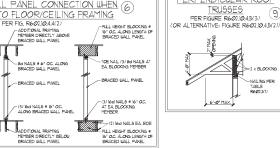

This sealed page is to be used in conjunction with a full plan set engineered by J.S. Thompson Engineering, Inc. only. Use of this individual sealed page within architectural pages or shop drawings by others is a punishable offense under N.C. Statute § 89C-23



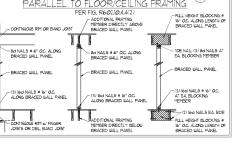

NO S

S

GENERAL NOTES

- 1 ENGINEER'S SEAL APPLIES ONLY TO STRUCTURAL COMPONENTS INCLUDING ROOF RAFFERS HIPS VALLEYS RIGGES FLOORS HALLS BEAMS HEADERS, COLLINS, CANTILEVERS, OFFSET LOAD BEARNS WILLS, PERS, GIRDER SYSTEM AND FOOTNS. INSIGERS'S EAL DOES NOT CERTIFY DIMENSIONAL ACCURACY OF ARCHITECTURAL LAYOUT INCLUDING ROOF. ENGINEER'S EAL DOES NOT APPLY TO 1-JOIST OR FLOOR/ROOF TRUSS
- ALL CONSTRUCTION SHALL CONFORM TO THE LATEST REQUIREMENTS OF THE NORTH CAROLINA RESIDENTIAL CODE INDEX.) 20% EDITION, PLUS ALL LOCAL CODES AND REGULATIONS. THE STRUCTURAL ENGINEERS IN OTHER PROVISIONED FOR ANY DILL NOT HAVE CONTROL OF, CONSTRUCTION PEANS, HETCHOS, ELEVANORE, SEQUENCES OR RECOGNIZED, AND RESIDENCES OR CONSTRUCTION. WORK, NOR WILL THE ENGINEER BE RESPONSIBLE FOR THE CONTRACTORS FAILURE TO CARRY OUT THE CONSTRUCTION WORK IN ACCORDANCE WITH THE CONTRACT DOCUMENTS
- 3. STRUCTURAL DESIGN BASED ON THE PROVISIONS OF THE NORC, 2018 EDITION (RGØ1.4 RGØ1.1)

DESIGN CRITERIA:	LIVE LOAD (PSF)	DEAD LOAD (PSF)	DEFLECTION (IN)
ATTIC WITH LIMITED STORAGE	20	lø	L/240 (L/360 w/ BRITTLE FINISHES)
ATTIC WITHOUT STORAGE	lø	lØ	L/36Ø
DECKS	40	iø	L/36Ø
EXTERIOR BALCONIES	40	1Ø	L/36Ø
FIRE ESCAPES	40	10	L/36Ø
HANDRAILS/GUARDRAILS	200 LB OR 50 (PLF)	IØ	L/36Ø
PASSENGER VEHICLE GARAGE	50	iø	L/36Ø
ROOMS OTHER THAN SLEEPING ROOM	40	10	L/36Ø
SLEEPING ROOMS	30	iø	L/36Ø
STAIRS	40	10	L/36Ø
UND LOAD	(BASED ON TABLE RSQ(2/4) WIND ZONE AND EXPOSURE)		
GROUND SNOW LOAD: Pg	2Ø (PSF)		

- I-JOIST SYSTEMS DESIGNED WITH 12 PSF DEAD LOAD AND DEFLECTION (IN) OF L/480
- 4. FOR 115 AND 130 MPH WIND ZONES, FOUNDATION ANCHORAGE 15 TO COMPLY WITH SECTION RADAGE OF THE NORG, 20'9 EDITION. FOR 150 MPH, IAO MPH, IAO 150 MPH WIND ZONES, FOUNDATION ANCHORAGE 15 TO COMPLY WITH SECTION 4504 OF THE NORG, 20'9 EDITION.
- 5. ENERGY EFFICIENCY COMPLIANCE AND INSULATION VALUES OF THE BUILDING TO BE IN ACCORDANCE WITH CHAPTER II OF THE NORC. 2018 EDITION.

FOOTING AND FOUNDATION NOTES

- 1. FOUNDATION DEBIGN BASED ON A MINIMUM ALLOHABLE BEARING CAPACITY OF 2000 P6F, CONTACT GEOTECHNICAL ENGINEER IF BEARING CAPACITY IS NOT ACHEVED.
- 2. FOR ALL CONCRETE SLABS AND FOOTHS'S. THE AREA UTWIN THE FRENETIER OF THE BULD NO SYMELOTE PALL LAVE ALL ASSESSMENT OF SOME AND TORSION VARIENCE REPOYED. THE THERMAL SHALL BE FREE THE OFFICE OF THE THE STATE OF THE OFFICE AND THE
- PROPERLY DEMATER EXCAVATION PRIOR TO POURNIC CONCRETE WEN BOTTOM OF CONCRETE SLAB IS AT OR BELOW WATER TABLE.
 APPLICABLE 344 1 DEEP CONTROL JOINTS ARE TO BE SAMED WITHIN 4 TO THOURS OF CONCRETE PINSHING AND WALL LOCATIONS BEST CHARGE. JOINT WATER EXCESSION?
- 4. CONCRETE SHALL COPPORT TO SECTION RADGE OF THE NORC, 1908 EDITION. CONCRETE REINFORCING STEEL TO BE ASSTY ASS GRADE 60. BELDED LIRE FARRECT OF SEASTH ASS. MARKET AND MINISTRATION OF SEASTH ASSOCIATION STEEL OF 3" IN PROTINGS ASD 10" IN SUASS. FOR PROPER CONCRETE LIGHT, SOURCESTE CONCRETE CONCRETE
- MASONRY UNITS TO CONFORM TO ACE 530/ASCE 5/TMS 402. MORTAR SHALL CONFORM TO ASTM CITIE.
- 6. THE UNSUPPORTED HEIGHT OF MASONRY PIERS SHALL NOT EXCEED FOUR TIMES THEIR LEAST DIMENSION FOR CAPILLED HOLLOW CONCRETE MASONRY UNITS AND TEN TIMES THEIR LEAST DIMENSION FOR SOLD OR SOLID FILLED FIRED. FERSE MAY BE FILLED SOLID WITH CONCRETE OR TYPE IN OR S YOUTH, PIERS AND WALLS SHALL BE CAPPED WITH 8" OF S OLID MASONRY.
- THE CENTER OF EACH OF THE PIERS SHALL BEAR IN THE MIDDLE THIRD OF ITS RESPECTIVE FOOTING, EACH GIRDER SHALL BEAR IN THE MIDDLE THIRD OF THE PIERS.
- ALL COPERTE AID MASONET FOUNDATION ALLS LIFE TO BE CONTINCED IN ACCORDANCE WITH THE PROPRIORS OF RECTION AND IT HE LUCKER, THE SETTION OF IN ACCORDANCE WITH ALT 39, ACL 333, NOTA TRAIN-A OR ACE BROADED THRE ABOUT THE CONTINUE AND THE ACT OF THE REPORT OF THE THE ACT AND ACCORDANCE THRE THE ACT ADMINISTRATION OF THE ACCORDANCE THE THE ACCORDANCE THREE ACCORDANCE THE THE ACCORDANCE THE THE ACCORDANCE THE ACCOR

This sealed page is to be used in conjunction with a full plan set engineered by J.S. Thompson Engineering, Inc. only. Use of this individual sealed page within architectural pages or shop drawings by others is a punishable offense under N.C. Statute § 89C-23

FRAMING NOTES

- L. ALL FRAMING LIMPER 9-IALL BE 12 9FF MINIMUM (Fig. 875 PS) Fy : 375 PS) E : 16/00/2/2 PS) UNLESS NOTED OTHERUSE (UNC). ALL TREATED LUMBER SHALL BE 12 SYP MINMUM (Fb = 915 PS), Fv = 115 PS), E = 16000000 PS) UNLESS NOTED OTHERWISE (UNO
- 2. LATINATED VENEER LIMBER (LIV.) SHALL HAVE THE FOLLOUNG MINITUM PROFERITIES. Fo. 12600 PSI, Fo. 1265 PSI, E. 1. B000000 PSI, LATINATED STRAND LIMBER (SLJ.) SHALL HAVE THE FOLLOUNG MINITUM PROFERITIES fo. 1250 PSI, Fo. 19500000 PSI, PARALLEL STRAND LIMBER (PSIL) TO TO TERM FAILL HAVE THE FOLLOUNG MINITUM PROFERITIES fo. 1250 PSI E. 12600000 PSI, PARALLEL STRAND LIMBER (PSIL) MORE THAN 17 DEPTH SHALL HAVE THE FOLLOUNG MINITUM PROFERITIES fo. 1200 PSI E. 120000000. PSI, INSTALL ALL CONNECTIONS PER MANUFACTURER'S SPECIFICATIONS.
- 3. STRUCTURAL STEEL SHALL CONFORM TO THE FOLLOWING ASTM SPECIFICATIONS

, A4.	W AND WI SHAFES!	MOTH MODE
В.	CHANNELS AND ANGLES:	ASTM A36
C.	PLATES AND BARS:	ASTM A36
D.	HOLLOW STRUCTURAL SECTIONS:	ASTM A500 GRADE B
E.	STEEL PIPE:	ASTM A53, GRADE B. TYPE E OR S

4. STEEL BEAMS SHALL BE SUPPORTED AT EACH END WITH A MINIMUM BEARING LENGTH OF 3 I/2" AND FULL FLANGE WIDTH (UNO), PROVIDE SOLID BEARNS FROM BEAM SUPPORT TO FOUNDATION, BEAMS SHALL BE ATTACHED AT THE BOTTOM FLANGE TO EACH SUPPORT AS FOLLOUS (UNO)

A, WOOD FRAMING (2) 12° DIA, x 4° LONG LAG SCREUS (2) 12° DIA, x 4° WEDGE ANCHORS (2) 12° DIA, x 4° LONG SIMPSON TITEN HD ANCHORS

LATERAL SUPPORT IS CONSIDERED ADEQUATE PROVIDING THE JOISTS ARE TOE NALED TO THE 5X NAILER ON TOP OF THE STEEL BEAM, AND THE 2x NATURE IS SECURED TO THE TOP OF THE STEEL BEAM w/ (2) ROUS OF SELF TAPPING SCREUS @ Vo" O.C. OR (2) ROUS OF I/2" DIAMETER BOLTS * I6* O.C. F 12* BOLTS ARE USED TO FASTEN THE NALER. THE STEEL BEAM SHALL BE FABRICATED w/ (2) ROUS OF 9/16* DIAMETER HOLES & IS' OC.

- SQUARES DENOTE POINT LOADS WHICH REQUIRE SOULD BLOCKING TO GIRDER OR FOUNDATION, SHADED SQUARES DENOTE POINT LOADS FROM ABOVE WHICH REQUIRE SOULD BLOCKING TO SUPPORTING MEMBER BELOW.
- 6. ALL LOAD BEARING HEADERS TO CONFORM TO TABLE R602.1(1) AND R602.1(2) OF THE NORC, 2018 EDITION OR BE (2) 2 x 6 WITH (1) JACK AND (I) KING STUD EACH END (UNO), WHICHEVER IS GREATER ALL HEADERS TO BE SECURED TO EACH JACK STUD WITH (4) 8d NAILS, ALL BEAMS TO BE SUPPORTED WITH (2) STUDS AT EACH BEARING FOINT (UNO). INSTALL KING STUDS PER SECTION R6(02):15 OF THE NORTH CAROLINA RESIDENTIAL CODE 2018 EDITION
- 1. ALL BEAMS, HEADERS, OR GRODER TRUSSES PARALLEL TO WALL ARE TO BEAR RULLY ON (1) JACK OR (2) STUDS THINMTH OR THE NUMBER OF JACKS OR STUDS NOTES. ALL BEAMS OR GRODER TRUSSES FREEDOLGLAR TO WALL AND SUPPORTED BY (1) STUDS OR LESS ARE TO MAKE (1)? MAND MEANING MEANING AND, ALL BEAMS OR GRODER TRUSSES FREEDOCULAR TO WALL AND SUPPORTED BY ONE THAN (13) STUDS OR OTHER MOTED COUNTY, ARE TO BEAR RULLY ON SUPPORT DO YOUR TRUSSES FREEDOCULAR TO WALL DEATH HOUSE BEAM BUT STUD OR OTHER MOTED COUNTY ARE TO BEAR RULLY ON SUPPORT COUNTY FOR BUTTIES WALL DEPTH (NO.). BEAM BUTCS THAT BUTT INTO ONE ANOTHER ARE TO EACH BEAR EQUAL LENGTHS (UNO).
- 8. FLITCH BEAMS SHALL BE BOLTED TOGETHER USING 101 DIAMETER BOLTS (ASTM A3@1) WITH WASHERS PLACED AT THREADED END OF BOLT. BOLTS SHALL BE SPACED AT 24" CENTERS (MAXIMUM), AND STAGGERED AT TOP AND BOTTOM OF BEAM (2" EDGE DISTANCE), WITH (2) BOLTS LOCATED AT 6" PROM EACH END (UNO
- ALL I-JOIST OR TRUSS LAYOUTS ARE TO BE IN COMPLIANCE WITH THE OVERALL DESIGN SPECFED ON THE PLANS. ALL DEVIATIONS ARE TO BE BROUGHT TO THE ATTENTION OF THE ENGINEER OF RECORD PRIOR TO INSTALLATION.
- 10. BRACED WALL PANELS SHALL BE CONSTRUCTED ACCORDING TO THE NORTH CAROLINA RESIDENTIAL CODE 2018 EDITION WALL BRACING CRITERIA THE AMOUNT, LENGTH, AND LOCATION OF BRACING SHALL COMPLY WITH ALL APPLICABLE TABLES IN SECTION REGION.
- PROVIDE DOUBLE JOST UNDER ALL WALLS PARALLEL TO FLOOR JOSTS. PROVIDE SUPPORT UNDER ALL WALLS PARALLEL TO FLOOR 5 PER MANUFACTURER'S SPECIFICATIONS. INSTALL BLOCKING BETWEEN JOISTS OR TRUSSES FOR POINT LOAD SUPPORT FOR ALL POINT LOADS ALONG OFFSET LOAD LINES.
- FOR ALL HEADERS SUPPORTING BRICK VENEER THAT ARE LESS THAN 8"-0" IN LENGTH, REST A 6" x 4" x 5/6" STEEL ANGLE WITH 6" MINIMUM EMBEDMENT AT SIDES FOR BRICK SUPPORT (UNO). FOR ALL HEADERS 8'-8" AND GREATER IN LENGTH, BOLT A 6" x 4" x 5'/6" STEEL ANGLE TO HEADER WITH IVE LAG SCREUS AT 12' O.C. STAGGERED FOR BRICK SUPPORT. FOR ALL BRICK SUPPORT AT ROOF LINES, BOLT A 6" x 4" x 5/16" STEEL ANGLE TO (2) 2 x 10 BLOCKING INSTALLED W (4) 12d NAILS EA, PLY BETWEEN WALL STUDG WITH (2) PROUS OF 1/2" LAG SCREWS AT 12" O.C. STAGGERED AND IN ACCORDANCE WITH SECTION RTØ3.8.2.) OF THE NORC, 2018 EDITION
- 13. FOR STICK FRAMED ROOFS; CIRCLES DENOTE (3) 2 x 4 POSTS FOR ROOF MEMBER SUPPORT, HIP SPLICES ARE TO BE SPACED A MINIMUM OF SHOULD NOT SEE THAT THE ROUS OF 124 X × TUDITS FOR ROOF PETIERR SUPPORT, HIP SPLICES ARE TO BE SPACED A MINIMUM SHOP. FASTEN MEMBERS WITH THREE ROUS OF 12d NALES AT 16* O.C. FRAME DORMER WALLS ON TOM OF DOUBLE OR TRIMLE RAFFERS AS SHOULD KNOW.
- 14. FOR TRUSSED ROOFS: FRAME DORMER WALLS ON TOP OF 2 x 4 LADDER FRAMING AT 24" OC. BETWEEN ADJACENT ROOF TRUSSES. STICK FRAME OVER-FRAMED BOOF SECTIONS WITH 2 x 8 RIDGES, 2 x 6 RAFTERS AT 16" O.C., AND FLAT 2 x 10 VALLEYS (LNO.);
- 15. ALL 4 x 4 AND 6 x 6 POSTS TO BE INSTALLED WITH TWO LIB CAPACITY UPLIFT CONNECTORS TOP AND BOTTOM (UNO.) POSTS MAY BE SECURED USING ONE SIMPBON HOR CITIST UPLIFT CONNECTOR FASTENED TO THE BAND AT THE BOTTOM AND THE BEAM AT THE TOP OF EACH POST. ONE IN SECTION OF SIMPBON CASE COLL STREAMEN WITH 16 26 HOS AND, AT EACH END MAY BE WEED IN LIEU OF EACH TWIST STRUP IP DESIRED. FOR MASONIX OR CONCRETE POWD ATOM USE SIMPSON POST EACH.

WIND SPEED · 130 MPH ULTIMATE DESIGN WIN STANDARD STRUCTURAL NOTES

DATE: NOVEMBER 14, 2018

MPH.

20

GINEERED BY: 157

S-0 STRUCTURAL NOTES

HOMPS S.Tr