



FIRST FLOOR OPENING SCHEDULE										
PRODUCT CODE SIZE HINGE REVERSED COUNT										
2-4 Door Unit	2'-4"	R	NO	2						
2-8 Door Unit	2'-8"	L	NO	1						
28x52 single	2'-8" x 5'-2"	N	NA	3						
32X80 FRENCH A 1	2'-8"	L	NO	1						
36X80 COLONIAL A 1	3'-0"	R	NO	1						
192X84 - 8 PANEL GARAGE DR	16'-0"	U	NO	1						

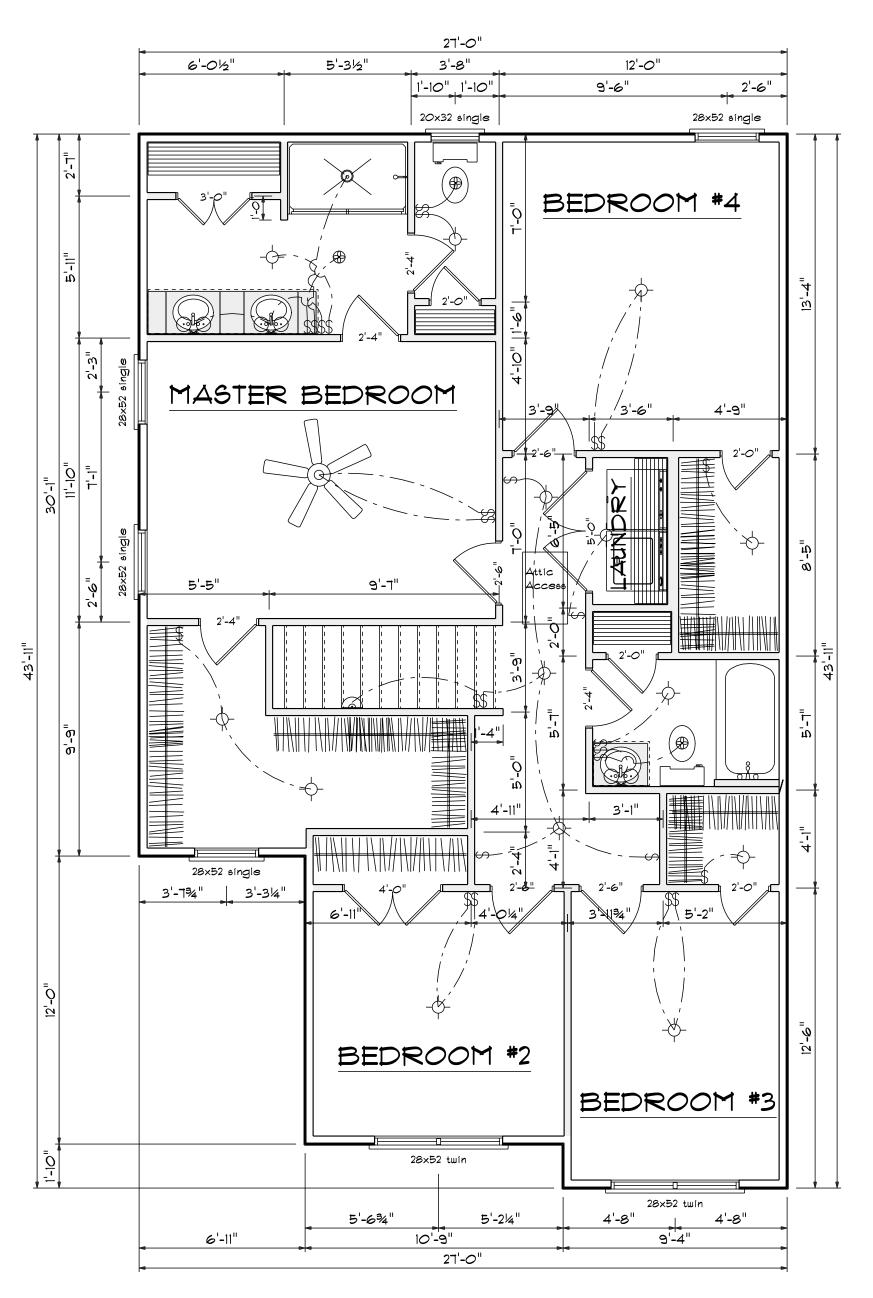



Second Floor Plan Scale: 1/4"= 1'-0" /

SECOND FLOOR OPENING SCHEDULE									
PRODUCT CODE	SIZE	HINGE	REVERSED	COUNT					
2-0 Door Unit	2'-0"	L	NO	2					
2-0 Door Unit	2'-0"	R	NO	2					
2-4 Door Unit	2'-4"	L	NO	2 2					
2-4 Door Unit	2'-4"	R NO L NO	NO						
2-6 Door Unit	2'-6"		NO	3					
2-6 Door Unit	2'-6"	R	NO	1					
3-0 Doublehung Door Unit	3'-0"	LR	NO	1					
4-0 Doublehung Door Unit	4'-0"	LR	NO	1					
5-0 Doublehung Door Unit	5'-0"	LR	NO	1					
20x32 single	2'-0" x 3'-2"	N	NA	1					
28x52 single	2'-8" x 5'-2"	N	NA	4					
28x52 twin	5'-4" x 5'-2"	NN	NA	2					

	SCALE: 1/4"	DATE: 1/4/2024	
Plan #12	DRAWN BY	REVISED	
·	APPROVED	DRAWING#	

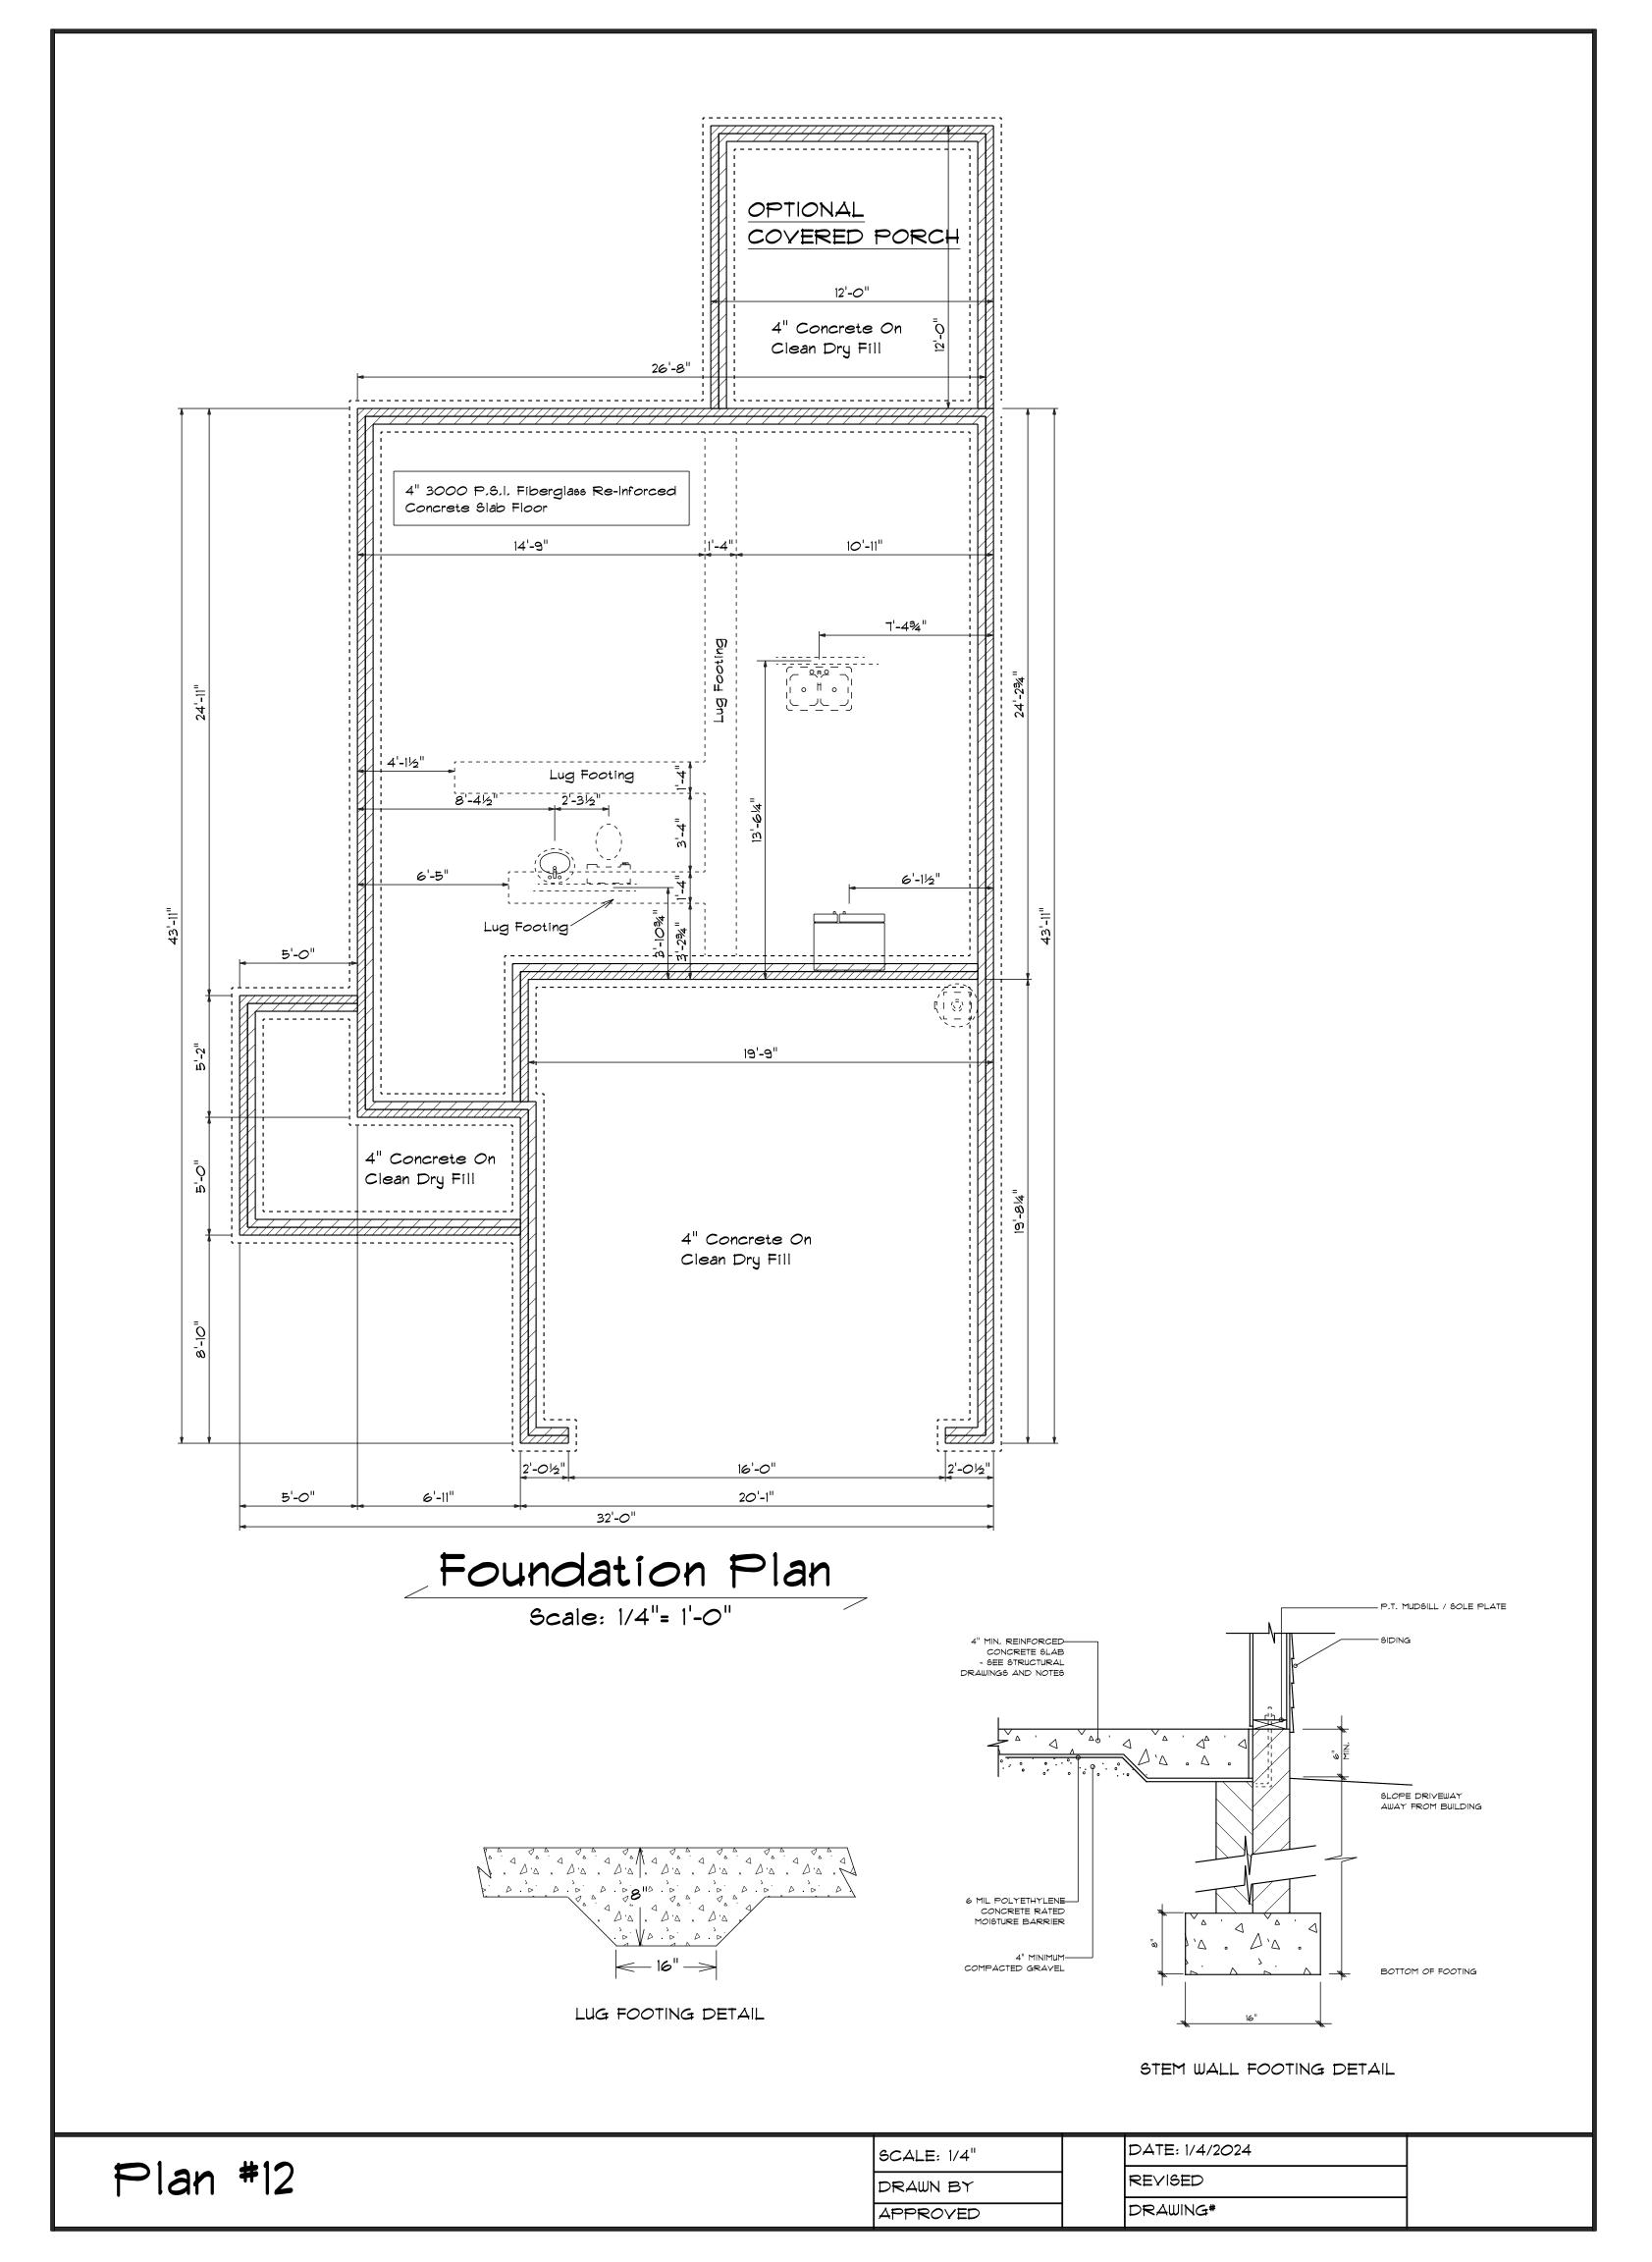

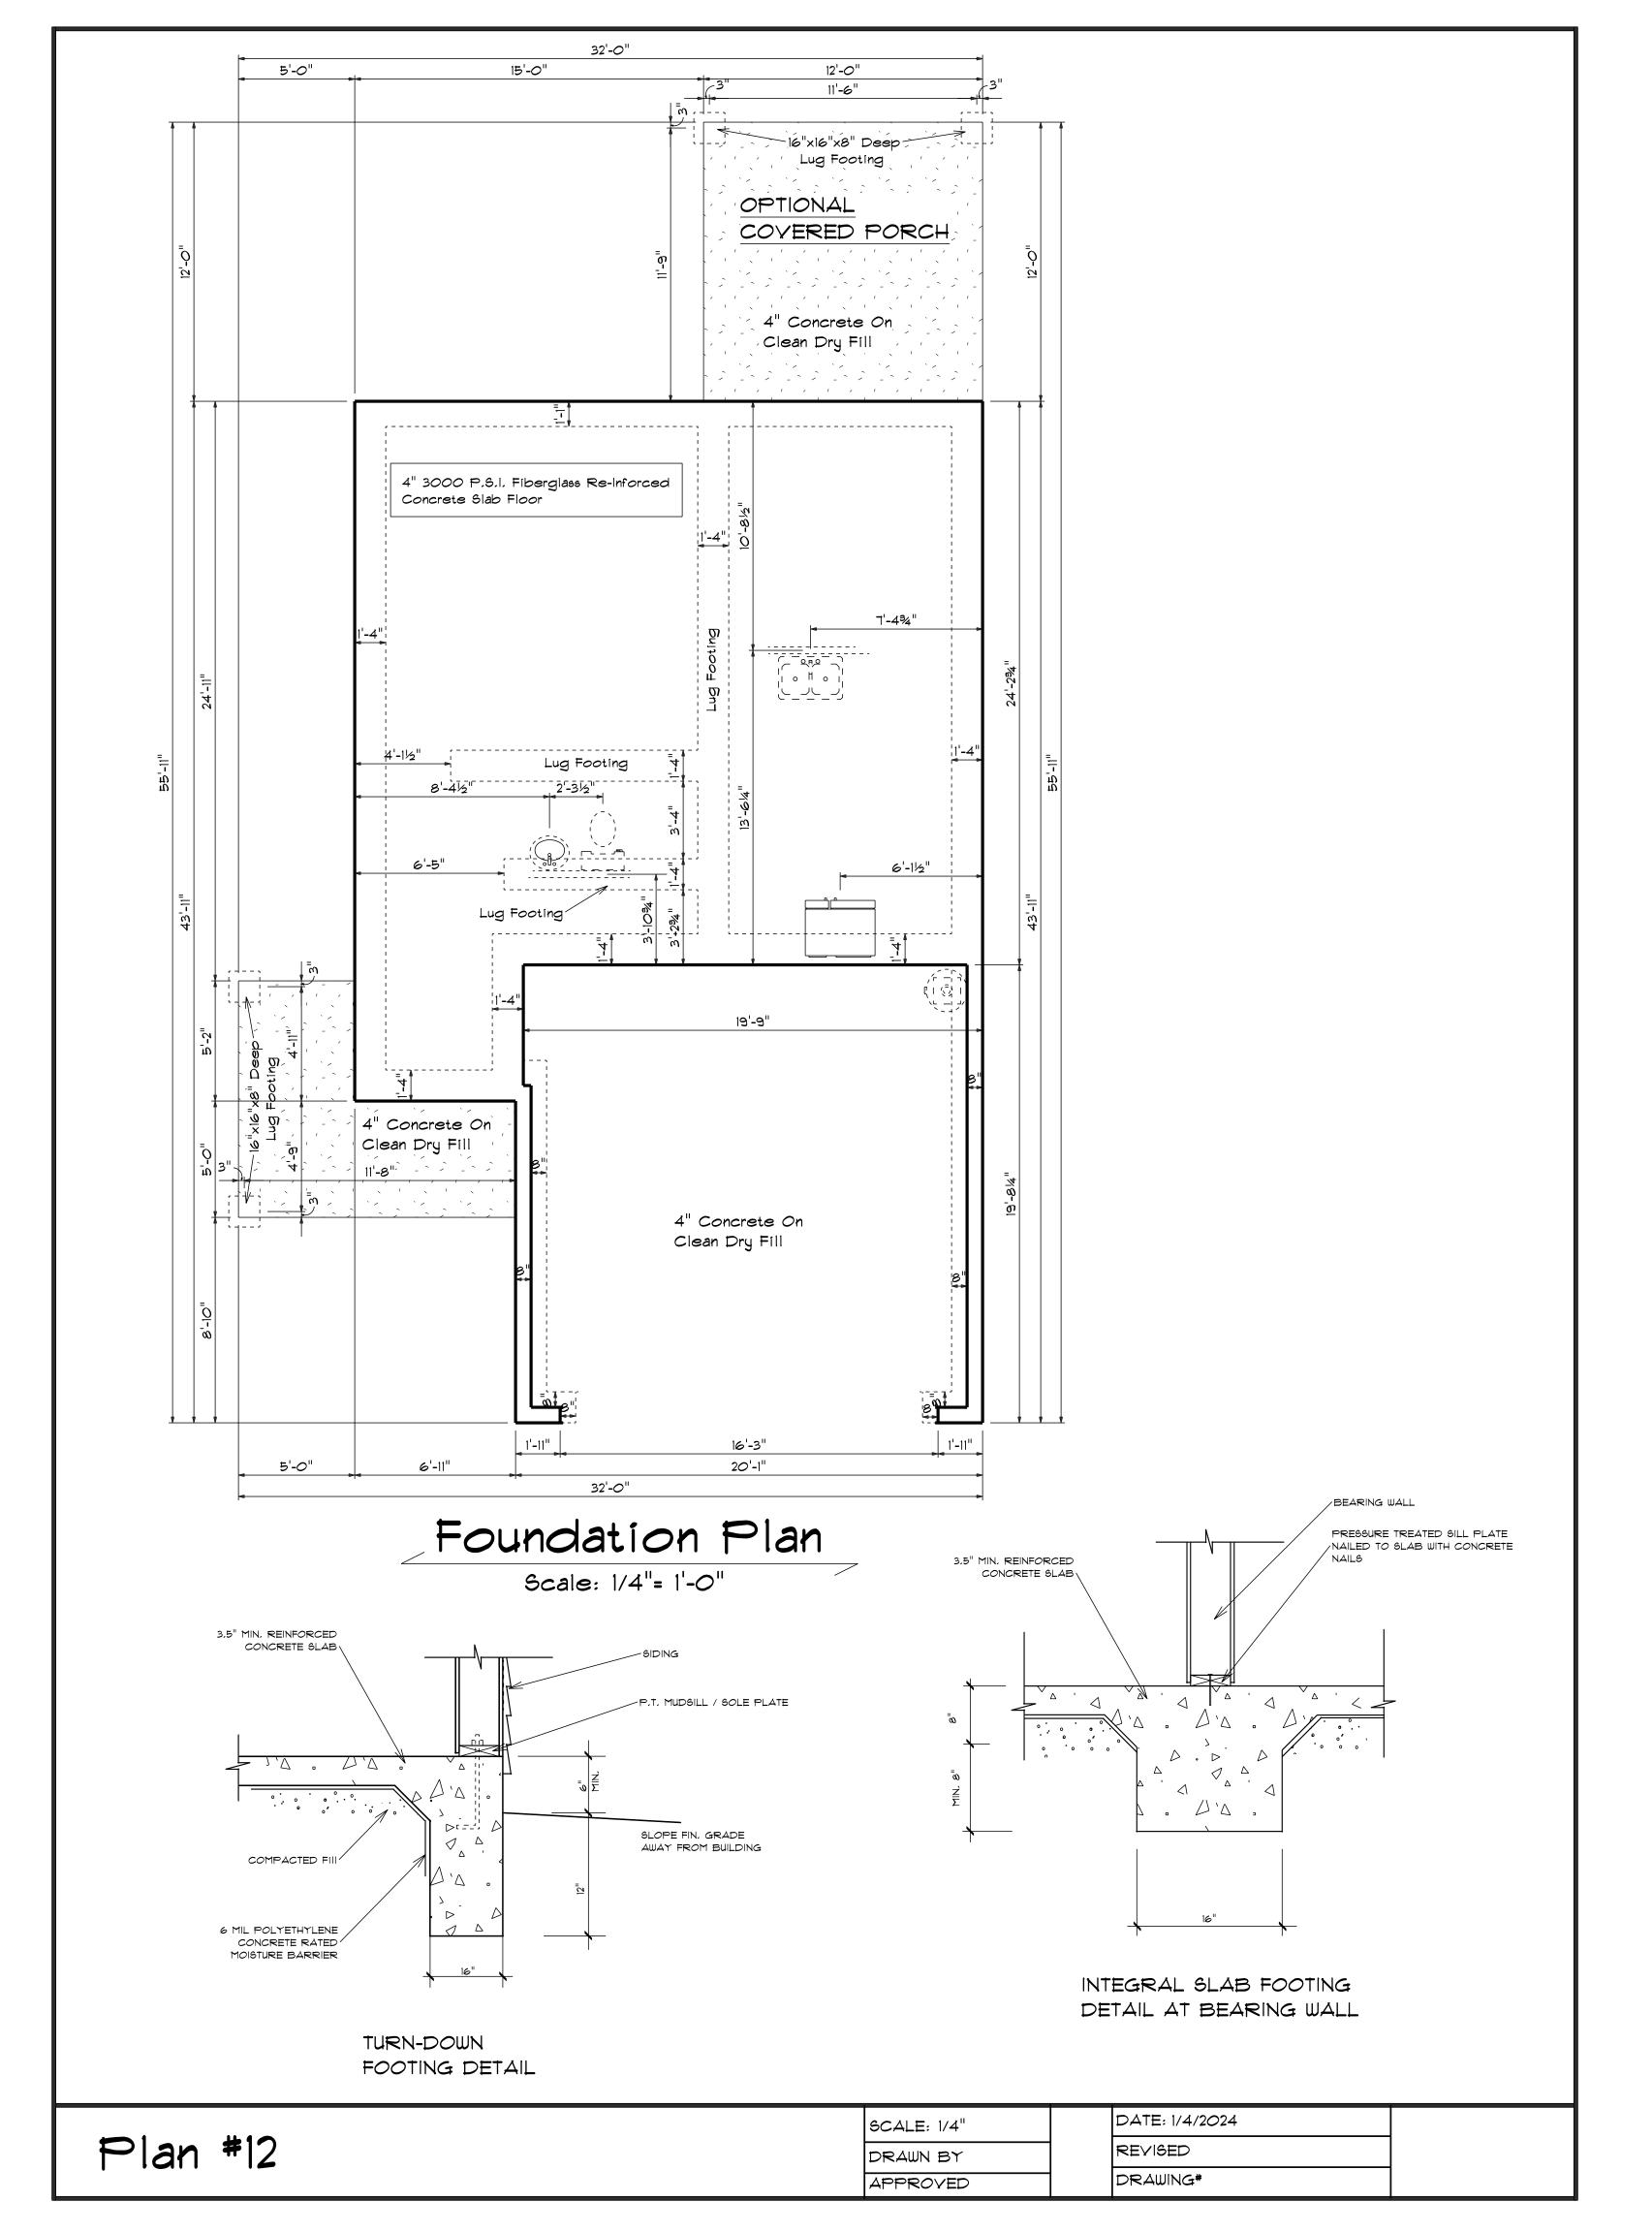

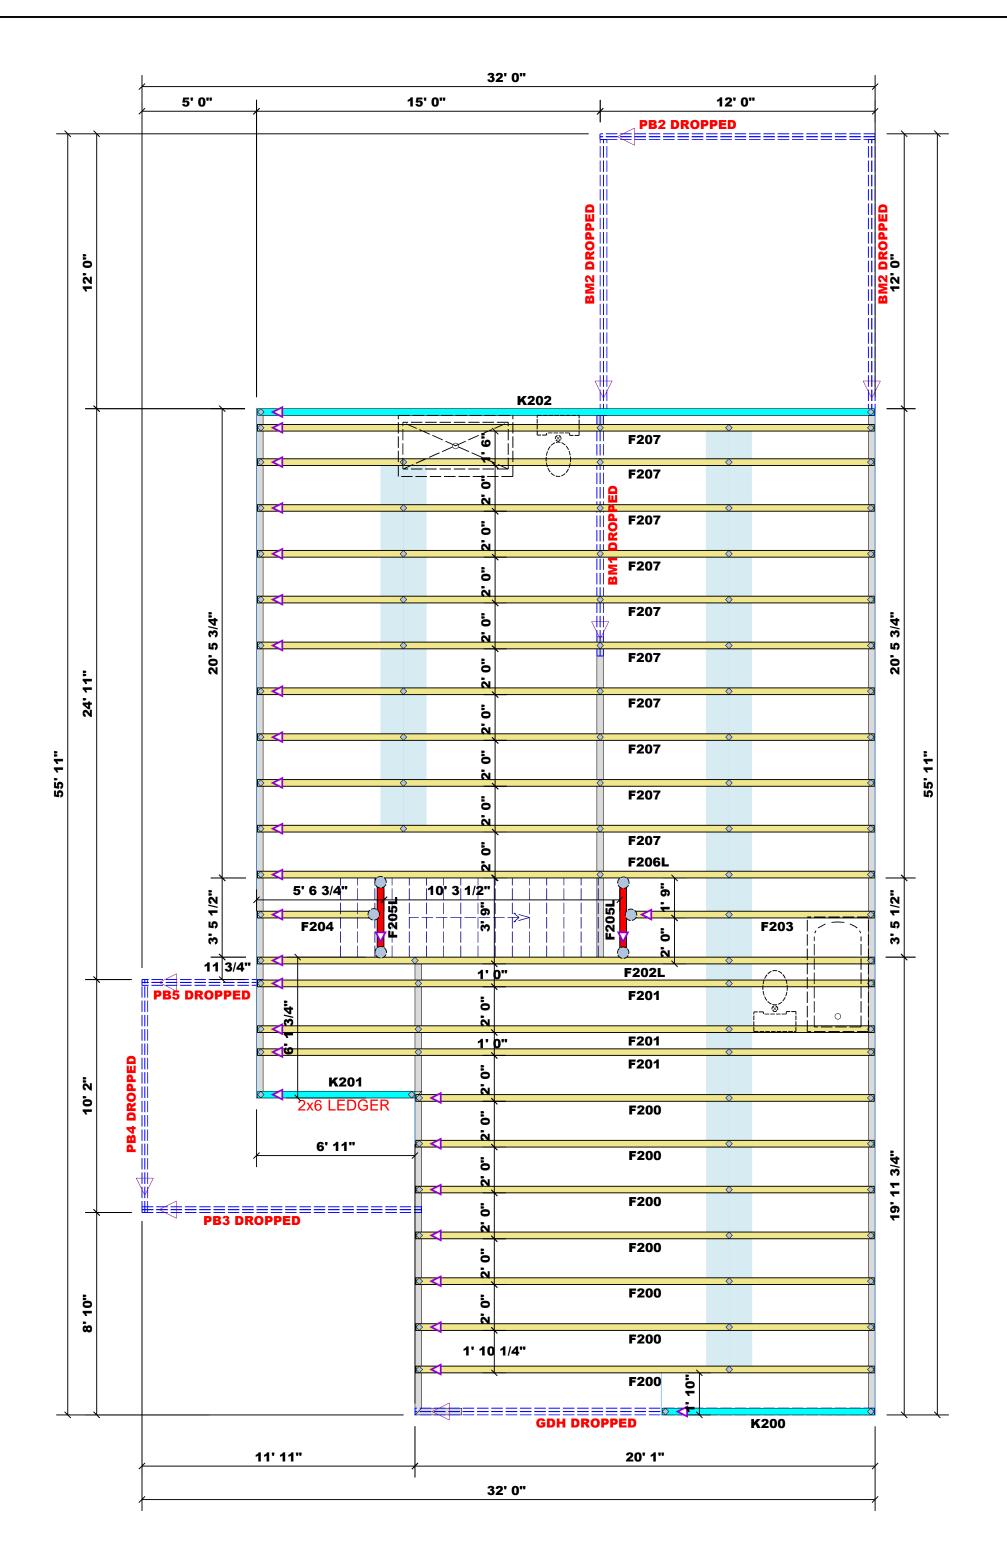


	Conne	Nail Info	ormation			
Sym	Product	Product Manuf Qty Supported Member		Supported Member	Header	Truss
$\bigcirc$	MSH422	USP	6	Varies	10d/3"	10d/3"

		Products		
PlotID	Length	Product	Plies	Net Qty
BM2 DROPPED	13' 0"	1-3/4"x 9-1/4" LVL Kerto-S	2	4
BM1 DROPPED	11' 0"	1-3/4"x 11-7/8" LVL Kerto-S	2	2
GDH DROPPED	21' 0"	1-3/4"x 14" LVL Kerto-S	2	2
PB3 DROPPED	14' 0"	2x10 SPF No.2	2	2
PB2 DROPPED	12' 0"	2x10 SPF No.2	2	2
PB4 DROPPED	12' 0"	2x10 SPF No.2	2	2
PB5 DROPPED	6' 0"	2x10 SPF No.2	2	2

(BASED ON T	T FOR JACK STUDS	BUILDER	Wellco Construction	<i>C</i> ITY / <i>C</i> O.	Harnett County / Harnett	THIS IS A TRUSS PLACEMENT DIAGRAM ONLY. These trusses are designed as individual building components to be incorporated into the building design at the specification of the building designer. See individual design sheets for each truss design identified on the placement drawing. The building designer	
	ADER/GIRDER	JOB NAME	Lot 4 Overhills Creek 2ND FL	ADDRESS	340 Caldwell Street	is responsible for temporary and permanent bracing of the roof and floor system and for the overall structure. The design of the truss support structure including headers, beams, walls, and columns is the responsibility of the building designer. For general guidance regarding bracing, consult BCSI-B1 and BCSI-B3 provided with the truss delivery package	соттесн
END REAC (UP T (UP T (2) PLY H (2) PLY H	END REAC (UP T (UP T) (UP T) (3) PLY H (3) PLY H (UP T) (UP T) (4) PLY H	PLAN	Plan #12	MODEL	FLOOR	or online @ sbcindustry.com Bearing reactions less than or equal to 3000# are deemed to comply with the prescriptive Code requirements. The contractor shall refer to the attached Tables	<b>ROOF &amp; FLOOR</b>
3400     2     5       5100     3     76	2550     1     3400     1       5100     2     6800     2       7650     3     10200     3	SEAL DATE	Seal Date	DATE REV.	11	( derived from the prescriptive Code requirements ) to determine the minimum foundation size and number of wood studs required to support reactions greater than 3000# but not greater than 15000#. A registered design professional shall be retained to design the support system for any reaction that exceeds those	<b>TRUSSES &amp; BEAMS</b> Reilly Road Industrial Park
8500 5 12 10200 6 15	0200 4 13600 4 2750 5 5300 6	QUOTE #	B0424-1916	DRAWN BY	Michael Turner	specified in the attached Tables. A registered design professional shall be retained to design the support system for all reactions that exceed 15000#. Michael Turner	Fayetteville, N.C. 28309 Phone: (910) 864-8787
11900 7 13600 8 15300 9		JOB #	J0424-1916	SALES REP.	Lenny Norris	SignatureMichael Turner	Fax: (910) 864-4444

<u>Truss</u> <u>Placement</u> <u>Plan</u> SCALE: NTS Indicates Left End of Truss
(Reference Engineered Truss Drawing)
Do NOT Erect Truss Backwards

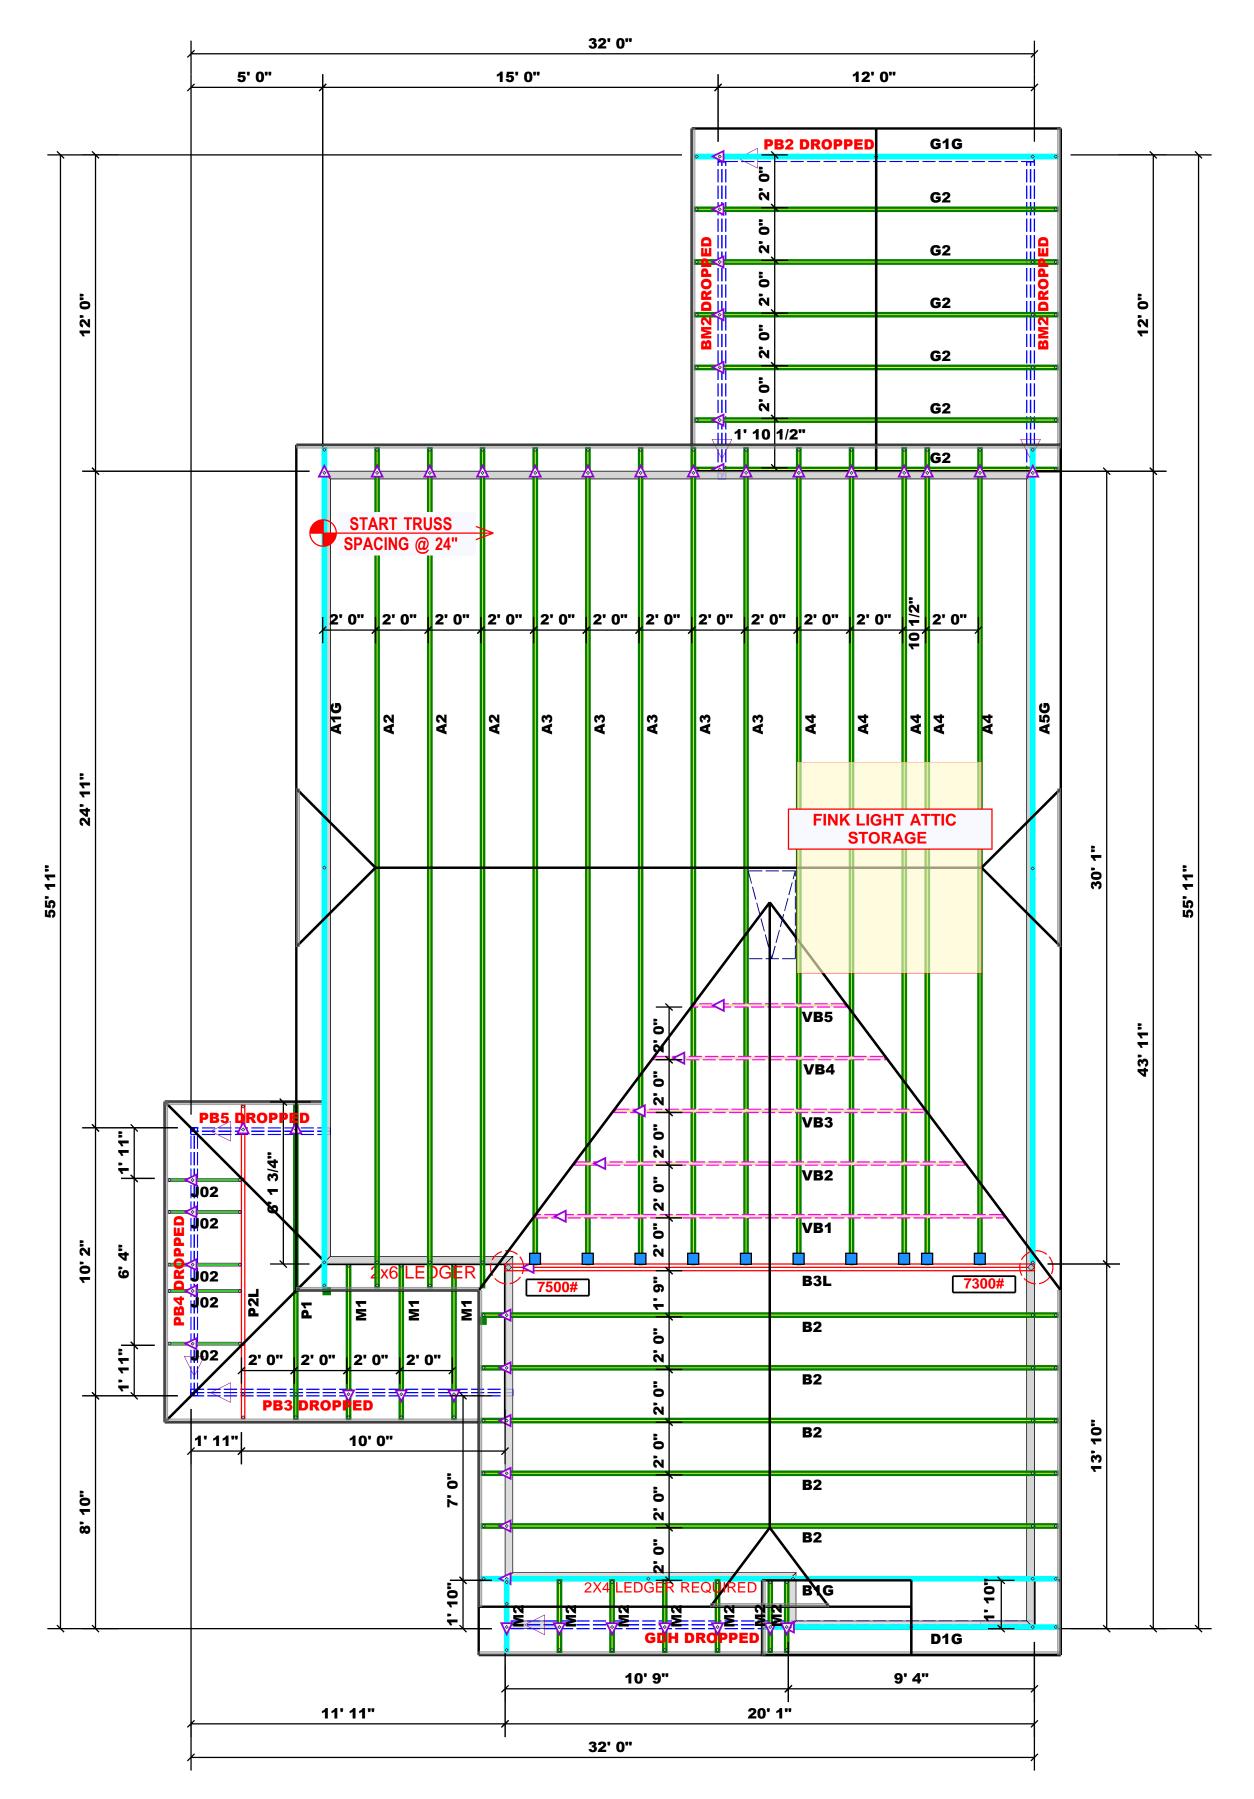

	Conne	Nail Info	ormation			
Sym	Product	Manuf	Qty	Supported Member	Header	Truss
	HUS26	USP	10	NA	16d/3-1/2"	16d/3-1/2"

GENERAL NOTES 1. FLAS IN A4 TRUSSES 2. M2 TRUSSES REQUIRE LEDGER

Indicates Left End of Truss
(Reference Engineered Truss Drawing)
Do NOT Erect Truss Backwards

	(BASED C	RT FOR JAC	å (b))	BUILDER	Wellco Construction	CITY / CO.	Harnett County / Harnett	THIS IS A TRUSS PLACEMENT DIAGRAM ONLY. These trusses are designed as individual building components to be incorporated into the building design at the specification of the building designer. See individual design sheets for each truss design identified on the placement drawing. The building designer	
NOIL (C		HEADER/GIRDER	O) O) Seven and a seven and a seven a	JOB NAME	Lot 4 Overhills Creek	ADDRESS	340 Caldwell Street	is responsible for temporary and permanent bracing of the roof and floor system and for the overall structure. The design of the truss support structure including headers, beams, walls, and columns is the responsibility of the building designer. For general guidance regarding bracing, consult BCSI-B1 and BCSI-B3 provided with the truss delivery package	соттесн
-	REQ'D STU (2) PLY HI	END REAC (UP TC (UP TC (3) PLY HI	END REAC (UP T (4) PLY H	PLAN	Plan #12	MODEL	Roof	or online @ sbcindustry.com Bearing reactions less than or equal to 3000# are deemed to comply with the prescriptive Code requirements. The contractor shall refer to the attached Tables	<b>ROOF &amp; FLOOR</b>
1700 3400 5100	) 2 ) 3	2550 1 5100 2 7650 3	10200 3	SEAL DATE	Seal Date	DATE REV.	04/03/24	( derived from the prescriptive Code requirements ) to determine the minimum foundation size and number of wood studs required to support reactions greater than 3000# but not greater than 15000#. A registered design professional shall be retained to design the support system for any reaction that exceeds those	<b>TRUSSES &amp; BEAMS</b> Reilly Road Industrial Park
6800 8500 10200	) 5 0 6	10200 4 12750 5 15300 6	13600 4 17000 5	QUOTE #	B0324-1878	DRAWN BY	Michael Turner	specified in the attached Tables. A registered design professional shall be retained to design the support system for all reactions that exceed 15000#. Michael Turner	Fayetteville, N.C. 28309 Phone: (910) 864-8787
11900 13600 15300	08			JOB #	J0324-1878	SALES REP.	Lenny Norris	SignatureMichael Turner	Fax: (910) 864-4444

<u>Truss Placement Plan</u> SCALE: NTS

