REVISION LOG

REVISION:001

- CHANGED OPT. EXTENDED CAFE TO STANDARD
- ADDED 24" CHASE TO EXTENDED CAFE
 ADDED BEAD BOARD AND HOOKS TO DROP ZONE AREA

- 3. ADDED BEAD BOARD AND HOOKS TO DROP ZONE AREA
 4. BUMPED LOFT AND BEDROOM 3 OUT 24* TO LINE UP WITH FLOOR BELOW
 5. FLIPPED DOOR AT LAUNDRY CLOSET
 6. CHANGED OWNER'S BLINEN DOOR TO A 3/0 DOUBLE HINGE
 7. ALIGNED OWNER'S BATH DOOR WITH WIC ACROSS
 8. FLIPPED SEAT AT OPT. SHOWER
 9. ROOF AT REAR CHANGED PER BUMP OUT
 10. EXTENDED TRIM AT GRARGE DOOR DOWN TO BASE AND CUT BRICK/STONE BACK
 11. REMOVED HALF WALLS AT KITCHEN ISLAND AND UPDATED PER CABINET PROVIDER
 12. CHANGED ALL LINEN CLOSETS TO HAVE ONLY 4 SHELVES
 22. CHANGED THE BASE OWNER'S BATH WINDOW TO 4010
 24. CHANGED THE OWNER'S BATH OPTION SHOWER W/18* SEAT WINDOW TO 4010
 24. CHANGED THE OWNER'S BATH OPTION SUPER SHOWER WINDOWS TO (2)3010

- CHANGED THE OWNER'S BATH OPTION SUPER SHOWER WINDOWS TO (2)3010
 UPDATED THE FRENCH COUNTRY PORCH STONE COLUMNS
 EXTENDED FRENCH COUNTRY PORCH SLAB 4" AT FRONT AND EXTEND AROUND CORNER TO SUPPORT STONE VENEER

REVISION:002 DATE: 3/24/2022

- ADD ELECTRICAL PLANS
 EXTEND 4" PORCH LEDGE ON SLAB FOUNDATION PAGE
- EXTEND 4" PORCH LEDGE ON FLOOR PLAN W/ NOTE "EXTEND PORCH SLAB 4" FROM FRAMING FOR STONE VENEER @ SLAB FOUNDATION PORCH DOES NOT EXTEND WITH CRAWL OPTION".
- 4. ADD 2030 WINDOWS IN THE POWDER & CLOSET/OPT. DELIVERY CENTER. CENTER INBETWEEN THE COLUMNS
 5. CHANGE PORCH BEAMS FROM 12" WIDE TO 8" WIDE.
 6. CHANGE PORCH WALLS TO 20"X20" FRAMED W/ STONE WRAP. ADJUST ELEVATIONS.

- CHANGE PORCH WALLS TO 20"X20" FRAMED WY STONE WRAP. ADJUST ELEVATO.
 ADD RASED CEILING @ PORCH GABLE. ADD PLATE HT DIMENSION TO FRONT ELEVATION.
 CENTER GABLE RIDGE WITH BEDROOM #2 WINDOW. ADJUST PORCH GABLE ACCORDINGLY. ADD DIMENSION ON ELEVATION.
 ADD 10" BAND AT GABLES ON FRONT ELEVATION

- ADD TO BAND AT GABLES ON FRONT ELEVATION
 DIN STONE WAINSCORING HT
 SHOW CRAME SPACE GRADE LINE 2'-6" BELOW FINSHED FLOOR
 INCREASE WIDTH OF EXTERIOR STAIRS TO ALLOW FOR RAIL
 ADD NOTE "FURR OUT DOUBLE WALL UNDER FRONT PORCH CEILING." ON FLOOR PLANS AND ELEVATIONS
- 14. ABOVE PORCH SHED ROOF, CUT OFF STONE AT COLUMN AND ADD SIDING BACK TO WALL.

REVISION:003

DATE: 6/20/2022

ADD SIDE LOAD GARAGE.

REVISION:004

- ADD STEM WALL SLAB FOUNDATION SHEETS.
 ADD "STEM WALL" TO CRAWL ELEVATION TITLES AND ADD NOTE "SEE FOUNDATION PAGES FOR FOUNDATION TYPE". UPDATE SHEET TITLES

4-18-24- Initial Redlines - JJ

SQUARE	FOOT	4GE					
	'FRENCH COUNTRY' ELEVAT						
	UNHEATED	HEATED					
FIRST FLOOR	0	1053					
SECOND FLOOR	0	1462					
FRONT PORCH	180	0					
REAR PATIO	144	0					
2 CAR GARAGE	403	0					
SUBTOTALS	727	2515					
TOTAL UNDER ROOF	32	42					
0	PTIONS						
	UNHEATED S.F.	HEATED S.F.					
COVERED PATIO	144	0					
EXTENDED PATIO	+120	0					
SMART DOOR	-0	+0					
ALT. FIRST FLOOR w/ SMART DOOR DELIVERY	36	+36					

170 DC - Duncan Creek Rd, Lillington, NC 27546

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PLAN 3 The Cary - LH 'FRENCH COUNTRY'

ARCHITECTURAL DRAWINGS								
Sheet No.	Sheet Description							
0.0	Cover Sheet							
1.1	Foundation (Slab)							
1.1.1	Foundation Options (Slab)							
1.2	Foundation (Crawl)							
1.2.1	Foundation Options (Crawl)							
1.3	Foundation (Stem Wall Slab))							
1.3.1	Foundation Options (Stem Wall Slab)							
2.1	First Floor Plan							
2.1.1	First Floor Plan Options							
2.2	Second Floor Plan							
2.2.1	Second Floor Plan Options							
2.4	Covered Patio Plans & Elevations (Slab)							
2.4.1	Covered Deck Plans & Elevations (Crawl/ Stem Wall)							
2.5	2-Car Sideload Garage Plans							
2.5.1	2-Car Sideload Garage Elevations							
3.1	Front & Rear Elevations (Slab)							
3.1.1	Front & Rear Elevations (Crawl/ Stem Wall)							
3.2	Side Elevations (Slab)							
3.2.1	Side Elevations (Crawl/ Stem Wall)							
3.3	Roof Plan							
5.1	First Floor Electrical Plan							
5.1.1	First Floor Options Electrical Plan							
5.2	Second Floor Electrical Plan							
5.2.1	Second Floor Options Electrical Plan							

DESIGN CRITERIA:

THIS PLAN IS TO BE BUILT IN CONFORMANCE WITH THE 2018 NORTH CAROLINA STATE BUILDING CODE: RESIDENTIAL CODE

DIMENSIONS SHALL GOVERN OVER SCALE, AND CODE SHALL GOVERN OVER DIMENSIONS


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THE CARY

Cover Sheet 'French Country'


DRAWN BY: South Designs ISSUE DATE: CURRENT REVISION DATE

1/8" = 1'-0"

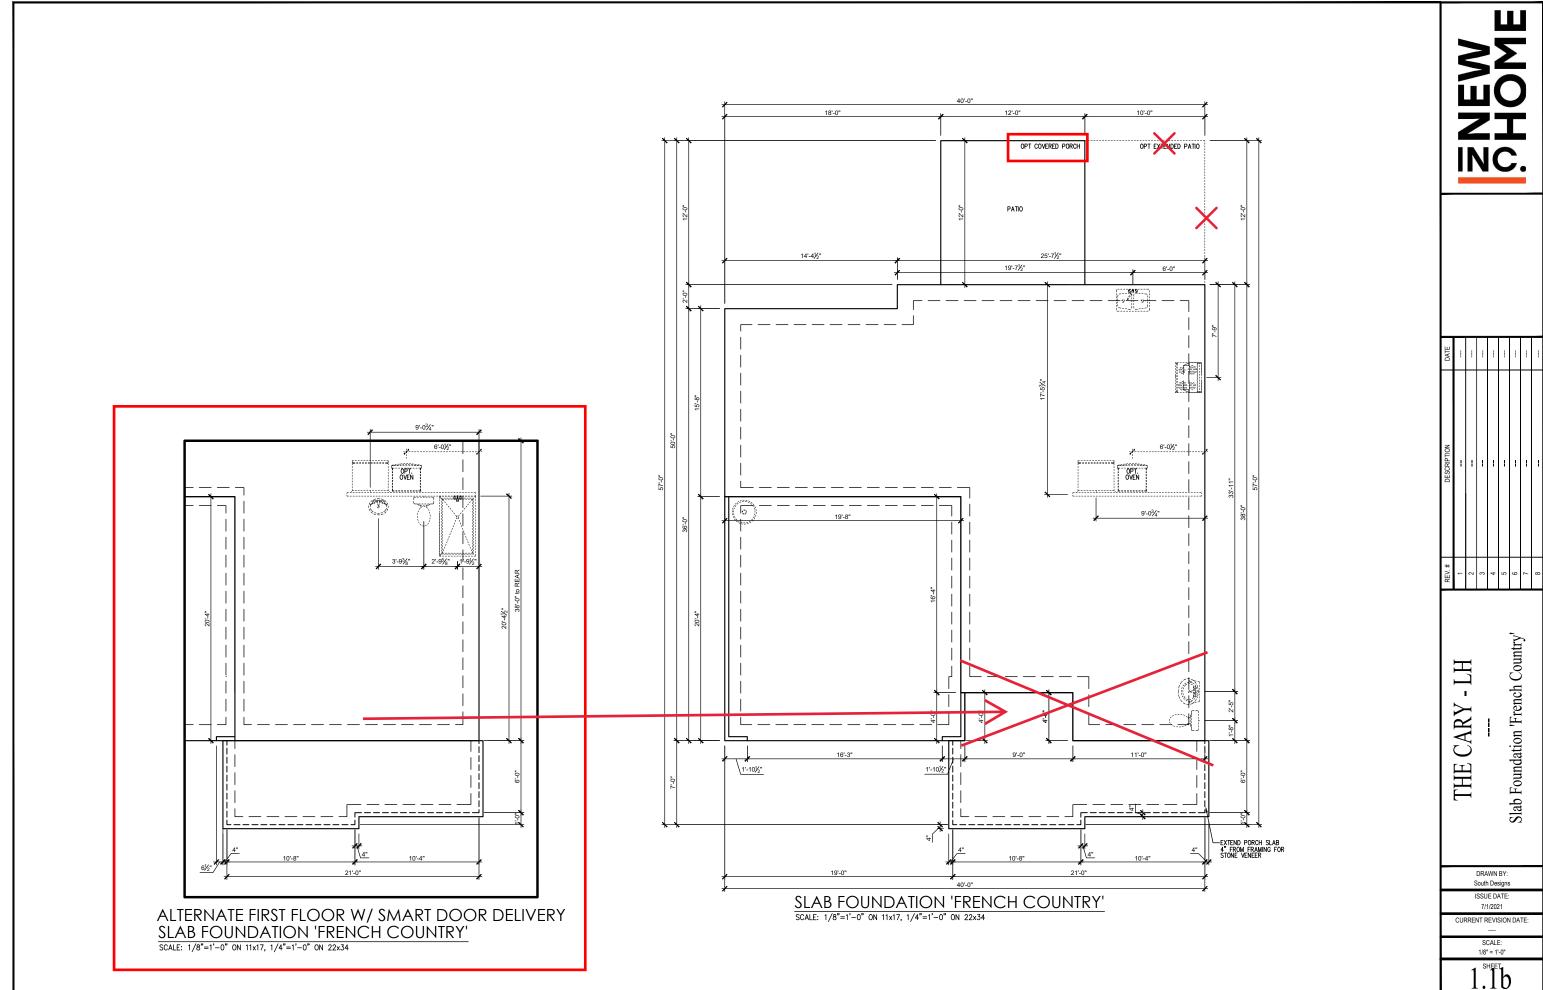

General Floor Plan Notes shall apply unless noted otherwise on plan.

- Wall Heights: Typically 9°-0" at first floor and 8°-0" at second floor and attics U.N.O. All walls are constructed using a double top plate. Splices at Double Top Plate do not need to occur at Vertical Studs but must be at least 24" apart from Joint in other Top Plate layer. Special wall heights are noted on plans where they occur.
- Wall Thickness is typically 3 1/2". 2x6 frame shall be used at walls that back up to plumbing fixtures.
 Walls greater than 10' high shall be framed with 2x6 framing or greater and will be noted as a special condition where it occurs on plan.
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- Jacks: Openings up to 3'-4" wide shall have (1) 2x4
 jack stud SPF on each side. Openings greater than
 3'-4" wide shall have (2) 2x4 jack studs SPF on each
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- Closets for clothing or coat storage shall be equipped with 1 rod/shelf. Closets for linen shall have 4 open equal shelves. Closets for panties shall have 4 equal wood shelves, painted.
- Stair treads shall be a min of 9" deep, risers shall be a maximum of 8 1/4", unless noted otherwise, per the current North Carolina Residential Code
- 10. Handrails and Guards at stairs shall be 34" above the finished surface of the ramp surface of the stair. Handrails at landings and overlooks of multilevel spaces shall be 36" above finished floor. Guards (pickets or balusters) shall be spaced with no more than 4" between guards.
- Attic Access shall be provided at all attic area with a height greater than 30". Minimum clear attic access shall be 20" x 30". Pull down stairs and access doors in knee walls meeting minimum criteria are also acceptable.
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- 13. Garage Walls, as a minimum, shall be separated from living space by installing 1/2" gypsum board on the garage side of the wall. With habitable space above, the inside of all garage walls require 1/2" GWB supporting 5/8" type X GWB on ceiling.

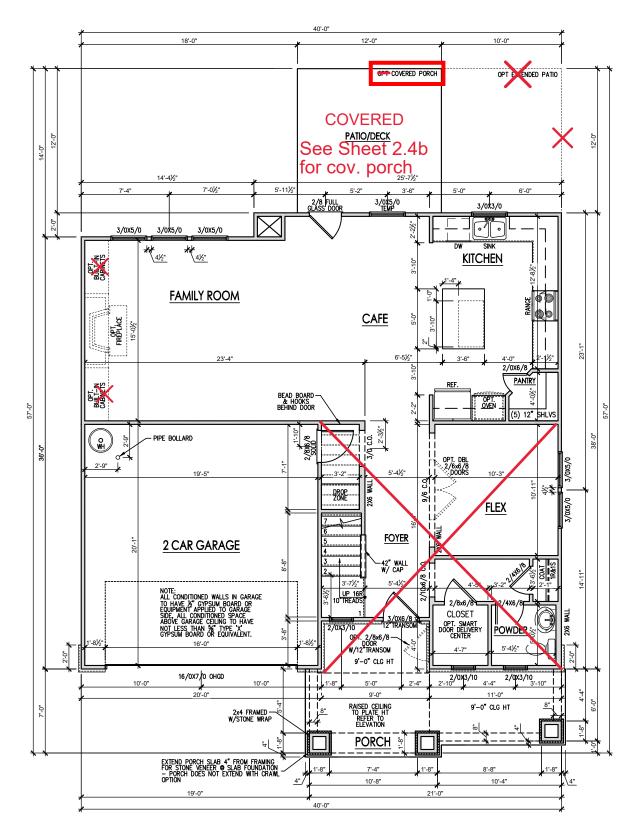

FIRST FLOOR PLAN 'FRENCH COUNTRY' SCALE: 1/8"=1'-0" ON 11x17, 1/4"=1'-0" ON 22x34

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DATE	2/4/2022	03/24/2022	06/20/2022	07/22/2022				
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First Floor Plan 'French Country' - THE CARY 3 PLAN.

-TH


DRAWN BY: South Designs

ISSUE DATE: 07/01/2021

JRRENT REVISION DATE 07/22/2022 SCALE: 1/8" = 1'-0"


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SECOND FLOOR PLAN 'FRENCH COUNTRY'
SCALE: 1/8"=1'-0" ON 11x17, 1/4"=1'-0" ON 22x34

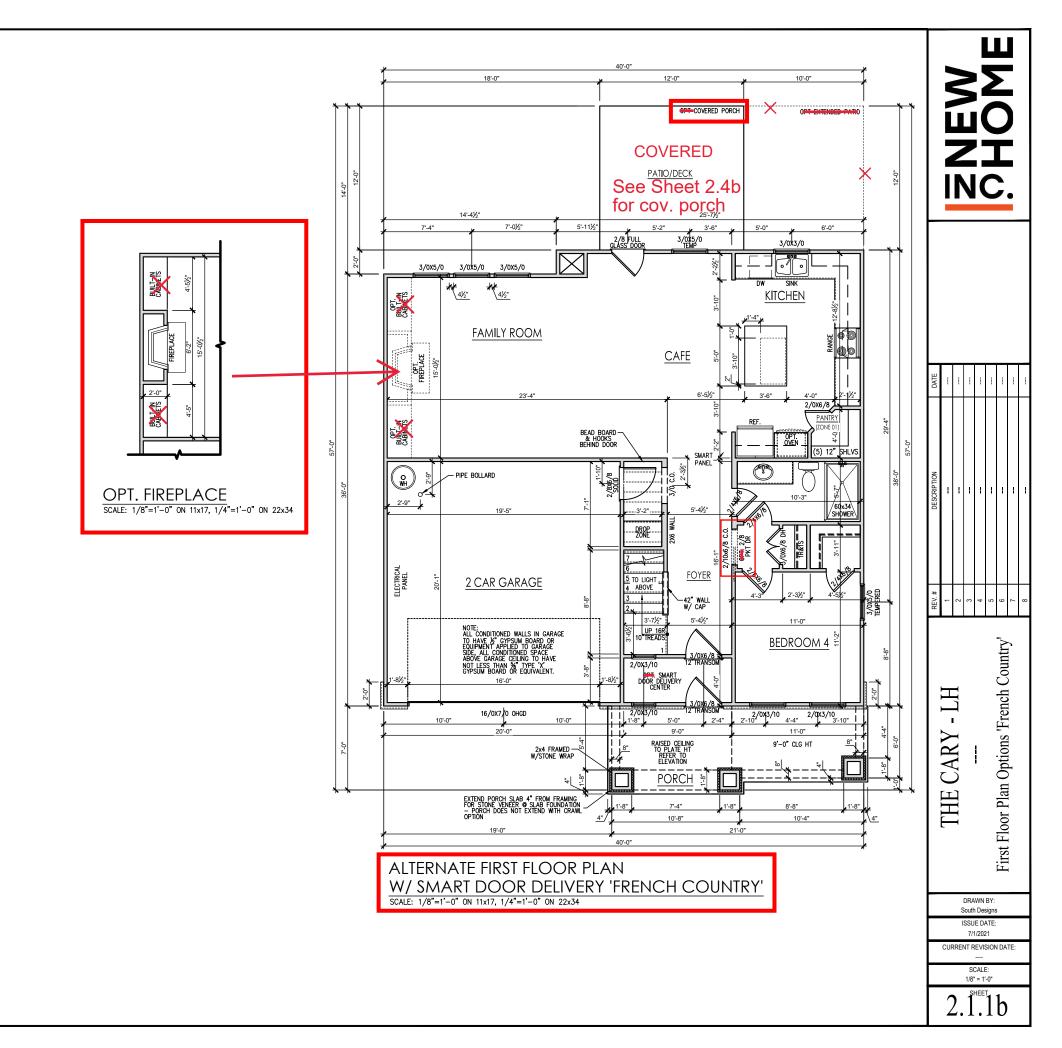

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DRAWN BY: South Designs

- THE CARY

3

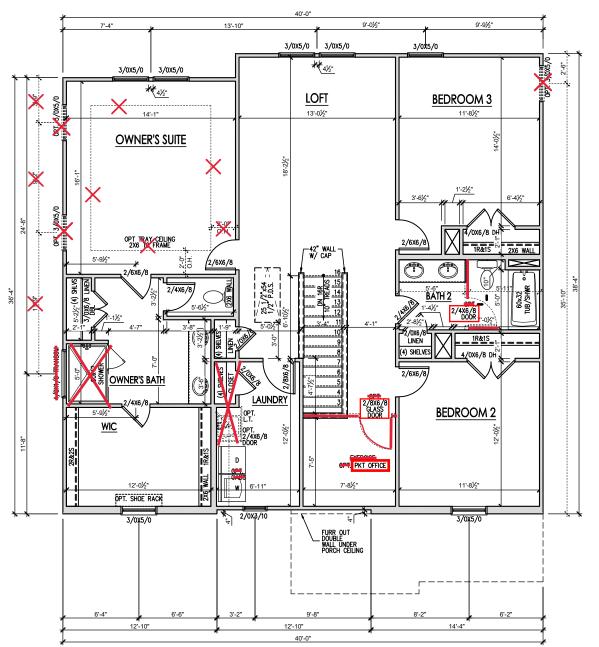PLAN

Second Floor Plan 'French Country'


ISSUE DATE: 07/01/2021

CURRENT REVISION DATE: 07/22/2022 SCALE:

1/8" = 1'-0"
2.2b

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DATE	2/4/2022	03/24/2022	06/20/2022	07/22/2022				
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| 3 - THE CARY - LH SINGLE FAMILY d Floor Plan Options French Country' 3 Second PLAN


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DRAWN BY: South Designs

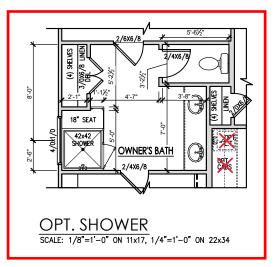ISSUE DATE: 07/01/2021

CURRENT REVISION DATE: 07/22/2022 SCALE: 1/8" = 1'-0"

2.2.1b

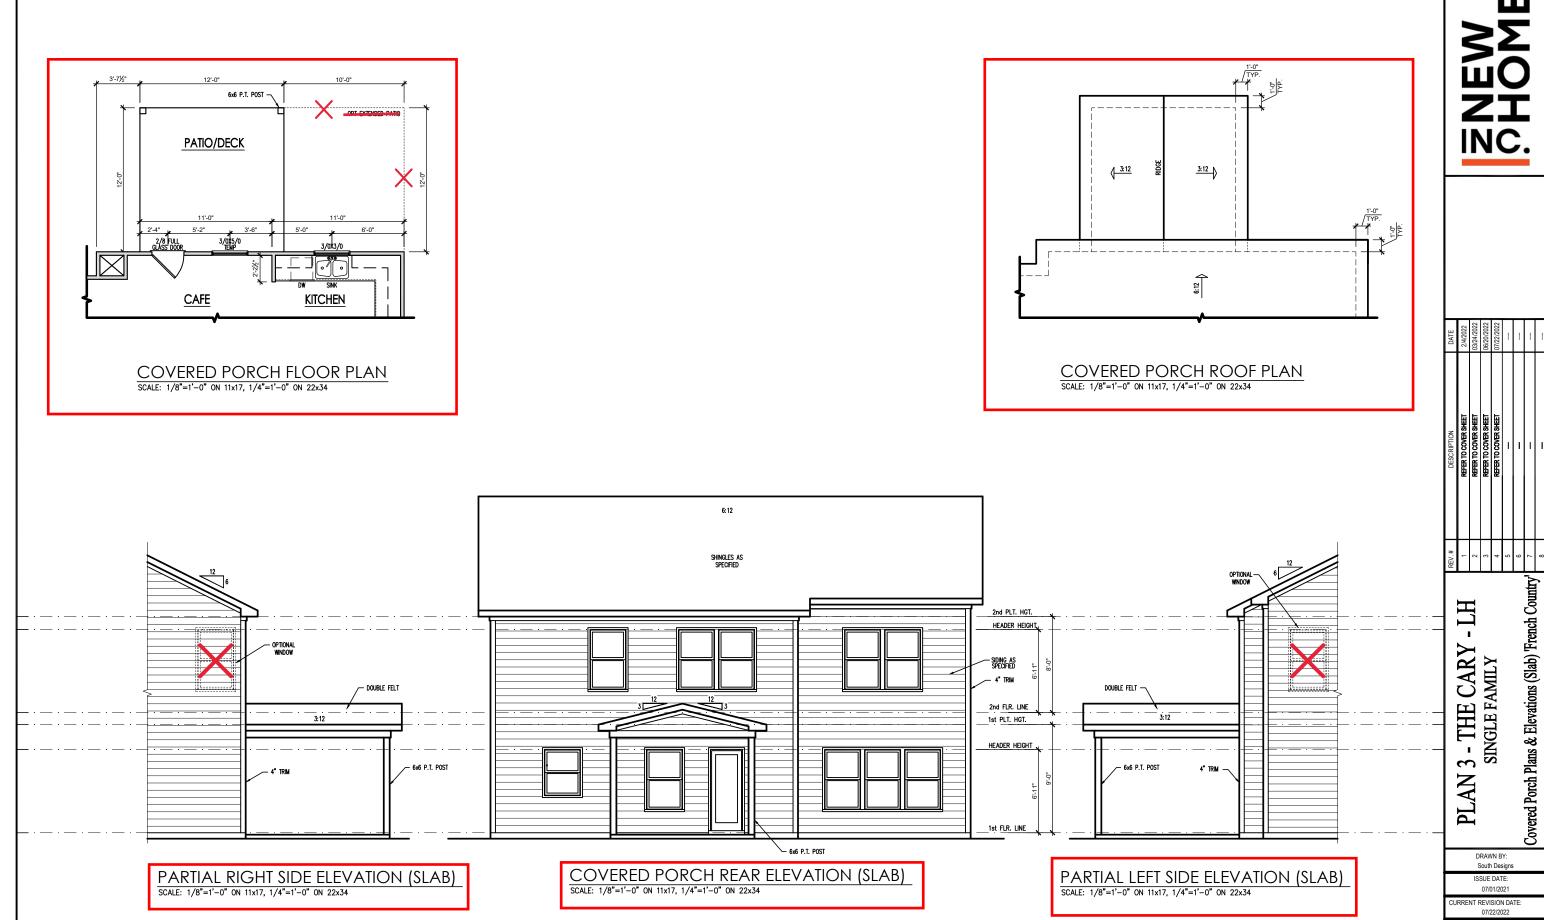

SCALE: 1/8" = 1'-0"

2.4b

General Elevation Notes


General Elevation Notes shall apply unless noted otherwise on plan.

- Roof shall be finished with architectural composition shingles with slopes as noted on plan.
- Ridge Vent shall be provided and installed on all ridges greater than 6' in length per manufacturer's specifications.
- 3. Soffit Vent shall be continuous soffit vent
- House Wrap, "tyvek" or approved equal shall be installed over entire exterior wall per manufacturer's specifications and recommendations.
- Flashing shall be provided above all door and window openings, above finish wall material changes and at wall surfaces where lower roof areas abut vertical wall surfaces.
- Porch Railings shall be provided at all porch walking surfaces greater than 30" above adjacent finished grade. It shall be 36" high with guards spaced no more than 4" apart. Consult community specifications for material.
- Finish Wall Material shall be as noted on elevation drawings.
- 8. Brick Veneer, if included on elevation shall be fled to wall surface with galvanized corrugated metal fles at a rate of 24" oc horizontally and 16" oc vertically so that no more than 2.67sf of brick is supported by (1) fle. Space between face of wall and back face of brick shall be limited to a maximum of 1". Flashing shall be provided behind brick above all wall openings and at base of brick wall. Flashing shall be a minimum of 6-mil poly or other corrosion resistant material and shall be installed so that it laps under the house wrap material an inimum of 2". Weepholes shall be provided at a rate of 48" oc and shall not be less than 3/16" in diameter and shall be located immediately above flashing.
- Brick Veneer Support Lintels shall be provided if brick veneer is included on elevation. Lintels shall be provided as listed in the following schedule and shall have a minimum bearing length of 6". Masonry Lintels shall be provided so that deflection is limited to L/600.

Masonry Opening Lintel Schedule

ning Size Angle

	-		-
up to	4'-0"		3-1/2" x 3-1/2" x 5/16"
4'-1"	to	5'-6"	4" x 3-1/2" x 5/16" LLV
5'-7"	to	6'-6"	5" x 3-1/2" x 5/16" LLV
6'-7"	to	8'-4"	6" x 3-1/2" x 5/16" LLV
8'-5"	to	16'-4"	7" x 4" x 3/8" LLV

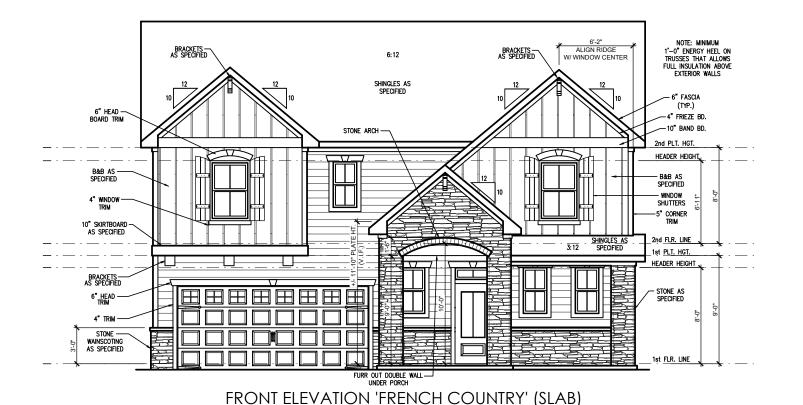

SCALE: 1/4" = 1'-0" ON 22x34, 1/8" = 1'-0" ON 11x17

PLAN 3 - THE CARY - LH
SINGLE FAMILY
Front & Rear Elevations (Slab) 'French
Country'

DRAWN BY: South Designs

ISSUE DATE: 07/01/2021

CURRENT REVISION DATE: 07/22/2022 SCALE: 1/8" = 1'-0"

3.1b

General Elevation Notes


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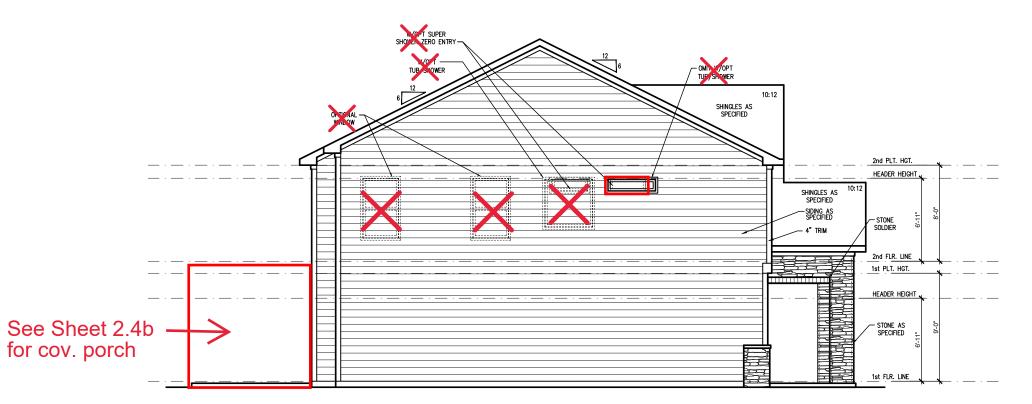
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Masonry Opening Lintel Schedule

Opening Size	Angle

up to	4'-0"		3-1/2" x 3-1/2" x 5/16
4'-1"	to	5'-6"	4" x 3-1/2" x 5/16" LLV
5'-7"	to	6'-6"	5" x 3-1/2" x 5/16" LLV
6'-7"	to	8'-4"	6" x 3-1/2" x 5/16" LLV
8'-5"	to	16'-4"	7" x 4" x 3/8" LLV



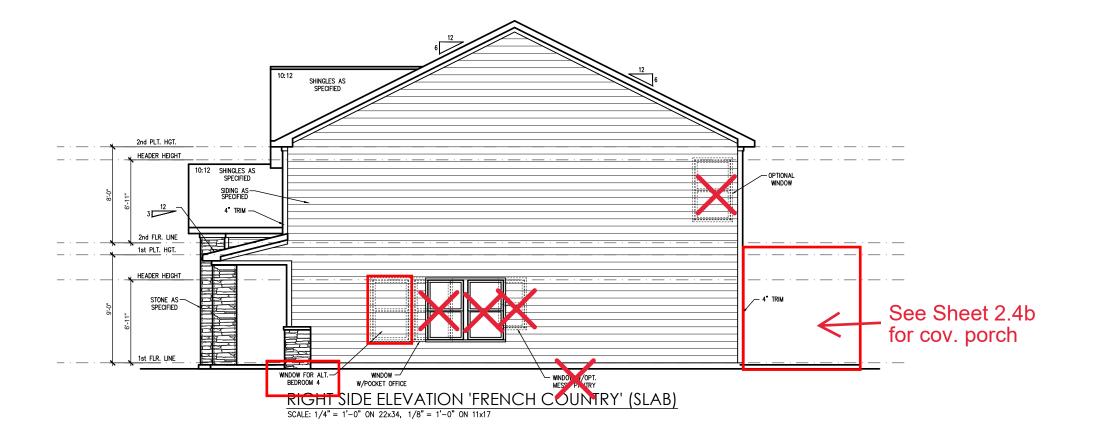

 $\frac{\text{LEFT SIDE ELEVATION 'FRENCH COUNTRY' (SLAB)}}{\text{SCALE: } 1/4" = 1'-0" \text{ ON } 22x34, \ 1/8" = 1'-0" \text{ ON } 11x17}$




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Side Elevations (Slab) 'French Country' - LH THE CARY

> DRAWN BY: South Designs ISSUE DATE: 7/1/2021

CURRENT REVISION DATE:

1/8" = 1'-0"

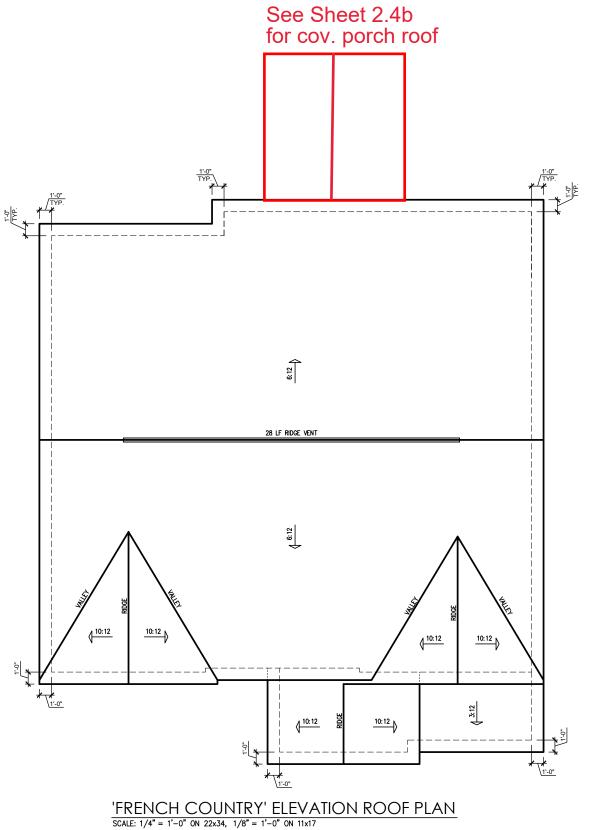

	ATTIC VENT SCHEDULE												
	'FRENCH COUNTRY' ELEVATION												
	MAIN	HOUSE		SQ FTG	1449	AT	/ NEAR RID	AT / NEAR EAVE					
			. FT. JIRED	SQ. FT.	PERCENT OF TOTAL	POT LARGE (SQ. FT. EACH)	POT SMALL (SQ. FT. EACH)	RIDGE VENT (SQ. FT. PER LF)	EAVE VENT (SQ. IN. EACH)	CONT. VENT (SQ. IN. PER LF)			
	721111112	RAN		SUPPLIED	SUPPLIED	0.4236	0.2778	0.125	0.1944	0.0625			
	RIDGE VENT 1.93 2.42		2.42	3.50	48.28	0	0	28.00					
			3.75	51.72				0	60.00				
	TOTAL (MIN)	4.83	4.83	.83 7.25 100.00 POT VENTS MAY BE REQUIRED IF THERE IS INSUFFICIENT RID					GE AVAILABLE				

* SCHEDULE HAS BEEN CALCULATED ASSUMING EAVE VENTILATION AT 50-60% OF TOTAL AND RIDGE AT 40-50% OF TOTAL REQUIRED VENTILATION

MINC.

PLAN 3 - THE CARY - LH SINGLE FAMILY Roof Plan 'French Country'

> DRAWN BY: South Designs

ISSUE DATE: 07/01/2021


CURRENT REVISION DATE: 07/22/2022

3.3b

PROJECT # 21-2867-LH

P.A. 27609

Southern Engineers, P 3716 Benson Drive, Raleigh, NC 27 Phone: (919) 878-1617 License: C-4772

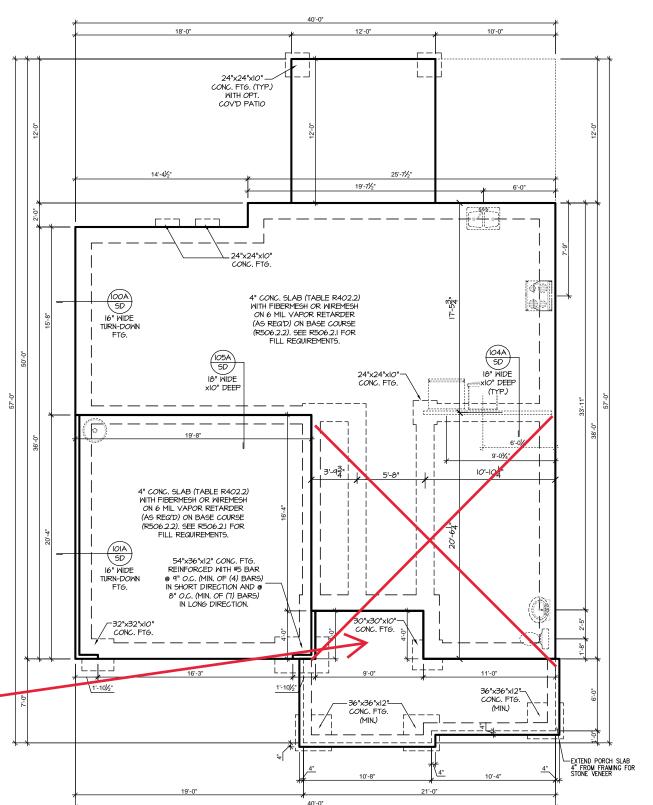

SLAB FOUNDATION 'FRENCH COUNTRY' SCALE: 1/8"=1'-0" ON 11x17, 1/4"=1'-0" ON 22x34

ALTERNATE FIRST FLOOR W/ SMART DOOR DELIVERY SLAB FOUNDATION 'FRENCH COUNTRY' SCALE: 1/8"=1'-0" ON 11x17, 1/4"=1'-0" ON 22x34

36"x36"x12"— CONC. FTG. (MIN.)

EXTEND PORCH SLAB 4" FROM FRAMING FOR STONE VENEER

(IO4A) SD

18" WIDE xIO" DEEP

36"x36"x12"-CONC. FTG.

(MIN.)

32"x32"xIO"

REFER TO "SD" SHEET(S) FOR STANDARD DETAILS, BRACING DETAILS AND STRUCTURAL NOTES.

-The Cary

3 Plan

INC. NEW HOME,

- TRUSS SYSTEM LAYOUTS (PLACEMENT PLANS) SHALL BE DESIGNED IN ACCORDANCE WITH SEALED STRUCTURAL PLANS. ANY NEED TO CHANGE TRUSSES SHALL BE COORDINATED WITH SOUTHERN ENGINEERS
- TRUSS SCHEMATICS (PROFILES) SHALL BE PREPARED AND SEALED BY TRUSS MANUFACTURER.
- ALL TRUSSES SHALL BE DESIGNED FOR BEARING ON SPF #2 OR #3 PLATES OR LEDGERS (UNO).
- ALL REQUIRED ANCHORS FOR TRUSSES DUE TO UPLIFT OR BEARING SHALL MEET THE REQUIREMENTS AS SPECIFIED ON THE TRUSS SCHEMATICS.

HEADER/BEAM & COLUMN NOTES

- ALL EXTERIOR AND LOAD BEARING HEADERS SHALL BE MIN. (2)2x6 (4" WALL) OR (3)2x6 (6" WALL) WITH (1) SUPPORT STUD, UNLESS NOTED OTHERWISE.
- THE NUMBER SHOWN AT BEAM AND HEADER SUPPORTS INDICATES THE NUMBER OF SUPPORT STUDS REQUIRED IN STUD POCKET OR COLUMN THE NUMBER OF KING STUDS AT EACH END OF HEADERS IN EXTERIOR WALLS SHALL BE ACCORDING TO ITEM "d" IN TABLE R602.3(5) OR AS BELOW PER NCDOI COMMENTARY "KING STUDS AT WALL OPENINGS" REVISED 1-9-2020:
- UP TO 3' SPAN: (I) KING STUD
- OVER 3' UP TO 6' SPAN: (2) KING STUDS
- OVER 6' UP TO 4' SPAN: (3) KING STUDS

- OVER 9' UP TO 12' SPAN: (4) KING STUDS OVER 12' UP TO 15' SPAN: (5) KING STUDS

MOOD I-JOISTS

- (SHALL BE ONE OF THE FOLLOWING):

 TJI 2IO BY TRUS JOIST
- LPL 20 PLUS BY LP
- BCI 5000s I.8 BY BC
- ALL WOOD I-JOISTS SHALL BE INSTALLED ACCORDING TO MANUFACTURER'S SPECIFICATIONS.
- INSTALL SQUASH BLOCKS, WEB STIFFENERS, ETC. AS REQUIRED BY AND ACCORDING TO THE I-JOIST MANUFACTURER'S SPECIFICATIONS AND
- HANGERS FOR I-JOISTS ARE THE RESPONSIBILITY OF THE I-JOIST SUPPLIER.
- FLOOR TRUSSES BY THE MANUFACTURER MAY BE SUBSTITUTED FOR I-JOISTS.

PORCH POST NOTES:

- 4"x4" (6"x6") TRT'D POST (OR EQUAL). ATTACH TRUSSES (RAFTERS) AT PORCH WITH HURRICANE
- CONNECTORS.
 POST CAP: SIMPSON AC4-MAX (AC6-MAX)
- POST CAP AT CORNER: (2) SIMPSON LCE4 (MITER HEADER AT CORNER). HIGH WIND; ADD (1) SIMPSON H6.
- 3. POST BASE: SIMPSON ABU44 (ABU66).
- 3.I. 3.2.
- MOND: 5% ANCHOR (EMBED 1")
 CML: 5% ANCHOR (EXTEND TO FOOTING HIGH WIND ONLY)
- 4. POST BASE: WOOD FOUNDATION: (2) SIMPSON CSI6 STRAPS AT POSTS. EXTEND 12" ONTO EACH POST (UPPER AND LOWER) OR TO GIRDER.
- NOTE: EQUIVALENT POST CAP AND BASE ACCEPTABLE.

FRAMING NOTES

NC (2018 NCRC): Wind: 115-120 mph


- BRACING METHOD AND TYPE: CONTINUOUSLY SHEATHED WGP: CS-WSP, NOTE THAT THE WALL BRACING AMOUNT PROVIDED ON THE PLANS (DETAILS AND SPECIFICATIONS) IS GREATER THAN THE AMOUNT OF WALL BRACING REQUIRED BY SECTION R602.10 OF THE CODE. SEE NOTES BELOW FOR DETAILS AND SPECIFICATIONS FOR WALL BRACING AND WALL FRAMING
- 2. EXTERIOR WALL SHEATHING: WALLS SHALL BE BRACED BY SHEATHING WALLS ON ALL STORIES WITH WOOD STRUCTURAL PANEL SHEATHING (WSP) (EXPOSURE B: 7/16". EXPOSURE C. 15/32") SHEATHING SHALL BE ATTACHED WITH 8d NAILS AT A 6"/12" NAILING PATTERN (6" OC AT PANEL EDGES AND 12" OC AT INTERMEDIATE SUPPORTS). INSTALL BLOCKING AT ALL PANEL EDGES.
- MSP SHEATHING SHALL EXTEND TO THE UPPERMOST DOUBLE BEARING PLATE. BLOCK AT ROOF PER SECTION R602.10.45 AND ATTACH BRACED WALLS PER CODE, WSP SHEATHING BETWEEN FLOORS SHALL BE SPLICED ALONG CONTINUOUS BAND OR THE WSP SHEATHING MAY BE SPLICED ACROSS STUDS (CONTINUOUS ACROSS FLOOR SYSTEM) WITH BLOCKING AT PANEL EDGES. (MINIMUM 12" BEYOND FLOOR BREAK) OR OTHER APPROVED METHOD.
- 4. "HD" = HOLDOWN: HOLD-DOWN DEVICE (NOTED AS "HD" ON PLANS) SHALL BE AN 800 POUND CAPACITY ASSEMBLY AS NOTED ON PLANS. SEE DETAILS FOR HD ASSEMBI Y
- ASSEMBLT: OR EQUIV.)

 ***!GROUND/FIRST FLOOR: USE "HD HOLD-DOWN DETAIL" ON SD SHEET (OR EQUIV.)

 ***!UPER FLOORS: ATTACH BASE OF KING STUD WITH A SIMPSON C522 STRAP
 DOWN ACROSS THE BAND AND DOWN TO A STUD BELOW OR HEADER BELOW.

 EXTEND STRAP 1" MIN ALONG EACH STUD (OR HEADER) AND ATTACH EACH END W
- 5. INTERIOR BRACED WALL: (NOTED AS "IBM" ON PLANS) ATTACH I/2" GYPSIM BOARD (GB) ON EACH SIDE OF WALL WITH A MIN. OF 5d COOLER NAILS OR #6 SCREMS ◎ 7" O.C. ALONG THE EDGES AND AT INTERMEDIATE SUPPORTS
- 6. INTERIOR BRACED WALL-WOOD STRUCTURAL PANEL: (NOTED AS "IBW-WSP" ON PLANS). ATTACH ONE SIDE WITH "%" WSP SHEATHING WITH 8d NAILS AT A 6"/12" NAILING PATTERN (6" OC AT PANEL EDGES AND 12" OC AT INTERMEDIATE SUPPORTS), INSTALL BLOCKING AT ALL PANEL EDGES, ATTACH GB OVER WSP AS REQUIRED. ATTACH OPPOSITE SIDE WITH I/2" GB WITH A MIN. OF 5d COOLER NAILS OR #6 SCREWS @ 7" OC ALONG THE EDGES AND AT INTERMEDIATE SUPPORTS.

See Sheet S-2.1.2 for fireplace

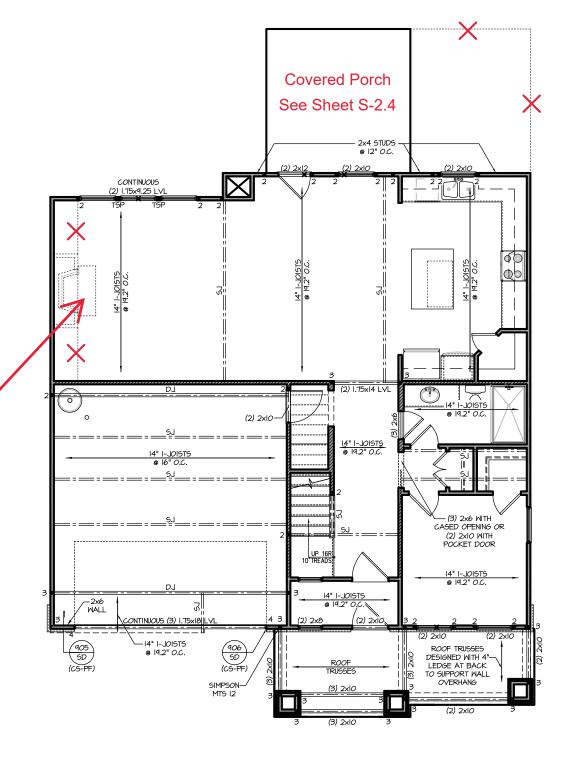

ALTERNATE FIRST FLOOR PLAN W/ SMART DOOR DELIVERY 'FRENCH COUNTRY' SCALE: 1/8"=1'-0" ON 11x17, 1/4"=1'-0" ON 22x34

PROJECT # 21-2867-LH


e to be brought to the Failure to do so will

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REFER TO "SD" SHEET(S) FOR STANDARD DETAILS BRACING DETAILS AND STRUCTURAL NOTES.

CARO SEAL 35153 SEAL 36153 SEAL 36153 SEAL 36153 SEAL 36153

2x4 STVDS -14" I-JOISTS @ 19.2" O.C. (2) 2x8 — (WITH DOOR) OPT. KITCHEN / MESSY KITCHEN / POCKET OFFICE SCALE: 1/8"=1'-0" ON 11x17, 1/4"=1'-0" ON 22x34

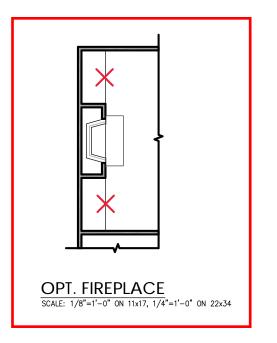

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PROJECT # 21-2867-LH

NEW HOME, INC.

Plan 3 -The Cary - LH

S-2.1.2

- TRUSS SYSTEM LAYOUTS (PLACEMENT PLANS) SHALL BE DESIGNED IN ACCORDANCE WITH SEALED STRUCTURAL PLANS. ANY NEED TO CHANGE TRUSSES SHALL BE COORDINATED WITH SOUTHERN ENGINEERS.
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- ALL TRUSSES SHALL BE DESIGNED FOR BEARING ON SPF #2 OR #3 PLATES OR LEDGERS (UNO).
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HEADER/BEAM & COLUMN NOTES

- ALL EXTERIOR AND LOAD BEARING HEADERS SHALL BE MIN. (2)2x6 (4" WALL) OR (3)2x6 (6" WALL) WITH (1) SUPPORT STUD, UNLESS NOTED OTHERWISE.
- 2. THE NUMBER SHOWN AT BEAM AND HEADER SUPPORTS INDICATES THE NUMBER OF SUPPORT STUDS REQUIRED IN STUD POCKET OR COLUMN. THE NUMBER OF KING STUDS AT EACH END OF HEADERS IN EXTERIOR WALLS SHALL BE ACCORDING TO ITEM "d" IN TABLE R602.3(5) OR AS BELOW PER NCDOI COMMENTARY "KING STUDS AT WALL OPENINGS" REVISED 1-4-2020:
- UP TO 3' SPAN: (I) KING STUD OVER 3' UP TO 6' SPAN: (2) KING STUDS
- OVER 6' UP TO 4' SPAN: (3) KING STUDS
- OVER 9' UP TO 12' SPAN: (4) KING STUDS
- OVER 12' UP TO 15' SPAN: (5) KING STUDS

FRAMING NOTES

NC (2018 NCRC): Wind: 115-120 mph


- BRACING METHOD AND TYPE: CONTINUOUSLY SHEATHED MSP: CS-MSP, NOTE THAT THE WALL BRACING AMOUNT PROVIDED ON THE PLANS (DETAILS AND SPECIFICATIONS) IS GREATER THAN THE AMOUNT OF WALL BRACING REQUIRED BY SECTION R602.10 OF THE CODE. SEE NOTES BELOW FOR DETAILS AND SPECIFICATIONS FOR WALL BRACING AND WALL FRAMING
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- MSP SHEATHING SHALL EXTEND TO THE UPPERMOST DOUBLE BEARING PLATE. BLOCK AT ROOF PER SECTION R602.10.4.5 AND ATTACH BRACED WALLS PER CODE, WSP SHEATHING BETWEEN FLOORS SHALL BE SPLICED ALONG CONTINUOUS BAND OR THE WSP SHEATHING MAY BE SPLICED ACROSS STUDS (CONTINUOUS ACROSS FLOOR SYSTEM) WITH BLOCKING AT PANEL EDGES. (MINIMUM 12" BEYOND FLOOR BREAK) OR OTHER APPROVED METHOD.
- 4. ${}^{ ext{"HD"}}$ = HOLDOWN: HOLD-DOWN DEVICE (NOTED AS "HD" ON PLANS) SHALL BE AN 800 POUND CAPACITY ASSEMBLY AS NOTED ON PLANS. SEE DETAILS FOR HD ASSEMBLY.
- ASSEMBLT: OR EQUIV.)

 ***!GROUND/FIRST FLOOR: USE "HD HOLD-DOWN DETAIL" ON SD SHEET (OR EQUIV.)

 ***!UPER FLOORS: ATTACH BASE OF KING STUD WITH A SIMPSON C522 STRAP
 DOWN ACROSS THE BAND AND DOWN TO A STUD BELOW OR HEADER BELOW.

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- 5. INTERIOR BRACED WALL: (NOTED AS "IBM" ON PLANS) ATTACH I/2" GYPSIM BOARD (GB) ON EACH SIDE OF WALL WITH A MIN. OF 5d COOLER NAILS OR #6 SCREMS ◎ 7" O.C. ALONG THE EDGES AND AT INTERMEDIATE SUPPORTS
- 6. INTERIOR BRACED WALL-WOOD STRUCTURAL PANEL: (NOTED AS "IBW-WSP" ON PLANS), ATTACH ONE SIDE WITH $\frac{1}{6}$ " WSP SHEATHING WITH 8d NAILS AT A 6"/12" NAILING PATTERN (6" OC AT PANEL EDGES AND 12" OC AT INTERMEDIATE SUPPORTS). INSTALL BLOCKING AT ALL PANEL EDGES, ATTACH GB OVER WSP AS REQUIRED. ATTACH OPPOSITE SIDE WITH I/2" GB WITH A MIN. OF 5d COOLER NAILS OR #6 SCREWS @ 7" OC ALONG THE EDGES AND AT INTERMEDIATE SUPPORTS.



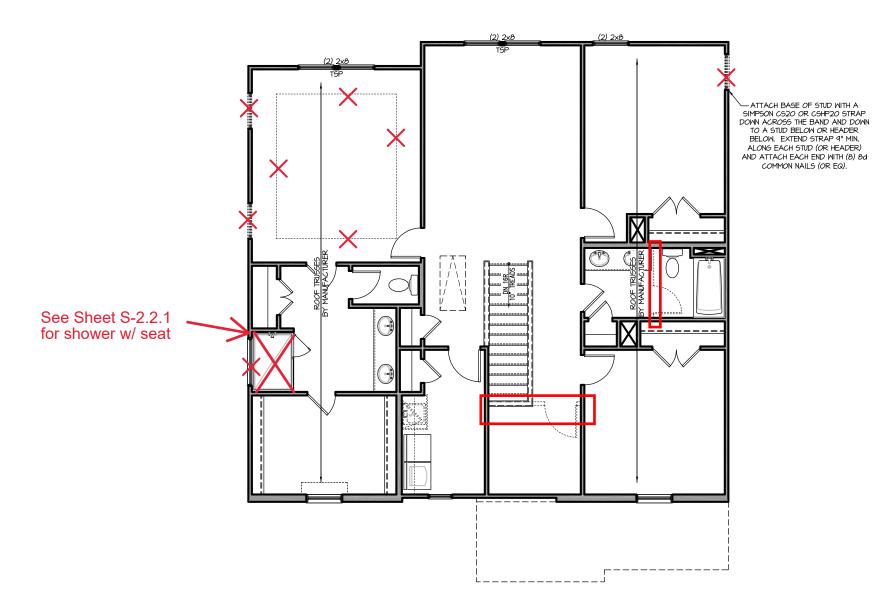

SECOND FLOOR PLAN 'FRENCH COUNTRY'

SCALE: 1/8"=1'-0" ON 11x17, 1/4"=1'-0" ON 22x34

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> HOME, NEW

-The 3 Plan

REFER TO "SD" SHEET(S) FOR STANDARD DETAILS BRACING DETAILS AND STRUCTURAL NOTES.







NO STRUCTURAL CHANGES FROM BASE PLAN





Plan 3 -The Cary

REFER TO "SD" SHEET(S) FOR STANDARD DETAILS, BRACING DETAILS AND STRUCTURAL NOTES. S-2.2.1

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TRUSS SYSTEM REQUIREMENTS NC (2018 NCRC): Wind: 115-120 mph

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See Sheet S-2.4 for Cov. Porch 1'-0" TYP. 6:12 28 LF RIDGE VENT 10:12 ROOF BY MAN 10:12 10:12 ROOF TRUSSES — BY MANUFACTURER

'FRENCH COUNTRY' ELEVATION ROOF PLAN

SCALE: 1/4" = 1'-0" ON 22x34, 1/8" = 1'-0" ON 11x17


Plan 3 -The Cary

NEW HOME, INC.

Southern Engineers, P

PROJECT # 21-2867-LH

REFER TO "SD" SHEET(S) FOR STANDARD DETAILS, BRACING DETAILS AND STRUCTURAL NOTES.

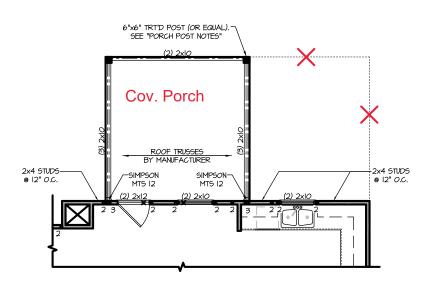

TYP.

STILE

ROOF TRUSSES

BY MANUFACTURER

TYP.

TYP.

STILE

TYP.

TYP.

STILE

TYP.

STILE

TYP.

STILE

TYP.

TYP.

TYP.

STILE

TYP.

STILE

TYP.

STILE

TYP.

COVERED PORCH FLOOR PLAN
SCALE: 1/8"=1'-0" ON 11x17, 1/4"=1'-0" ON 22x34

COVERED PORCH ROOF PLAN
SCALE: 1/8"=1'-0" ON 11x17, 1/4"=1'-0" ON 22x34




REFER TO "SD" SHEET(S) FOR STANDARD DETAILS, BRACING DETAILS AND STRUCTURAL NOTES. NEW HOME, INC.


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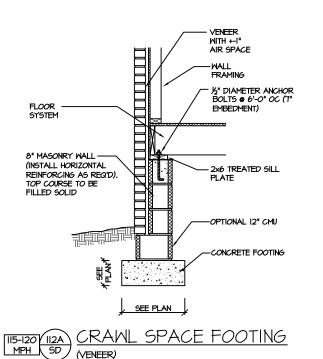
PROJECT # 21-2867-LH


Plan 3 -The Cary - LH


S-2.4



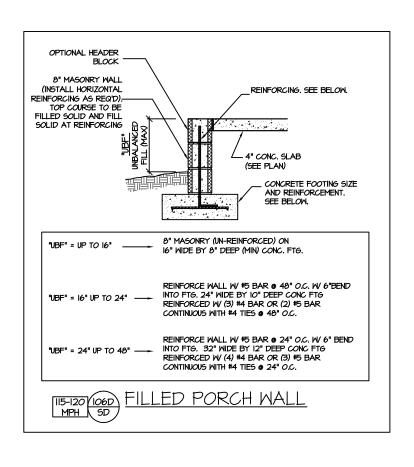

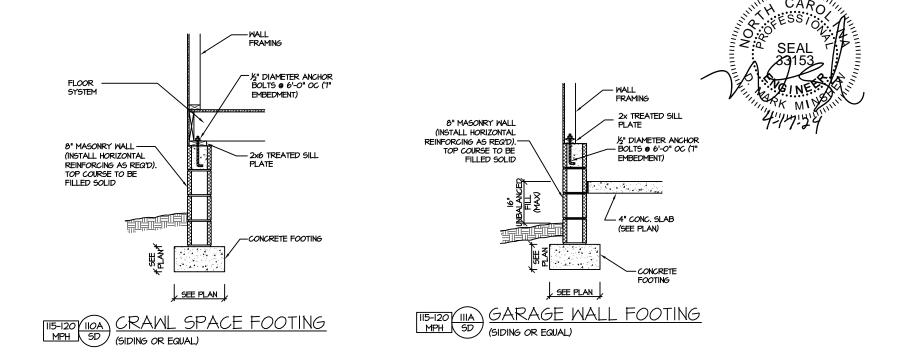

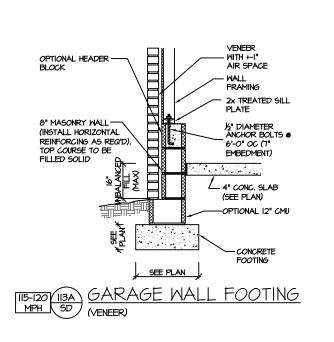

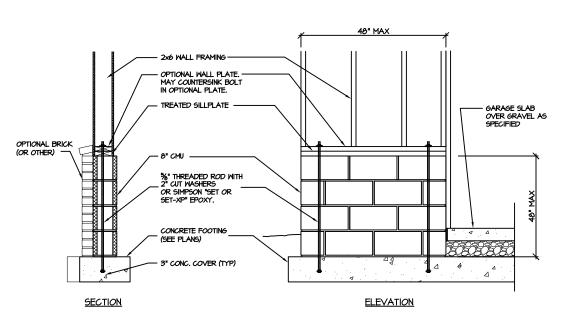

GARAGE 'WING WALL' REINFORCING PER IRC FIGURE R602.IO.4.3

CRAWL SPACE FOUNDATION


PROJECT # 21-2867


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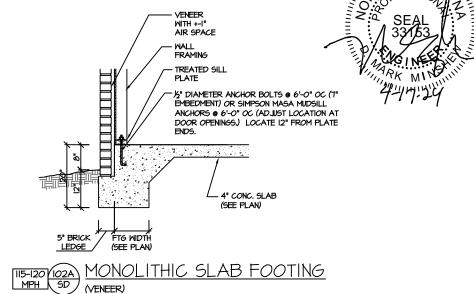
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NEW HOME,

CARY THE 3 **PLAN**






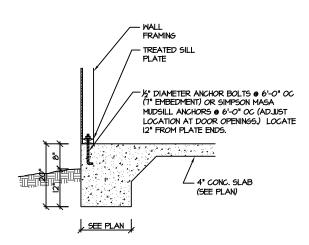


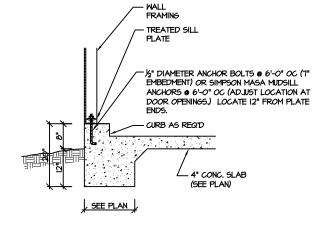
(VENEER)

MONOLITHIC SLAB FOOTING | II5-I20 | IOOA | SD |

MONOLITHIC SLAB @ GARAGE (SIDING OR EQUAL)

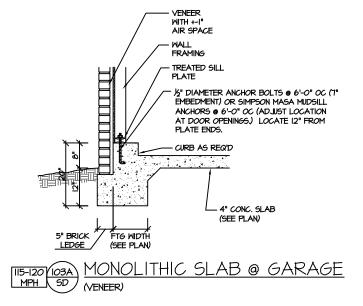

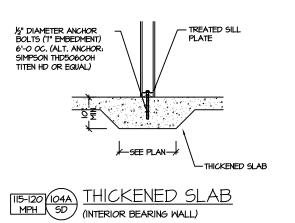

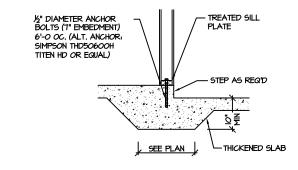

THICKENED SLAB @ GARAGE | II5-I20 | IO5A | SD | (INTERIOR GARAGE WALL)


SLAB FOUNDATION

PROJECT # 21-2867


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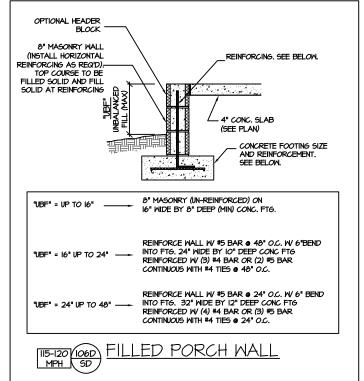
NEW HOME, INC

CARY THE 3 **PLAN**

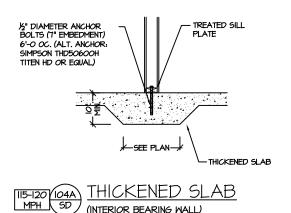



(INTERIOR BEARING WALL)




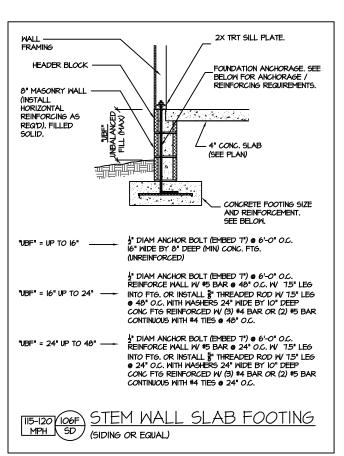




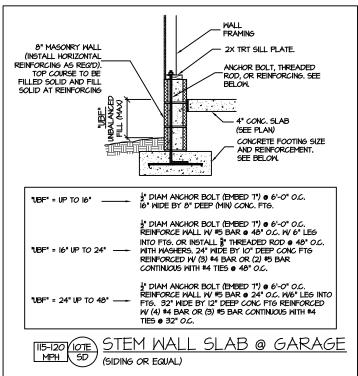

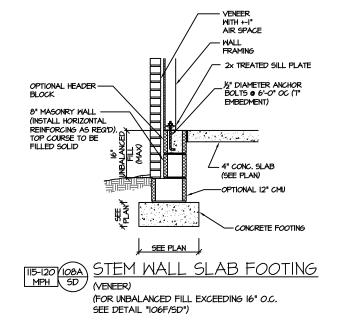

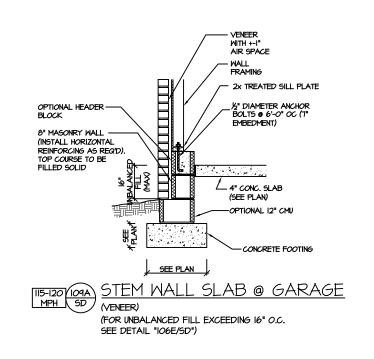

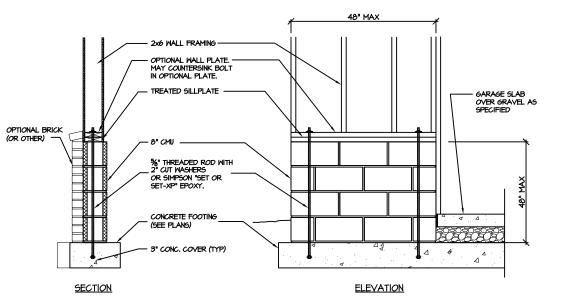

GARAGE 'WING WALL' REINFORCING PER IRC FIGURE R602.IO.4.3

STEMMALL SLAB FOUNDATION

PROJECT # 21-2867

P.A. 27609

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NEW HOME,

CARY THE 3 **PLAN**

CS-PF - OVER WOOD FLOOR


SILL PLATE (DO NOT SPLICE)

MSP OVERLAP OPTION

<u>CS-PF: CONTINUOUS PORTAL FRAME CONSTRUCTION</u> DETAIL AND APPLICATION BASED ON NORC FIGURE R602.IO.I - PORTAL FRAME CONSTRUCTION

ANCHOR

FRAMING ANCHOR OPTION

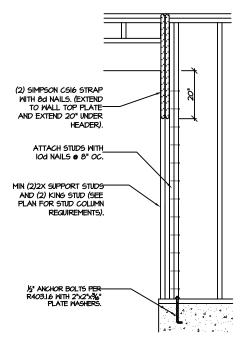

CS-PF: END CONDITION DETAIL (FOR USE WITH SINGLE CS-PF CONDITION) DETAIL AND APPLICATION BASED ON NORC FIGURE R602.IO.I - PORTAL FRAME CONSTRUCTION



STRUCTURAL NOTES NC (2018 NCRC): Wind: 115-120 mph

- ENGINEER'S SEAL APPLIES ONLY TO STRUCTURAL COMPONENTS INCLUDING ROOF RAFTERS, HIPS, VALLEY'S, RIDGES, FLOORS, WALLS, BEAMS AND HEADERS, COLUMMS, CANTILEVERS, OFFSET LOAD BEARING WALLS, PIER & GIRDER SYSTEM, FOOTING, AND PILING SYSTEM. ENGINEER'S SEAL DOES NOT CERTIFY DIMENSIONAL ACCURACY OR ARCHITECTURAL LATOUT INCLUDING ROOF SYSTEM, ALL REQUIREMENTS FOR PROFESSIONAL CERTIFICATION SHALL BE PROVIDED BY THE APPROPRIATE PROFESSIONAL. SOUTHERN ENGINEERS, P.A. CERTIFIES ONLY THE STRUCTURAL COMPONENTS AS SPECIFICALLY STATED.
- ALL CONSTRUCTION SHALL CONFORM TO THE LATEST REQUIREMENTS OF THE 2018 NC RESIDENTIAL CODE, PLUS ALL LOCAL CODES AND REGULATIONS. THE STRUCTURAL ENGINEER IS NOT RESPONSIBLE FOR, AND WILL NOT HAVE CONTROL OF, CONSTRUCTION MEANS, METHODS, TECHNIQUES, SEQUENCES OR PROCEDURES, OR FOR SAFETY PRECAUTIONS AND PROGRAMS IN CONNECTION WITH THE CONSTRUCTION MORK, NOR WILL THE ENGINEER BE RESPONSIBLE FOR THE CONTRACTOR'S FAILURE TO CARRY OUT THE CONSTRUCTION WORK IN ACCORDANCE WITH THE CONTRACT DOCUMENTS. "CONSTRUCTION REVIEW" SERVICES ARE NOT PART OF OUR CONTRACT.
 ALL MEMBERS SHALL BE FRAMED ANCHORED, TIED AND BRACED IN ACCORDANCE WITH GOOD CONSTRUCTION PRACTICE AND THE BUILDING CODE.
- DESIGN LOADS (LISTED AS: LIVE LOAD, DEAD LOAD, DEFLECTION) ROOMS OTHER THAN SLEEPING ROOMS: (40 PSF, IO PSF, L/360)
- SLEEPING ROOMS: (30 PSF, IO PSF, L/360)
- ATTIC WITH PERMANENT STAIR: (40 PSF, IO PSF, L/360)
- ATTIC WITHOUT PERMANENT STAIR: (20 PSF, I/O PSF, L/360) ATTIC WITHOUT STORAGE: (10 PSF, I/O PSF, L/240)
- STAIRS: (40 PSF, IO PSF, L/360)
- EXTERIOR BALCONIES: (60 PSF, IO PSF, L/360)
- DECKS: (40 PSF, IO PSF, L/360)
- GUARDRAILS AND HANDRAILS: (200 LBS) PASSSENGER VEHICLE GARAGES: (50 PSF, IO PSF, L/360) FIRE ESCAPES: (40 PSF, IO PSF, L/360)

- 4. WALLS SHALL BE BRACED BY SHEATHING WALLS ON ALL STORIES WITH WOOD STRUCTURAL PANELS. SEE FRAMING NOTES FOR THICKNESS AND NAILING REQUIREMENTS
- 5. SEE APPENDIX M (DCA6) FOR EXTERIOR DECK REQUIREMENTS INCLUDING ATTACHMENTS FOR LATERAL LOADS.
- 6. CONCRETE SHALL HAVE A MINIMUM 28 DAY STRENGTH OF 3000 PSI AND A MAXIMUM SLUMP OF 5 INCHES UNLESS NOTED OTHERWISE (UNO). AIR ENTRAINED PER TABLE 402.2. ALL CONCRETE SHALL BE PROPORTIONED, MIXED, HANDLED, SAMPLED, TESTED, AND PLACED IN ACCORDANCE MITH ACI STANDARDS, ALL SAMPLES FOR PUMPING SHALL BE TAKEN FROM THE EXIT END OF THE PUMP. CONTROL JOINTS IN SLABS SHALL BE SPACED ON A GRID OF +30 TIMES THE DEPTH (D). CONTROL JOINTS SHALL BE SANCUT TO A DEPTH OF I/D. (I.E. 4" CONCRETE SLABS SHALL HAVE 1/4" DEEP CONTROL JOINTS SAWOUT IN SLAB ON A +-10'-0" x +-10'-0" GRID).
- ALLOMABLE SOIL BEARING PRESSURE ASSUMED TO BE 2000 PSF. THE CONTRACTOR MUST CONTACT A GEOTECHNICAL ENGINEER AND THE STRUCTURAL ENGINEER IF UNGATISFACTORY SUBSURFACE CONDITIONS ARE ENCOUNTERED. THE SURFACE AREA ADJACENT TO THE FOUNDATION WALL SHALL BE PROVIDED WITH ADEQUATE DRAINAGE, AND SHALL BE GRADED SO AS TO DRAIN SURFACE WATER AWAY FROM FOUNDATION WALLS.
- 8. ALL FRAMING LUMBER SHALL BE SPF #2 (Fb = 875 PSI) UNLESS NOTED OTHERWISE (UNO). ALL TREATED LUMBER SHALL BE SYP # 2. PLATE MATERIAL MAY BE SPF # 3 OR SYP #3 (Fc(perp) =
- 9. L.V.L. SHALL BE LAMINATED VENEER LUMBER: Fb=2600 PSI, Fv=285 PSI, E=I.9xi0 PSI. P.S.L. SHALL BE PARALLEL STRAND LUMBER: Fb=2400 PSI, Fv=240 PSI, E=2.0xl0 PSI. L.S.L. SHALL BE LAMINATED STRAND LUMBER: Fb=2250 PSI, Fv=400 PSI, E=1.55xl0 PSI. INSTALL ALL CONNECTIONS PER MANUFACTURERS INSTRUCTIONS.
- IO. ALL ROOF TRUSS AND I-JOIST LAYOUTS SHALL BE PREPARED IN ACCORDANCE WITH THE SEALED STRUCTURAL DRAWINGS, TRUSSES AND I-JOISTS SHALL BE INSTALLED ACCORDING TO THE MANUFACTURE'S SPECIFICATIONS, ANY CHANGE IN TRUSS OR I-JOIST LAYOUT SHALL BE
- ALL STRUCTURAL STEEL SHALL BE ASTM A-36. STEEL BEAMS SHALL BE SUPPORTED AT EACH END WITH A MINIMUM BEARING LENGTH OF 3 1/2" INCHES AND FULL FLANGE WIDTH, PROVIDE SOLID BEARING FROM BEAM SUPPORT TO FOUNDATION. BEAMS SHALL BE ATTACHED TO EACH SUPPORT WITH TWO LAG SCREWS (I/2" DIAMETER x 4" LONG). LATERAL SUPPORT IS CONSIDERED ADEQUATE PROVIDING THE JOIST ARE TOE NAILED TO THE SOLE PLATE, AND SOLE PLATE IS NAILED OR BOLTED TO THE BEAM FLANGE @ 48" O.C. ALL STEEL TUBING SHALL BE ASTM A500.
- 12. REBAR SHALL BE DEFORMED STEEL, ASTM615, GRADE 60. LAP ALL REBAR SPLICES 30 BAR
- 13. FLITCH BEAMS SHALL BE BOLTED TOGETHER USING (2) ROWS OF 1/2" DIAMETER BOLTS (ASTM A325) WITH WASHERS PLACED UNDER THE THREADED END OF BOLT. BOLTS SHALL BE SPACED AT 24" O.C. (MAX), AND STAGGERED AT THE TOP AND BOTTOM OF BEAM (2" EDGE DISTANCE), WITH 2 BOLTS LOCATED AT 6" FROM EACH END.
- I4. BRICK LINTELS (WHEN REQUIRED) SHALL BE 3 I/2"x3 I/2"x1/4" STEEL ANGLE FOR UP TO 6'-O" SPAN AND 6"x4"x5/16" STEEL ANGLE WITH 6" LEG VERTICAL FOR SPANS UP TO 9'-O". SEE PLANS FOR SPANS OVER 4'-0". SEE ALSO SECTION R703.8.3 LINTELS.

PROJECT # 21-2867

P.A. 27609

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